




MANHATTAN WEST: NORTH TOWER

ISSUED FOR: FOUNDATION BID
SEPTEMBER 12TH, 2014



MANHATTAN WEST:
NORTH TOWER
375 Ninth Avenue, New York, NY 10001

Client

Brookfield

Brookfield Place
250 Vesey Street, 15th Floor, New York, NY 10281

Architecture/Structural Engineering

SOM

Skidmore, Owings & Merrill LLP
14 Wall Street, New York, NY 10005

Civil Engineering

Philip Habib & Associates
102 Madison Avenue #11, New York, NY 10016

MEP Engineering

Jaros Baum & Bolles
80 Pine Street, New York, NY 10005

Vertical Transportation

Edgett Williams Consulting Group, Inc.
102 East Blithedale Ave, Suite 1, Mill Valley, California 94041

Sustainable Design

Viridian Energy & Environmental
50 Washington Street, Newark, CT 06854

Geotechnical Engineering

Mueser Rutledge Consulting Engineers
14 Penn Plaza, 225 W. 34th Street, New York, NY 10122

Landscape Consultant

Field Operations
475 10th Avenue, New York, NY 10018

Security Consultant

Ducibella, Vantor & Santore
250 State Street #F1, North Haven, CT 06473

Blast Consultant

Weidinger Associates, Inc.
40 Wall Street, New York, NY 10005

Acoustical Consultant

Cerami & Associates
404 Fifth Avenue #8, New York, NY 10016

Vibration Consultant

Wilson, Uhrig & Associates, Inc.
65 Broadway, Suite 401, New York, NY 10006

Code Consultant

Code Consultants Professional Engineers PC
215 West 40th Street, 15th Floor, New York, NY 10018

Facade Maintenance Consultant

Entek Engineering LLC
166 Ames Street, Hackensack, NJ 07601


Wind Tunnel Consultant

Rowan Williams Davies & Irwin Inc.
650 Woodlawn Road West, Guelph, Ontario, Canada N1K 1B8

PRELIMINARY
NOT FOR CONSTRUCTION

Key Plan:

Seal & Signature:



Warning: It is a violation of the New York State Architecture Law, §20-5(b) for any person, unless they are acting under the direction of a Licensed Architect, to alter this item in any way.

7	12 SEPT 2014	ISSUED FOR FOUNDATION PERMIT
6	20 JUN 2014	ISSUED FOR FOUNDATION BID
5	20 JUN 2014	ISSUED FOR FOUNDATION PERMIT
4	20 DEC 2013	ISSUED FOR FOUNDATION PERMIT
3	15 NOV 2013	ISSUED FOR 50% PROGRESS PRICING
2	12 JUL 2013	ISSUED FOR 90% DESIGN DEVELOPMENT
1	19 MAR 2013	ISSUED FOR RECONCILIATION

No. Date Description
Sheet Name:

COVER SHEET

Project No.: 207150
Date: 12 SEPT 2014
Scale: NTS
File No.: G-001

B-SCAN Sheet No.:
G-001.00
Sheet No.:
G-001
Page No.: 1 OF 30



MANHATTAN WEST:
NORTH TOWER
375 Ninth Avenue, New York, NY 10001

Client

Brookfield

Brookfield Place
250 Vessey Street, New York, NY 10021

Architecture/Structural Engineering

SOM

Skidmore, Owings & Merrill LLP
14 Wall Street, New York, NY 10005

Civil Engineering

Philip Habib & Associates
102 Madison Avenue #11, New York, NY 10016

MEP Engineering

Jaros Baum & Boles
80 Pine Street, New York, NY 10005

Vertical Transportation

Edget Williams Consulting Group, Inc.
102 East Blinnedale Ave., Suite 1, Mill Valley, California 94041

Sustainable Design

Viridian Energy & Environmental
50 Washington Street, Newhall, CT 06854

Geotechnical Engineering

Mueser Rutledge Consulting Engineers
14 Penn Plaza, 225 W. 34th Street, New York, NY 10122

Landscape Consultant

Field Operations
475 10th Avenue, New York, NY 10018

Security Consultant

Ducibella, Vantor & Santore
250 State Street #F 1, North Haven, CT 06473

Blatt Consultant

Weldingers Associates, Inc.
40 Wall Street, New York, NY 10005

Acoustical Consultant

Gerrami & Associates
404 Fifth Avenue #6, New York, NY 10018

Vibration Consultant

Wilson, Uhrig & Associates, Inc.
65 Broadway, Suite 401, New York, NY 10006

Code Consultant

Code Consultants Professional Engineers PC
215 West 40th Street, 15th Floor, New York, NY 10018

Facade Maintenance Consultant

Entek Engineering LLC
166 Ames Street, Hackensack, NJ 07601

Wind Tunnel Consultant

Rowan Williams Davies & Irwin Inc.
880 Woodlawn Road West, Guelph, Ontario, Canada N1K 1B8

Key Plans:

Warning: It is a violation of the New York State Architecture Law, §§16-500 to 16-509, unless, unless they are acting under the terms of a Licensed Architect, to alter this item in any way.

PRELIMINARY
NOT FOR CONSTRUCTION

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GENERAL DRAWINGS		
DRAWING NO.	DRAWING NAME	SCALE
G-001.00	COVER SHEET	NTS
G-003.00	DRAWING INDEX	NTS
G-005.00	GENERAL NOTES	NTS
G-006.00	ABBREVIATIONS, LEGENDS & SYMBOLS	NTS
G-007.00	ADA REQUIREMENTS	1/4" = 1'-0"

DRAWING LIST - BUILDERS PAVEMENT PLAN		
DRAWING NO.	DRAWING NAME	SCALE
BPP-100.00	BPP TITLE SHEET	1" = 20'-0"
BPP-101.00	WEST 33RD STREET PLAN & PROFILE	1" = 20'-0"
BPP-102.00	9TH AVENUE PLAN & PROFILE	1" = 20'-0"
BPP-103.00	BPP DETAILS	1" = 20'-0"

ARCHITECTURAL DRAWINGS		
DRAWING NO.	DRAWING NAME	SCALE
A-002.00	FLOOD ZONE DATA	1" = 20'-0"
A-004.00	KEY PLAN - CELLAR B1 PITS	1" = 20'-0"
A-005.00	KEY PLAN - CELLAR B1	1" = 20'-0"
A-006.00	KEY PLAN - CELLAR B	1" = 20'-0"
A-007.00	KEY PLAN - GROUND FLOOR	1" = 20'-0"
A-012.00	CODE ANALYSIS - CELLAR B1	1/16" = 1'-0"
A-013.00	CODE ANALYSIS - CELLAR B	1/16" = 1'-0"
A-014.00	CODE ANALYSIS - GROUND FLOOR LEVEL 2	1/16" = 1'-0"
A-016.00	CODE ANALYSIS - LEVEL 5 & 6-18	1/16" = 1'-0"
A-021.00	CODE ANALYSIS - LEVEL 32 & 33-38	1/16" = 1'-0"
A-027.00	CODE ANALYSIS - LEVEL 59 & 57-58	1/16" = 1'-0"

A-094.00	CELLAR B1 PIT PLAN	1/8" = 1'-0"
A-095.00	CELLAR B1 FLOOR PLAN - PART A	1/8" = 1'-0"
A-096.00	CELLAR B1 FLOOR PLAN - PART B	1/8" = 1'-0"
A-097.00	CELLAR B1 FLOOR PLAN - PART A	1/8" = 1'-0"
A-098.00	CELLAR B FLOOR PLAN - PART B	1/8" = 1'-0"
A-100.00	GROUND FLOOR PLAN - PART B	1/8" = 1'-0"
A-101.00	GROUND FLOOR PLAN - PART B	1/8" = 1'-0"
A-102.00	LEVEL 2 FLOOR PLAN - RETAIL	1/8" = 1'-0"
A-103.00	LEVEL 3 FLOOR PLAN - STAR TRANSFER	1/8" = 1'-0"
A-104.00	LEVEL 4 FLOOR PLAN - MECHANICAL	1/8" = 1'-0"
A-105.00	LEVEL 5 FLOOR PLAN - MECHANICAL	1/8" = 1'-0"
A-106.00	LEVEL 6-16 FLOOR PLAN - TYPICAL LOW-RISE	1/8" = 1'-0"
A-117.00	LEVEL 17 FLOOR PLAN - LOW-RISE	1/8" = 1'-0"
A-118.00	LEVEL 18 FLOOR PLAN - LOW-RISE OVERRUN	1/8" = 1'-0"
A-119.00	LEVEL 19-20 FLOOR PLAN - LOW-RISE EMR	1/8" = 1'-0"
A-121.00	LEVEL 21-27 FLOOR PLAN - TYPICAL LOW-RISE	1/8" = 1'-0"
A-128.00	LEVEL 28 FLOOR PLAN - LOW-RISE & MID-RISE	1/8" = 1'-0"
A-129.00	LEVEL 29 FLOOR PLAN - MID-RISE OVERRUN	1/8" = 1'-0"
A-130.00	LEVEL 30 FLOOR PLAN - MID-RISE EMR	1/8" = 1'-0"
A-131.00	LEVEL 31 FLOOR PLAN - MID-RISE PUMP ROOM	1/8" = 1'-0"
A-132.00	LEVEL 32 FLOOR PLAN - MID-RISE WATER TANK	1/8" = 1'-0"
A-133.00	LEVEL 33-38 FLOOR PLAN - TYPICAL MID-RISE	1/8" = 1'-0"
A-139.00	LEVEL 39 FLOOR PLAN - MID-RISE	1/8" = 1'-0"
A-140.00	LEVEL 40-41 FLOOR PLAN - MID-RISE OVERRUN	1/8" = 1'-0"
A-142.00	LEVEL 42 FLOOR PLAN - MID-RISE EMR	1/8" = 1'-0"
A-143.00	LEVEL 43-48 FLOOR PLAN - TYPICAL MID-RISE	1/8" = 1'-0"
A-140.00	LEVEL 49 FLOOR PLAN - MID-RISE & HIGH-RISE	1/8" = 1'-0"
A-150.00	LEVEL 50-51 FLOOR PLAN - HIGH-RISE OVERRUN	1/8" = 1'-0"
A-152.00	LEVEL 52 FLOOR PLAN - HIGH-RISE EMR	1/8" = 1'-0"
A-153.00	LEVEL 53 FLOOR PLAN - HIGH-RISE PUMP ROOM	1/8" = 1'-0"
A-154.00	LEVEL 54 FLOOR PLAN - HIGH-RISE WATER TANK	1/8" = 1'-0"
A-155.00	LEVEL 55 FLOOR PLAN - HIGH-RISE	1/8" = 1'-0"
A-156.00	LEVEL 56 FLOOR PLAN - HIGH-RISE	1/8" = 1'-0"
A-157.00	LEVEL 57-58 FLOOR PLAN - TYPICAL HIGH-RISE	1/8" = 1'-0"
A-159.00	LEVEL 59 FLOOR PLAN - HIGH-RISE	1/8" = 1'-0"
A-160.00	LEVEL 60-61 FLOOR PLAN - HIGH-RISE OVERRUN	1/8" = 1'-0"
A-162.00	LEVEL 62 FLOOR PLAN - HIGH-RISE EMR	1/8" = 1'-0"
A-163.00	LEVEL 63 FLOOR PLAN - HIGH-RISE	1/8" = 1'-0"
A-164.00	LEVEL 64-67 FLOOR PLAN - TYPICAL HIGH-RISE	1/8" = 1'-0"
A-168.00	LEVEL 68 FLOOR PLAN - MECHANICAL	1/8" = 1'-0"
A-169.00	LEVEL 69 FLOOR PLAN - MECHANICAL	1/8" = 1'-0"
A-170.00	ROOF PLAN - MECHANICAL PENTHOUSE ROOF	1/8" = 1'-0"
A-171.00	ROOF PLAN - MECHANICAL PENTHOUSE ROOF	1/8" = 1'-0"
A-172.00	ROOF PLAN	1/8" = 1'-0"

A-200.00	BUILDING ELEVATIONS	1/32" = 1'-0"
A-201.00	BUILDING ELEVATIONS	1/32" = 1'-0"
A-210.00	ENLARGED ELEVATIONS AT GROUND FLOOR	1/8" = 1'-0"
A-211.00	ENLARGED ELEVATIONS AT GROUND FLOOR	1/8" = 1'-0"
A-225.00	ENLARGED ELEVATIONS AT LOFT BUILDING	1/8" = 1'-0"
A-230.00	ENLARGED ELEVATIONS AT ROOF	1/8" = 1'-0"
A-231.00	ENLARGED ELEVATIONS AT ROOF	1/8" = 1'-0"

A-250.00	BUILDING SECTIONS	1/32" = 1'-0"
A-270.00	ENLARGED SECTION AT LOBBY	1/8" = 1'-0"
A-271.00	ENLARGED SECTION AT LOBBY	1/8" = 1'-0"
A-290.00	ENLARGED SECTIONS AT ROOF	1/8" = 1'-0"
A-296.00	CELLAR B1 ENLARGED PIT PLAN	1/4" = 1'-0"
A-299.00	CELLAR B1 ENLARGED CORE PLAN	1/4" = 1'-0"
A-300.00	CELLAR B ENLARGED CORE PLAN	1/4" = 1'-0"
A-301.00	GROUND FLOOR ENLARGED CORE PLAN	1/4" = 1'-0"
A-306.00	LEVEL 1-16 ENLARGED CORE PLAN - TYPICAL LOW-RISE	1/4" = 1'-0"
A-328.00	LEVEL 28 ENLARGED CORE PLAN - LOW-RISE & MID-RISE	1/4" = 1'-0"
A-333.00	LEVEL 33-38 ENLARGED CORE PLAN - TYPICAL MID-RISE	1/4" = 1'-0"
A-340.00	LEVEL 43 ENLARGED CORE PLAN - MID-RISE & HIGH-RISE	1/4" = 1'-0"
A-357.00	LEVEL 57-58 ENLARGED CORE PLAN - TYPICAL HIGH-RISE	1/4" = 1'-0"
A-384.00	LEVEL 64-67 ENLARGED CORE PLAN - TYPICAL HIGH-RISE	1/4" = 1'-0"
A-372.00	ENLARGED RETAIL CORE PLANS	1/4" = 1'-0"
A-395.00	ENLARGED TRANSFORMER VAULT PLANS	1/4" = 1'-0"
A-396.00	ENLARGED TRANSFORMER VAULT SECTIONS	1/4" = 1'-0"

A-500.00	FOUNDATION WALL SECTIONS	1/2" = 1'-0"
A-501.00	FOUNDATION WALL SECTIONS	1/2" = 1'-0"
A-502.00	FOUNDATION WALL SECTIONS	1/2" = 1'-0"
A-503.00	FOUNDATION WALL SECTIONS	1/2" = 1'-0"
A-504.00	FOUNDATION WALL SECTIONS	1/2" = 1'-0"
A-505.00	FOUNDATION WALL SECTIONS	1/2" = 1'-0"
A-506.00	FOUNDATION WALL SECTIONS	1/2" = 1'-0"
A-507.00	FOUNDATION WALL SECTIONS	1/2" = 1'-0"
A-508.00	FOUNDATION DETAILS	1 1/2" = 1'-0"
A-520.00	TYPICAL STOREFRONT	1/2" = 1'-0"
A-521.00	TYPICAL STOREFRONT	1/2" = 1'-0"
A-525.00	STOREFRONT ENTRANCES	1/2" = 1'-0"
A-526.00	STOREFRONT ENTRANCES	1/2" = 1'-0"
A-530.00	CURTAIN WALL AT LEVEL 2 MECHANICAL	3/4" = 1'-0"
A-535.00	TYPICAL CURTAIN WALL	3/4" = 1'-0"
A-536.00	TYPICAL CURTAIN WALL CORNERS	3/4" = 1'-0"
A-537.00	TYPICAL CURTAIN WALL CORNERS	3/4" = 1'-0"
A-538.00	PANEL TYPES	3/4" = 1'-0"
A-540.00	CURTAIN WALL AT ROOF	1/2" = 1'-0"
A-541.00	CURTAIN WALL AT ROOF	1/2" = 1'-0"
A-550.00	STOREFRONT DETAILS	3" = 1'-0"
A-551.00	STOREFRONT DETAILS	3" = 1'-0"
A-552.00	STOREFRONT DETAILS	3" = 1'-0"
A-560.00	CURTAIN WALL DETAILS	3" = 1'-0"
A-561.00	CURTAIN WALL DETAILS	3" = 1'-0"
A-570.00	CURTAIN WALL DETAILS	3" = 1'-0"
A-571.00	CURTAIN WALL DETAILS	3" = 1'-0"
A-575.00	CURTAIN WALL DETAILS	3" = 1'-0"

ZONING DRAWINGS		
DRAWING NO.	DRAWING NAME	SCALE
Z-001.00	ZONING MAP & TAX LOT MAP	NTS
Z-002.00	ZONING CALCULATIONS & ROOF PLAN	1" = 20'-0"
Z-003.00	HEIGHT & SETBACK SCHEDULES / FLOOR AREA SCHEDULE	1" = 40'-0"
Z-004.00	STREET TREES PLANTING	1" = 40'-0"
Z-005.00	PUBLIC ACCESS AREAS - ENTRY PLAZA	AS SHOWN
Z-006.00	DEVELOPMENT SITE SURVEY	1" = 30'-0"
Z-007.00	BICYCLE PARKING / LOADING BERTHS	AS SHOWN
Z-101.00	ZONING FLOOR AREA DEDUCTIONS - CELLAR B1 PITS	1/16" = 1'-0"
Z-102.00	ZONING FLOOR AREA DEDUCTIONS - CELLAR B1	1/16" = 1'-0"
Z-103.00	ZONING FLOOR AREA DEDUCTIONS - CELLAR B	1/16" = 1'-0"
Z-104.00	ZONING FLOOR AREA DEDUCTIONS - GROUND FLOOR & LEVEL 2-4	1/16" = 1'-0"
Z-105.00	ZONING FLOOR AREA DEDUCTIONS - LEVEL 5-6	1/16" = 1'-0"
Z-106.00	ZONING FLOOR AREA DEDUCTIONS - LEVEL 9-12	1/16" = 1'-0"
Z-107.00	ZONING FLOOR AREA DEDUCTIONS - LEVEL 13-16	1/16" = 1'-0"
Z-108.00	ZONING FLOOR AREA DEDUCTIONS - LEVEL 17-20	1/16" = 1'-0"
Z-109.00	ZONING FLOOR AREA DEDUCTIONS - LEVEL 21-24	1/16" = 1'-0"
Z-110.00	ZONING FLOOR AREA DEDUCTIONS - LEVEL 25-28	1/16" = 1'-0"
Z-111.00	ZONING FLOOR AREA DEDUCTIONS - LEVEL 29-32	1/16" = 1'-0"
Z-112.00	ZONING FLOOR AREA DEDUCTIONS - LEVEL 33-36	1/16" = 1'-0"
Z-113.00	ZONING FLOOR AREA DEDUCTIONS - LEVEL 37-40	1/16" = 1'-0"
Z-114.00	ZONING FLOOR AREA DEDUCTIONS - LEVEL 41-44	1/16" = 1'-0"
Z-115.00	ZONING FLOOR AREA DEDUCTIONS - LEVEL 45-48	1/16" = 1'-0"
Z-116.00	ZONING FLOOR AREA DEDUCTIONS - LEVEL 49-52	1/16" = 1'-0"
Z-117.00	ZONING FLOOR AREA DEDUCTIONS - LEVEL 53-56	1/16" = 1'-0"
Z-118.00	ZONING FLOOR AREA DEDUCTIONS - LEVEL 57-60	1/16" = 1'-0"
Z-119.00	ZONING FLOOR AREA DEDUCTIONS - LEVEL 61-64	1/16" = 1'-0"
Z-120.00	ZONING FLOOR AREA DEDUCTIONS - LEVEL 65-68	1/16" = 1'-0"
Z-121.00	ZONING FLOOR AREA DEDUCTIONS - LEVEL 69 & PENTHOUSE ROOF PLANS	1/16" = 1'-0"

ENERGY CODE DRAWINGS		
DRAWING NO.	DRAWING NAME	SCALE
EN-001.00	NYC EC COMPLIANCE COVER SHEET	NTS
EN-002.00	NYC EC COMPLIANCE MANDATORY MEASURES SHEET NO. 1	NTS
EN-003.00	NYC EC COMPLIANCE MANDATORY MEASURES SHEET NO. 2	NTS
EN-004.00	NYC EC ENERGY MODELING AND PRESCRIPTIVE PATH SHEET NO. 1	NTS
EN-005.00	NYC EC ENERGY MODELING AND PRESCRIPTIVE PATH SHEET NO. 2	NTS
EN-100.00	NYC EC COMPLIANCE COMPLIANCE LIGHTING CELLAR B1 FLOOR PLAN - PART A	NTS
EN-101.00	NYC EC COMPLIANCE COMPLIANCE LIGHTING CELLAR B1 FLOOR PLAN - PART B	NTS
EN-102.00	NYC EC COMPLIANCE COMPLIANCE LIGHTING CELLAR B FLOOR PLAN - PART B	NTS
EN-103.00	NYC EC COMPLIANCE LIGHTING LEVEL 1 FLOOR PLAN	NTS
EN-104.00	NYC EC COMPLIANCE LIGHTING LEVEL 2 FLOOR PLAN	NTS
EN-105.00	NYC EC COMPLIANCE LIGHTING LEVEL 3 FLOOR PLAN	NTS
EN-106.00	NYC EC COMPLIANCE LIGHTING LEVEL 4 FLOOR PLAN	NTS
EN-107.00	NYC EC COMPLIANCE LIGHTING LEVEL 5 FLOOR PLAN	NTS
EN-108.00	NYC EC COMPLIANCE LIGHTING LEVEL 6-16 FLOOR PLAN	NTS
EN-109.00	NYC EC COMPLIANCE LIGHTING LEVEL 17 FLOOR PLAN	NTS
EN-110.00	NYC EC COMPLIANCE LIGHTING LEVEL 18 FLOOR PLAN	NTS
EN-111.00	NYC EC COMPLIANCE LIGHTING LEVEL 19-20 FLOOR PLAN	NTS
EN-112.00	NYC EC COMPLIANCE LIGHTING LEVEL 21 FLOOR PLAN	NTS
EN-113.00	NYC EC COMPLIANCE LIGHTING LEVEL 22 FLOOR PLAN	NTS
EN-114.00	NYC EC COMPLIANCE LIGHTING LEVEL 23 FLOOR PLAN	NTS
EN-115.00	NYC EC COMPLIANCE LIGHTING LEVEL 24 FLOOR PLAN	NTS
EN-116.00	NYC EC COMPLIANCE LIGHTING LEVEL 25 FLOOR PLAN	NTS
EN-117.00	NYC EC COMPLIANCE LIGHTING LEVEL 26 FLOOR PLAN	NTS
EN-118.00	NYC EC COMPLIANCE LIGHTING LEVEL 27 FLOOR PLAN	NTS
EN-119.00	NYC EC COMPLIANCE LIGHTING LEVEL 28 FLOOR PLAN	NTS
EN-120.00	NYC EC COMPLIANCE LIGHTING LEVEL 29 FLOOR PLAN	NTS
EN-121.00	NYC EC COMPLIANCE LIGHTING LEVEL 30 FLOOR PLAN	NTS
EN-122.00	NYC EC COMPLIANCE LIGHTING LEVEL 31 FLOOR PLAN	NTS
EN-123.00	NYC EC COMPLIANCE LIGHTING LEVEL 32 FLOOR PLAN	NTS
EN-124.00	NYC EC COMPLIANCE LIGHTING LEVEL 33-38 FLOOR PLAN	NTS
EN-125.00	NYC EC COMPLIANCE LIGHTING LEVEL 39 FLOOR PLAN	NTS
EN-126.00	NYC EC COMPLIANCE LIGHTING LEVEL 40-41 FLOOR PLAN	NTS
EN-127.00	NYC EC COMPLIANCE LIGHTING LEVEL 42 FLOOR PLAN	NTS
EN-128.00	NYC EC COMPLIANCE LIGHTING LEVEL 43-48 FLOOR PLAN	NTS
EN-129.00	NYC EC COMPLIANCE LIGHTING LEVEL 49 FLOOR PLAN	NTS
EN-130.00	NYC EC COMPLIANCE LIGHTING LEVEL 50-51 FLOOR PLAN	NTS
EN-131.00	NYC EC COMPLIANCE LIGHTING LEVEL 52 FLOOR PLAN	NTS
EN-132.00	NYC EC COMPLIANCE LIGHTING LEVEL 53 FLOOR PLAN	NTS
EN-133.00	NYC EC COMPLIANCE LIGHTING LEVEL 54 FLOOR PLAN	NTS
EN-134.00	NYC EC COMPLIANCE LIGHTING LEVEL 55 FLOOR PLAN	NTS
EN-135.00	NYC EC COMPLIANCE LIGHTING LEVEL 56 FLOOR PLAN	NTS
EN-136.00	NYC EC COMPLIANCE LIGHTING LEVEL 57-58 FLOOR PLAN	NTS
EN-137.00	NYC EC COMPLIANCE LIGHTING LEVEL 59 FLOOR PLAN	NTS
EN-138.00	NYC EC COMPLIANCE LIGHTING LEVEL 60-61 FLOOR PLAN	NTS
EN-139.00	NYC EC COMPLIANCE LIGHTING LEVEL 62 FLOOR PLAN	NTS
EN-140.00	NYC EC COMPLIANCE LIGHTING LEVEL 63 FLOOR PLAN	NTS
EN-141.00	NYC EC COMPLIANCE LIGHTING LEVEL 64-67 FLOOR PLAN	NTS
EN-142.00	NYC EC COMPLIANCE LIGHTING LEVEL 68 FLOOR PLAN	NTS
EN-143.00	NYC EC COMPLIANCE LIGHTING LEVEL 69 FLOOR PLAN	NTS
EN-144.00	NYC EC COMPLIANCE LIGHTING LEVEL 70 FLOOR PLAN	NTS
EN-145.00	NYC EC COMPLIANCE LIGHTING LEVEL 71 FLOOR PLAN	NTS
EN-146.00	NYC EC COMPLIANCE LIGHTING LEVEL 72 FLOOR PLAN	NTS
EN-147.00	NYC EC COMPLIANCE LIGHTING LEVEL 73 FLOOR PLAN	NTS
EN-148.00	NYC EC COMPLIANCE LIGHTING LEVEL 74 FLOOR PLAN	NTS
EN-149.00	NYC EC COMPLIANCE LIGHTING LEVEL 75 FLOOR PLAN	NTS
EN-150.00	NYC EC COMPLIANCE LIGHTING LEVEL 76 FLOOR PLAN	NTS
EN-151.00	NYC EC COMPLIANCE LIGHTING LEVEL 77 FLOOR PLAN	NTS
EN-152.00	NYC EC COMPLIANCE LIGHTING LEVEL 78 FLOOR PLAN	NTS
EN-153.00	NYC EC COMPLIANCE LIGHTING LEVEL 79 FLOOR PLAN	NTS
EN-154.00	NYC EC COMPLIANCE LIGHTING LEVEL 80 FLOOR PLAN	NTS
EN-155.00	NYC EC COMPLIANCE LIGHTING LEVEL 81 FLOOR PLAN	NTS
EN-156.00	NYC EC COMPLIANCE LIGHTING LEVEL 82 FLOOR PLAN	NTS
EN-157.00	NYC EC COMPLIANCE LIGHTING LEVEL 83 FLOOR PLAN	NTS
EN-158.00	NYC EC COMPLIANCE LIGHTING LEVEL 84 FLOOR PLAN	NTS
EN-159.00	NYC EC COMPLIANCE LIGHTING LEVEL 85 FLOOR PLAN	NTS
EN-160.00	NYC EC COMPLIANCE LIGHTING LEVEL 86 FLOOR PLAN	NTS
EN-161.00	NYC EC COMPLIANCE LIGHTING LEVEL 87 FLOOR PLAN	NTS
EN-162.00	NYC EC COMPLIANCE LIGHTING LEVEL 88 FLOOR PLAN	NTS
EN-163.00	NYC EC COMPLIANCE LIGHTING LEVEL 89 FLOOR PLAN	NTS
EN-164.00	NYC EC COMPLIANCE LIGHTING LEVEL 90 FLOOR PLAN	NTS
EN-165.00	NYC EC COMPLIANCE LIGHTING LEVEL 91 FLOOR PLAN	NTS
EN-166.00	NYC EC COMPLIANCE LIGHTING LEVEL 92 FLOOR PLAN	NTS
EN-167.00	NYC EC COMPLIANCE LIGHTING LEVEL 93 FLOOR PLAN	NTS
EN-168.00	NYC EC COMPLIANCE LIGHTING LEVEL 94 FLOOR PLAN	NTS
EN-169.00	NYC EC COMPLIANCE LIGHTING LEVEL 95 FLOOR PLAN	NTS
EN-170.00	NYC EC COMPLIANCE LIGHTING LEVEL 96 FLOOR PLAN	NTS
EN-171.00	NYC EC COMPLIANCE LIGHTING LEVEL 97 FLOOR PLAN	NTS
EN-172.00	NYC EC COMPLIANCE LIGHTING LEVEL 98 FLOOR PLAN	NTS
EN-173.00	NYC EC COMPLIANCE LIGHTING LEVEL 99 FLOOR PLAN	NTS
EN-174.00	NYC EC COMPLIANCE LIGHTING LEVEL 100 FLOOR PLAN	NTS
EN-175.00	NYC EC COMPLIANCE LIGHTING LEVEL 101 FLOOR PLAN	NTS
EN-176.00	NYC EC COMPLIANCE LIGHTING LEVEL 102 FLOOR PLAN	NTS
EN-177.00	NYC EC COMPLIANCE LIGHTING LEVEL 103 FLOOR PLAN	NTS
EN-178.00	NYC EC COMPLIANCE LIGHTING LEVEL 104 FLOOR PLAN	NTS
EN-179.00	NYC EC COMPLIANCE LIGHTING LEVEL 105 FLOOR PLAN	NTS
EN-180.00	NYC EC COMPLIANCE LIGHTING LEVEL 106 FLOOR PLAN	NTS
EN-181.00	NYC EC COMPLIANCE LIGHTING LEVEL 107 FLOOR PLAN	NTS
EN-182.00	NYC EC COMPLIANCE LIGHTING LEVEL 108 FLOOR PLAN	NTS
EN-183.00	NYC EC COMPLIANCE LIGHTING LEVEL 109 FLOOR PLAN	NTS
EN-184.00	NYC EC COMPLIANCE LIGHTING LEVEL 110 FLOOR PLAN	NTS
EN-185.00	NYC EC COMPLIANCE LIGHTING LEVEL 111 FLOOR PLAN	NTS
EN-186.00	NYC EC COMPLIANCE LIGHTING LEVEL 112 FLOOR PLAN	NTS
EN-187.00	NYC EC COMPLIANCE LIGHTING LEVEL 113 FLOOR PLAN	NTS
EN-188.00	NYC EC COMPLIANCE LIGHTING LEVEL 114 FLOOR PLAN	NTS
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EN-190.00	NYC EC COMPLIANCE LIGHTING LEVEL 116 FLOOR PLAN	NTS
EN-191.00	NYC EC COMPLIANCE LIGHTING LEVEL 117 FLOOR PLAN	NTS
EN-192.00	NYC EC COMPLIANCE LIGHTING LEVEL 118 FLOOR PLAN	NTS
EN-193.00	NYC EC COMPLIANCE LIGHTING LEVEL 119 FLOOR PLAN	NTS
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EN-196.00	NYC EC COMPLIANCE LIGHTING LEVEL 122 FLOOR PLAN	NTS
EN-197.00	NYC EC COMPLIANCE LIGHTING LEVEL 123 FLOOR PLAN	NTS
EN-198.00	NYC EC COMPLIANCE LIGHTING LEVEL 124 FLOOR PLAN	NTS
EN-199.00	NYC EC COMPLIANCE LIGHTING LEVEL 125 FLOOR PLAN	NTS
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EN-205.00	NYC EC COMPLIANCE LIGHTING LEVEL 131 FLOOR PLAN	NTS
EN-206.00	NYC EC COMPLIANCE LIGHTING LEVEL 132 FLOOR PLAN	NTS
EN-207.00	NYC EC COMPLIANCE LIGHTING LEVEL 133 FLOOR PLAN	NTS
EN-208.00	NYC EC COMPLIANCE LIGHTING LEVEL 134 FLOOR PLAN	NTS
EN-209.00	NYC EC COMPLIANCE LIGHTING LEVEL 135 FLOOR PLAN	NTS
EN-210.00	NYC EC COMPLIANCE LIGHTING LEVEL 136 FLOOR PLAN	NTS
EN-211.00	NYC EC COMPLIANCE LIGHTING LEVEL 137 FLOOR PLAN	NTS
EN-212.00	NYC EC COMPLIANCE LIGHTING LEVEL 138 FLOOR PLAN	NTS
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EN-214.00	NYC EC COMPLIANCE LIGHTING LEVEL 140 FLOOR PLAN	NTS
EN-215.00	NYC EC COMPLIANCE LIGHTING LEVEL 141 FLOOR PLAN	NTS
EN-216.00	NYC EC COMPLIANCE LIGHTING LEVEL 142 FLOOR PLAN	NTS
EN-217.00	NYC EC COMPLIANCE LIGHTING LEVEL 143 FLOOR PLAN	NTS
EN-218.00	NYC EC COMPLIANCE LIGHTING LEVEL 144 FLOOR PLAN	NTS
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EN-221.00	NYC EC COMPLIANCE LIGHTING LEVEL 147 FLOOR PLAN	NTS
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EN-223.00	NYC EC COMPLIANCE LIGHTING LEVEL 149 FLOOR PLAN	NTS
EN-224.00	NYC EC COMPLIANCE LIGHTING LEVEL 150 FLOOR PLAN	NTS
EN-225.00	NYC EC COMPLIANCE LIGHTING LEVEL 151 FLOOR PLAN	NTS
EN-226.00	NYC EC COMPLIANCE LIGHTING LEVEL 152 FLOOR PLAN	NTS
EN-227.00	NYC EC COMPLIANCE LIGHTING LEVEL 153 FLOOR PLAN	NTS
EN-228.00	NYC EC COMPLIANCE LIGHTING LEVEL 154 FLOOR PLAN	NTS
EN-229.00	NYC EC COMPLIANCE LIGHTING LEVEL 155 FLOOR PLAN	NTS
EN-230.00	NYC EC COMPLIANCE LIGHTING LEVEL 156 FLOOR PLAN	NTS
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EN-233.00	NYC EC COMPLIANCE LIGHTING LEVEL 159 FLOOR PLAN	NTS
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EN-236.00	NYC EC COMPLIANCE LIGHTING LEVEL 162 FLOOR PLAN	NTS
EN-237.00	NYC EC COMPLIANCE LIGHTING LEVEL 163 FLOOR PLAN	NTS
EN-238.00	NYC EC COMPLIANCE LIGHTING LEVEL 164 FLOOR PLAN	NTS
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EN-244.00	NYC EC COMPLIANCE LIGHTING LEVEL 170 FLOOR PLAN	NTS
EN-245.00	NYC EC COMPLIANCE LIGHTING LEVEL 171 FLOOR PLAN	NTS
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EN-256.00	NYC EC COMPLIANCE LIGHTING LEVEL 182 FLOOR PLAN	NTS
EN-257.00	NYC EC COMPLIANCE LIGHTING LEVEL 183 FLOOR PLAN	NTS
EN-258.00	NYC EC COMPLIANCE LIGHTING LEVEL 184 FLOOR PLAN	NTS
EN-259.00	NYC EC COMPLIANCE LIGHTING LEVEL 185 FLOOR PLAN	NTS
EN-260.00	NYC EC COMPLIANCE LIGHTING LEVEL 186 FLOOR PLAN	NTS
EN-261.00	NYC EC COMPLIANCE LIGHTING LEVEL 187 FLOOR PLAN	NTS
EN-262.00	NYC EC COMPLIANCE LIGHTING LEVEL 188 FLOOR PLAN	NTS
EN-263.00	NYC EC COMPLIANCE LIGHTING LEVEL 189 FLOOR PLAN	NTS
EN-264.00	NYC EC COMPLIANCE LIGHTING LEVEL 190 FLOOR PLAN	NTS
EN-265.00	NYC EC COMPLIANCE LIGHTING LEVEL 191 FLOOR PLAN	NTS
EN-266.00	NYC EC COMPLIANCE LIGHTING LEVEL 192 FLOOR PLAN	NTS
EN-267.00	NYC EC COMPLIANCE LIGHTING LEVEL 193 FLOOR PLAN	NTS
EN-268.00	NYC EC COMPLIANCE LIGHTING LEVEL 194 FLOOR PLAN	NTS
EN-269.00	NYC EC COMPLIANCE LIGHTING LEVEL 195 FLOOR PLAN	NTS
EN-270.00	NYC EC COMPLIANCE LIGHTING LEVEL 196 FLOOR PLAN	NTS
EN-271.00	NYC EC COMPLIANCE LIGHTING LEVEL 197 FLOOR PLAN	NTS
EN-272.00	NYC EC COMPLIANCE LIGHTING LEVEL 198 FLOOR PLAN	NTS
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EN-276.00	NYC EC COMPLIANCE LIGHTING LEVEL 202 FLOOR PLAN	NTS
EN-277.00	NYC EC COMPLIANCE LIGHTING LEVEL 203 FLOOR PLAN	NTS
EN-278.00	NYC EC COMPLIANCE LIGHTING LEVEL 204 FLOOR PLAN	NTS
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EN-285.00	NYC EC COMPLIANCE LIGHTING LEVEL 211 FLOOR PLAN	NTS
EN-286.00	NYC EC COMPLIANCE LIGHTING LEVEL 212 FLOOR PLAN	NTS
EN-287.00	NYC EC COMPLIANCE LIGHTING LEVEL 213 FLOOR PLAN	NTS
EN-288.00	NYC EC COMPLIANCE LIGHTING LEVEL 214 FLOOR PLAN	NTS
EN-289.00	NYC EC COMPLIANCE LIGHTING LEVEL 215 FLOOR PLAN	NTS
EN-290.00	NYC EC COMPLIANCE LIGHTING LEVEL 216 FLOOR PLAN	NTS
EN-291.00	NYC EC COMPLIANCE LIGHTING LEVEL 217 FLOOR PLAN	NTS
EN-292.00	NYC EC COMPLIANCE LIGHTING LEVEL 218 FLOOR PLAN	NTS
EN-293.00	NYC EC COMPLIANCE LIGHTING LEVEL 219 FLOOR PLAN	NTS
EN-294.00	NYC EC COMPLIANCE LIGHTING LEVEL 220 FLOOR PLAN	NTS
EN-295.00	NYC EC COMPLIANCE LIGHTING LEVEL 221 FLOOR PLAN	NTS
EN-296.00	NYC EC COMPLIANCE LIGHTING LEVEL 222 FLOOR PLAN	NTS
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EN-303.00	NYC EC COMPLIANCE LIGHTING LEVEL 229 FLOOR PLAN	NTS
EN-304.00	NYC EC COMPLIANCE LIGHTING LEVEL 230 FLOOR PLAN	NTS
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EN-320.00	NYC EC COMPLIANCE LIGHTING LEVEL 246 FLOOR PLAN	NTS
EN-321.00	NYC EC COMPLIANCE LIGHTING LEVEL 247 FLOOR PLAN	NTS
EN-322.00	NYC EC COMPLIANCE LIGHTING LEVEL 248 FLOOR PLAN	NTS
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EN-324.00	NYC EC COMPLIANCE LIGHTING LEVEL 250 FLOOR PLAN	NTS
EN-325.00	NYC EC COMPLIANCE LIGHTING LEVEL 251 FLOOR PLAN	NTS
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EN-333.00	NYC EC COMPLIANCE LIGHTING LEVEL 259 FLOOR PLAN	NTS
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EN-340.00	NYC EC COMPLIANCE LIGHTING LEVEL 266 FLOOR PLAN	NTS
EN-341.00	NYC EC COMPLIANCE LIGHTING LEVEL 267 FLOOR PLAN	NTS
EN-342.00	NYC EC COMPLIANCE LIGHTING LEVEL 268 FLOOR PLAN	NTS
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EN-344.00	NYC EC COMPLIANCE LIGHTING LEVEL 270 FLOOR PLAN	NTS
EN-345.00	NYC EC COMPLIANCE LIGHTING LEVEL 271 FLOOR PLAN	NTS
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EN-348.00	NYC EC COMPLIANCE LIGHTING LEVEL 274 FLOOR PLAN	NTS
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EN-351.00	NYC EC COMPLIANCE LIGHTING LEVEL 277 FLOOR PLAN	NTS
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EN-357.00	NYC EC COMPLIANCE LIGHTING LEVEL 283 FLOOR PLAN	NTS
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EN-361.00	NYC EC COMPLIANCE LIGHTING LEVEL 287 FLOOR PLAN	NTS
EN-362.00	NYC EC COMPLIANCE LIGHTING LEVEL 288 FLOOR PLAN	NTS
EN-363.00	NYC EC COMPLIANCE LIGHTING LEVEL 289 FLOOR PLAN	NTS
EN-364.00	NYC EC COMPLIANCE LIGHTING LEVEL 290 FLOOR PLAN	NTS
EN-365.00	NYC EC COMPLIANCE LIGHTING LEVEL 291 FLOOR PLAN	NTS
EN-366.00	NYC EC COMPLIANCE LIGHTING LEVEL 292 FLOOR PLAN	NTS
EN-367.00	NYC EC COMPLIANCE LIGHTING LEVEL 293 FLOOR PLAN	NTS
EN-368.00	NYC EC COMPLIANCE LIGHTING LEVEL 294 FLOOR PLAN	NTS
EN-369.00	NYC EC COMPLIANCE LIGHTING LEVEL 295 FLOOR PLAN	NTS

G-000 - GENERAL NOTES

1. THESE DRAWINGS INDICATE THE GENERAL SCOPE OF THE PROJECT IN TERMS OF ARCHITECTURAL DESIGN CONCEPT, THE DIMENSIONS OF THE BUILDING, THE MAJOR ARCHITECTURAL ELEMENTS AND THE TYPE OF STRUCTURAL, MECHANICAL, ELECTRICAL, PLUMBING, AND FIRE PROTECTION SYSTEMS. THE DRAWINGS DO NOT NECESSARILY INDICATE OR DESCRIBE ALL WORK REQUIRED FOR FULL PERFORMANCE AND COMPLETION OF THE REQUIREMENTS OF THE CONTRACT DOCUMENTS. ON THE BASIS OF THE GENERAL SCOPE INFORMATION OR DESCRIBED, THE CONTRACTOR SHALL FURNISH ALL ITEMS REQUIRED FOR THE PROPER EXECUTION AND COMPLETION OF THE WORK.

2. THE CONTRACTOR SHALL PREPARE "COORDINATION DRAWINGS" WHICH REPRESENT THAT ALL TRADES INVOLVED IN THE PROJECT HAVE COORDINATED THE INSTALLATION OF THEIR WORK SO AS TO AVOID CONFLICTS AND/OR MISALIGNMENTS.

3. ALL WORK CONTAINED IN ALL CEILINGS SHALL BE SIMULTANEOUSLY REPRESENTED ON A SINGLE DRAWING TO CONTRIBUTE THAT ALL TRADES FIT WITHIN THE ALLOTTED SPACE. ALL CONFLICTS SHALL BE RESOLVED PRIOR TO SUBMITTING SHOP DRAWINGS FOR THE ARCHITECT'S OR ENGINEER'S REVIEW AND PRIOR TO EXECUTING ANY OF THE WORK WITHIN THE CEILING CAVITY.

4. EXISTING WORK IS TO BE PROTECTED DURING CONSTRUCTION AND KEPT FREE OF DEBRIS. ANY EXISTING WORK DAMAGED DURING CONSTRUCTION IS TO BE REPLACED WITH WORK OF EQUAL QUALITY.

5. THE ARCHITECT HAS NOT BEEN RETAINED FOR SUPERVISION OF CONSTRUCTION AND ASSUMES NO RESPONSIBILITY FOR MEANS, METHODS AND TECHNIQUES OF CONSTRUCTION.

6. THE CONTRACTOR SHALL CHECK AND VERIFY ALL DIMENSIONS AND JOB CONDITIONS BEFORE COMMENCEMENT OF WORK AND BE RESPONSIBLE FOR THEIR ACCURACY. ANY DISCREPANCIES BETWEEN FIELD CONDITIONS AND THE DOCUMENTS OR WITHIN THE DOCUMENTS ARE TO BE REPORTED TO THE ARCHITECT VIA THE CONTRACTOR. DIMENSIONS SHALL BE FIGURED RATHER THAN DETERMINED BY SCALE OR RULE. IN THE EVENT OF CONFLICT BETWEEN THE DRAWINGS AND SPECIFICATIONS OR WITHIN THEMSELVES, IT IS THE RESPONSIBILITY OF THE CONTRACTOR TO BRING THE CONFLICT TO THE ARCHITECT'S ATTENTION. THE ARCHITECT WILL DECIDE WHICH CONFLICTING REQUIREMENT GOVERNS.

8. ALL REFERENCES TO CODES, SPECIFICATIONS AND STANDARDS REFERRED TO IN THE CONTRACT DOCUMENTS SHALL MEAN, AND ARE INTENDED TO BE, THE LATEST EDITION, AMENDMENT, ORDINANCE OR SUCH REFERENCE STANDARDS IN EFFECT AS OF THE DATE OF ISSUANCE OF THE CONTRACT DOCUMENTS.

9. EXCEPT WHERE THE CONTRACT DOCUMENTS INCLUDE MORE STRINGENT REQUIREMENTS, APPLICABLE CONSTRUCTION INDUSTRY STANDARDS HAVE THE SAME FORCE AND EFFECT AS IF BOARD OR CODED INFORMATION WERE INCORPORATED INTO THE CONTRACT DOCUMENTS TO THE EXTENT REFERENCED. SUCH STANDARDS ARE MADE A PART OF THE CONTRACT DOCUMENTS BY REFERENCE.

10. WHERE COMPLIANCE WITH TWO OR MORE STANDARDS IS SPECIFIED, AND THE STANDARDS MAY ESTABLISH DIFFERENT OR CONFLICTING REQUIREMENTS FOR MINIMUM QUANTITIES OR QUANTITY LEVELS, REQUIREMENTS THAT ARE DIFFERENT, BUT APPARENTLY EQUAL, AND UNCERTAINTIES ARE TO BE DEFERRED TO THE DESIGN TEAM FOR A DECISION BEFORE PROCEEDING.

11. EACH ENTITY ENGAGED IN CONSTRUCTION ON THE PROJECT IS REQUIRED TO BE FAMILIAR WITH INDUSTRY STANDARDS APPLICABLE TO THAT ENTITY'S CONSTRUCTION ACTIVITY. COPIES OF APPLICABLE STANDARDS ARE NOT BOUND WITH THE CONTRACT DOCUMENTS, WHERE COMES OF STANDARDS ARE NEEDED FOR PERFORMANCE OF A REQUIRED CONSTRUCTION ACTIVITY, THE CONTRACTOR SHALL OBTAIN COPIES DIRECTLY FROM THE PUBLICATION SOURCE.

12. WHERE "AS SHOWN", "AS INDICATED", "AS DETAIL" OR WORDS OF SIMILAR IMPORT ARE USED, IT SHALL BE UNDERSTOOD THAT REFERENCE TO THE DRAWINGS ACCORDINGLY IS MADE UNLESS OTHERWISE STATED. WHERE "AS DIRECTED", "AS REQUIRED", "AS AUTHORIZED", "AS ACCEPTED", OR WORDS OF SIMILAR IMPORT ARE USED, IT SHALL BE UNDERSTOOD THAT THE DIRECTOR REQUIREMENT, REVIEW OR ACCEPTANCE OF THE DESIGN TEAM IS INTENDED, UNLESS OTHERWISE STATED.

13. AS USED IN THE CONTRACT DOCUMENTS, "PROVIDE" SHALL BE UNDERSTOOD TO MEAN "PROVIDE COMPLETE IN PLACE," THAT IS, "FURNISH AND INSTALL."

14. THE TERM "TURNKEY" IS USED TO MEAN "SUPPLY AND DELIVER TO THE PROJECT SITE, READY FOR UNLOADING, UNPACKING, ASSEMBLY, INSTALLATION, AND SIMILAR OPERATIONS."

15. THE TERM "INSTALL" IS TO BE USED TO DESCRIBE OPERATIONS AT THE PROJECT SITE INCLUDING THE ACTUAL UNLOADING, UNPACKING, ASSEMBLY, ERECTION, PLACING, ANCHORING, APPLYING, WORKING TO DIMENSION, FINISHING, CURING, PROTECTING, CLEANING, AND SIMILAR OPERATIONS.

16. THE TERM "REGULATIONS" INCLUDES LAWS, ORDINANCES, STATUTES, AND LAWFUL ORDERS ISSUED BY AUTHORITIES HAVING JURISDICTION, AS WELL AS RULES, CONVENTIONS, AND AGREEMENTS WITHIN THE CONSTRUCTION INDUSTRY THAT CONTROL PERFORMANCE OF THE WORK.

17. ON SHEETS FOR MULTIPLE FLOORS, FINISH CODES, KEYNOTES, GENERAL NOTES AND SHEET NOTES ARE FOR FLOOR LISTED UNLESS NOTED.

G-000 - BUILDING DEPARTMENT NOTES (NYC)

A. GENERAL NOTES

1. THE CONTRACTOR IS RESPONSIBLE FOR FILING AND SECURING ALL PERMITS.

2. THE CONTRACTOR IS TO BE PRESENT AT FINAL INSPECTION WITH THE BUILDING DEPARTMENT INSPECTOR.

3. PROPER 24 HOUR WRITTEN NOTICE SHALL BE GIVEN TO THE DEPARTMENT BEFORE COMMENCEMENT OF WORK PER SECTION BC 105.5.1. PROPER 24 HOUR WRITTEN NOTICE SHALL BE GIVEN TO SPECIAL INSPECTORS BEFORE COMMENCEMENT OF ANY WORK REQUIRING SPECIAL INSPECTION PER SECTION BC 104.1.1.1.

4. ALL CONSTRUCTION TO BE IN ACCORDANCE WITH THE RULES AND REGULATIONS OF THE NEW YORK CITY CONSTRUCTION CODE.

5. THE CONTRACTOR SHALL BECOME FAMILIAR WITH THE REQUIREMENTS OF CHAPTER 33, "SAFEGUARDS DURING CONSTRUCTION OR DEMOLITION" AND SHALL BE HELD RESPONSIBLE FOR SAFE MAINTENANCE UNTIL COMPLETION AND FINAL ACCEPTANCE OF THE WORK.

6. OCCUPANCY CLASSIFICATION PER SECTION BC 302.

7. THE BUILDING IS CLASSIFIED AS CONSTRUCTION CLASS IB, NON-COMBUSTIBLE CONSTRUCTION PER SECTION BC 402.

8. CORRIDORS AND PASSAGEWAYS SHALL COMPLY WITH SECTIONS BC 1002, BC 1014, AND BC 1020.

9. HEADROOM IN CORRIDORS AND IN EXIT PASSAGEWAYS SHALL COMPLY WITH SECTION BC 1003.2. HEADROOM IN EXIT STAIRS SHALL NOT BE LESS THAN 7'-0" CLEAR PER SECTION BC 1009.2.

10. PROJECT SHALL COMPLY WITH CHAPTER 31 OF THE NEW YORK CITY BUILDING CODE AND ANS A117.1-2009 REGARDING HANDICAPPED ACCESSIBILITY REQUIREMENTS, CHAPTER 4 OF THE NEW YORK CITY PLUMBING CODE FOR PLUMBING FIXTURE REQUIREMENTS, AND SECTION BC 701 OF THE NEW YORK CITY BUILDING CODE FOR EARTHQUAKE CRITERIA.

11. TO THE BEST OF OUR PROFESSIONAL KNOWLEDGE, BELIEF, AND JUDGEMENT, THESE DOCUMENTS CONFORM TO THE NEW YORK STATE ENERGY CONSERVATION CONSTRUCTION CODE.

12. TEN (10) DAYS PRIOR NOTICE SHALL BE GIVEN TO ADJOINING LOT OWNERS BY THE CONTRACTOR WHEN AFFECTED BY WORK PER SECTIONS BC 3304.3.2 AND BC 3306.3.2.

13. AN ACCURATE AND COMPLETE SURVEY MADE BY A LICENSED SURVEYOR AS PER ARTICLE 118, SECTION 28-118.4 SHALL BE SUBMITTED AFTER COMPLETION OF WORK WITH FIRST FLOOR ELEVATION, EXTERIOR GRADES AND CURB ELEVATIONS.

14. PERMIT FOR WORK BEYOND THE BUILDING LINE, SIDEWALK AND VAULTS WILL BE OBTAINED BY THE CONTRACTOR BEFORE CONSTRUCTION IS STARTED, AS PER THE DEPARTMENT OF HIGHWAYS.

15. BORING DIAGRAM WILL BE FILED BEFORE CONSTRUCTION AS PER SECTION BC 1802.402.

16. THE CONTRACTOR IS TO PROVIDE ALL SHORING, BRACING, BARRICADES, TEMPORARY FENCES, PARTITIONS, AND EXCAVATIONS TO ACCOMPLISH ALL OF THE WORK IN AN APPROVED MANNER PER SECTION BC 3304.4.

17. MATERIALS APPROVAL PROCEDURE: WHENEVER THE BUILDING CODE PRESCRIBES A METHOD OF TESTING, SUCH TEST SHALL BE MADE BY A TESTING SERVICE OR LABORATORY ACCEPTABLE TO THE COMMISSIONER AS PER ARTICLE 113, SECTION 28-113.3.

18. INSPECTIONS DURING PROGRESS OF WORK SHALL BE IN ACCORDANCE WITH ARTICLE 166, SECTION 28-116.2.3.

19. MASONRY TO COMPLY WITH CHAPTER 21 OF THE NEW YORK CITY BUILDING CODE.

20. CONCRETE BLOCK SHALL BE OF BOARD OF STANDARDS AND APPEALS APPROVED TYPE AND SHALL BE IN ACCORDANCE WITH SECTION BC 2103.1.

21. UNITS FOR OPENINGS IN MASONRY WALLS WIDER THAN 4'-0" SHALL BE FIRE PROTECTED AS PER SECTION BC 714.3 AND BC 714.4.

22. INTERIOR AND EXTERIOR STEEL COLUMNS, BEAMS, GIRDERS AND FLOOR CONSTRUCTION SHALL BE FIREPROOFED IN ACCORDANCE WITH NEW YORK CITY BUILDING CODE, TABLE 601, FIRE-RESISTANCE RATING REQUIREMENTS FOR BUILDING ELEMENTS.

23. HANDRAILS WILL BE PROVIDED ON BOTH SIDES OF REQUIRED STAIRS AND SHALL NOT ENCLOSE MORE THAN 4'-0" PER SECTION BC 1009.11.7.

24. GUARDS AND HANDRAILS SHALL COMPLY WITH SECTION BC 1009.11. DESIGN AND CONSTRUCTION TO WITHSTAND A 200 LB. LOAD APPLIED AT ANY POINT, DOWNWARD OR HORIZONTALLY OR THE SMALL TABULAR APPLICATION OF A LATERAL FORCE OF 40 P.S.F. AND A VERTICAL FORCE OF 50 P.S.F. BOTH APPLIED AT THE TOP OF THE RAILING. THE MORE STRINGENT REQUIREMENT GOVERNING.

25. STAIRS TO BE DESIGNED FOR 100 LB. LIVE LOAD AND CONSTRUCTED OF STEEL PANS WITH CONCRETE FILLED TREADS OR PRECAST CONCRETE TREADS, STEEL STRINGERS, RISER, TREADS AND PLATFORM MATERIALS SHALL CONFORM TO SECTIONS BC 1009.3 AND BC 1009.4.

26. ALL WOOD SHALL BE FIRE-RETARDANT-TREATED PER SECTION 2003.2 AND BE TESTED AS PER SECTION 700.3.

27. ALL FIRE-SAFETY AT THE PERIMETERS OF FLOORS AND AT PENETRATIONS IN FIRE-RATED SEPARATIONS SHALL BE SEMI-RIGID MINERAL FIBER RATED AT TWO(2) OR THREE(3) HOURS (AS REQUIRED).

28. FIRESTOPPING OF OPENINGS THROUGH FLOORS OR PARTITIONS SHALL PROVIDE A FIRE RESISTANCE RATING EQUIVALENT TO THAT OF THE FLOOR OR PARTITION ASSEMBLY.

29. ROOFING FIRE CLASSIFICATION TO BE AS PER SECTION BC 1505.

30. PARAPETS SHALL COMPLY WITH SECTIONS BC 704.11 AND BC 1509.8.

31. DOORS AND ASSEMBLIES SHALL HAVE FIRE-RESISTIVE RATINGS PER SECTION BC 1008.1.

32. ALL FIRE RATED DOORS SHALL BEAR A LABEL INDICATING SAME TYPE AS APPROVED BY BOARD OF STANDARDS AND APPEALS OF M.E.A. ALL OTHER DOORS SHALL BE OF NON-COMBUSTIBLE MATERIALS.

33. MINIMUM PASS THROUGH DOOR WIDTH SHALL BE 2'-0"

34. WHERE GLASS IS USED, GLASS SHALL COMPLY WITH SECTIONS BC 2403 AND BC 2404.

35. ALL EXTERIOR WINDOW FRAMES SHALL BE METAL.

36. ALL FINISHES SHALL COMPLY WITH CHAPTER 8 OF THE NEW YORK CITY BUILDING CODE.

37. SUSPENDED CEILING SYSTEMS SHALL CONSIST OF SUPPORTING RUNNERS, CARRYING CHANNELS AND A SUPPORTING GRID AND SHALL COMPLY WITH SECTION BC 803.9 FOR TYPE IB NON-COMBUSTIBLE CONSTRUCTION.

38. ALL ELEVATOR DOORS SHALL HAVE ELECTRIC INTERLOCKS IN ACCORDANCE WITH SECTION BC 3001.2.

39. ALL MECHANICAL EQUIPMENT TO BE M.E.A. APPROVED.

40. FIRE STANDPIPES SHALL BE PROVIDED IN ACCORDANCE WITH SECTION BC 905.

41. ALL MATERIALS AND SERVICE EQUIPMENT WILL COMPLY WITH ARTICLE 113.

42. THE ENTIRE BUILDING SHALL BE PROVIDED WITH AN APPROVED SPRINKLER SYSTEM.

43. ALL TOILETS SHALL BE MECHANICALLY VENTILATED IN ACCORDANCE WITH SECTION BC 1203.4.2.1.

B. CONTROLLED INSPECTIONS

THE FOLLOWING MATERIALS, OPERATIONS AND EQUIPMENT RELATED TO THE WORK DESCRIBED IN THESE DOCUMENTS ARE SUBJECT TO CONTROLLED INSPECTIONS AS DESCRIBED BY THE NEW YORK CITY BUILDING CODE SECTION BC 1704:

FLOOD ZONE COMPLIANCE (BC 1703)
FIRE ALARM TESTING (BC 901, BC 1704.13)
PHOTOLUMINESCENT EXIT PATH MARKINGS (BC 1008.11)
EMERGENCY POWER SOURCE GENERATION (BC 1704.11, BC 2202)
STRUCTURAL STEEL - WELDING (BC 1704.3)
STRUCTURAL STEEL - ERECTION AND LIFTING (BC 1704.3.2, BC 1704.3.3)
STRUCTURAL CORROSION-RESISTANT STEEL (BC 1704.3.4)
CONCRETE - CAST-IN-PLACE (BC 1704.4)
CONCRETE - PRECAST (BC 1704.4)
MASONRY (BC 1704.5)
WOOD - OFF-SITE FABRICATION OF STRUCTURAL ELEMENTS (BC 1704.6)
WOOD - INSTALLATION OF HIGH-LOAD BRACINGS (BC 1704.1)
WOOD - INSTALLATION OF METAL PLATE CONNECTED TRUSSES (BC 1704.6.3)
WOOD - INSTALLATION OF PREFABRICATED JOISTS (BC 1704.4.4)
SOILS - SITE PREPARATION (BC 1704.1.7)
SOILS - FILL PLACEMENT & IN-PLACE DENSITY (BC 1704.1.2, BC 1704.1.3)
SOILS - INVESTIGATIONS (BORING/TEST PITS) (BC 1704.1.4)
PILE FOUNDATIONS & DRILLED PIER INSTALLATION (BC 1704.8)
UNDERPINNING (BC 1704.9)
WALL PANELS, OVERHANGS AND VENEERS (BC 1704.10)
SPRAYED FIRE-RESISTANT MATERIALS (BC 1704.11)
PILE FOUNDATIONS & DRILLED PIER INSTALLATION (BC 1704.8)
UNDERPINNING (BC 1704.9)
WALL PANELS, OVERHANGS AND VENEERS (BC 1704.10)
SMOKE CONTROL SYSTEMS (BC 1704.14)
MECHANICAL SYSTEMS (BC 1704.15)
FUEL OIL STORAGE AND FUEL OIL PIPING SYSTEMS (BC 1704.16)
HIGH-PRESSURE STEAM PIPING (WELDING) (BC 1704.17)
FUEL GAS PIPING (WELDING) (BC 1704.18)
STRUCTURAL SAFETY - STRUCTURAL STABILITY (BC 1704.19)
MECHANICAL DEMOLITION (BC 1704.19, BC 3304.4)
FUEL GAS PIPING (WELDING) (BC 1704.19, BC 3304.4.1)
SOIL PERCOLATION TEST - DRYWELL (BC 1704.20.1)
SOIL PERCOLATION TEST - SEPTIC (BC 1704.20.1)
SEPTIC SYSTEM INSTALLATION (BC 1704.20)
SPRINKLER SYSTEMS (BC 1704.21)
STANDPIPE SYSTEMS (BC 1704.22)
HEATING SYSTEMS (BC 1704.23)
CHIMNEYS (BC 1704.24)
FIRESTOP, DRAFTSTOP AND FIREBLOCK SYSTEMS (BC 1704.25)
ALUMINUM WELDING (BC 1704.26)
SEGMENTAL INSULATION SYSTEMS (BC 1704.28)
CONCRETE TEST CYLINDERS (BC 1905.4)
CONCRETE DESIGN MIX (BC 1905.3)

C. RESPONSIBILITY OF THE OWNER'S AGENT PERFORMING CONTROLLED INSPECTION OF THE STABILITY AND INTEGRITY OF THE EXISTING STRUCTURE DURING CONSTRUCTION OPERATIONS

1. THE NEW YORK STATE REGISTERED ARCHITECT OR PROFESSIONAL ENGINEER RETAINED BY THE OWNER TO PERFORM THE CONTROLLED INSPECTION OF THE STABILITY AND INTEGRITY OF THE EXISTING STRUCTURE SHALL PERFORM THIS INSPECTION SERVICE IN STRICT COMPLIANCE WITH THE PROCEDURES AND REQUIREMENTS DEFINED BY THE NEW YORK CITY DEPARTMENT OF BUILDINGS IN THE DOCUMENT "PROHIBITION OF THE RULES RELATING TO THE CONTROLLED INSPECTION OF THE STABILITY AND INTEGRITY OF EXISTING STRUCTURES DURING CONSTRUCTION OPERATIONS," DATED AUGUST 26, 1992. IT SHALL BE THE RESPONSIBILITY OF THE OWNER'S CONTROLLED INSPECTING AGENT TO PREPARE DETAIL DRAWINGS AND ASSOCIATED CALCULATIONS REPRESENTING ALL SHORING, BRACING OR OTHER TEMPORARY CONSTRUCTION WHICH MAY BE REQUIRED TO MAINTAIN THE STRUCTURAL STABILITY AND INTEGRITY OF THE EXISTING CONSTRUCTION DURING THE COURSE OF THE WORK DESCRIBED IN THESE DOCUMENTS.

2. ALL DRAWINGS AND CALCULATIONS PREPARED BY THE OWNER'S CONTROLLED INSPECTING AGENT SHALL BEAR AN ORIGINAL SIGNATURE AND SEAL INDICATING THE INSPECTOR'S NEW YORK STATE REGISTRATION. DUPLICATE COPIES OF ALL DRAWINGS AND CALCULATIONS SHALL BE FORWARDED TO THE OWNER PRIOR TO COMMENCING ANY OF THE TEMPORARY WORK REPRESENTED IN THOSE DOCUMENTS. THE OWNER WILL, IN TURN, TRANSMIT THOSE DOCUMENTS TO THE STRUCTURAL ENGINEER OF RECORD FOR HIS REVIEW.

3. THE STRUCTURAL ENGINEER OF RECORD WILL REVIEW THE DOCUMENTS ONLY FOR HOW THE SHORING, BRACING AND OTHER TEMPORARY CONSTRUCTION INTERFERES WITH THE EXISTING STRUCTURE. THE STRUCTURAL ENGINEER AT RECORD REVIEW SHALL NOT BE CONSIDERED AS COMPLETE CHECK, NOR RELIEVE THE OWNER'S CONTROLLED INSPECTING AGENT FROM RESPONSIBILITY FOR ERRORS OF ANY SORT NOR FROM THE NECESSITY OF FURNISHING ANY ADDITIONAL DETAILS OR CALCULATIONS WHICH MAY HAVE BEEN OMITTED OR REQUIRED BY LOCAL AUTHORITY HAVING JURISDICTION.

D. BUILDING DEPARTMENT AND ZONING DATA

ZONING DISTRICT: HY (SPECIAL HUDSON YARDS DISTRICT)
ZONING MAP: MANHATTAN BOROUGH- BD 1A
CONSTRUCTION TYPE: B (BUSINESS)
FLOOR AREA ABOVE GRADE: 179,837 SF GROSS FLOOR AREA ABOVE GRADE
ADDRESS: 375 NINTH AVENUE, NEW YORK, NY 10001
FIRE RESISTIVE REQUIREMENTS: CLASS 1A
COLUMNS, GIRDERS, TRUSSES: 3HR
FLOOR CONSTRUCTION: 2HR
STAIRS, ELEVATORS, SHAFTS: 2HR
HORIZONTAL EXITS: 2HR

E. CON EDISON VAULT NOTES:

THE CONTRACTOR SHALL NOTIFY CON EDISON OF ALL PLANNED CONSTRUCTION ACTIVITIES & MILESTONES, AND SHALL PROVIDE CON EDISON REPRESENTATIVES AND INSPECTORS WITH TIMELY, SATISFACTORY, AND ACCEPTABLE ACCESS TO ALL WORK REQUIRING CON EDISON INSPECTION AND APPROVAL.

ALL SUBMITTALS RELATIVE TO CON EDISON WORK SHALL BE SUBJECT TO REVIEW AND APPROVAL BY CON EDISON.



375 Ninth Avenue, New York, NY 10001

Client

Brookfield

Brookfield Place
250 Vesey Street, 15th Floor, New York, NY 10021

Architecture/Structural Engineering

SOM

Skidmore, Owings & Merrill LLP

14 Wall Street, New York, NY 10005

Civil Engineering

Philip Habib & Associates

102 Madison Avenue #11, New York, NY 10016

MEP Engineering

Jaros Baum & Bolles

80 Pine Street, New York, NY 10005

Vertical Transportation

Edgett Williams Consulting Group, Inc.

102 East Bliffedale Ave, Suite 1, Mill Valley, California 94041

Sustainable Design

Viridian Energy & Environmental

50 Washington Street, Newark, CT 06854

Geotechnical Engineering

Mueser Rutledge Consulting Engineers

14 Penn Plaza, 225 W. 34th Street, New York, NY 10122

Landscape Consultant

Field Operations

475 10th Avenue, New York, NY 10018

Security Consultant

Ducibella, Vantor & Santoro

250 State Street #F1, North Haven, CT 06473

Blast Consultant

Weidinger Associates, Inc.

40 Wall Street, New York, NY 10005

Acoustical Consultant

Cerami & Associates

404 Fifth Avenue #8, New York, NY 10018

Vibration Consultant

Wilson, Uhrig & Associates, Inc.

65 Broadway, Suite 401, New York, NY 10006

Code Consultant

Code Consultants Professional Engineers PC

215 West 40th Street, 15th Floor, New York, NY 10018

Facade Maintenance Consultant

Entek Engineering LLC

166 Ames Street, Hackensack, NJ 07601

Wind Tunnel Consultant

Rowan Williams Davies & Irwin Inc.

650 Woodlawn Road West, Guelph Ontario, Canada N1K 1B8

Key Plan:

Seal & Signature:

Warning: It is a violation of the New York State Architecture Law, §16-509, for any person, unless they are acting under the direction of a Licensed Architect, to alter this item in any way.

PROJECT NO. 201501

DATE: 20 JUN 2014

SCALE: 1/15

FILE NO: G-005

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ANNOTATIONS

#	Number	FLH	Flushing	PSF	Pounds per Square Foot
&	And	FLMT	Flush Mounted	PSI	Pounds per Square Inch
/	Angle	FLR	Floor(s)	PT	Particled
@	At	FLS	Floor Scales	PTN	Partition
		FLUR	Fluorescent	PVC	Polyvinyl Chloride
AC	Air Conditioning	FLURC	Fluorescent	PD	Painting
AV	Audio Visual	FP	Fingertopping	PWR	Power
ACST	Acoustical	FPM	Feet per Minute		
AD	Area Drain	FPSIC	Fireproofing Self-Closing	QTY	Quantity
ADDL	Additional	FR	Fire Retardant / Rating / Resistance		
ADJ	Adjust	FRM	Frame		
ADR	Access Door	FRWY	Fire Resistant Treated Wood	R	River
AF	Access Floor	FS	Full Size	RA	Return Air
AJR	Above Finished Floor	FSE	Food Service Equipment	RAD	Radius
AGGR	Aggregate	FSP	Fire Stopping	RB	Reinforced Base
AL	Aluminum	FSS	Fire Stopping	RC	Reinforced Concrete
AND	And	FT	Foot (Foot)	RD	Roof Drain
AP	Access Panel	FTG	Footing	RECP	Receptacle
APPROX	Approximately	FWP	Fabric Wrapped Panel	RECT	Rectangle
APT	Apartment			REF	Reference
ARC	Architectural Concrete	G	Gas	REFR	Refrigerator
ARCH	Architectural	GA	Gauge	REG	Register
ASPH	Asphalt	GAL	Gallon(s)	REIN	Reinforced (ing. mnt)
AUTO	Automatic	GALV	Galvanized	REQD	Required
AUX	Auxiliary	GFRG	Glass Fiber Reinforced Concrete	REV	Revised / Revision
AVG	Average	GRG	Gypsum Reinforced Gypsum	RF	Resilient Flooring
		GI	Galvanized Iron	RFA	Roofing Accessories
B	Bottom of	GL	Glass	RH	Right Hand
BD	Board	GL BLK	Glass Block	RM	Room
BEV	Berried	GRD	Ground	RNM	Room Mark
BG	Bumper Guard	GPH	Gallons per Hour	RND	Round(s)
BLDG	Building	GPM	Gallons per Minute	RO	Rough Opening
BLK	Block	GRD	Grade	ROW	Right of Way
BM	Beam	GRL	Grille	RPM	Revolutions per Minute
BMC	Benchmark	GWB	Gypsum Wallboard	RS	Railing System
BMD	Building Maintenance Unit				
BOC	Bottom of Curb	HB	Hose Bib	SA	Supply Air
BR	Bedroom	HD	Head	SAN	Sanitary
BRK	Brick	HDW	Hardware	SAN	Splash Block
BRZ	Brace	HEX	Hexagon(s)	S8	Schedule
BS	Brass	HM	Hollow Metal	SCHED	Schedule
BSMT	Basement	HMDRL	Handrail	SE	Section
BTU	British Thermal Unit(s)	HO	Hold Open	SECT	Section
		HORIZ	Horizontal	SIR	Shower
CAP	Capacity	HPT	High Point	SMT	Sheet
CB	Catch Basin	HR	Hour(s) (Fire Resistance Rating)	SHING	Shuathing
CCTV	Closed Circuit Television	HT	Height	SM	Smiler
CH	Cable Feed Per Minute	HVAC	Heating Ventilation Air Conditioning	SLDG	Slab / Sliding
CG	Corner Guard	HWY	Highway	SMR	Sheet Metal Roofing
				SPC	Synthetic Polymer Countertop
CI	Cast Iron	ID	Inside Diameter	SPEC	Specification(s)
CJ	Control Joint	INCL	Included / Inclusive / Including	SQ	Square
CL	Center Line	INFO	Information	SQ FT	Square Foot / Feet
CLC HT	Celling Height	INS	Insulation / Insulated	SST	Stainless Steel
CLO	Closet	INT	Interior	ST	Stone
CLD OPNG	Clear Opening	JC	Joint Closet	STC	Sound Transmission Class
CML	Concrete-Masonry Unit(s)	JF	Joint Filler	STD	Standard
CO	Cleanout	JG	Joint Gasket	STL	Steel
COL	Column	JT	Joint	STOR	Storage
CONF	Conference	KD	Knockdown	STRUCT	Structural / Structural
CONN	Connection	KIT	Kitchen	SURF MTD	Surface Mounted
CONCTN	Construction	KLO	Knockout	SUSP	Suspended / Suspension
CONT	Continuous / Continue	KPL	Kidplate	SWBD	Switchboard
CONV	Convector			SYMM	Symmetrical
CORR	Corridor	T	Tread		
OPI	Carpet(s)	LAB	Laboratory	T&G	Tongue and Groove
CSK	Countersink / Countersunk	LAM	Laminated	TY	Ty
CSWK	Coverwork	LAV	Lavatory	TA	Tank Accessory(ies)
CT	Ceramic Tile	LBS	Pounds	TC	Traffic Coating
CTR	Centered	LD	Linear Diffuser	TD	Trench Drain
CU	Cubic	LH	Left Hand	TEL	Telephone
CW	Cold Water	LIN	Linear	TEMP	Temperature
		LONG	Longitudinal	TER	Terrazzo
DB	Ductile	LPT	Low Point	THK	Thickness
DBL	Double	LRF	Living Room	THRES	Threshold
DD	Dock Drain	LTG	Lighting	TOC	Top of Curb
DEG	Degrees	LVE	Lowest	TOPO	Topography Map
DEPT	Department	MACH	Machine	TRANS	Transom
DET	Detail(s)	MAINT	Maintenance / Maintenance	TV	Television
DF	Drinking Fountain	MATL	Material	TPP	Typical
DH	Double Hung	MAX	Maximum	UC	Undercut
DA	Diameter	MB	Metal Base	UNFIN	Unfinished
DAG	Diagram	MECH	Mechanical	UNO	Unless Noted Otherwise
DFF	Diffuser(s)	MEU	Medium	UPS	Uninterrupted Power Supply
DM	Dimension(s)	MEZZ	Mezzanine		
DMP	Dampening	MFR	Manufacturer	VAC	Vacuum
DMPR	Damper	MH	Metric	VERT	Vertical
DN	Down	MN	Minimum	VIB	Vibration
DP	Display Panel	MISC	Miscellaneous	VF	Verify in Field
DR	Dining Room	ML	Metal Lath	VNR	Vanner
DRF	Drainage	ML WK	Metal Lath	VOL	Volume
DWG	Drawings	MDG	Molding		
DWTR	Dumbwaiter	MD	Masonry Opening	W	With
		MTD	Metal Panel	WD	Without
EA	Each	MTL	Metal	WB	Wood Base
EC	Exposed Construction	MUL	Mulch	WCV	Wall Covering
EFS	Exterior Insulated Finish System	WDF	Wood Door Frame	WDO	Wood
EJ	Expansion Joint	NA	Not Applicable	WH	Wall Hydrant
EL	Elevation (Grade)	NC	Noise Criteria	WI	Wrought Iron
EAST	East	NC	Not in Contact	WP	Work Point
ELEC	Electrical	ND	Number	WPS	Waterspreading System
ELEC CL	Electrical Closet	NOM	Nominal	WR	Weather Resistant
ELEV	Elevation	NWC	Noise Reduction Coefficient	WRB	Weatherstripping
ELEV	Elevation (Ramp)	NYS	Not to Scale	WT	Weight
EM	Entrance Mat	NWP	Network Protector	WTR	Window Treatment
EMR	Emergency			WW	Wood Window
ENCL	Enclosure / Enclosed	OA	Outside Air	WWF	Window Frame
ENTR	Entrance	OC	On Center		
EOS	Edge of Slope	OD	Outside Diameter / Dimension		
EQ	Equal	OF	Outside Face		
EQUIP	Equipment	OFD	Overflow Drain		
ESCAL	Escalator	OFF	Office		
EW	Each Way	OH OR	Overhead Ceiling Door		
EWG	Electrical Water Cooler	OPH	Opposite Hand		
EXH	Exhaust	OPG	Opening		
EXST	Existing	OPR	Operating / Operate		
EXPV	Expansion	OSD	Overhead Roll Chain		
EXT	Exterior	OSHA	Occupational Safety and Health Administration		
		OZ	Ounce		
F	Farewell	PA	Public Address		
FA	Fire Alarm	PAR	Parallel		
FABP	Fire Alarm Annunciator Panel	PART	Partial		
FAB	Fabric	PAN	Panels		
FAI	Fresh Air Intake	PB	Partial Board		
FD	Flow Drain	PCC	Precast Concrete		
FDMPR	Fire Damper	PERF	Perforated		
FDTN	Foundation	PERP	Perpendicular		
FE	Fire Extinguisher	PL	Plastic Laminated		
FEC	Fire Extinguisher Cabinet	PLA	Plaster		
FEMA	Federal Emergency Management Agency	PLBG	Plumbing		
FIN	Finish	PLYWD	Plywood		
FHC	Fire Hose Cabinet	PNEU	Pneumatic		
FHR	Fire Hose Rack	POL	Polished		
FIN	Finished	PR	Pipe		
FIN FL	Finished Floor	PREFAB	Prefabricated		
FIN GR	Finished Grade	PROJ	Project(s)		
FLEX	Flexible	PROP	Property		

G-000 - SYMBOLS LEGEND

	BUILDING ELEVATION REFERENCE		WALL TYPE REFERENCE		SINGLE POLE ELECTRICAL SWITCH
	INTERIOR ELEVATION REFERENCE		DOOR REFERENCE		TWO POLE ELECTRICAL SWITCH
	SECTION REFERENCE		ROOM TARGET REFERENCE		THREE POLE ELECTRICAL SWITCH
	DETAIL REFERENCE		ELEVATOR REFERENCE		SINGLE ELECTRICAL RECEPTACLE
	DETAIL CALLOUT REFERENCE		WINDOW REFERENCE		DUPLEX ELECTRICAL RECEPTACLE
	COLUMN CENTERLINE REFERENCE		CURTAIN PANEL REFERENCE		QUAD ELECTRICAL RECEPTACLE
	REVISION		MATERIAL REFERENCE		220V ELECTRICAL RECEPTACLE
	FINISH FLOOR LEVEL REFERENCE		LIGHT FIXTURE REFERENCE		DUPLEX ELECTRICAL RECEPTACLE WITH GFI PROTECTION
	FLOOR SLAB LEVEL REFERENCE		CASEWORK REFERENCE		WALL MOUNTED TELEPHONE RECEPTACLE
	SPOT ELEVATION (TOP OF FINISHED FLOOR)		PARKING REFERENCE		WALL MOUNTED DATA RECEPTACLE
	SPOT ELEVATION (TOP OF SLAB)		1 HR FIRE RATING		WALL MOUNTED TELEPHONE & DATA RECEPTACLE
	SPOT COORDINATE		2 HR FIRE RATING		SINGLE FLOOR MOUNTED ELECTRICAL RECEPTACLE
	WORK POINT		3 HR FIRE RATING		DUPLEX FLOOR MOUNTED ELECTRICAL RECEPTACLE
	KEYNOTE REFERENCE		4 HR FIRE RATING		GFI PROTECTED ELECTRICAL RECEPTACLE
	NORTH ARROW		SMOKE RATING		FLOOR DRAIN
	CHANGE IN SLAB		LINE ABOVE		ROOF DRAIN
	ALIGN SYMBOL		LINE BELOW / HIDDEN		ROOF DRAIN WITH OVERFLOW
	MATCHLINE REFERENCE		DIRECTION OF GRAIN		FACE MOUNTED ROOF DRAIN
	PROPERTY LINE		ACCESS PANEL		CEILING MOUNTED EXIT SIGN
	NOT IN SCOPE / NOT IN CONTRACT		SUPPLY DIFFUSER		CEILING MOUNTED DIRECTIONAL EXIT SIGN
	DRAWING TITLE		RETURN DIFFUSER		CEILING MOUNTED DIRECTIONAL EXIT SIGN (TWO SIDED)

G-000 - MATERIALS LEGEND

	EARTH / SOIL		GYPSUM BOARD
	CONCRETE		BRICK
	CONCRETE MASONRY UNIT		STONE
	CERAMIC / QUARRY TILE		ACOUSTIC CEILING TILE
	STEEL		ALUMINUM
	PARTICLE BOARD / PLYWOOD / MEDIUM DENSITY FIBERBOARD		RIGID INSULATION / FIRE SAFING
	SEMI-RIGID INSULATION		GRAVEL / TERRAZZO
	CONTINUOUS BLOCKING / FURRING / SHIM		NON-CONTINUOUS BLOCKING / FURRING / SHIM
	BATT INSULATION		FINISHED WOOD
	SAND / MORTAR / GROUT / PLASTER / SPRAY-ON FIREPROOFING		ACOUSTICAL INSULATION
	EXPANSION JOINT		METAL GRATING
	WATERPROOFING MEMBRANE		AIR / VAPOR BARRIER

MANHATTAN WEST: NORTH TOWER

375 Ninth Avenue, New York, NY 10001

Client

Brookfield

250 Vesey Street, 15th Floor, New York, NY 10021

Architecture/Structural Engineering

SOM

Skidmore, Owings & Merrill LLP

14 Wall Street, New York, NY 10005

Civil Engineering

Philip Habbis & Associates

102 Madison Avenue #11, New York, NY 10016

MEP Engineering

Jaros Baum & Boles

80 Pine Street, New York, NY 10005

Vertical Transportation

Edgett Williams Consulting Group, Inc.

102 East Bluffside Ave., Suite 1, Mill Valley, California 94941

Sustainable Design

Viridian Energy & Environmental

50 Washington Street, Newark, CT 06854

Geotechnical Engineering

Mueser Rutledge Consulting Engineers

14 Penn Plaza, 25th W., 34th Street, New York, NY 10122

Landscape Consultant

Field Operations

475 10th Avenue, New York, NY 10018

Security Consultant

Ducibella, Venter & Santoro

250 State Street #F1, North Haven, CT 06473

Blast Consultant

Weidinger Associates, Inc.

40 Wall Street, New York, NY 10005

Acoustical Consultant

Cerami & Associates

404 Fifth Avenue #8, New York, NY 10018

Vibration Consultant

Wilson, Uhrig & Associates, Inc.

65 Broadway, Suite 401, New York, NY 10006

Code Consultant

Code Consultants Professional Engineers PC

215 West 40th Street, 15th Floor, New York, NY 10018

Facade Maintenance Consultant

Entek Engineering LLC

166 Ames Street, Hackensack, NJ 07601

Wind Tunnel Consultant

Rowan Williams Davies & Irwin Inc.

680 Woodlawn Road West, Guelph Ontario, Canada N1K 1B8

Key Plan:

Warning: It is a violation of the New York State Architecture Law, (E.O. 565) for any person, unless they are acting under the direction of a Licensed Architect, to alter this item in any way.

Seal & Signature:

PREPARED AND SEALED BY THE STATE OF NEW YORK

Project No.: 207150

Date: 20 JUN 2014

Scale: NTS

File No: G-006

B-SCAN Sheet No.: G-006.00

Sheet No.: G-006

Page No.: 4 OF 87

G-000 - MOUNTING HEIGHTS

6/19/2014 12:22:20 AM



Client

Brookfield

Brookfield Place
250 Vesey Street, 15th Floor, New York, NY 10021

Architecture/Structural Engineering

SOM
Skidmore, Owings & Merrill LLP
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Civil Engineering
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102 Madison Avenue #11, New York, NY 10016

MEP Engineering
Jaros Baum & Bolles
80 Pine Street, New York, NY 10005

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102 East Blithedale Ave, Suite 1, Mill Valley, California 94041

Sustainable Design
Viridian Energy & Environmental
50 Washington Street, Newark, CT 06854

Geotechnical Engineering
Mueser Rutledge Consulting Engineers
14 Penn Plaza, 225 W. 34th Street, New York, NY 10122

Landscape Consultant
Field Operations
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Ducibella, Vantor & Santoro
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40 Wall Street, New York, NY 10005

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650 Woodlawn Road West, Guelph Ontario, Canada N1K 1B8


**PRELIMINARY
NOT FOR CONSTRUCTION**

SIGNAGE

HANDICAPPED ACCESS NOTES:


1. DOORS SHALL BE CAPABLE OF OPENING AT LEAST 90 DEGREES AND SHALL BE SO MOUNTED THAT CLEAR WIDTH OF DOORWAY IS NOT AT LEAST 32 INCHES.
2. LATCHING AND LOCKING DOORS THAT ARE HAND ACTIVATED AND WHICH ARE IN A PATH OF TRAVEL SHALL BE OPERABLE WITH A SINGLE EFFORT BY LEVER TYPE HARDWARE.
3. MAXIMUM EFFORT TO OPERATE FIRE DOORS SHALL BE 15 LBS. AT OTHER INTERIOR DOORS MAXIMUM EFFORT TO OPERATE SHALL BE 5 LBS.
4. FLOOR, RAMP, AND TREAD SURFACES SHALL BE SLIP RESISTANT.
5. EMERGENCY WARNING SYSTEM SHALL ACTIVATE A MEANS OF WARNING THE HEARING IMPAIRED PLASHING VISUAL WARNING SHALL HAVE A FREQUENCY OF NOT MORE THAN 60 FLASHES PER MINUTE.
6. THRESHOLDS SHALL NOT BE MORE THAN 1/2" HIGHER THAN ADJACENT FLOOR OR LANDING. LEVEL CHANGE BETWEEN 1/4" AND 1/2" SHALL BE BEVELED WITH SLOPE NO GREATER THAN 1:2.
7. CENTER OF ALARM PULL BOXES SHALL BE 4'-0" A.F.F.

NOTE:
AT TOILET ROOMS WITH FINISHED DIMENSIONS LESS THAN 5'-5" X 7'-4", Y=48" Y=54" MINIMUM SHALL BE PROVIDED IF THE DOOR HAS A CLOSER.

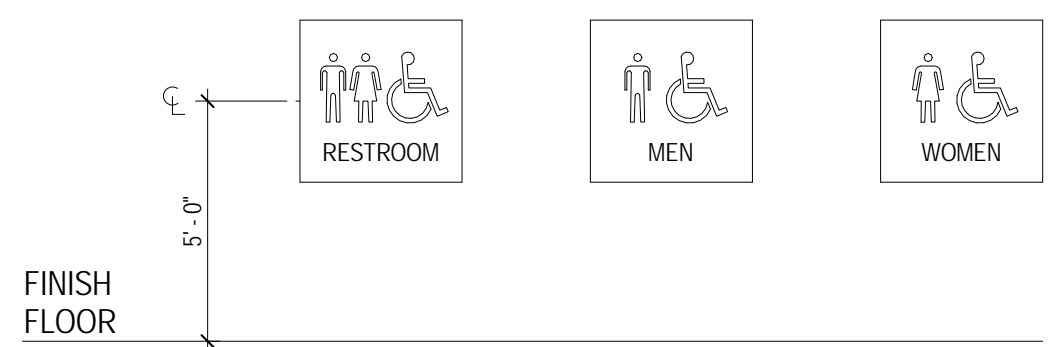


- NOTES:**
1. ADD TO LATCH SIDE OF DOOR
 2. 6" PICTOGRAM WITH VERBAL DESCRIPTION
 3. CENTER 48" FROM FLOOR
 4. LETTERS AND NUMERALS ARE RAISED 1/32" SANS-SERIF UPPERCASE CHARACTERS
 5. BLACK COPY ON A BRUSHED ALUM. BACKGROUND


MANEUVERING & PROTRUDING OBJECTS

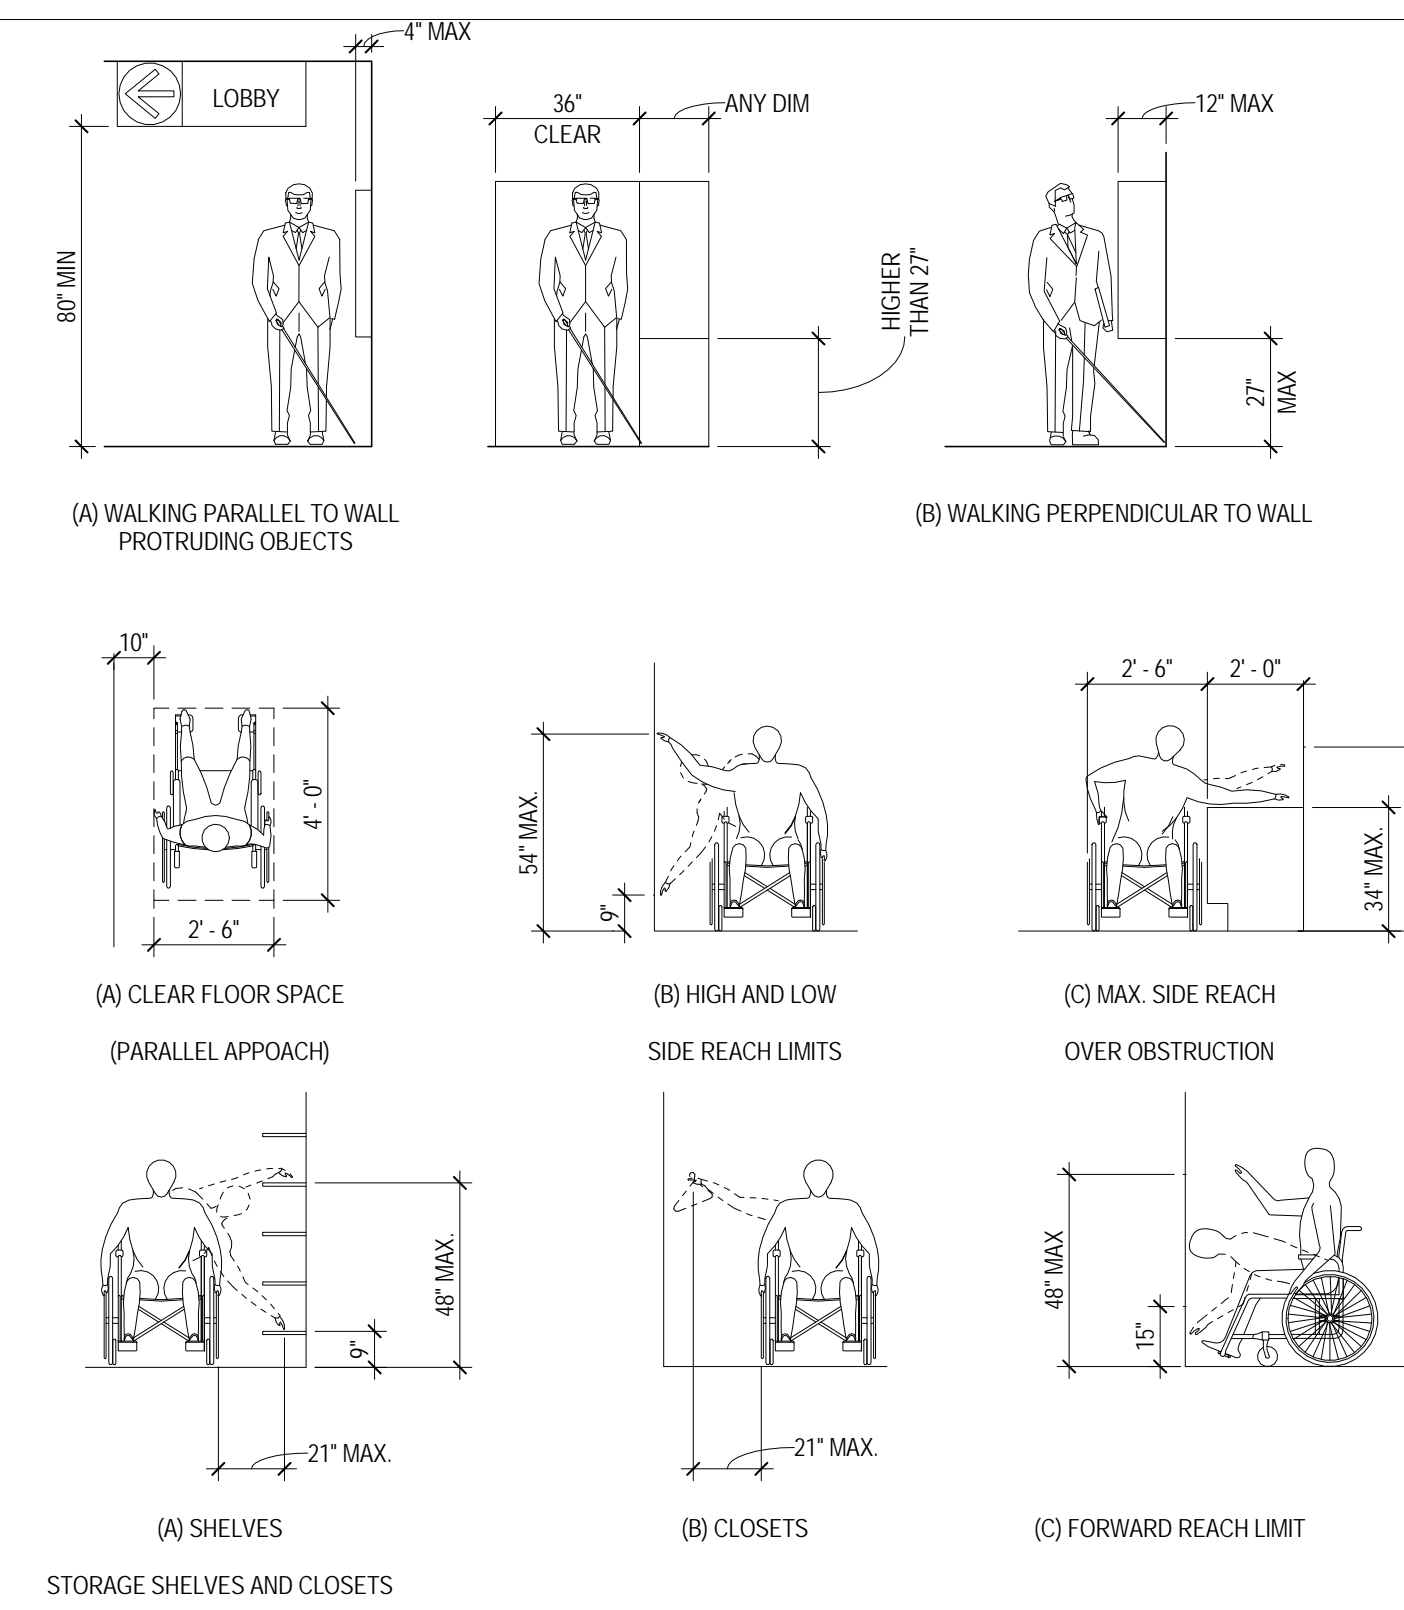


GRAB BARS

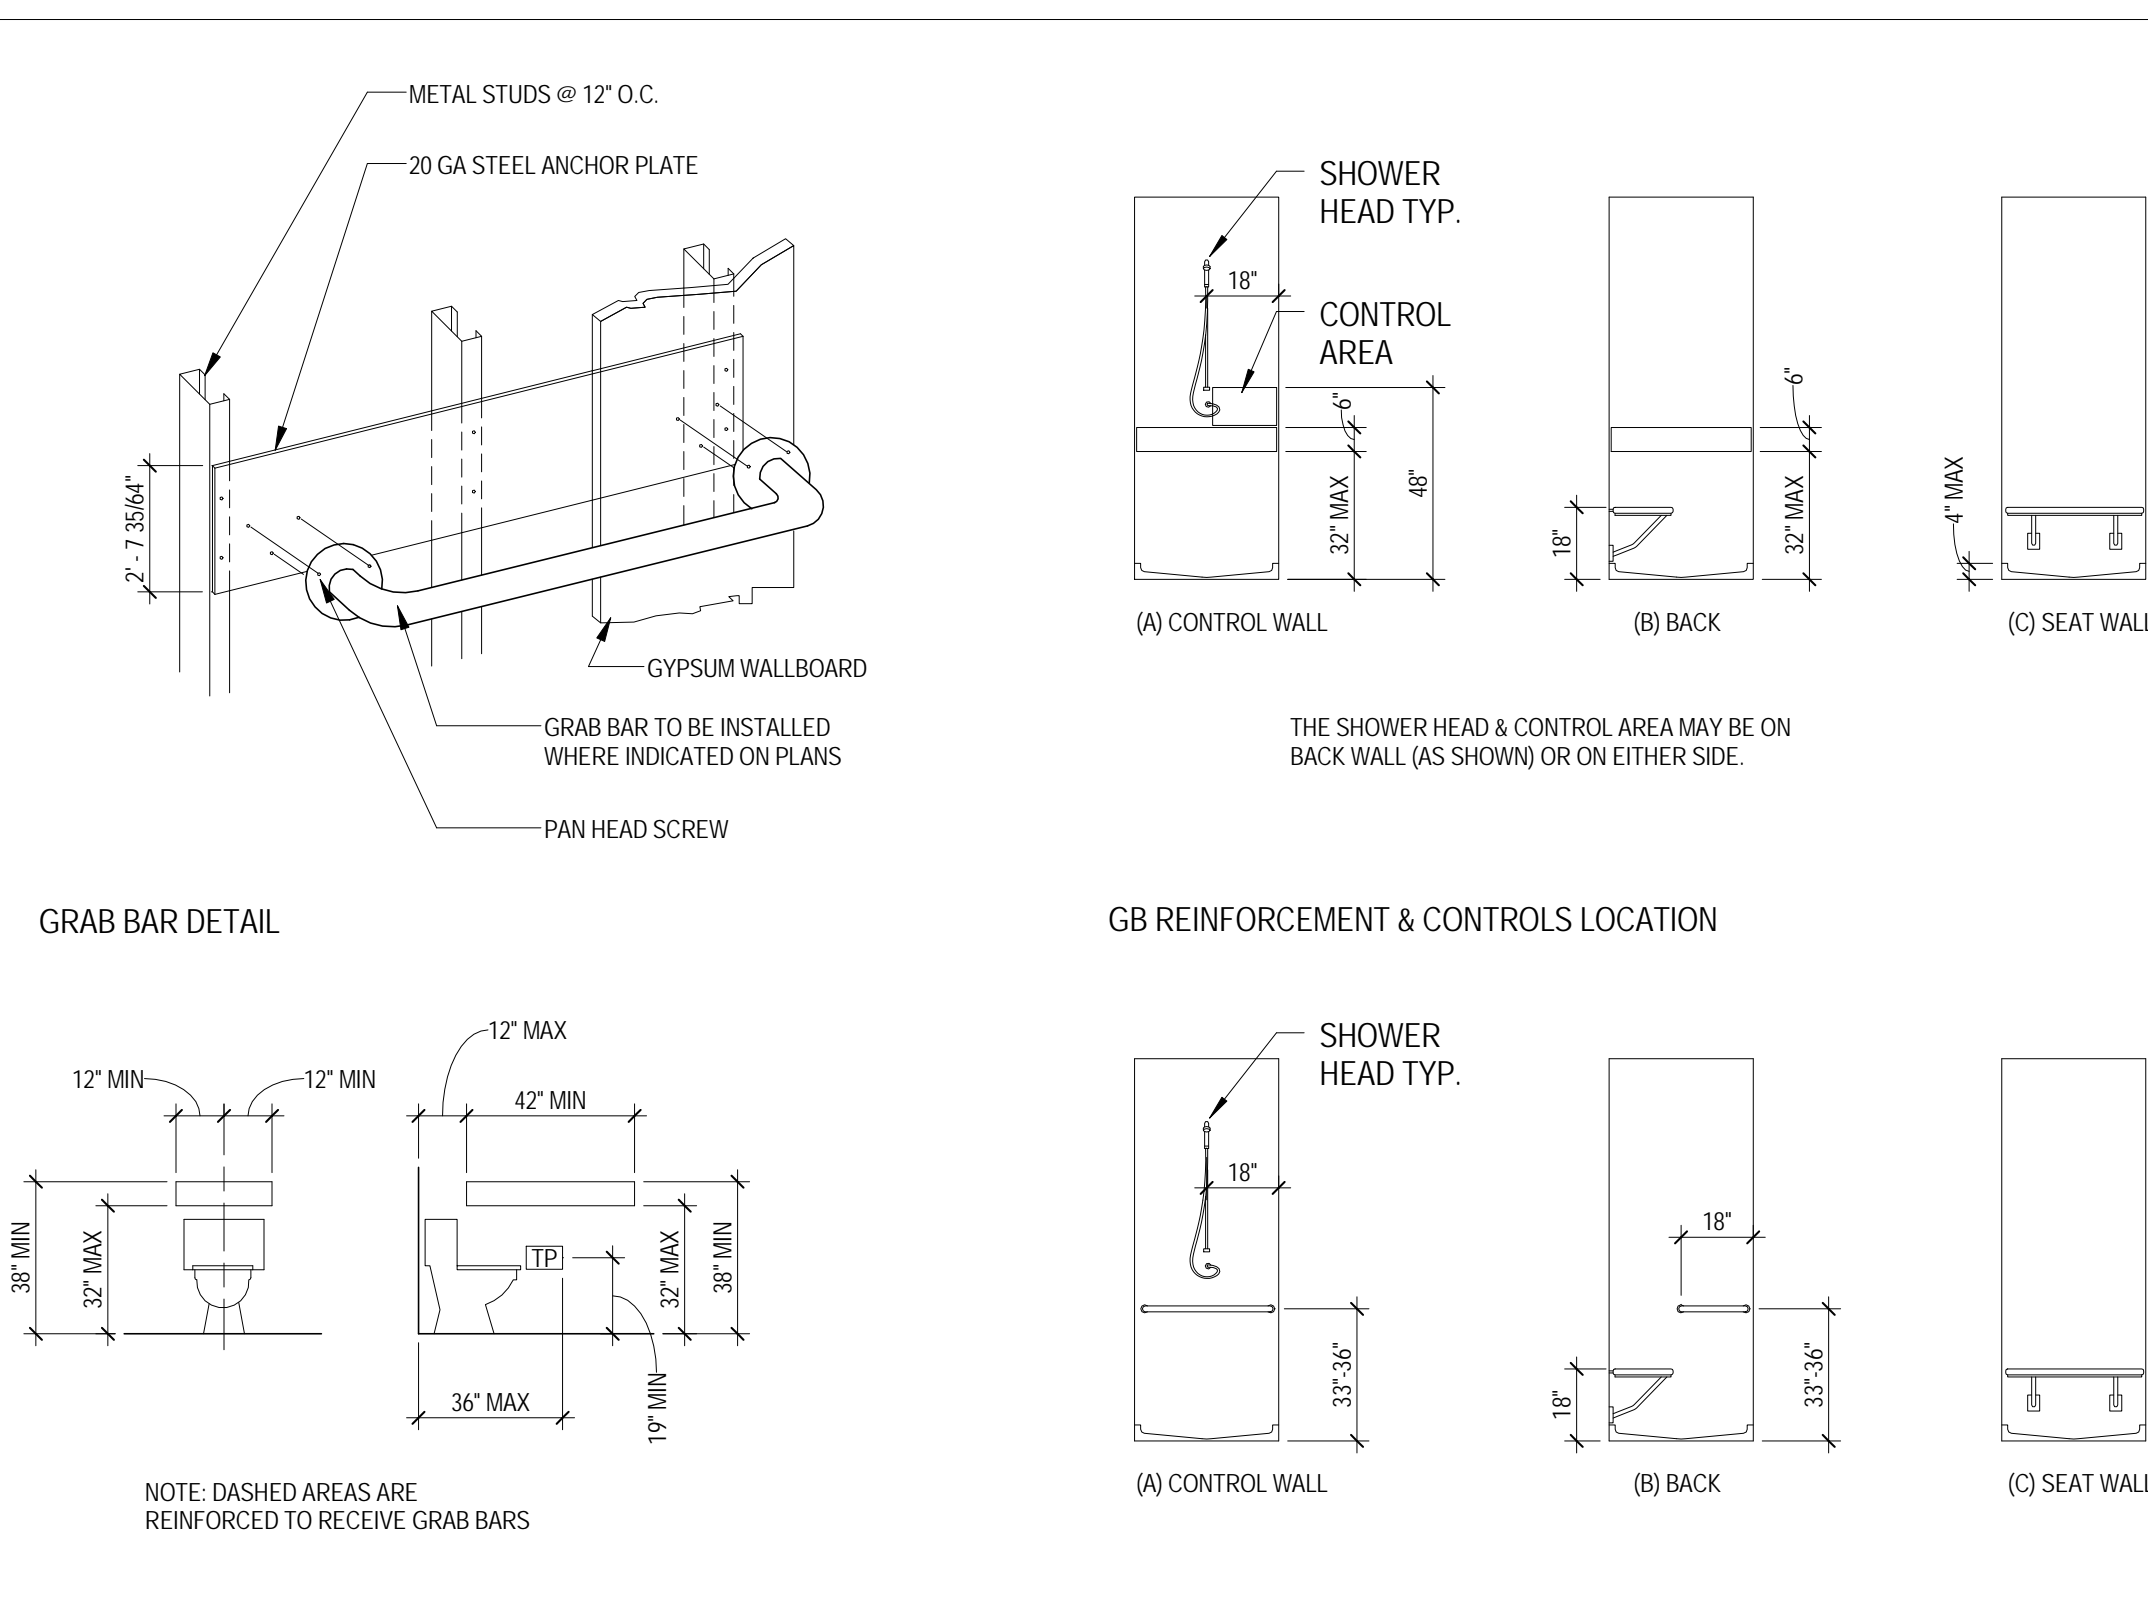


TURNING SPACE REQUIREMENTS

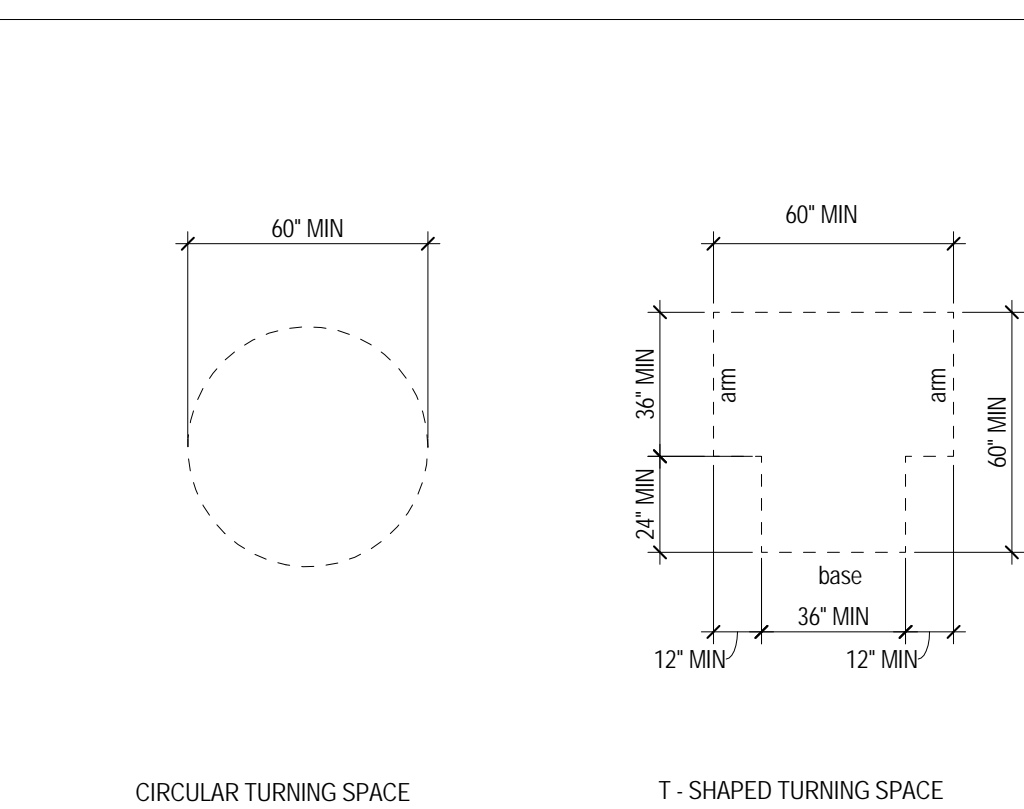


PRIMARY ACCESS

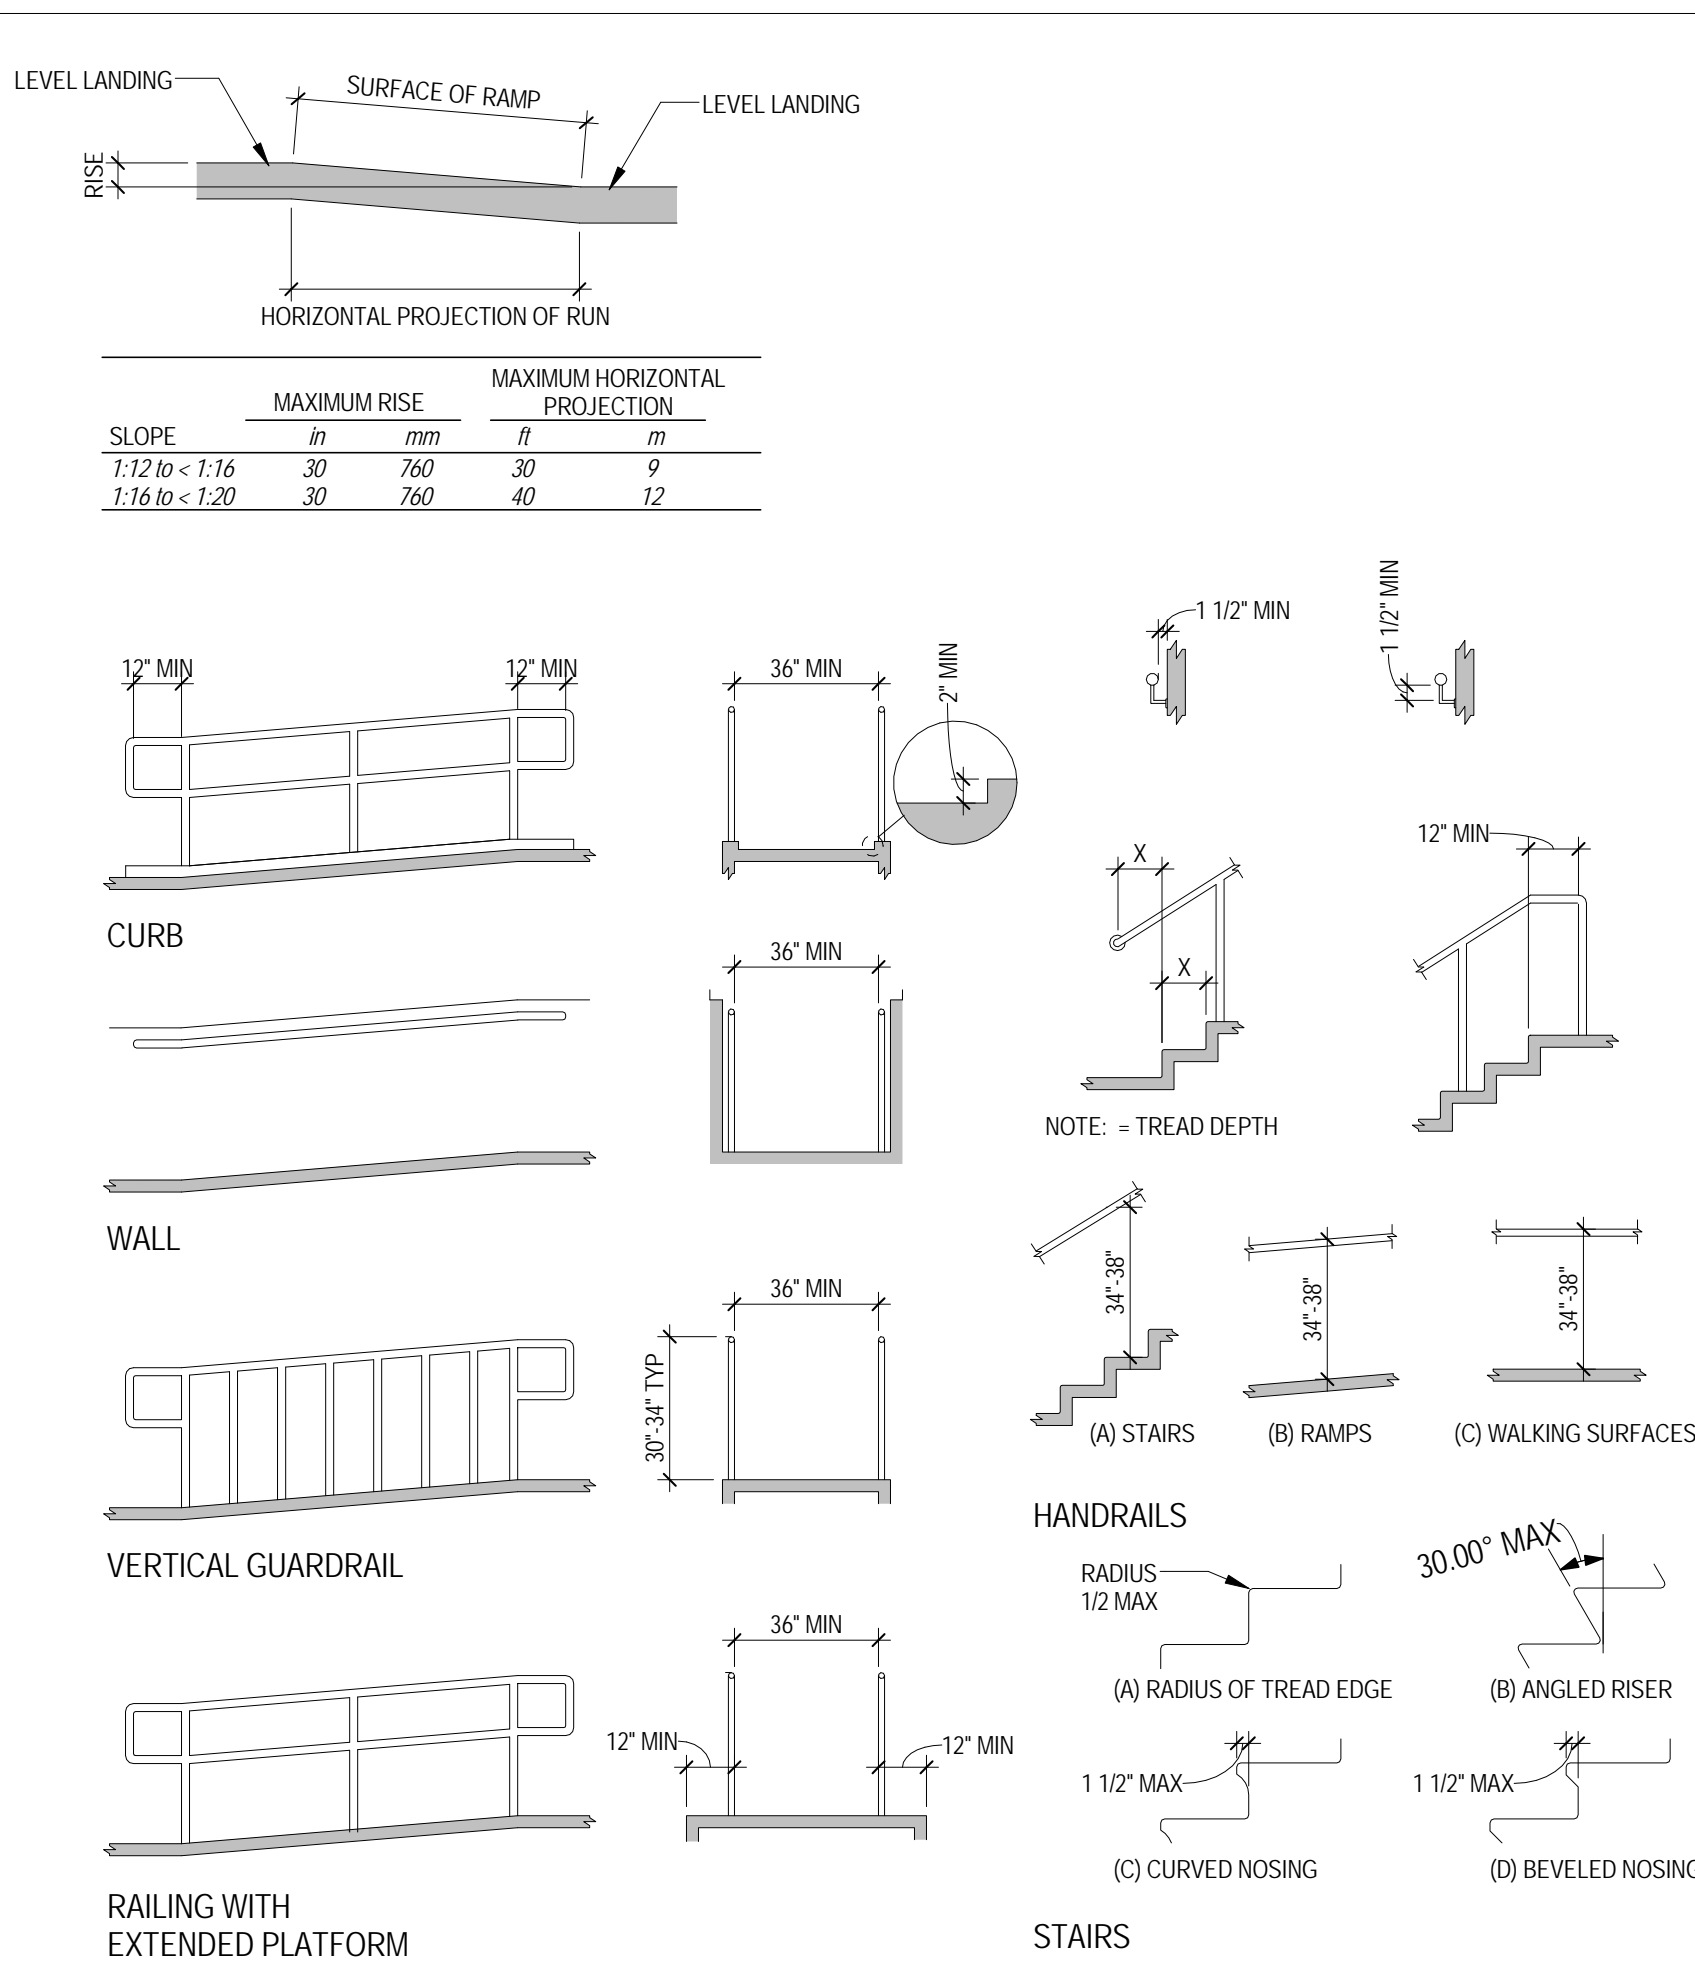


ELEVATORS

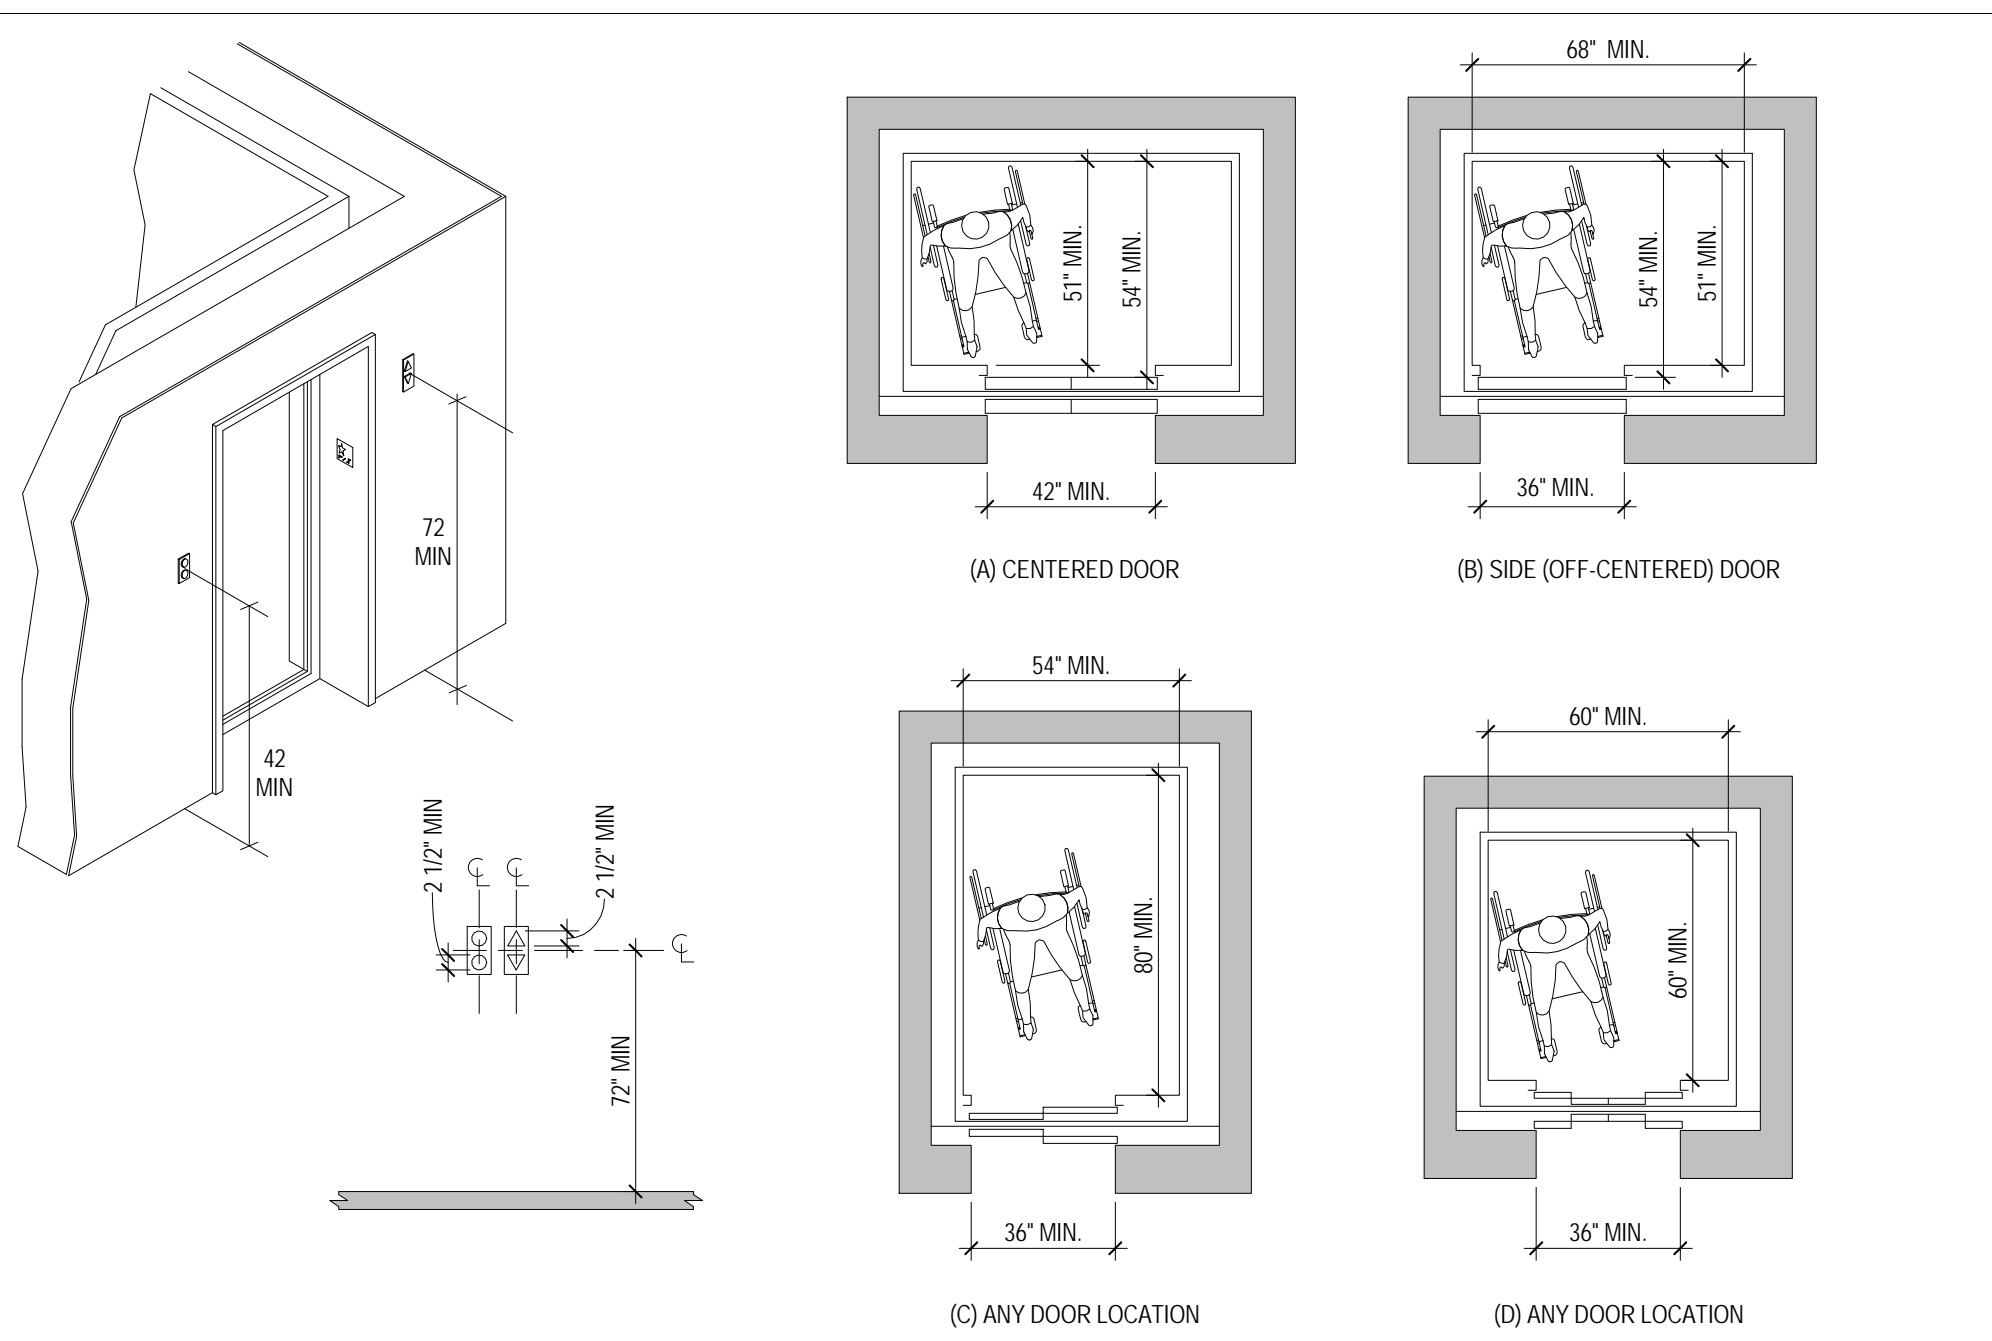


WATER CLOSETS

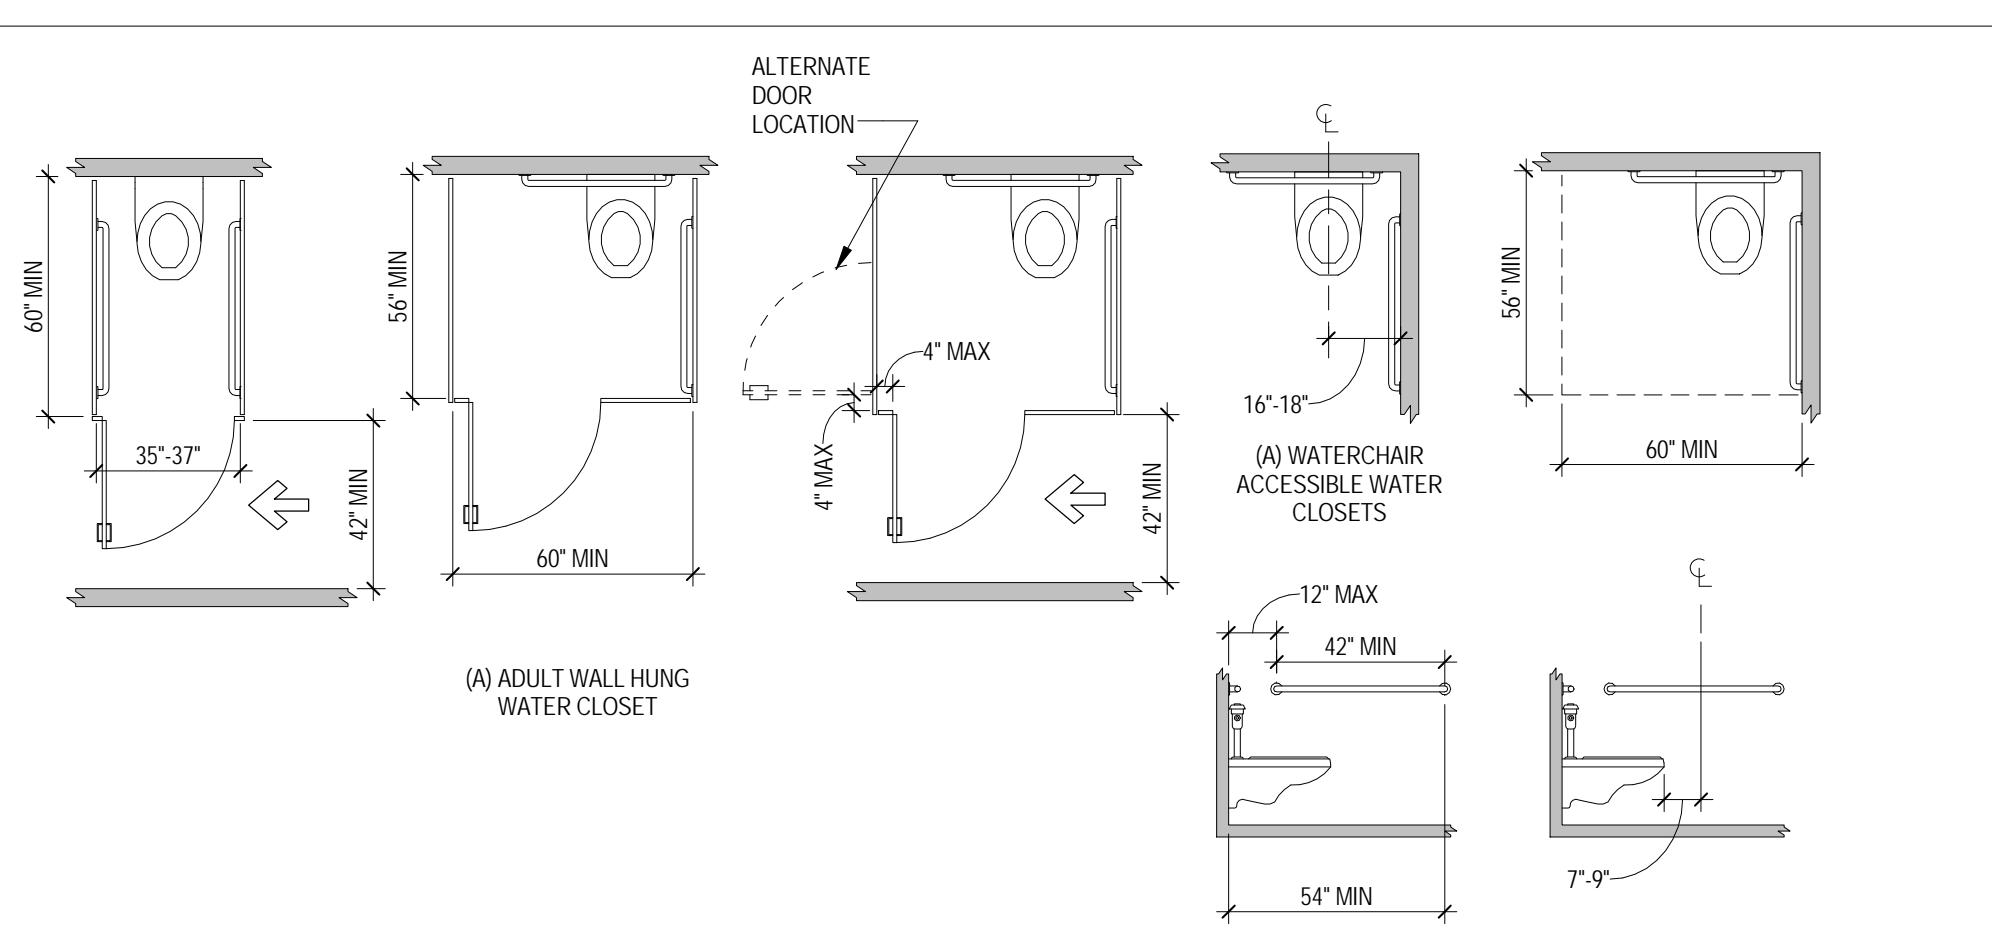


DOORS & MANEUVERING CLEARANCES

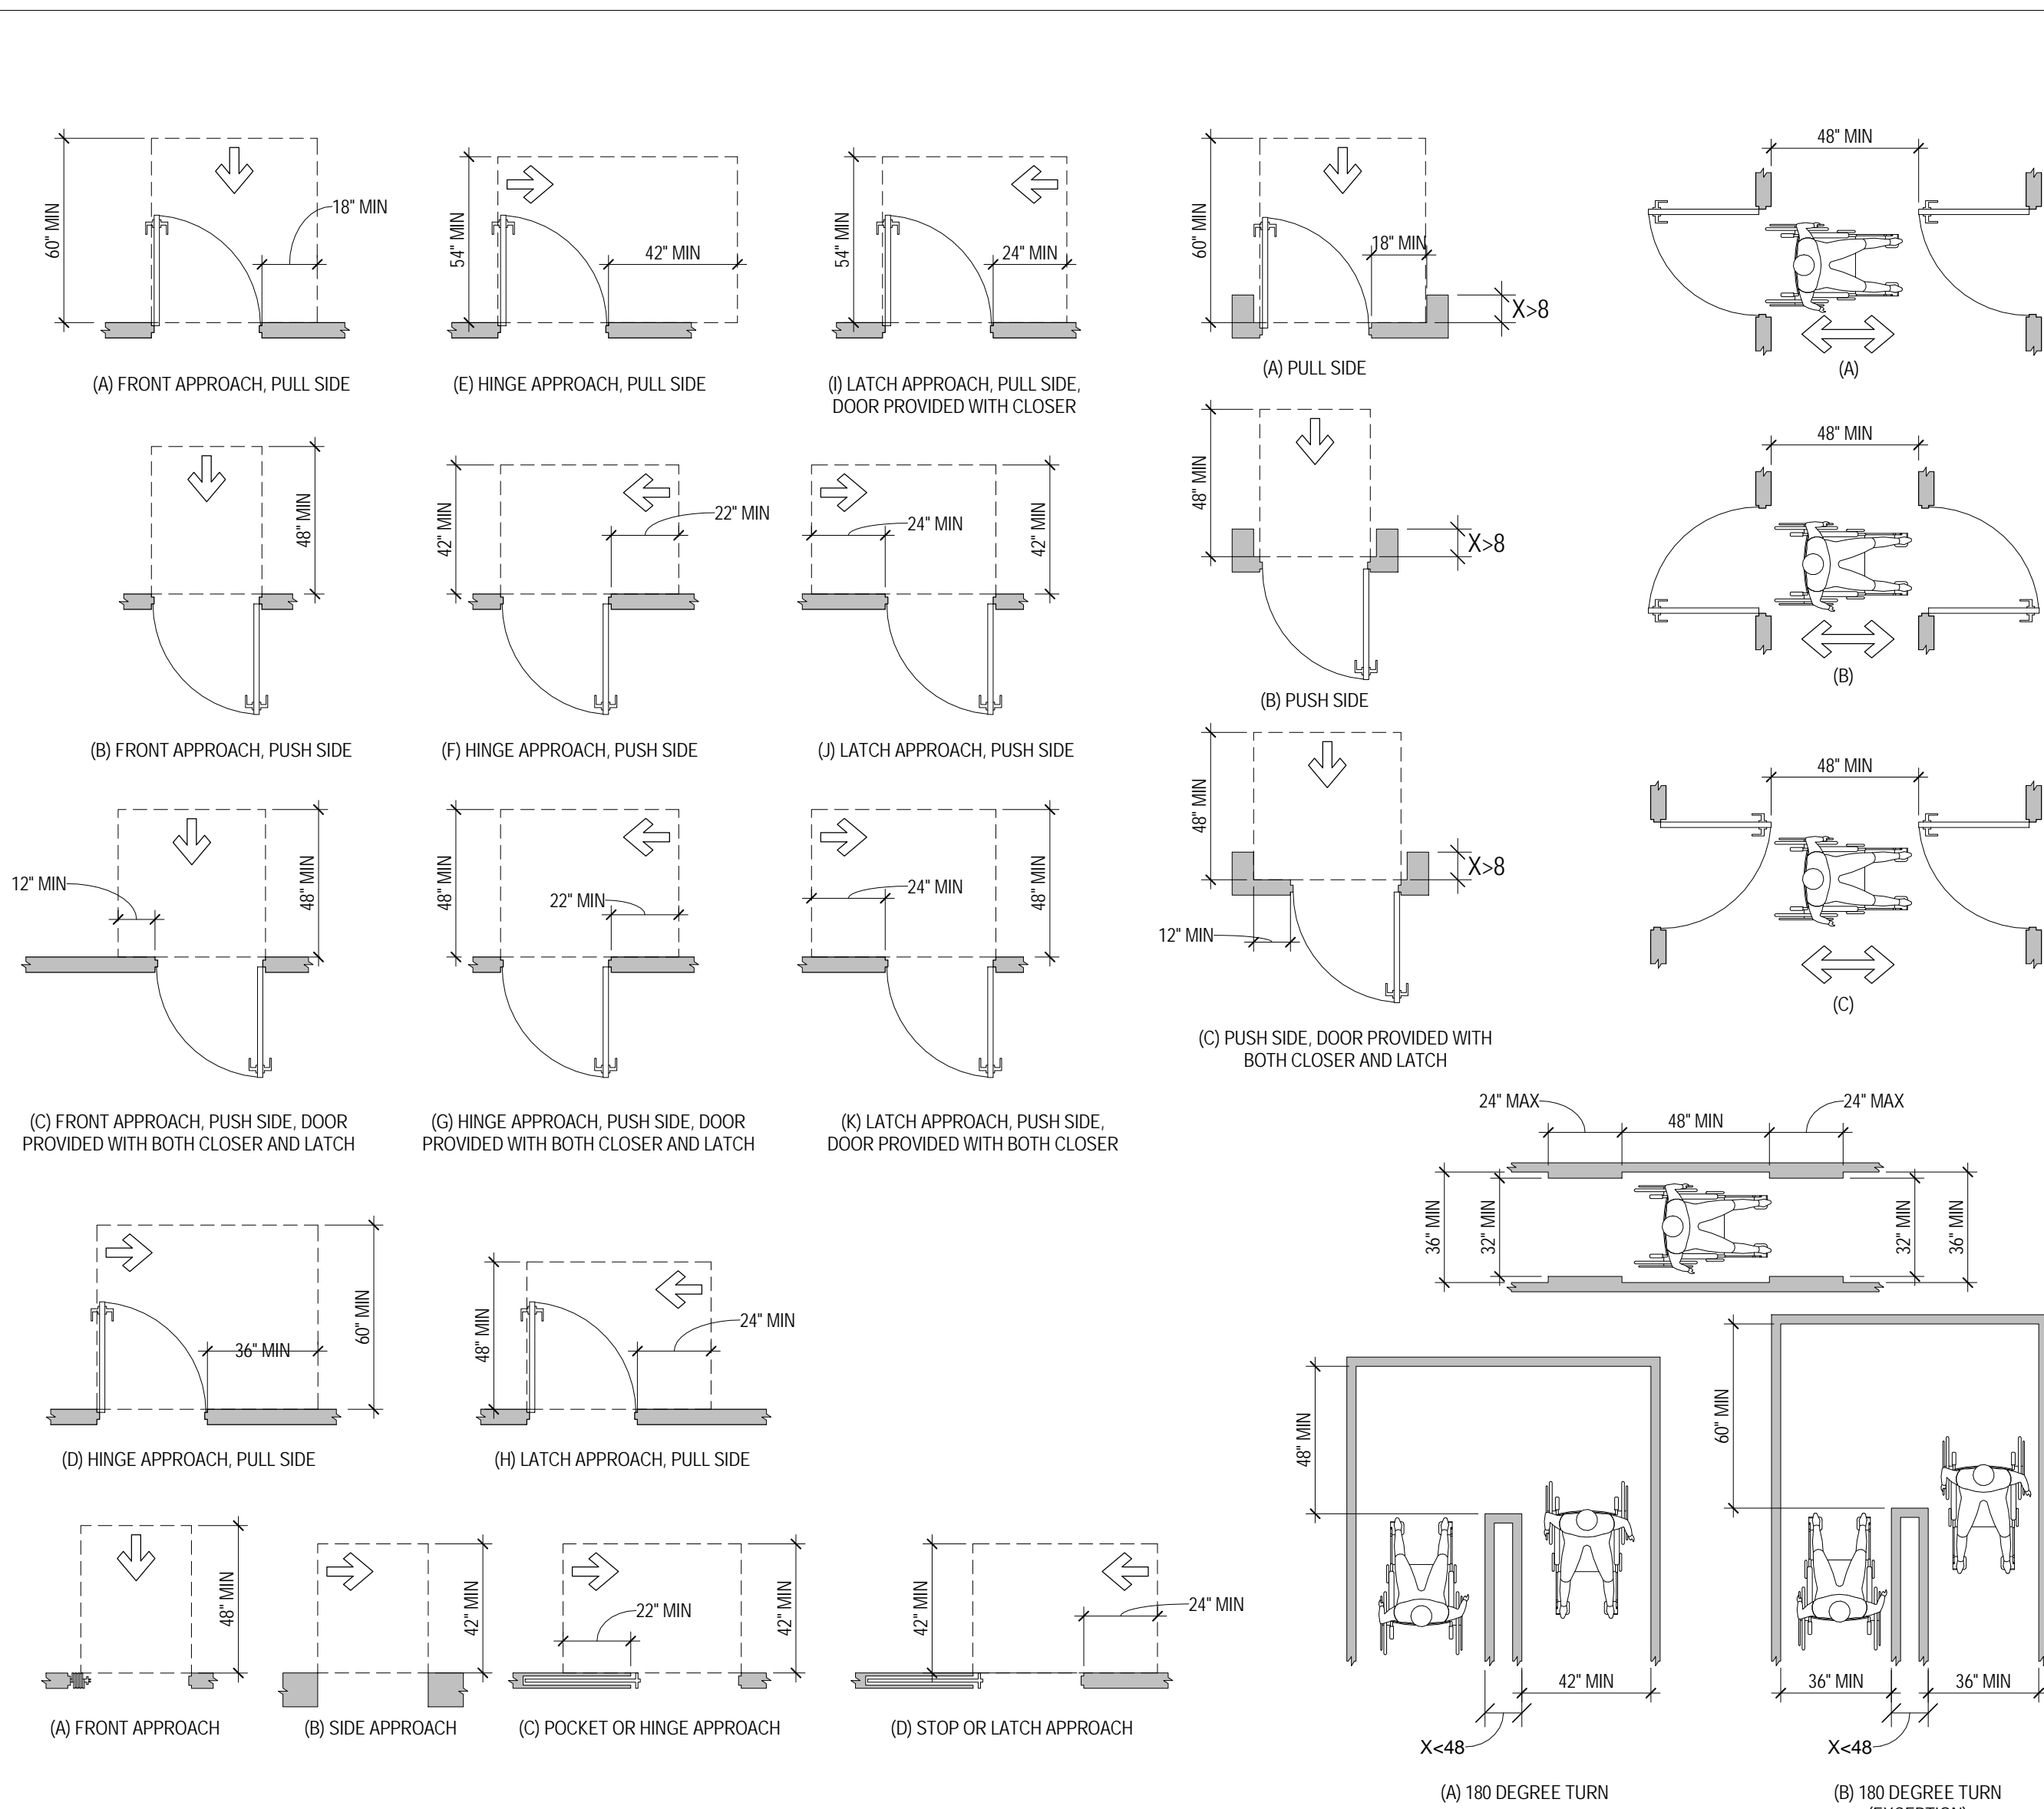


LAVATORIES & SINKS

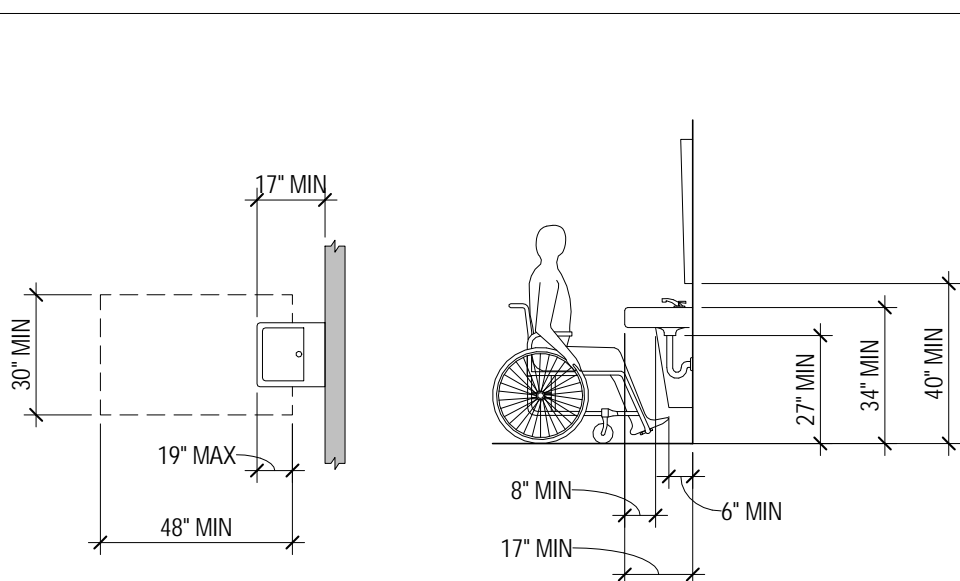

STORAGE

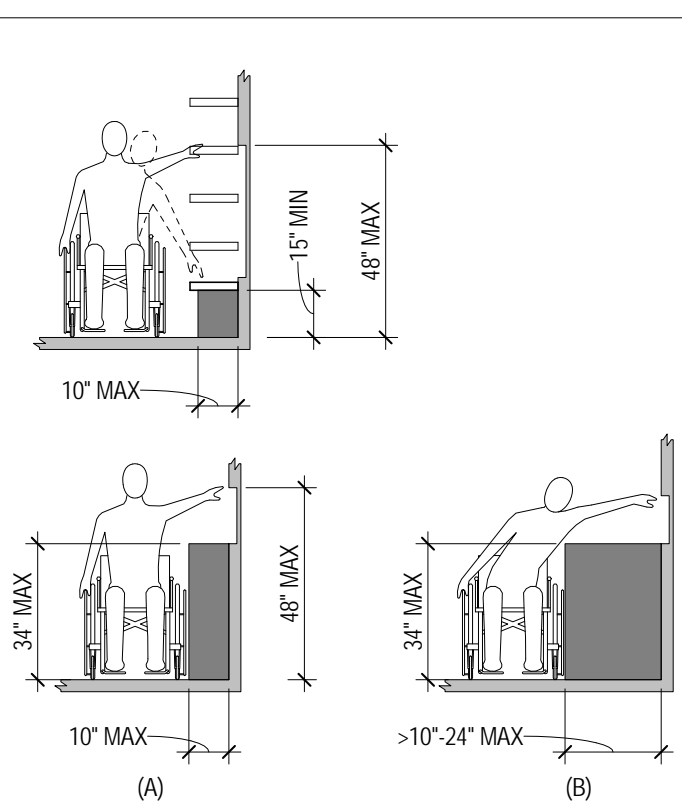


SHOWER CLEARANCES

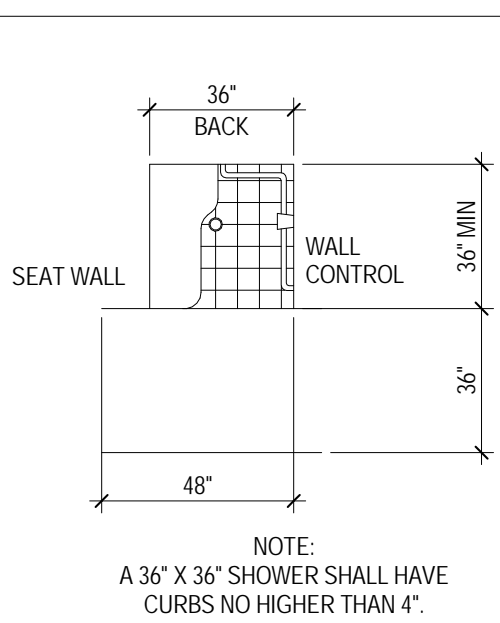

Key Plan:

Seal & Signature:

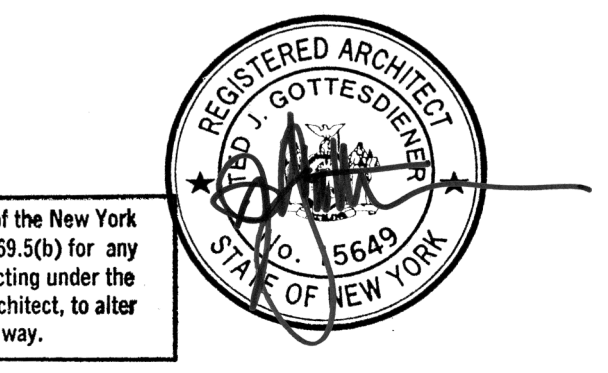

Warning: It is a violation of the New York State Architecture Law, (E.O. 56) for any person, unless they are acting under the direction of a Licensed Architect, to alter this item in any way.

5 20 JUN 2014 ISSUED FOR FOUNDATION BID
4 20 JUN 2014 ISSUED FOR FOUNDATION PERMIT
3 20 DEC 2013 ISSUED FOR FOUNDATION PERMIT
2 15 NOV 2013 ISSUED FOR DD PROGRESS PRICING
1 12 JUL 2013 ISSUED FOR 50% DESIGN DEVELOPMENT

No. Date Description
Sheet Name:

**ADA
REQUIREMENTS**


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Date: 20 JUN 2014
Scale: 1/4" = 1'-0"
File No: G-007
B-SCAN Sheet No.:
G-007.00
Sheet No.:
G-007
Page No.: 5 OF 87

DOT APPROVAL OF DESIGN ELEMENTS


For self-certified projects only

Item requiring DOT approval	Approved by	Date
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MANHATTAN WEST - NE TOWER

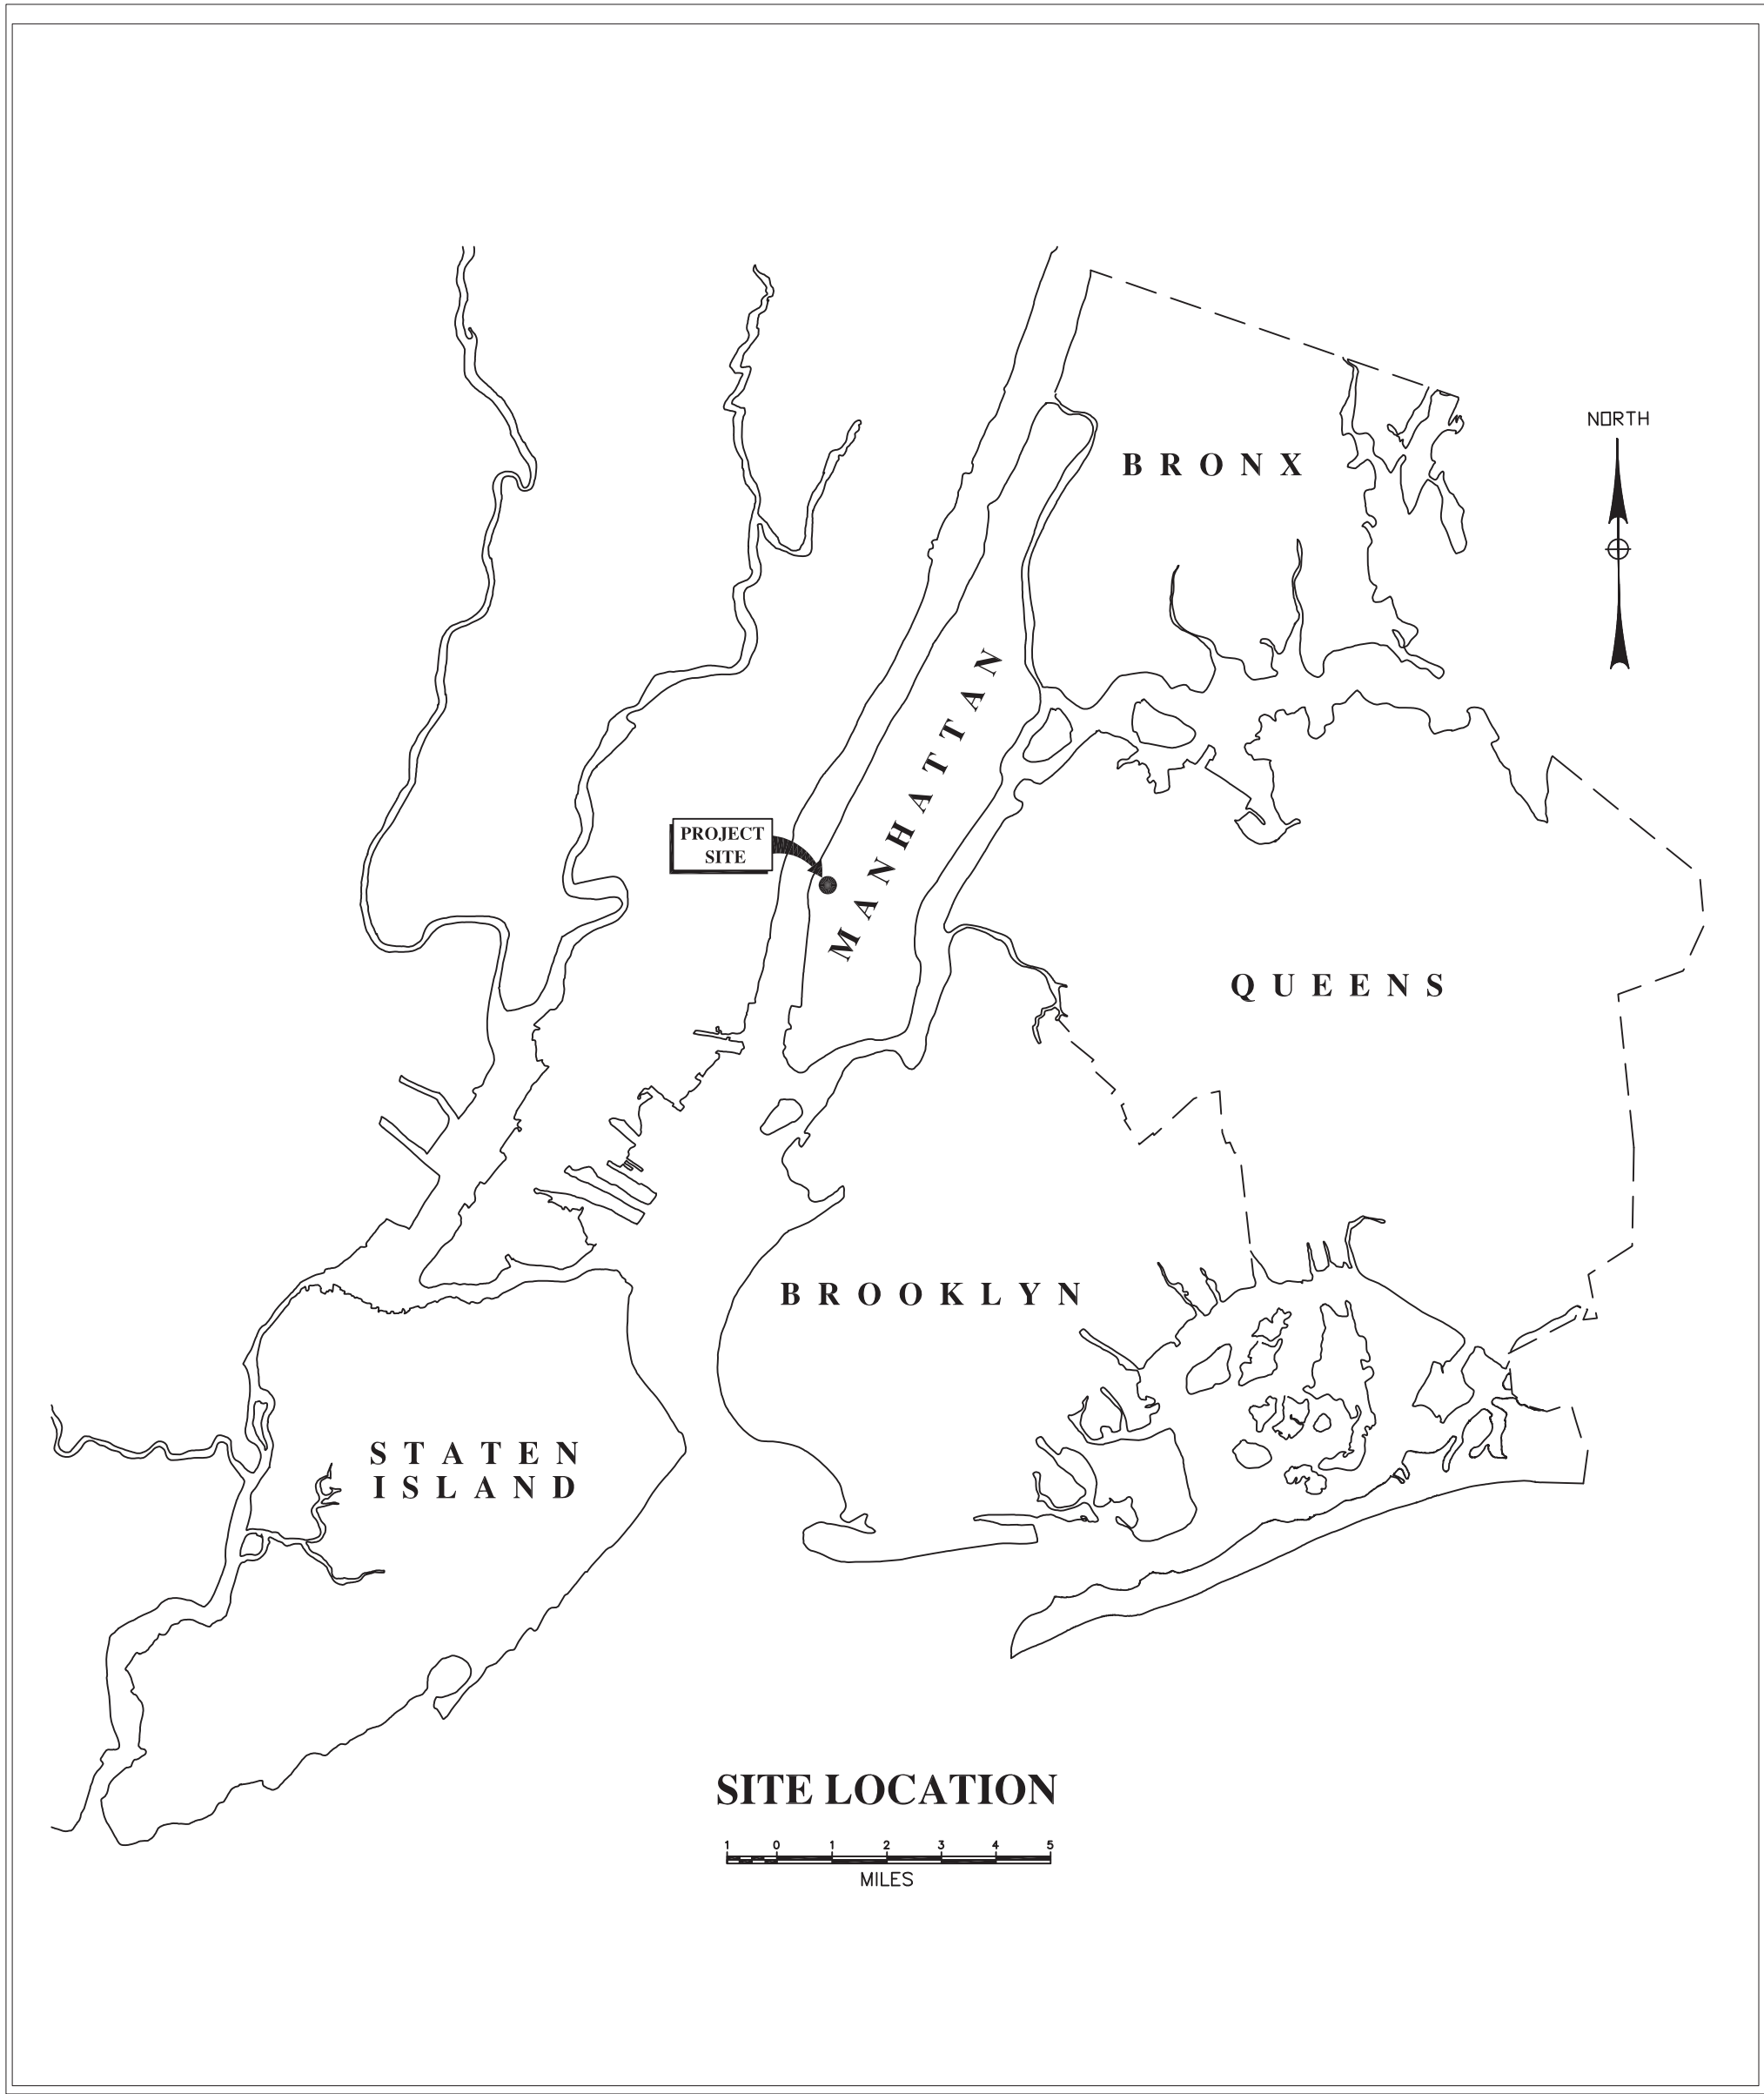

LIST OF ESTIMATED QUANTITIES			
New Curb	555	Lin. ft.	
New Sidewalk	7,685	Sq. ft.	
New Roadway	310	Sq. yds.	
New Trees	10	Each	
New CBs	0	Each	
New DIP	0	Lin. ft.	
New Manholes	0	Each	

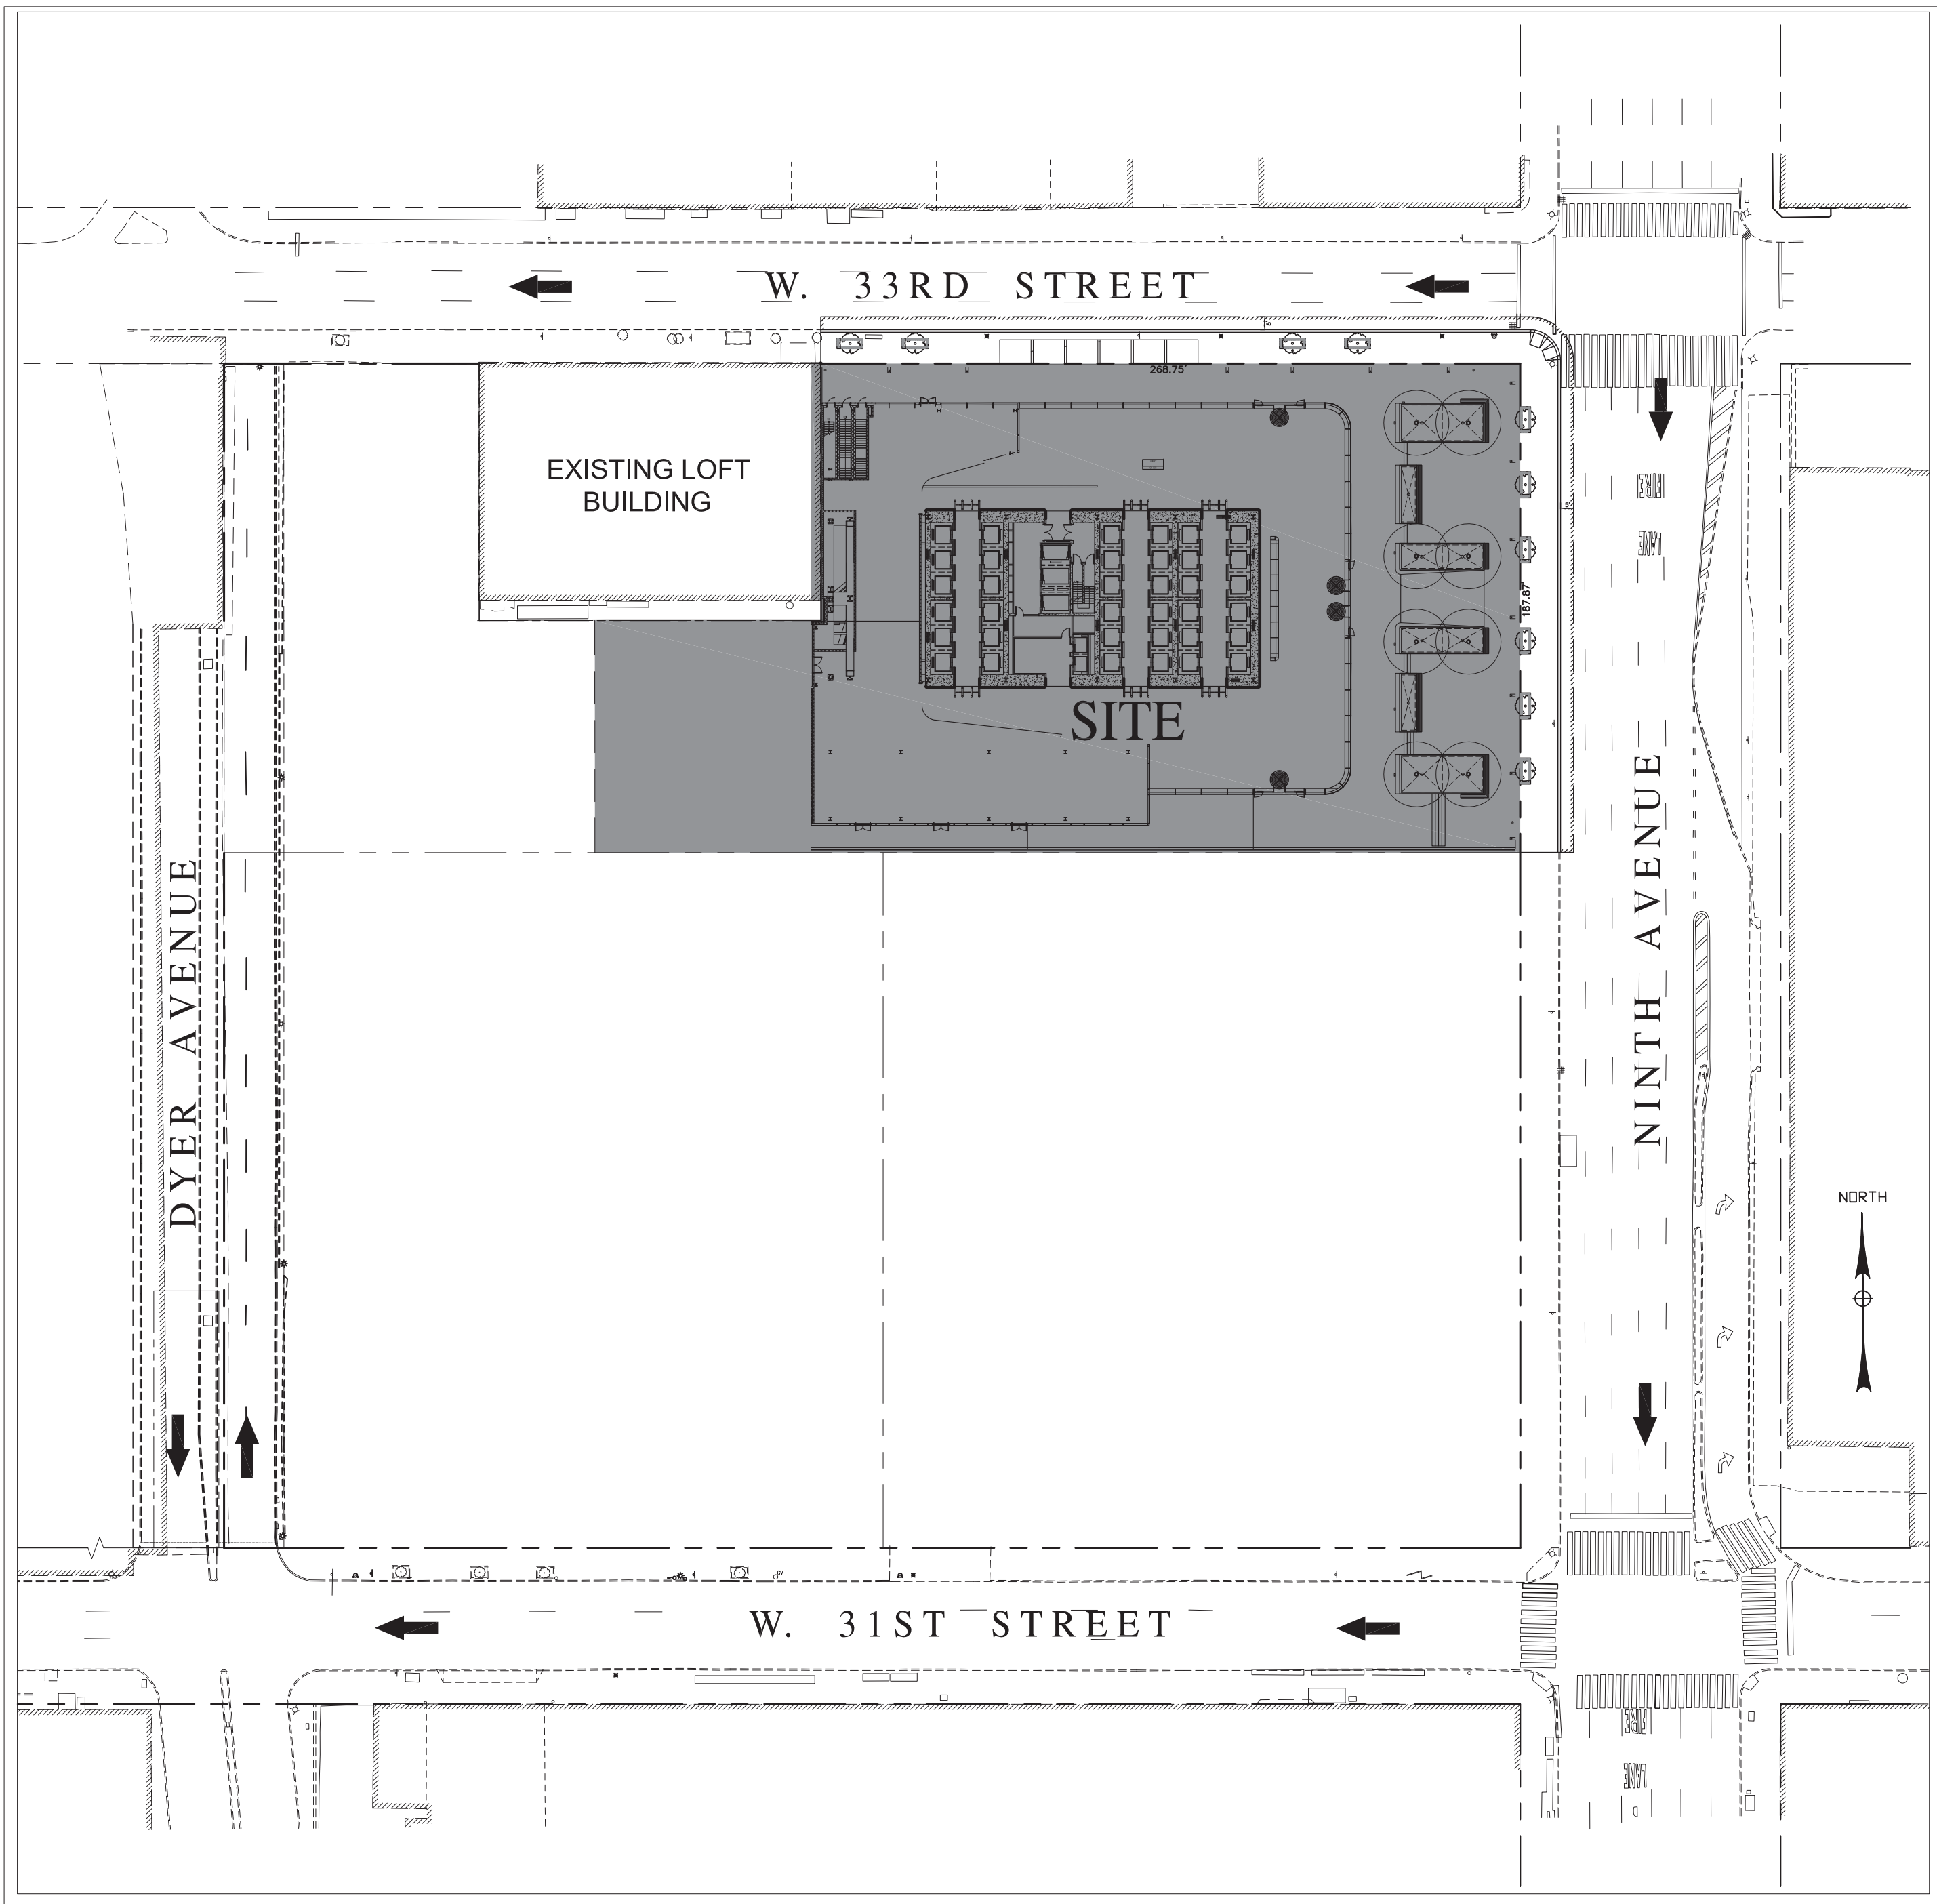

KEY PLAN
SCALE: 1"=50'

Date: June 20, 2014

NEW YORK CITY
DEPARTMENT OF TRANSPORTATION
BUILDERS PAVEMENT PLAN
PROJECT DATA

Block: 729
Zoning: M1-6
Street Address: 401 9th Avenue, New York, NY 10001
Owner: Name: 33rd Street Corporation

Lot(s): 60
Zoning Map No.: 08d
New York, NY 10016
Address: 3 World Financial Center, 200 Vesey Street, New York, NY 10281

Plan prepared by:
Philip Habib & Associates
102 Madison Avenue, 11th Floor
New York, NY 10016
(212) 929-5656

Seal

Signature

DOT requirement waived

As per/Date

1)
2)
3)
4)

GENERAL REQUIREMENTS

1. ALL DESIGNS, MATERIALS, CONSTRUCTION METHODS AND WORKMANSHIP SHALL COMPLY WITH THE FOLLOWING PUBLICATIONS OF THE BUREAU OF HIGHWAYS: STANDARD SPECIFICATIONS, STANDARD DETAILS OF CONSTRUCTION, RULES OF THE BUREAU OF HIGHWAY OPERATIONS, GUIDELINES FOR THE DESIGN INFRASTRUCTURE COMPONENTS.

2. ALL NON STANDARD MATERIALS AND CONSTRUCTION PROCEDURES SHALL BE SPECIFICALLY APPROVED IN WRITING BY THE DOT.

3. ANY WORK NOT COMPLYING WITH THE REQUIREMENTS OF THE DOT SHALL BE REMOVED AND REPLACED.

4. THIS PLAN SHALL BE VALID FOR THE ISSUANCE OF CONSTRUCTION PERMITS FOR A PERIOD OF ONE YEAR FROM THE DATE OF APPROVAL OR SELF-CERTIFICATION, AS APPLICABLE.

5. ALL SIDEWALK AND STREET AREAS CONSTRUCTED UNDER THIS PLAN SHALL REMAIN OPEN TO THE PUBLIC AT ALL TIMES.

ISSUANCE OF PERMITS

6. NO SIDEWALK, CURB OR ROADWAY WORK SHALL BE DONE WITHOUT A PERMIT FROM THE BOROUGH HIGHWAY SUPERINTENDANT. APPLICATION SHALL BE MADE THREE DAYS BEFORE STARTING CONSTRUCTION. THE CONTRACTOR SHALL HAVE ALL REQUIRED INSURANCE COVERAGE ON FILE.

7. NO WORK ON DRAINAGE STRUCTURES SHALL BE DONE WITHOUT A PERMIT FROM THE BOROUGH OFFICE OF THE DEPARTMENT OF ENVIRONMENTAL PROTECTION.

8. ANY VAULT WORK AT THE SITE SHALL BE DONE AS PER THE APPLICABLE RULES OF THE DOT AND THE DEPT. OF BUILDINGS.

CONSTRUCTION ACTIVITY

9. A CONSTRUCTION PLAN SHOWING MAINTENANCE AND PROTECTION OF TRAFFIC, INCLUDING PLACEMENT OF SIDEWALK BRIDGES, BARRIERS AND SIGNAGE, SHALL BE SUBMITTED TO THE BOROUGH HIGHWAY OFFICE BEFORE CONSTRUCTION BEGINS.

10. NO SIDEWALK SHALL BE CLOSED WITHOUT A PERMIT. PEDESTRIAN AND TRAFFIC SAFETY SHALL BE PROTECTED AT ALL TIMES. ROADWAY CLOSINGS SHALL BE AS DIRECTED.

11. THE SITE SHALL BE MAINTAINED IN A CLEAN AND SAFE CONDITION.

FINAL SIGN-OFF

12. PERMITS SHALL BE PRESENTED FROM ALL PUBLIC AGENCIES AND UTILITIES HAVING OWNERSHIP OF STRUCTURES RELOCATED OR REMOVED DURING CONSTRUCTION.

13. ALL PAVEMENT MARKINGS INCLUDING THERMOPLASTIC LANE DIVIDERS, REMOVED DURING CONSTRUCTION SHALL BE REPLACED IN KIND TO THE BUREAU OF TRAFFIC STDs.

14. ALL EXISTING CATCH BASINS ON SITE SHALL BE CLEANED AND MADE OPERABLE.

15. ALL DAMAGE CAUSED BY CONSTRUCTION ON THIS PROJECT OUTSIDE THE PROJECT LIMITS SHALL BE REPAIRED AS DIRECTED.

16. THE ROADWAY SHALL BE PAVED TO THE REQUIREMENTS OF THE DOT AND AS DIRECTED.

PROFESSIONAL CERTIFICATION

(Optional)

I am submitting this plan under professional certification in compliance with all applicable requirements.

Signature / Date

DOT APPROVAL NOT REQUIRED

DOT APPROVAL

Proposed and existing work shown here reviewed for compliance with all applicable rules and requirements by:

Plan Examiner

Approval for issuance of work permits granted by:

Chief / Builders Pavement Section / Date

SHEET NOTES

MANHATTAN WEST:
NORTH TOWER

375 Ninth Avenue, New York, NY 10001

Client

Brookfield Place
250 Vesey Street, 15th Floor, New York, NY 10281

Architecture/Structural Engineering

SOM

Skidmore, Owings & Merrill LLP
14 Wall Street, New York, NY 10005

Civil Engineering

Philip Habib & Associates
102 Madison Avenue #11, New York, NY 10016

MEP Engineering

Jaros Baum & Bolles
80 Pine Street, New York, NY 10005

Vertical Transportation

Edgett Williams Consulting Group, Inc.
102 East 8th Street, Suite 1, Mill Valley, California 94941

Sustainable Design

Viridian Energy & Environmental
50 Washington Street, Norwalk, CT 06854

Geo-Technical Engineering

Mueser Rutledge Consulting Engineers
14 Penn Plaza, 225 W. 34th Street #610,
New York, NY 10122

Landscape Consultant

Field Operations
475 10th Avenue, New York, NY 10018

Security Consultant

Ducibella, Ventor & Santoro
250 State Street #F1, North Haven, CT 06473

Blasi Consultant

Weldinger Associates, Inc.
40 Wall Street, New York, NY 10005

Acoustical Consultant

Cerami & Associates
404 Fifth Avenue #8, New York, NY 10018

Vibration Consultant

Wilson, Uhrig & Associates, Inc.
65 Broadway, Suite 401, New York, NY 10006

Code Consultant

Code Consultants Professional Engineers PC
215 West 40th Street, 10th Floor, New York, NY 10018


Facade Maintenance Consultant

Entek Engineering LLC
166 Ames Street, Hackensack, NJ 07601

Wind Tunnel Consultant

Rowan Williams Davies & Irwin Inc.
650 Woodlawn Road West, Guelph
Ontario, Canada N1K 1S8

Key Plan:

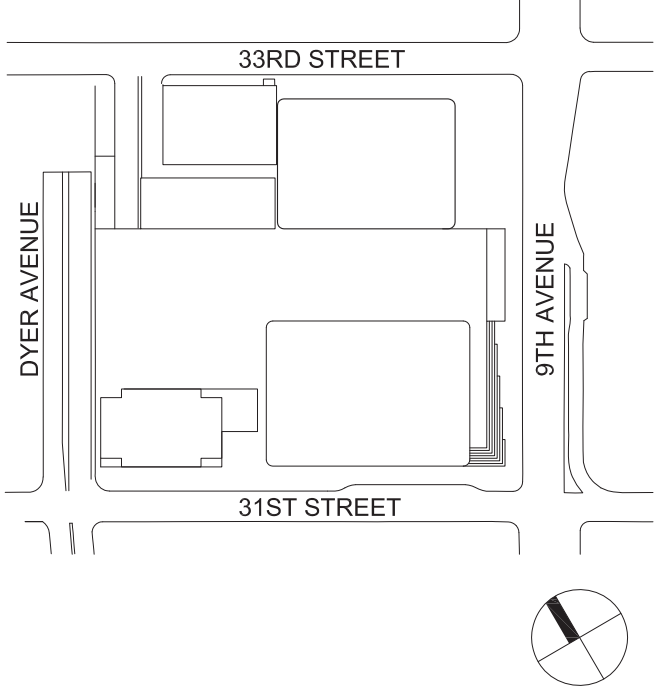

Seal & Signature:



4	20 JUN 2014	ISSUED FOR FOUNDATION PERMIT
3	20 DEC 2013	ISSUED FOR FOUNDATION PERMIT
2	15 NOV 2013	ISSUED FOR DD PROGRESS PRICING
1	12 JUL 2013	ISSUED FOR 50% DESIGN DEVELOPMENT

No. Date Description

Sheet Name:

BPP TITLE
SHEET

Project No.: 201120	B-SCAN Sheet No.: BPP-100.00
Date: 20 DEC 2013	Sheet No.: BPP-100
Scale: 1" = 20'	Page No.: 1 OF 4

MANHATTAN WEST:
NORTH TOWER

375 Ninth Avenue, New York, NY 10001

Client

Brookfield Place
250 Vesey Street, 15th Floor, New York, NY 10281

Architecture/Structural Engineering

SOM

Skidmore, Owings & Merrill LLP
14 Wall Street, New York, NY 10005

Civil Engineering

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MEP Engineering

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80 Pine Street, New York, NY 10005

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New York, NY 10122

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166 Ames Street, Hackensack, NJ 07601

Wind Tunnel Consultant

Rowan Williams Davies & Irwin Inc.
650 Woodlawn Road West, Guelph
Ontario, Canada N1K 1S8

Key Plan:



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Project No.: 207120
Date: 20 DEC 2013
Scale: 1" = 20'
File No.: 2 OF 4

B-SCAN Sheet No.:
BPP-101.00
Sheet No.: BPP-101
Page No.: 2 OF 4

WEST 33RD STREET
PLAN & PROFILE



W. 33RD STREET
SOUTH SIDE
SCALE: H: 1"=20'
V: 1"=1'

MANHATTAN WEST
NE TOWER
33rd ST. PLAN & PROFILE
PHILIP HABIB & ASSOCIATES
102 MADISON AVENUE
NEW YORK, NY 10016
DATE: 6/20/2014
Scale: AS SHOWN
DOB Ref. No.: -----
Sheet 2 of 4
BPP 101.00

7/20/2013 11:02:02 AM

SHEET NOTES

MANHATTAN WEST:
NORTH TOWER

375 Ninth Avenue, New York, NY 10001

Client

Brookfield Place
250 Vesey Street, 15th Floor, New York, NY 10281

Architecture/Structural Engineering

SOM

Skidmore, Owings & Merrill LLP
14 Wall Street, New York, NY 10005

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50 Washington Street, Newark, CT 06854

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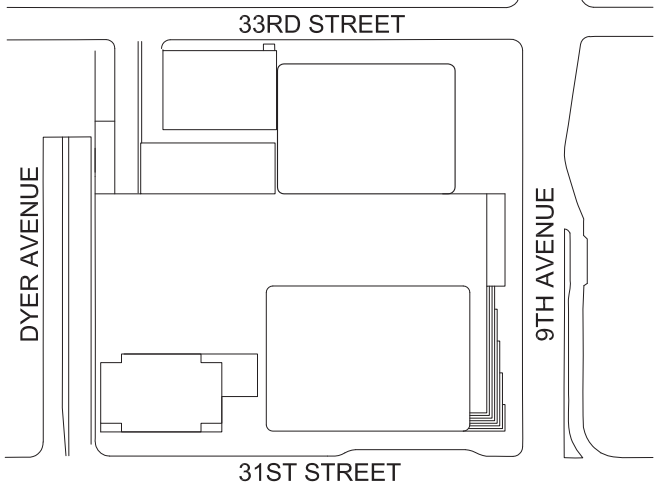
Facade Maintenance Consultant

Entek Engineering LLC
186 Ames Street, Hackensack, NJ 07601

Wind Tunnel Consultant

Rowan Williams Davies & Irwin Inc.
650 Woodlawn Road West, Guelph
Ontario, Canada N1K 1B8

Key Plan:



Seal & Signature:



4 20 JUN 2014 ISSUED FOR FOUNDATION PERMIT
3 20 DEC 2013 ISSUED FOR FOUNDATION PERMIT
2 15 NOV 2013 ISSUED FOR DD PROGRESS PRICING
1 12 JUL 2013 ISSUED FOR 50% DESIGN DEVELOPMENT

No. Date Description
Sheet Name:

9TH AVENUE
PLAN & PROFILE

Project No.: 201120
Date: 20 DEC 2013
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B-SCAN Sheet No.:
BPP-102.00
Sheet No.: BPP-102
Page No.: 3 OF 4

GENERAL NOTES:



- ELEVATIONS ARE BASED ON THE DATUM USED BY THE TOPOGRAPHICAL BUREAU, BOROUGH OF MANHATTAN, WHICH IS 2.750 FEET ABOVE THE UNITED STATES COAST AND GEODETIC SURVEY DATUM MEAN SEA LEVEL, SANDY HOOK, NEW JERSEY.
- UNDERGROUND UTILITY LOCATIONS ARE NOT GUARANTEED, NOR IS THERE ANY GUARANTEE THAT ALL EXISTING UTILITIES, WHETHER FUNCTIONAL OR ABANDONED, WITHIN THE PROJECT AREA ARE SHOWN.
- CONTRACTOR SHALL FIELD VERIFY DIMENSIONS OF DESIGN ELEMENTS AND LOCATIONS OF EXISTING ELEMENTS, IMMEDIATELY INFORM THE ARCHITECT AND CONSTRUCTION MANAGER ABOUT ANY DIMENSIONAL DISCREPANCIES OR POTENTIAL CONFLICTS.
- MATERIALS, CONSTRUCTION METHODS AND WORKMANSHIP FOR STANDARD DETAILS SHALL CONFORM WITH STANDARD DETAILS AND SPECIFICATIONS OF NEW YORK STATE DEPARTMENT OF TRANSPORTATION AND/OR THE NEW YORK CITY DEPARTMENT OF TRANSPORTATION BUREAU OF HIGHWAY OPERATIONS (LATEST EDITION) AVAILABLE AT 40 WORTH STREET, ROOM 824.
- PROVIDE ONE-QUARTER (1/4) INCH EXPANSION JOINTS WITH PREFORMED FILLER AND SEALANT IN ACCORDANCE WITH THE NEW YORK CITY DEPARTMENT OF TRANSPORTATION STANDARDS. CONTRACTOR TO SUBMIT LOCATIONS OF EXPANSION JOINTS FOR ARCHITECTS APPROVAL. JOINTS TO BE PROVIDED AT 20' ON CENTER.
- EXPANSION JOINTS FOR ALL CURBS SHALL BE ONE-HALF (1/2) INCH WIDTH FILLED WITH PREMOULDED JOINT FILLER AND JOINT SEALANT. EXPANSION JOINTS FOR CURBS SHALL LINE UP WITH THE PROPOSED LOCATION OF EXPANSION JOINTS IN NEW ABUTTING CONC. SIDEWALK. FILLERS SHALL COMPLETELY FILL THE JOINT AND SHALL BE CUT FLUSH WITH ALL CURB SURFACES. JOINTS TO BE PROVIDED AT 20' ON CENTER.
- THE CONTRACTOR SHALL INFORM THE OWNER OF ANY EXISTING SIDEWALK OR CURB WHICH IS NOT CALLED OUT FOR REPLACEMENT ON THIS PLAN, BUT MAY PRESENT A TRIP HAZARD OR UNSAFE CONDITION. SUCH CONDITION WILL BE CORRECTED AS DIRECTED BY THE OWNER.
- ALL EXISTING HYDRANTS AND CATCH BASINS WITHIN THE WORK LIMITS SHALL BE MADE OPERABLE PER THE LATEST NEW YORK CITY DEPARTMENT OF ENVIRONMENTAL PROTECTION STANDARDS AND REQUIREMENTS.
- ALL EXISTING PAVEMENT STRIPING & SIGNAGE TO BE REPLACED IN KIND PER THE MOST RECENT MUTCD REQUIREMENTS.
- ALL EXISTING MANHOLES, VAULTS, VALVE BOXES AND OTHER SUCH HARDWARE IN THE ADJACENT SIDEWALKS SHALL BE ABANDONED IF NOT UTILIZED IN THE FINAL BUILDING PLANS. IF EXISTING HARDWARE AND UTILITIES WILL BE REUSED IN THE FINAL BUILDING PLAN, THEY SHALL BE ADJUSTED TO FINISH GRADES AS NECESSARY. THIS HARDWARE MAY NOT BE SHOWN ON THESE PLANS. CONTRACTOR SHALL VERIFY LOCATIONS OF THIS HARDWARE IN THE FIELD AND WITH THE SIGNED AND SEALED SURVEY.

DRAINAGE NOTES:

- ALL CATCH BASINS SHALL BE CONSTRUCTED IN ACCORDANCE WITH THE LATEST NEW YORK CITY DEPARTMENT OF ENVIRONMENTAL PROTECTION STANDARDS AND REQUIREMENTS. ALL NEW CATCH BASIN CONNECTIONS SHALL BE MADE TO THE EXISTING SEWERS AT MANHOLES AND SHALL CONSIST OF 12" DUCTILE IRON PIPE CLASS 56, "PUSH-ON" JOINTS LAID ON BROKEN STONE.
- ALL EXISTING NON-STANDARD BASINS WITHIN THE PROJECT LIMITS SHALL BE REPLACED OR MODIFIED TO CONFORM WITH THE LATEST NEW YORK CITY DEPARTMENT OF ENVIRONMENTAL PROTECTION STANDARDS AND REQUIREMENTS.
- ALL EXISTING BASINS, INLETS, AND DRAINAGE STRUCTURES TO BE ABANDONED SHALL BE BULK-HEADED AND CUT DOWN TO TWO (2) FEET BELOW SUBGRADE. HOLES PUNCHED IN BOTTOM SLAB AND FILLED WITH COMPACTED CLEAN SAND. BASIN CONNECTIONS TO BE ABANDONED SHALL BE PLUGGED AT BOTH ENDS.
- ALL DAMAGED MANHOLES DAMAGED BY THE CONTRACTOR'S WORK SHALL BE REPAIRED OR REPLACED BY THE CONTRACTOR, AS DIRECTED BY THE ENGINEER, AT NO COST TO THE CITY.
- PRIOR TO INSTALLATION OF THE DRAINAGE FACILITIES PROPOSED UNDER THIS PLAN, PERMITS ARE TO BE OBTAINED FROM THE LOCAL SEWER RECORDS OFFICE OF THE DEPARTMENT OF ENVIRONMENTAL PROTECTION (D.E.P.). CONSTRUCTION INSPECTION IS TO BE REQUESTED AT LEAST 24 HOURS IN ADVANCE FROM THE HOUSE CONNECTION INSPECTION UNIT OF THE D.E.P. DIVISION OF SEWER REGULATION AND CONTROL.

PARKS & RECREATION NOTES:

- CONTRACTOR SHALL CONTACT CITY OF NEW YORK PARKS & RECREATION (PARKS) IF ANY UNDERGROUND INFRASTRUCTURE (GAS/WATER/ELECTRIC/ETC.) AFFECTS ANY PROPOSED/EXISTING CITY TREES. ANY CONSTRUCTION ACTIVITIES, INCLUDING EXCAVATION, GRADE CHANGES, UTILITIES, SIDEWALKS, PRUNING, OR ANY OTHER WORK, PERFORMED BY THE CONTRACTOR OR SUBCONTRACTORS ABOVE OR BELOW GROUND ADJACENT TO A CITY TREE OR WITHIN THE TREE DRILLING REQUIRES A FORESTRY PERMIT FROM PARKS.
- ALL CITY TREE PLANTINGS SHALL FOLLOW PARKS PLANTING SPECIFICATIONS AND GUIDELINES. THE CONTRACTOR SHALL FIELD VERIFY LOCATIONS OF EXISTING UTILITIES AND LAY OUT PROPOSED UTILITIES AND/OR STREET FURNITURE. IF ANY DIMENSIONAL DISCREPANCIES OR POTENTIAL CONFLICTS ARE FOUND, THE CONTRACTOR SHALL INFORM THE ENGINEER. ANY SUBSTANTIAL REVISIONS TO THE PLAN SHALL BE SENT TO PARKS FOR APPROVAL.
- ALL PIT SIZES INDICATED ARE TO BE FULLY EXCAVATED TO NYC DIMENSIONS LABELED AND REPLACED WITH NEW TOPSOIL TO NYC PARKS STANDARDS.
- TOTAL NUMBER OF:
 - TREES REQUIRED BY NYCDOB=19
 - EXISTING TREES TO PROTECT=0
 - PROPOSED TREES TO REMOVE/RELOCATE
 - W/ NYC PARKS DOCUMENTATION=3
 - PROPOSED TREES TO PLANT=11
 - TREES TO PLANT OFFSITE=0
 - TREES TO PAY INTO TREE FUND=8

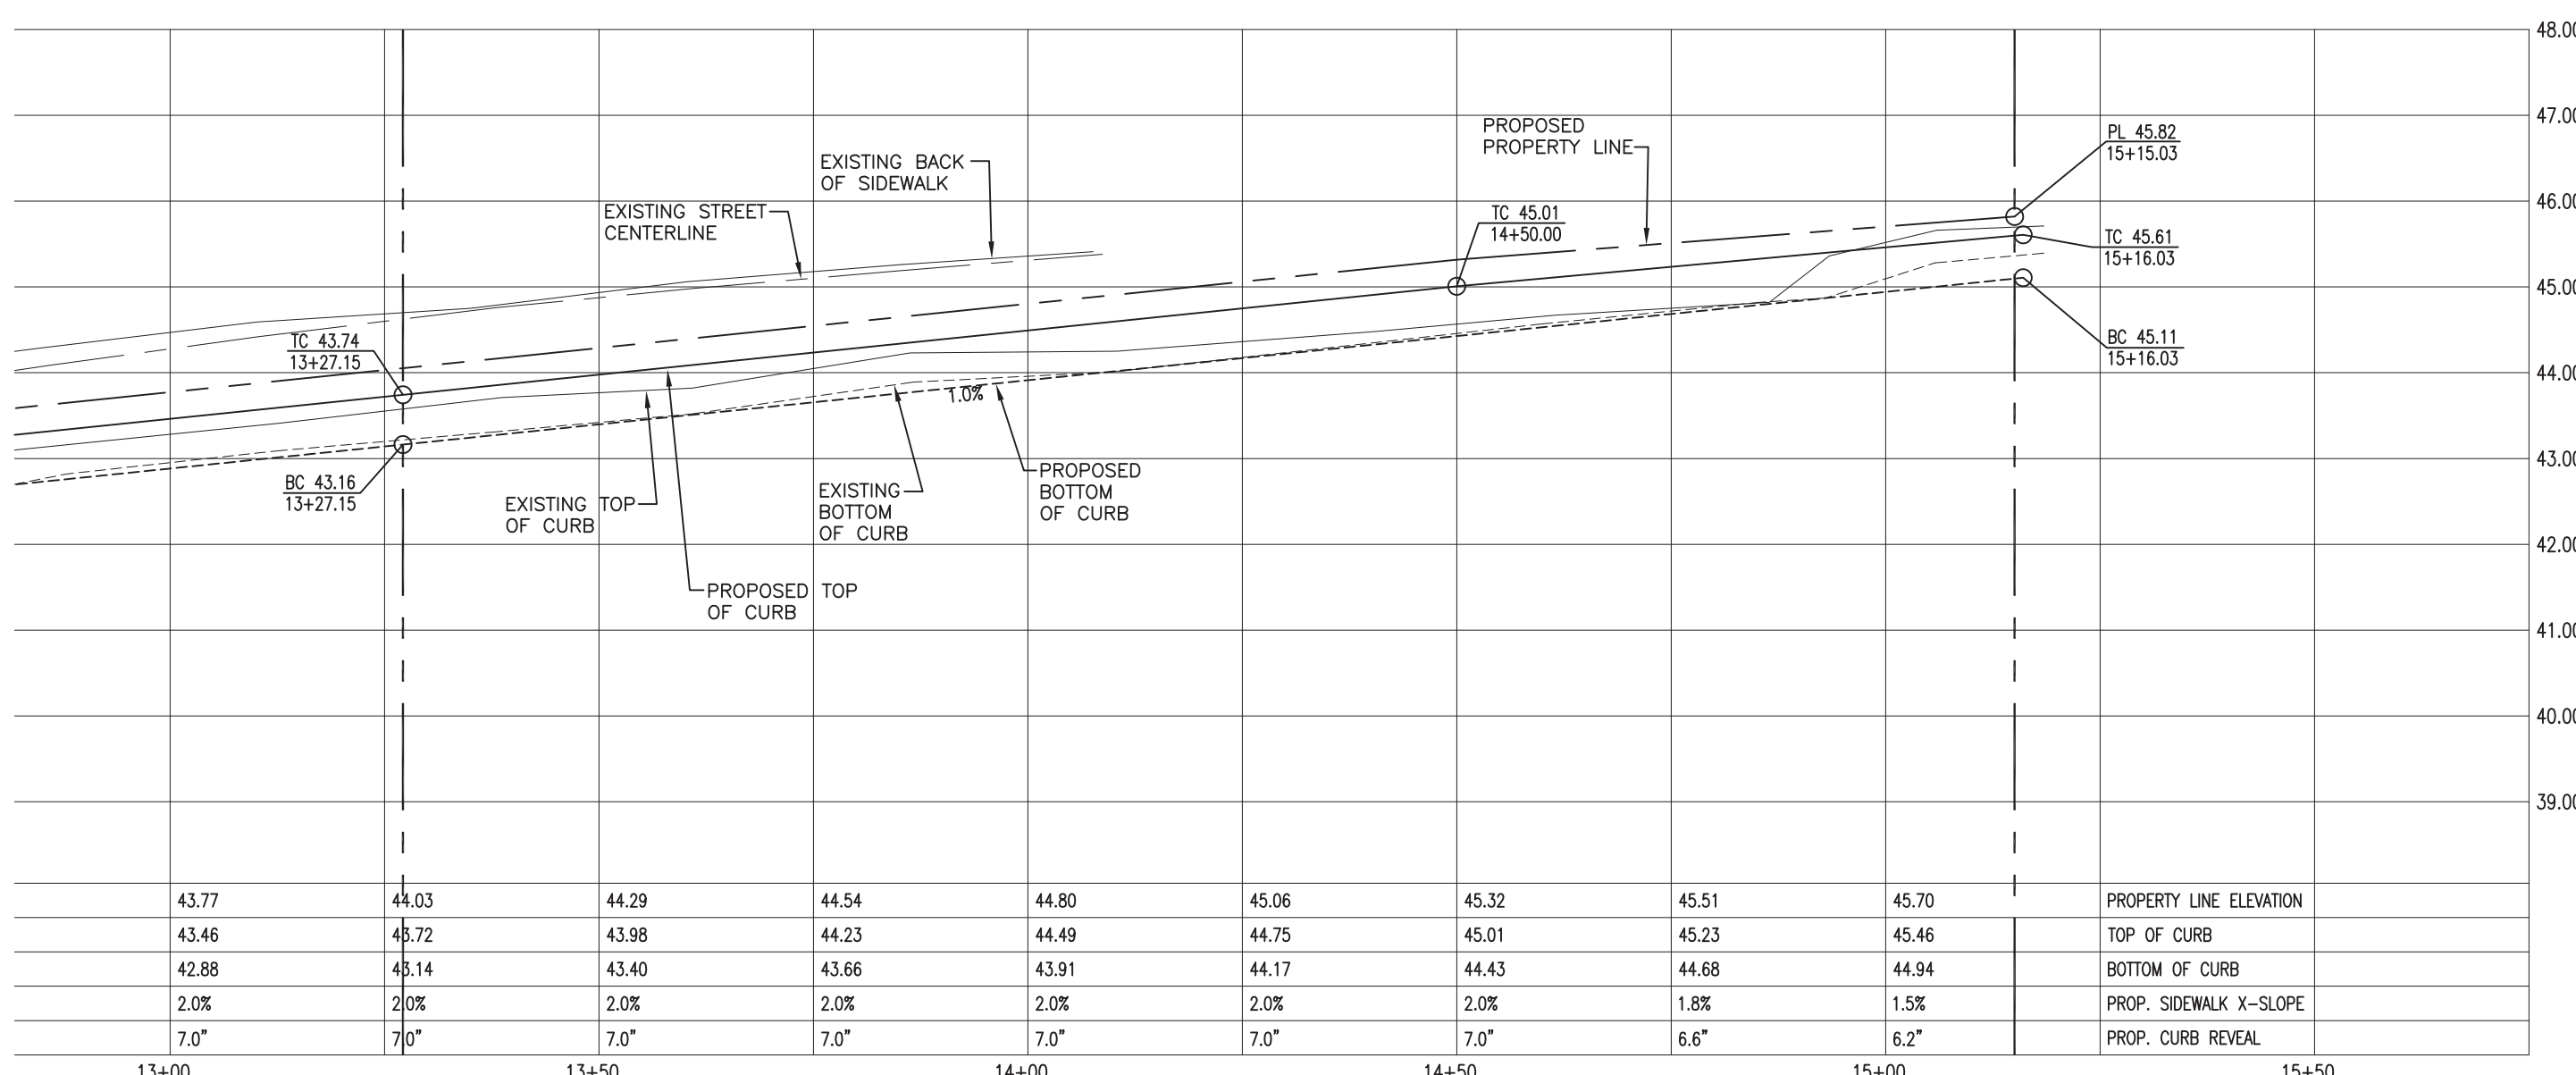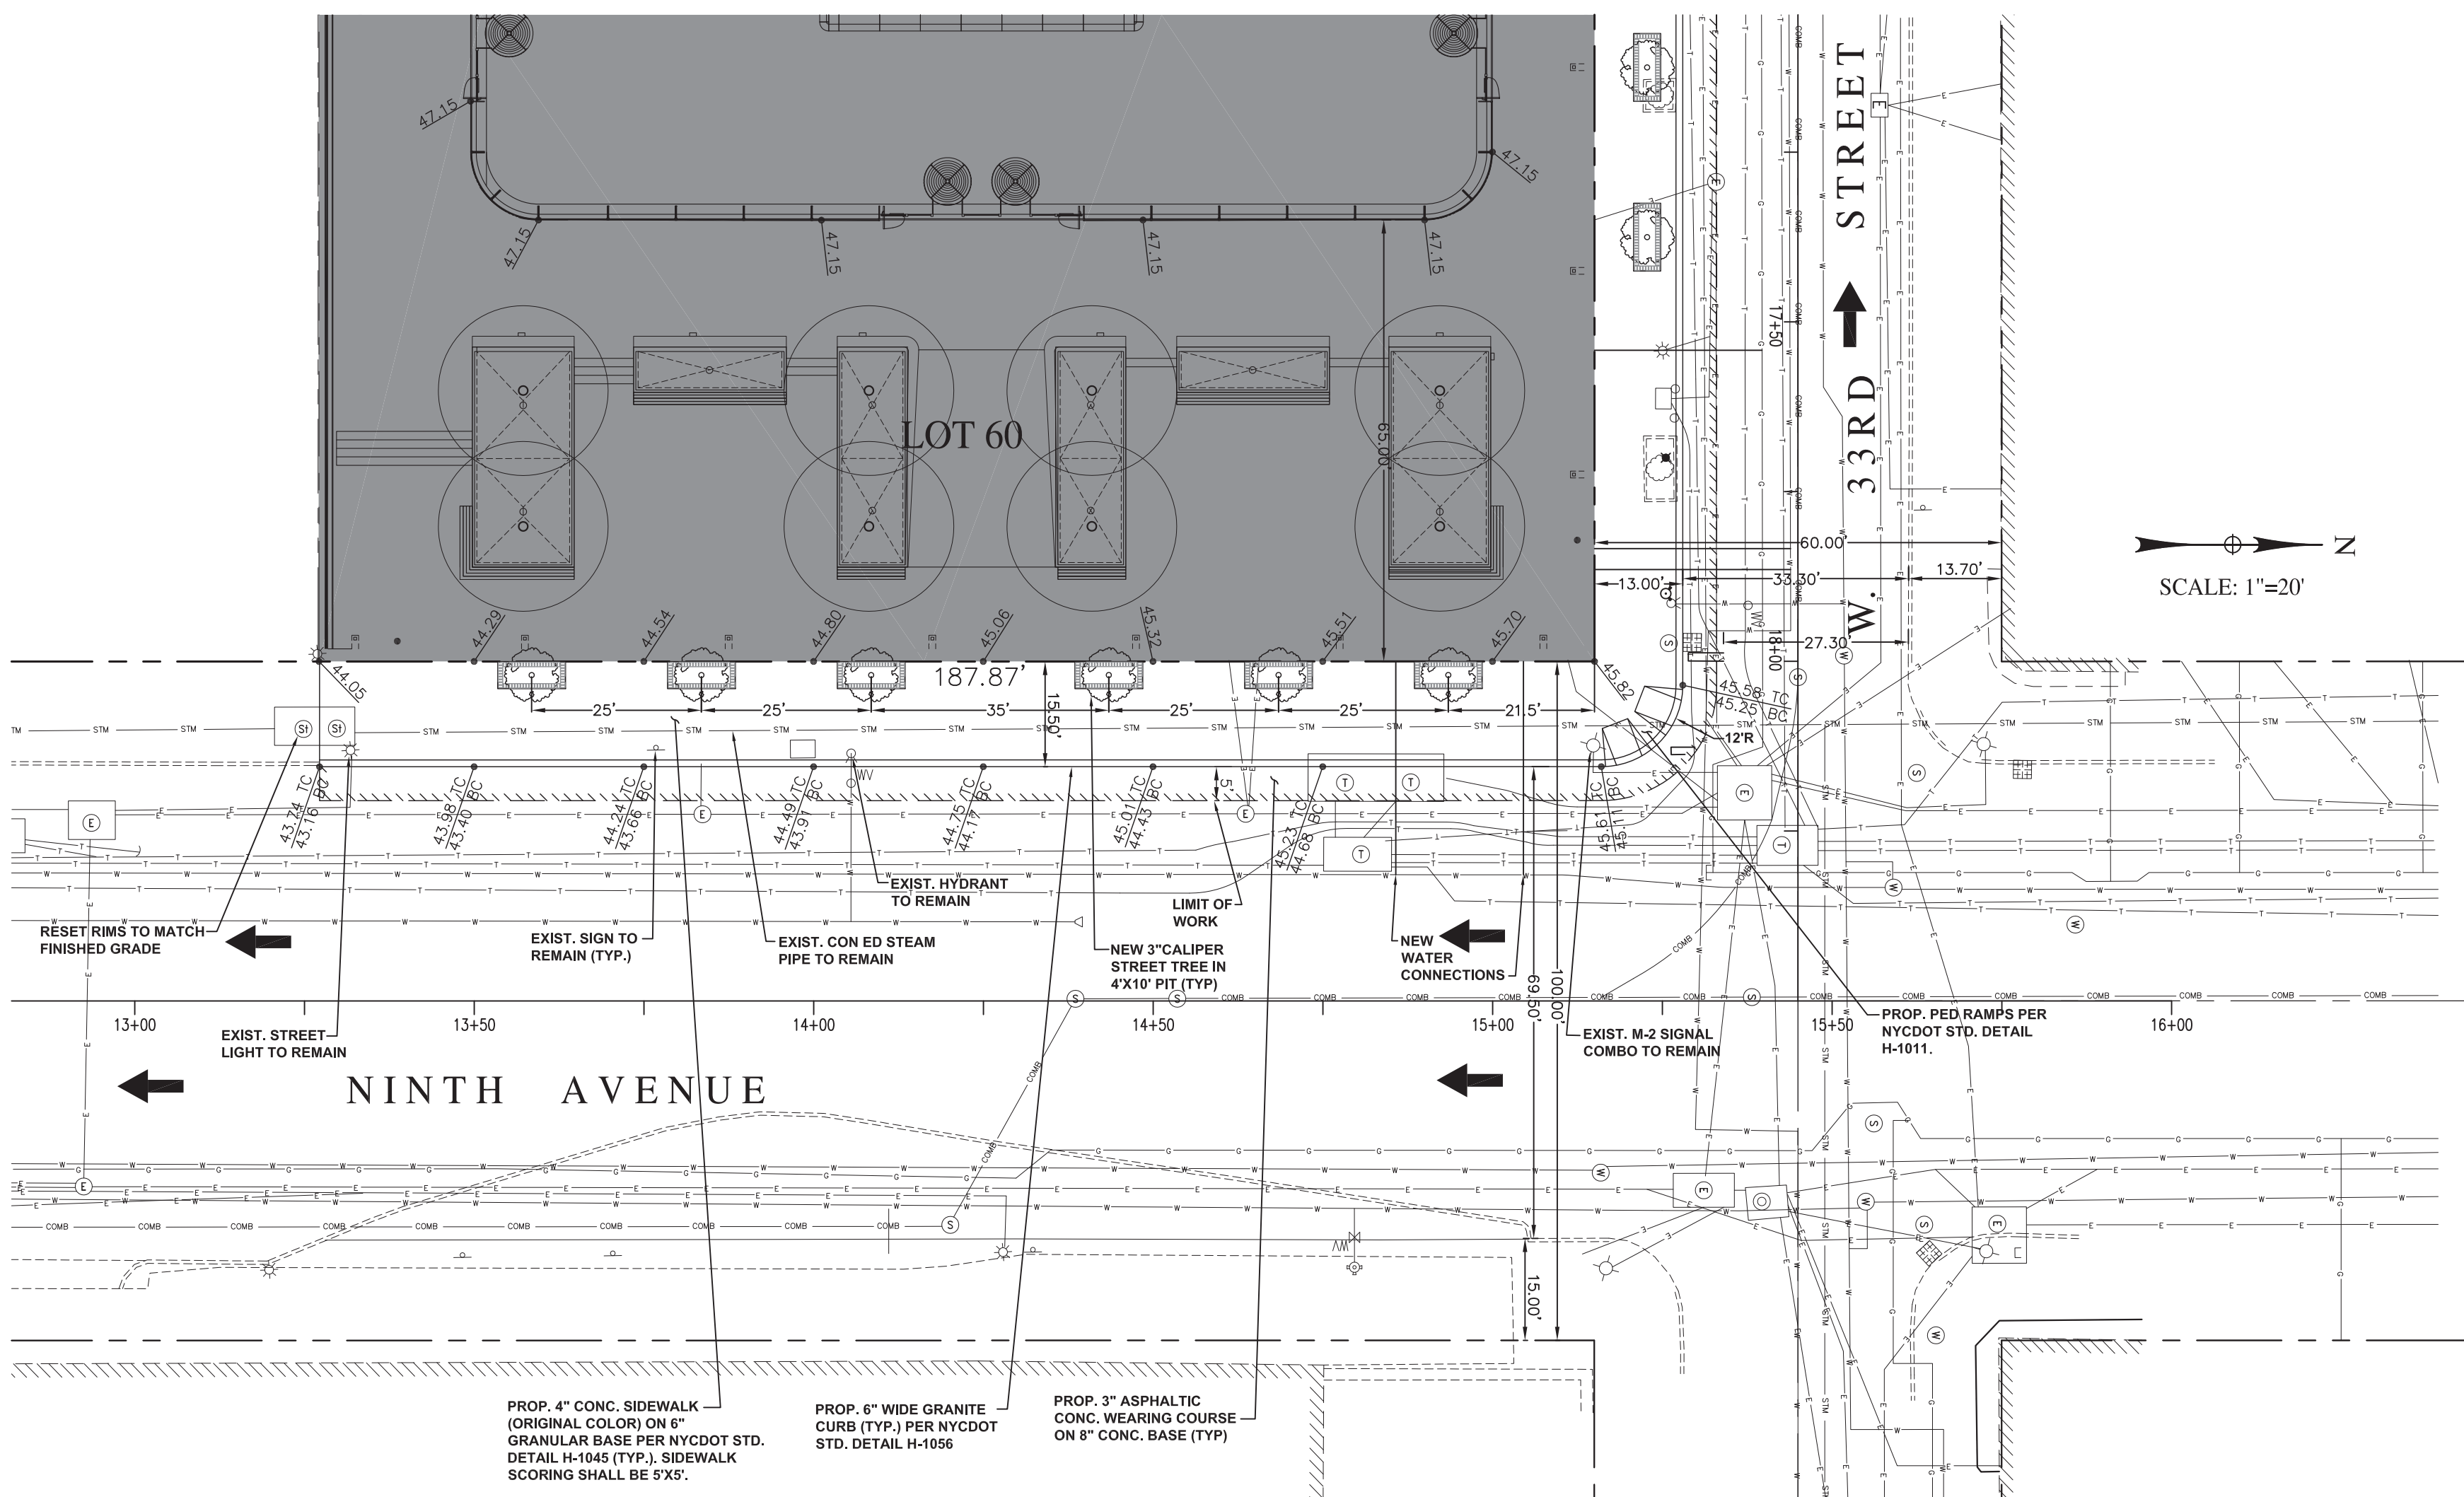

NINTH AVENUE
WEST SIDE
SCALE: H: 1"=20'
V: 1"=1'

LEGEND:

- EXISTING MANHOLE
- PROPOSED MANHOLE
- EXISTING STREET LIGHT
- PROPOSED/RELOCATED STREET LIGHT
- EXISTING HYDRANT WITH STEEL FENDERS
- EXISTING CATCH BASIN OR DRAIN INLET
- PROPOSED CATCH BASIN OR DRAIN INLET
- PEDESTRIAN RAMP
- DROP CURB
- PROPOSED/RELOCATED SIGN
- EXISTING SIGN
- PROPOSED GRADE
- EXISTING TREE & PROPOSED PIT
- PROPOSED TREE & PIT
- PROFILE
- EXISTING CENTERLINE
- PROPOSED CENTERLINE
- PROPOSED PROPERTY LINE
- EXISTING PROPERTY LINE
- PROPOSED TOP OF CURB
- EXISTING TOP OF CURB
- PROPOSED BOTTOM OF CURB
- EXISTING BOTTOM OF CURB
- TC PROPOSED TOP OF CURB
- BC PROPOSED BOTTOM OF CURB
- PPL PROPOSED PROPERTY LINE

MANHATTAN WEST NE TOWER			
9th AVE. PLAN & PROFILE			
PHILIP HABIB & ASSOCIATES 220 WEST 20TH STREET NEW YORK, NY 10011	DATE 6/20/2014		
Scale: AS SHOWN		Sheet 3 of 4	
DOB Ref. No.: -----		BPP 102.00	

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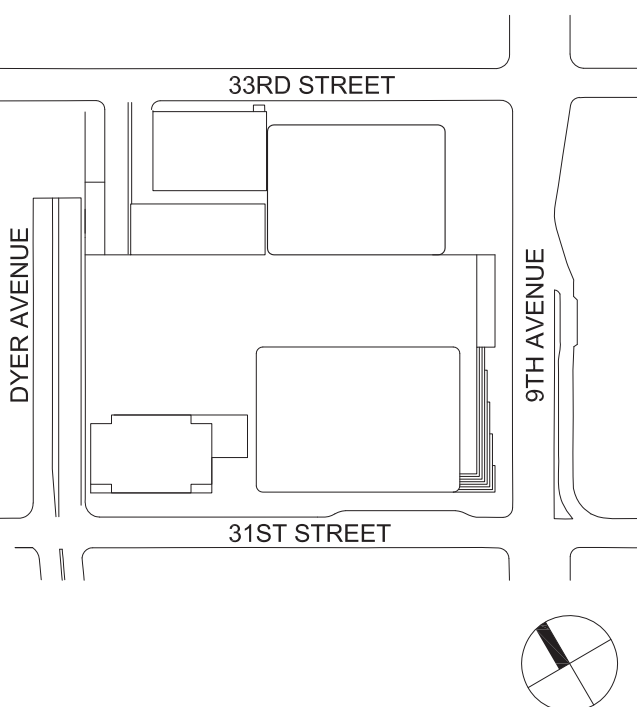
Facade Maintenance Consultant

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185 Ames Street, Hackensack, NJ 07601

Wind Tunnel Consultant

Rowan Williams Davies & Irwin Inc.
650 Woodlawn Road West, Guelph
Ontario, Canada N1K 1S8

Key Plan:



Seal & Signature:




4	20 JUN 2014	ISSUED FOR FOUNDATION PERMIT
3	20 DEC 2013	ISSUED FOR FOUNDATION PERMIT
2	15 NOV 2013	ISSUED FOR DD PROGRESS PRICING
1	12 JUL 2013	ISSUED FOR 50% DESIGN DEVELOPMENT

No. Date Description
Sheet Name:


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Project No.: 201120	B-SCAN Sheet No.:
Date: 20 DEC 2013	BPP-103.00
Scale: 1" = 20'	BPP-103
File No.:	Page No.: 4 OF 4

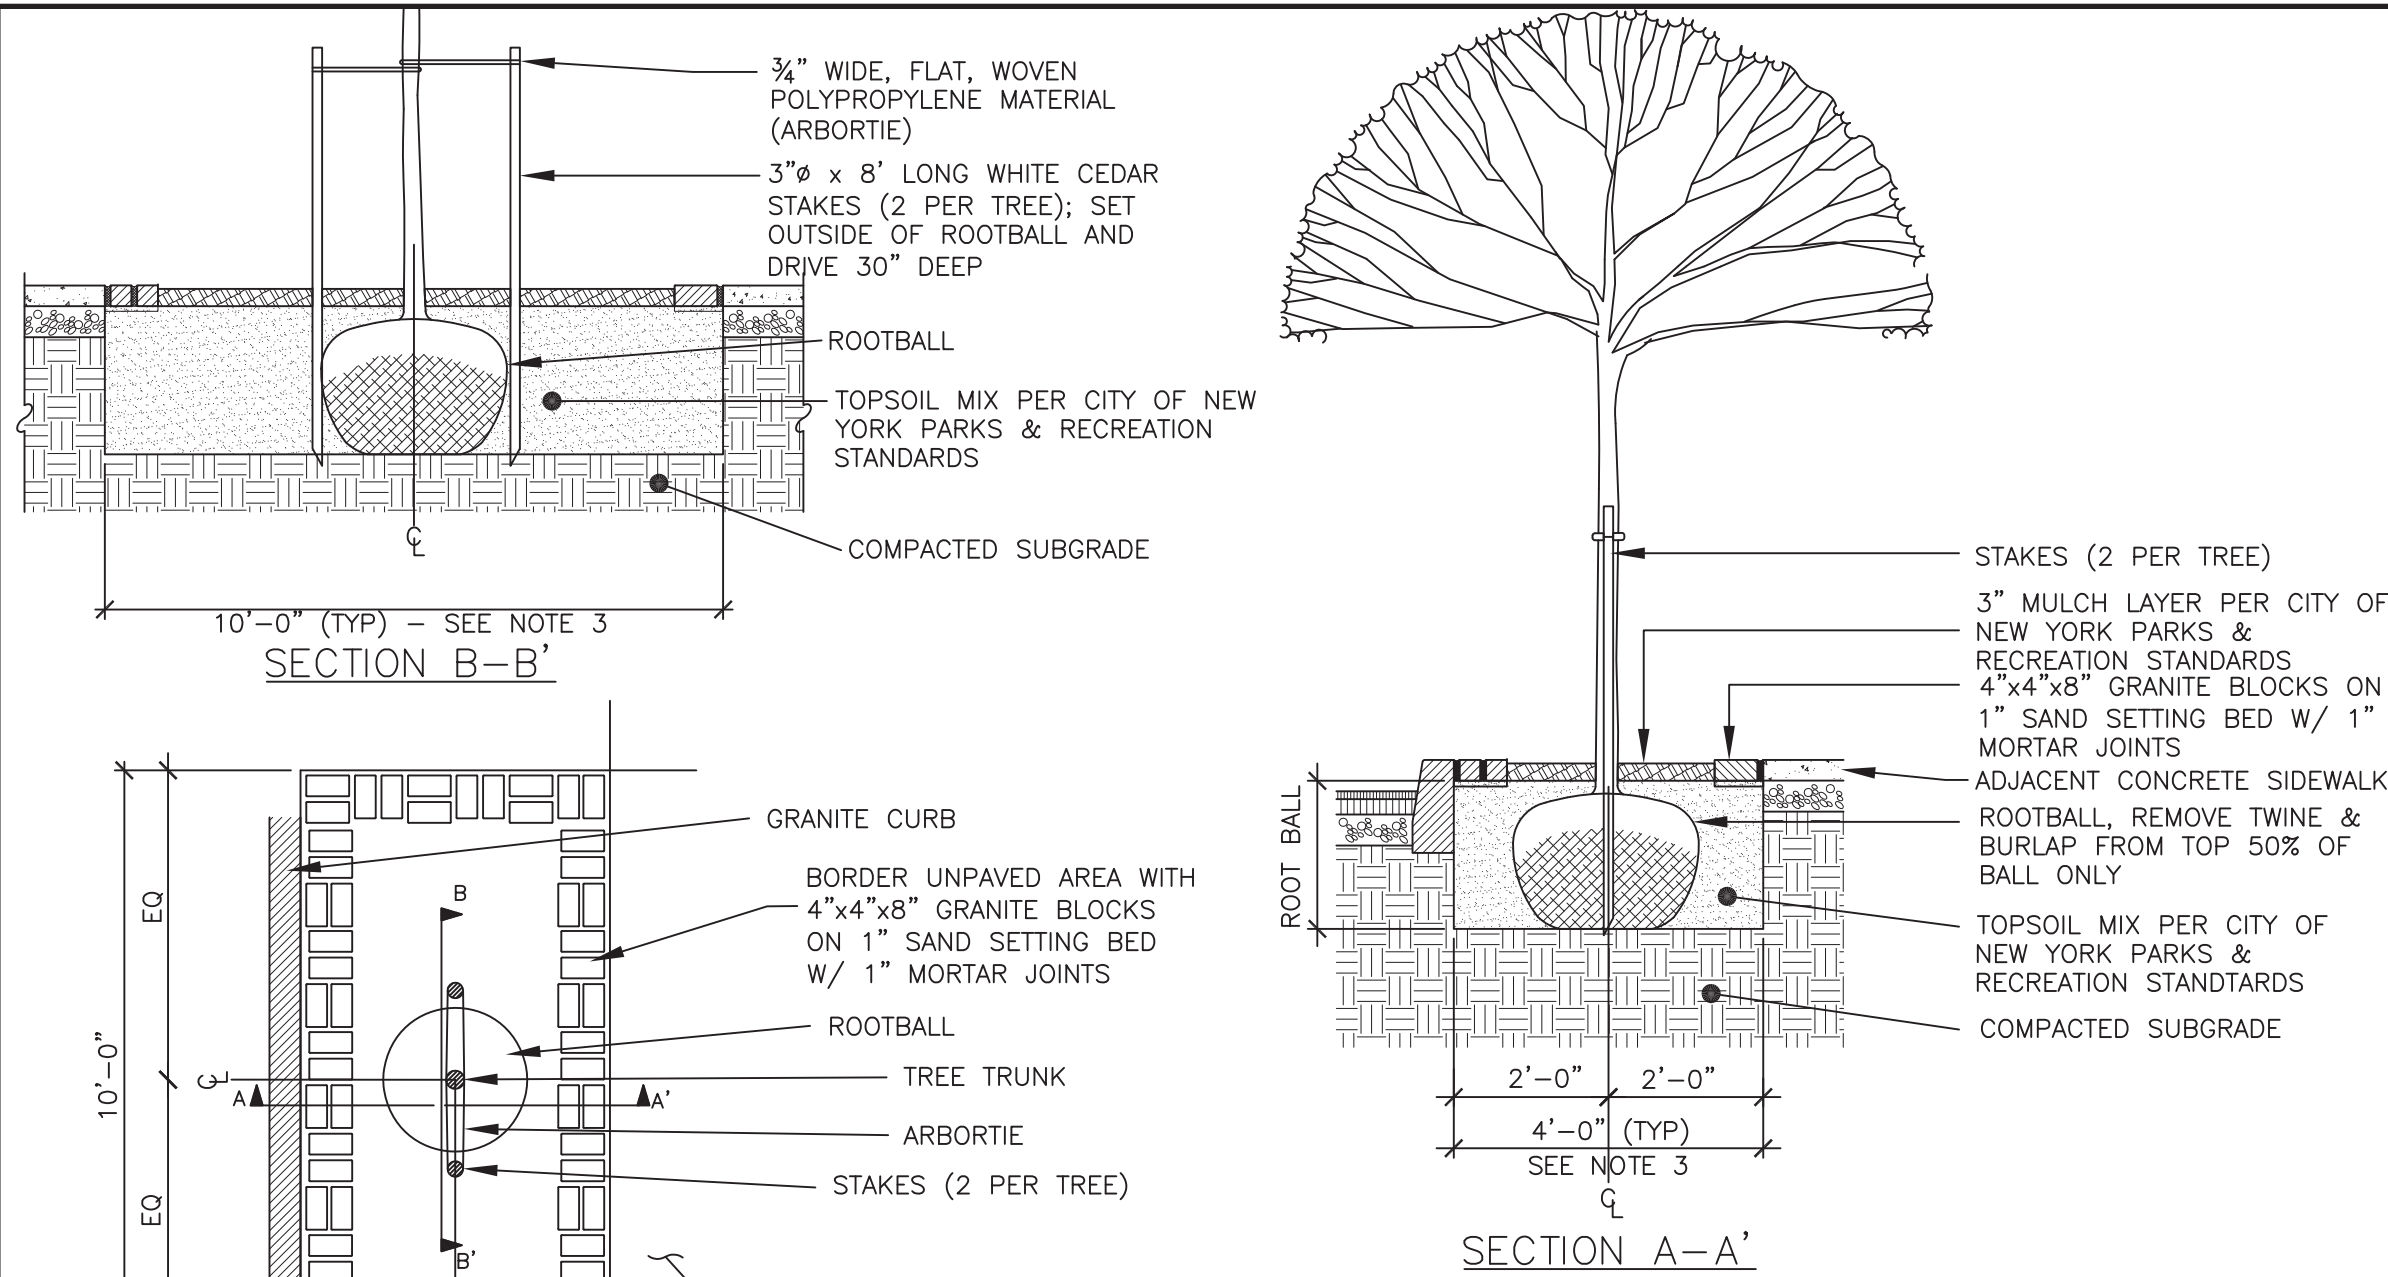


6 STANDARD STREET TREE
SCALE: N.T.S.

NOTES:
1. ALL STREET TREE PLANTINGS REQUIRE CITY OF NEW YORK PARKS & RECREATION APPROVED PERMIT.
2. ANY TREE WORK IMPROPERLY PERFORMED OR OTHERWISE NOT IN ACCORDANCE WITH CITY OF NEW YORK PARKS & RECREATION STANDARDS WILL BE SUBJECT TO RESTITUTION AND PENALTY AT THE EXPENSE OF THE PROPERTY OWNER.
3. OPTIMAL TREE PIT SIZE IS 4'x10' OR 5'x10'. SEE PLANS FOR INDIVIDUAL TREE PIT SIZES. REFER TO CITY OF NEW YORK PARKS & RECREATION TREE PIT CONFIGURATION SHEET FOR ALTERNATE SIZES.

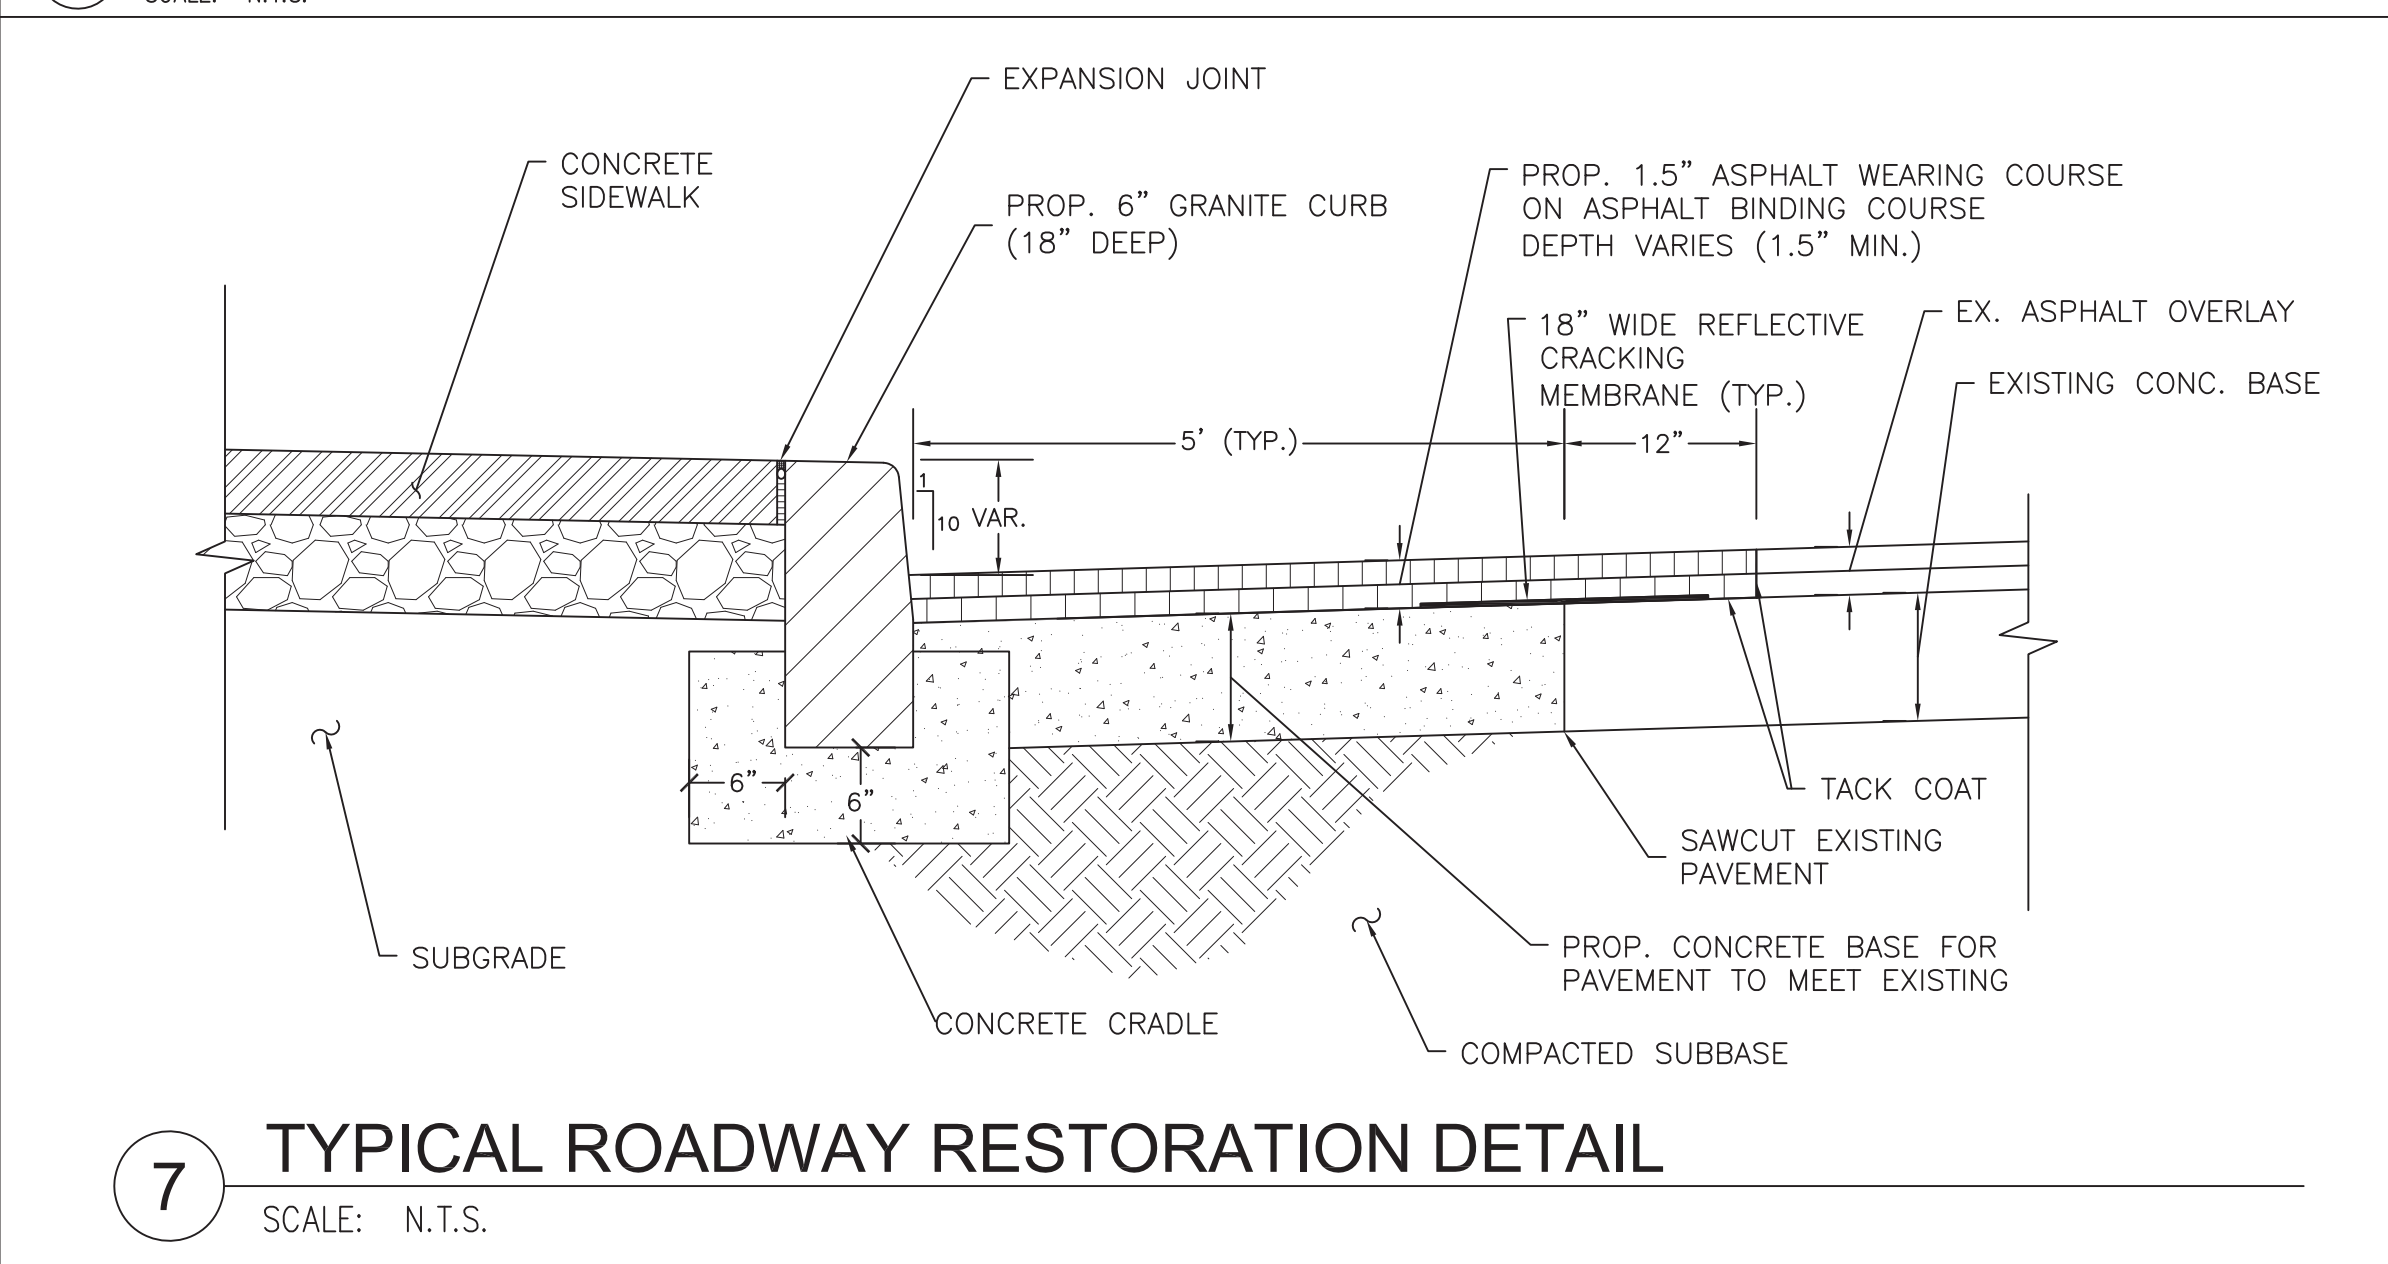


7 TYPICAL ROADWAY RESTORATION DETAIL
SCALE: N.T.S.


- NOTES
1. CONCRETE COLLARS SHALL BE INSTALLED SUCH THAT FINISHED CONC. SIDEWALK LIES FLUSH WITH ADJACENT CONC. SIDEWALK.
 2. ALL PARTS OF HYDRANT FENDER SHALL BE CLEANED OF SCALE, RUST AND DIRT AND BE COATED ON THE OUTSIDE WITH ONE COAT OF RED LEAD AND ONE COAT OF BLACK ASPHALT PAINT BELOW THE GROUND AND ONE COAT OF ALUMINUM PAINT ABOVE THE GROUND. COLOR TO BE DETERMINED.
 3. FIRE HYDRANT FENDERS SHOULD RECEIVE DECORATIVE CAPS AND SHALL BE PAINTED BLACK. SEE STANDARD NYCDEP (WATER SUPPLY) DRAWING 49500-2 FOR DETAILS.

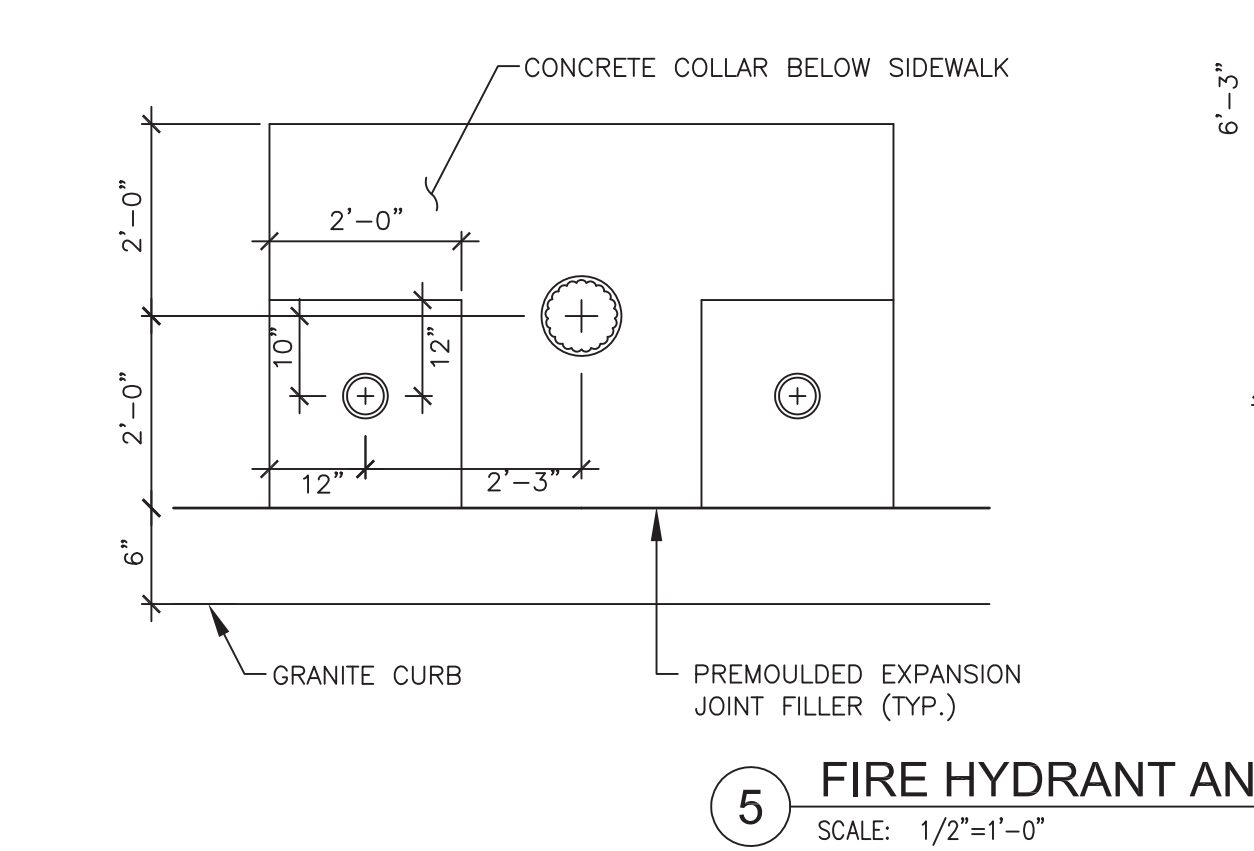


5 FIRE HYDRANT AND FENDER LAYOUT
SCALE: 1/2"=1'-0"

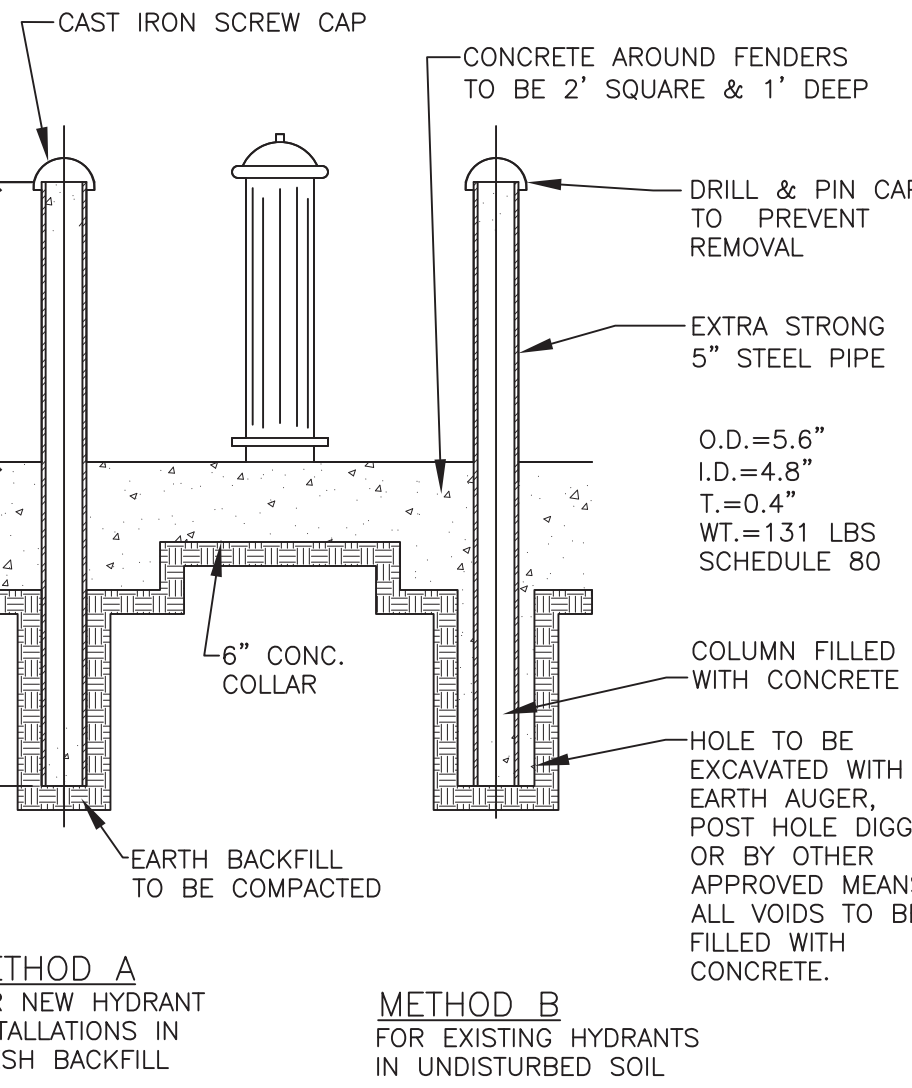


6 SIDEWALK AT CORNER
SCALE: N.T.S.

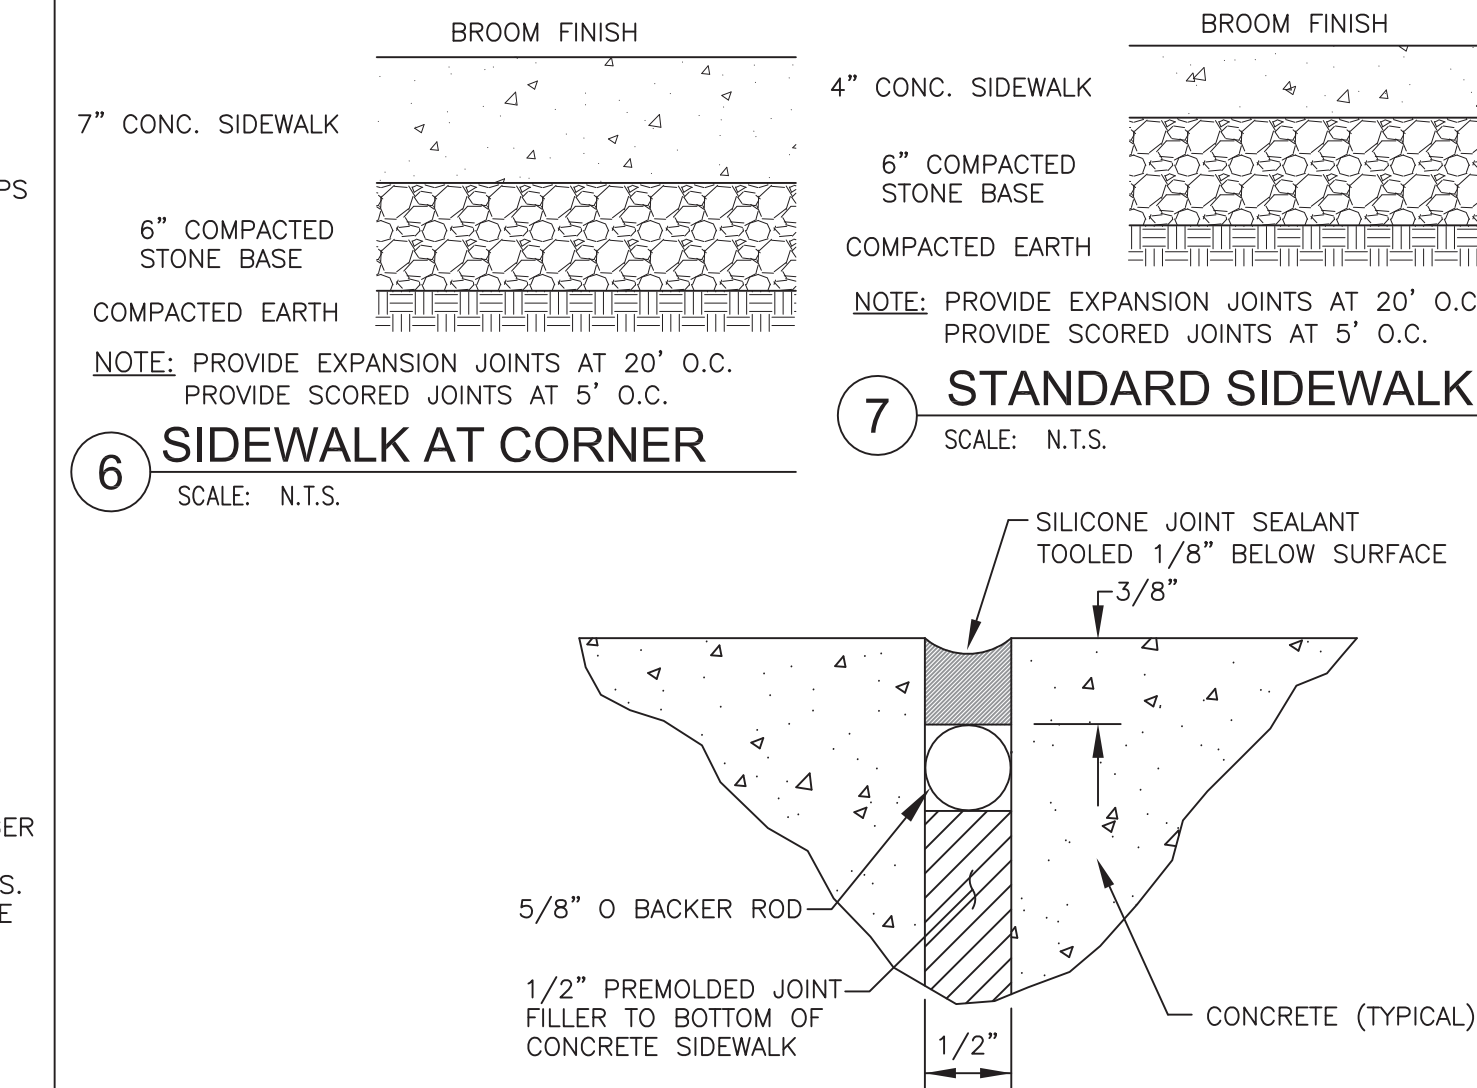


7 STANDARD SIDEWALK
SCALE: N.T.S.

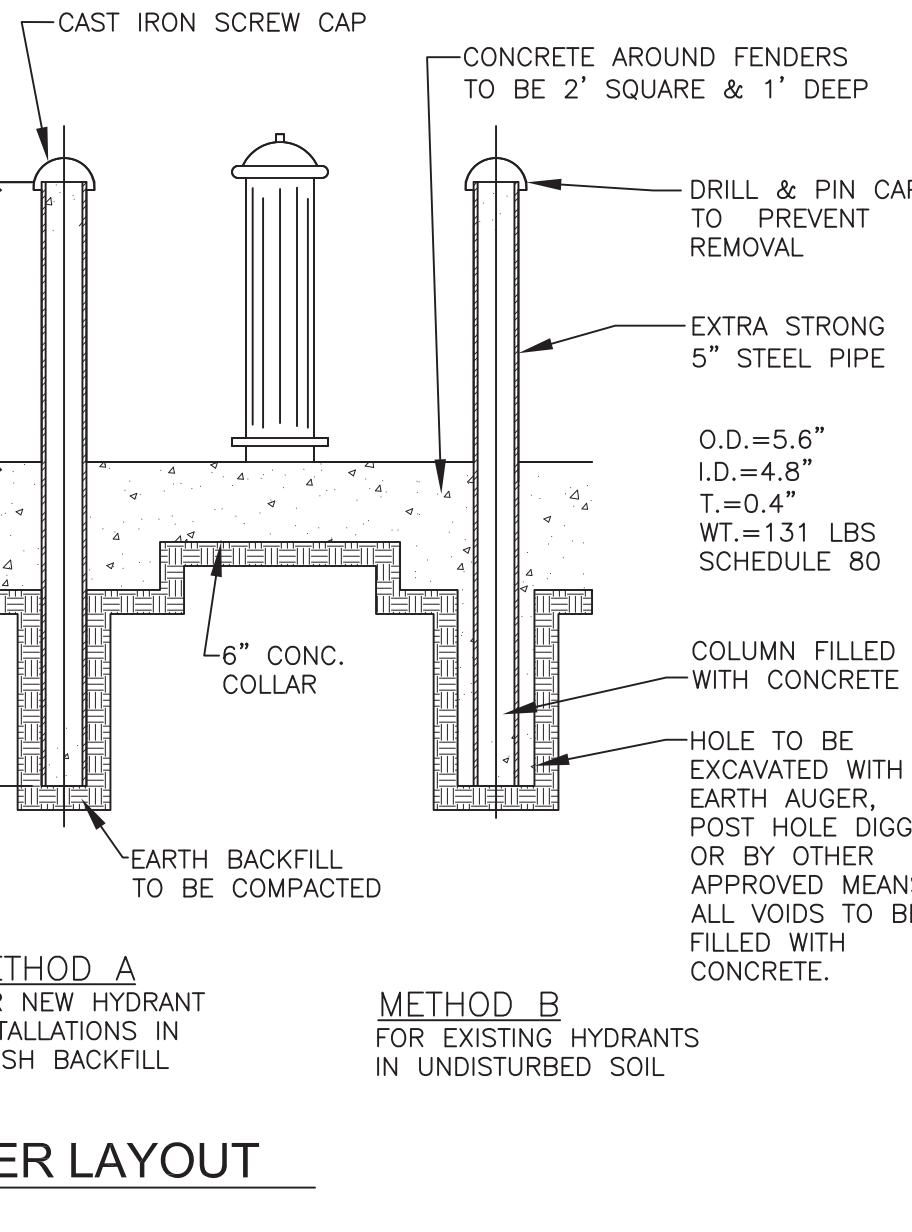


8 CURB EXPANSION JOINT DETAIL
SCALE: N.T.S.

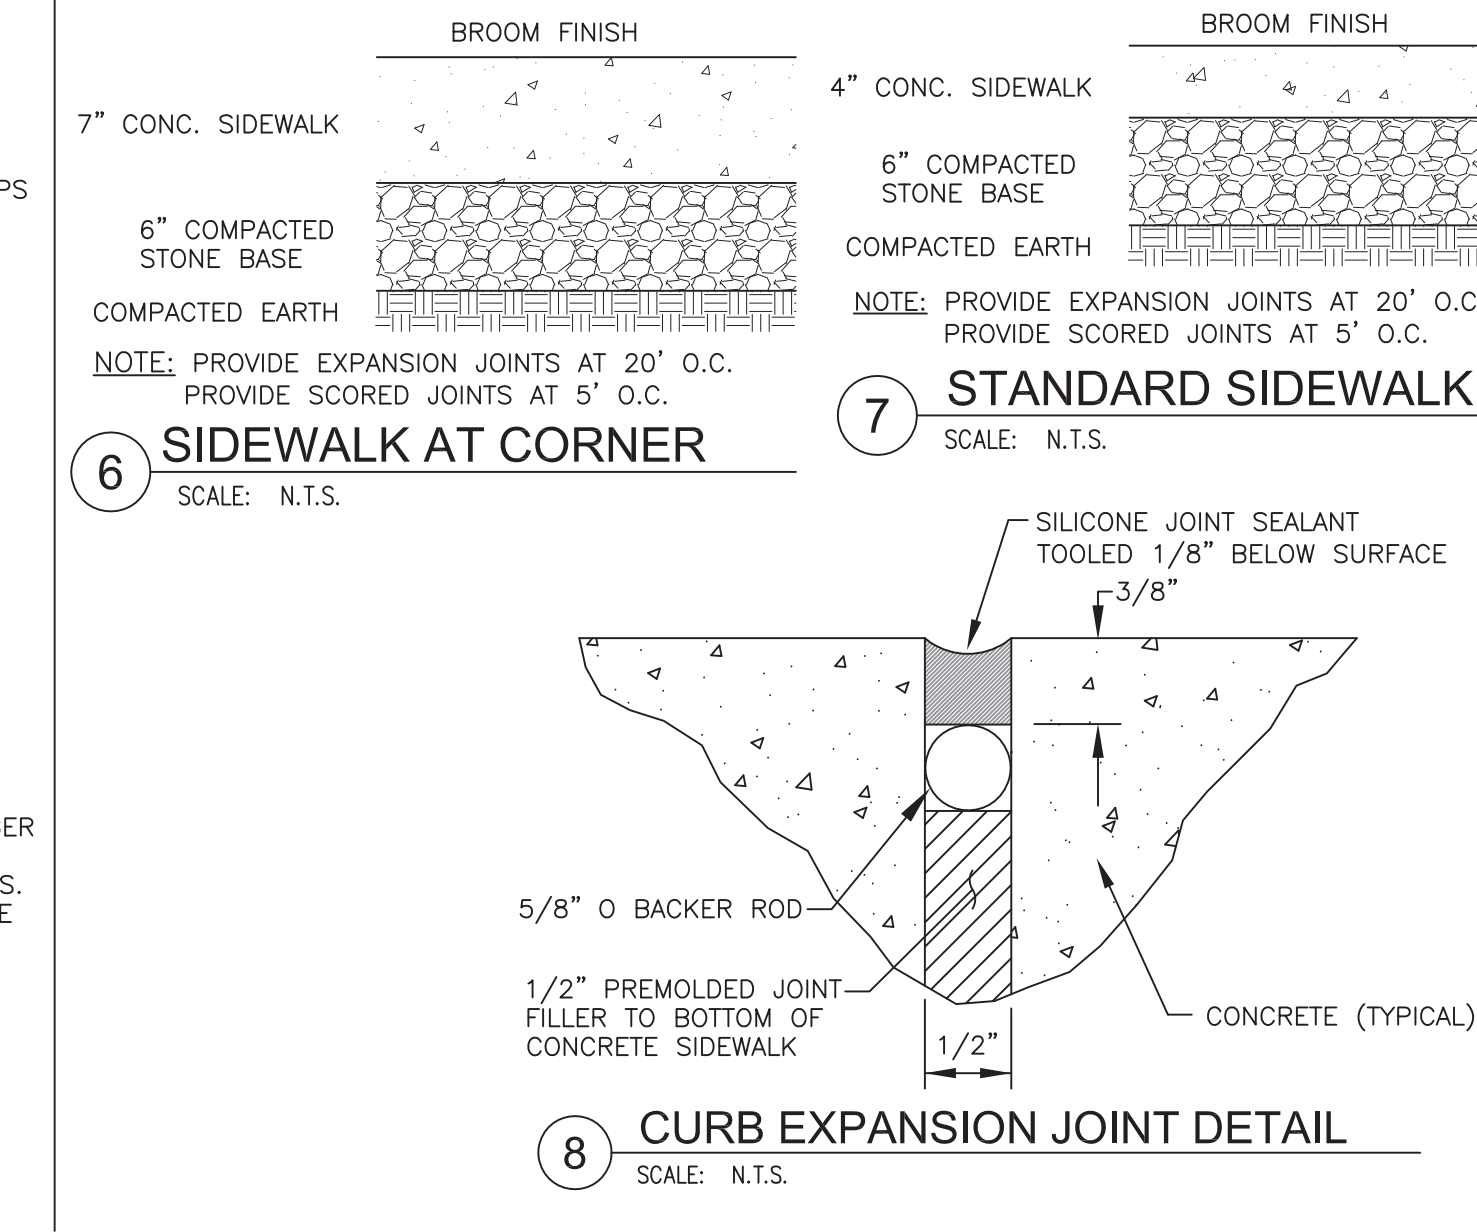


10 EXPANSION JOINT DETAIL
SCALE: N.T.S.

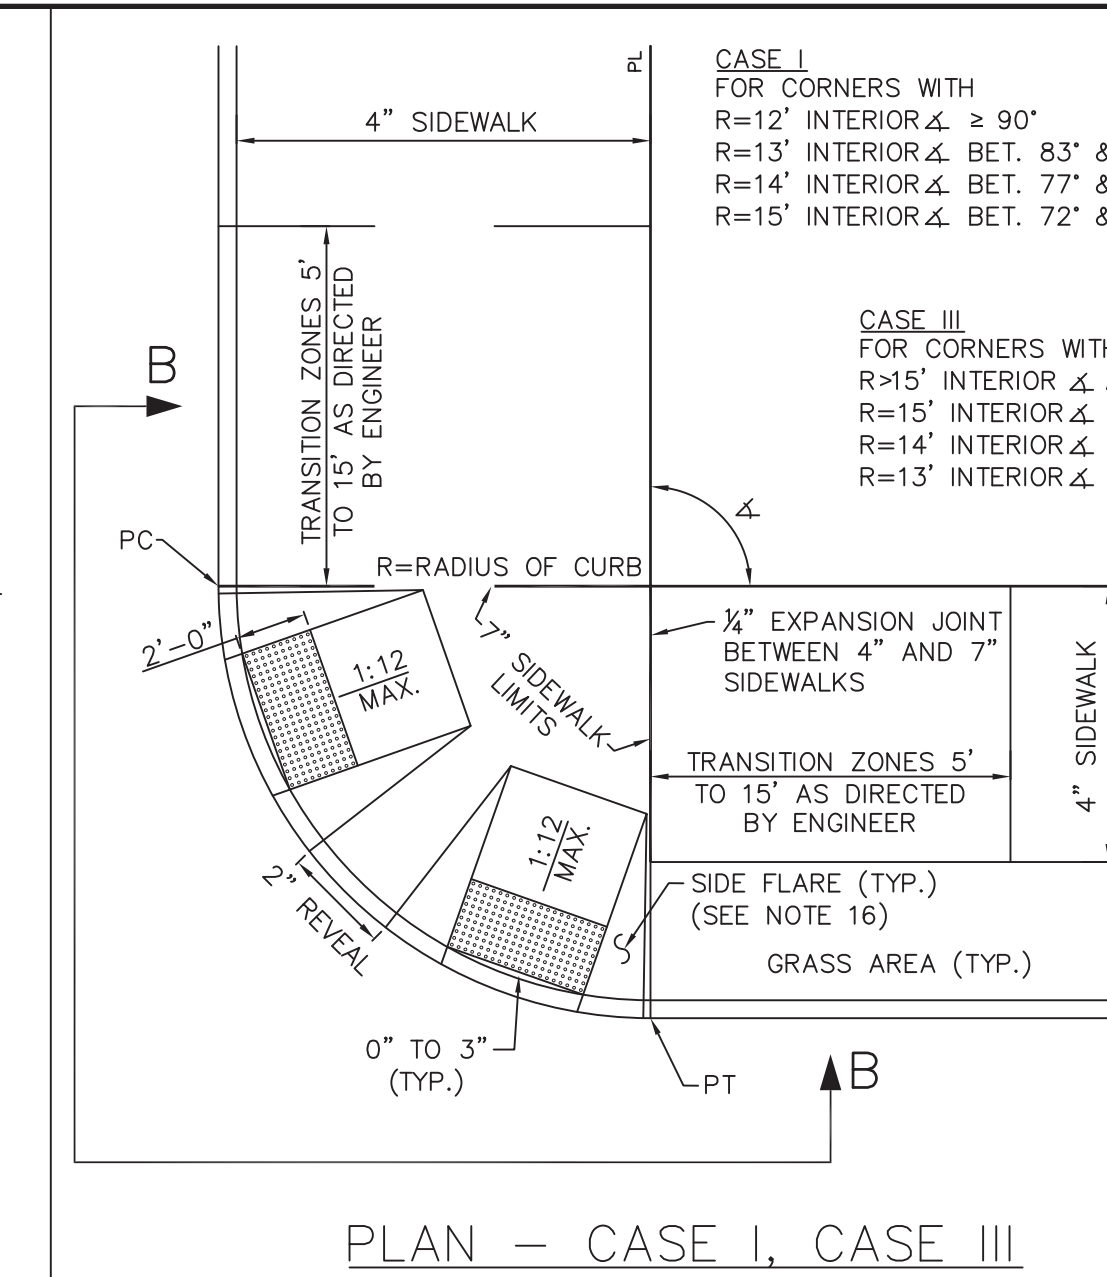


PLAN - CASE I, CASE III
N.T.S.

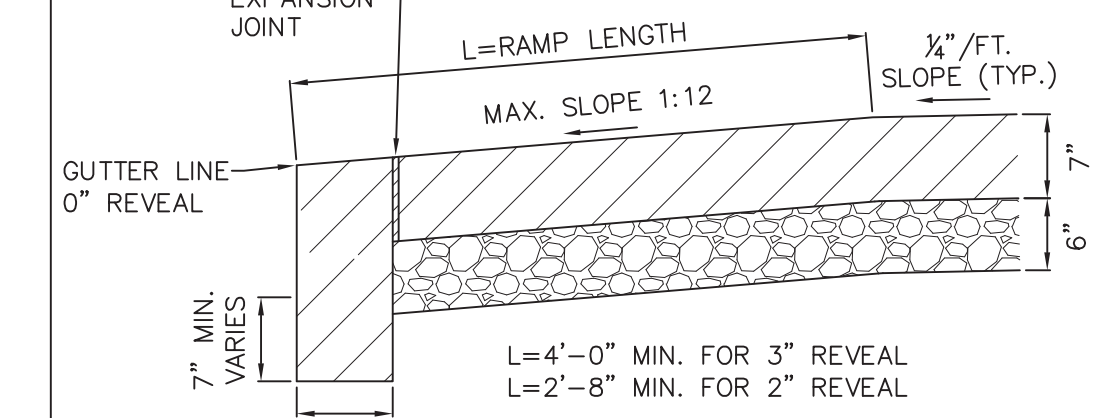

SECTION A-A
N.T.S.

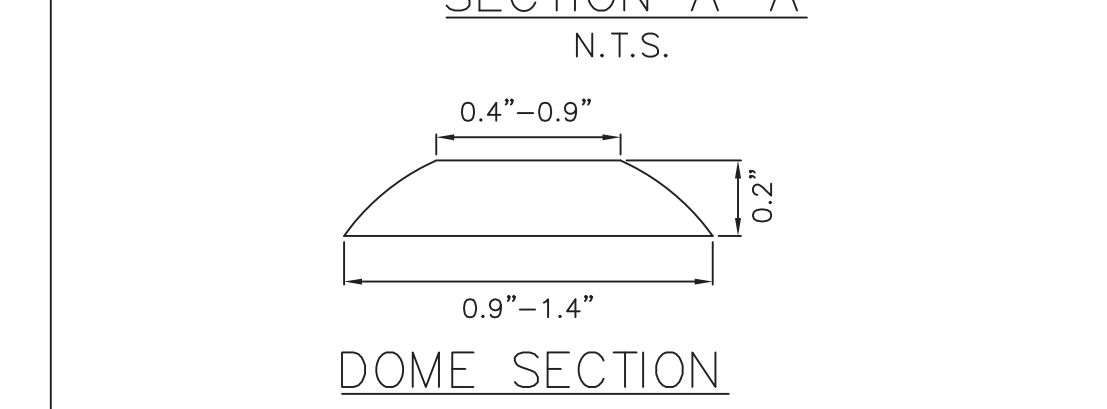


DOME SECTION
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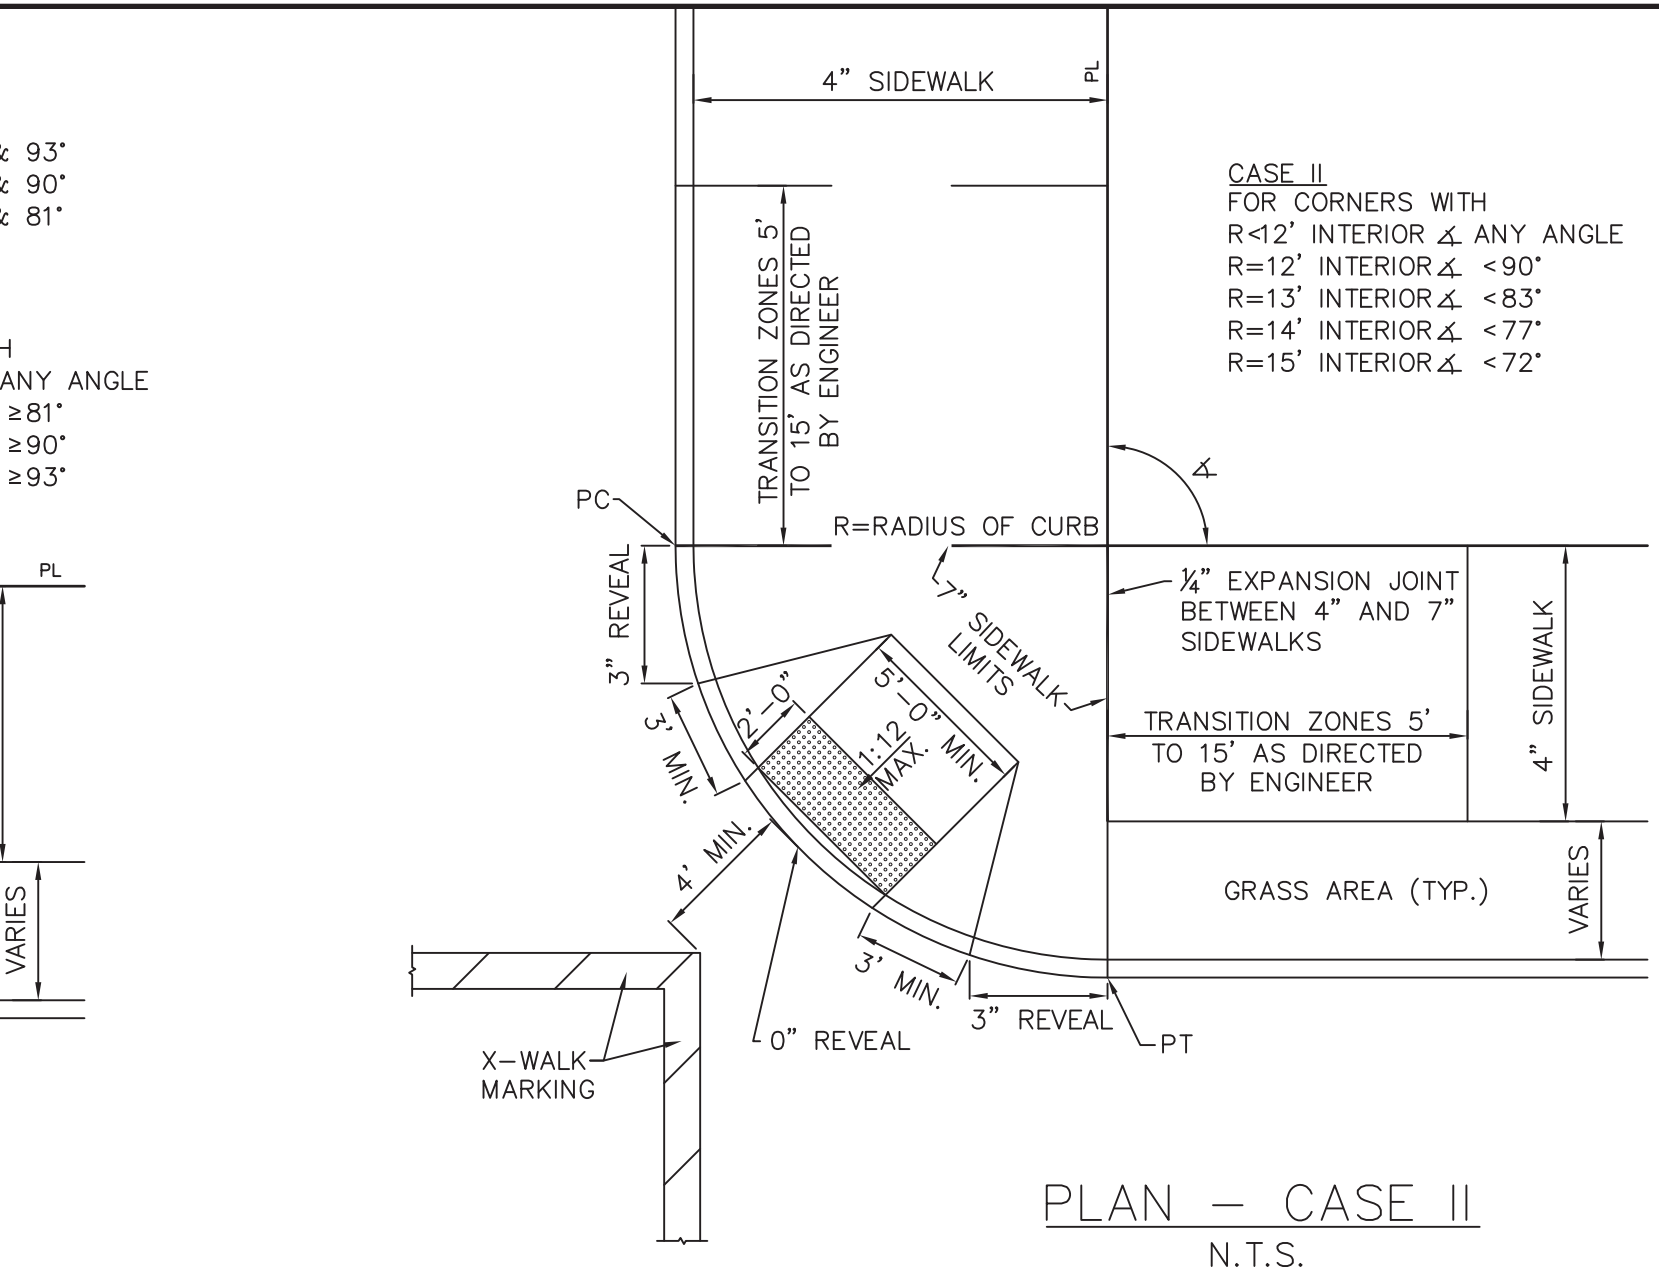
DOME SPACING
N.T.S.

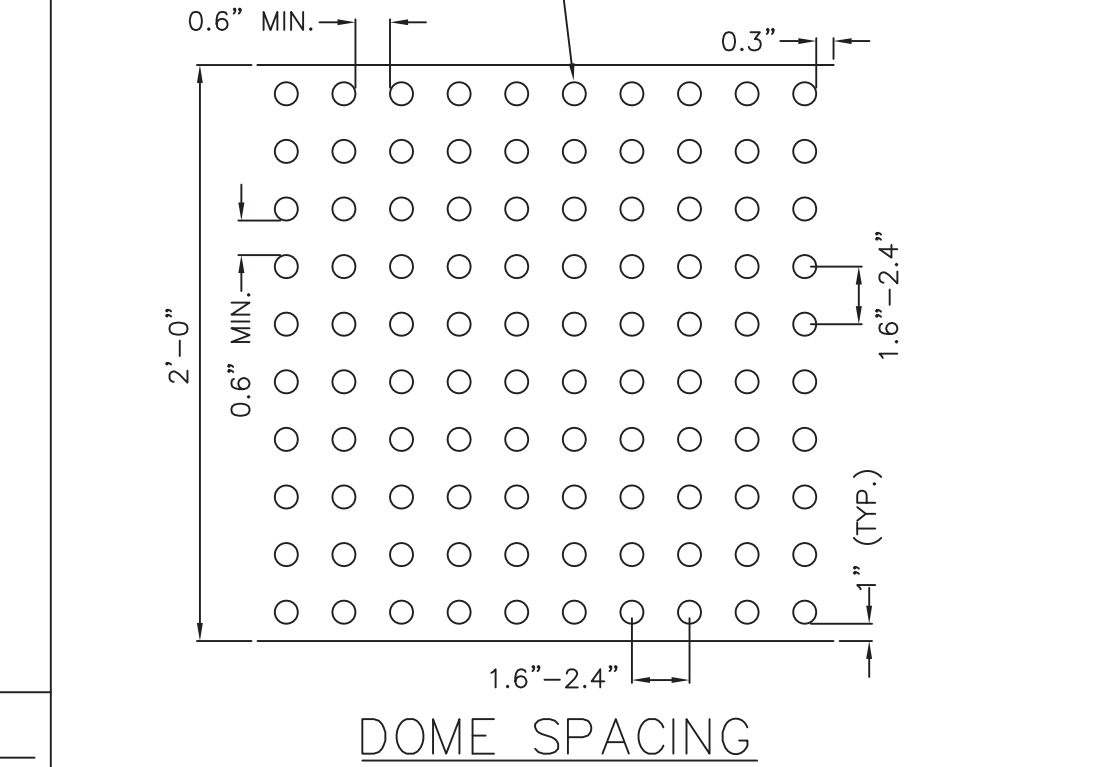DETECTABLE WARNING SURFACE DETAILS


10 SIDEWALK PEDESTRIAN RAMP
SCALE: N.T.S.



10 EXPANSION JOINT DETAIL
SCALE: N.T.S.

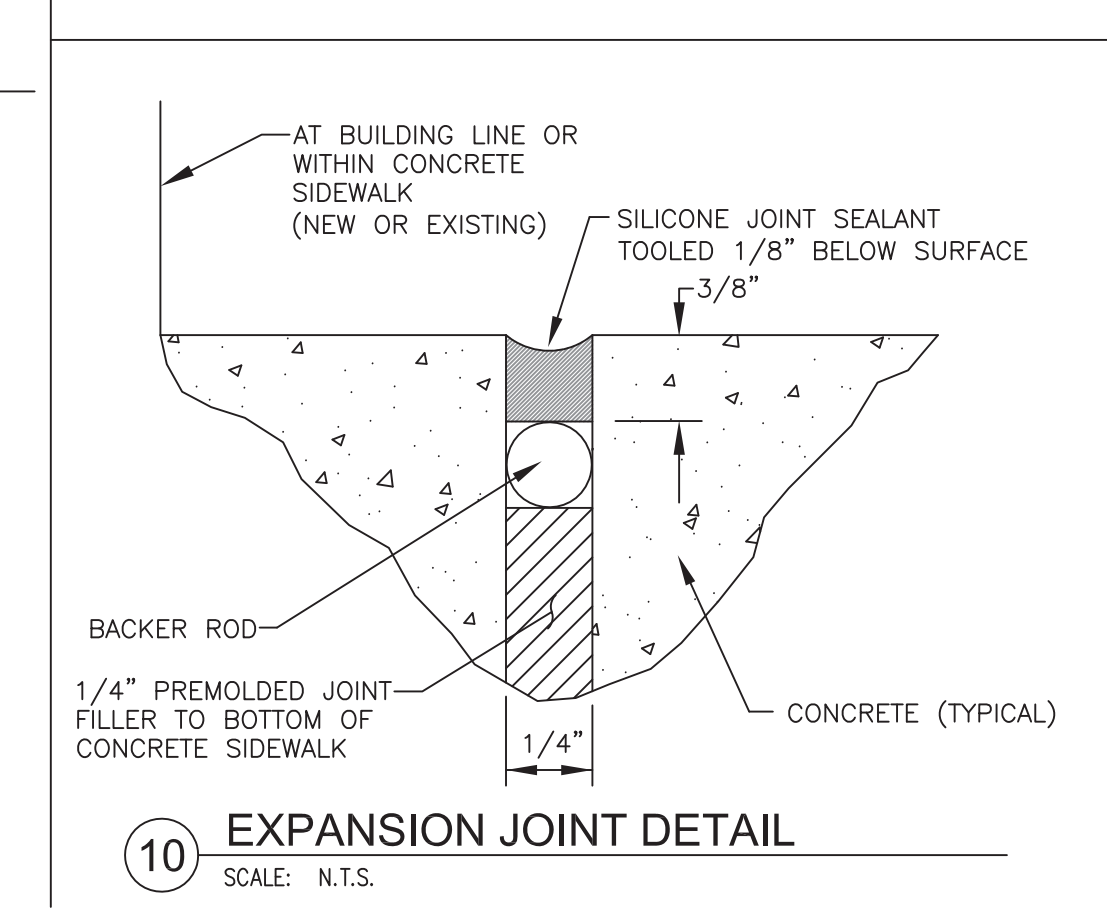

PLAN - CASE II
N.T.S.

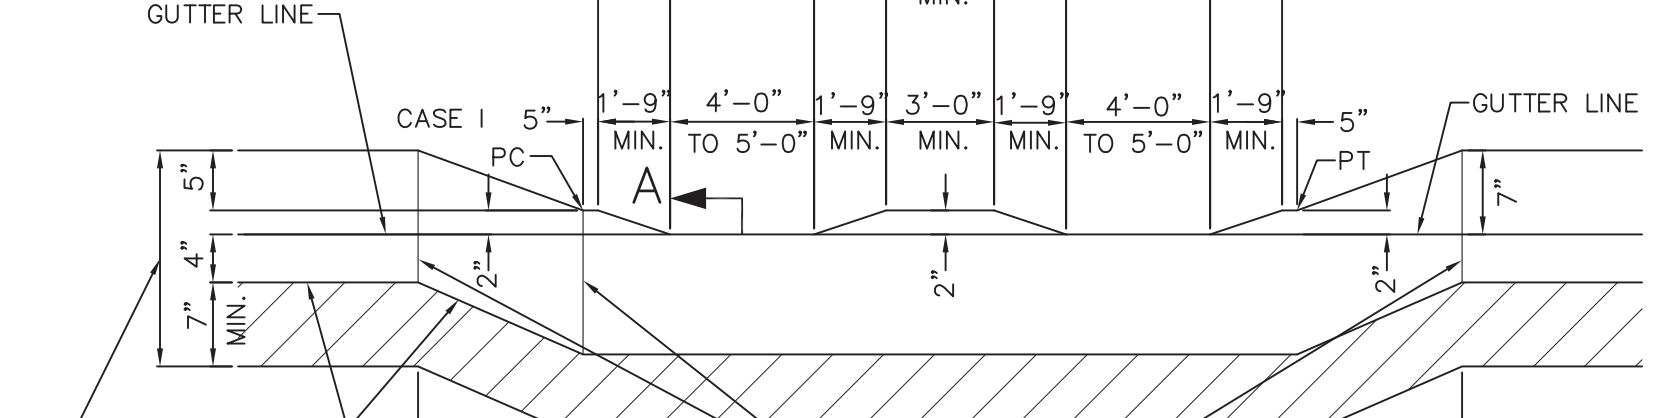

ELEVATION B-B
N.T.S.

- NOTES
1. REFER TO H-1010 (LATEST REVISION) FOR STEEL FACED CURB TYPE D.
 2. ALL MATERIALS AND CONSTRUCTION METHODS USED SHALL CONFORM TO SECTIONS #4.08/4.09/4.13/4.13DE OF THE STANDARD SPECIFICATIONS, LATEST EDITION, AS AMENDED.
 3. WHEN INSTALLING PEDESTRIAN RAMPS IN OTHER THAN PRE-ENGINEERED CAPITAL RECONSTRUCTION PROJECTS, ALLOWANCE SHALL BE MADE FOR EXISTING CONDITIONS PROVIDED THAT THE SLOPE OF THE RAMP SHALL NOT EXCEED 1:12 AND THE ZERO INCH REVEAL IS OBTAINED. TO INSURE THAT SOUND ENGINEERING JUDGEMENT IS USED IN MEETING EXISTING CONDITIONS, ANY AND ALL VARIATIONS FROM THE DETAILS OF CONSTRUCTION HEREIN SHOWN MUST HAVE THE JOINT APPROVAL OF THE COMMISSIONER.
 4. CASE II PLAN SHALL BE USED ONLY WHERE EXPLICITLY DIRECTED BY THE ENGINEER AND APPROVED BY THE COMMISSIONER PRIOR TO DESIGN/INSTALLATION.
 5. SURFACE OF ALL PEDESTRIAN RAMPS SHALL BE STABLE, FIRM AND SLIP RESISTANT. CONCRETE RAMP SURFACE SHALL HAVE A COARSE BROOM FINISH RUNNING PERPENDICULAR TO THE SLOPE, EXCLUSIVE OF THE DETECTABLE WARNING FIELDS.
 6. LANDINGS BETWEEN THE PROPERTY LINE AND THE BACK EDGE OF RAMPS SHALL HAVE A MINIMUM CLEAR DIMENSION OF 5 FT. BY 5 FT. SQUARE. HOWEVER, WHERE CASE I RAMPS ARE USED THE MINIMUM CLEAR DIMENSION SHALL BE 4 FT. BY 4 FT. SQUARE. THE MAXIMUM CROSS SLOPE AT LANDINGS IS 1/4" PER FOOT IN ANY DIRECTION. LANDINGS MAY OVERLAP WITH ADJACENT LANDINGS OR A SINGLE LANDING MAY SERVE MULTIPLE CURB RAMPS.
 7. ALL EXPOSED STEEL SURFACES SHALL BE GROUND SMOOTH.
 8. ON FULL WIDTH SIDEWALKS, EXPANSION JOINTS TO BE PLACED AT BUILDING FACES AND STRUCTURES, AS WELL AS AT BACK FACE OF CURB.
 9. ALL DIMENSIONS AND NOTES SHALL BE APPLICABLE TO GRANITE CURB INSTALLATIONS AND/OR CONCRETE CURB INSTALLATIONS.
 10. THE DETAILS PROVIDED ARE NOT DRAWN TO SCALE. THE QUANTITY OF DOMES DEPICTED ON THE DETECTABLE WARNING FIELD (THE DOMES AND THE ENTIRE 2 FT. WIDE SURFACE) IS FOR ILLUSTRATION ONLY.
 11. THE SIZE OF THE DETECTABLE WARNING FIELD SHALL BE 2 FT. IN THE DIRECTION OF TRAVEL AND SHALL EXTEND THE FULL WIDTH OF THE CURB RAMP AS SHOWN, EXCLUSIVE OF SIDE FLARES.
 12. DETECTABLE WARNINGS SHALL BE LOCATED SO THAT THE EDGE OF THE WARNING FIELD NEAREST TO THE ROADWAY OR STREET SURFACE IS 0" TO 3" FROM THE BACK OF CURB AS SHOWN.
 13. DOMES SHALL BE ALIGNED ON A SQUARE GRID IN THE PREDOMINANT DIRECTION OF TRAVEL.
 14. THE DETECTABLE WARNING FIELD SHALL BE THE COLOR SPECIFIED IN THE CONTRACT DOCUMENTS OR SHALL VISUALLY CONTRAST WITH THE ADJOINING CURB RAMP, OR OTHER ADJACENT WALKWAY SURFACES WHERE THERE IS NO CURB RAMP, EITHER LIGHT-ON-DARK, OR DARK-ON-LIGHT AS DEFINED IN THE AMERICANS WITH DISABILITIES ACCESSIBILITY GUIDELINES (ADAG).
 15. PAVEMENT LINES FOR DETECTABLE WARNING UNITS ARE THE 2FT. DIMENSION SHOWN IN THE DETAILS EXTENDING THE FULL WIDTH OF THE CURB RAMP.
 16. WHEN STREET FURNITURE (LAMP POSTS, TRAFFIC SIGNAL POSTS, UTILITY POSTS, HYDRANTS, ETC.) INTERFERES WITH THE CONSTRUCTION OF A SIDE FLARE ADJACENT TO A NON-WALKING (GRASS) AREA, SAID SIDE FLARE SHALL BE REPLACED WITH A CONCRETE CURB, AS DIRECTED BY THE ENGINEER, PROVIDED THE INTERFERENCE CAN BE AVOIDED AND LEFT IN PLACE.
 17. REFER TO NYC DOT DRAWING H-1011 FOR LATEST REVISION (R9/06).

MANHATTAN WEST NE TOWER DETAILS		
PHILIP HABIB & ASSOCIATES 102 MADISON AVENUE NEW YORK, NY 10016	DATE 6/20/2014	
Scale: AS SHOWN	Sheet 4 of 4	
DOB Ref. No.: -----	BPP 103.00	



SHEET NOTES

1. ALL BUILDING ELEVATIONS (IN FEET) REFERENCED TO THE NORTH AMERICAN VERTICAL DATUM OF 1988 (NAV88).
2. FOR GENERAL NOTES, BUILDING DEPARTMENT NOTES, AND CLARIFICATION OF THE WORK NOTES REFER TO SHEET NO. G-005.
3. FOR ARCHITECTURAL ABBREVIATIONS, LEGEND OF SYMBOLS & MATERIALS, AND MOUNTING HEIGHTS REFER TO SHEET NO. G-006.
4. FOR ROOM FINISH SCHEDULE SEE A-700 SERIES DRAWINGS.
5. FOR DOOR SCHEDULE SEE A-700 SERIES DRAWINGS. FOR DOOR HARDWARE SPECIFICATION SEE TECHNICAL SPECIFICATION SECTION (05100).
6. FOR PARTITION TYPES SEE A-700 SERIES DRAWINGS.
7. FOR REFLECTED CEILING PLANS SEE A-600 SERIES DRAWINGS. IF RCP IS NOT PROVIDED SEE MEP/FP ASSOCIATE SERVICE DRAWINGS FOR LOCATIONS OR ALL CEILING/WALL MOUNTED DEVICES.
8. FOR STRUCTURAL COLUMNS, EDGE OF SLAB, AND CORE WORK POINTS SEE STRUCTURAL SERIES DRAWINGS, UNO.
9. REFER TO STRUCTURAL SERIES DRAWINGS FOR ALL STRUCTURAL WALL DESIGNATIONS AND DIMENSIONS.
10. REFER TO MEP/FP DRAWINGS FOR ALL MECHANICAL, ELECTRICAL, PLUMBING AND FIRE PROTECTION ROOM, RISER AND EQUIPMENT DESIGNATIONS.



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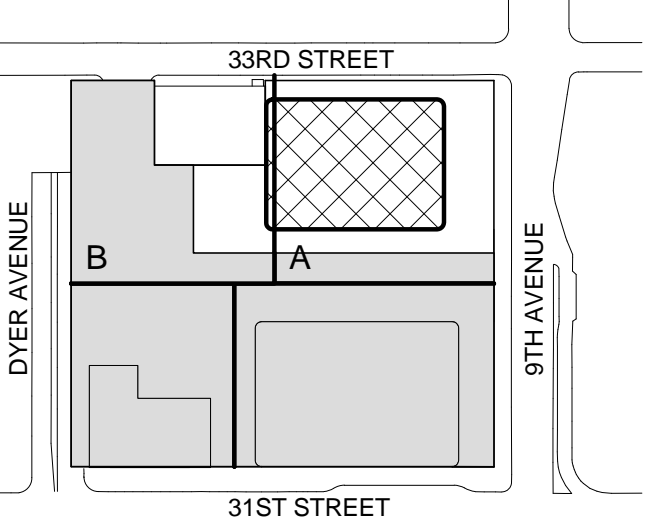
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PRELIMINARY
NOT FOR CONSTRUCTION

Key Plan:




Seal & Signature:



Warning: It is a violation of the New York State Architecture Law, §19-50b) for any person, unless they are acting under the direction of a Licensed Architect, to alter this item in any way.

KEY PLAN -
CELLAR B1

Project No.: 207150
Date: 20 JUN 2014
Scale: 1" = 20'-0"
File No.: A-005
B-SCAN Sheet No.: A-005.00
Sheet No.: A-005
Page No.: 8 OF 87

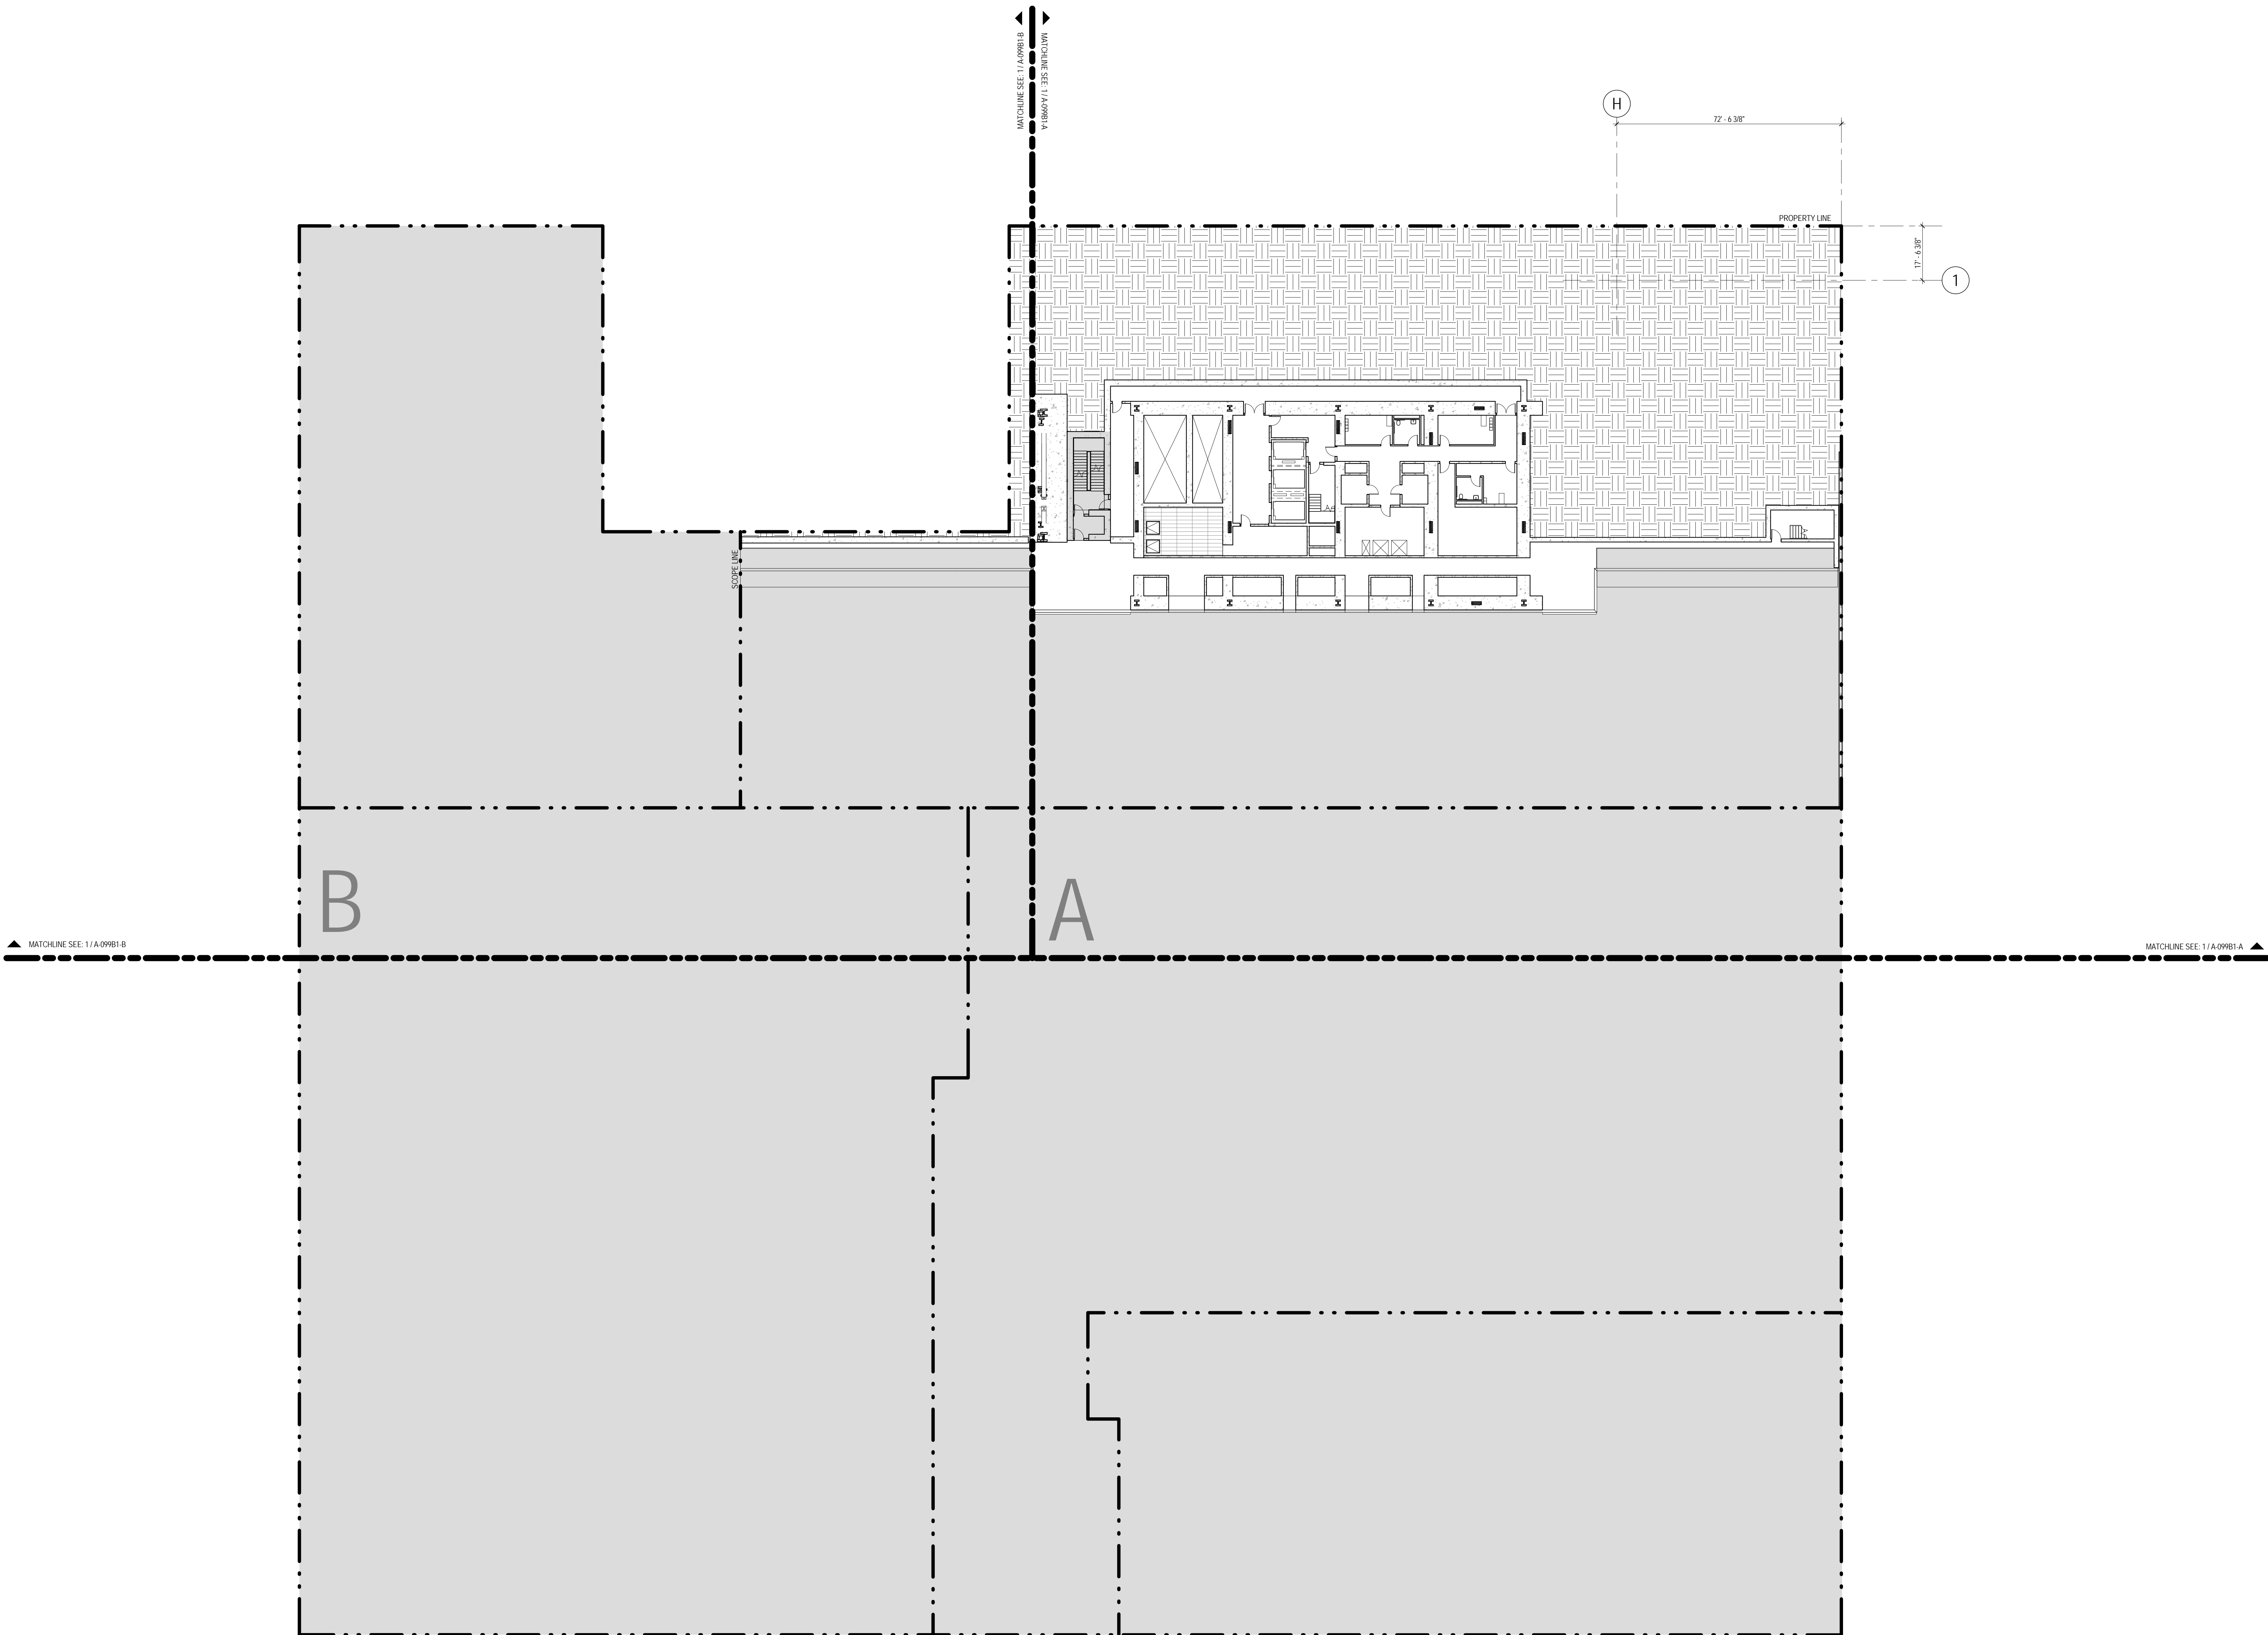

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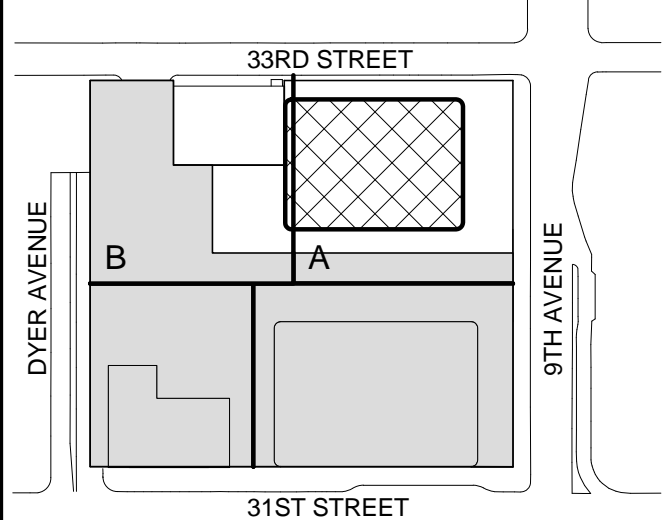
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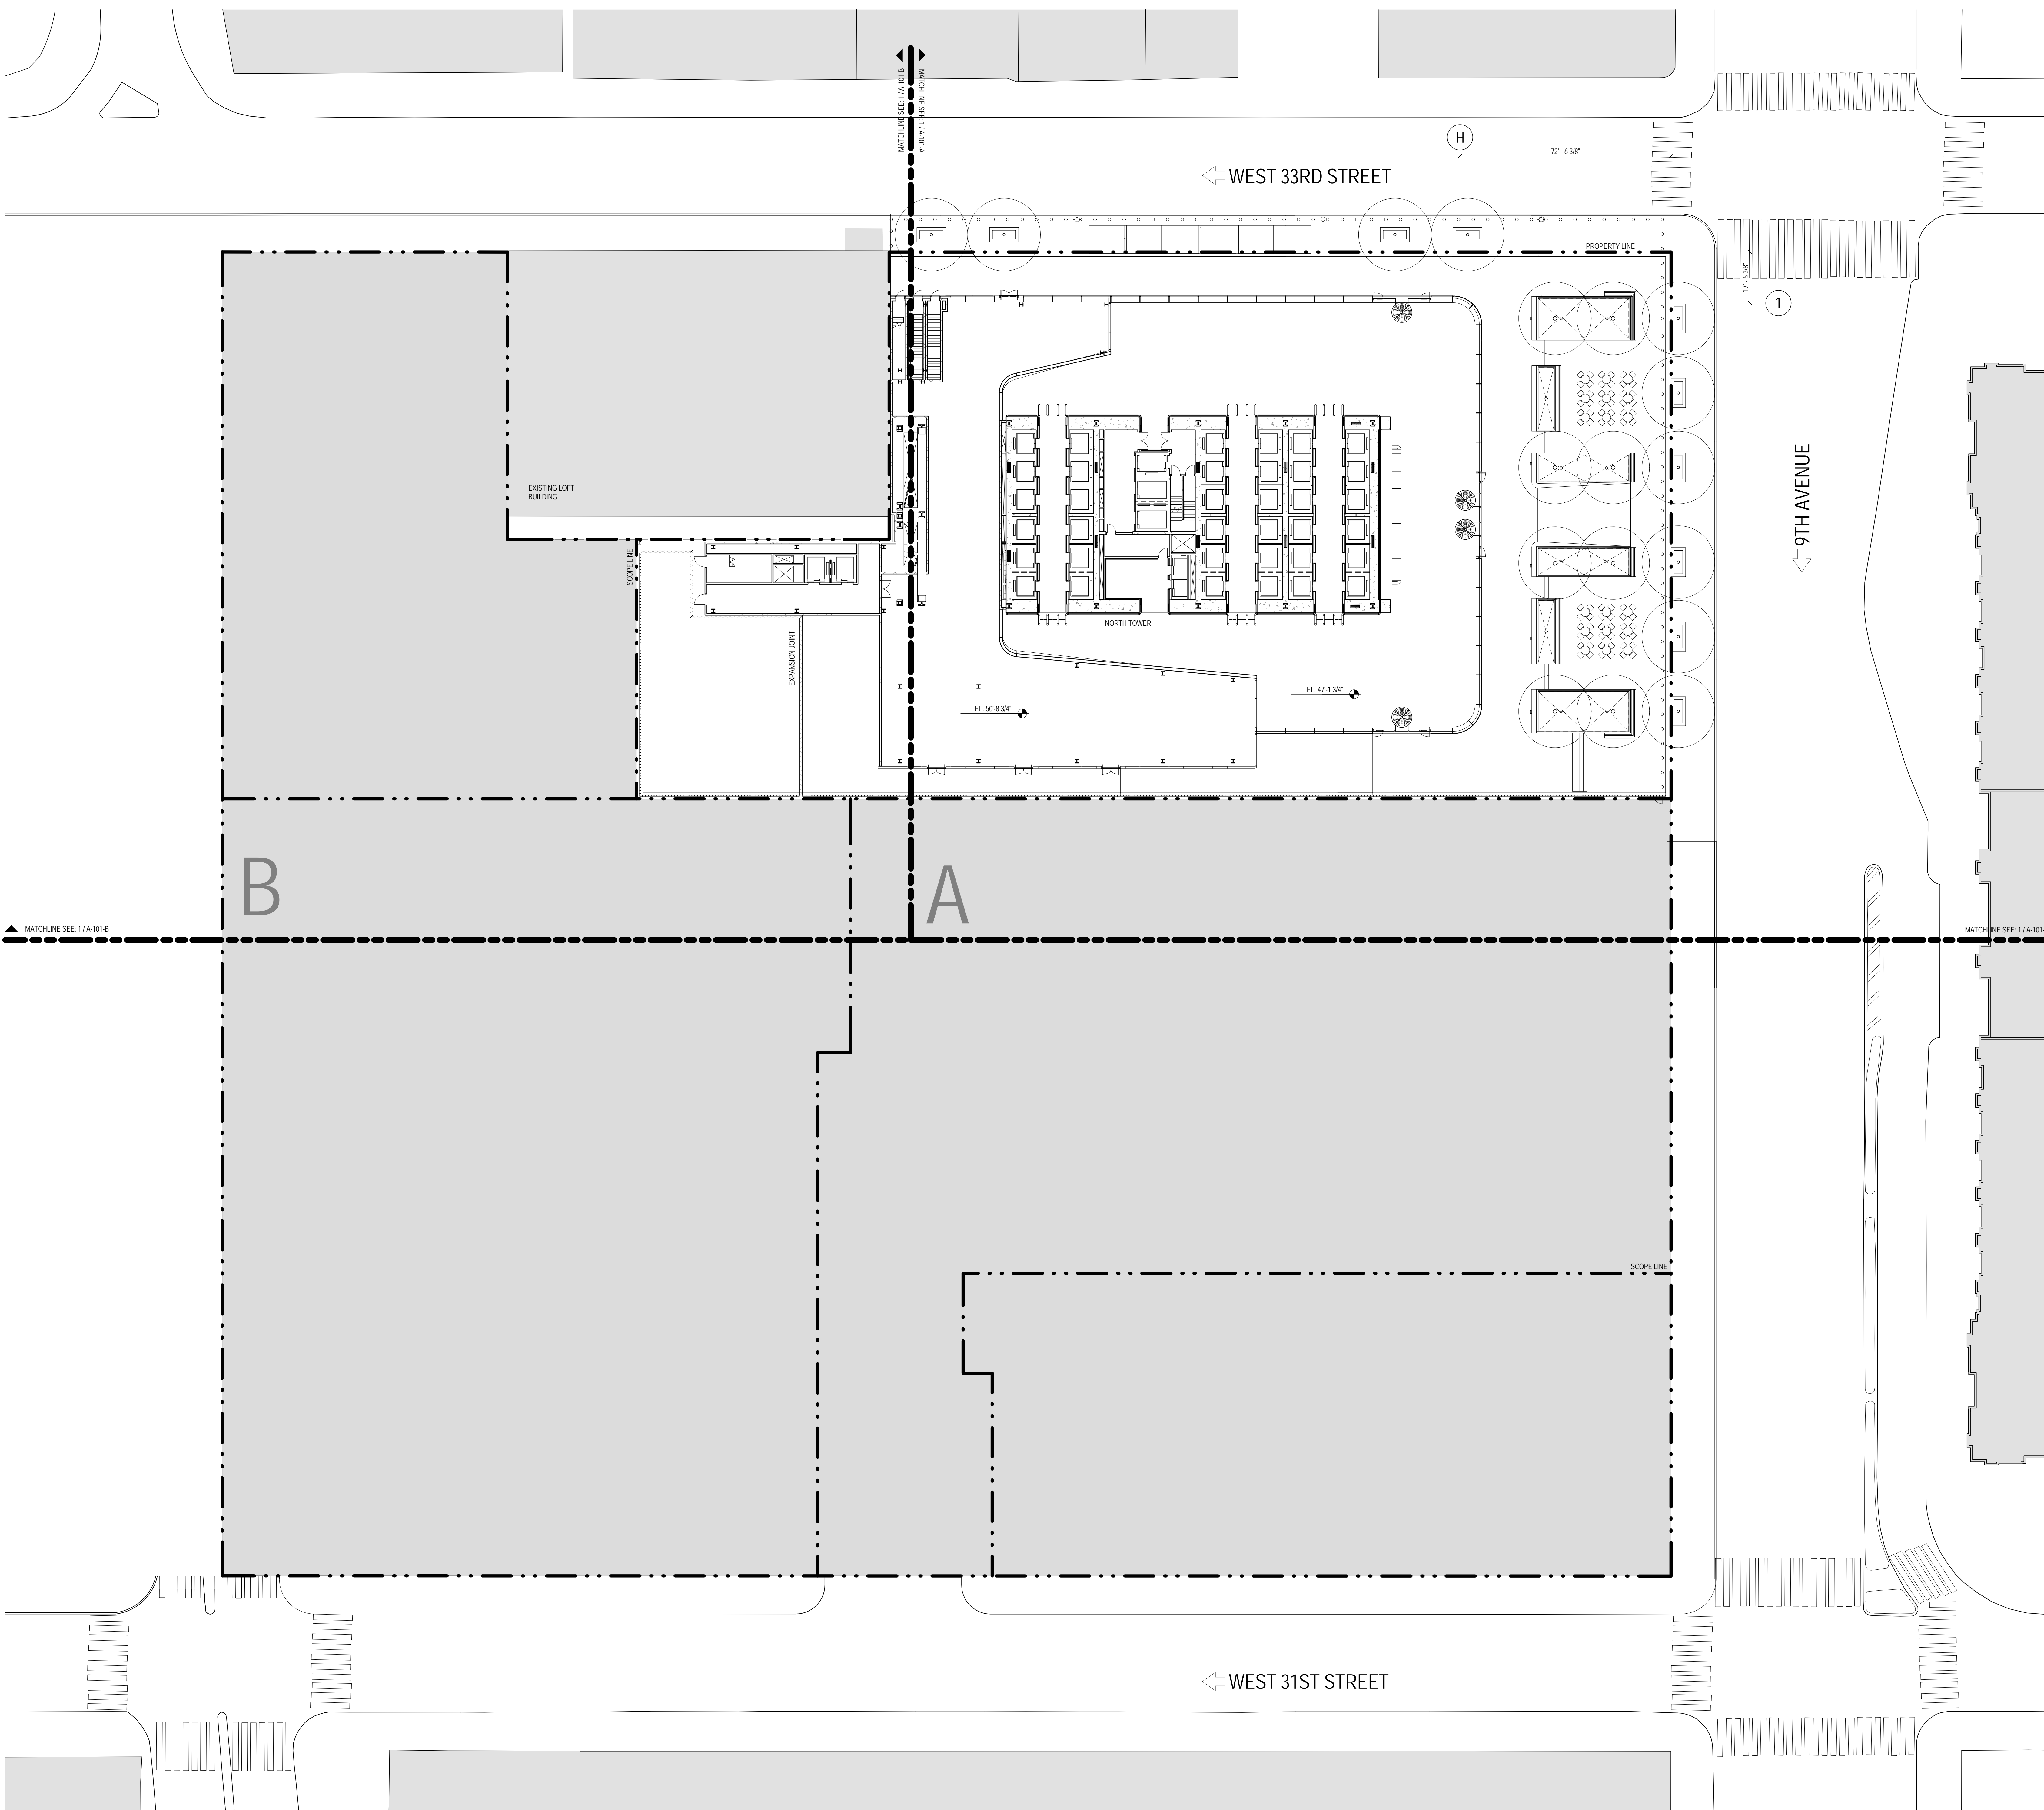
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Key Plan:





SHEET NOTES

1. ALL BUILDING ELEVATIONS ON FEET REFERENCED TO THE NORTH AMERICAN VERTICAL DATUM OF 1988 (NAVB88).
2. FOR GENERAL NOTES, BUILDING DEPARTMENT NOTES AND CLARIFICATION OF THE WORK NOTES REFER TO SHEETS A, C, D, E, F, G, H, I, J, K, L, M, N, O, P, Q, R, S, T, U, V, W, X, Y, Z, AA, AB, AC, AD, AE, AF, AG, AH, AI, AJ, AK, AL, AM, AN, AO, AP, AQ, AR, AS, AT, AU, AV, AW, AX, AY, AZ, BA, BB, BC, BD, BE, BF, BG, BH, BI, BJ, BK, BL, BM, BN, BO, BP, BQ, BR, BS, BT, BU, BV, BW, BX, BY, BZ, CA, CB, CC, CD, CE, CF, CG, CH, CI, CJ, CK, CL, CM, CN, CO, CP, CQ, CR, CS, CT, CU, CV, CW, CX, CY, CZ, DA, DB, DC, DD, DE, DF, DG, DH, DI, DJ, DK, DL, DM, DN, DO, DP, DQ, DR, DS, DT, DU, DV, DW, DX, DY, DZ, EA, EB, EC, ED, EE, EF, EG, EH, EI, EJ, EK, EL, EM, EN, EO, EP, EQ, ER, ES, ET, EU, EV, EW, EX, EY, EZ, FA, FB, FC, FD, FE, FF, FG, FH, FI, FJ, FK, FL, FM, FN, FO, FP, FQ, FR, FS, FT, FU, FV, FW, FX, FY, FZ, GA, GB, GC, GD, GE, GF, GG, GH, GI, GJ, GK, GL, GM, GN, GO, GP, GQ, GR, GS, GT, GU, GV, GW, GX, GY, GZ, HA, HB, HC, HD, HE, HF, HG, HH, HI, HJ, HK, HL, HM, HN, HO, HP, HQ, HR, HS, HT, HU, HV, HW, HX, HY, HZ, IA, IB, IC, ID, IE, IF, IG, IH, II, IJ, IK, IL, IM, IN, IO, IP, IQ, IR, IS, IT, IU, IV, IW, IX, IY, IZ, JA, JB, JC, JD, JE, JF, JG, JH, JI, JJ, JK, JL, JM, JN, JO, JP, JQ, JR, JS, JT, JU, JV, JW, JX, JY, JZ, KA, KB, KC, KD, KE, KF, KG, KH, KI, KJ, KK, KL, KM, KN, KO, KP, KQ, KR, KS, KT, KU, KV, KW, KX, KY, KZ, LA, LB, LC, LD, LE, LF, LG, LH, LI, LJ, LK, LL, LM, LN, LO, LP, LQ, LR, LS, LT, LU, LV, LW, LX, LY, LZ, MA, MB, MC, MD, ME, MF, MG, MH, MI, MJ, MK, ML, MM, MN, MO, MP, MQ, MR, MS, MT, MU, MV, MW, MX, MY, MZ, NA, NB, NC, ND, NE, NF, NG, NH, NI, NJ, NK, NL, NM, NN, NO, NP, NQ, NR, NS, NT, NU, NV, NW, NX, NY, NZ, OA, OB, OC, OD, OE, OF, OG, OH, OI, OJ, OK, OL, OM, ON, OO, OP, OQ, OR, OS, OT, OU, OV, OW, OX, OY, OZ, PA, PB, PC, PD, PE, PF, PG, PH, PI, PJ, PK, PL, PM, PN, PO, PP, PQ, PR, PS, PT, PU, PV, PW, PX, PY, PZ, QA, QB, QC, QD, QE, QF, QG, QH, QI, QJ, QK, QL, QM, QN, QO, QP, QQ, QR, QS, QT, QU, QV, QW, QX, QY, QZ, RA, RB, RC, RD, RE, RF, RG, RH, RI, RJ, RK, RL, RM, RN, RO, RP, RQ, RR, RS, RT, RU, RV, RW, RX, RY, RZ, SA, SB, SC, SD, SE, SF, SG, SH, SI, SJ, SK, SL, SM, SN, SO, SP, SQ, SR, SS, ST, SU, SV, SW, SX, SY, SZ, TA, TB, TC, TD, TE, TF, TG, TH, TI, TJ, TK, TL, TM, TN, TO, TP, TQ, TR, TS, TT, TU, TV, TW, TX, TY, TZ, UA, UB, UC, UD, UE, UF, UG, UH, UI, UJ, UK, UL, UM, UN, UO, UP, UQ, UR, US, UT, UY, UV, UW, UX, UY, UZ, VA, VB, VC, VD, VE, VF, VG, VH, VI, VJ, VK, VL, VM, VN, VO, VP, VQ, VR, VS, VT, VU, VV, VW, VX, VY, VZ, WA, WB, WC, WD, WE, WF, WG, WH, WI, WJ, WK, WL, WM, WN, WO, WP, WQ, WR, WS, WT, WU, WV, WW, WX, WY, WZ, XA, XB, XC, XD, XE, XF, XG, XH, XI, XJ, XK, XL, XM, XN, XO, XP, XQ, XR, XS, XT, XU, XV, XW, XX, XY, XZ, YA, YB, YC, YD, YE, YF, YG, YH, YI, YJ, YK, YL, YM, YN, YO, YP, YQ, YR, YS, YT, YU, YV, YW, YX, YY, YZ, ZA, ZB, ZC, ZD, ZE, ZF, ZG, ZH, ZI, ZJ, ZK, ZL, ZM, ZN, ZO, ZP, ZQ, ZR, ZS, ZT, ZU, ZV, ZW, ZX, ZY, ZZ.
3. FOR ARCHITECTURAL ABBREVIATIONS, LEGEND OF SYMBOLS, CLAYTONS, AND MOUNTING HEIGHTS REFER TO SHEET NO. C-606.
4. FOR ROOM FINISH SCHEDULE SEE A 700 SERIES DRAWINGS.
5. FOR DOOR SCHEDULE SEE A 700 SERIES DRAWINGS. FOR DOOR HARDWARE SPECIFICATION SEE TECHNICAL SPECIFICATION SECTION 08700.
6. FOR PARTITION TYPES SEE A 700 SERIES DRAWINGS.
7. FOR REFLECTED CEILING PLANS SEE A 600 SERIES DRAWINGS. FOR CEILING TYPES NOT LISTED IN THE MEPP/ASSET SCHEDULE, SEE DRAWINGS FOR LOCATIONS OR CALL CEILING/MOUNTED DEVICES.
8. FOR STRUCTURAL COLUMN, EDGE OF SLAB, AND CORNER POINTS SEE STRUCTURAL SERIES DRAWINGS, UNLESS OTHERWISE NOTED.
9. REFER TO STRUCTURAL SERIES DRAWINGS FOR ALL STRUCTURAL WALL DESIGNATIONS AND DIMENSIONS.
10. REFER TO MEPP DRAWINGS FOR ALL MECHANICAL EQUIPMENT, PLUMBING AND THE PROTECTION ROOM, RISER AND EQUIPMENT DESIGNATIONS.



**MANHATTAN WEST:
NORTH TOWER**
375 Ninth Avenue, New York, NY 10001

Brookfield
Brookfield Place
250 Vesey Street, 15th Floor, New York, NY 10281

Architecture/Structural Engineering

SOM

Skidmore, Owings & Merrill LLP
14 Wall Street, New York, NY 10005

Civil Engineering
Philip Habib & Associates
102 Madison Avenue #11, New York, NY 10016

MEP Engineering
Jaros Baum & Bolles
80 Pine Street, New York, NY 10005

Vertical Transportation

Edgett Williams Consulting Group, Inc.
102 East Blithedale Ave. Suite 1 Mill Valley, California 94941

Sustainable Design
Viridian Energy & Environmental
80 Monington Street, Newbury, CT 06054

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Mueser Rutledge Consulting Engineers

14 Penn Plaza, 225 W. 34th Street, New
York, NY 10122

Landscape Consultant

Field Operations

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Security Consultant

Ducibella, Ventor & Santore

250 State Street #F1, North Haven, CT 06473

Blast Consultant

Windlinger Associates, Inc.

Acoustical Consultant

Cerami & Associates
404 Fifth Avenue #8, New York, NY 10018

Vibration Consultant

Wilson, Uhrig & Associates, Inc.
65 Broadway, Suite 401, New York, NY 10006

Code Consultant

Code Consultants Professional Engineers PC
215 West 40th Street, 15th Floor, New York, NY 10018

Facade Maintenance Consultant


Entek Engineering LLC
166 Ames Street, Hackensack, NJ 07601

Wind Tunnel Consultant

Rowan Williams Davies & Irwin Inc.
650 Woodlawn Road West, Guelph
Ontario, Canada N1K 1B8

PRELIMINARY
NOT FOR CONSTRUCTION

Key Plan:

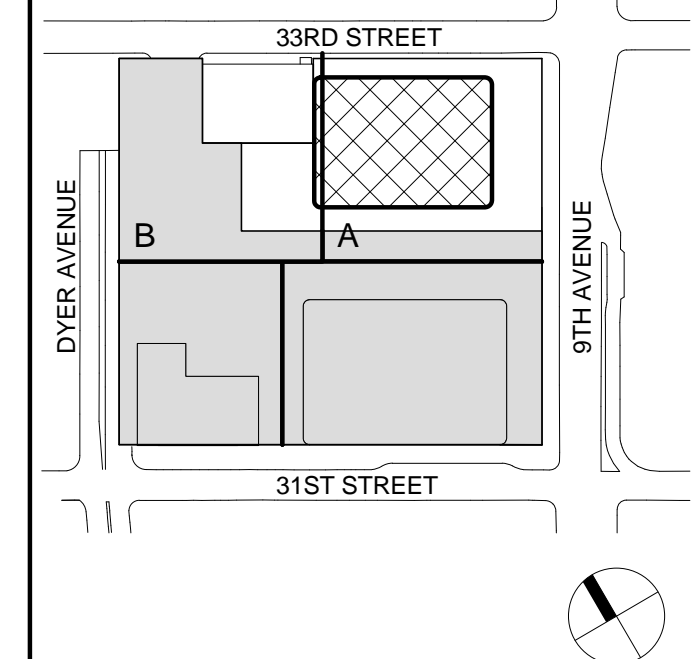

Seal & Signature:



Warning: It is a violation of the New York State Architecture Law, §69.5(b) for any person, unless they are acting under the direction of a Licensed Architect, to alter this item in any way.

6	20 JUN 2014	ISSUED FOR FOUNDATION BID
5	20 JUN 2014	ISSUED FOR FOUNDATION PERMIT
4	20 DEC 2013	ISSUED FOR FOUNDATION PERMIT
3	15 NOV 2013	ISSUED FOR DD PROGRESS PRICING
2	12 JUL 2013	ISSUED FOR 50% DESIGN DEVELOPMENT
1	15 MAR 2013	ISSUED FOR RECONCILIATION
No.	Date	Description

No.	Date	Description
Sheet Name:		


KEY PLAN -
GROUND FLOOR

Project No.: 207120	B-SCAN Sheet No.: A-007.00
Date: 20 JUN 2014	Sheet No.: A-007
Scale: 1" = 20'-0"	
File No.:	Page No.: 10 OF 87

EXIT STAIR F	TOTAL CAPACITY: 167
STAIR WIDTH: 50"	OCCUPANCY FACTOR: 0.3
STAIR CAPACITY: 167 PEOPLE	
DOOR WIDTH: 34"	OCCUPANCY FACTOR: 0.2
DOOR CAPACITY: 170 PEOPLE	

EXIT STAIR D	TOTAL CAPACITY: 147
STAIR WIDTH: 44"	OCCUPANCY FACTOR: 0.3
STAIR CAPACITY: 147 PEOPLE	
DOOR WIDTH: 34"	OCCUPANCY FACTOR: 0.2
DOOR CAPACITY: 170 PEOPLE	

EXIT DOOR S	
DOOR WIDTH: 34"	OCCUPANCY FACTOR: 0.2
DOOR CAPACITY: 170 PEOPLE	

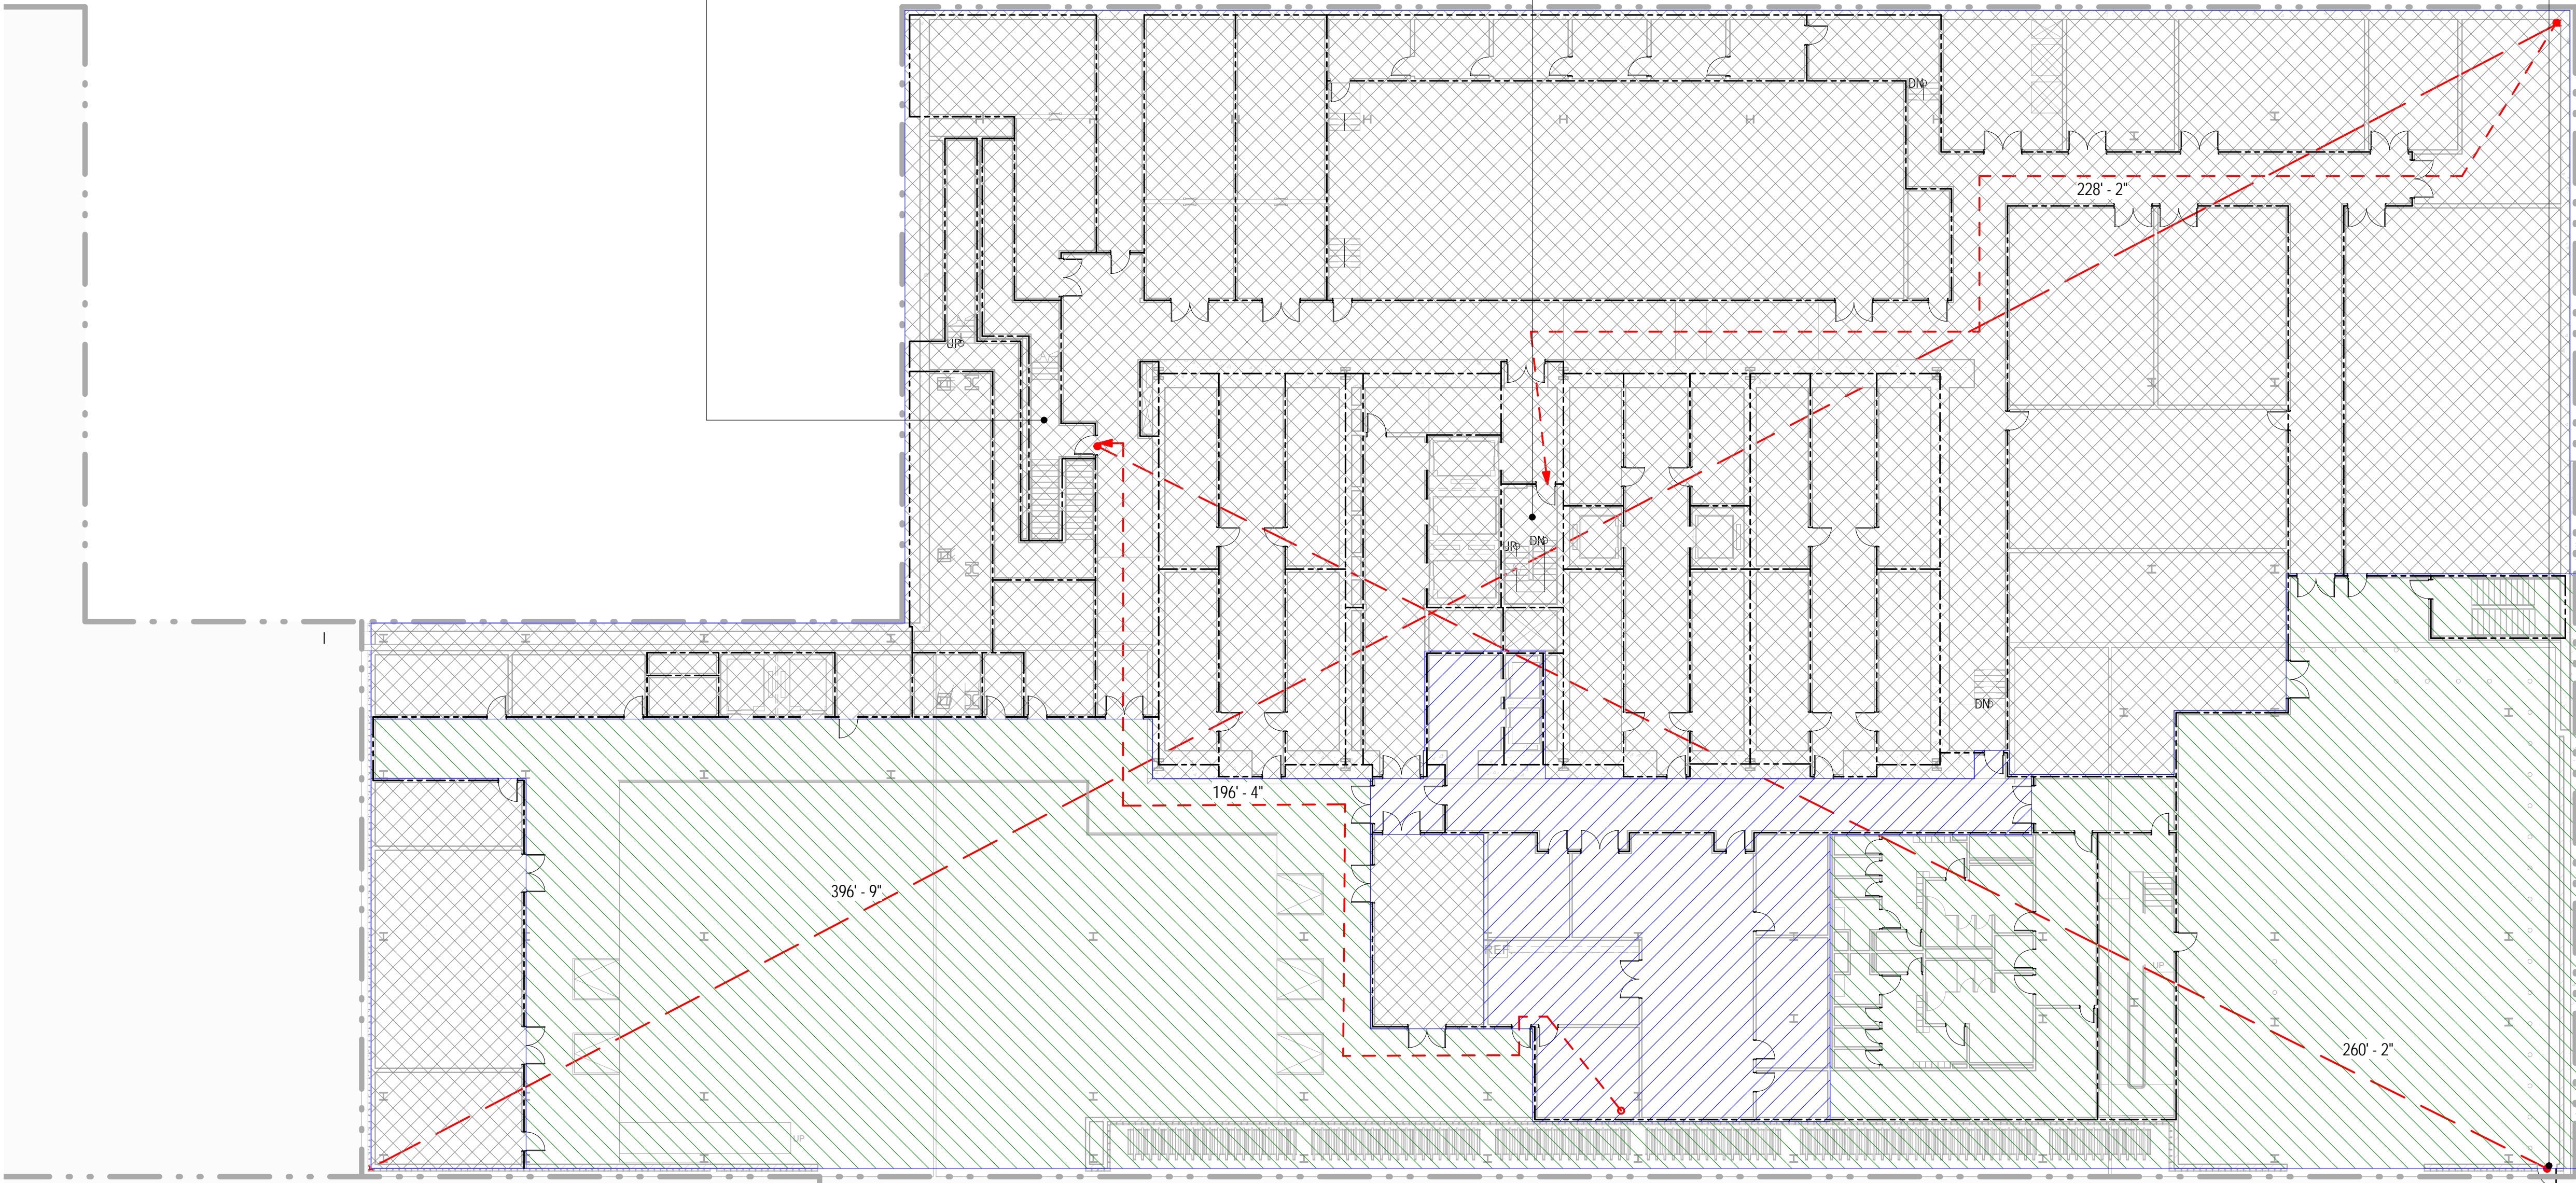

STAIR / DOOR	CLEAR STAIR WIDTH	STAIR OCC. FACTOR	STAIR OCC. TOTAL	CLEAR DOOR WIDTH	DOOR OCC. FACTOR	DOOR OCC. TOTAL	CAPACITY
D	44	0.3	147	34	0.2	170	147
F	50	0.3	167	34	0.2	170	167
S	0	0.3	0	34	0.2	170	170
Grand total							464

USE OF SPACE	AREA	FLOOR AREA PER OCCUPANT	TOTAL OCCUPANT LOAD
BUSINESS	3826 SF	100 SF	38
MECHANICAL / STORAGE	33934 SF	300 SF	113
PARKING	19596 SF	200 SF	98
Grand total	57356 SF		249

FIXTURE TYPE	REQUIRED*		PROVIDED**	
	MALE	FEMALE	MALE	FEMALE
WATER CLOSETS	0	0	0	0
URINALS	0	-	0	-
LAVATORIES	0	0	0	0
DRINKING FOUNTAINS	0	0	0	0

*PLUMBING FIXTURE REQUIREMENTS FOR BUSINESS OCCUPANCY ARE BASED ON POPULATION DENSITY OF 100 GROSS SQ. FT. PER PERSON (BASED ON CHAPTER 3 OF THE 2008 NEW YORK CITY BUILDING CODE & INTRO 659A OF THE NEW YORK CITY PLUMBING CODE) AND A 50/50 SPLIT BETWEEN MALE AND FEMALE OCCUPANTS.
**FULFILLMENT OF REQUIRED DRINKING FOUNTAINS TO BE PROVIDED BY TENANT WHERE REQUIRED AS PER SECTION PC 403 OF THE 2008 NEW YORK CITY PLUMBING CODE.

BUILDING CODE

BUILDING CODE OF THE CITY OF NEW YORK - 2008 EDITION, UNLESS OTHERWISE NOTED.

OCCUPANCY CLASSIFICATION

DESIGNATIONS FOR THE BUILDING (SECTION BC 301-312):

A-2	ASSEMBLY
B	BUSINESS (PRIMARY)
M	MERCANTILE
S-1	MODERATE-HAZARD STORAGE
S-2	LOW-HAZARD STORAGE
F-2	LOW-HAZARD FACTORY/INDUSTRIAL

CONSTRUCTION CLASSIFICATION

CONSTRUCTION TYPE FOR THE BUILDING (TABLE 503): 1A

FIRE RESISTANCE REQUIREMENTS FOR BUILDING ELEMENTS (TABLE 601 & 602):

BUILDING ELEMENT	FIRE RATING
STRUCTURAL FRAME	3 HRS
BEARING WALLS (EXTERIOR)	3 HRS
BEARING WALLS (INTERIOR)	3 HRS
NONBEARING WALLS & PARTITIONS (EXTERIOR)	1 HR
SEPARATION BETWEEN 5'-0" AND 10'-0"	1 HR
SEPARATION BETWEEN 10'-0" AND 30'-0"	1 HR
SEPARATION GREATER OR EQUAL TO 30'-0"	0 HRS
NONBEARING WALLS & PARTITIONS (INTERIOR)	2 HRS
FLOOR CONSTRUCTION	1.5 HR
ROOF CONSTRUCTION	1.5 HR

BUILDING LIMITATIONS

AREA, HEIGHT & # OF STORIES (TABLE 503):

CLASS 1A CONSTRUCTION; NO LIMIT FOR HEIGHT, AREA, OR # OF STORIES.

*BUILDING IS FULLY SPRINKLERED IN ACCORDANCE WITH SECTION 903.3.1.1

FIRE SEPARATION

BUILDING IS FULLY SPRINKLERED IN ACCORDANCE WITH SECTION 903.3.1.1

OCCUPANCY SEPARATION NEED NOT BE PROVIDED FOR STORAGE AREAS SERVING GROUP B OR IF ANY OF THE FOLLOWING CONDITIONS APPLY (TABLE 508.3):

- THE STORAGE AREA IS LESS THAN 10% OF THE FLOOR AREA AND LESS THAN 1,000 SF

- THE STORAGE AREA IS PROVIDED WITH AN AUTOMATIC FIRE EXTINGUISHING SYSTEM AND IS LESS THAN 1,000 SF

- THE STORAGE AREA IS LESS THAN 1,000 SF

SPACES OCCUPIED BY DIFFERENT TENANTS SHALL BE SEPARATED BY FIRE BARRIERS HAVING AT LEAST 1-HOUR FIRE RESISTANCE RATINGS (SECTION 509.9)

MEANS OF EGRESS

EXIT ACCESS TRAVEL DISTANCE (TABLE 1015.1)

OCCUPANCY

W/SPRINKLER SYSTEM (F)

PRIMARY

SECONDARY

A-2

B

M

S-1

S-2

F-2

*BUILDING IS FULLY SPRINKLERED IN ACCORDANCE WITH SECTION 903.3.1.1

EXIT OR EXIT ACCESS REMOTE ACCESS (SECTION 1004.2.1)

MIN. EXIT TRAVEL DISTANCE TO THE MAX. DIAGONAL DISTANCE

MIN. EXIT REMOTE ACCESS (SPRINKLERED): 1/3 THE MAX. DIAGONAL DISTANCE

DEAD ENDS (TABLE 3)

MAX. DEAD END LENGTH (GROUP B, F): 50'-0"

COMMON PATH OF EGRESS TRAVEL (TABLE 1015.3)

MAX. COMMON PATH OF EGRESS (GROUP B, F, S): 100'-0"

*BUILDING IS FULLY SPRINKLERED IN ACCORDANCE WITH SECTION 903.3.1.1

DOOR WIDTH (SECTION 1008.1.1.1)

MIN. DOOR CLEAR WIDTH (SINGLE LEAF): 32"

MIN. DOOR CLEAR WIDTH (DOUBLE LEAF): 32" FOR A SINGLE LEAF

MAX. DOOR CLEAR WIDTH (PER LEAF): 48"

STAIRWAY WIDTH (SECTION 1009.3)

MIN. STAIRWAY WIDTH: 44"

CORRIDOR WIDTH (SECTION 1010.2)

MIN. CORRIDOR WIDTH: 44"

*BUILDING IS FULLY SPRINKLERED IN ACCORDANCE WITH SECTION 903.3.1.1

EXIT ENVELOPE FIRE RATING REQUIREMENTS (SECTION 1010.1)

MIN. FIRE RATING REQUIREMENT: 2 HRS

EXIT DOOR FIRE RATING REQUIREMENTS (TABLE 715.3)

MIN. FIRE RATING REQUIREMENT: 1.5 HRS

STAIR REQUIREMENTS (SECTION 1009.2 & 1009.3)

MIN. HEADROOM: 8'-0"

MIN. RISER HEIGHT: 4"

MAX. RISER HEIGHT: 7"

MIN. TREAD DEPTH: 11"

PLUMBING FACILITIES

(2008 NEW YORK CITY PLUMBING CODE)

MINIMUM NUMBER OF FIXTURES (SECTION 403.1)

PLUMBING FIXTURES SHALL BE PROVIDED FOR THE TYPE OF OCCUPANCY AND IN THE MINIMUM NUMBER SHOWN IN TABLE 403.1. TYPES OF OCCUPANCIES NOT SHOWN IN TABLE 403.1 SHALL BE CONSIDERED INDIVIDUALLY BY THE COMMISSIONER. THE NUMBER OF OCCUPANTS AND OCCUPANCY CLASSIFICATION SHALL BE DETERMINED BY THE NEW YORK CITY BUILDING CODE.

MIN. NO. OF PLUMBING FIXTURES (TABLE 403.1)

OCC - WC - LAV - TURB - DRINKING - OTHER

A-2 - 1/25 - 1/25 - 1/25 - 1/25 - 1/25

B - 200 - 200 - 200 - 200 - 200 - 200

M - SEE CHART BELOW - 1/1000 - 1/1000 - 1/1000 - 1/1000

S-1 - 1/1000 - 1/1000 - 1/1000 - 1/1000 - 1/1000 - 1/1000

S-2 - 1/1000 - 1/1000 - 1/1000 - 1/1000 - 1/1000 - 1/1000

F-2 - 1/1000 - 1/1000 - 1/1000 - 1/1000 - 1/1000 - 1/1000

BUSINESS PLUMBING FIXTURE REQUIREMENT (TABLE 403.1)

WATER CLOSETS & URINALS - LAVATORIES

OF PERSONS / # OF FIXTURES - # OF PERSONS / # OF FIXTURES

1-20 - 1 - 1-25 - 1

21-45 - 2 - 26-50 - 2

46-70 - 3 - 51-75 - 3

71-100 - 4 - 76-115 - 4

101-140 - 5 - 116-160 - 5

141-190 - 6 - 171-240 - 6

1 FIXTURE PER ADDITIONAL 60 PERSONS

1 FIXTURE PER ADDITIONAL 60 PERSONS

NUMBER OF OCCUPANTS OF EACH SEX (SECTION 403.3)

THE OCCUPANT LOAD SHALL BE COMPOSED OF 50% OF EACH SEX

REQUIRED DRINKING FOUNTAINS (SECTION 419.2)

UP TO 50% OF THE REQUIRED DRINKING FOUNTAINS MAY BE SUBSTITUTED BY DEDICATED PLUMBING FIXTURES WITH FAUCETS DESIGNED FOR FILLING A CONTAINER AT LEAST 32" IN HEIGHT.

URINALS SHALL NOT BE SUBSTITUTED FOR MORE THAN 50% OF THE REQUIRED WATER CLOSETS.

SUBSTITUTION FOR WATER CLOSETS (SECTION 419.2)

URINALS SHALL NOT BE SUBSTITUTED FOR MORE THAN 50% OF THE REQUIRED WATER CLOSETS.

Warning: It is a violation of the New York State Architecture Law, §19-50, for any person, unless they are acting under the direction of a Licensed Architect, to alter this item in any way.

REGISTERED ARCHITECT

STATE OF NEW YORK

PROJECT NO. 207150

DATE: 20 JUN 2014

SCALE: 1/16" = 1'-0"

FILE NO. A-013



Brookfield Place
250 Vesey Street, 15th Floor, New York, NY 10021

Architecture/Structural Engineering

SOM

Skidmore, Owings & Merrill LLP

14 Wall Street, New York, NY 10005

Civil Engineering

Philip Habib & Associates

102 Madison Avenue #11, New York, NY 10016

MEP Engineering

Jaros Baum & Bolles

80 Pine Street, New York, NY 10005

Vertical Transportation

Edgett Williams Consulting Group, Inc.

102 East Bluffside Ave., Suite 1, Mill Valley, California 94041

Sustainable Design

Viridian Energy & Environmental

50 Penn Plaza, 225 W. 34th Street, New York, NY 10122

Geotechnical Engineering

Mueser Rutledge Consulting Engineers

14 Penn Plaza, 225 W. 34th Street, New York, NY 10122

Landscape Consultant

Field Operations

475 10th Avenue, New York, NY 10018

Security Consultant

Ducibella, Venter & Santoro

250 State Street #F1, North Haven, CT 06473

Blast Consultant

Weidinger Associates, Inc.

40 Wall Street, New York, NY 10005

Acoustical Consultant

Cerami & Associates

404 Fifth Avenue #B, New York, NY 10018

Vibration Consultant

Wilson, Uhrig & Associates, Inc.

65 Broadway, Suite 401, New York, NY 10006

Code Consultant

Code Consultants Professional Engineers PC

215 West 40th Street, 15th Floor, New York, NY 10018

Facade Maintenance Consultant

Entek Engineering LLC

166 Ames Street, Hackensack, NJ 07601

Wind Tunnel Consultant

Rowan Williams Davies & Irwin Inc.

650 Woodlawn Road West, Guelph, Ontario, Canada N1K 1B6

Key Plan:

33RD STREET

9TH AVENUE

31ST STREET

DYER AVENUE

B

A

Seal & Signature:

REGISTERED ARCHITECT

STATE OF NEW YORK

PROJECT NO. 207150

DATE: 20 JUN 2014

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FILE NO. A-013

PROJECT NO. 207150


DATE: 20 JUN 2014

SCALE: 1/16" = 1'-0"

FILE NO. A-013

PROJECT NO. 207150

DATE: 20 JUN 2014

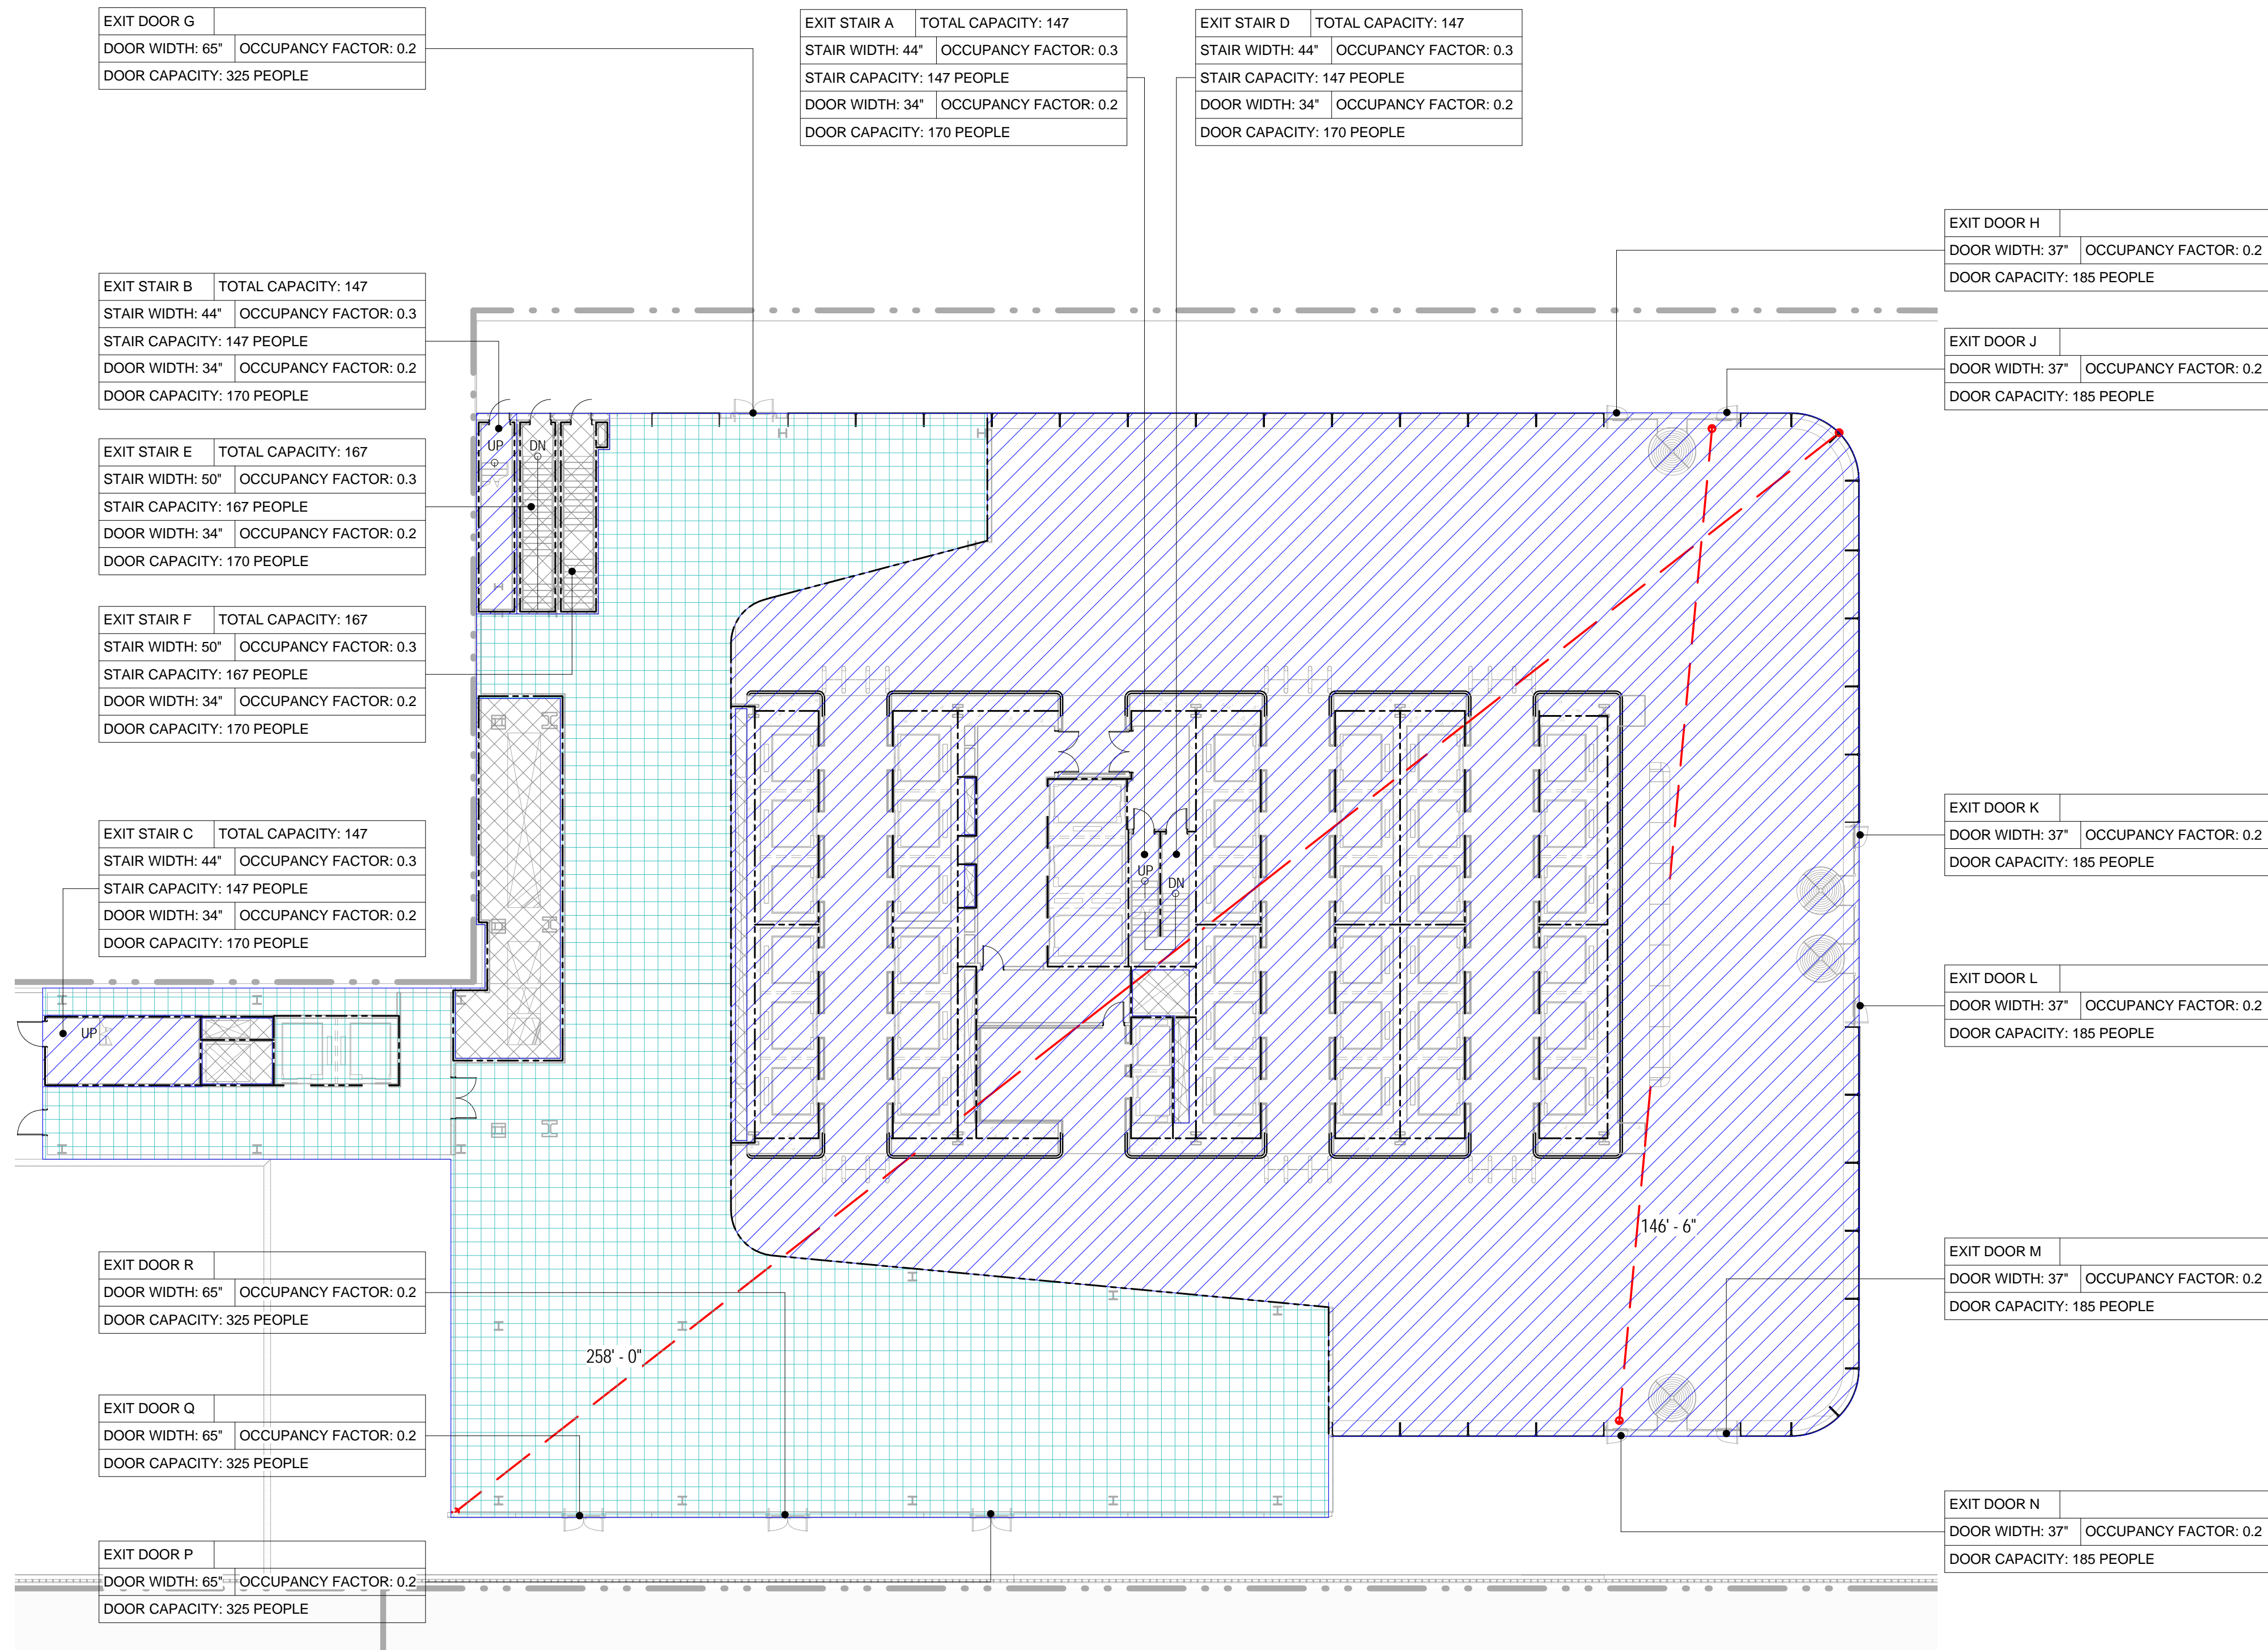

EGRESS CAPACITY - GROUND FLOOR									
STAIR / DOOR	CLEAR STAIR WIDTH	STAIR OCC. FACTOR	STAIR OCC. TOTAL	CLEAR DOOR WIDTH	DOOR OCC. FACTOR	DOOR OCC. TOTAL	CAPACITY		
A	44	0.3	147	34	0.2	170	147		
B	44	0.3	147	34	0.2	170	147		
C	44	0.3	147	34	0.2	170	147		
D	44	0.3	147	34	0.2	170	147		
E	50	0.3	167	34	0.2	170	167		
F	50	0.3	167	34	0.2	170	167		
G	44	0.3	147	65	0.2	325	147		
H	44	0.3	147	37	0.2	185	147		
J	44	0.3	147	37	0.2	185	147		
K	44	0.3	147	37	0.2	185	147		
L	44	0.3	147	37	0.2	185	147		
M	44	0.3	147	37	0.2	185	147		
N	44	0.3	147	37	0.2	185	147		
P	44	0.3	147	65	0.2	325	147		
Q	44	0.3	147	65	0.2	325	147		
R	44	0.3	147	65	0.2	325	147		
Grand total			147	65	0.2	325	2392		

OCCUPANT LOAD - GROUND FLOOR			
USE OF SPACE	AREA	FLOOR AREA PER OCCUPANT	TOTAL OCCUPANT LOAD
BUSINESS	22181 R ²	100 R ²	222
MERCANTILE	10207 R ²	200 R ²	51
Grand total	33382 R ²		279

PLUMBING FIXTURE CALCULATION - GROUND FLOOR				
FIXTURE TYPE	REQUIRED*		PROVIDED**	
	MALE	FEMALE	MALE	FEMALE
WATER CLOSETS	0	0	0	0
URINALS	0	-	0	-
LAVATORIES	0	0	0	0
DRINKING FOUNTAINS			0	0

*PLUMBING FIXTURE REQUIREMENTS FOR BUSINESS OCCUPANCY ARE BASED ON POPULATION DENSITY OF 100 GROSS SQ. FT. PER PERSON (BASED ON CHAPTER 3 OF THE 2008 NEW YORK CITY BUILDING CODE & INTRO AREA OF THE NEW YORK CITY PLUMBING CODE) AND A 50/50 SPLIT BETWEEN MALE AND FEMALE OCCUPANTS.

**FULFILLMENT OF REQUIRED DRINKING FOUNTAINS TO BE PROVIDED BY TENANT WHERE REQUIRED AS PER SECTION PD-403 OF THE 2008 NEW YORK CITY PLUMBING CODE.

BUILDING CODE

BUILDING CODE OF THE CITY OF NEW YORK - 2008 EDITION, UNLESS OTHERWISE NOTED.

OCCUPANCY CLASSIFICATION

DESIGNATIONS FOR THE BUILDING (SECTION BC 301-312):

A-2 ASSEMBLY
B BUSINESS (PRIMARY)
M MERCANTILE
S-1 MODERATE-HAZARD STORAGE
S-2 LOW-HAZARD FACTORY INDUSTRIAL

CONSTRUCTION CLASSIFICATION

CONSTRUCTION TYPE FOR THE BUILDING (TABLE 503): 1A

FIRE RESISTANCE REQUIREMENTS FOR BUILDING ELEMENTS (TABLE 601 & 602):

BUILDING ELEMENT	FIRE RATING
STRUCTURAL FRAME	3 HRS
BEARING WALLS (EXTERIOR)	3 HRS
BEARING WALLS (INTERIOR)	3 HRS
NONBEARING WALLS & PARTITIONS (EXTERIOR)	1 HR
SEPARATION BETWEEN 5'-0" AND 10'-0"	1 HR
SEPARATION BETWEEN 10'-0" AND 30'-0"	1 HR
SEPARATION GREATER OR EQUAL TO 30'-0"	0 HRS
NONBEARING WALLS & PARTITIONS (INTERIOR)	0 HRS
FLOOR CONSTRUCTION	2 HRS
ROOF CONSTRUCTION	15 HR

BUILDING LIMITATIONS

AREA, HEIGHT & # OF STORIES (TABLE 503):

CLASS 1A CONSTRUCTION: NO LIMIT FOR HEIGHT, AREA, OR # OF STORIES.

*BUILDING IS FULLY SPRINKLERED IN ACCORDANCE WITH SECTION 903.1.1

FIRE SEPARATION

BUILDING IS FULLY SPRINKLERED IN ACCORDANCE WITH SECTION 903.1.1

OCCUPANCY SEPARATION NEED NOT BE PROVIDED FOR STORAGE AREAS SERVING GROUP B OR IF ANY OF THE FOLLOWING CONDITIONS APPLY (TABLE 508.1):

- THE STORAGE AREA IS LESS THAN 10% OF THE FLOOR AREA AND LESS THAN 1,000 SF
- THE STORAGE AREA IS PROVIDED WITH AN AUTOMATIC FIRE EXTINGUISHING SYSTEM AND IS LESS THAN 1,000 SF
- THE STORAGE AREA IS LESS THAN 1,000 SF

SPACES OCCUPIED BY OR FOR TENANTS SHALL BE SEPARATED BY FIRE BARRIERS HAVING AT LEAST 1-HOUR FIRE RESISTANCE RATINGS (SECTION 509.9).

MEANS OF EGRESS

EXIT ACCESS TRAVEL DISTANCE (TABLE 1015.1):

W/ SPRINKLER SYSTEM (F):

OCCUPANCY	PRIMARY	SECONDARY
A-2	150	250
B	150	250
M	200	250
S-1	200	250
S-2	250	250
F-2	250	250

*BUILDING IS FULLY SPRINKLERED IN ACCORDANCE WITH SECTION 903.1.1

EXIT OR EXIT ACCESS REMOTENESS (SECTION 1014.2.1):

MIN. EXIT REMOTENESS: 1/2 THE MAX. DIAGONAL DISTANCE
MIN. EXIT REMOTENESS (SPRINKLERED): 1/3 THE MAX. DIAGONAL DISTANCE

DEAD ENDS (TABLE 3):

MAX. DEAD END LENGTH (GROUP B, F): 50'-0"

COMMON PATH OF EGRESS TRAVEL (TABLE 1013.3):

MAX. COMMON PATH OF EGRESS (GROUP B, F, S): 100'-0"

*BUILDING IS FULLY SPRINKLERED IN ACCORDANCE WITH SECTION 903.1.1

DOOR WIDTH (SECTION 1008.1.1.1):

MIN. DOOR CLEAR WIDTH (SINGLE LEAF): 32"

MIN. DOOR CLEAR WIDTH (DOUBLE LEAF): 32" FOR A SINGLE LEAF

MAX. DOOR CLEAR WIDTH (PER LEAF): 48"

STAIRWAY WIDTH (SECTION 1009.1):

MIN. STAIRWAY WIDTH: 44"

COORRIDOR WIDTH (SECTION 1016.2):

MIN. CORRIDOR WIDTH: 44"

*BUILDING IS FULLY SPRINKLERED IN ACCORDANCE WITH SECTION 903.1.1

EXIT DOOR FIRE RATING REQUIREMENTS (SECTION 1010.1):

MIN. FIRE RATING REQUIREMENT: 2 HRS

EXIT DOOR FIRE RATING REQUIREMENTS (TABLE 715.3):

MIN. FIRE RATING REQUIREMENT: 1.5 HRS

STAIR REQUIREMENTS (SECTION 1009.2 & 1009.3):

MIN. HEADROOM: 8'-0"

MIN. RISER HEIGHT: 4"

MAX. RISER HEIGHT: 7"

MIN. TREAD DEPTH: 11"

PLUMBING FACILITIES

(2008 NEW YORK CITY PLUMBING CODE)

MINIMUM NUMBER OF FIXTURES (SECTION 403.1):

PLUMBING FIXTURES SHALL BE PROVIDED FOR THE TYPE OF OCCUPANCY AND IN THE MINIMUM NUMBER SHOWN IN TABLE 403.1. TYPES OF OCCUPANCIES NOT SHOWN IN TABLE 403.1 SHALL BE CONSIDERED INDIVIDUALLY BY THE COMMISSIONER. THE NUMBER OF OCCUPANTS AND OCCUPANCY CLASSIFICATION SHALL BE DETERMINED BY THE NEW YORK CITY BUILDING CODE.

MIN. NO. OF PLUMBING FIXTURES (TABLE 403.1):

OCC. WC, LAV., TURB. (DRINKING), OTHER

A-2 175 175 175 175

B 200 200 200 200

M SEE CHART BELOW 15000 15000

S-1 17000 17000 17000 SEE 411.1 15000

S-2 17000 17000 17000 SEE 411.1 15000

F-2 17000 17000 17000 SEE 411.1 15000

17000 17000 17000 SEE 411.1 15000

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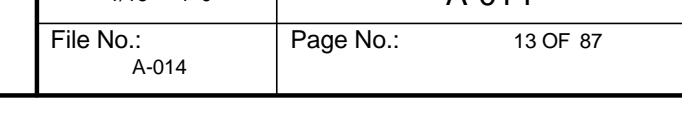
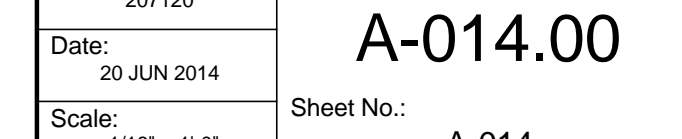
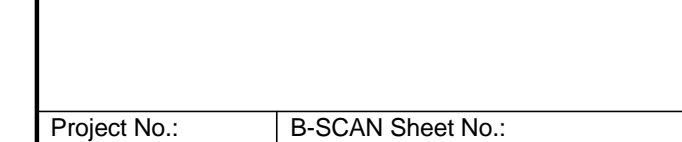
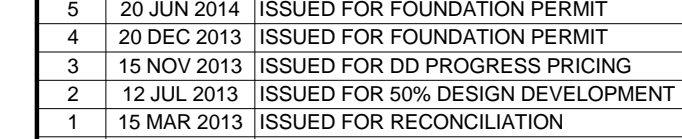
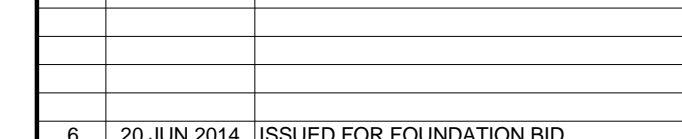
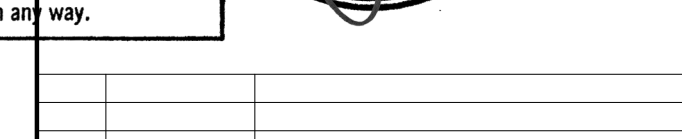
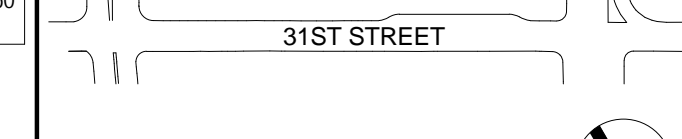
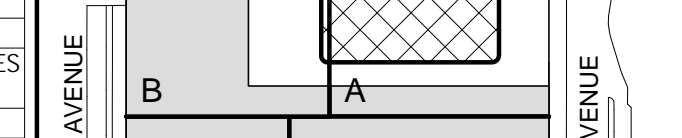
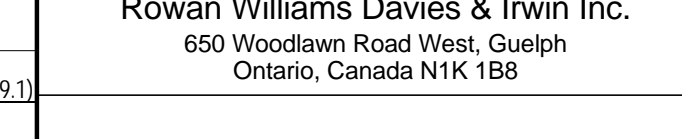
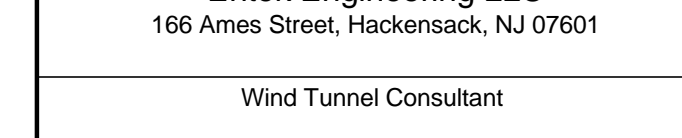
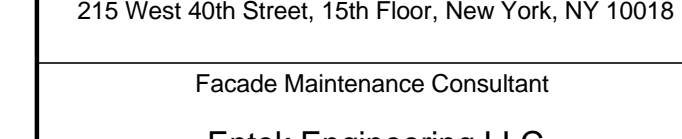
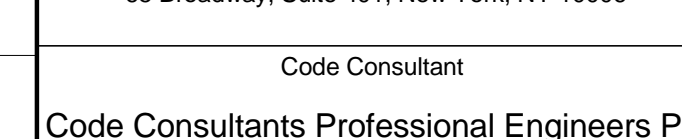
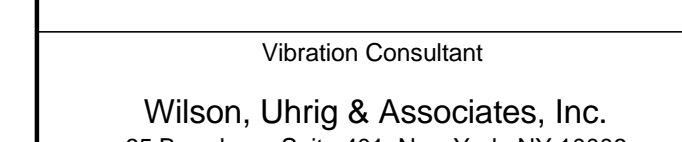
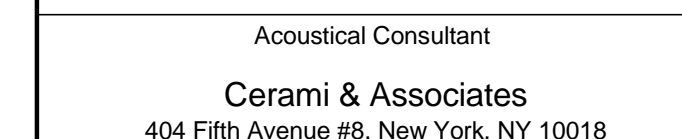
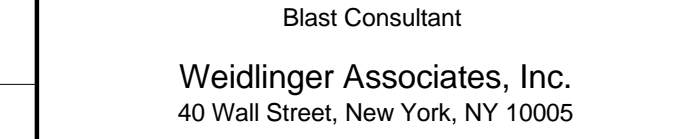
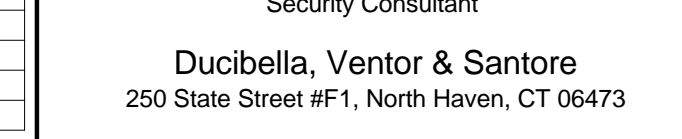
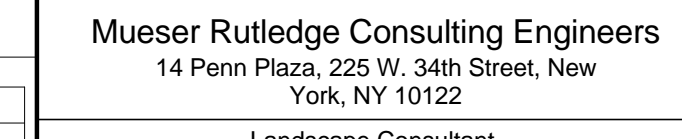
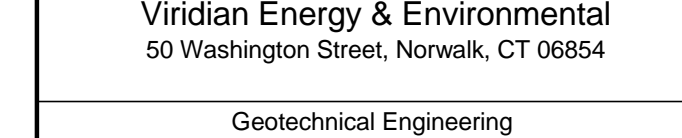
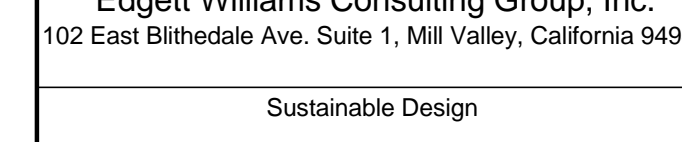
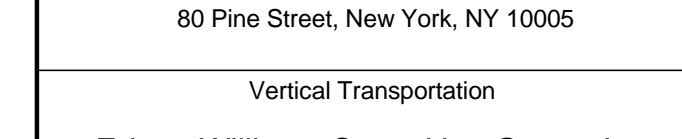
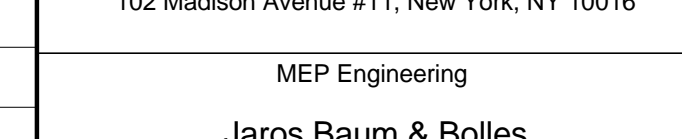
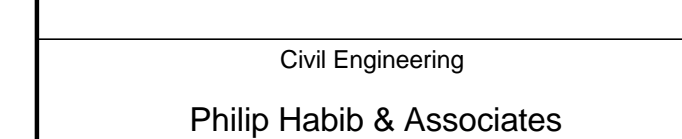
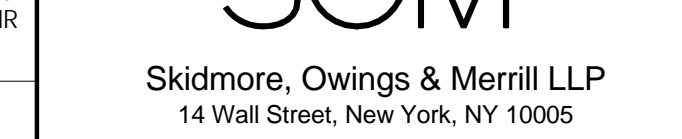
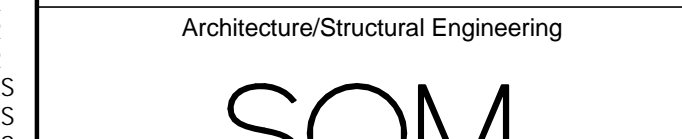
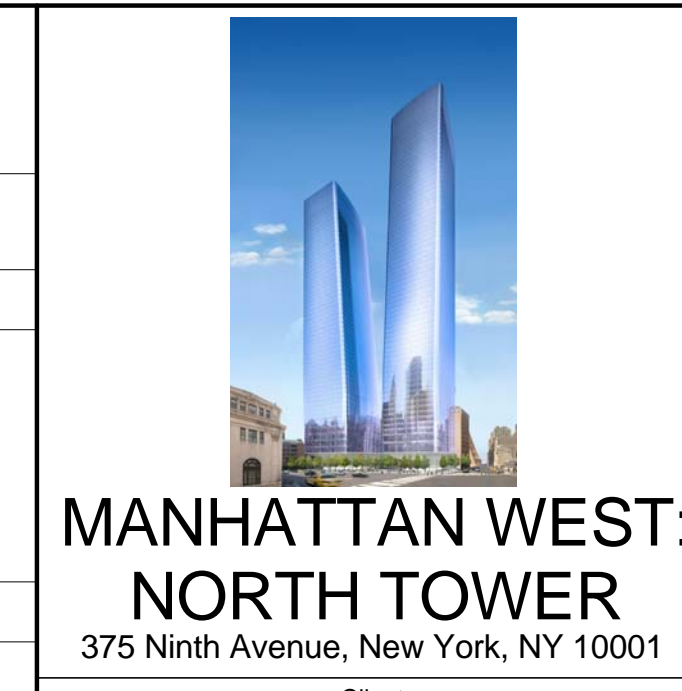
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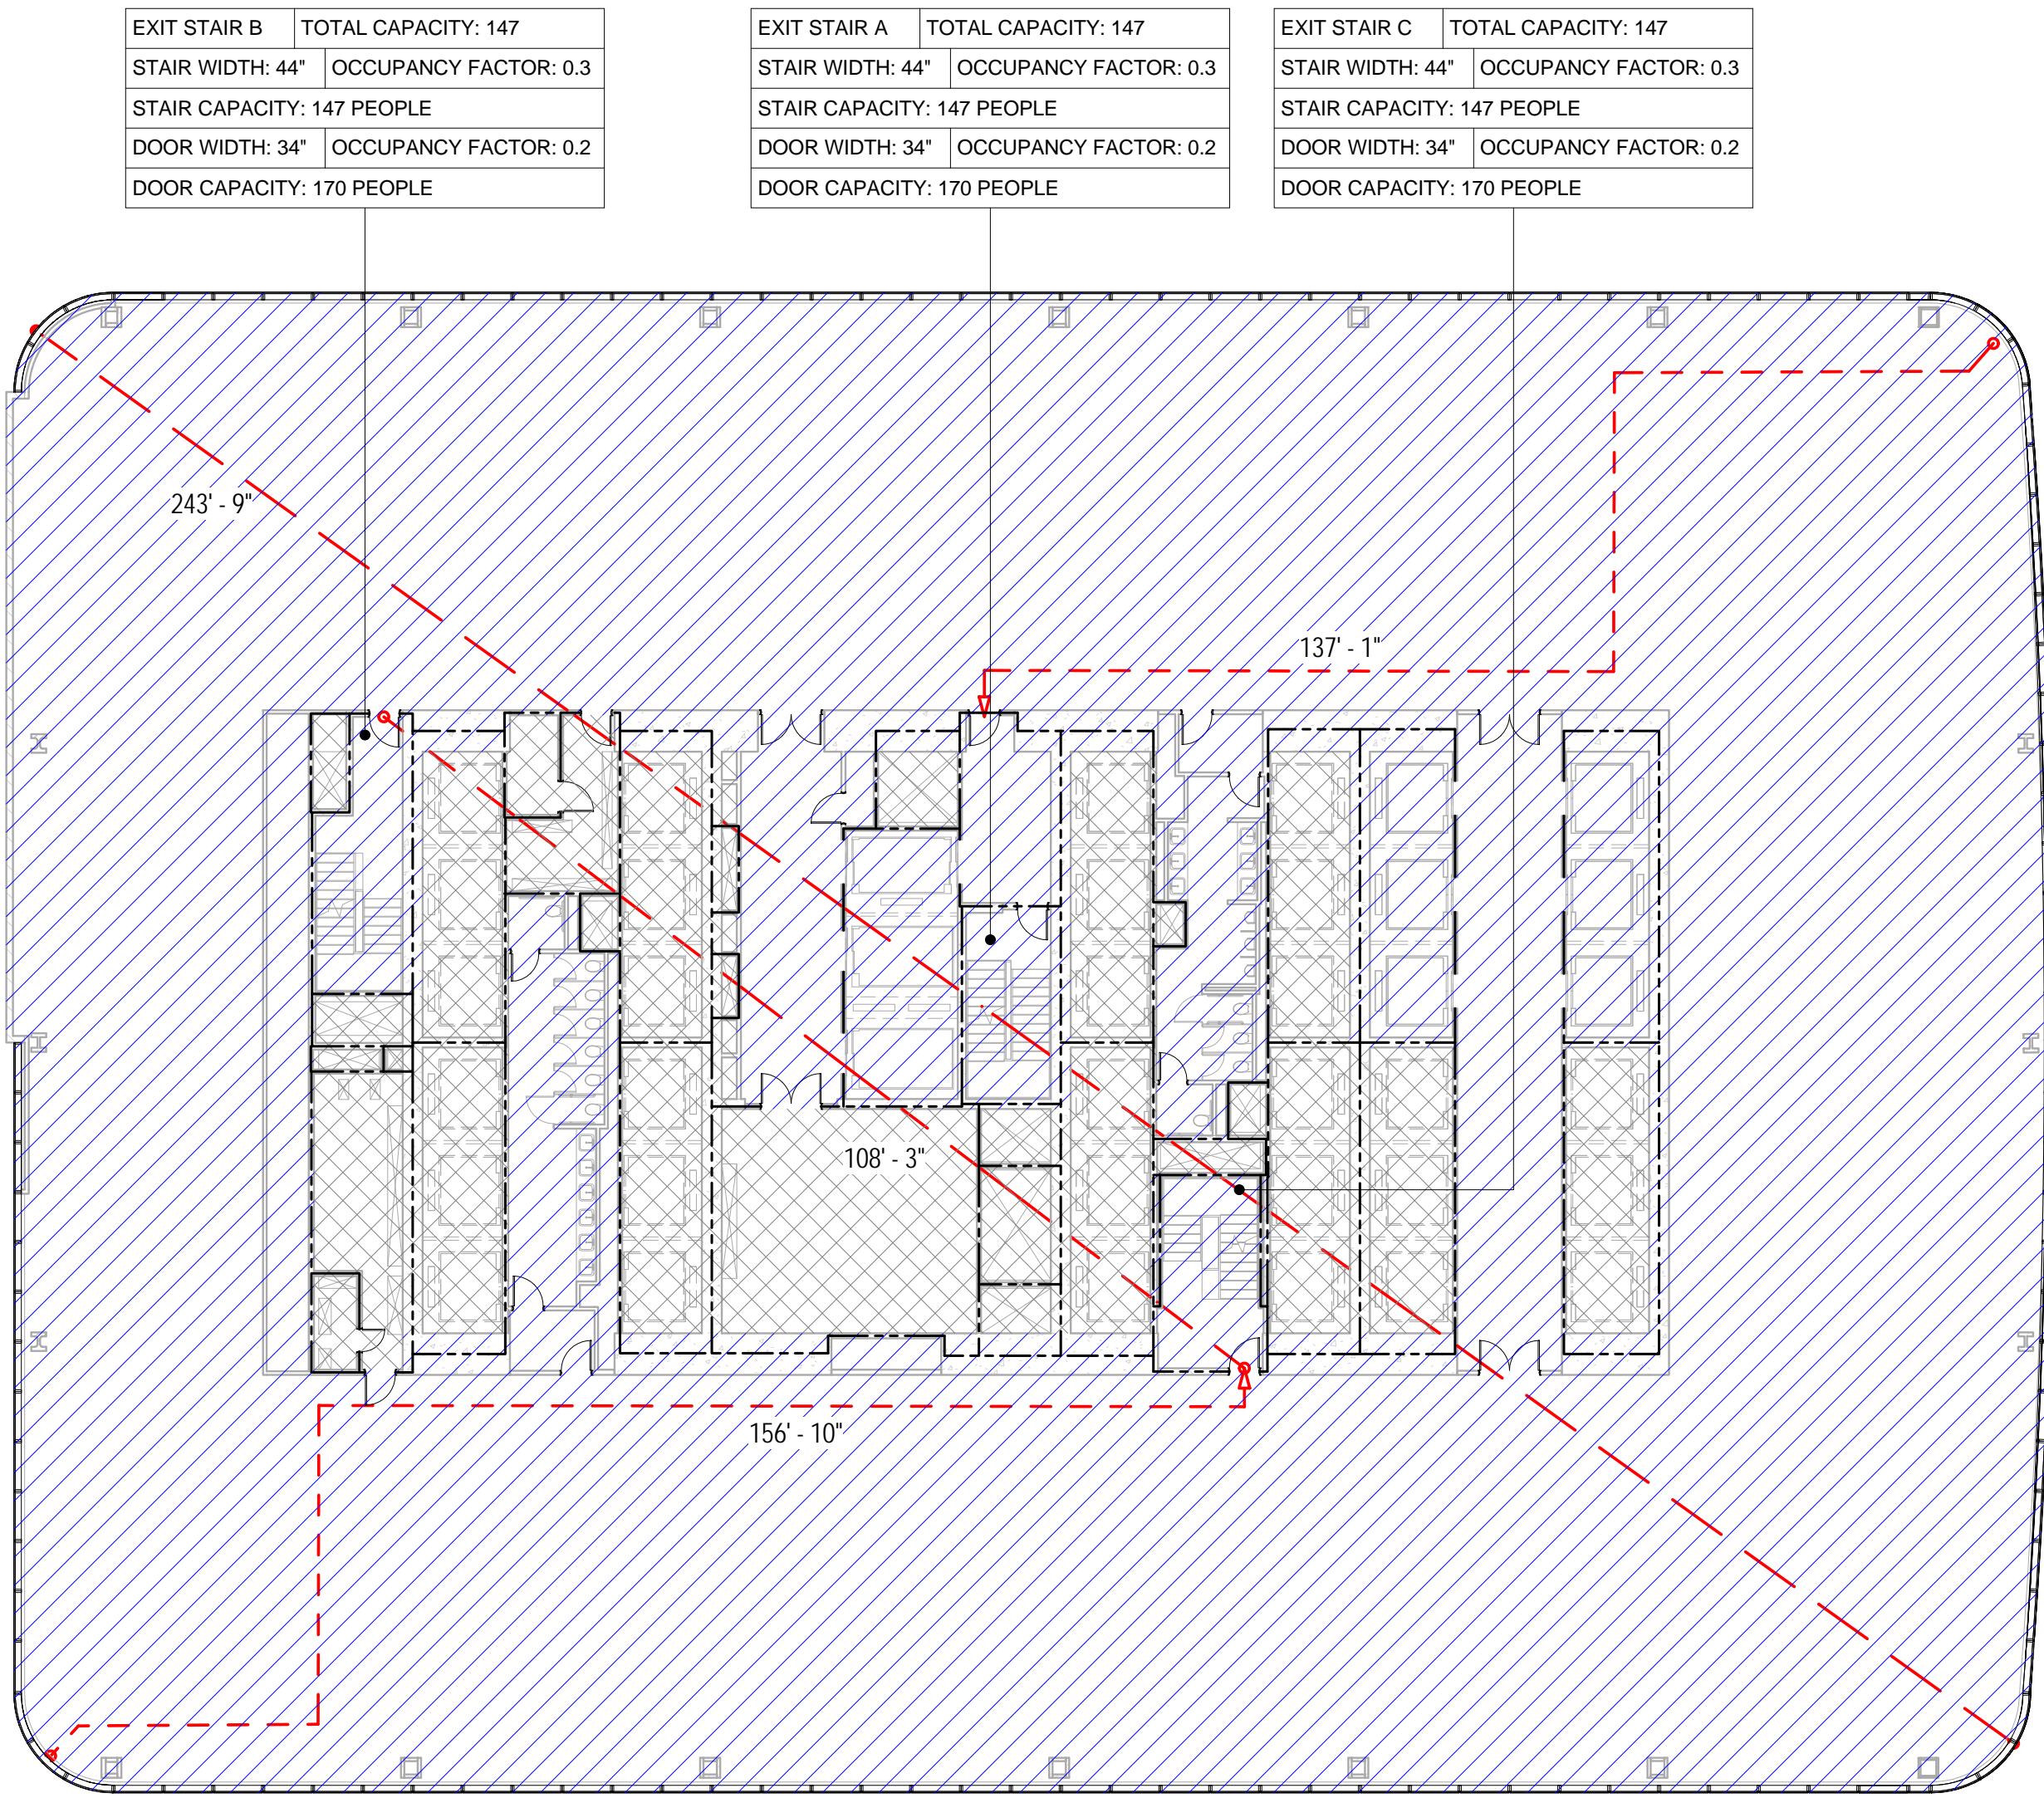
17000 17000 17000 SEE 411.1 15000



1

LEVEL 6-16

SCALE: 1/16" = 1'-0"



EGRESS CAPACITY - LEVEL 6-16							
STAIR	CLEAR STAIR WIDTH	STAIR OCC. FACTOR	STAIR TOTAL	CLEAR DOOR WIDTH	DOOR OCC. FACTOR	DOOR TOTAL	CAPACITY
A	44	0.3	147	34	0.2	170	147
B	44	0.3	147	34	0.2	170	147
C	44	0.3	147	34	0.2	170	147
Grand total							441

OCCUPANT LOAD - LEVEL 6-16			
USE OF SPACE	AREA	FLOOR AREA PER OCCUPANT	TOTAL OCCUPANT LOAD
BUSINESS	26406 R ²	100 R ²	264
MECHANICAL / STORAGE	4209 R ²	300 R ²	14
Grand total	30615 R ²		278

PLUMBING FIXTURE CALCULATION - LEVEL 6-16					
FIXTURE TYPE	REQUIRED*		PROVIDED**		
	MALE	FEMALE	MALE	FEMALE	
WATER CLOSETS	3	6	4	7	
URINALS	3	-	3	-	
LAVATORIES	5	5	6	6	
DRINKING FOUNTAINS	3		0		

*PLUMBING FIXTURE REQUIREMENTS FOR BUSINESS OCCUPANCY ARE BASED ON POPULATION DENSITY OF 100 GROSS SQ. FT. PER PERSON BASED ON CHAPTER 3 OF THE 2008 NEW YORK CITY BUILDING CODE & NYTRO 686A OF THE NEW YORK CITY PLUMBING CODE) AND A 50/50 SPLIT BETWEEN MALE AND FEMALE OCCUPANTS.

**FULFILLMENT OF REQUIRED DRINKING FOUNTAINS TO BE PROVIDED BY TENANT WHERE REQUIRED AS PER SECTION PC 403 OF THE 2008 NEW YORK CITY PLUMBING CODE.

BUILDING CODE

BUILDING CODE OF THE CITY OF NEW YORK - 2008 EDITION, UNLESS OTHERWISE NOTED.

OCCUPANCY CLASSIFICATION

DESIGNATIONS FOR THE BUILDING (SECTION BC 301-312):

A-2	ASSEMBLY
B	BUSINESS (PRIMARY)
M	MERCANTILE
S-1	MODERATE-HAZARD STORAGE
S-2	LOW-HAZARD STORAGE
F-2	LOW-HAZARD FACTORY INDUSTRIAL

CONSTRUCTION CLASSIFICATION

CONSTRUCTION TYPE FOR THE BUILDING (TABLE 503): 1A

FIRE RESISTANCE REQUIREMENTS FOR BUILDING ELEMENTS (TABLE 601 & 602):

BUILDING ELEMENT	FIRE RATING
STRUCTURAL FRAME	3 HRS
BEARING WALLS (EXTERIOR)	3 HRS
BEARING WALLS (INTERIOR)	3 HRS
NONBEARING WALLS & PARTITIONS (EXTERIOR)	1 HR
SEPARATION BETWEEN 5'-0" AND 10'-0"	1 HR
SEPARATION BETWEEN 10'-0" AND 30'-0"	1 HR
SEPARATION GREATER OR EQUAL TO 30'-0"	0 HRS
NONBEARING WALLS & PARTITIONS (INTERIOR)	2 HRS
FLOOR CONSTRUCTION	2 HRS
ROOF CONSTRUCTION	1.5 HR

BUILDING LIMITATIONS

AREA, HEIGHT & # OF STORIES (TABLE 503): CLASS 1A CONSTRUCTION: NO LIMIT FOR HEIGHT, AREA, OR # OF STORIES.

*BUILDING IS FULLY SPRINKLERED IN ACCORDANCE WITH SECTION 903.1.1

FIRE SEPARATION

BUILDING IS FULLY SPRINKLERED IN ACCORDANCE WITH SECTION 903.1.1

OCCUPANCY SEPARATION NEED NOT BE PROVIDED FOR STORAGE AREAS SERVING GROUP B OR IF ANY OF THE FOLLOWING CONDITIONS APPLY (TABLE 508.1.3):

- THE STORAGE AREA IS LESS THAN 10% OF THE FLOOR AREA AND LESS THAN 1,000 R²
- THE STORAGE AREA IS PROVIDED WITH AN AUTOMATIC FIRE EXTINGUISHING SYSTEM AND IS LESS THAN 1,000 R²
- THE STORAGE AREA IS LESS THAN 1,000 R²

SPACES OCCUPIED BY DIFFERENT TENANTS SHALL BE SEPARATED BY FIRE BARRIERS HAVING AT LEAST 1 HOUR FIRE RESISTANCE RATINGS (SECTION 509.9).

MEANS OF EGRESS

EXIT ACCESS TRAVEL DISTANCE (TABLE 1015.1):

OCCUPANCY	W/ SPRINKLER SYSTEM (R ²)	
	PRIMARY	SECONDARY
A-2	150	250
B	300	250
M	200	
S-1	200	
S-2	250	
F-2	250	

*BUILDING IS FULLY SPRINKLERED IN ACCORDANCE WITH SECTION 903.1.1

EXIT OR EXIT ACCESS REMOTENESS (SECTION 1014.2.1): MIN. EXIT REMOTENESS: 1/3 THE MAX. DIAGONAL DISTANCE MIN. EXIT REMOTENESS (SPRINKLERED): 1/3 THE MAX. DIAGONAL DISTANCE

DEAD ENDS (TABLE 3): MAX. DEAD END LENGTH (GROUP B, F): 50'-0"

COMMON PATH OF EGRESS TRAVEL (TABLE 1013.3): MAX. COMMON PATH OF EGRESS (GROUP B, F, S): 100'-0"

*BUILDING IS FULLY SPRINKLERED IN ACCORDANCE WITH SECTION 903.1.1

DOOR WIDTH (SECTION 1008.1.1.1): MIN. DOOR CLEAR WIDTH (SINGLE LEAF): 32" MIN. DOOR CLEAR WIDTH (DOUBLE LEAF): 32" FOR A SINGLE LEAF MAX. DOOR CLEAR WIDTH (PER LEAF): 48"

STAIRWAY WIDTH (SECTION 1009.1): MIN. STAIRWAY WIDTH: 44"

CORRIDOR WIDTH (SECTION 1016.2): MIN. CORRIDOR WIDTH: 44"

*BUILDING IS FULLY SPRINKLERED IN ACCORDANCE WITH SECTION 903.1.1

EXIT ENCL. DOUBLE FIRE RATING REQUIREMENTS (SECTION 1010.1): MIN. FIRE RATING REQUIREMENT: 2 HRS

EXIT DOOR FIRE RATING REQUIREMENTS (TABLE 715.3): MIN. FIRE RATING REQUIREMENT: 1.5 HRS

STAIR REQUIREMENTS (SECTION 1009.2 & 1009.3): MIN. HEADROOM: 8'-0" MIN. RISER HEIGHT: 4" MAX. RISER HEIGHT: 7" MIN. TREAD DEPTH: 11"

PLUMBING FACILITIES

(2008 NEW YORK CITY PLUMBING CODE)

MINIMUM NUMBER OF FIXTURES (SECTION 403.1): PLUMBING FIXTURES SHALL BE PROVIDED FOR THE TYPE OF OCCUPANCY AND IN THE MINIMUM NUMBER SHOWN IN TABLE 403.1. TYPES OF OCCUPANCIES NOT SHOWN IN TABLE 403.1 SHALL BE CONSIDERED INDIVIDUALLY BY THE COMMISSIONER. THE NUMBER OF OCCUPANTS AND OCCUPANCY CLASSIFICATION SHALL BE DETERMINED BY THE NEW YORK CITY BUILDING CODE.

MIN. NO. OF PLUMBING FIXTURES (TABLE 403.1)					
OCC.	WC	LAV.	TURY	DRINKING	OTHER
A-2	175	175	1	1	1 SWS SINK
B	200	200	1	1	1 SWS SINK
M	SEE CHART BELOW	1/1000	1	1	1 SWS SINK
S-1	1/1000	1/1000	1	1	1 SWS SINK
S-2	1/1000	1/1000	1	1	1 SWS SINK
F-2	1/1000	1/1000	1	1	1 SWS SINK

BUSINESS PLUMBING FIXTURE REQUIREMENT (TABLE 403.1): WATER CLOSETS & URINALS: LAVATORIES: (PER SEX)

1-20	1	1-25	1
21-45	2	26-50	2
46-70	3	51-75	3
71-100	4	76-115	4
101-140	5	116-160	5
141-190			

1 FIXTURE PER ADDITIONAL 60 PERSONS 1 FIXTURE PER ADDITIONAL 60 PERSONS

NUMBER OF OCCUPANTS OF EACH SEX (SECTION 403.3): THE OCCUPANT LOAD SHALL BE COMPOSED OF 50% OF EACH SEX

REQUIRED DRINKING FOUNTAINS (SECTION 419.2): UP TO 50% OF THE REQUIRED DRINKING FOUNTAINS MAY BE SUBSTITUTED BY DEDICATED PLUMBING FIXTURES WITH FAUCETS DESIGNED FOR FILLING A CONTAINER AT LEAST 3' IN HEIGHT.

SUBSTITUTION FOR WATER CLOSETS (SECTION 419.2): URINALS SHALL NOT BE SUBSTITUTED FOR MORE THAN 50% OF THE REQUIRED WATER CLOSETS.

Warning: It is a violation of the New York State Architecture Law, §19-50 (b) for any person, unless they are acting under the direction of a Licensed Architect, to alter this item in any way.

Project No.: 207150 B-SCAN Sheet No.: A-016.00

Date: 20 JUN 2014

Scale: 1/16" = 1'-0"

File No.: A-016

Sheet Name: CODE ANALYSIS - LEVEL 5 & 6-16

LEGEND

	BUSINESS
	ASSEMBLY (UNCONCENTRATED)
	MERCANTILE
	MECHANICAL / STORAGE
	PARKING
	LOCKER ROOMS



MANHATTAN WEST: NORTH TOWER

Client

Brookfield Place
250 Vesey Street, 15th Floor, New York, NY 10021

Architecture/Structural Engineering

SOM
Skidmore, Owings & Merrill LLP
14 Wall Street, New York, NY 10005

Civil Engineering

Philip Habib & Associates
102 Madison Avenue #11, New York, NY 10016

MEP Engineering

Jaros Baum & Bolles
80 Pine Street, New York, NY 10005

Vertical Transportation

Edgett Williams Consulting Group, Inc.
102 East Bluffside Ave, Suite 1, Mill Valley, California 94041

Sustainable Design

Viridian Energy & Environmental
50 Washington Street, Newark, CT 06854

Geotechnical Engineering

Mueser Rutledge Consulting Engineers
14 Penn Plaza, 225 W. 34th Street, New York, NY 10122

Landscape Consultant

Field Operations
475 10th Avenue, New York, NY 10018

Security Consultant

Ducibella, Ventor & Santoro
250 State Street #F1, North Haven, CT 06473

Blast Consultant

Weidinger Associates, Inc.
40 Wall Street, New York, NY 10005

Acoustical Consultant

Cerami & Associates
404 Fifth Avenue #B, New York, NY 10018

Vibration Consultant

Wilson, Uhrig & Associates, Inc.
65 Broadway, Suite 401, New York, NY 10006

Code Consultant

Code Consultants Professional Engineers PC
215 West 40th Street, 15th Floor, New York, NY 10018


Facade Maintenance Consultant

Entek Engineering LLC
166 Ames Street, Hackensack, NJ 07601

Wind Tunnel Consultant

Rowan Williams Davies & Irwin Inc.
650 Woodlawn Road West, Guelph Ontario, Canada N1K 1B8

Key Plan:

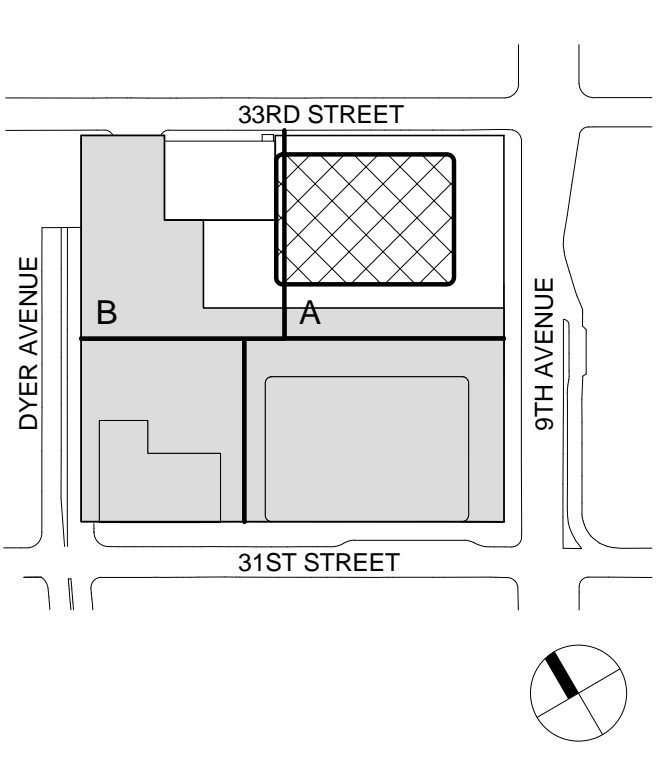

Seal & Signature:



Warning: It is a violation of the New York State Architecture Law, §19-50 (b) for any person, unless they are acting under the direction of a Licensed Architect, to alter this item in any way.

Project No.: 207150 B-SCAN Sheet No.: A-016.00

Date: 20 JUN 2014


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File No.: A-016

Sheet Name: CODE ANALYSIS - LEVEL 5 & 6-16

	BUSINESS
	ASSEMBLY (UNCONCENTRATED)
	MERCANTILE
	MECHANICAL / STORAGE
	PARKING
	LOCKER ROOMS

1 LEVEL 33-36
SCALE: 1/16" = 1'-0"

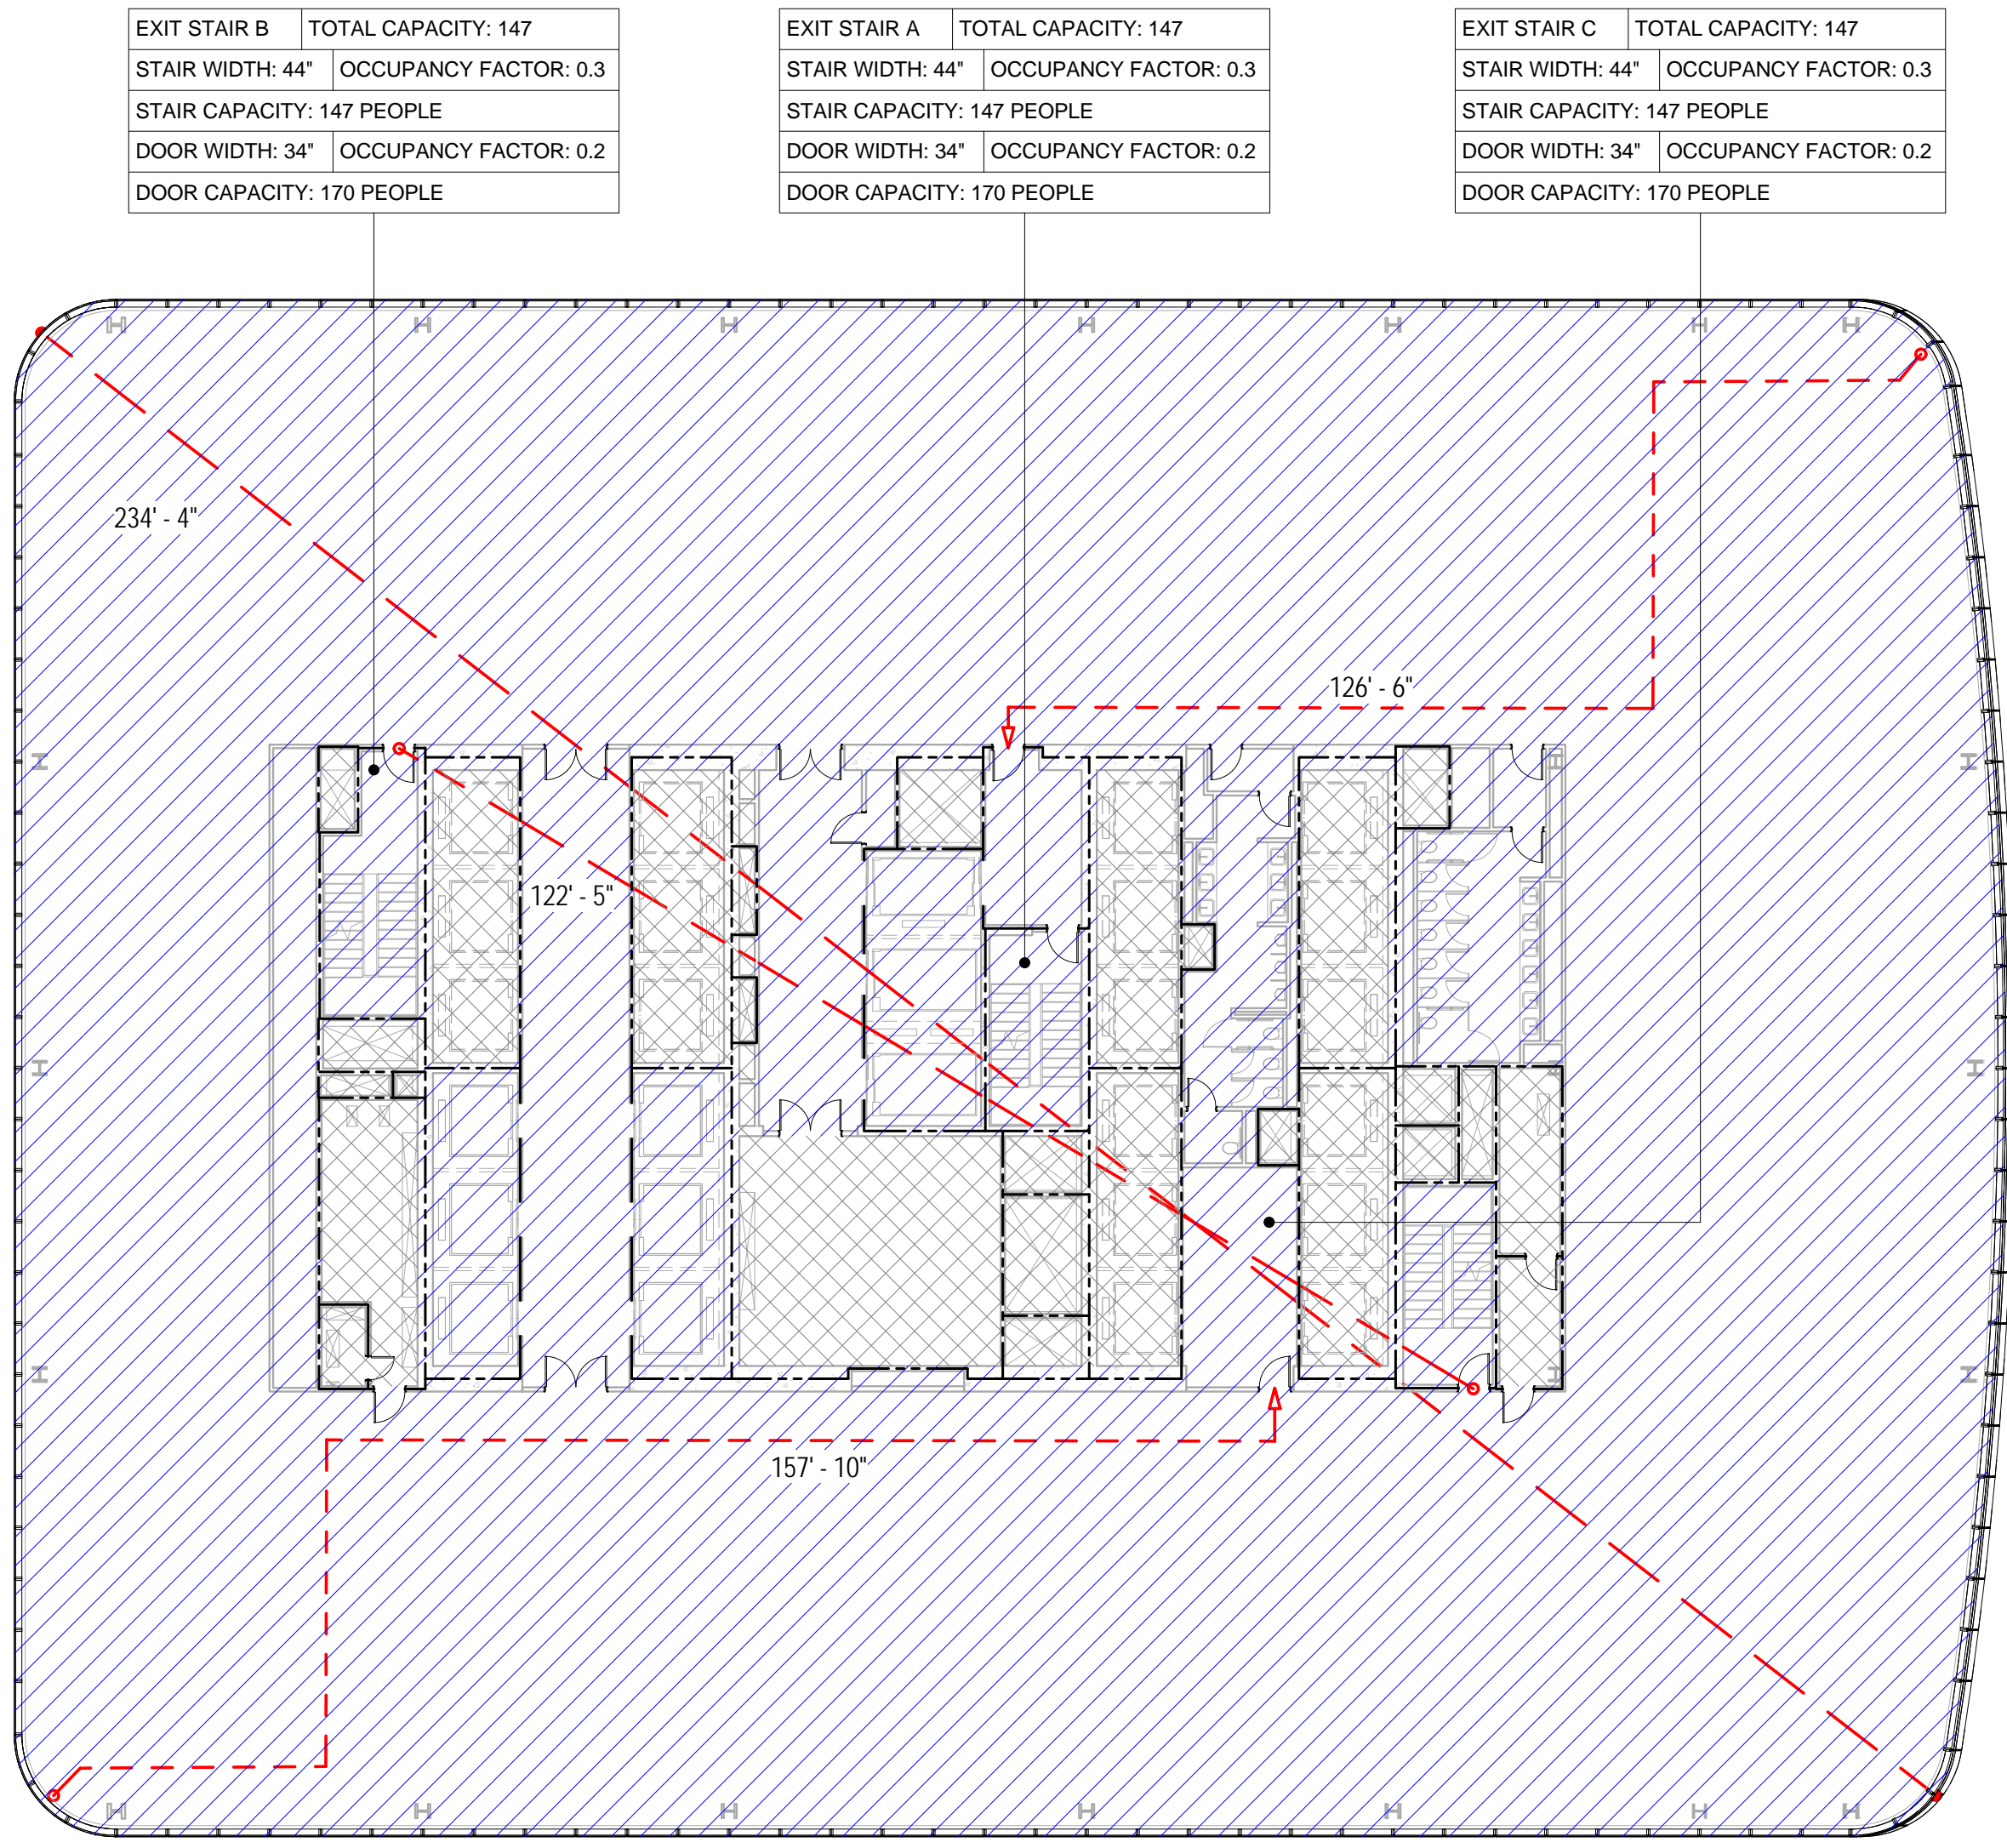

EGRESS CAPACITY - LEVEL 33-36							
STAIR	CLEAR STAIR WIDTH	STAIR OCC. FACTOR	STAIR OCC. TOTAL	CLEAR DOOR WIDTH	DOOR OCC. FACTOR	DOOR OCC. TOTAL	CAPACITY
A	44	0.3	147	34	0.2	170	147
B	44	0.3	147	34	0.2	170	147
C	44	0.3	147	34	0.2	170	147
Grand total							441

OCCUPANT LOAD - LEVEL 33-36			
USE OF SPACE	AREA	FLOOR AREA PER OCCUPANT	TOTAL OCCUPANT LOAD
BUSINESS	25814 SF	100 SF	258
MECHANICAL / STORAGE	3137 SF	300 SF	10
Grand total	28951 SF		268

PLUMBING FIXTURE CALCULATION - LEVEL 33-36					
FIXTURE TYPE	REQUIRED*		PROVIDED**		
	MALE	FEMALE	MALE	FEMALE	
WATER CLOSETS	3	6	4	7	
URINALS	3	-	3	-	
LAVATORIES	5	5	6	6	
DRINKING FOUNTAINS	3		0		

*PLUMBING FIXTURE REQUIREMENTS FOR BUSINESS OCCUPANCY ARE BASED ON POPULATION DENSITY OF 100 GROSS SQ. FT. PER PERSON BASED ON CHAPTER 3 OF THE 2008 NEW YORK CITY BUILDING CODE & NYTRO 688A OF THE NEW YORK CITY PLUMBING CODE) AND A 50/50 SPLIT BETWEEN MALE AND FEMALE OCCUPANTS.

**FULFILLMENT OF REQUIRED DRINKING FOUNTAINS TO BE PROVIDED BY TENANT WHERE REQUIRED AS PER SECTION PC 403 OF THE 2008 NEW YORK CITY PLUMBING CODE.

BUILDING CODE

BUILDING CODE OF THE CITY OF NEW YORK - 2008 EDITION, UNLESS OTHERWISE NOTED.

OCCUPANCY CLASSIFICATION

DESIGNATIONS FOR THE BUILDING (SECTION BC 301-312):

A-2	ASSEMBLY
B	BUSINESS (PRIMARY)
M	MERCANTILE
S-1	MODERATE-HAZARD STORAGE
S-2	LOW-HAZARD STORAGE
F-2	LOW-HAZARD FACTORY INDUSTRIAL

CONSTRUCTION CLASSIFICATION

CONSTRUCTION TYPE FOR THE BUILDING (TABLE 503.1A)

FIRE RESISTANCE REQUIREMENTS FOR BUILDING ELEMENTS (TABLE 601 & 602):

BUILDING ELEMENT	FIRE RATING
STRUCTURAL FRAME	3 HRS
BEARING WALLS (EXTERIOR)	3 HRS
BEARING WALLS (INTERIOR)	3 HRS
NONBEARING WALLS & PARTITIONS (EXTERIOR)	1 HR
SEPARATION BETWEEN 5'-0" AND 10'-0"	1 HR
SEPARATION BETWEEN 10'-0" AND 30'-0"	1 HR
SEPARATION GREATER OR EQUAL TO 30'-0"	0 HRS
NONBEARING WALLS & PARTITIONS (INTERIOR)	2 HRS
FLOOR CONSTRUCTION	1.5 HR
ROOF CONSTRUCTION	1.5 HR

BUILDING LIMITATIONS

AREA, HEIGHT & # OF STORIES (TABLE 503):

CLASS 1A CONSTRUCTION; NO LIMIT FOR HEIGHT, AREA, OR # OF STORIES.

*BUILDING IS FULLY SPRINKLERED IN ACCORDANCE WITH SECTION 903.1.1

FIRE SEPARATION

BUILDING IS FULLY SPRINKLERED IN ACCORDANCE WITH SECTION 903.1.1

OCCUPANCY SEPARATION NEED NOT BE PROVIDED FOR STORAGE AREAS SERVING GROUP B OR M IF ANY OF THE FOLLOWING CONDITIONS APPLY (TABLE 508.1.3):

- THE STORAGE AREA IS LESS THAN 10% OF THE FLOOR AREA AND LESS THAN 1,000 SF

- THE STORAGE AREA IS PROVIDED WITH AN AUTOMATIC FIRE EXTINGUISHING SYSTEM AND IS LESS THAN 1,000 SF

- THE STORAGE AREA IS LESS THAN 1,000 SF

SPACES OCCUPIED BY DIFFERENT TENANTS SHALL BE SEPARATED BY FIRE BARRIERS HAVING AT LEAST 1-HOUR FIRE RESISTANCE RATINGS (SECTION 509.9)

MEANS OF EGRESS

EXIT ACCESS TRAVEL DISTANCE (TABLE 1015.1)

OCCUPANCY

	W/ SPRINKLER SYSTEM (1)	
	PRIMARY	SECONDARY
A-2	150	250
B	300	250
M	200	
S-1	200	
S-2	250	
F-2	250	

*BUILDING IS FULLY SPRINKLERED IN ACCORDANCE WITH SECTION 903.1.1

EXIT OR EXIT ACCESS REMOTENESS (SECTION 1014.2.1):

MIN. EXIT REMOTENESS: 1/2 THE MAX. DIAGONAL DISTANCE

MIN. EXIT REMOTENESS (SPRINKLERED): 1/3 THE MAX. DIAGONAL DISTANCE

DEAD ENDS (1015.3):

MAX. DEAD END LENGTH (GROUP B, F): 50'-0"

COMMON PATH OF EGRESS TRAVEL (1013.3):

MAX. COMMON PATH OF EGRESS (GROUP B, F, S): 100'-0"

*BUILDING IS FULLY SPRINKLERED IN ACCORDANCE WITH SECTION 903.1.1

DOOR WIDTH (SECTION 1008.1.1.1):

MIN. DOOR CLEAR WIDTH (SINGLE LEAF): 32"

MIN. DOOR CLEAR WIDTH (DOUBLE LEAF): 32" FOR A SINGLE LEAF

MAX. DOOR CLEAR WIDTH (PER LEAF): 48"

STAIRWAY WIDTH (SECTION 1009.1):

MIN. STAIRWAY WIDTH: 44"

CORRIDOR WIDTH (SECTION 1016.2):

MIN. CORRIDOR WIDTH: 44"

*BUILDING IS FULLY SPRINKLERED IN ACCORDANCE WITH SECTION 903.1.1

EXIT ENVELOPE FIRE RATING REQUIREMENTS (SECTION 1019.1)

MIN. FIRE RATING REQUIREMENT: 2 HRS

EXIT DOOR FIRE RATING REQUIREMENTS (TABLE 715.3):

MIN. FIRE RATING REQUIREMENT: 1.5 HRS

STAIR REQUIREMENTS (SECTION 1009.2 & 1009.3):

MIN. HEADROOM: 8'-0"

MIN. RISER HEIGHT: 4"

MAX. RISER HEIGHT: 7"

MIN. TREAD DEPTH: 11"

PLUMBING FACILITIES

(2008 NEW YORK CITY PLUMBING CODE)

MINIMUM NUMBER OF FIXTURES (SECTION 403.1):

PLUMBING FIXTURES SHALL BE PROVIDED FOR THE TYPE OF OCCUPANCY AND IN THE MINIMUM NUMBER SHOWN IN TABLE 403.1. TYPES OF OCCUPANCIES NOT SHOWN IN TABLE 403.1 SHALL BE CONSIDERED INDIVIDUALLY BY THE COMMISSIONER.

THE NUMBER OF OCCUPANTS AND OCCUPANCY CLASSIFICATION SHALL BE DETERMINED BY THE NEW YORK CITY BUILDING CODE

MIN. NO. OF PLUMBING FIXTURES (TABLE 403.1)

OCC. NO. OF PLUMBING FIXTURES (TABLE 403.1)

WATER CLOSETS & URINALS

LAVATORIES

PER PERSONS

PER PERSONS

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PER PERSONS

PER PERSONS

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Key Plan:
33RD STREET
DYER AVENUE
31ST STREET
9TH AVENUE

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1 18 MAR 2012 ISSUED FOR RECONCILIATION

Project No.: 207150
Date: 20 JUN 2014
Scale: 1/16" = 1'-0"
File No.: A-021

B-SCAN Sheet No.:
A-021.00
Sheet No.:
A-021
Page No.: 15 OF 87

CODE ANALYSIS - LEVEL 32 & 33-36

LEGEND

BUSINESS

ASSEMBLY (UNCONCENTRATED)

MERCANTILE

MECHANICAL / STORAGE

PARKING


LOCKER ROOMS

1

LEVEL 57

SCALE: 1/16" = 1'-0"

EXIT STAIR B	TOTAL CAPACITY: 147	EXIT STAIR A	TOTAL CAPACITY: 147	EXIT STAIR C	TOTAL CAPACITY: 147
STAIR WIDTH: 44"	OCCUPANCY FACTOR: 0.3	STAIR WIDTH: 44"	OCCUPANCY FACTOR: 0.3	STAIR WIDTH: 44"	OCCUPANCY FACTOR: 0.3
STAIR CAPACITY: 147 PEOPLE		STAIR CAPACITY: 147 PEOPLE		STAIR CAPACITY: 147 PEOPLE	
DOOR WIDTH: 34"	OCCUPANCY FACTOR: 0.2	DOOR WIDTH: 34"	OCCUPANCY FACTOR: 0.2	DOOR WIDTH: 34"	OCCUPANCY FACTOR: 0.2
DOOR CAPACITY: 170 PEOPLE		DOOR CAPACITY: 170 PEOPLE		DOOR CAPACITY: 170 PEOPLE	

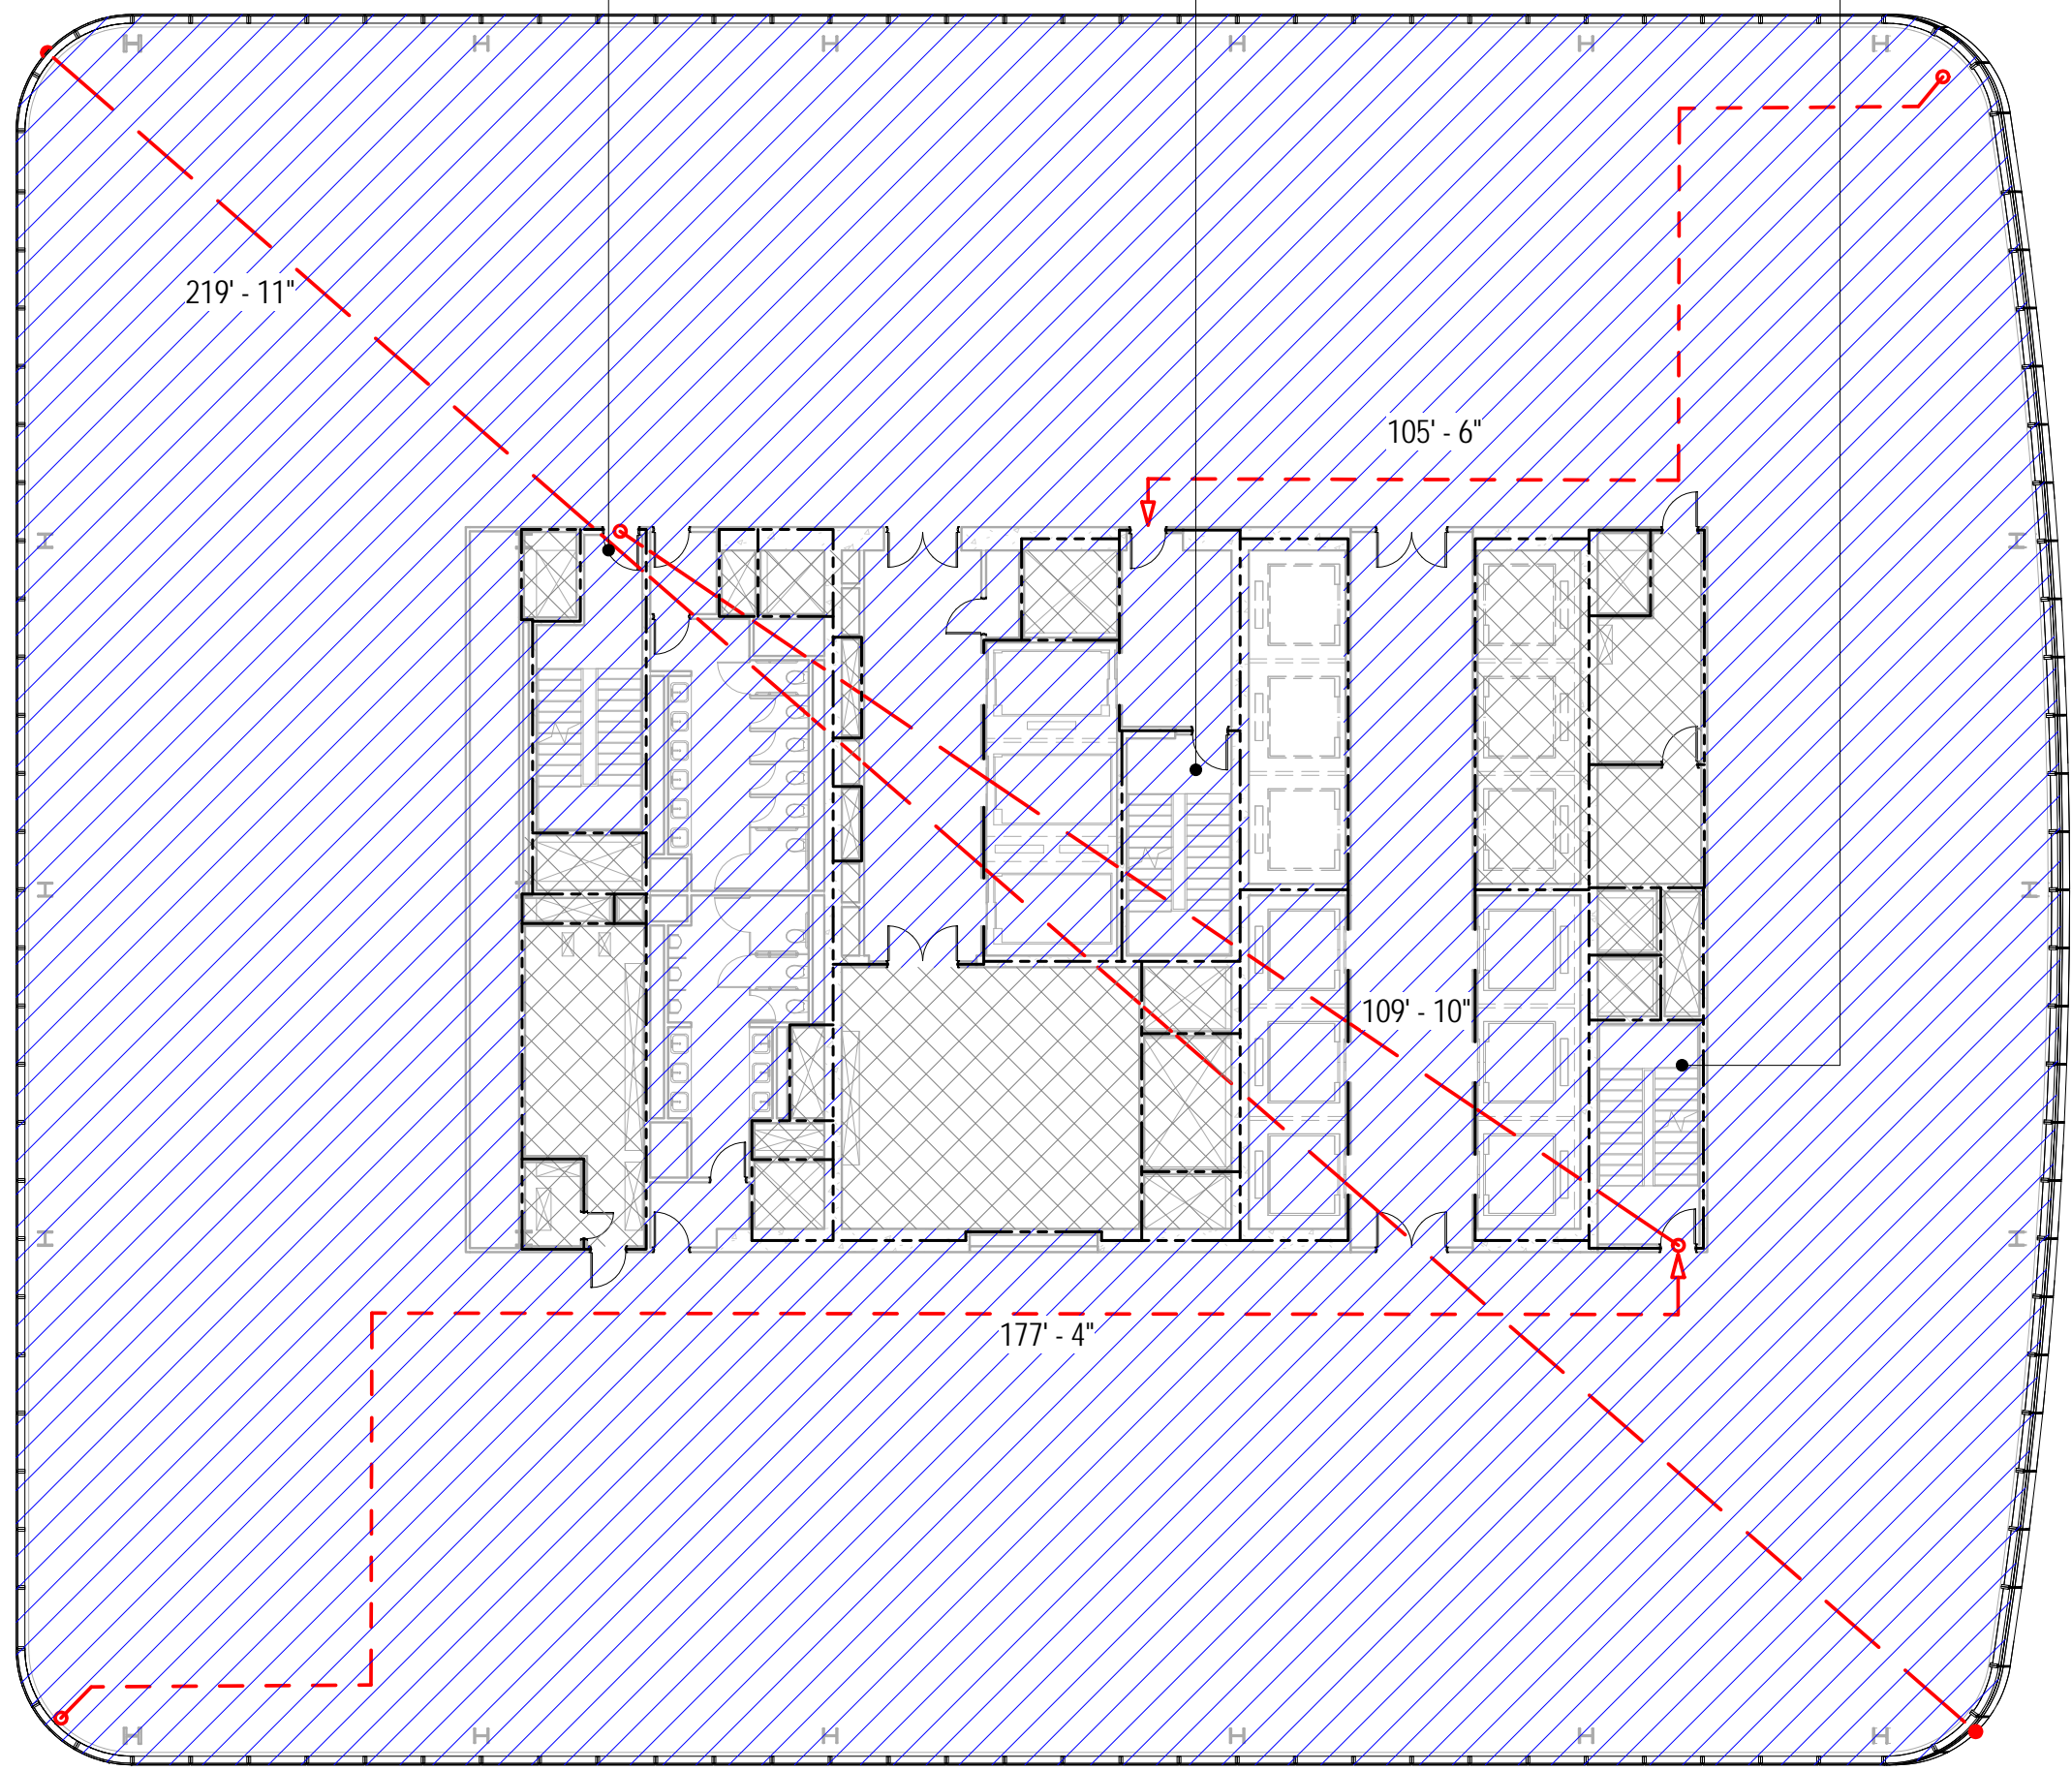

EGRESS CAPACITY - LEVEL 57-58					
STAIR	CLEAR STAIR WIDTH	STAIR OCC. FACTOR	STAIR OCC. TOTAL	CLEAR DOOR WIDTH	DOOR OCC. FACTOR
A	44	0.3	147	34	0.2
B	44	0.3	147	34	0.2
C	44	0.3	147	34	0.2
Grand total					

OCCUPANT LOAD - LEVEL 57-58			
USE OF SPACE	AREA	FLOOR AREA PER OCCUPANT	TOTAL OCCUPANT LOAD
BUSINESS	23768 SF	100 SF	238
MECHANICAL / STORAGE	2060 SF	300 SF	7
Grand total	25828 SF		245

PLUMBING FIXTURE CALCULATION - LEVEL 57-58					
FIXTURE TYPE	REQUIRED*		PROVIDED**		
	MALE	FEMALE	MALE	FEMALE	
WATER CLOSETS	3	5	3	6	
URINALS	2	-	3	-	
LAVATORIES	5	5	6	6	
DRINKING FOUNTAINS	3		0		

*PLUMBING FIXTURE REQUIREMENTS FOR BUSINESS OCCUPANCY ARE BASED ON POPULATION DENSITY OF 100 GROSS SQ. FT. PER PERSON BASED ON CHAPTER 3 OF THE 2008 NEW YORK CITY BUILDING CODE & NYTCO 688A OF THE NEW YORK CITY PLUMBING CODE) AND A 50/50 SPLIT BETWEEN MALE AND FEMALE OCCUPANTS.

**FULFILLMENT OF REQUIRED DRINKING FOUNTAINS TO BE PROVIDED BY TENANT WHERE REQUIRED AS PER SECTION PC 403 OF THE 2008 NEW YORK CITY PLUMBING CODE.

BUILDING CODE

BUILDING CODE OF THE CITY OF NEW YORK - 2008 EDITION, UNLESS OTHERWISE NOTED.

OCCUPANCY CLASSIFICATION

DESIGNATIONS FOR THE BUILDING (SECTION BC 301-312):

A-2 ASSEMBLY
B BUSINESS (PRIMARY)
M MERCANTILE
S-1 MODERATE-HAZARD STORAGE
F-2 LOW-HAZARD FACTORY INDUSTRIAL

CONSTRUCTION CLASSIFICATION

CONSTRUCTION TYPE FOR THE BUILDING (TABLE 503.1A)

FIRE RESISTANCE REQUIREMENTS FOR BUILDING ELEMENTS (TABLE 601 & 602):

BUILDING ELEMENT	FIRE RATING
STRUCTURAL FRAME	3 HRS
BEARING WALLS (EXTERIOR)	3 HRS
BEARING WALLS (INTERIOR)	3 HRS
NONBEARING WALLS & PARTITIONS (EXTERIOR)	1 HR
SEPARATION BETWEEN 5'-0" AND 10'-0"	1 HR
SEPARATION BETWEEN 10'-0" AND 30'-0"	0 HRS
SEPARATION GREATER OR EQUAL TO 30'-0"	2 HRS
NONBEARING WALLS & PARTITIONS (INTERIOR)	15 HR
FLOOR CONSTRUCTION	
ROOF CONSTRUCTION	

BUILDING LIMITATIONS

AREA, HEIGHT & # OF STORIES (TABLE 503):

CLASS 1A CONSTRUCTION: NO LIMIT FOR HEIGHT, AREA, OR # OF STORIES.

*BUILDING IS FULLY SPRINKLERED IN ACCORDANCE WITH SECTION 903.3.1.1

FIRE SEPARATION

BUILDING IS FULLY SPRINKLERED IN ACCORDANCE WITH SECTION 903.3.1.1

OCCUPANCY SEPARATION NEED NOT BE PROVIDED FOR STORAGE AREAS SERVING GROUP B OR IF ANY OF THE FOLLOWING CONDITIONS APPLY (TABLE 508.1.3):

THE STORAGE AREA IS LESS THAN 10% OF THE FLOOR AREA AND LESS THAN 1,000 SF.
THE STORAGE AREA IS PROVIDED WITH AN AUTOMATIC FIRE EXTINGUISHING SYSTEM AND IS LESS THAN 1,000 SF.
THE STORAGE AREA IS LESS THAN 1,000 SF.

SPACES OCCUPIED BY DIFFERENT TENANTS SHALL BE SEPARATED BY FIRE BARRIERS HAVING AT LEAST 1 HOUR FIRE RESISTANCE RATINGS (SECTION 509.9).

MEANS OF EGRESS

EXIT ACCESS TRAVEL DISTANCE (TABLE 1015.1)

OCCUPANCY	W/ SPRINKLER SYSTEM (F)	
	PRIMARY	SECONDARY
A-2	150	250
B	300	
M	200	
S-1	200	
S-2	250	
F-2	250	

*BUILDING IS FULLY SPRINKLERED IN ACCORDANCE WITH SECTION 903.3.1.1

EXIT OR EXIT ACCESS REMOTENESS (SECTION 1014.2.1):

MIN. EXIT REMOTENESS: 1/3 THE MAX. DIAGONAL DISTANCE

MIN. EXIT REMOTENESS (SPRINKLERED): 1/3 THE MAX. DIAGONAL DISTANCE

DEAD ENDS (TABLE 3):

MAX. DEAD END LENGTH (GROUP B, F): 50'-0"

COMMON PATH OF EGRESS TRAVEL (TABLE 1013.3):

MAX. COMMON PATH OF EGRESS (GROUP B, F, S): 100'-0"

*BUILDING IS FULLY SPRINKLERED IN ACCORDANCE WITH SECTION 903.3.1.1

DOOR WIDTH (SECTION 1008.1.1.1):

MIN. DOOR CLEAR WIDTH (SINGLE LEAF): 32"

MIN. DOOR CLEAR WIDTH (DOUBLE LEAF): 32" FOR A SINGLE LEAF

MAX. DOOR CLEAR WIDTH (PER LEAF): 48"

STAIRWAY WIDTH (SECTION 1009.1):

MIN. STAIRWAY WIDTH: 44"

CORRIDOR WIDTH (SECTION 1010.2):

MIN. CORRIDOR WIDTH: 44"

*BUILDING IS FULLY SPRINKLERED IN ACCORDANCE WITH SECTION 903.3.1.1

EXIT DOOR DOUBLE FIRE RATING REQUIREMENTS (SECTION 1010.1)

MIN. FIRE RATING REQUIREMENT: 2 HRS

EXIT DOOR FIRE RATING REQUIREMENTS (TABLE 715.3):

MIN. FIRE RATING REQUIREMENT: 1.5 HRS

STAIR REQUIREMENTS (SECTION 1009.2 & 1009.3):

MIN. HEADROOM: 8'-0"

MIN. RISER HEIGHT: 4"

MAX. RISER HEIGHT: 7"

MIN. TREAD DEPTH: 11"

PLUMBING FACILITIES

(2008 NEW YORK CITY PLUMBING CODE)

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MIN. NO. OF PLUMBING FIXTURES (TABLE 403.1)

OCC.	WC	AV.	TUR.	DRINKING	OTHER
A-2	1/25	1/25	1/25	1/25	1/25
B	200	200	1/1000	1/1000	1/1000
M	SEE CHART BELOW	1/1000	1/1000	1/1000	1/1000
S-1	1/1000	1/1000	1/1000	1/1000	1/1000
S-2	1/1000	1/1000	1/1000	1/1000	1/1000
F-2	1/1000	1/1000	1/1000	1/1000	1/1000

BUSINESS PLUMBING FIXTURE REQUIREMENT (TABLE 403.1)

WATER CLOSETS & URINALS: LAVATORIES:

OF PERSONS / # OF FIXTURES: # OF PERSONS / # OF FIXTURES:

1-20: 1: 1-25: 1:

21-45: 2: 46-70: 3: 71-100: 4: 101-140: 5: 141-190: 6:

1 FIXTURE PER ADDITIONAL 60 PERSONS: 1 FIXTURE PER ADDITIONAL 60 PERSONS:

NUMBER OF OCCUPANTS OF EACH SEX (SECTION 403.3):

THE OCCUPANT LOAD SHALL BE COMPOSED OF 50% OF EACH SEX.

REQUIRED DRINKING FOUNTAINS (SECTION 419.2):

UP TO 50% OF THE REQUIRED DRINKING FOUNTAINS MAY BE SUBSTITUTED BY DESIGNATED PLUMBING FIXTURES WITH FAUCETS DESIGNED FOR FILLING A CONTAINER AT LEAST 37 IN HEIGHT.

SUBSTITUTION FOR WATER CLOSETS (SECTION 419.2):

URINALS SHALL NOT BE SUBSTITUTED FOR MORE THAN 50% OF THE REQUIRED WATER CLOSETS.

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Date: 20 JUN 2014

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File No.: A-027



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Key Plan:

33RD STREET

9TH AVENUE

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DYER AVENUE

Seal & Signature:

REGISTERED ARCHITECT

STATE OF NEW YORK

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Project No.: 207150

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Page No.: 16 OF 87

Code Analysis - Level 56 & 57-58

Legend

BUSINESS


ASSEMBLY (UNCONCENTRATED)

MERCANTILE


MECHANICAL / STORAGE

PARKING

LOCKER ROOMS

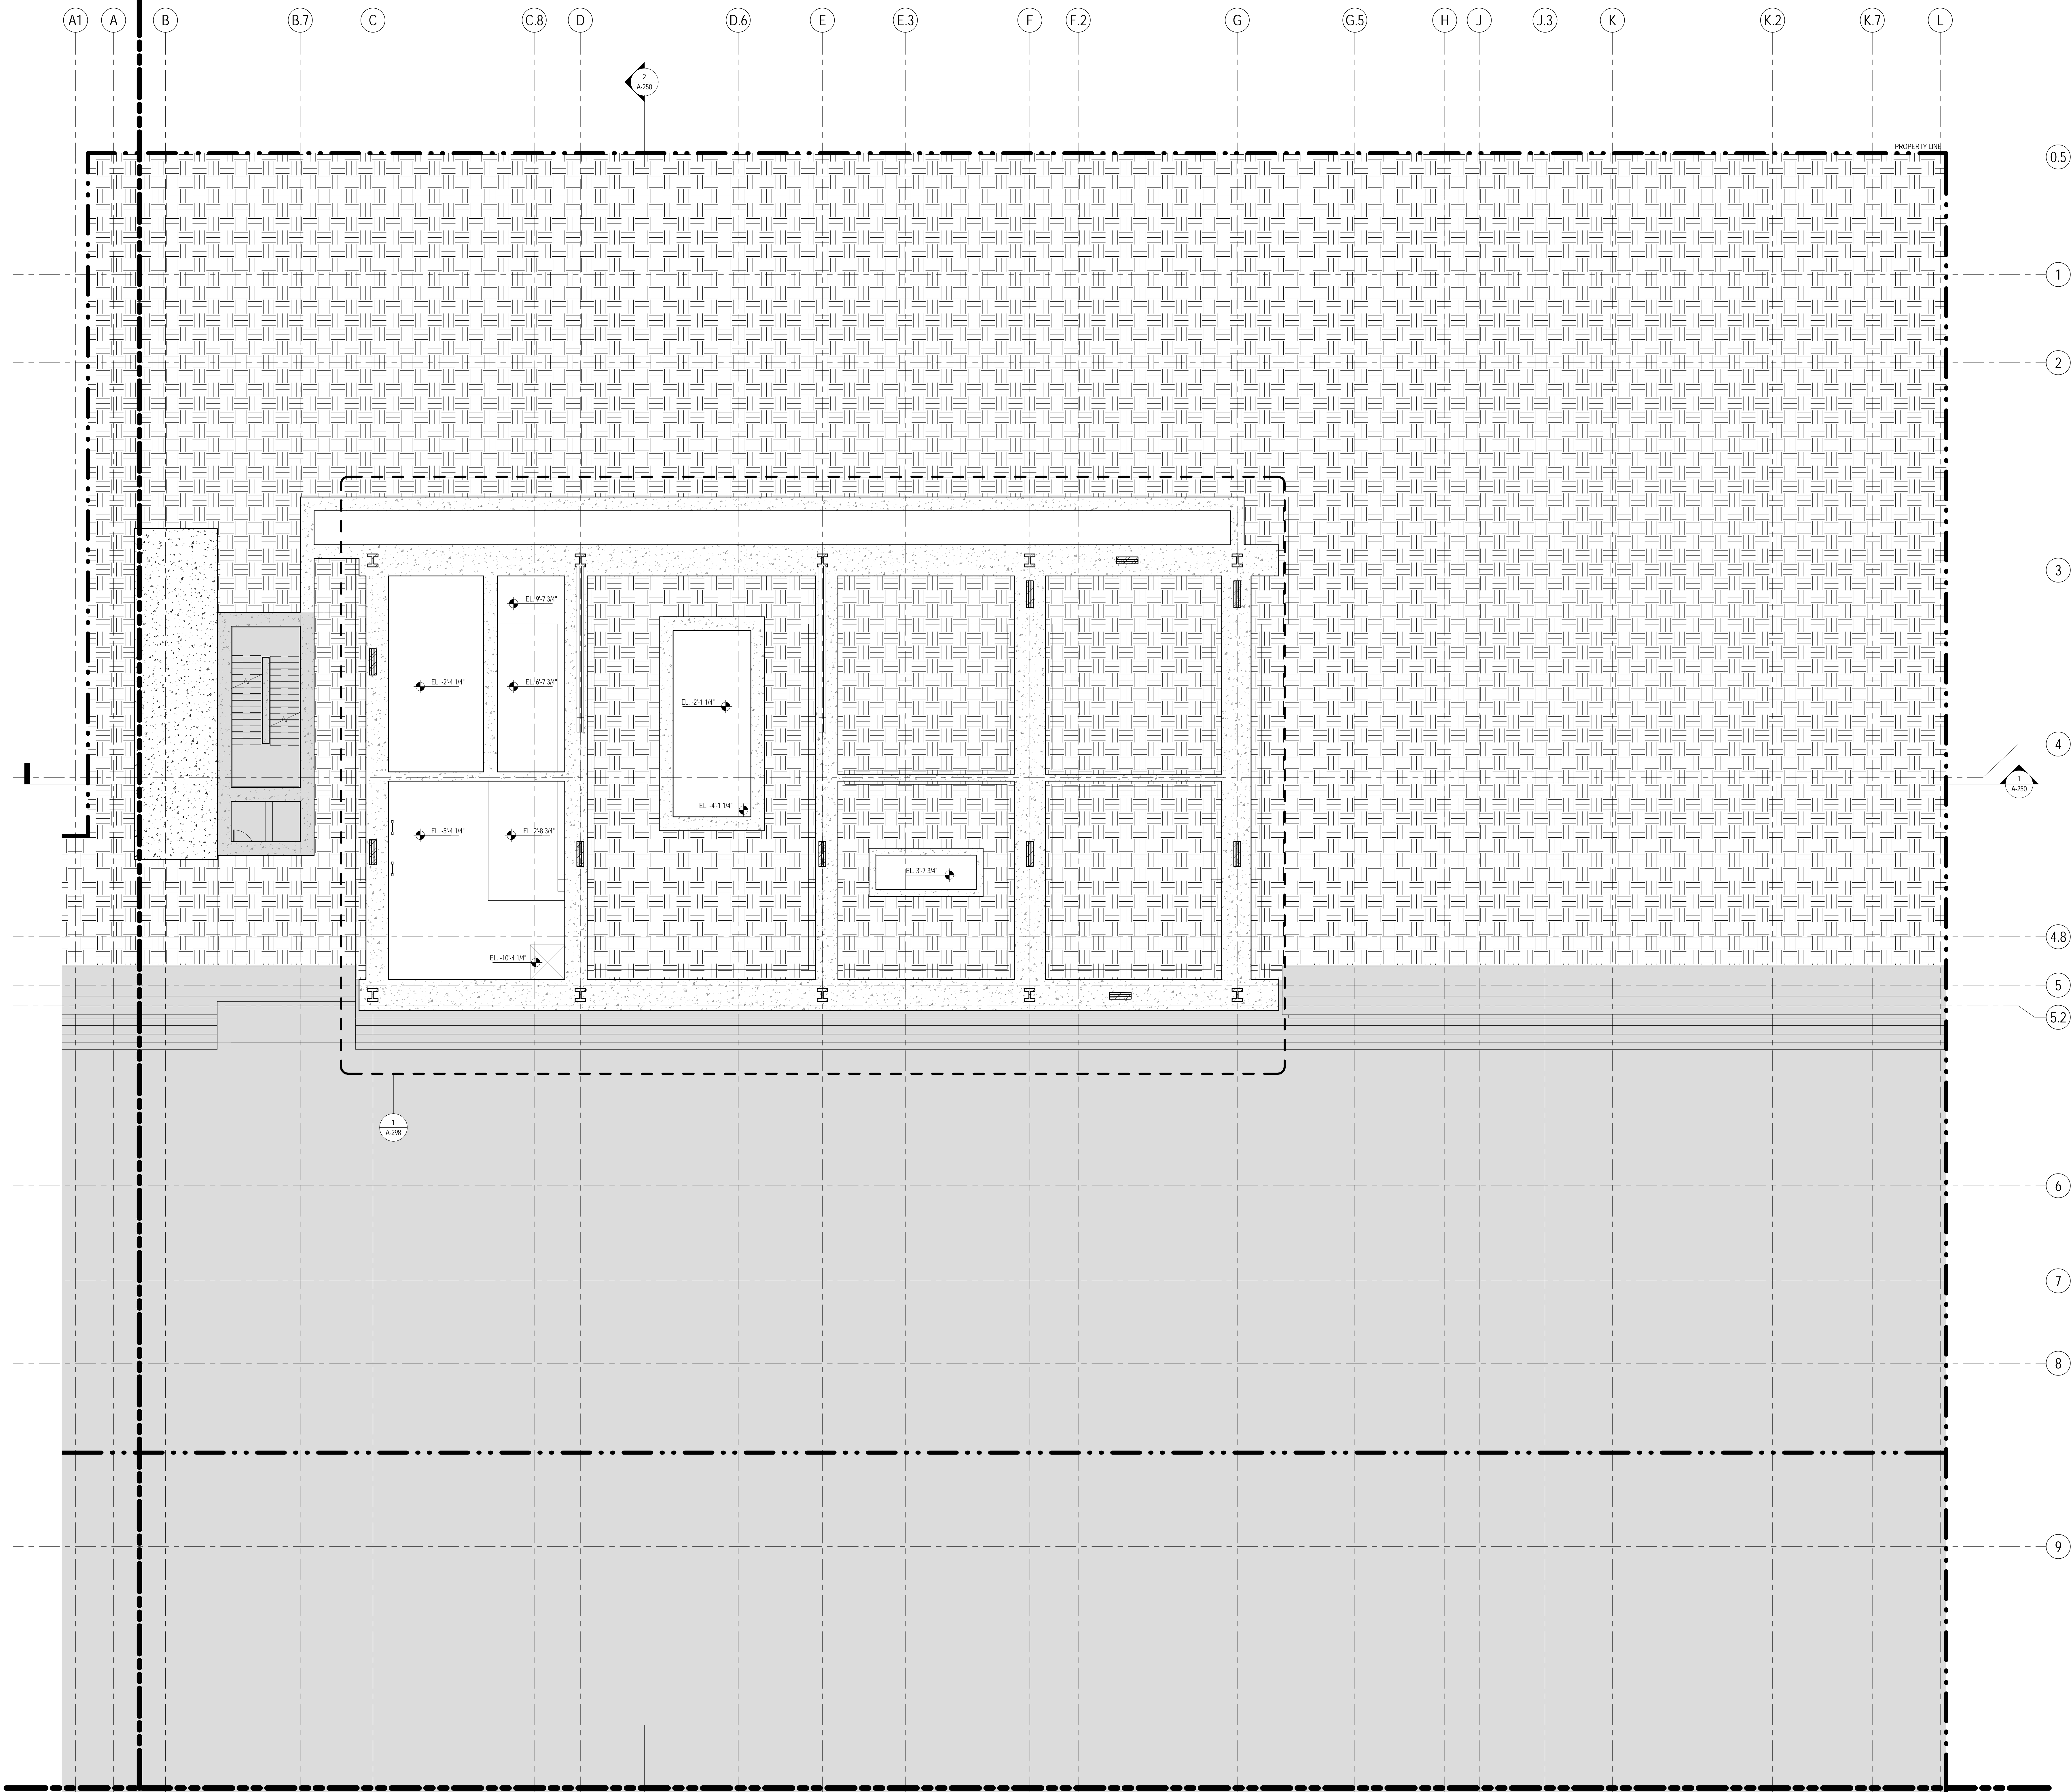

- SHEET NOTES**
1. ALL BUILDING ELEVATIONS (IN FEET) REFERENCED TO THE NORTH AMERICAN VERTICAL DATUM OF 1988 (NAV88).
 2. FOR GENERAL NOTES, BUILDING DEPARTMENT NOTES, AND CLASSIFICATION OF THE WORK NOTES REFER TO SHEET NO. G-005.
 3. FOR ARCHITECTURAL ABBREVIATIONS, LEGEND OF SYMBOLS & MATERIALS, AND MOUNTING HEIGHTS REFER TO SHEET NO. G-006.
 4. FOR ROOM FINISH SCHEDULE SEE A-700 SERIES DRAWINGS.
 5. FOR DOOR SCHEDULE SEE A-700 SERIES DRAWINGS. FOR DOOR HARDWARE SPECIFICATION SEE TECHNICAL SPECIFICATION SECTION 050700.
 6. FOR PARTITION TYPES SEE A-700 SERIES DRAWINGS.
 7. ALL PARTITIONS SHALL BE TYPE DR, UNO.
 8. FOR REFLECTED CEILING PLANS SEE A-600 SERIES DRAWINGS. IF RCP IS NOT PROVIDED SEE MEPP/PA/SC/TEC. SERVICE DRAWINGS FOR LOCATIONS OR ALL CEILING/WALL MOUNTED DEVICES.
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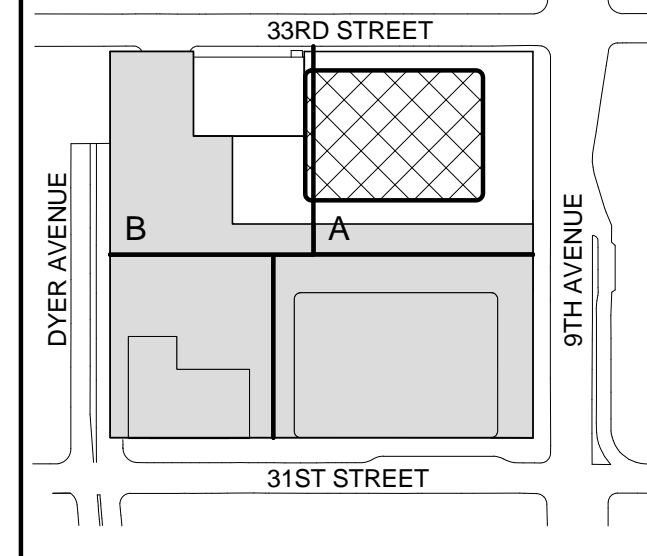
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
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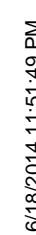
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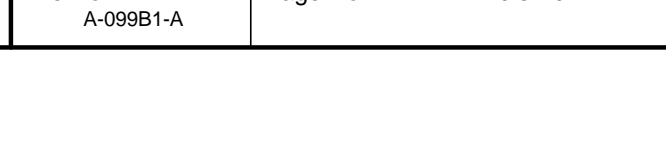
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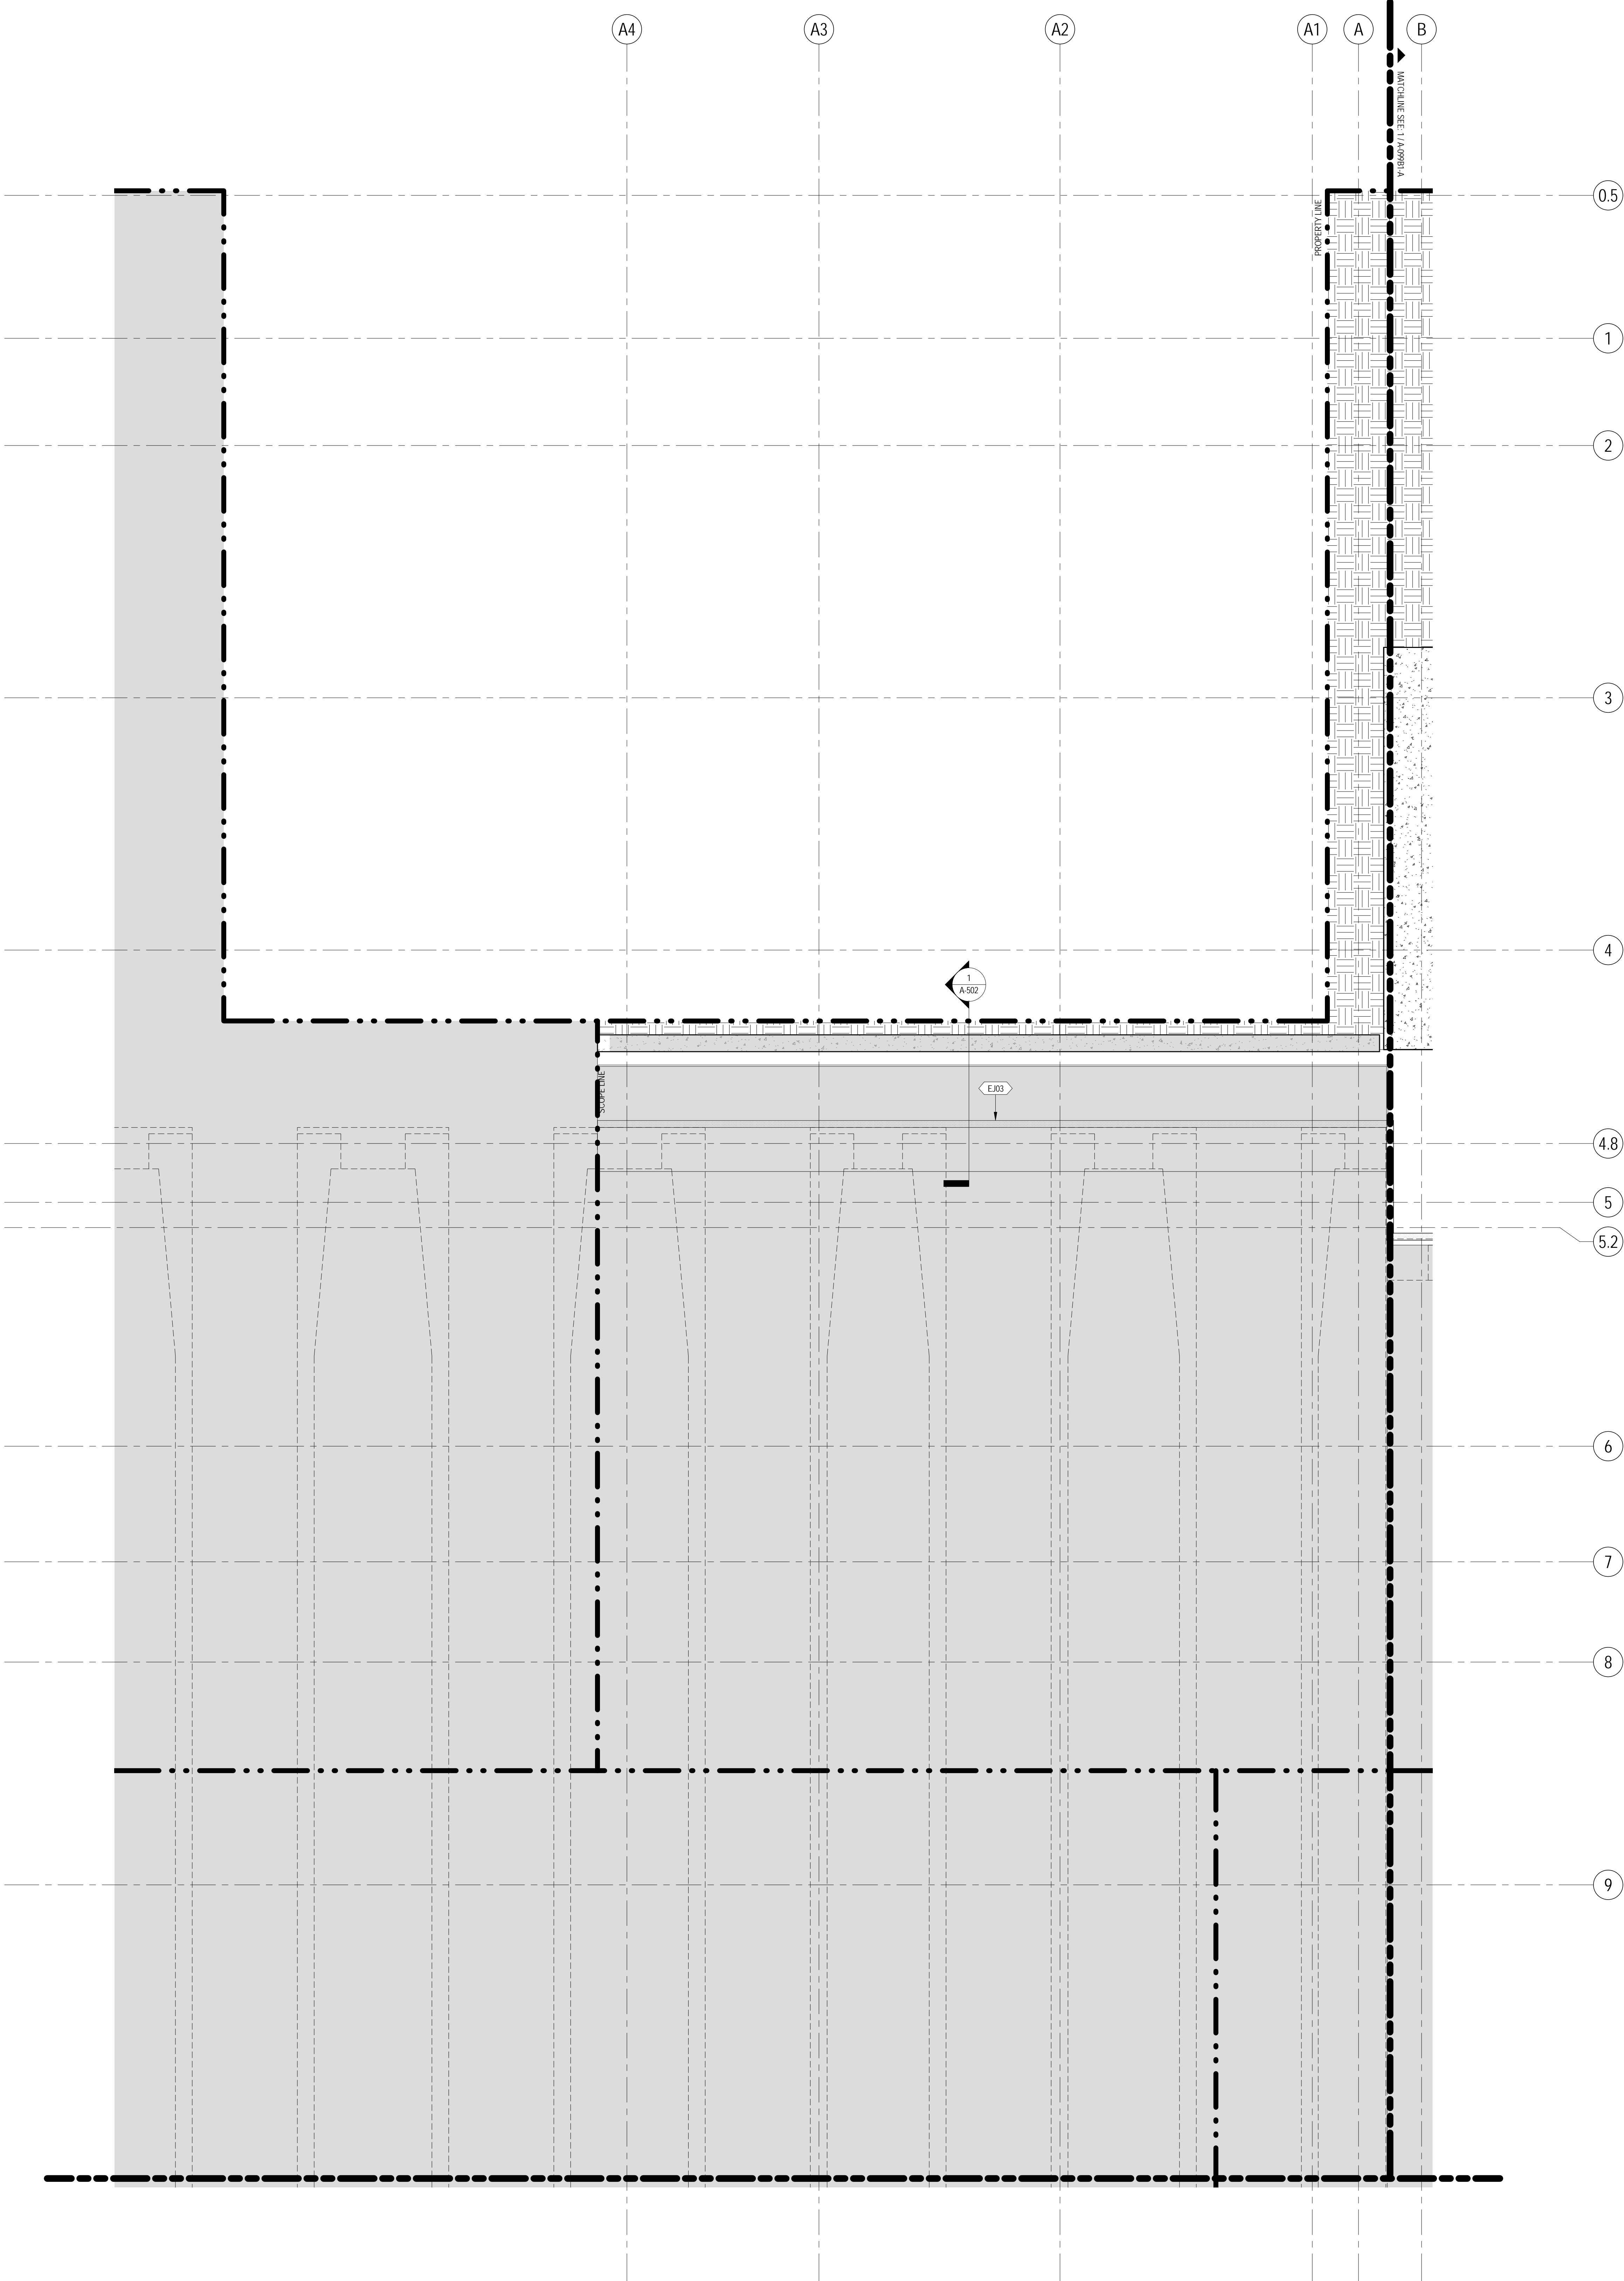
**CELLAR B1 PIT
PLAN**

Project No.: 207150	B-SCAN Sheet No.: A-094.00
Date: 20 JUN 2014	Sheet No.: A-098B1P
Scale: 1/8" = 1'-0"	Page No.: 17 OF 37
File No.: A-098B1P	



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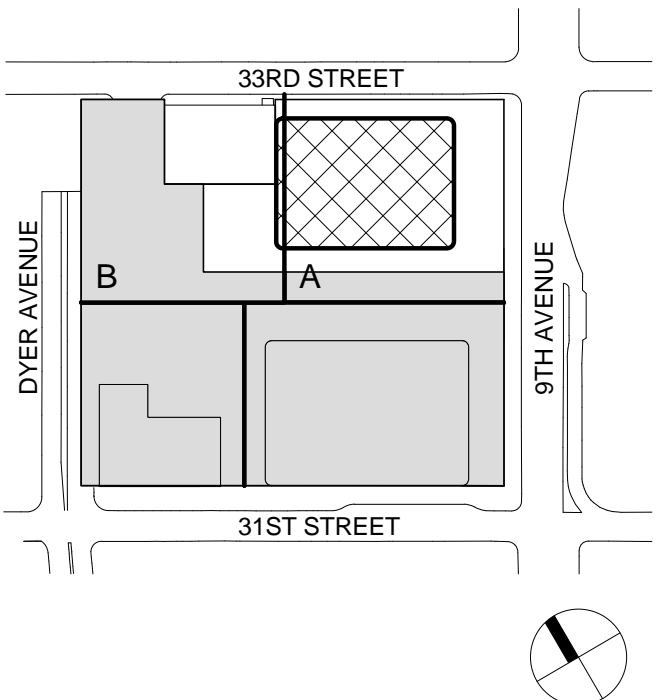
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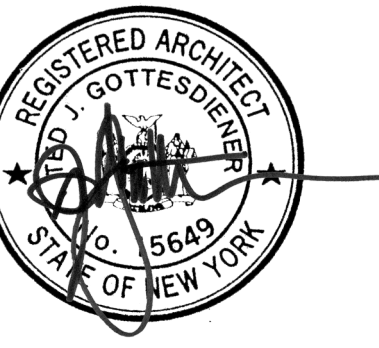
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Seal & Signature:



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No. Date Description
Sheet Name:

**CELLAR B1
FLOOR PLAN -
PART B**

Project No.:

207150

Date:

20 JUN 2014

Scale:

1/8" = 1'-0"

File No.:

A-099B1-B

B-SCAN Sheet No.:


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Sheet No.:

A-099B1-B

Page No.:

19 OF 37

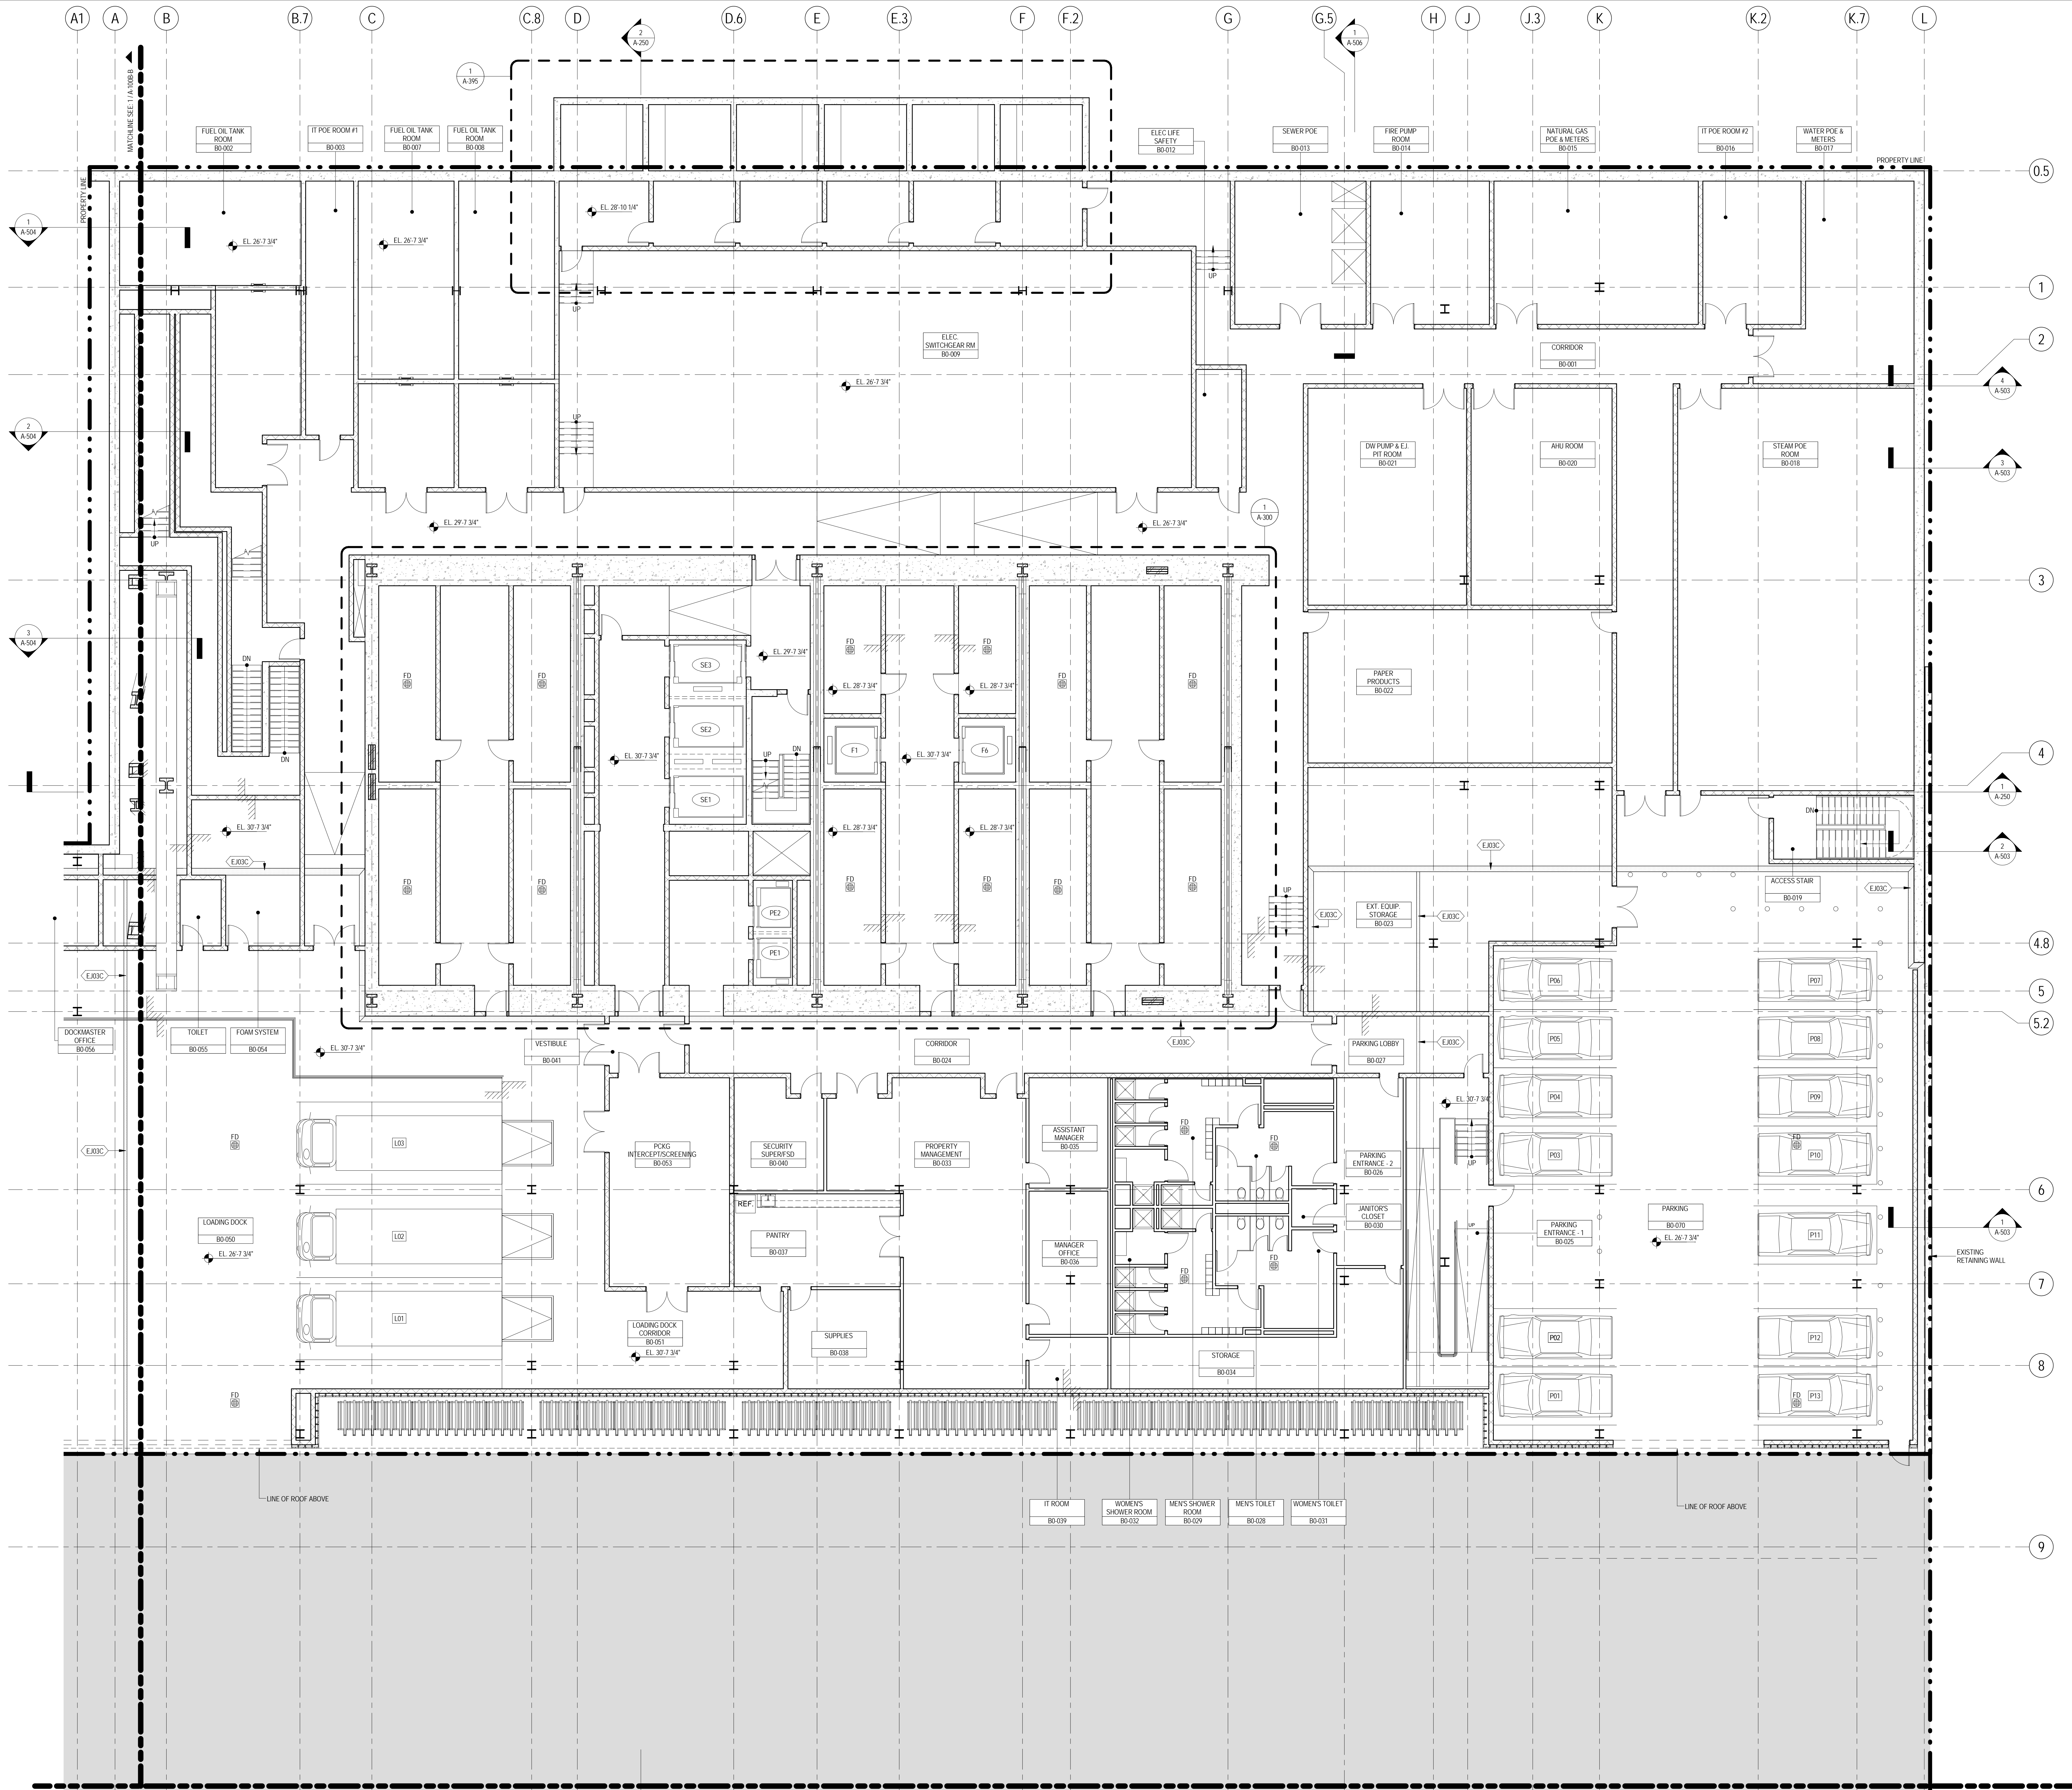

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8. FOR REFLECTED CEILING PLANS SEE A-600 SERIES DRAWINGS. IF RCP IS NOT PROVIDED SEE MEPP/FASSC/TEL SERVICE DRAWINGS FOR LOCATIONS OR ALL CEILING/WALL MOUNTED DEVICES.
9. FOR STRUCTURAL COLUMNS, EDGE OF SLAB AND CORE WORK POINTS SEE STRUCTURAL SERIES DRAWINGS, UNO.
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11. REFER TO MEPP/FASSC/TEL SERVICE DRAWINGS FOR ALL MECHANICAL, ELECTRICAL, PLUMBING AND FIRE PROTECTION ROOM, RISER AND EQUIPMENT DESIGNATIONS.
12. FOR PROJECT WORK POINT REFER TO A-000 SERIES DRAWINGS.

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186 Ames Street, Hackensack, NJ 07601

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Rowan Williams Davies & Irwin Inc.
680 Woodlawn Road West, Guelph, Ontario, Canada N1K 1B8

Key Plan:


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4	20 DEC 2013	ISSUED FOR FOUNDATION PERMIT
3	15 NOV 2013	ISSUED FOR 90% DESIGN DEVELOPMENT
2	12 JUL 2013	ISSUED FOR 90% DESIGN DEVELOPMENT
1	19 MAR 2012	ISSUED FOR RECONCILIATION

Sheet Name:
CELLAR B FLOOR PLAN - PART A

Project No.: 207150	B-SCAN Sheet No.: A-097.00
Date: 20 JUN 2014	Sheet No.: A-100B-A
Scale: 1/8" = 1'-0"	Page No.: 20 OF 87
File No.: A-100B-A	



SHEET NOTES

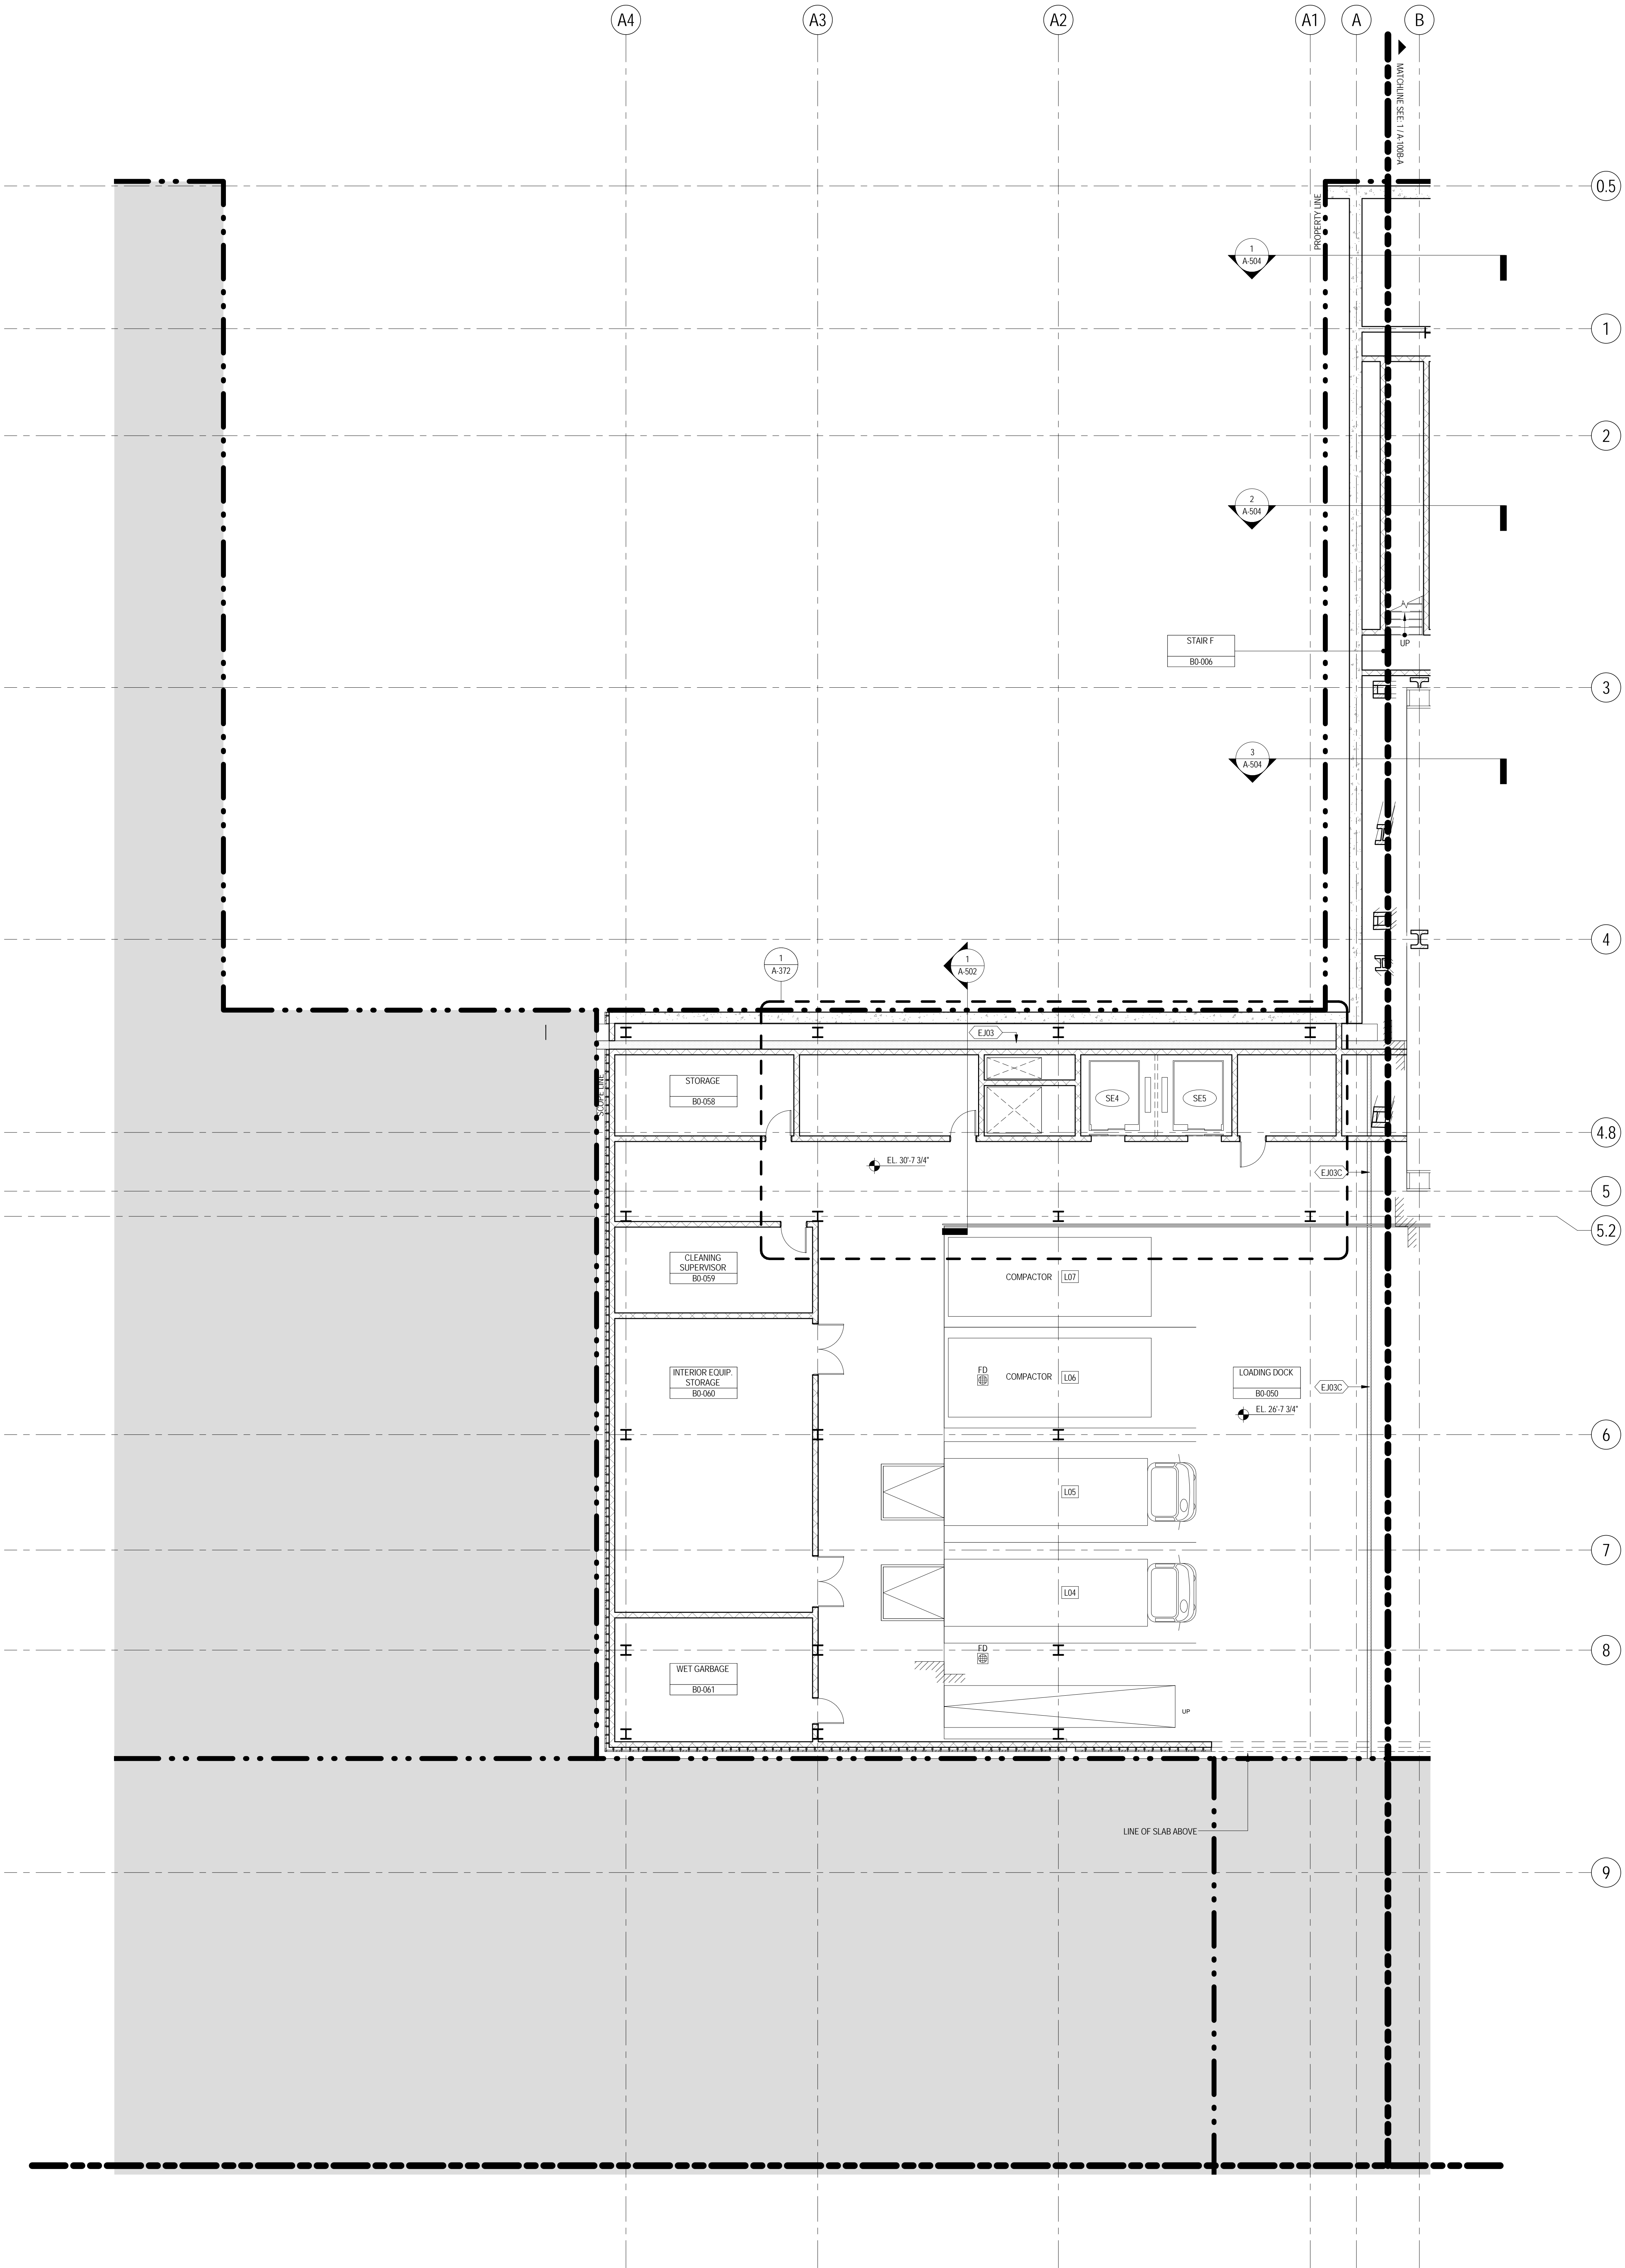1. ALL BUILDING ELEVATIONS (IN FEET) REFERENCED TO THE NORTH AMERICAN VERTICAL DATUM OF 1988 (NAV88).
2. FOR GENERAL NOTES, BUILDING DEPARTMENT NOTES, AND CLARIFICATION OF THE WORK NOTES REFER TO SHEET NO. G-005.
3. FOR ARCHITECTURAL ABBREVIATIONS, LEGEND OF SYMBOLS & MATERIALS, AND MOUNTING HEIGHTS REFER TO SHEET NO. G-006.
4. FOR ROOM FINISH SCHEDULE SEE A-700 SERIES DRAWINGS.
5. FOR DOOR SCHEDULE SEE A-700 SERIES DRAWINGS. FOR DOOR HARDWARE SPECIFICATION SEE TECHNICAL SPECIFICATION SECTION 051010.
6. FOR PARTITION TYPES SEE A-700 SERIES DRAWINGS.
7. ALL PARTITIONS SHALL BE TYPE DR, LND.
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Key Plan:




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Project No.: 207150
Date: 20 JUN 2014
Scale: 1/8" = 1'-0"
File No.: A-1008-B

B-SCAN Sheet No.: A-098.00
Sheet No.: A-1008-B
Page No.: 21 OF 87

CELLAR B FLOOR
PLAN - PART B



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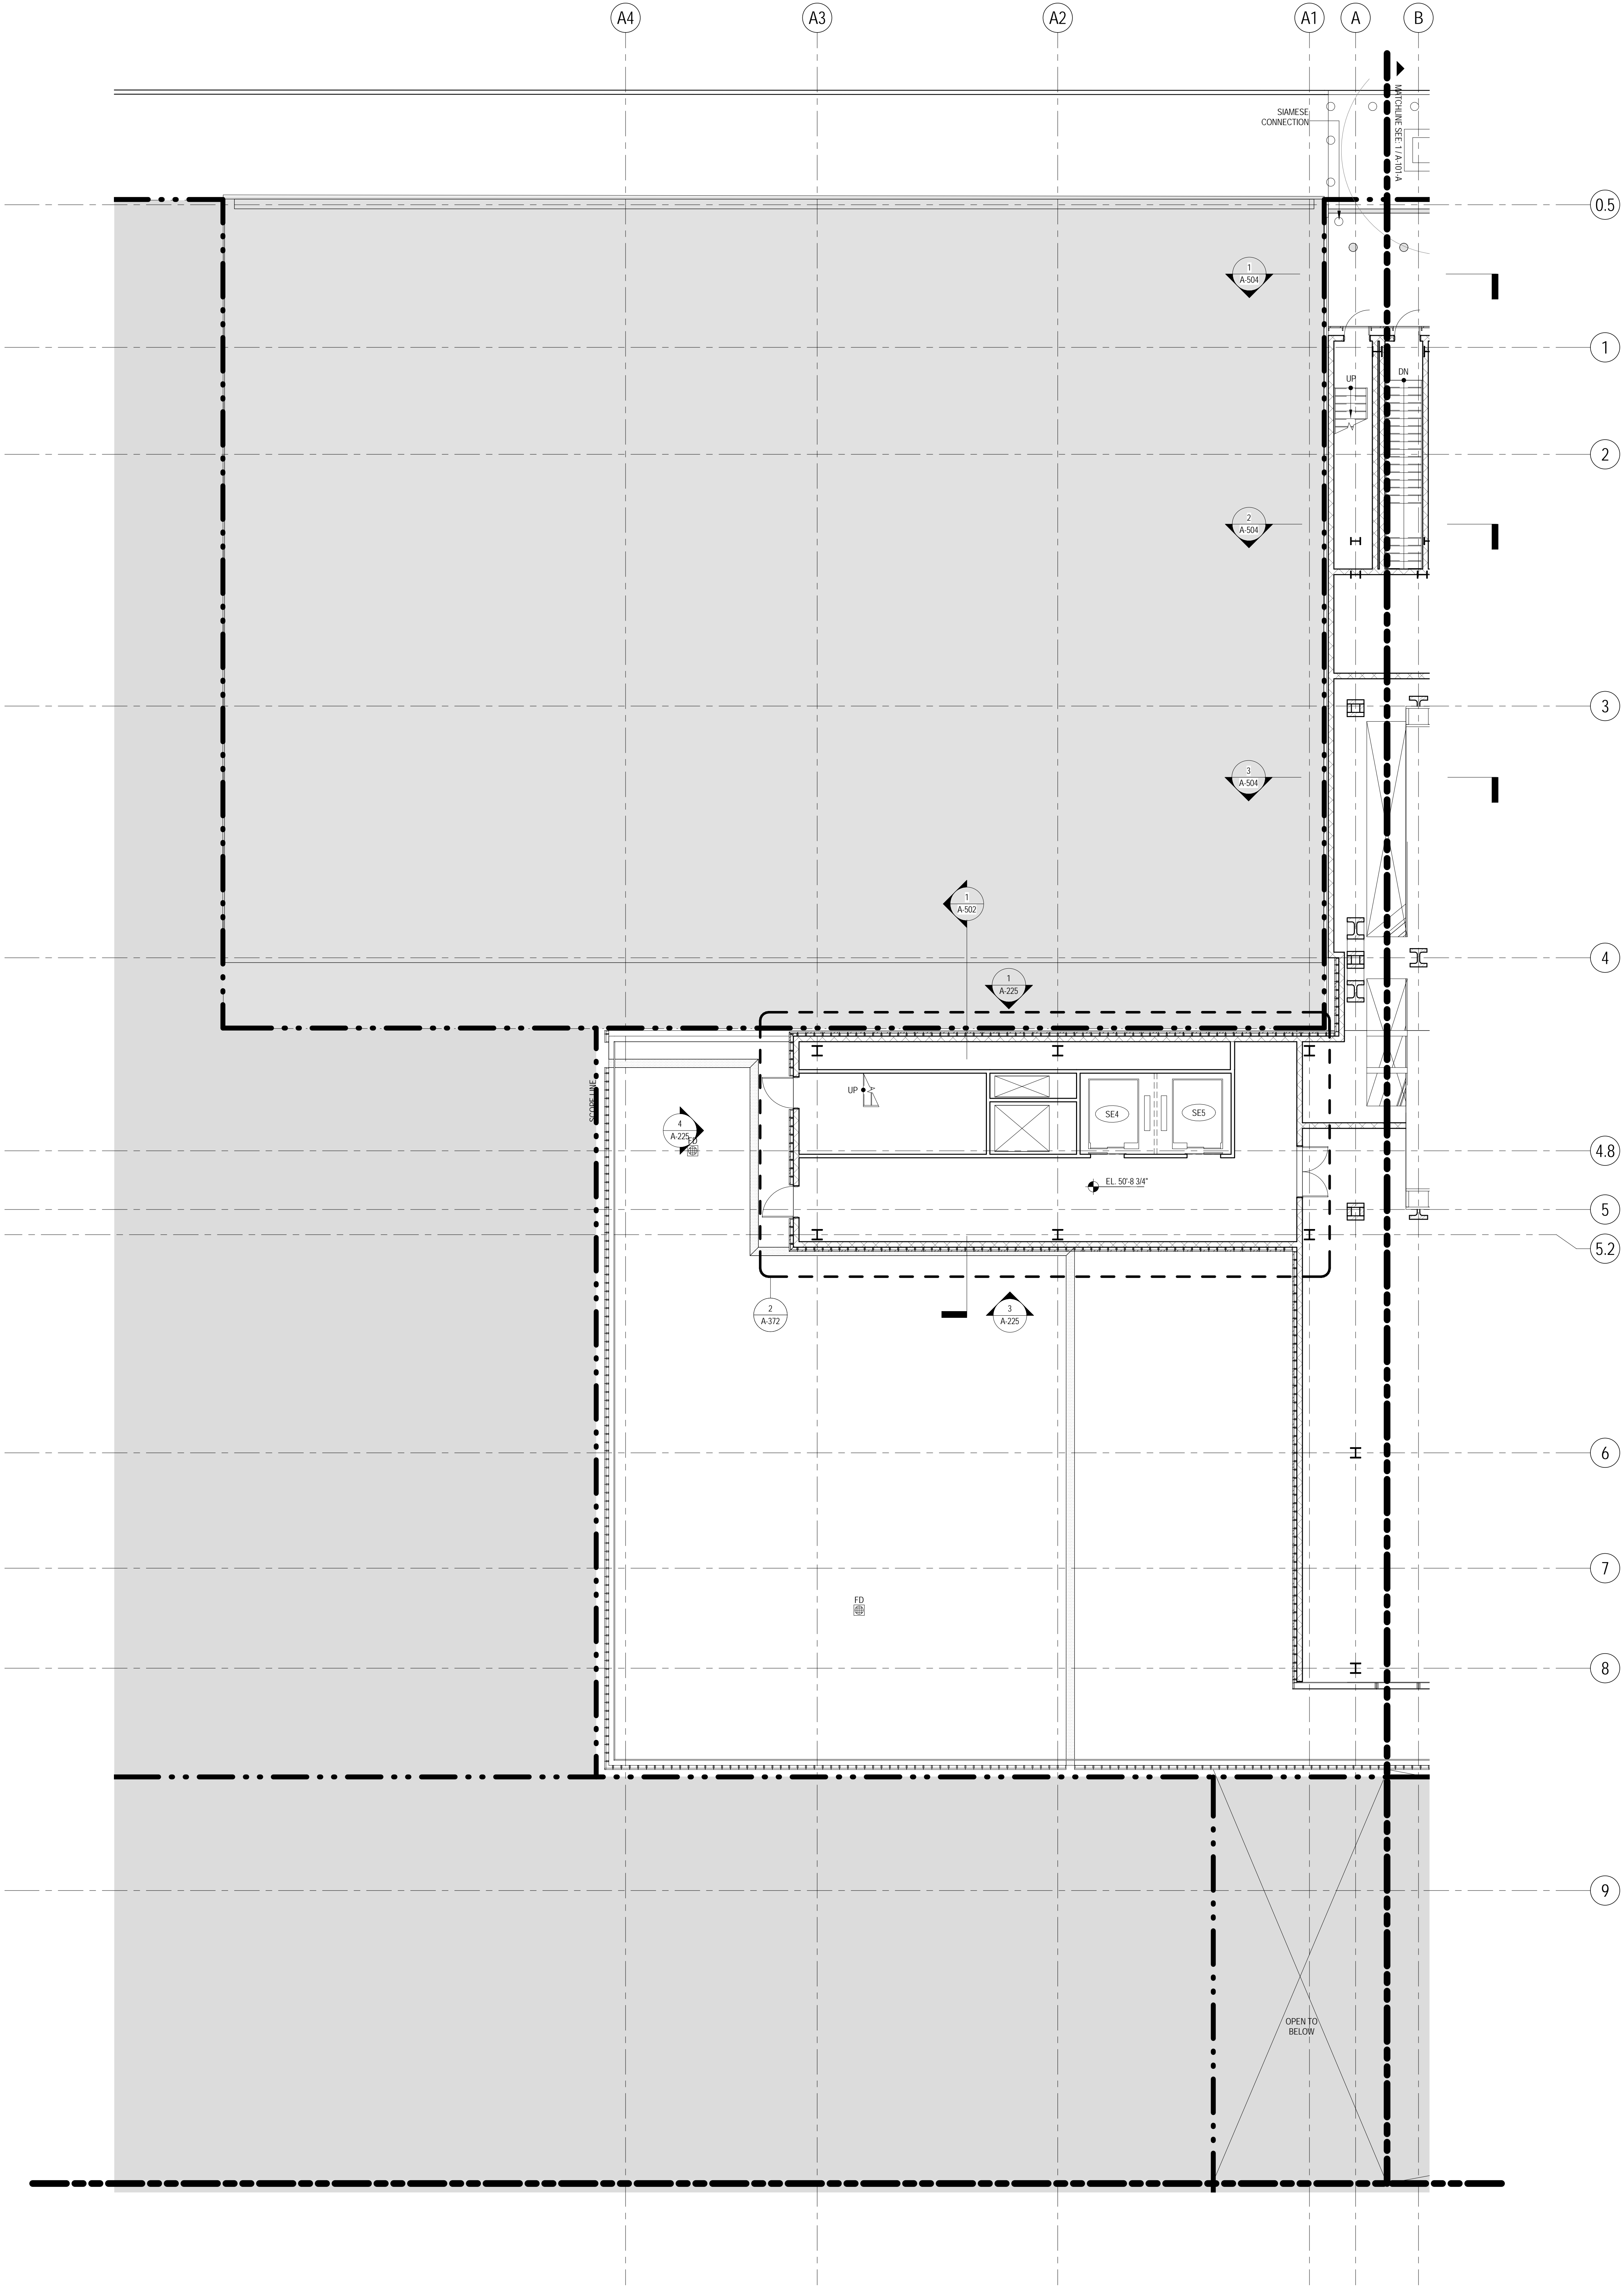
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1	19 MAR 2013	ISSUED FOR RECONCILIATION

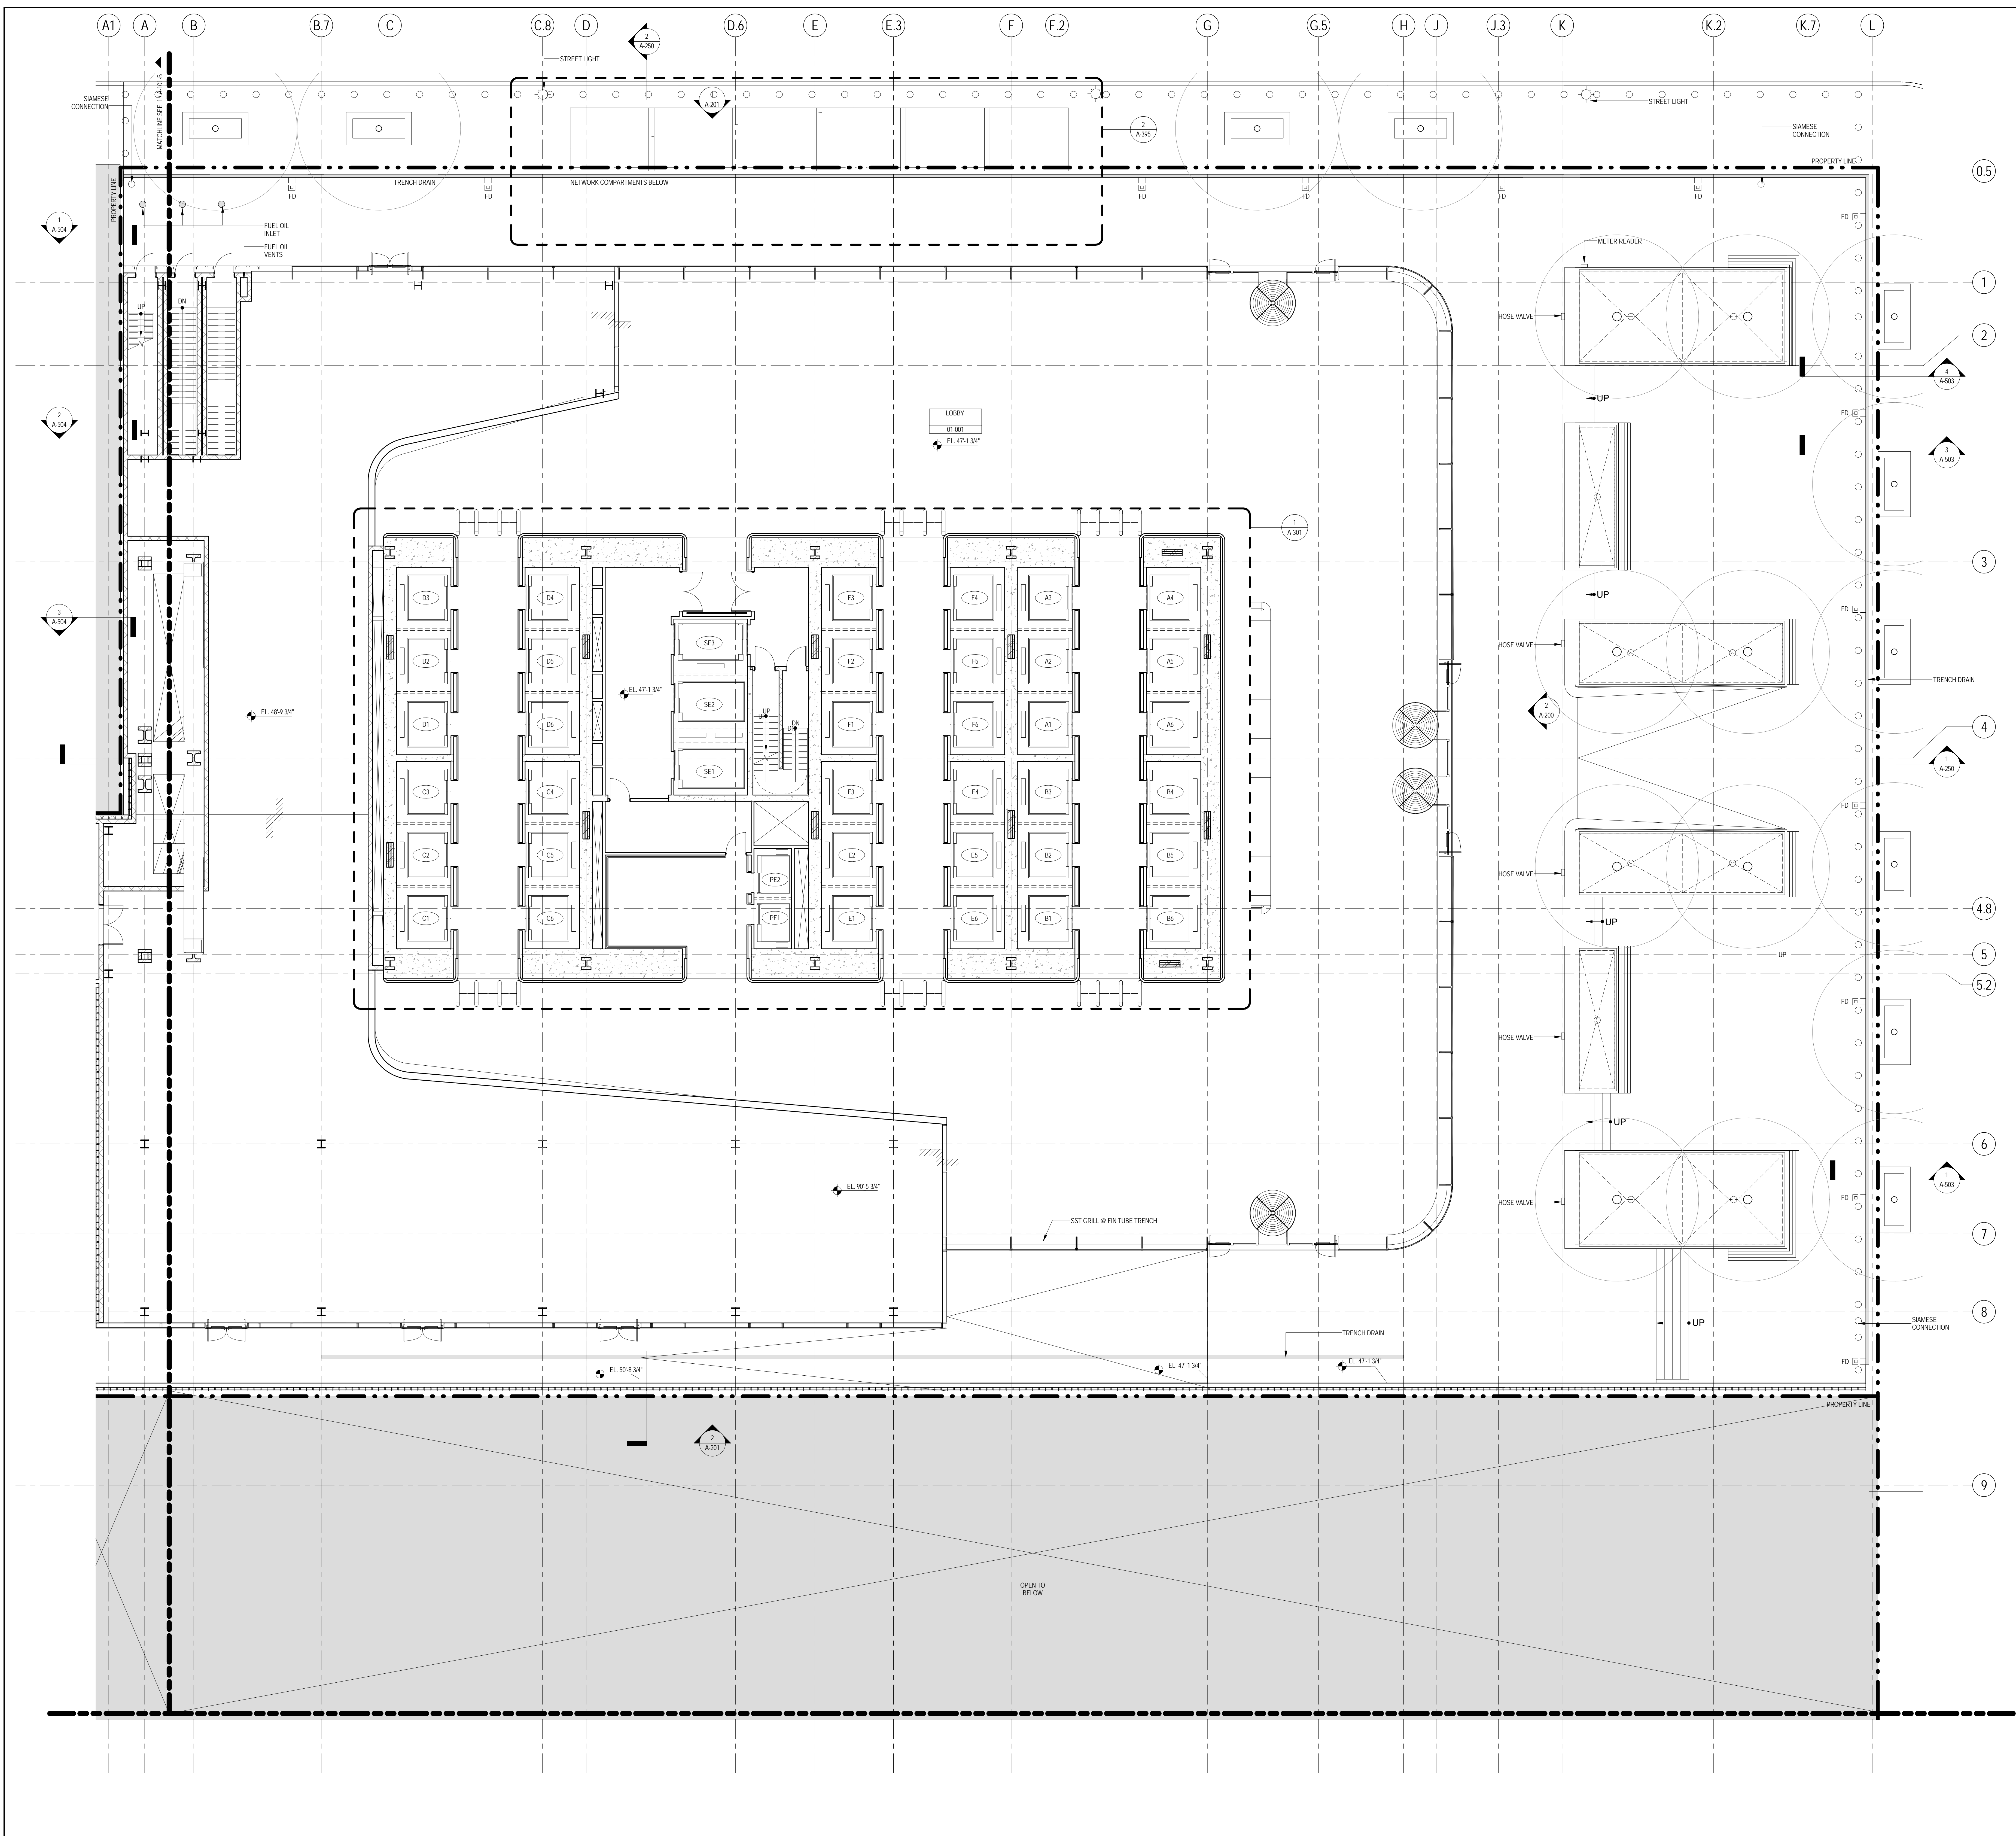No. _____ Date _____ Description _____

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
GROUND FLOOR PLAN - PART A

Project No.: 207150	B-SCAN Sheet No.: A-100.00
Date: 20 JUN 2014	Sheet No.: A-101-A
Scale: 1/8" = 1'-0"	Page No.: 22 OF 87
File No.: A-101-A	



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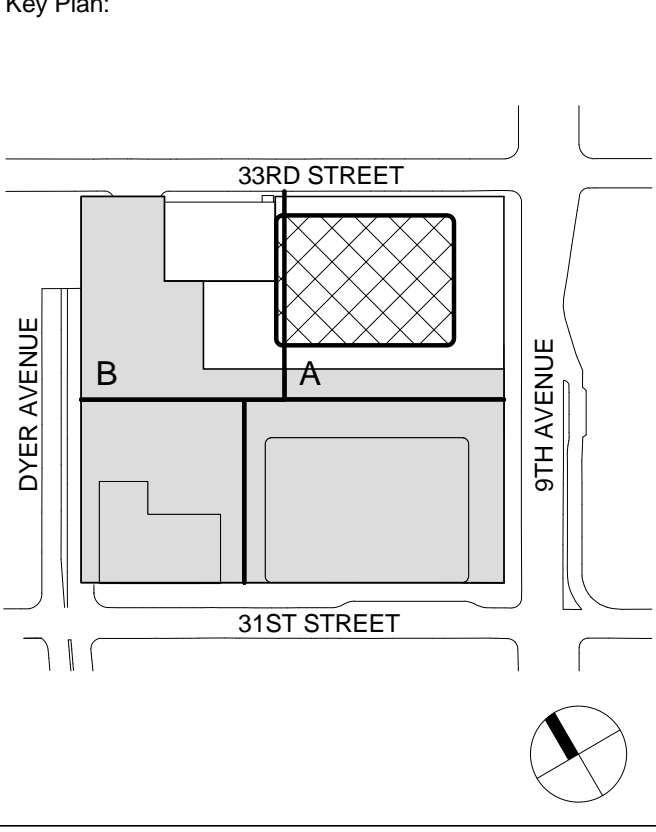
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
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No.	Date	Description
7	12 SEPT 2014	ISSUED FOR FOUNDATION PERMIT
6	20 JUN 2014	ISSUED FOR FOUNDATION BID
5	20 JUN 2014	ISSUED FOR FOUNDATION PERMIT
4	20 DEC 2013	ISSUED FOR FOUNDATION PERMIT
3	15 NOV 2013	ISSUED FOR 50% PROGRESS PRICING
2	12 JUL 2013	ISSUED FOR 90% DESIGN DEVELOPMENT
1	19 MAR 2012	ISSUED FOR RECONCILIATION

Sheet Name:

GROUND FLOOR
PLAN - PART B

Project No.: 207150	B-SCAN Sheet No.: A-101.00
Date: 12 SEPT 2014	Sheet No.: A-101-B
Scale: 1/8" = 1'-0"	Page No.: 23 OF 30
File No.: A-101-B	

SHEET NOTES

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4. FOR ROOM FINISH SCHEDULE SEE A-700 SERIES DRAWINGS.
5. FOR DOOR SCHEDULE SEE A-700 SERIES DRAWINGS. FOR DOOR HARDWARE SPECIFICATION SEE TECHNICAL SPECIFICATION SECTION 050700.
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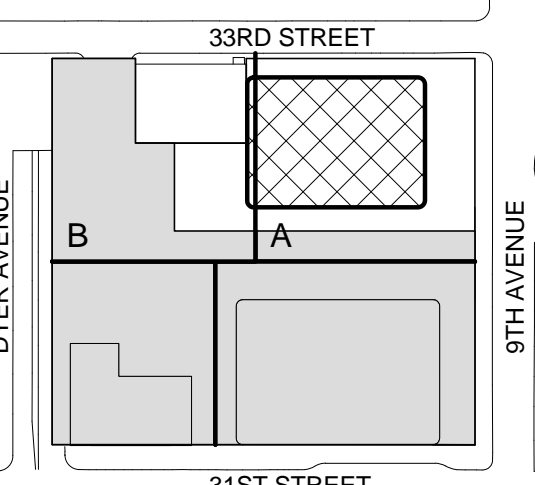
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2 20 DEC 2013 ISSUED FOR FOUNDATION PERMIT
1 18 NOV 2013 ISSUED FOR GD PROGRESS PRICING

No. Date Description
Sheet Name:

LEVEL 2 FLOOR
PLAN - RETAIL

Project No.:

207150

Date:

20 JUN 2014

Scale:

1/8" = 1'-0"

File No.:

A-102

B-SCAN Sheet No.:

A-102.00

Sheet No.:

A-102

Page No.:

24 OF 87

SHEET NOTES

1. ALL BUILDING ELEVATIONS (IN FEET) REFERENCED TO THE NORTH AMERICAN VERTICAL DATUM OF 1988 (NAV88).
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3. FOR ARCHITECTURAL ABBREVIATIONS, LEGEND OF SYMBOLS & MATERIALS, AND MOUNTING HEIGHTS REFER TO SHEET NO. G-06.
4. FOR ROOM FINISH SCHEDULE SEE A-700 SERIES DRAWINGS.
5. FOR DOOR SCHEDULE SEE A-700 SERIES DRAWINGS. FOR DOOR HARDWARE SPECIFICATION SEE TECHNICAL SPECIFICATION SECTION 05100.
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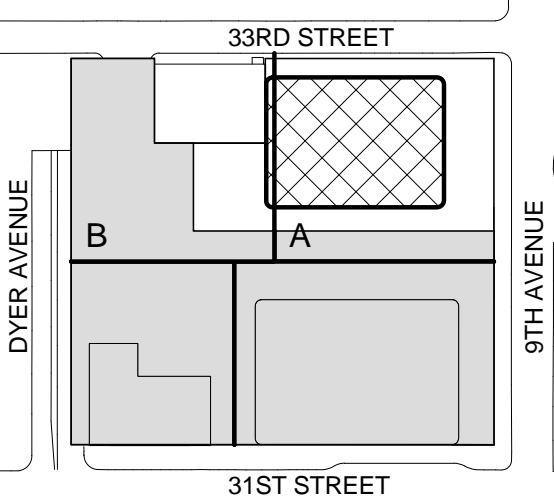
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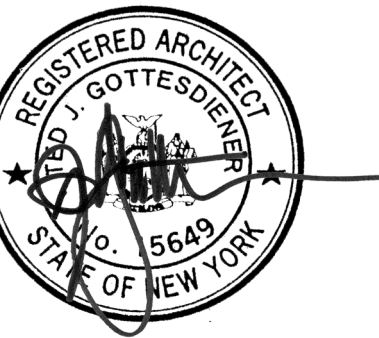
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No. Date Description

Sheet Name:

LEVEL 3 FLOOR
PLAN - STAIR
TRANSFER

Project No.:

207150

Date:

20 JUN 2014

Scale:

1/8" = 1'-0"

File No.:

A-103

B-SCAN Sheet No.:

A-103.00

Sheet No.:

A-103

Page No.:

25 OF 87

SHEET NOTES

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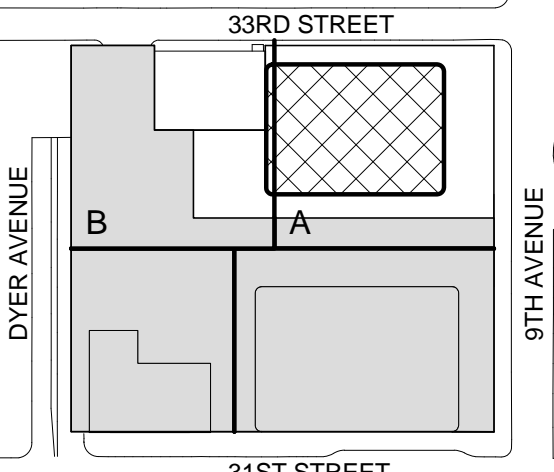
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Wind Tunnel Consultant

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Key Plan:



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| 6 | 20 JUN 2014 | ISSUED FOR FOUNDATION BID |
| 5 | 20 JUN 2014 | ISSUED FOR FOUNDATION PERMIT |
| 4 | 20 DEC 2013 | ISSUED FOR FOUNDATION PERMIT |
| 3 | 15 NOV 2013 | ISSUED FOR 90% DESIGN PRICING |
| 2 | 12 JUL 2013 | ISSUED FOR 90% DESIGN DEVELOPMENT |
| 1 | 19 MAR 2012 | ISSUED FOR RECONCILIATION |

No. Date Description
Sheet Name:

LEVEL 4 FLOOR
PLAN -
MECHANICAL

Project No.:

207150

Date:

20 JUN 2014

Scale:

1/8" = 1'-0"

File No.:

A-104

B-SCAN Sheet No.:

A-104.00

Sheet No.:

A-104

Page No.:

26 OF 87

SHEET NOTES

1. ALL BUILDING ELEVATIONS (IN FEET) REFERENCED TO THE NORTH AMERICAN VERTICAL DATUM OF 1988 (NAV88).
2. FOR GENERAL NOTES, BUILDING DEPARTMENT NOTES, AND CLARIFICATION OF THE WORK NOTES REFER TO SHEET NO. G-005.
3. FOR ARCHITECTURAL ABBREVIATIONS, LEGEND OF SYMBOLS & MATERIALS, AND MOUNTING HEIGHTS REFER TO SHEET NO. G-006.
4. FOR ROOM FINISH SCHEDULE SEE A-700 SERIES DRAWINGS.
5. FOR DOOR SCHEDULE SEE A-700 SERIES DRAWINGS. FOR DOOR HARDWARE SPECIFICATION SEE TECHNICAL SPECIFICATION SECTION 050700.
6. FOR PARTITION TYPES SEE A-700 SERIES DRAWINGS.
7. ALL PARTITIONS SHALL BE TYPE DR, UNO.
8. FOR REFLECTED CEILING PLANS SEE A-600 SERIES DRAWINGS. IF RCP IS NOT PROVIDED SEE MEPP/FASC/ITEL SERVICE DRAWINGS FOR LOCATIONS OR ALL CEILING/WALL MOUNTED DEVICES.
9. FOR STRUCTURAL COLUMNS, EDGE OF SLAB AND CORE WORK POINTS SEE STRUCTURAL SERIES DRAWINGS, UNO.
10. REFER TO STRUCTURAL SERIES DRAWINGS FOR ALL STRUCTURAL WALL DESIGNATIONS AND DIMENSIONS.
11. REFER TO MEPP/FASC/ITEL SERVICE DRAWINGS FOR ALL MECHANICAL, ELECTRICAL, PLUMBING AND FIRE PROTECTION ROOM, RISER AND EQUIPMENT DESIGNATIONS.
12. FOR PROJECT WORK POINT REFER TO A-000 SERIES DRAWINGS.



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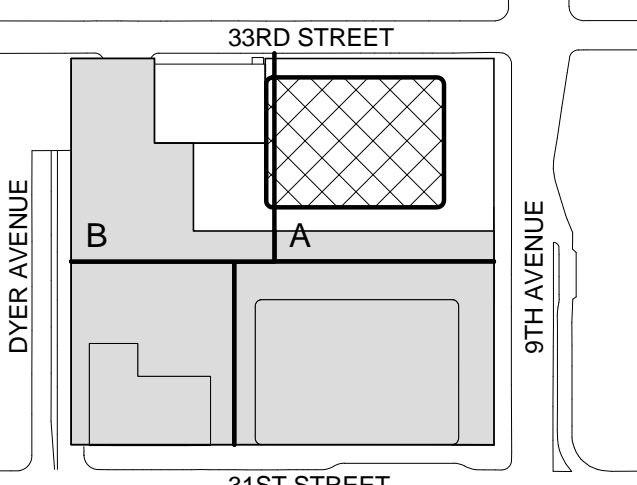
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5	20 JUN 2014	ISSUED FOR FOUNDATION BID
4	20 JUN 2014	ISSUED FOR FOUNDATION PERMIT
3	20 DEC 2013	ISSUED FOR FOUNDATION PERMIT
2	15 NOV 2013	ISSUED FOR DD PROGRESS PRICING
1	12 JUL 2013	ISSUED FOR 50% DESIGN DEVELOPMENT

No. Date Description

Sheet Name:

LEVEL 5 FLOOR
PLAN -
MECHANICAL

Project No.:

207150

Date:

20 JUN 2014

Scale:

1/8" = 1'-0"

File No.:

A-105

B-SCAN Sheet No.:


A-105.00

Sheet No.:

A-105

Page No.:

27 OF 87

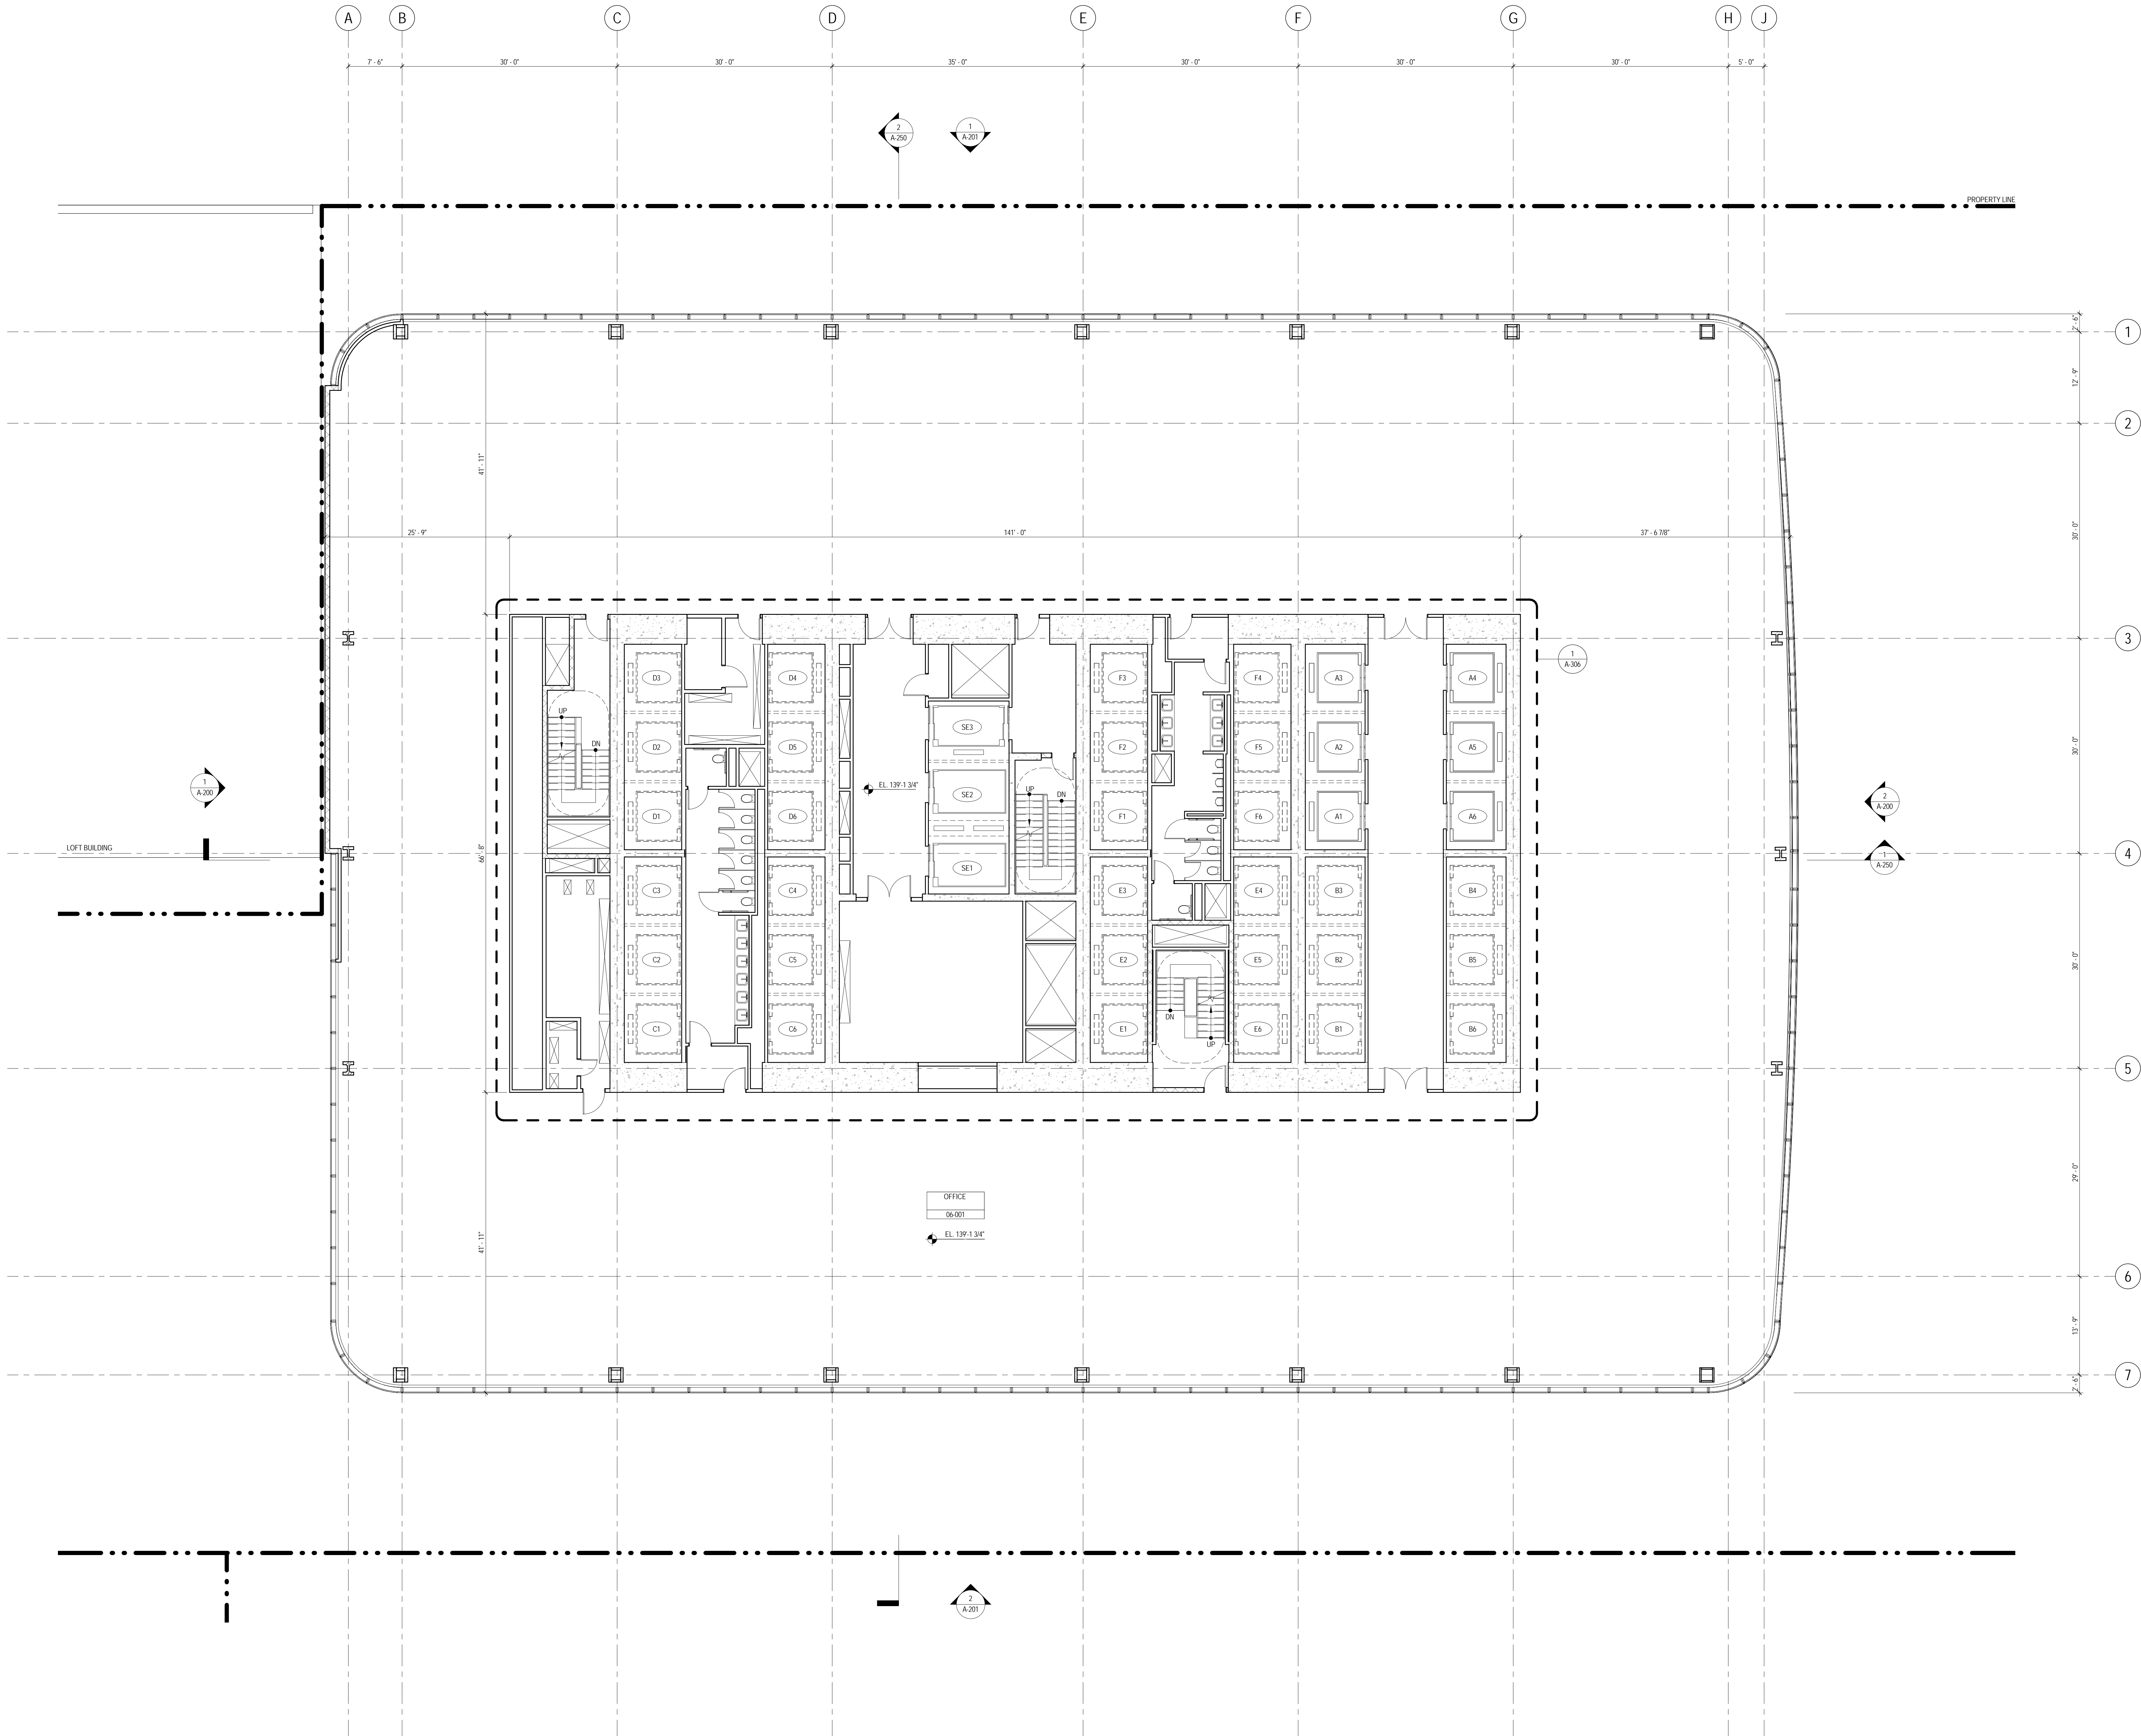

SHEET NOTES

1. ALL BUILDING ELEVATIONS (IN FEET) REFERENCED TO THE NORTH AMERICAN VERTICAL DATUM OF 1988 (NAV88).
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4. FOR ROOM FINISH SCHEDULE SEE A-700 SERIES DRAWINGS.
5. FOR DOOR SCHEDULE SEE A-700 SERIES DRAWINGS. FOR DOOR HARDWARE SPECIFICATION SEE TECHNICAL SPECIFICATION SECTION (B-700).
6. FOR PARTITION TYPES SEE A-700 SERIES DRAWINGS.
7. ALL PARTITIONS SHALL BE TYPE DR UNO.
8. FOR REFLECTED CEILING PLANS SEE A-600 SERIES DRAWINGS. IF RCP IS NOT PROVIDED SEE MEPP/PA/SC/TEL SERVICE DRAWINGS FOR LOCATIONS OR ALL CEILING/WALL MOUNTED DEVICES.
9. FOR STRUCTURAL COLUMNS, EDGE OF SLAB, AND CORE WORK POINTS SEE STRUCTURAL SERIES DRAWINGS, UNO.
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11. REFER TO MEPP DRAWINGS FOR ALL MECHANICAL, ELECTRICAL, PLUMBING AND FIRE PROTECTION ROOM RISER AND EQUIPMENT DESIGNATIONS.
12. FOR PROJECT WORK POINT REFER TO A-000 SERIES DRAWINGS.



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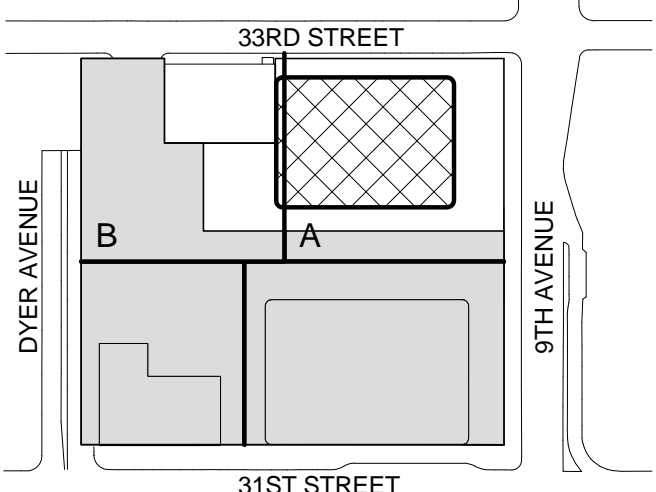
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4 - 20 DEC 2013 ISSUED FOR FOUNDATION PERMIT
3 - 15 NOV 2013 ISSUED FOR 30% PROGRESS PRICING
2 - 12 JUL 2013 ISSUED FOR 90% DESIGN DEVELOPMENT
1 - 18 MAR 2012 ISSUED FOR RECONCILIATION

No. Date Description
Sheet Name:

**LEVEL 6-16
FLOOR PLAN -
TYPICAL
LOW-RISE**

Project No.:

207150

Date:

20 JUN 2014

Scale:

1/8" = 1'-0"

File No.:

A-106

B-SCAN Sheet No.:

A-106.00

Sheet No.:

A-106

Page No.:

28 OF 87

SHEET NOTES

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4. FOR ROOM FINISH SCHEDULE SEE A-700 SERIES DRAWINGS.
5. FOR DOOR SCHEDULE SEE A-700 SERIES DRAWINGS. FOR DOOR HARDWARE SPECIFICATION SEE TECHNICAL SPECIFICATION SECTION 051010.
6. FOR PARTITION TYPES SEE A-700 SERIES DRAWINGS.
7. ALL PARTITIONS SHALL BE TYPE DR, UNO.
8. FOR REFLECTED CEILING PLANS SEE A-600 SERIES DRAWINGS. IF RCP IS NOT PROVIDED SEE MEPP/PAUSE/CITEL SERVICE DRAWINGS FOR LOCATIONS OR ALL CEILING/WALL MOUNTED DEVICES.
9. FOR STRUCTURAL COLUMNS, EDGE OF SLAB, AND CORE WORK POINTS SEE STRUCTURAL SERIES DRAWINGS, UNO.
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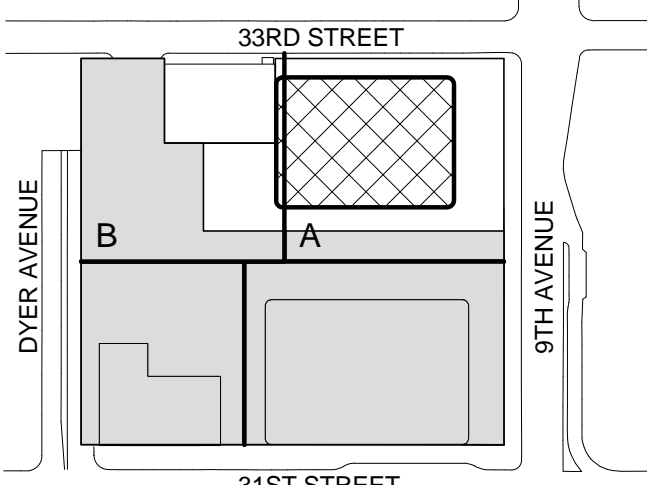
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4	20 DEC 2013	ISSUED FOR FOUNDATION PERMIT
3	15 NOV 2013	ISSUED FOR 30% PROGRESS PRICING
2	12 JUL 2013	ISSUED FOR 90% DESIGN DEVELOPMENT
1	19 MAR 2012	ISSUED FOR RECONCILIATION

No. Date Description
Sheet Name:

LEVEL 17 FLOOR
PLAN - LOW-RISE

Project No.:

207150

Date:

20 JUN 2014

Scale:

1/8" = 1'-0"

File No.:

A-117

B-SCAN Sheet No.:

A-117.00

Sheet No.:

A-117

Page No.:

29 OF 87

SHEET NOTES

1. ALL BUILDING ELEVATIONS (IN FEET) REFERENCED TO THE NORTH AMERICAN VERTICAL DATUM OF 1988 (NAV88).
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4. FOR ROOM FINISH SCHEDULE SEE A-700 SERIES DRAWINGS.
5. FOR DOOR SCHEDULE SEE A-700 SERIES DRAWINGS. FOR DOOR HARDWARE SPECIFICATION SEE TECHNICAL SPECIFICATION SECTION B57010.
6. FOR PARTITION TYPES SEE A-700 SERIES DRAWINGS.
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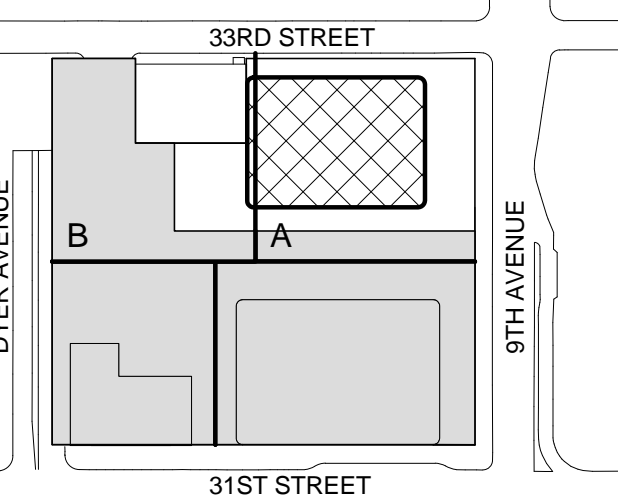
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3	15 NOV 2013	ISSUED FOR CD PROGRESS PRICING
2	12 JUL 2013	ISSUED FOR 90% DESIGN DEVELOPMENT
1	19 MAR 2012	ISSUED FOR RECONCILIATION

No. Date Description
Sheet Name:

LEVEL 21-27
FLOOR PLAN -
TYPICAL
LOW-RISE

Project No.:

207150

Date:

20 JUN 2014

Scale:

1/8" = 1'-0"

File No.:

A-121

B-SCAN Sheet No.:

A-121.00

Sheet No.:

A-121

Page No.:

32 OF 87

SHEET NOTES

1. ALL BUILDING ELEVATIONS (IN FEET) REFERENCED TO THE NORTH AMERICAN VERTICAL DATUM OF 1988 (NAV88).
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4. FOR ROOM FINISH SCHEDULE SEE A-700 SERIES DRAWINGS.
5. FOR DOOR SCHEDULE SEE A-700 SERIES DRAWINGS. FOR DOOR HARDWARE, SPECIFICATION SEE TECHNICAL SPECIFICATION SECTION 051010.
6. FOR PARTITION TYPES SEE A-700 SERIES DRAWINGS.
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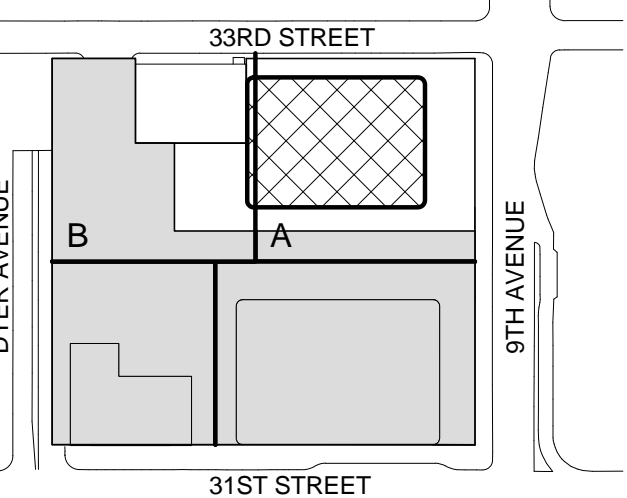
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| 4 | 20 DEC 2013 | ISSUED FOR FOUNDATION PERMIT |
| 3 | 15 NOV 2013 | ISSUED FOR 30% PROGRESS PRICING |
| 2 | 12 JUL 2013 | ISSUED FOR 90% DESIGN DEVELOPMENT |
| 1 | 19 MAR 2012 | ISSUED FOR RECONCILIATION |

No. Date Description
Sheet Name:

LEVEL 28 FLOOR
PLAN - LOW-RISE
& MID-RISE

Project No.:

207150

Date:

20 JUN 2014

Scale:

1/8" = 1'-0"

File No.:

A-128

B-SCAN Sheet No.:


A-128.00

Sheet No.:

A-128

Page No.:

33 OF 87

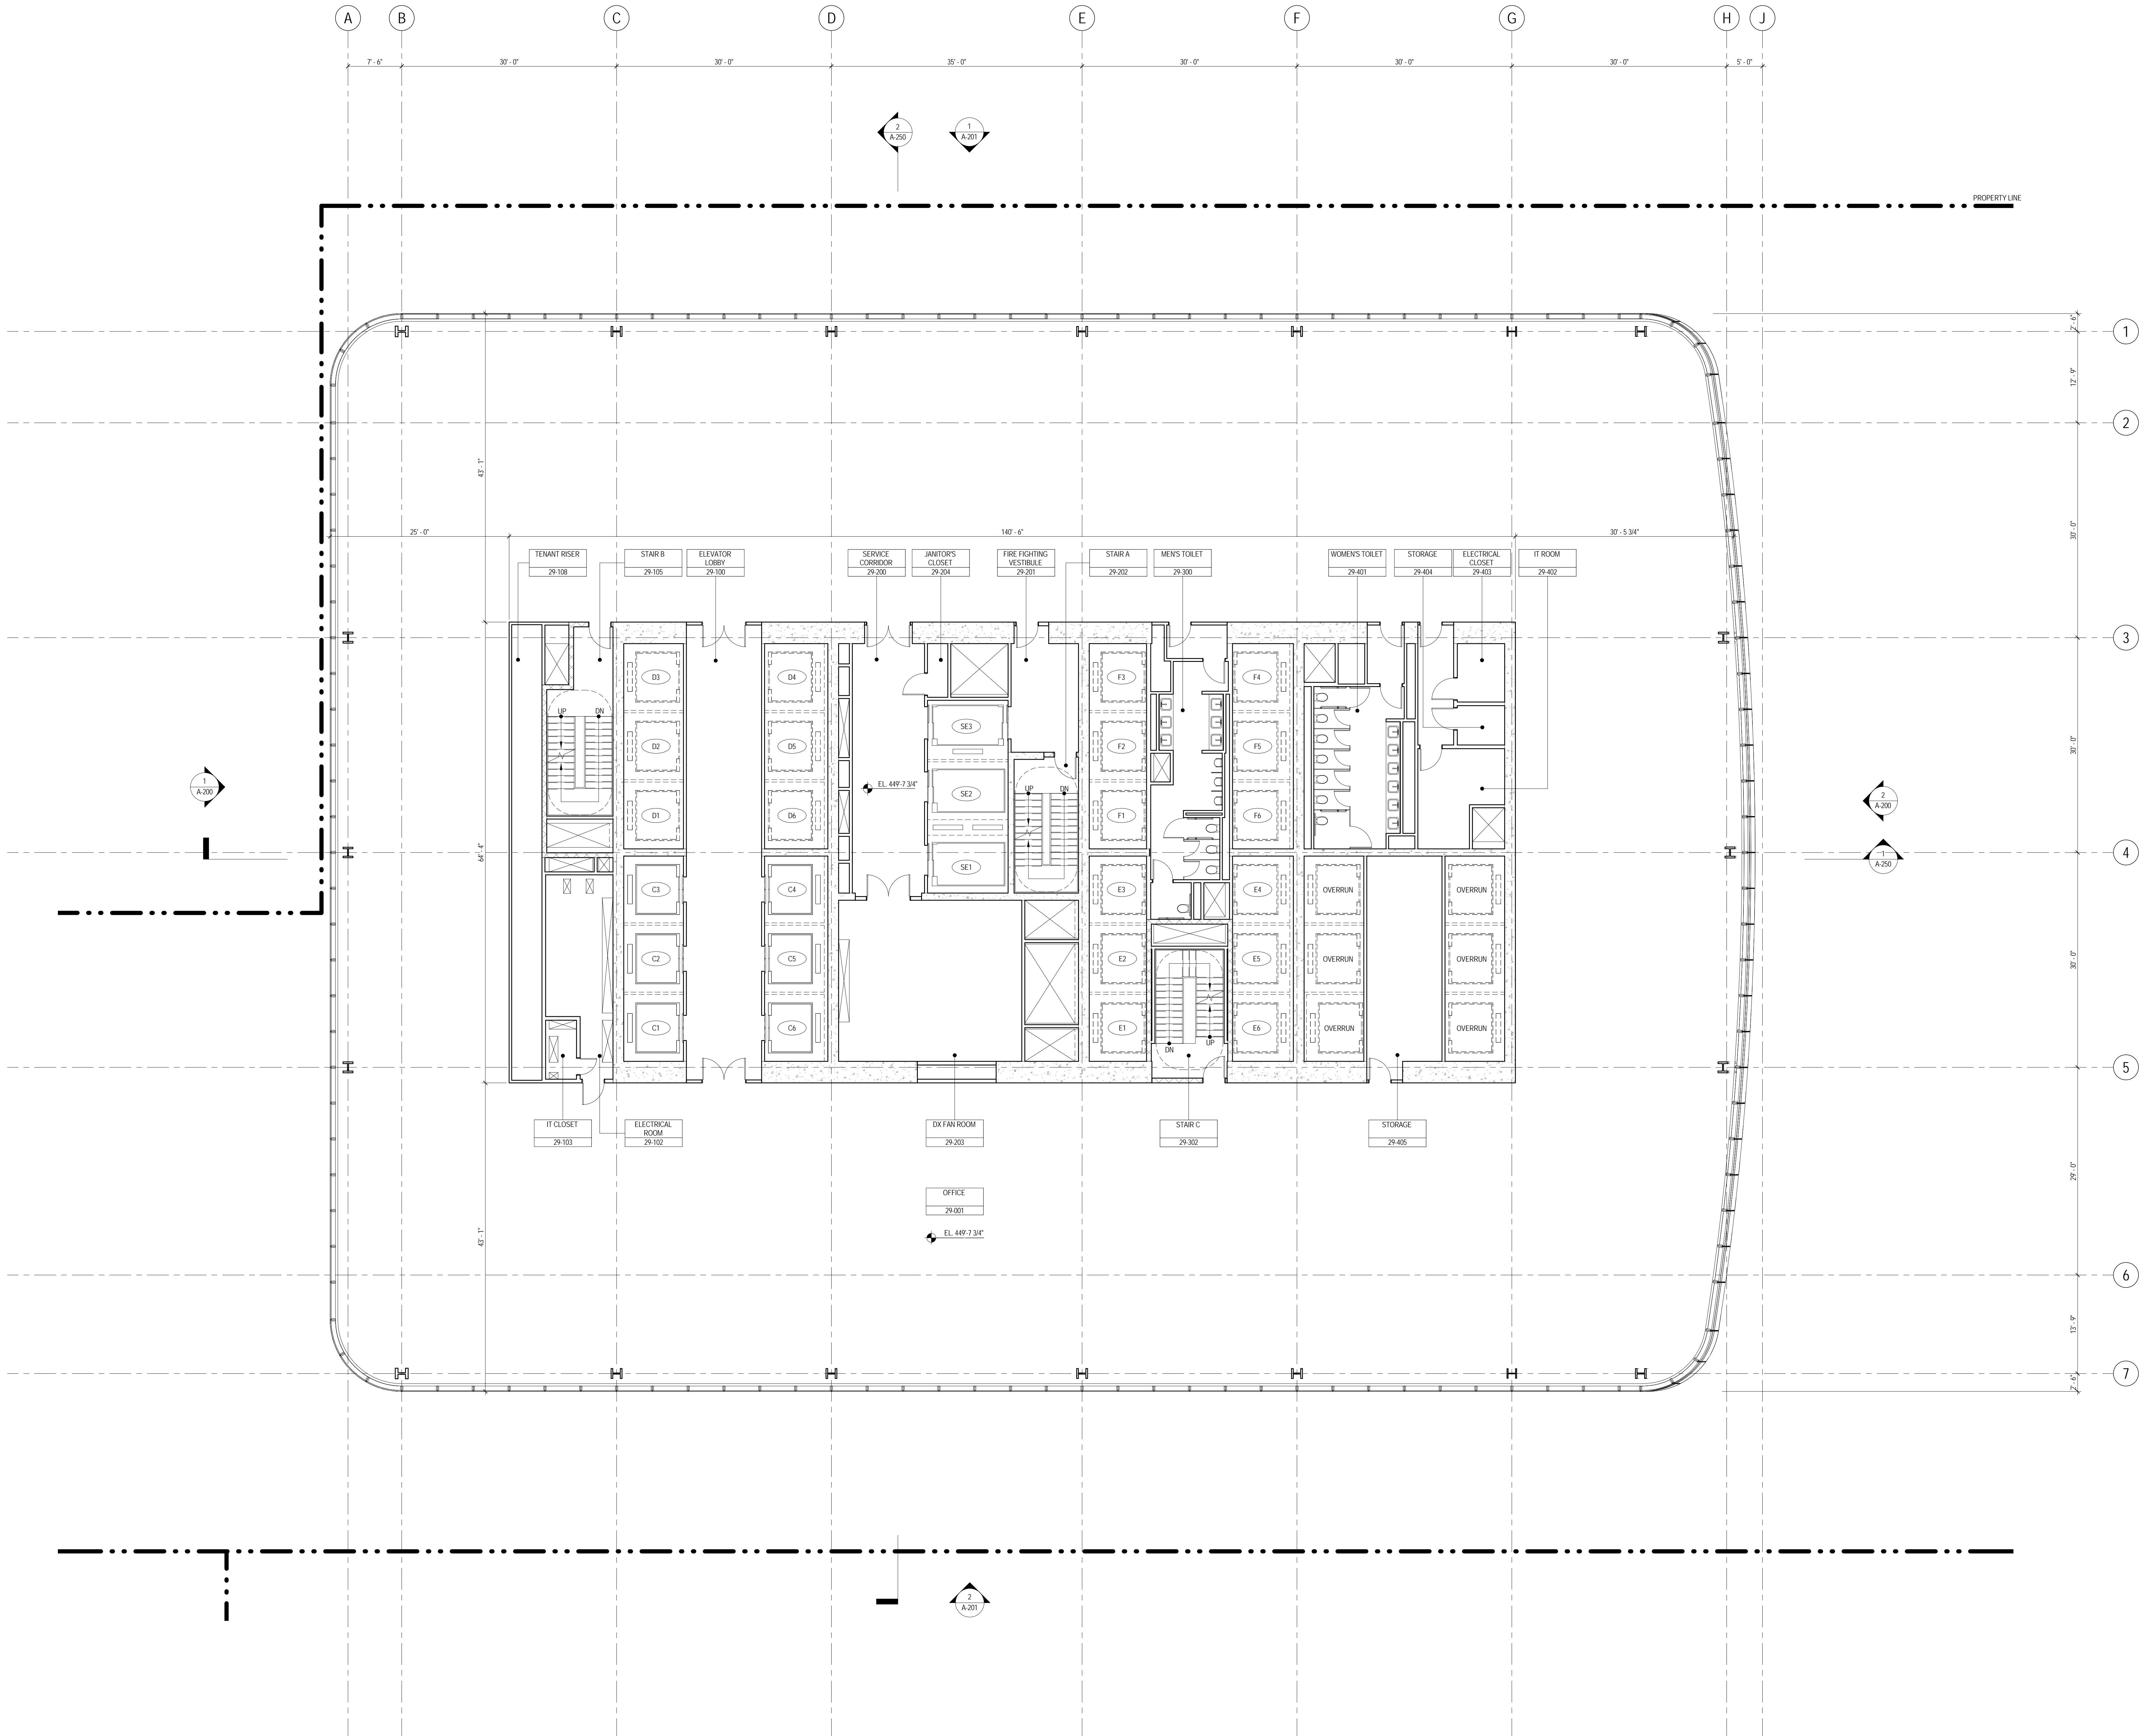

SHEET NOTES

1. ALL BUILDING ELEVATIONS (IN FEET) REFERENCED TO THE NORTH AMERICAN VERTICAL DATUM OF 1988 (NAV88).
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4. FOR ROOM FINISH SCHEDULE SEE A-700 SERIES DRAWINGS.
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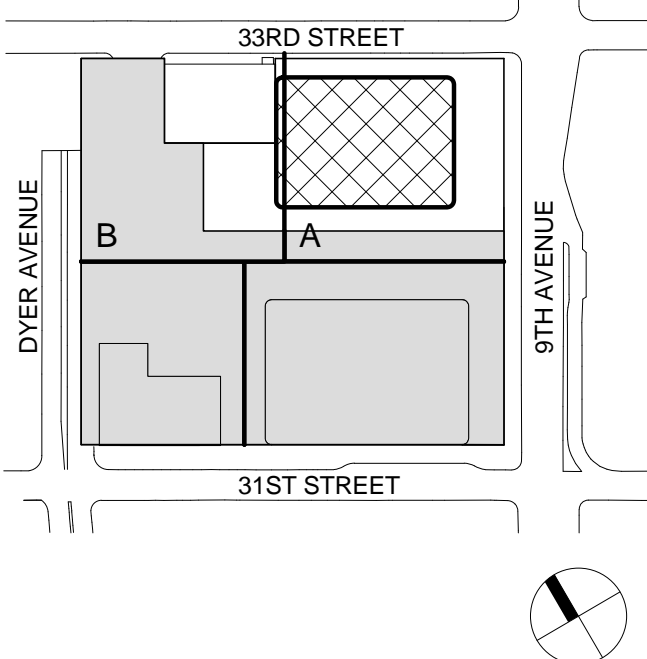
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Code Consultants Professional Engineers PC
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Entek Engineering LLC
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Key Plan:



Seal & Signature:



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4	20 DEC 2013	ISSUED FOR FOUNDATION PERMIT
3	15 NOV 2013	ISSUED FOR 50% PROGRESS PRICING
2	12 JUL 2013	ISSUED FOR 90% DESIGN DEVELOPMENT
1	19 MAR 2013	ISSUED FOR RECONCILIATION

No. Date Description
Sheet Name:

**LEVEL 29 FLOOR
PLAN - MID-RISE
OVERRUN**

Project No.: 207150	B-SCAN Sheet No.: A-129.00
Date: 20 JUN 2014	Sheet No.: A-129
Scale: 1/8" = 1'-0"	Page No.: 34 OF 87
File No.: A-129	

SHEET NOTES

1. ALL BUILDING ELEVATIONS (IN FEET) REFERENCED TO THE NORTH AMERICAN VERTICAL DATUM OF 1988 (NAV88).
2. FOR GENERAL NOTES, BUILDING DEPARTMENT NOTES, AND CLARIFICATION OF THE WORK NOTES REFER TO SHEET NO. G-006.
3. FOR ARCHITECTURAL ABBREVIATIONS, LEGEND OF SYMBOLS & MATERIALS, AND MOUNTING HEIGHTS REFER TO SHEET NO. C-006.
4. FOR ROOM FINISH SCHEDULE SEE A-700 SERIES DRAWINGS.
5. FOR DOOR SCHEDULE SEE A-700 SERIES DRAWINGS. FOR DOOR HARDWARE, SPECIFICATION SEE TECHNICAL SPECIFICATION SECTION (B700).
6. FOR PARTITION TYPES SEE A-700 SERIES DRAWINGS.
7. ALL PARTITIONS SHALL BE TYPE DR UNO.
8. FOR REFLECTED CEILING PLANS SEE A-600 SERIES DRAWINGS. IF RCP IS NOT PROVIDED SEE MEP PHYSICALLY SERVICE DRAWINGS FOR LOCATIONS OR ALL CEILING WALL MOUNTED DEVICES.
9. FOR STRUCTURAL COLUMNS, EDGE OF SLAB, AND CORE WORK POINTS SEE STRUCTURAL SERIES DRAWINGS, UNO.
10. REFER TO STRUCTURAL SERIES DRAWINGS FOR ALL STRUCTURAL WALL DESIGNATIONS AND DIMENSIONS.
11. REFER TO MEP DRAWINGS FOR ALL MECHANICAL, ELECTRICAL, PLUMBING AND FIRE PROTECTION ROOM RISER AND EQUIPMENT DESIGNATIONS.
12. FOR PROJECT WORK POINT REFER TO A-000 SERIES DRAWINGS.



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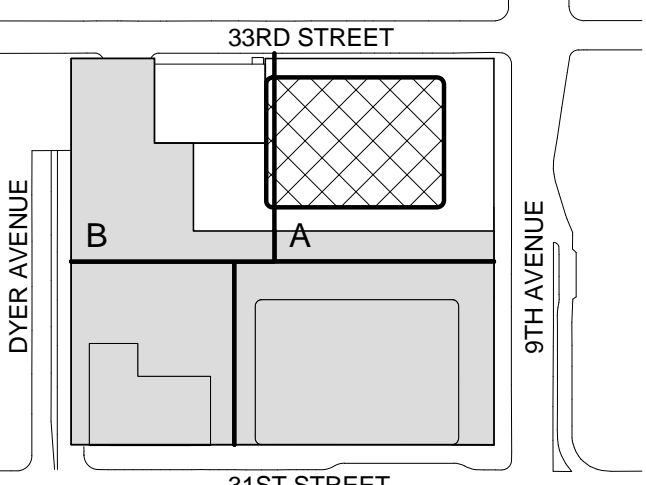
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2	12 JUL 2013	ISSUED FOR 90% DESIGN DEVELOPMENT
1	19 MAR 2012	ISSUED FOR RECONCILIATION

No. Date Description
Sheet Name:

LEVEL 30 FLOOR
PLAN - MID-RISE
EMR

Project No.:

207150

Date:

20 JUN 2014

Scale:

1/8" = 1'-0"

File No.:

A-130

B-SCAN Sheet No.:


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Sheet No.:

A-130

Page No.:

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SHEET NOTES

1. ALL BUILDING ELEVATIONS (IN FEET) REFERENCED TO THE NORTH AMERICAN VERTICAL DATUM OF 1988 (NAV88).
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4. FOR ROOM FINISH SCHEDULE SEE A-700 SERIES DRAWINGS.
5. FOR DOOR SCHEDULE SEE A-700 SERIES DRAWINGS. FOR DOOR HARDWARE SPECIFICATION SEE TECHNICAL SPECIFICATION SECTION 051000.
6. FOR PARTITION TYPES SEE A-700 SERIES DRAWINGS.
7. ALL PARTITIONS SHALL BE TYPE DR, UNO.
8. FOR REFLECTED CEILING PLANS SEE A-600 SERIES DRAWINGS. IF RCP IS NOT PROVIDED SEE MEPP/AVSC/TEL SERVICE DRAWINGS FOR LOCATIONS OR ALL CEILING WALL MOUNTED DEVICES.
9. FOR STRUCTURAL COLUMNS, EDGE OF SLAB, AND CORE WORK POINTS SEE STRUCTURAL SERIES DRAWINGS, UNO.
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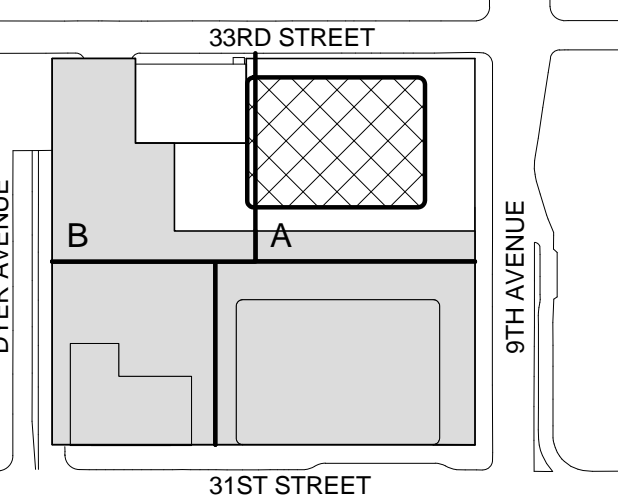
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1	19 MAR 2012	ISSUED FOR RECONCILIATION

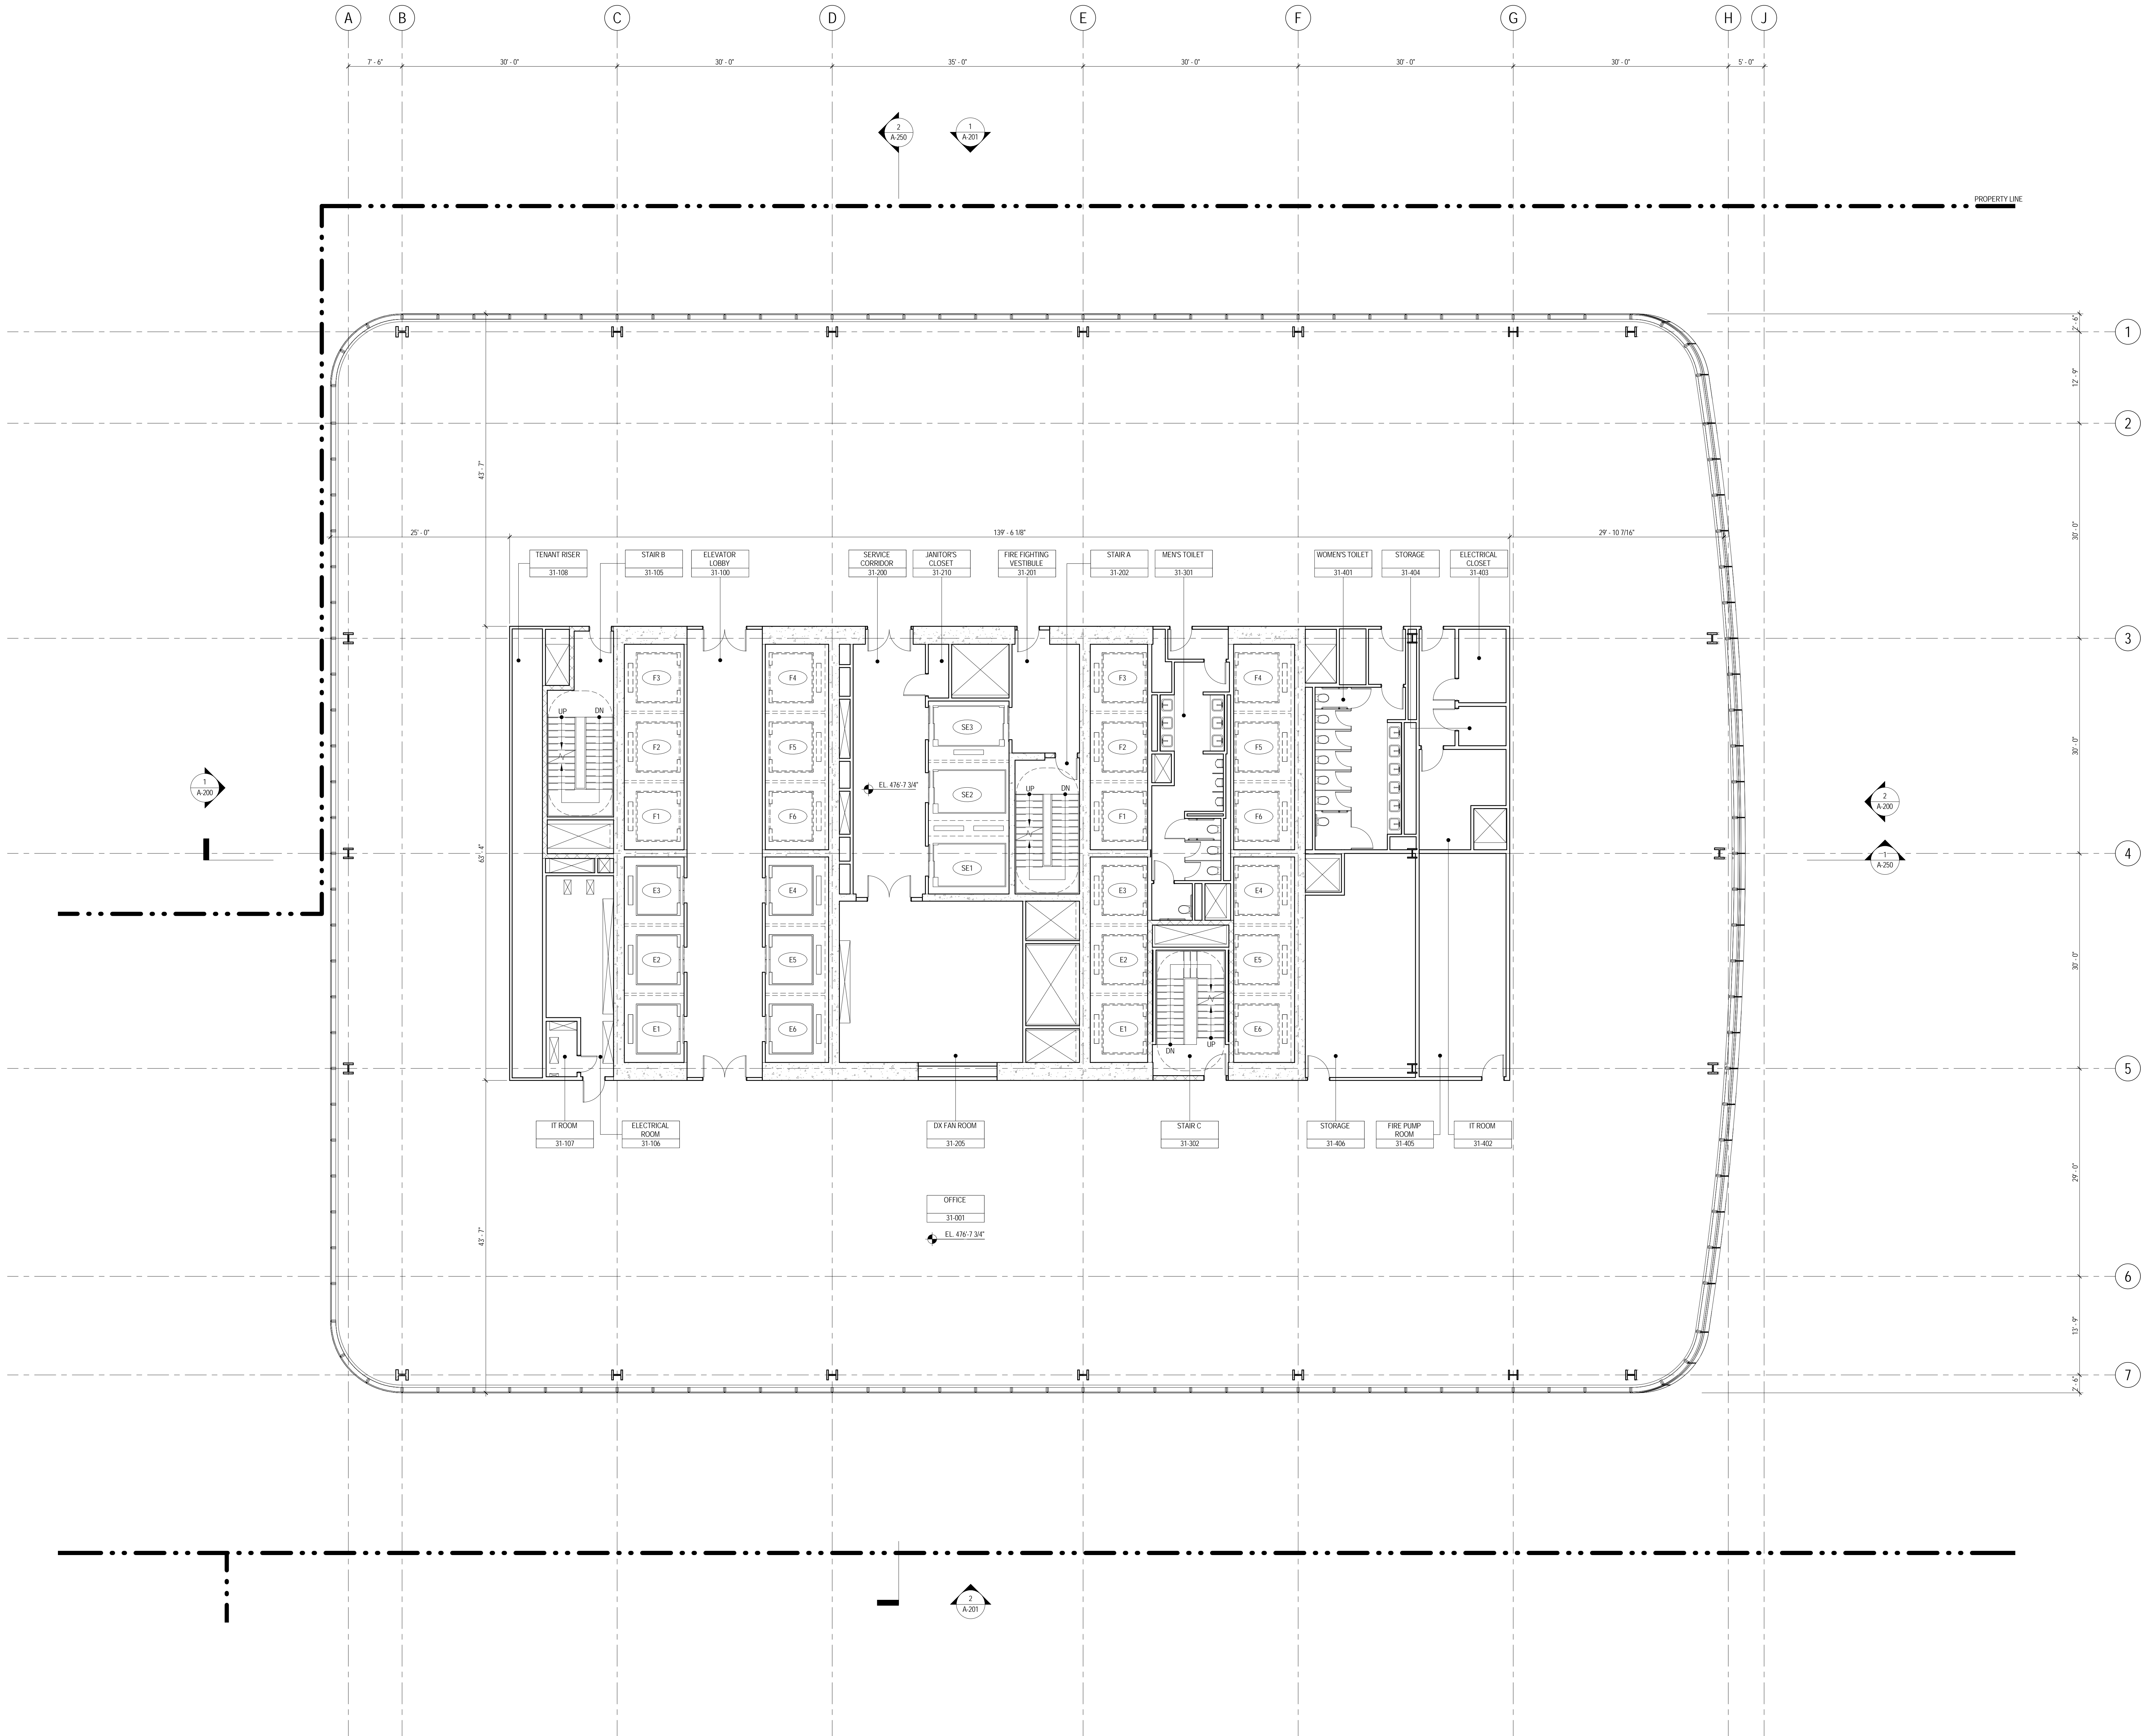No. Date Description

Sheet Name:

**LEVEL 31 FLOOR
PLAN - MID-RISE
PUMP ROOM**

Project No.:

207150

Date:

20 JUN 2014

Scale:

1/8" = 1'-0"

File No.:

A-131

B-SCAN Sheet No.:

A-131.00

Sheet No.:

A-131


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1 LEVEL 32 PLAN

SCALE: NTS



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4. FOR ROOM FINISH SCHEDULE SEE A-700 SERIES DRAWINGS.
5. FOR DOOR SCHEDULE SEE A-700 SERIES DRAWINGS. FOR DOOR HARDWARE SPECIFICATION SEE TECHNICAL SPECIFICATION SECTION 051010.
6. FOR PARTITION TYPES SEE A-700 SERIES DRAWINGS.
7. ALL PARTITIONS SHALL BE TYPE DR, UNO.
8. FOR REFLECTED CEILING PLANS SEE A-600 SERIES DRAWINGS. IF RCP IS NOT PROVIDED SEE MEPP/PA/SC/ITEL SERVICE DRAWINGS FOR LOCATIONS OR ALL CEILING/WALL MOUNTED DEVICES.
9. FOR STRUCTURAL COLUMNS, EDGE OF SLAB AND CORE WORK POINTS SEE STRUCTURAL SERIES DRAWINGS, UNO.
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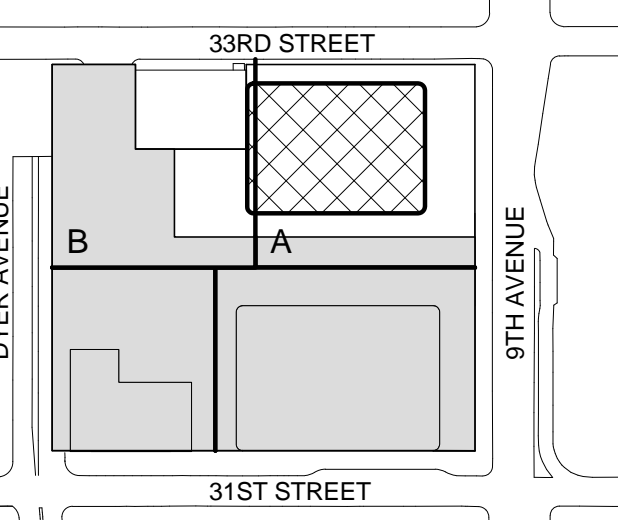
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1	19 MAR 2013	ISSUED FOR RECONCILIATION

No. Date Description
Sheet Name:

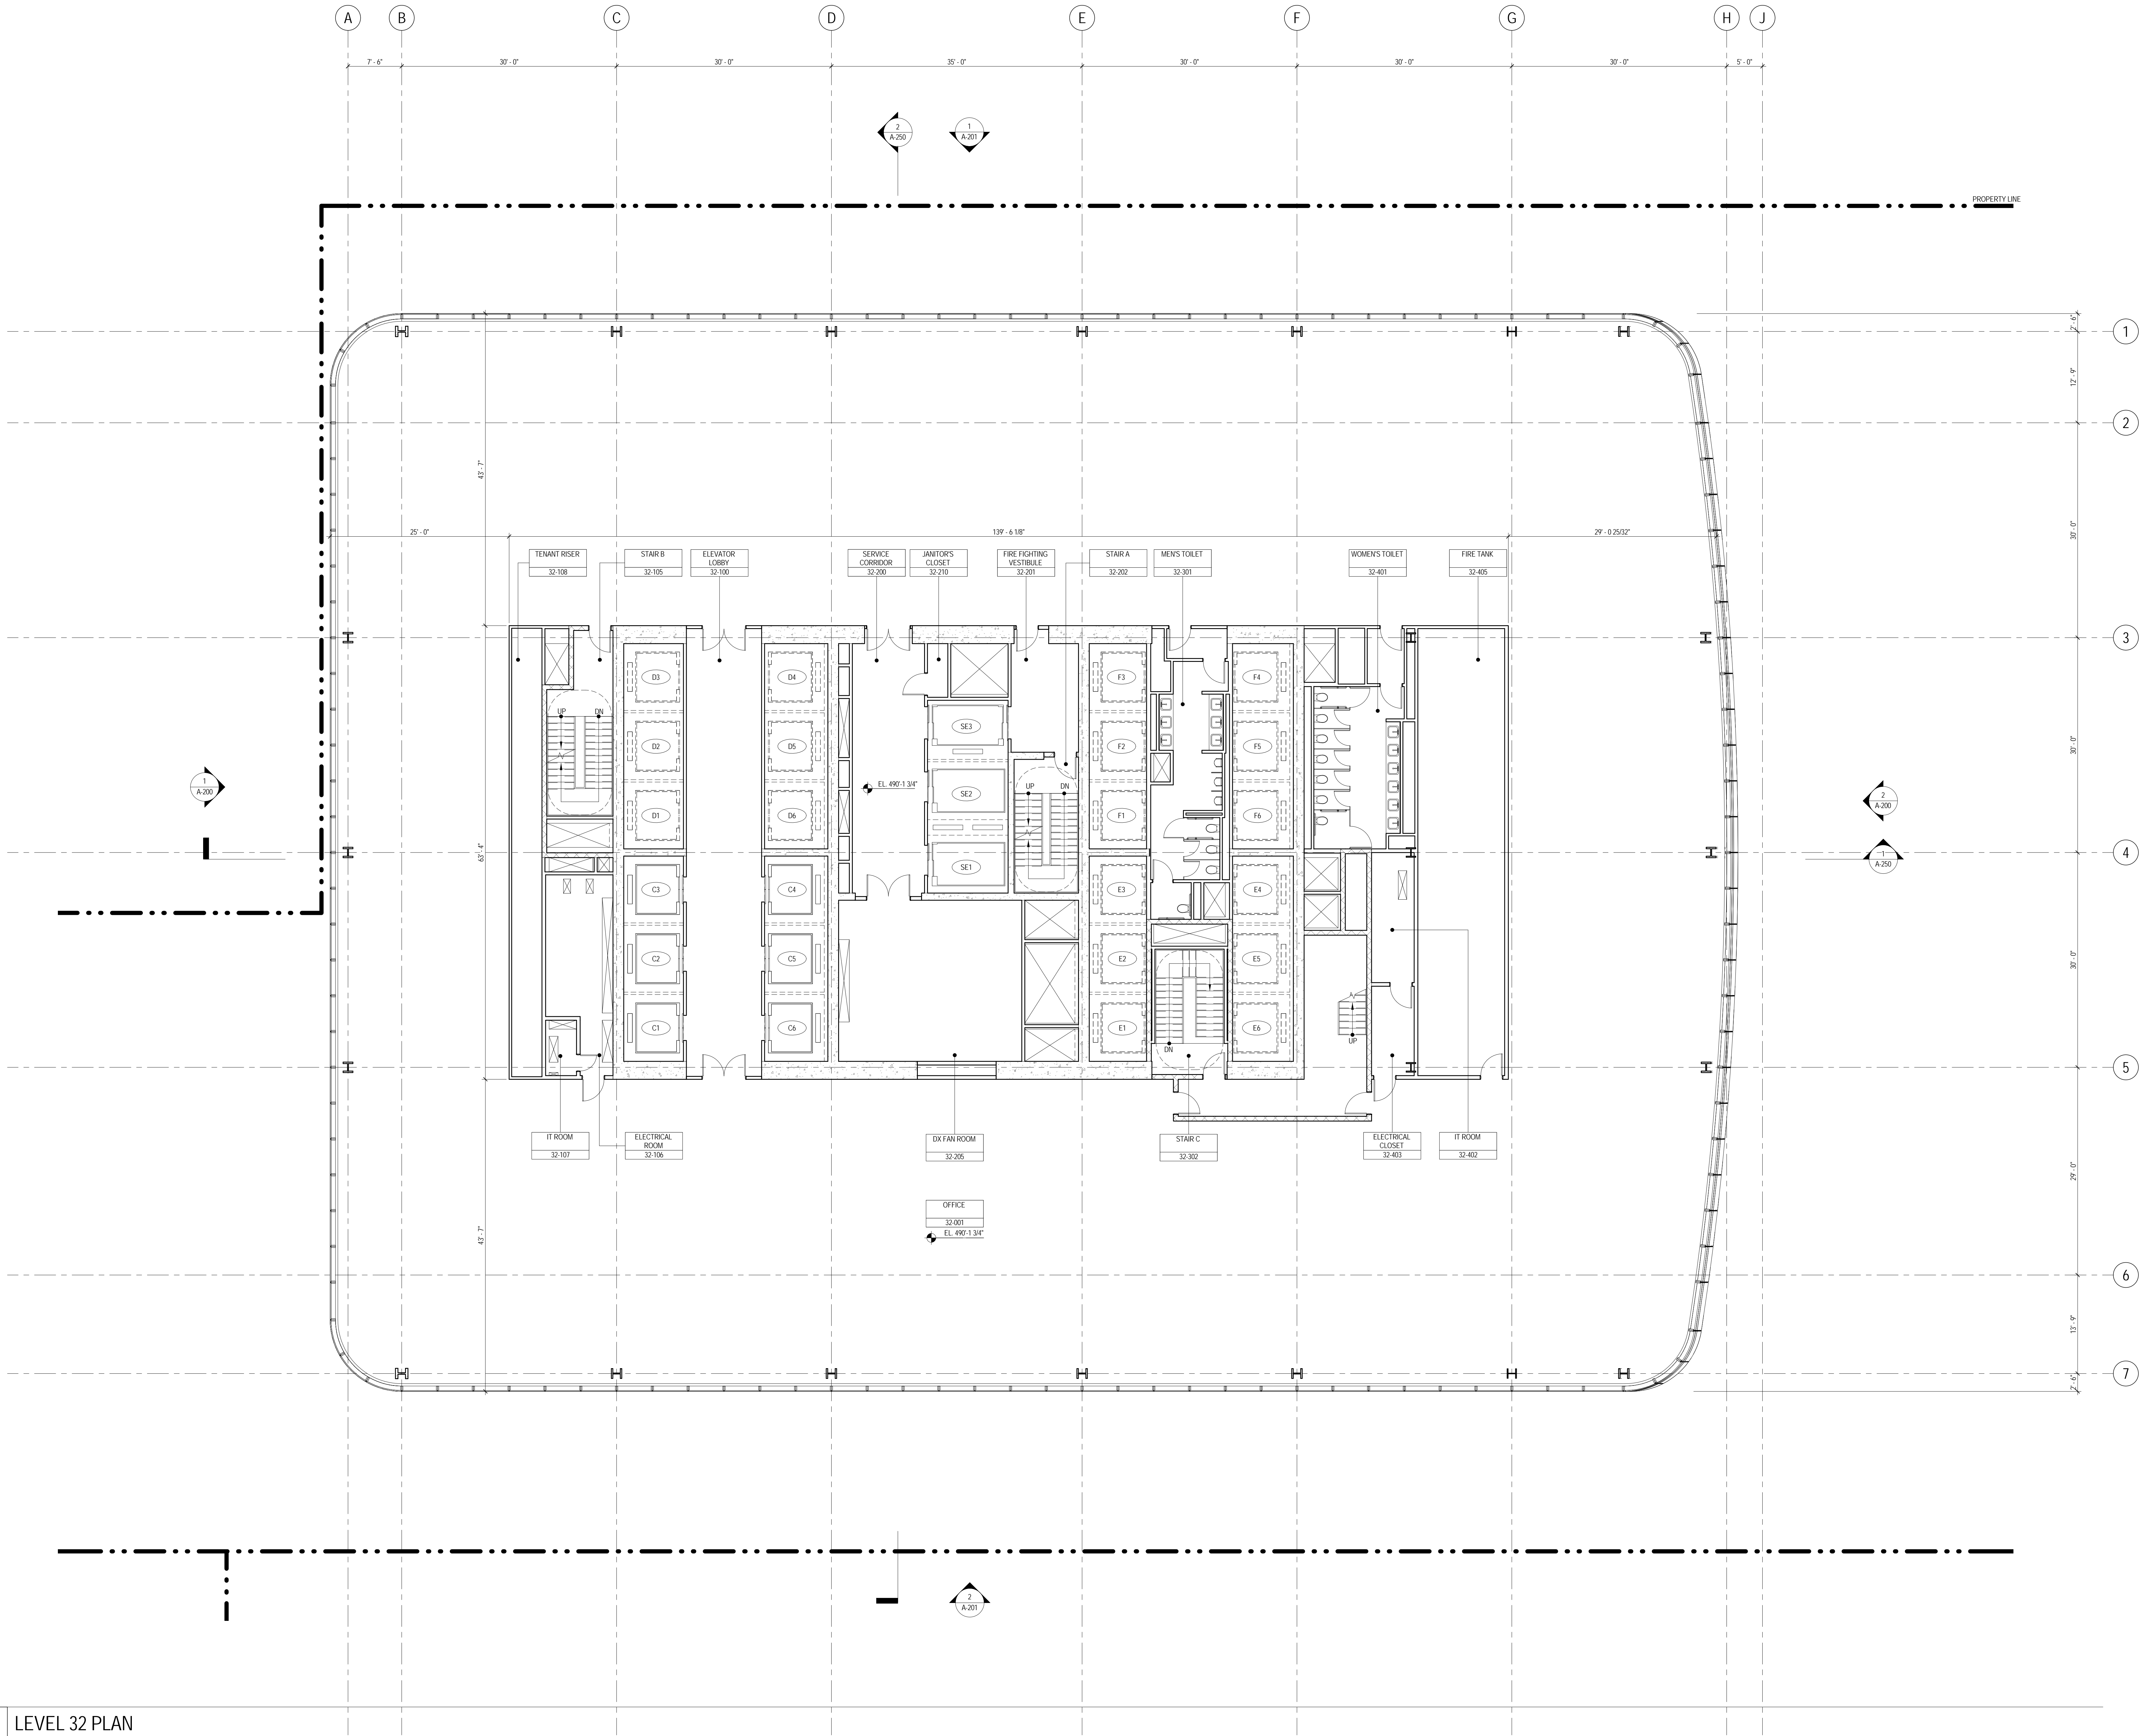LEVEL 32 FLOOR
PLAN - MID-RISE
WATER TANK

Project No.:

207150

Date:

20 JUN 2014

Scale:

1/8" = 1'-0"

File No.:

A-132

B-SCAN Sheet No.:


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Sheet No.:

A-132

Page No.:

37 OF 87

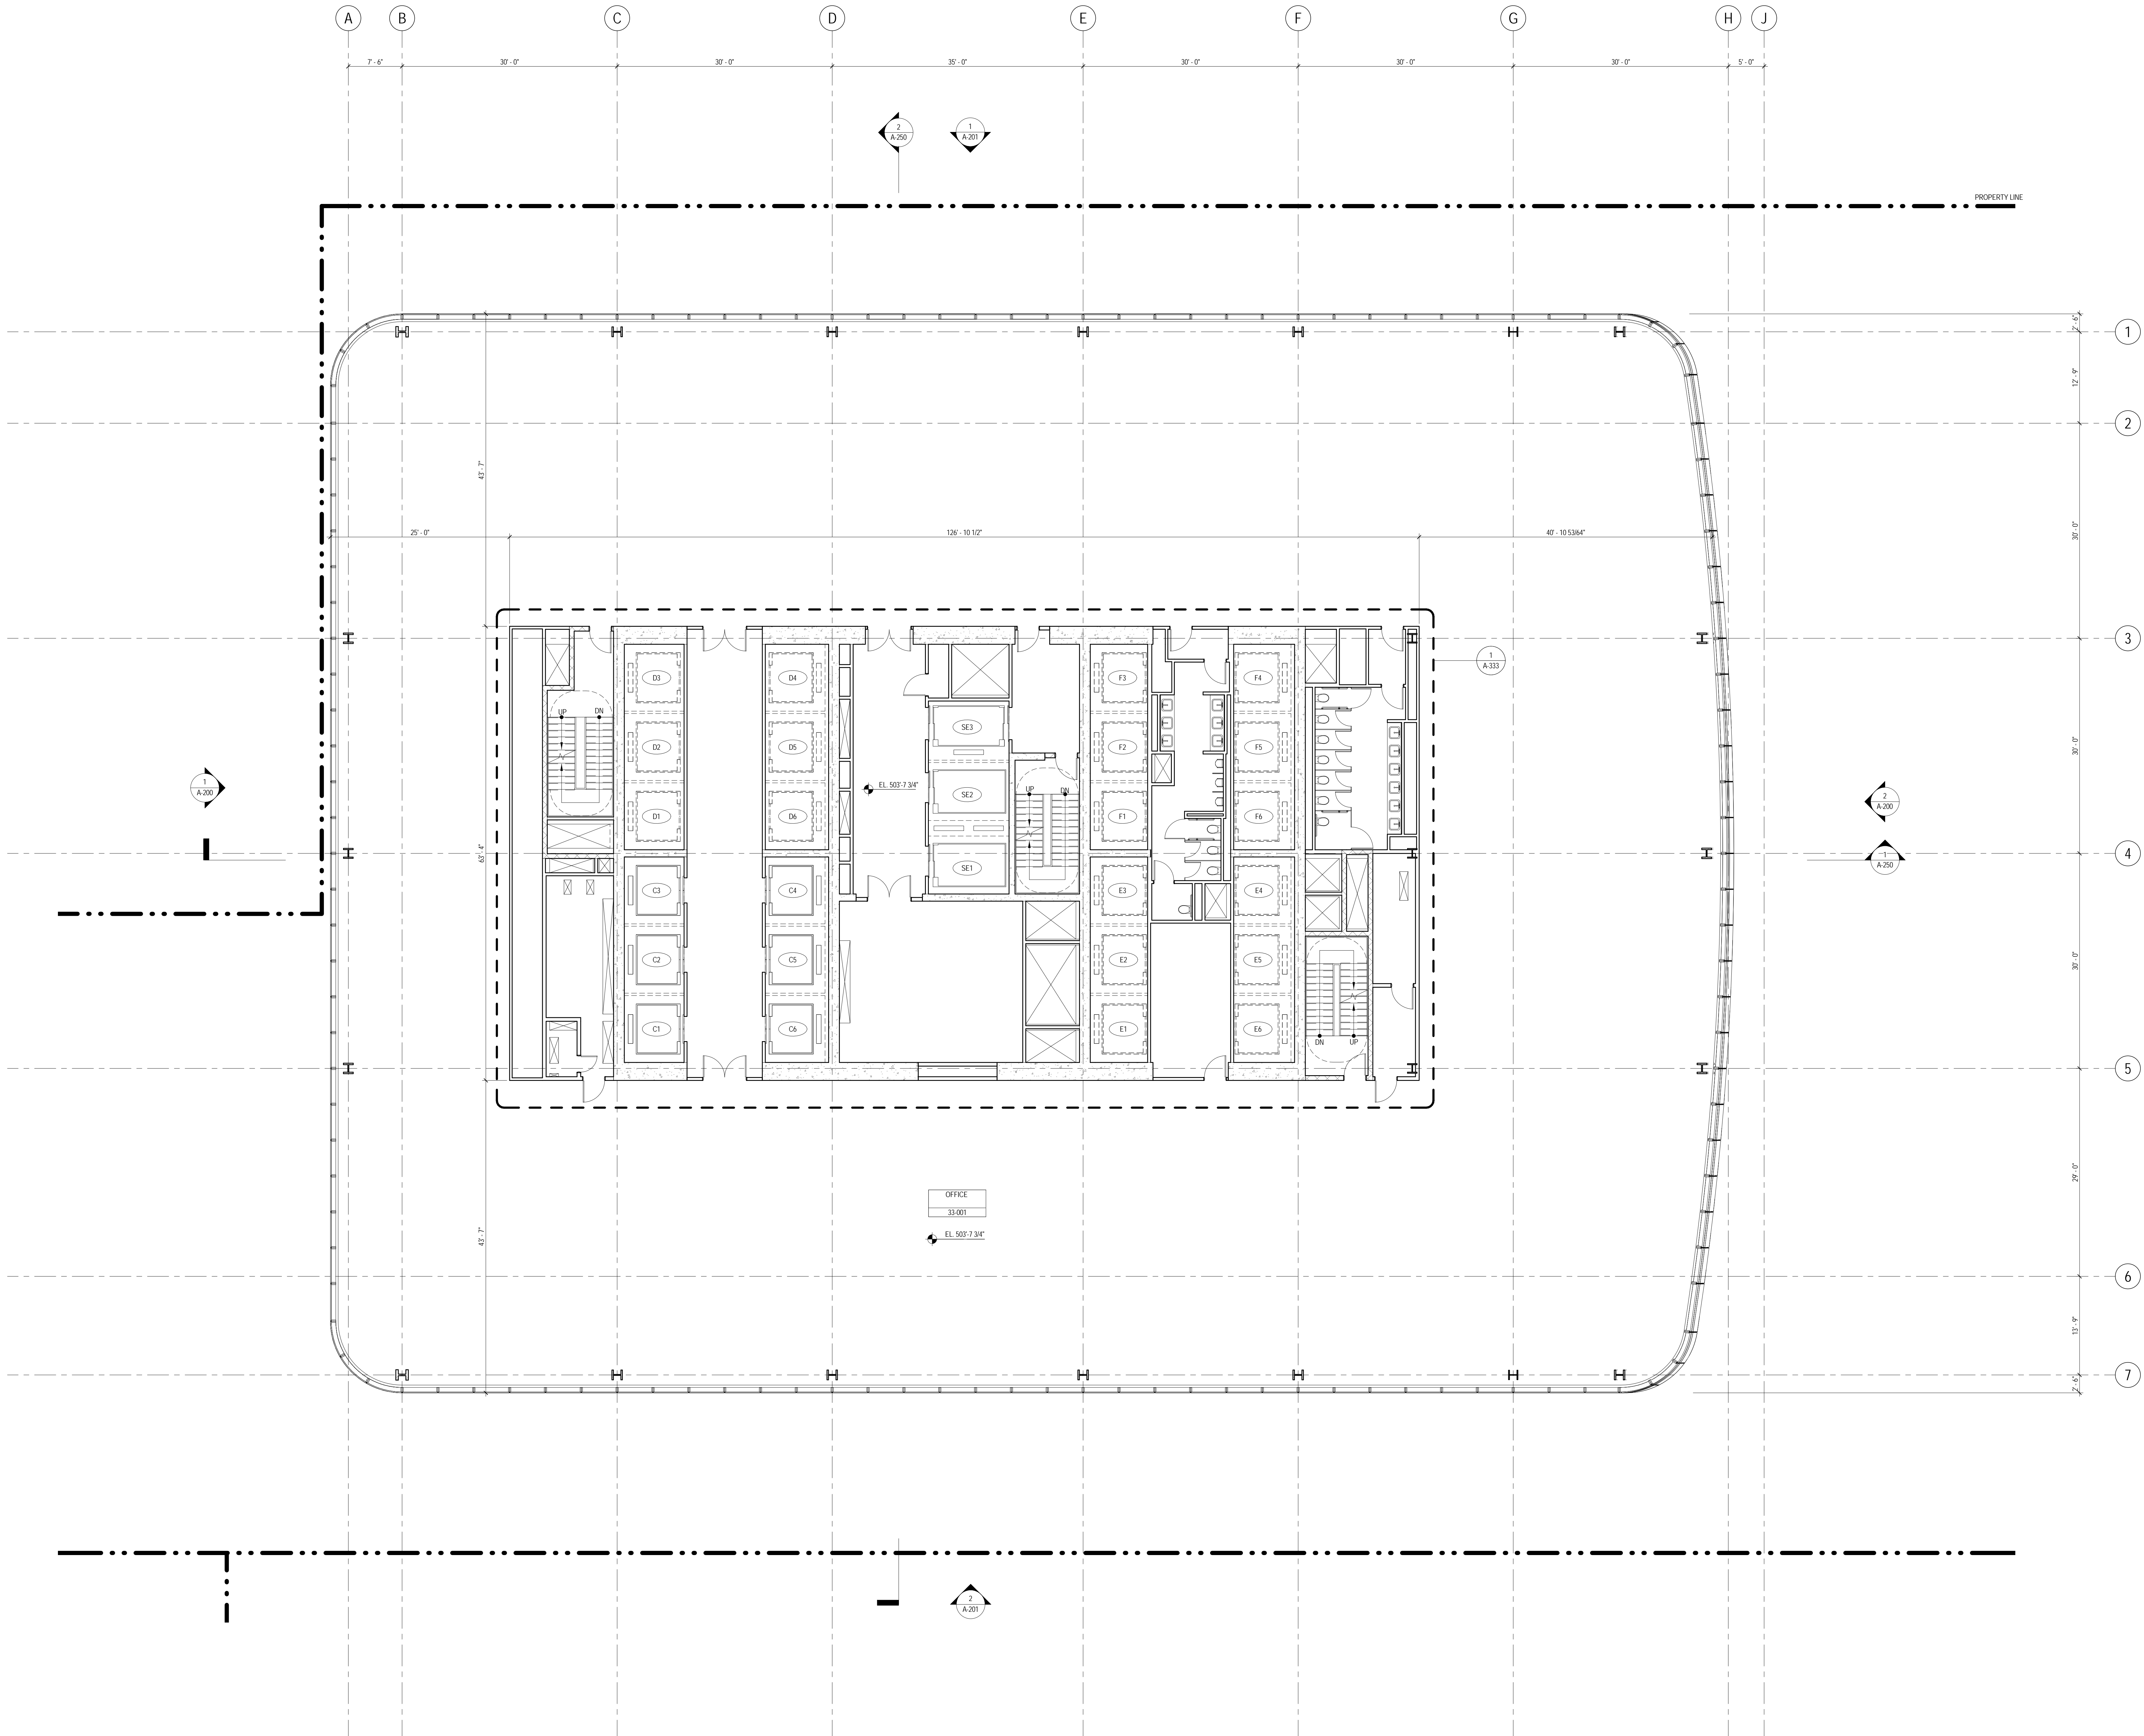

SHEET NOTES

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4. FOR ROOM FINISH SCHEDULE SEE A-700 SERIES DRAWINGS.
5. FOR DOOR SCHEDULE SEE A-700 SERIES DRAWINGS. FOR DOOR HARDWARE SPECIFICATION SEE TECHNICAL SPECIFICATION SECTION 051010.
6. FOR PARTITION TYPES SEE A-700 SERIES DRAWINGS.
7. ALL PARTITIONS SHALL BE TYPE DR, LINO.
8. FOR REFLECTED CEILING PLANS SEE A-400 SERIES DRAWINGS. IF RCP IS NOT PROVIDED SEE MEPP/PA/ASC/TEL SERVICE DRAWINGS FOR LOCATIONS OR ALL CEILING/WALL MOUNTED DEVICES.
9. FOR STRUCTURAL COLUMNS, EDGE OF SLAB, AND CORE WORK POINTS SEE STRUCTURAL SERIES DRAWINGS, LINO.
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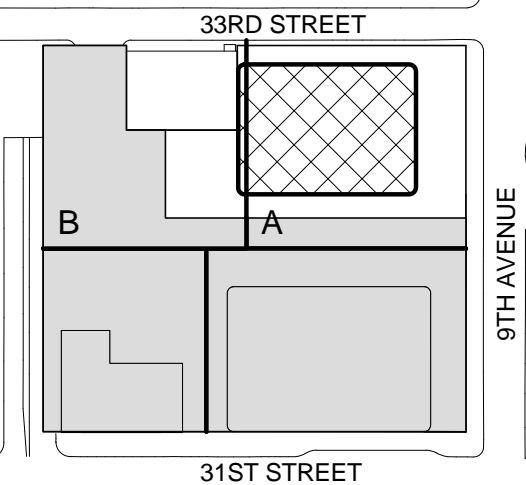
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1	19 MAR 2012	ISSUED FOR RECONCILIATION

No. Date Description
Sheet Name:

**LEVEL 33-38
FLOOR PLAN -
TYPICAL
MID-RISE**

Project No.:

207150

Date:

20 JUN 2014

Scale:

1/8" = 1'-0"

File No.:

A-133

B-SCAN Sheet No.:

A-133.00

Sheet No.:

A-133

Page No.:

38 OF 87

SHEET NOTES

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4. FOR ROOM FINISH SCHEDULE SEE A-700 SERIES DRAWINGS.
5. FOR DOOR SCHEDULE SEE A-700 SERIES DRAWINGS. FOR DOOR HARDWARE SPECIFICATION SEE TECHNICAL SPECIFICATION SECTION (B0701).
6. FOR PARTITION TYPES SEE A-700 SERIES DRAWINGS.
7. ALL PARTITIONS SHALL BE TYPE DR UNO.
8. FOR REFLECTED CEILING PLANS SEE A-600 SERIES DRAWINGS. IF RCP IS NOT PROVIDED SEE MEP PHYSICIST'S SERVICE DRAWINGS FOR LOCATIONS OR ALL CEILING/WALL MOUNTED DEVICES.
9. FOR STRUCTURAL COLUMNS, EDGE OF SLAB AND CORE WORK POINTS SEE STRUCTURAL SERIES DRAWINGS, UNO.
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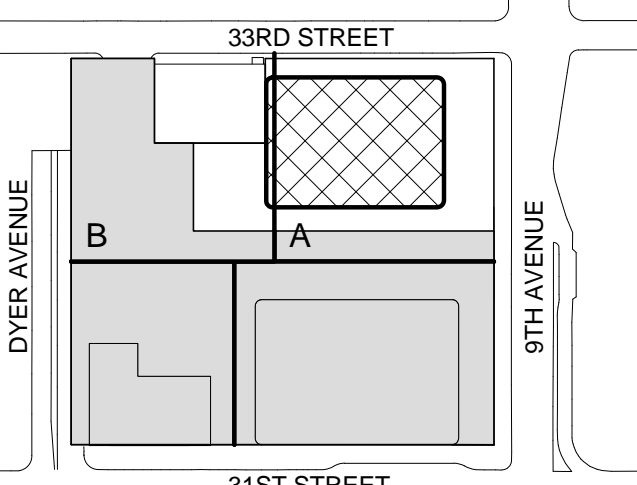
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| 2 | 12 JUL 2013 | ISSUED FOR 90% DESIGN DEVELOPMENT |
| 1 | 19 MAR 2012 | ISSUED FOR RECONCILIATION |

No. Date Description
Sheet Name:

LEVEL 39 FLOOR
PLAN - MID-RISE

Project No.:

207150

Date:

20 JUN 2014

Scale:

1/8" = 1'-0"

File No.:

A-139

B-SCAN Sheet No.:

A-139.00

Sheet No.:

A-139

Page No.:

39 OF 87

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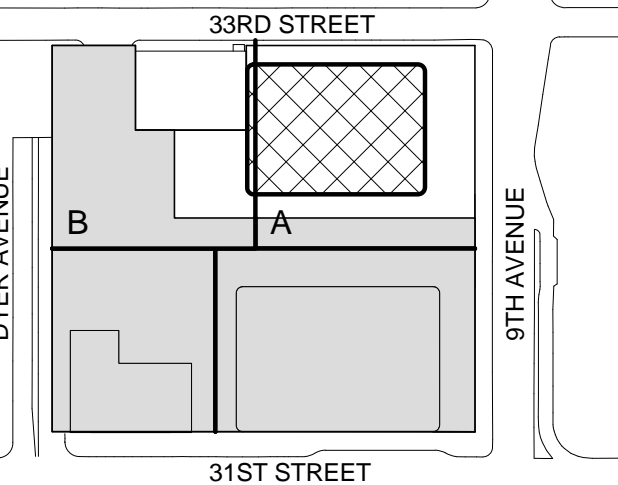
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Wind Tunnel Consultant

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Key Plan:



Seal & Signature:



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3	15 NOV 2013	ISSUED FOR 50% PROGRESS PRICING
2	12 JUL 2013	ISSUED FOR 90% DESIGN DEVELOPMENT
1	19 MAR 2012	ISSUED FOR RECONCILIATION

No. Date Description
Sheet Name:

LEVEL 40-41
FLOOR PLAN -
MID-RISE
OVERRUN

Project No.:

207150

Date:

20 JUN 2014

Scale:

1/8" = 1'-0"

File No.:

A-140

B-SCAN Sheet No.:

A-140.00

Sheet No.:

A-140

Page No.:

40 OF 87

SHEET NOTES

1. ALL BUILDING ELEVATIONS (IN FEET) REFERENCED TO THE NORTH AMERICAN VERTICAL DATUM OF 1988 (NAV88).
2. FOR GENERAL NOTES, BUILDING DEPARTMENT NOTES, AND CLARIFICATION OF THE WORK NOTES REFER TO SHEET NO. G-005.
3. FOR ARCHITECTURAL ABBREVIATIONS, LEGEND OF SYMBOLS & MATERIALS, AND MOUNTING HEIGHTS REFER TO SHEET NO. G-006.
4. FOR ROOM FINISH SCHEDULE SEE A-700 SERIES DRAWINGS.
5. FOR DOOR SCHEDULE SEE A-700 SERIES DRAWINGS. FOR DOOR HARDWARE, SPECIFICATION SEE TECHNICAL SPECIFICATION SECTION 05100.
6. FOR PARTITION TYPES SEE A-700 SERIES DRAWINGS.
7. ALL PARTITIONS SHALL BE TYPE DR UNO.
8. FOR REFLECTED CEILING PLANS SEE A-600 SERIES DRAWINGS. IF RCP IS NOT PROVIDED SEE MEP PHYSICIST'S SERVICE DRAWINGS FOR LOCATIONS OR ALL CEILING WALL MOUNTED DEVICES.
9. FOR STRUCTURAL COLUMNS, EDGE OF SLAB AND CORE WORK POINTS SEE STRUCTURAL SERIES DRAWINGS UNO.
10. REFER TO STRUCTURAL SERIES DRAWINGS FOR ALL STRUCTURAL WALL DESIGNATIONS AND DIMENSIONS.
11. REFER TO MEPD DRAWINGS FOR ALL MECHANICAL, ELECTRICAL, PLUMBING AND FIRE PROTECTION ROOM, RISER AND EQUIPMENT DESIGNATIONS.
12. FOR PROJECT WORK POINT REFER TO A-000 SERIES DRAWINGS.



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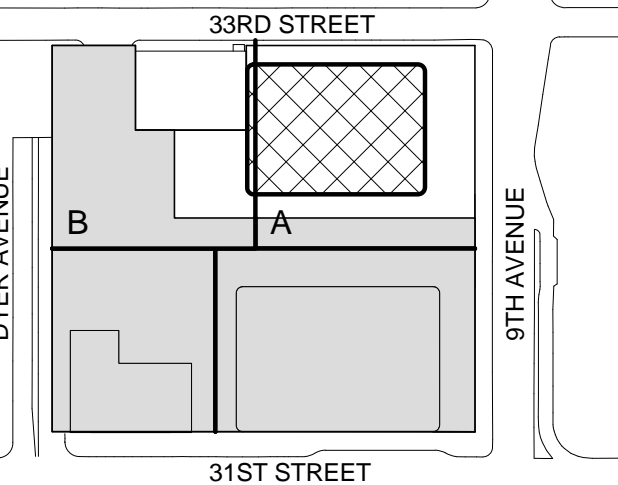
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|---|-------------|-----------------------------------|
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| 2 | 12 JUL 2013 | ISSUED FOR 90% DESIGN DEVELOPMENT |
| 1 | 19 MAR 2013 | ISSUED FOR RECONCILIATION |

No. Date Description
Sheet Name:

LEVEL 42 FLOOR
PLAN - MID-RISE
EMR

Project No.:

207150

Date:

20 JUN 2014

Scale:

1/8" = 1'-0"

File No.:

A-142

B-SCAN Sheet No.:

A-142.00

Sheet No.:

A-142

Page No.:

41 OF 87

SHEET NOTES

1. ALL BUILDING ELEVATIONS (IN FEET) REFERENCED TO THE NORTH AMERICAN VERTICAL DATUM OF 1988 (NAV88).
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4. FOR ROOM FINISH SCHEDULE SEE A-700 SERIES DRAWINGS.
5. FOR DOOR SCHEDULE SEE A-700 SERIES DRAWINGS. FOR DOOR HARDWARE SPECIFICATION SEE TECHNICAL SPECIFICATION SECTION B57000.
6. FOR PARTITION TYPES SEE A-700 SERIES DRAWINGS.
7. ALL PARTITIONS SHALL BE TYPE DR UNO.
8. FOR REFLECTED CEILING PLANS SEE A-600 SERIES DRAWINGS. IF RCP IS NOT PROVIDED SEE MEPP/PA/SC/TEL SERVICE DRAWINGS FOR LOCATIONS OR ALL CEILING/WALL MOUNTED DEVICES.
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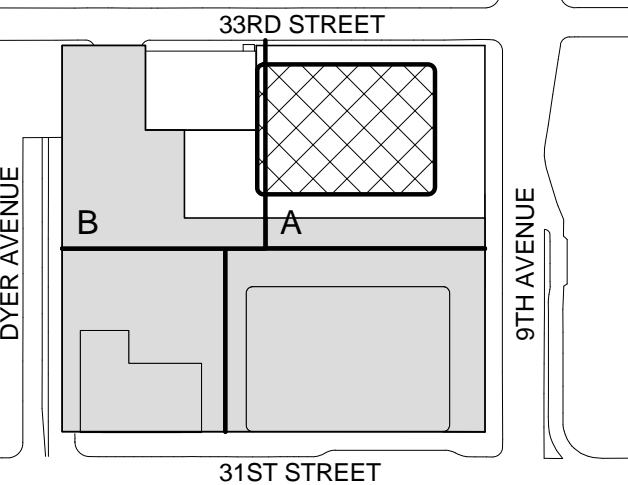
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1	19 MAR 2012	ISSUED FOR RECONCILIATION

No. Date Description
Sheet Name:

LEVEL 43-48
FLOOR PLAN -
TYPICAL
MID-RISE

Project No.:

207150

Date:

20 JUN 2014

Scale:

1/8" = 1'-0"

File No.:

A-143

B-SCAN Sheet No.:

A-143.00

Sheet No.:

A-143

Page No.:

42 OF 87

SHEET NOTES

1. ALL BUILDING ELEVATIONS (IN FEET) REFERENCED TO THE NORTH AMERICAN VERTICAL DATUM OF 1988 (NAV88).
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4. FOR ROOM FINISH SCHEDULE SEE A-700 SERIES DRAWINGS.
5. FOR DOOR SCHEDULE SEE A-700 SERIES DRAWINGS. FOR DOOR HARDWARE SPECIFICATION SEE TECHNICAL SPECIFICATION SECTION (B0700).
6. FOR PARTITION TYPES SEE A-700 SERIES DRAWINGS.
7. ALL PARTITIONS SHALL BE TYPE DR, UNO.
8. FOR REFLECTED CEILING PLANS SEE A-600 SERIES DRAWINGS. IF RCP IS NOT PROVIDED SEE MEP/FIT/ASC/CITEL SERVICE DRAWINGS FOR LOCATIONS OR ALL CEILING/WALL MOUNTED DEVICES.
9. FOR STRUCTURAL COLUMNS, EDGE OF SLAB, AND CORE WORK POINTS SEE STRUCTURAL SERIES DRAWINGS, UNO.
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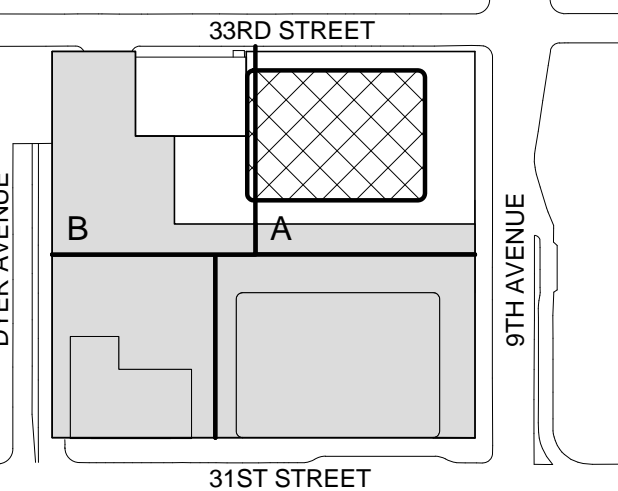
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1	19 MAR 2012	ISSUED FOR RECONCILIATION

No. Date Description
Sheet Name:

LEVEL 49 FLOOR
PLAN - MID-RISE
& HIGH-RISE

Project No.:

207150

Date:

20 JUN 2014

Scale:

1/8" = 1'-0"

File No.:

A-149

B-SCAN Sheet No.:


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A-149

Page No.:

43 OF 87



SHEET NOTES

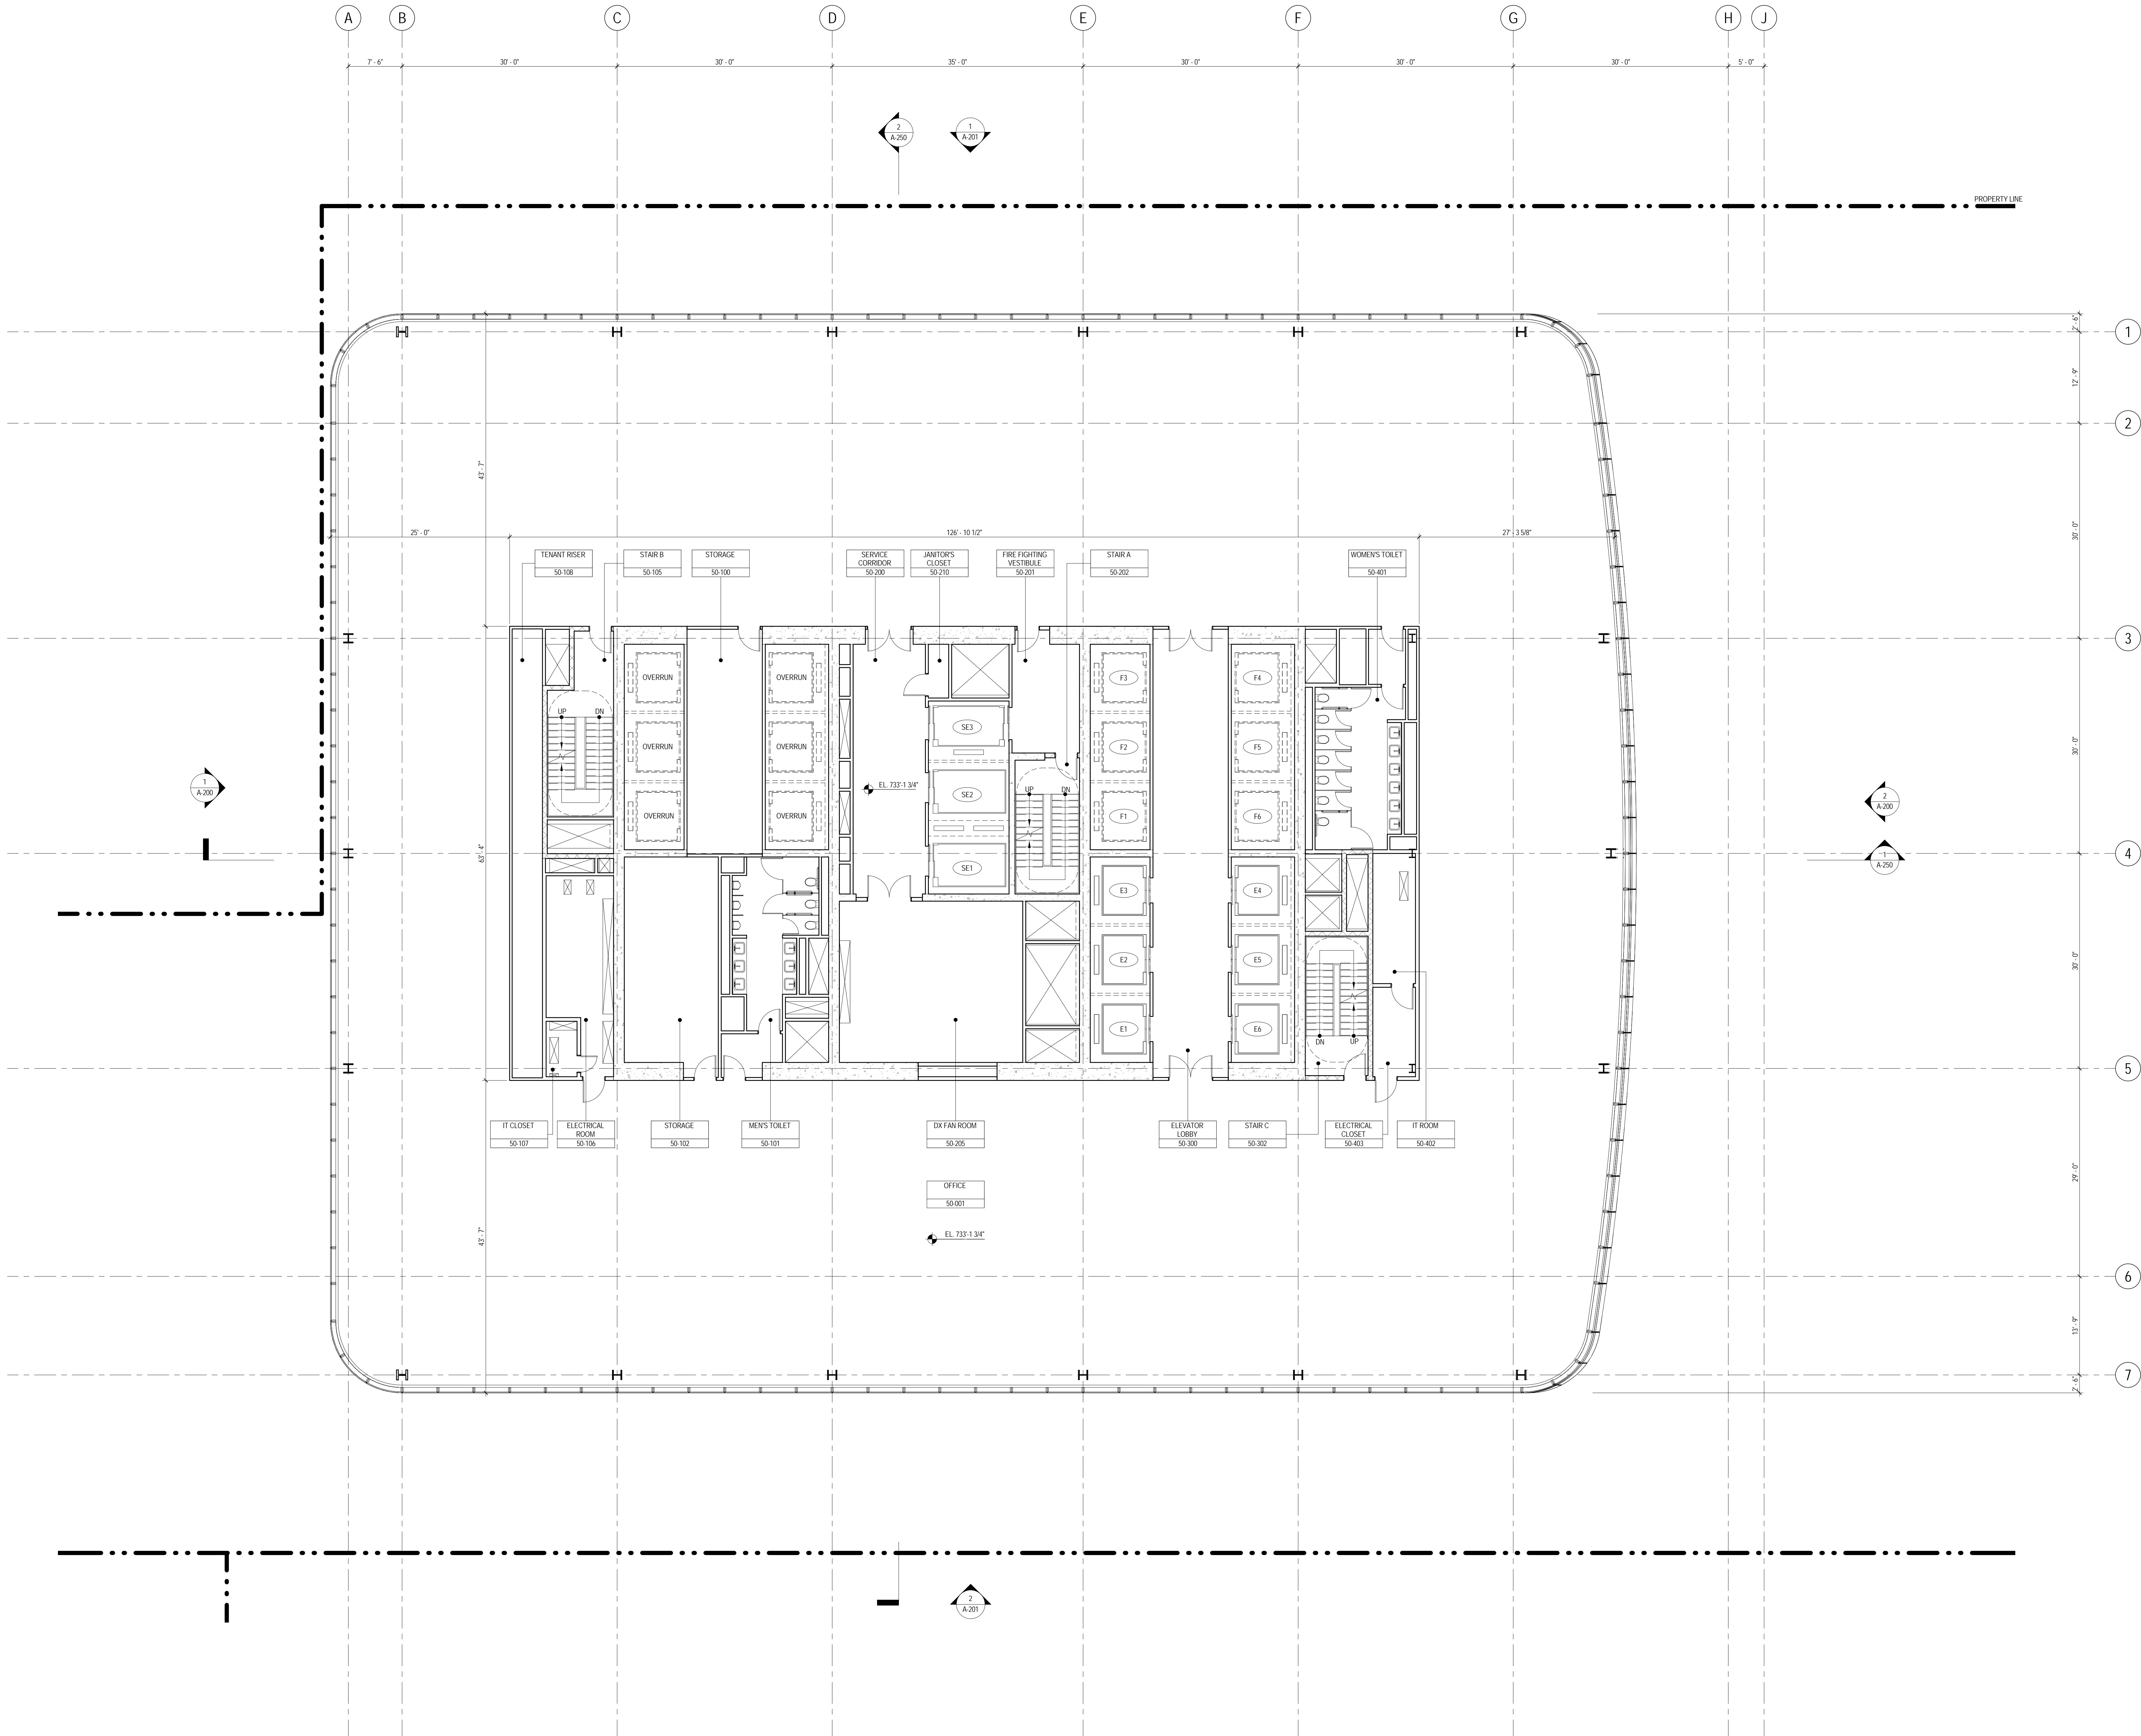1. ALL BUILDING ELEVATIONS (IN FEET) REFERENCED TO THE NORTH AMERICAN VERTICAL DATUM OF 1988 (NAV88).
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3. FOR ARCHITECTURAL ABBREVIATIONS, LEGEND OF SYMBOLS & MATERIALS, AND MOUNTING HEIGHTS REFER TO SHEET NO. C-006.
4. FOR ROOM FINISH SCHEDULE SEE A-700 SERIES DRAWINGS.
5. FOR DOOR SCHEDULE SEE A-700 SERIES DRAWINGS. FOR DOOR HARDWARE, SPECIFICATION SEE TECHNICAL SPECIFICATION SECTION 051010.
6. FOR PARTITION TYPES SEE A-700 SERIES DRAWINGS.
7. ALL PARTITIONS SHALL BE TYPE DR, UNO.
8. FOR REFLECTED CEILING PLANS SEE A-600 SERIES DRAWINGS. IF RCP IS NOT PROVIDED SEE MEPPH/ASCE/TEL SERVICE DRAWINGS FOR LOCATIONS OR ALL CEILING WALL MOUNTED DEVICES.
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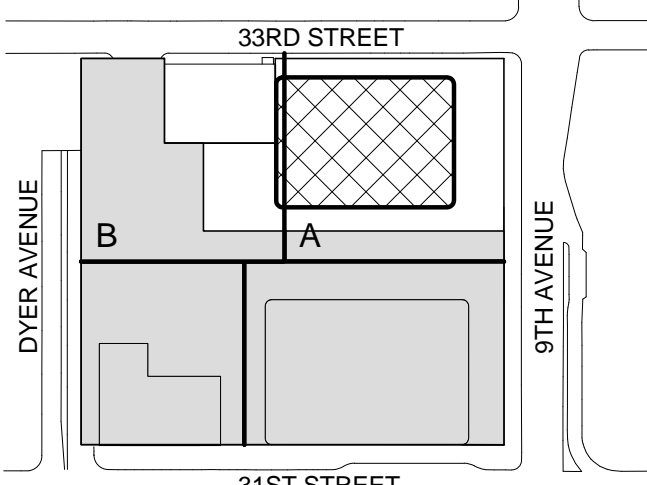
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1	19 MAR 2013	ISSUED FOR RECONCILIATION

No. Date Description

Sheet Name:

**LEVEL 50-51
FLOOR PLAN -
HIGH-RISE
OVERRUN**

Project No.:

207150

Date:

20 JUN 2014

Scale:

1/8" = 1'-0"

File No.:

A-150

B-SCAN Sheet No.:


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Sheet No.:

A-150

Page No.:

44 OF 87

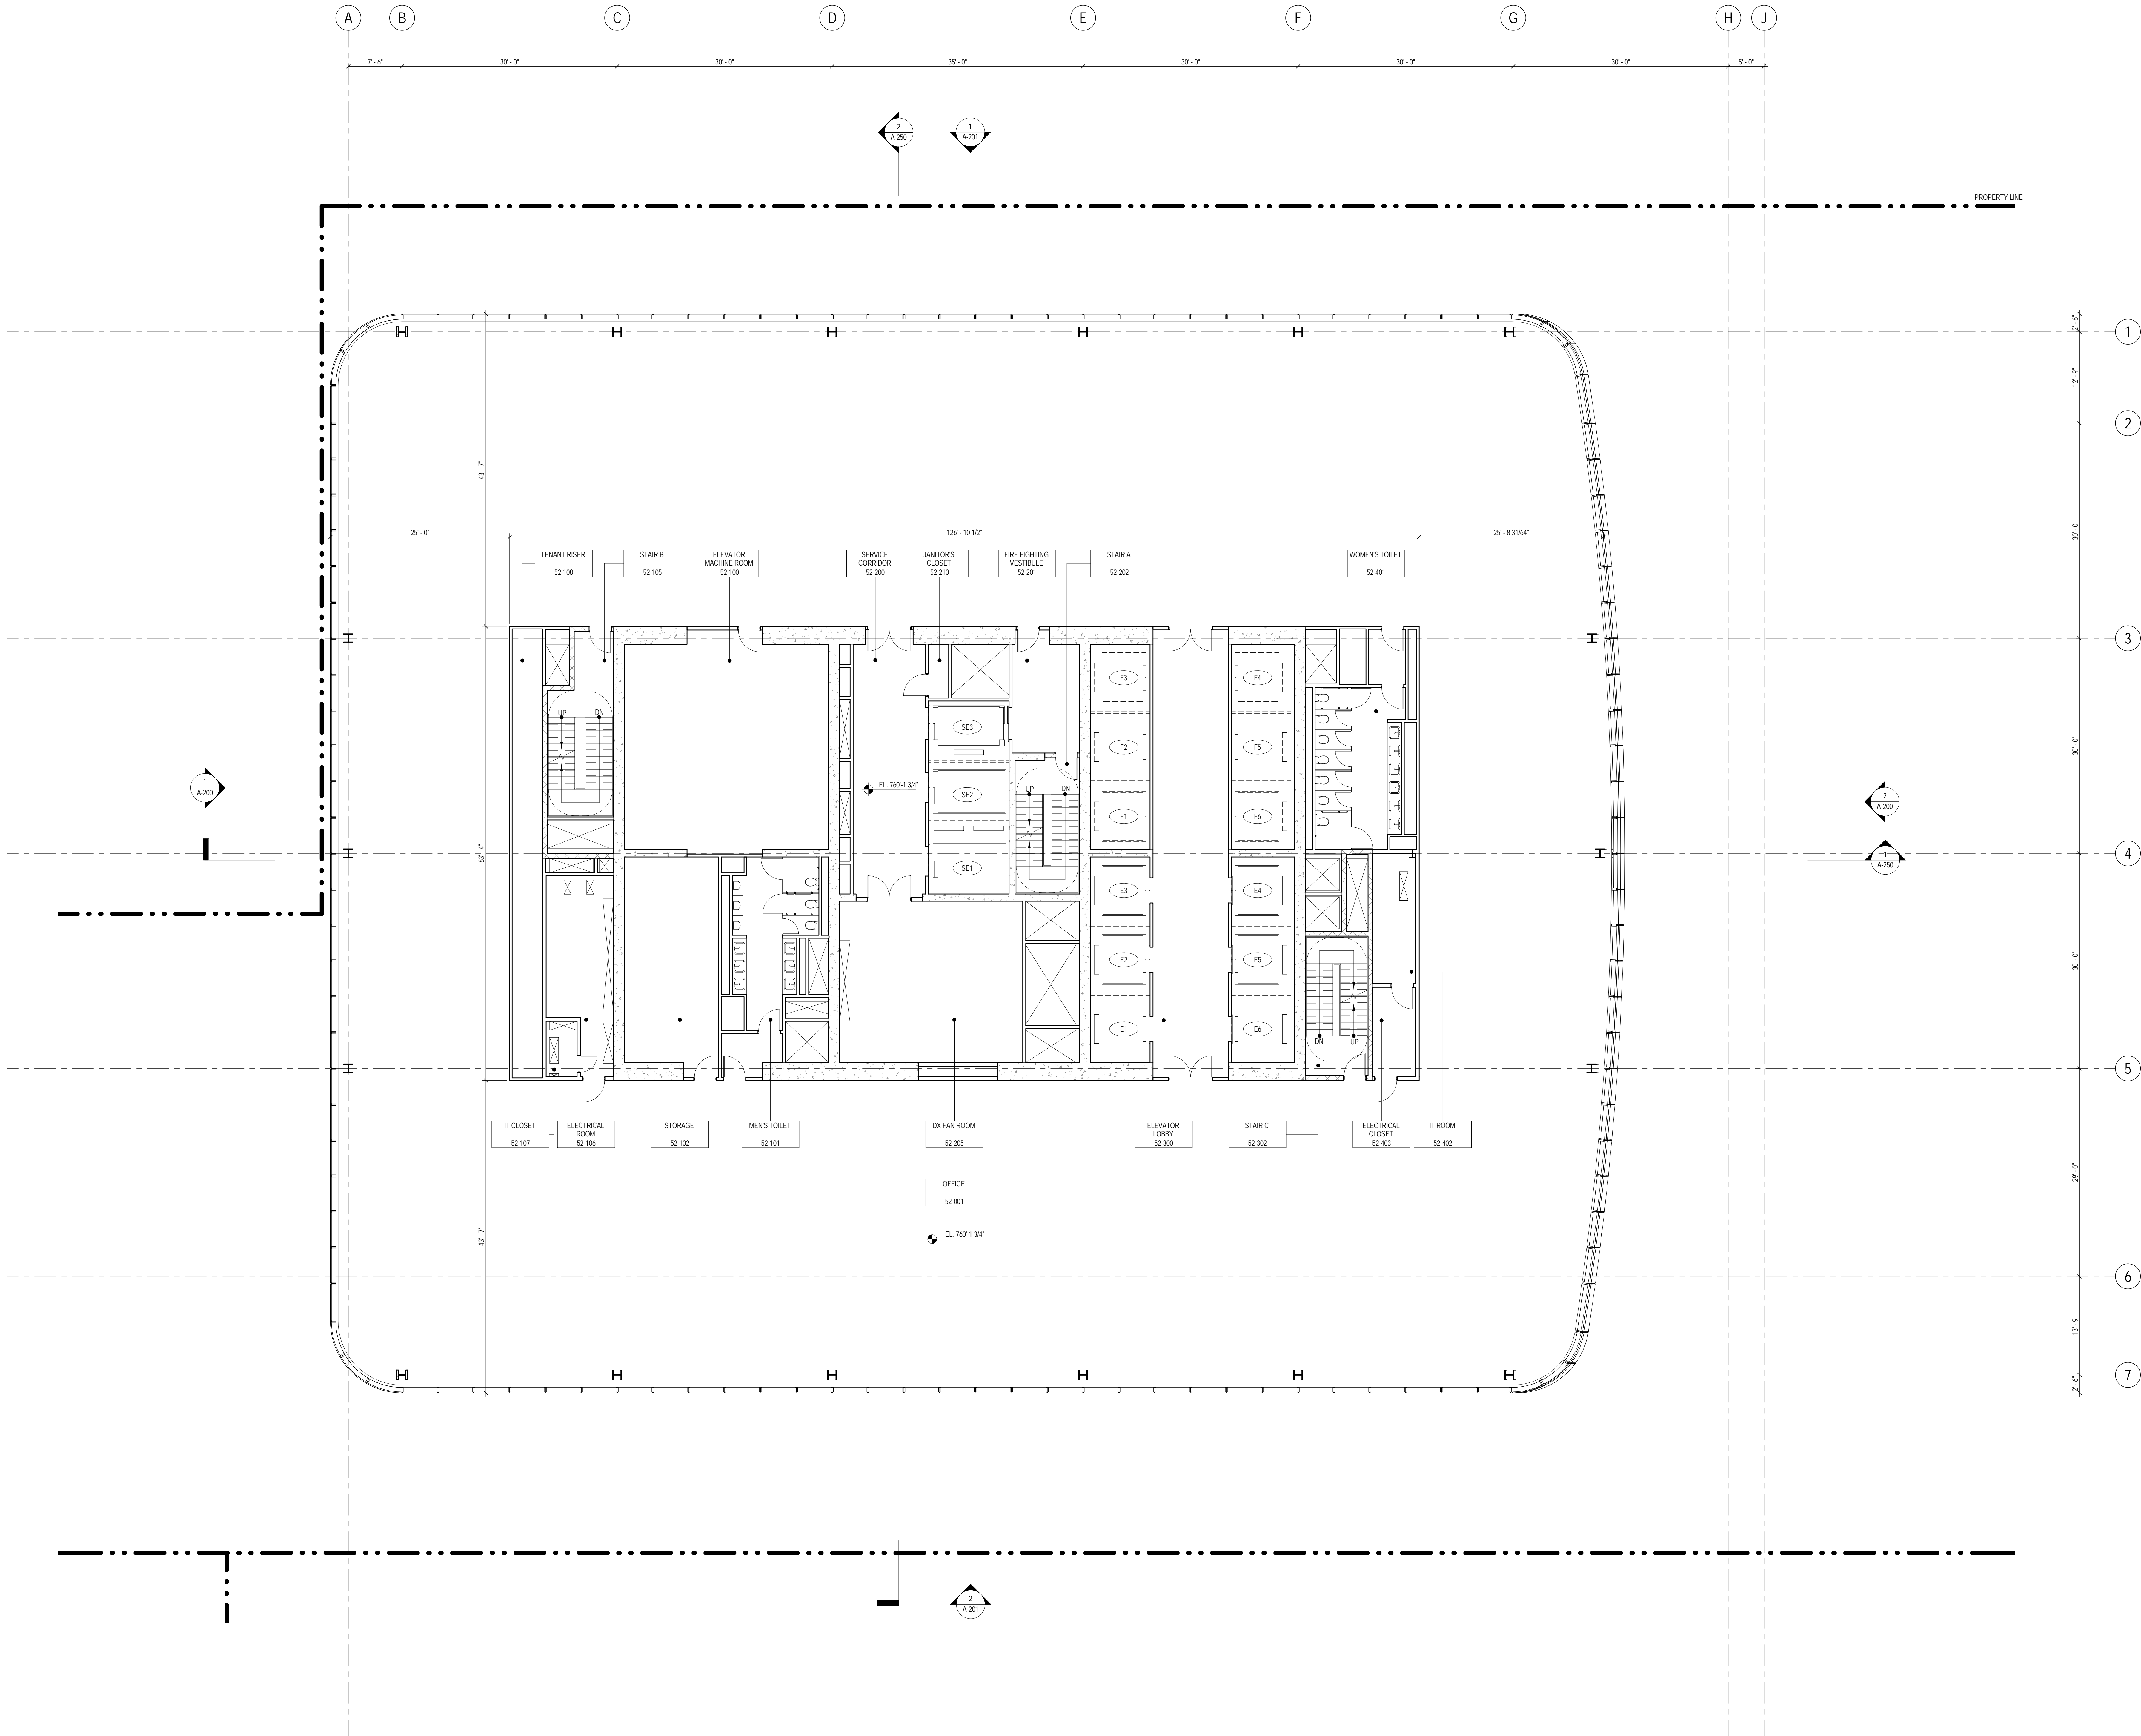

SHEET NOTES

1. ALL BUILDING ELEVATIONS (IN FEET) REFERENCED TO THE NORTH AMERICAN VERTICAL DATUM OF 1988 (NAV88).
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4. FOR ROOM FINISH SCHEDULE SEE A-700 SERIES DRAWINGS.
5. FOR DOOR SCHEDULE SEE A-700 SERIES DRAWINGS. FOR DOOR HARDWARE SPECIFICATION SEE TECHNICAL SPECIFICATION SECTION B5700.
6. FOR PARTITION TYPES SEE A-700 SERIES DRAWINGS.
7. ALL PARTITIONS SHALL BE TYPE DR UNO.
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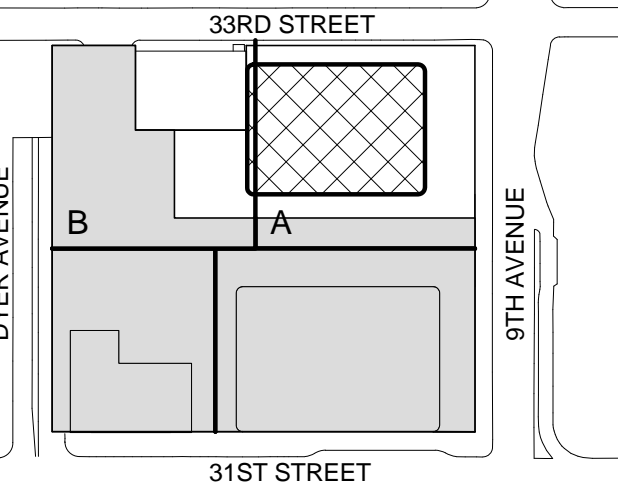
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No. Date Description
Sheet Name:

**LEVEL 52 FLOOR
PLAN - HIGH-RISE
EMR**

Project No.:

207150

Date:

20 JUN 2014

Scale:

1/8" = 1'-0"

File No.:

A-152

B-SCAN Sheet No.:


A-152.00

Sheet No.:

A-152

Page No.:

45 OF 87

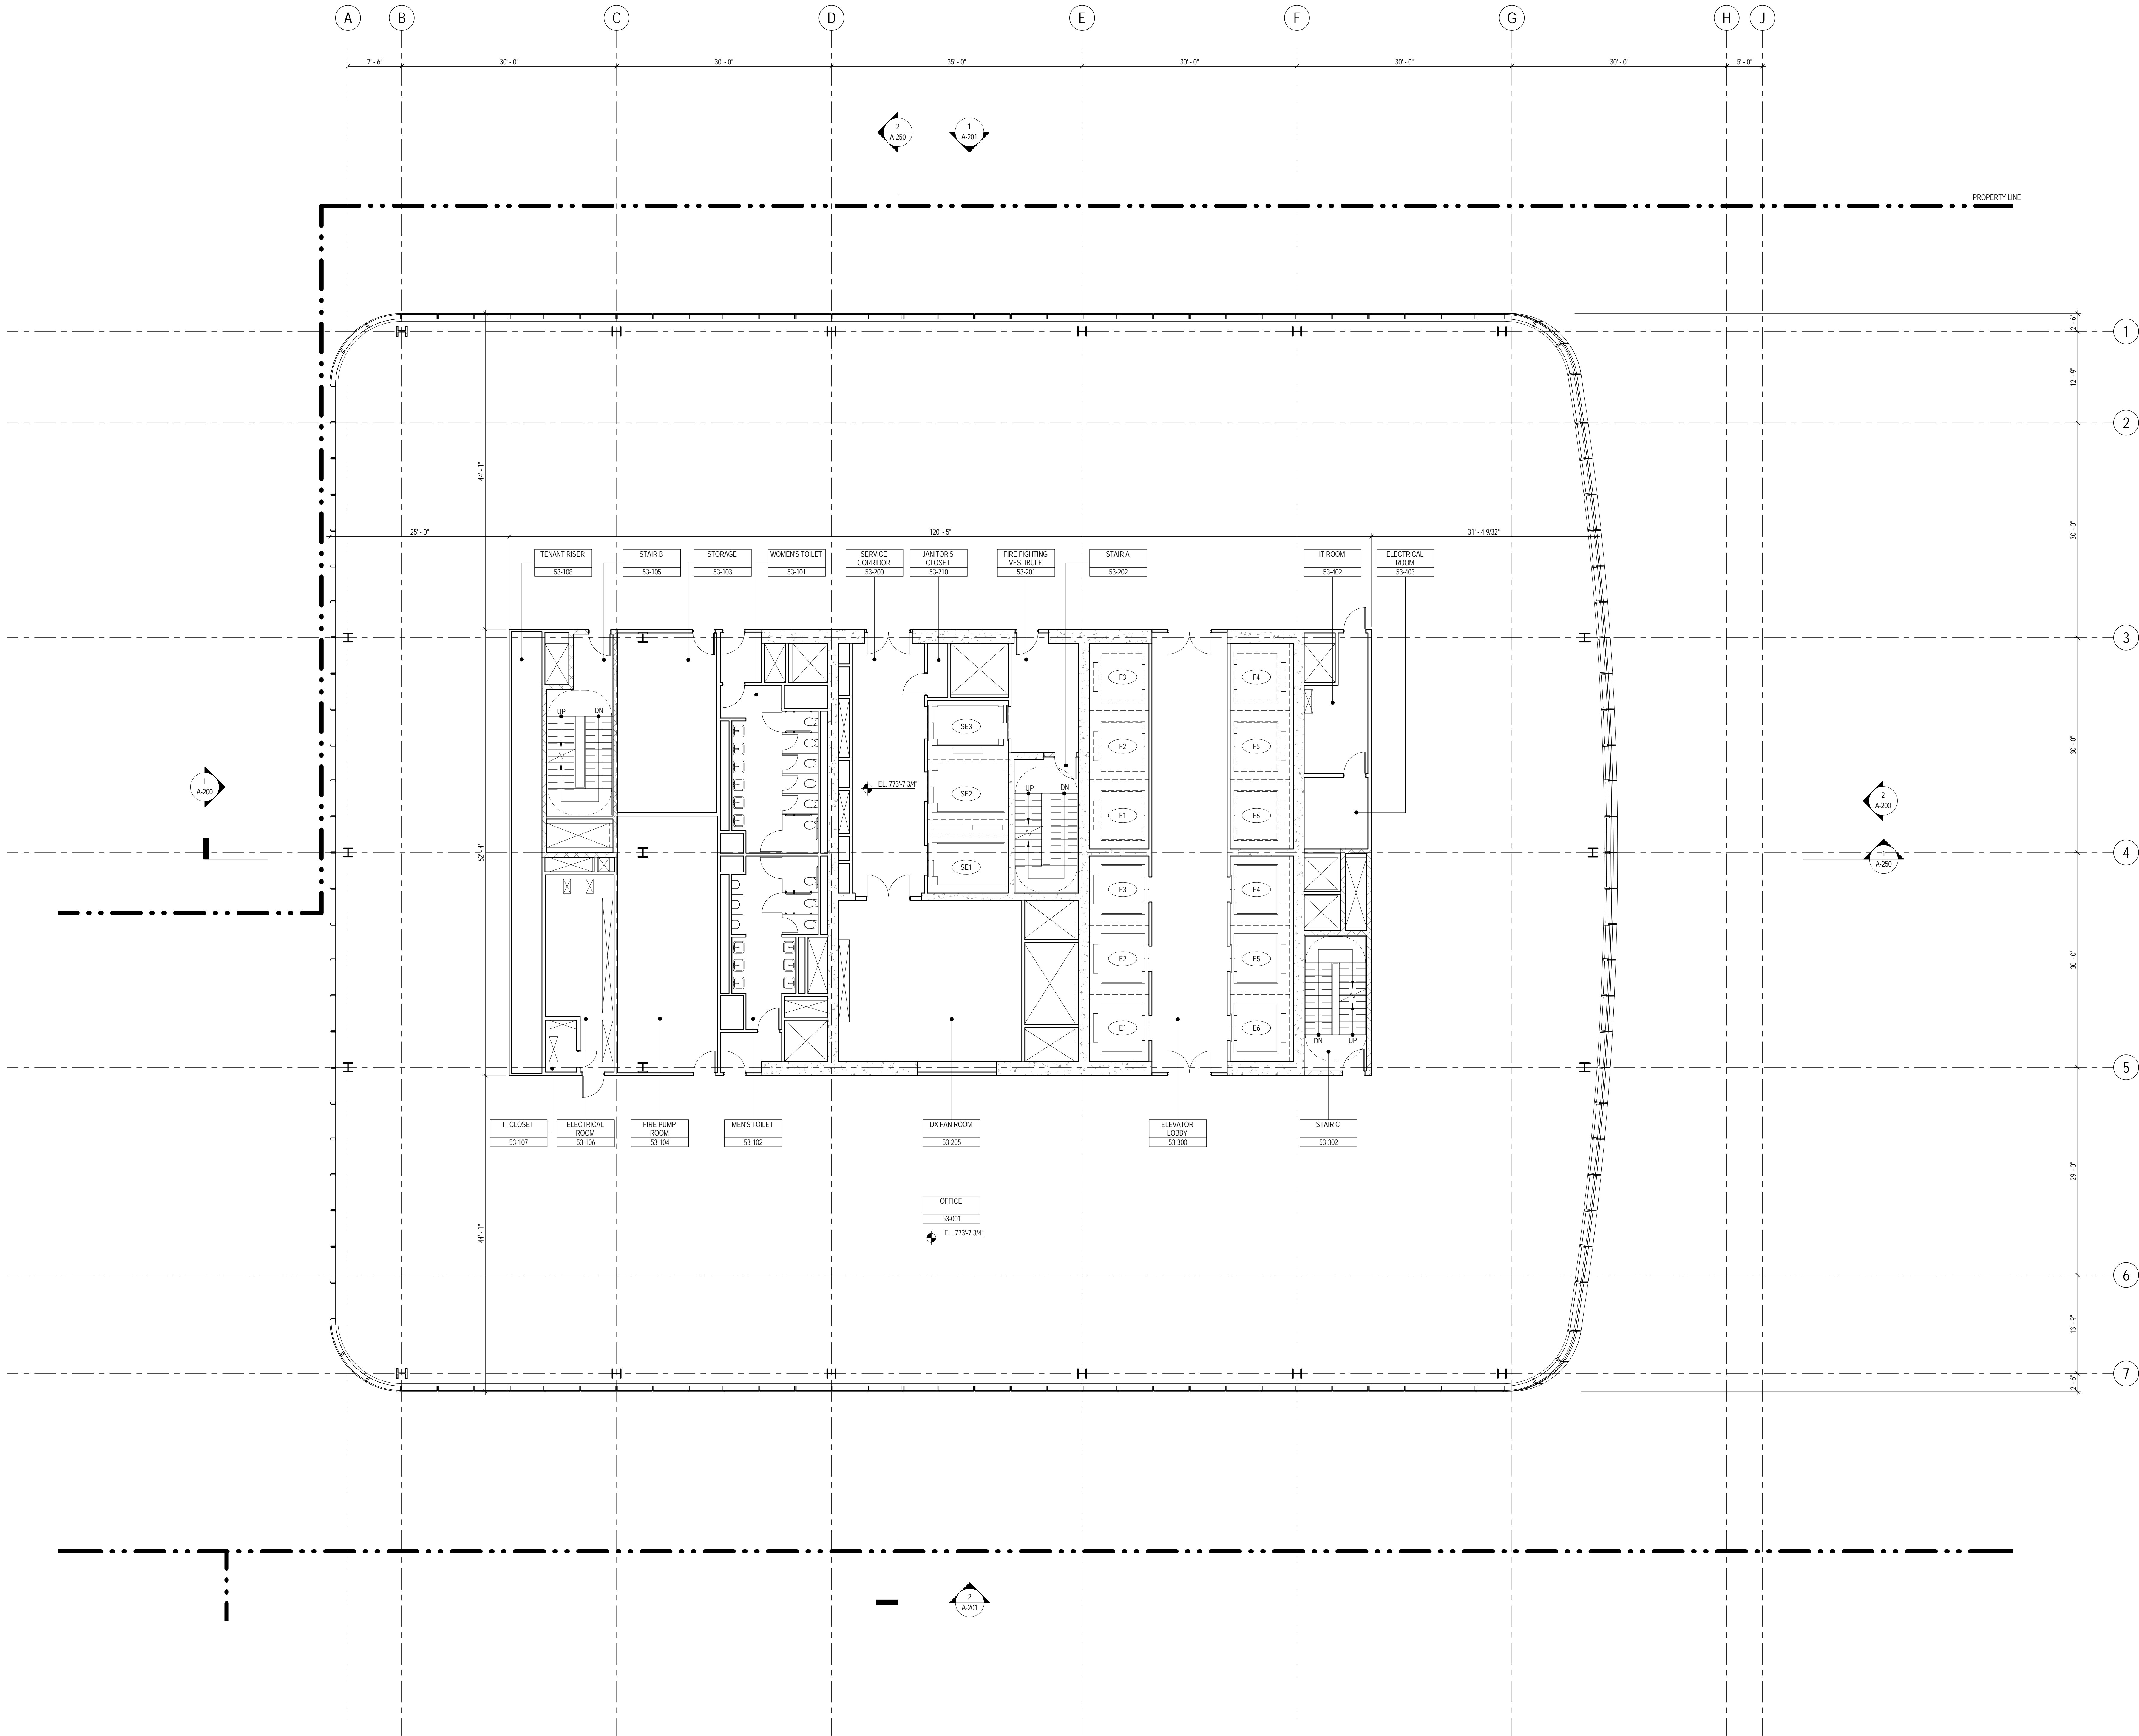

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5. FOR DOOR SCHEDULE SEE A-700 SERIES DRAWINGS. FOR DOOR FINISH SCHEDULE SEE A-700 SERIES DRAWINGS. SPECIFICATION SEE TECHNICAL SPECIFICATION SECTION 05200.
6. FOR PARTITION TYPES SEE A-700 SERIES DRAWINGS.
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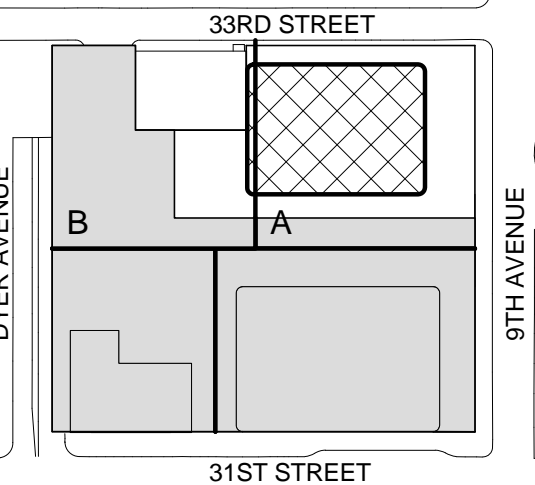
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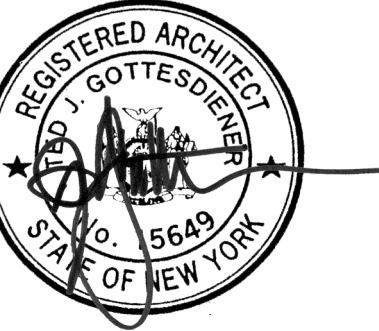
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2 12 JUL 2013 ISSUED FOR 90% DESIGN DEVELOPMENT
1 19 MAR 2012 ISSUED FOR RECONCILIATION

No. Date Description
Sheet Name:

**LEVEL 53 FLOOR
PLAN - HIGH-RISE
PUMP ROOM**

Project No.: 207150 B-SCAN Sheet No.: A-153.00

Date: 20 JUN 2014 Sheet No.: A-153

Scale: 1/8" = 1'-0" Sheet No.: A-153

File No.: A-153 Page No.: 46 OF 87

SHEET NOTES

1. ALL BUILDING ELEVATIONS (IN FEET) REFERENCED TO THE NORTH AMERICAN VERTICAL DATUM OF 1988 (NAV88).
2. FOR GENERAL NOTES, BUILDING DEPARTMENT NOTES, AND CLARIFICATION OF THE WORK NOTES REFER TO SHEET NO. G-005.
3. FOR ARCHITECTURAL ABBREVIATIONS, LEGEND OF SYMBOLS & MATERIALS, AND MOUNTING HEIGHTS REFER TO SHEET NO. G-006.
4. FOR ROOM FINISH SCHEDULE SEE A-700 SERIES DRAWINGS.
5. FOR DOOR SCHEDULE SEE A-700 SERIES DRAWINGS. FOR DOOR HARDWARE SPECIFICATION SEE TECHNICAL SPECIFICATION SECTION 08110.
6. FOR PARTITION TYPES SEE A-700 SERIES DRAWINGS.
7. ALL PARTITIONS SHALL BE TYPE OR UNO.
8. FOR REFLECTED CEILING PLANS SEE A-400 SERIES DRAWINGS. IF RCP IS NOT PROVIDED SEE MEPPH ASSECTED SERVICE DRAWINGS FOR LOCATIONS OR ALL CEILING WALL MOUNTED DEVICES.
9. FOR STRUCTURAL COLUMNS, EDGE OF SLAB, AND CORE WORK POINTS SEE STRUCTURAL SERIES DRAWINGS, UNO.
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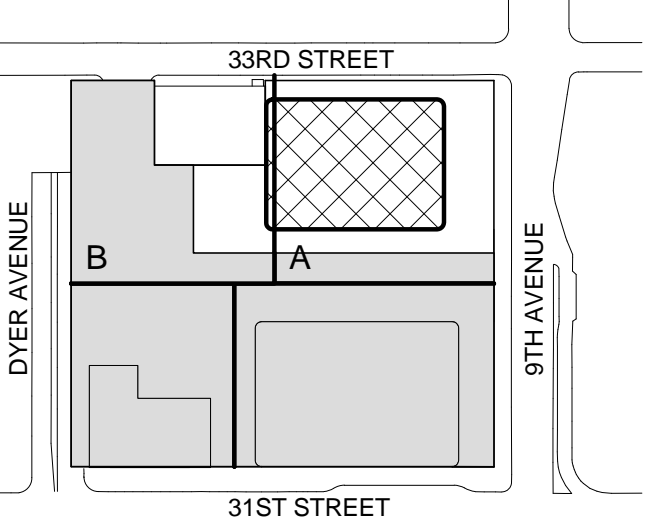
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1	19 MAR 2012	ISSUED FOR RECONCILIATION

No. Date Description

Sheet Name:

LEVEL 54 FLOOR
PLAN - HIGH-RISE
WATER TANK

Project No.:

207150

Date:

20 JUN 2014

Scale:

1/8" = 1'-0"

File No.:

A-154

B-SCAN Sheet No.:


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Sheet No.:

A-154

Page No.:

47 OF 87

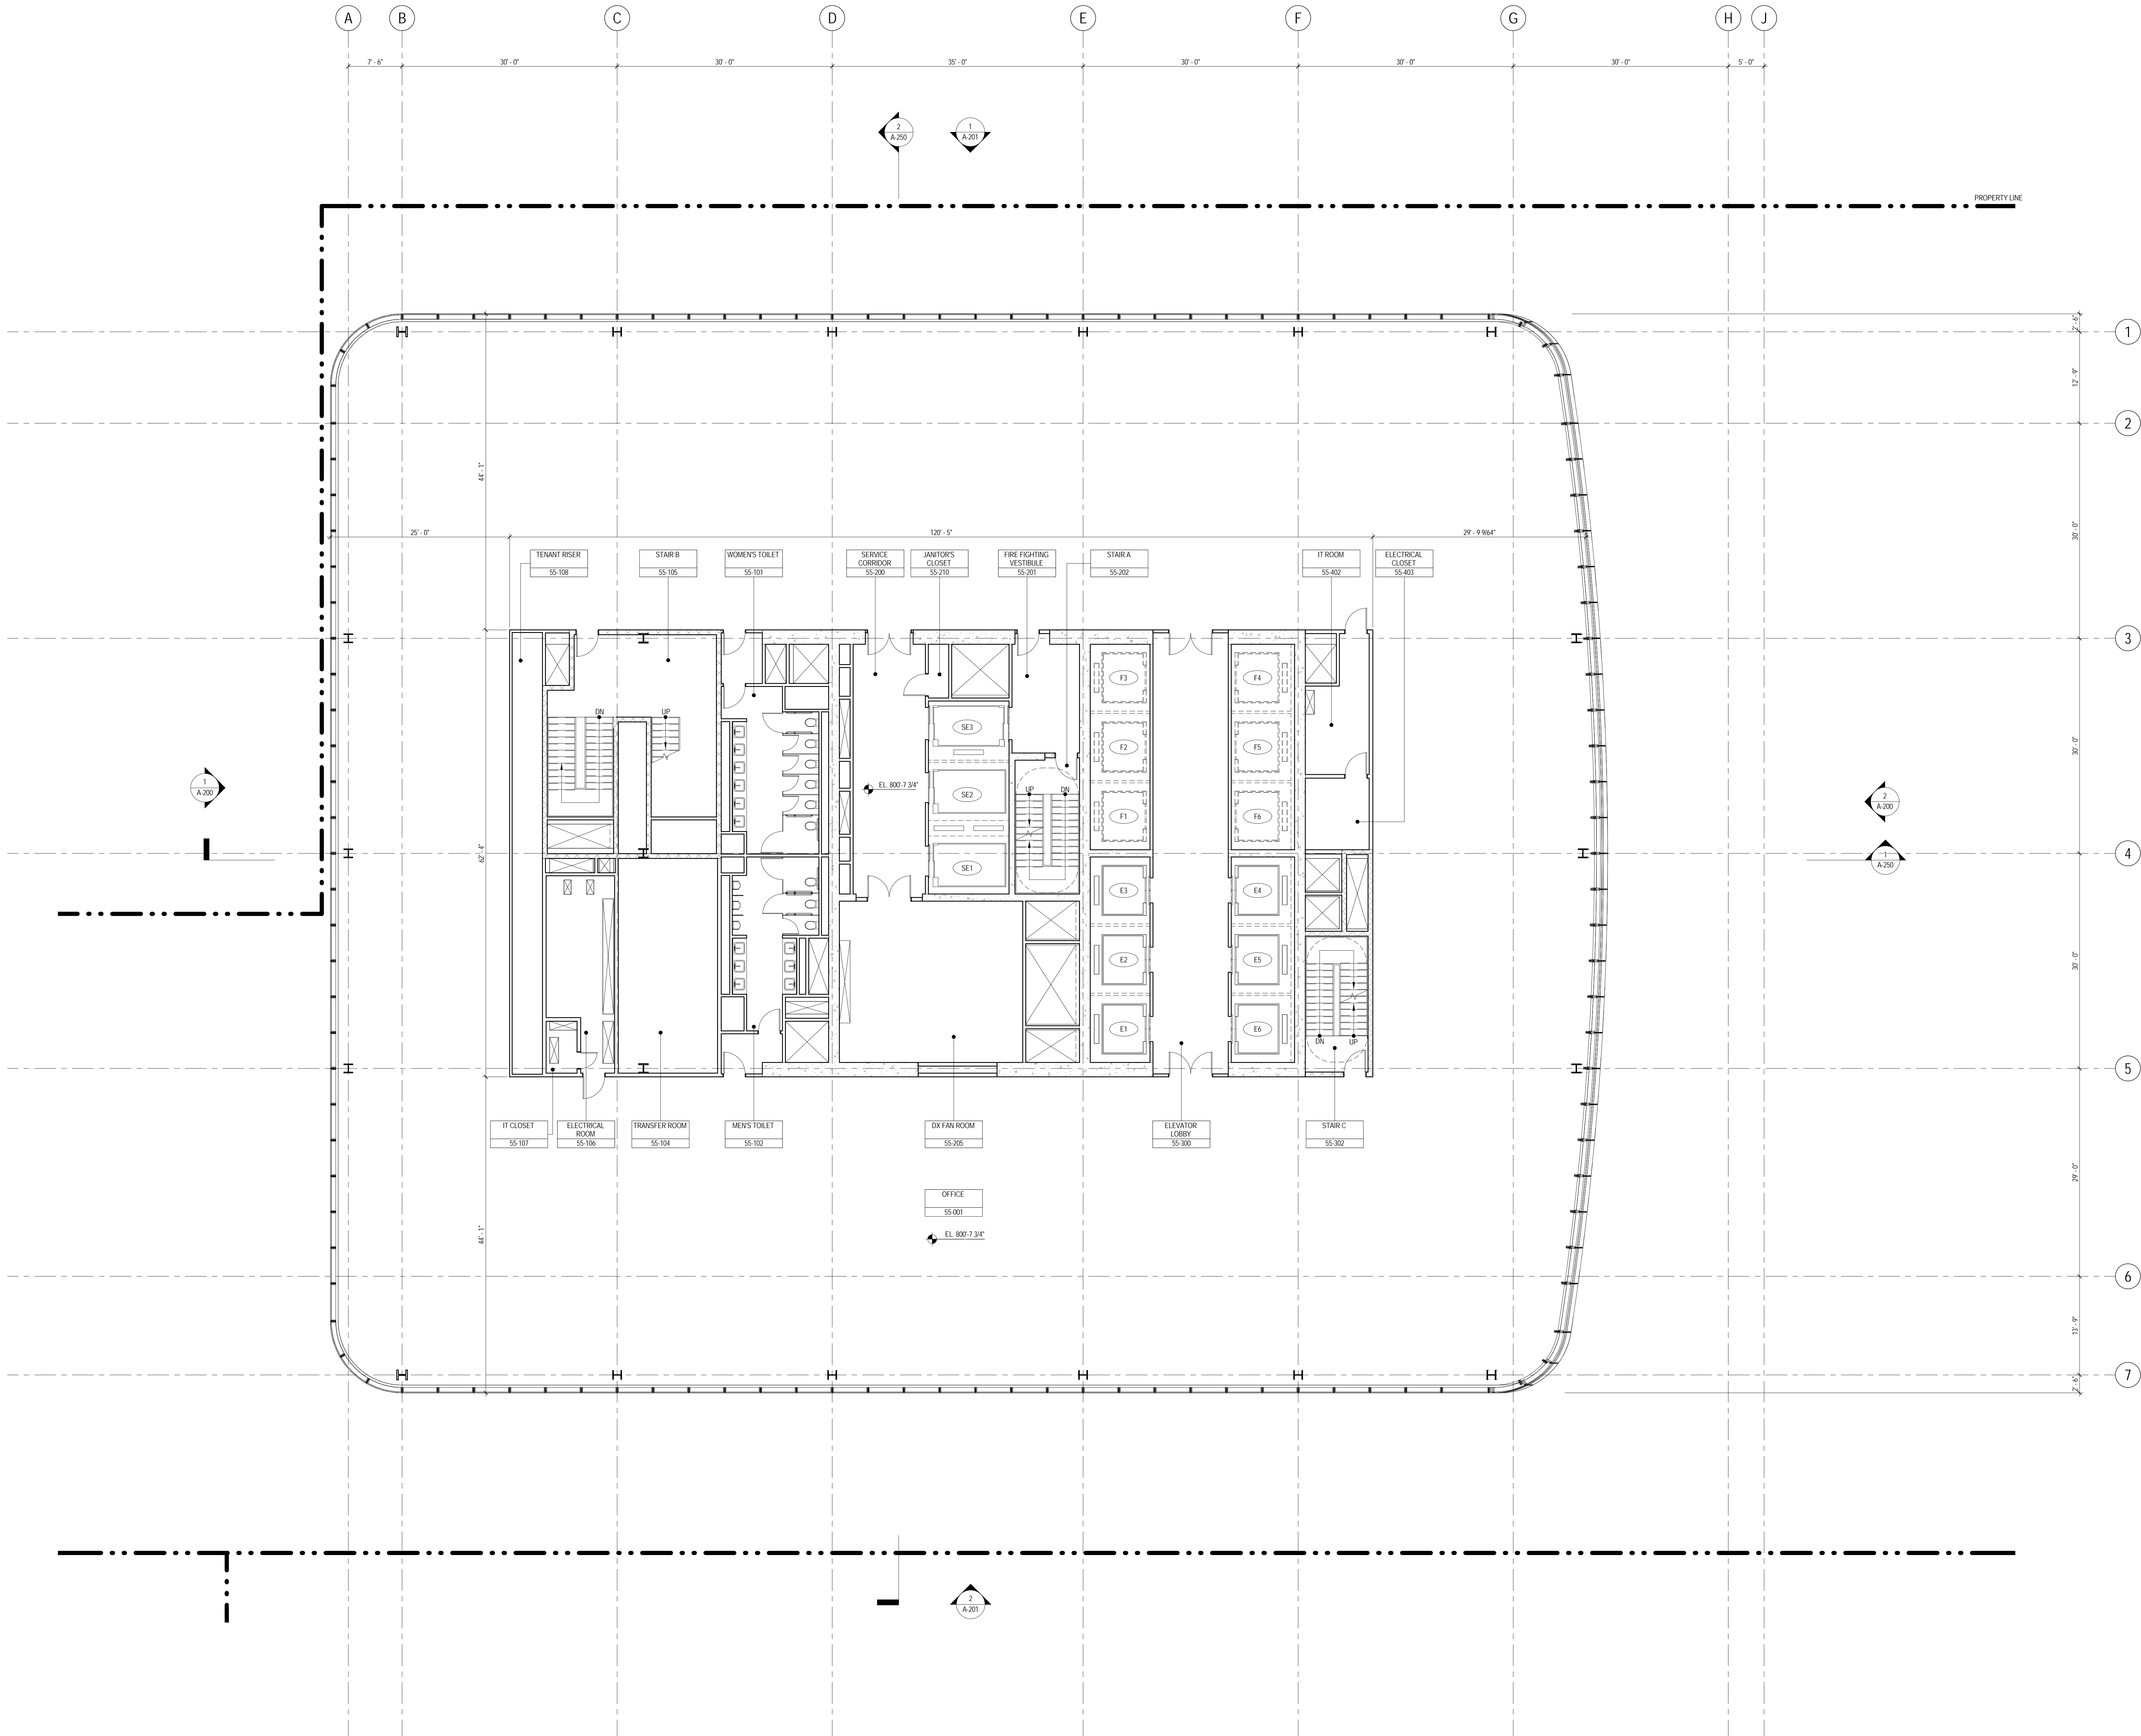

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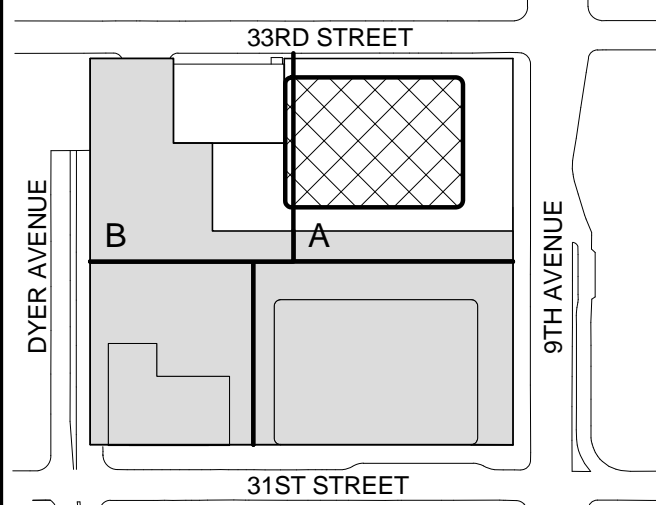
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Sheet Name:

**LEVEL 55 FLOOR
PLAN - HIGH-RISE**

Project No.: 207150	B-SCAN Sheet No.: A-155.00
Date: 20 JUN 2014	Sheet No.: A-155
Scale: 1/8" = 1'-0"	Page No.: 48 OF 87
File No.: A-155	

SHEET NOTES

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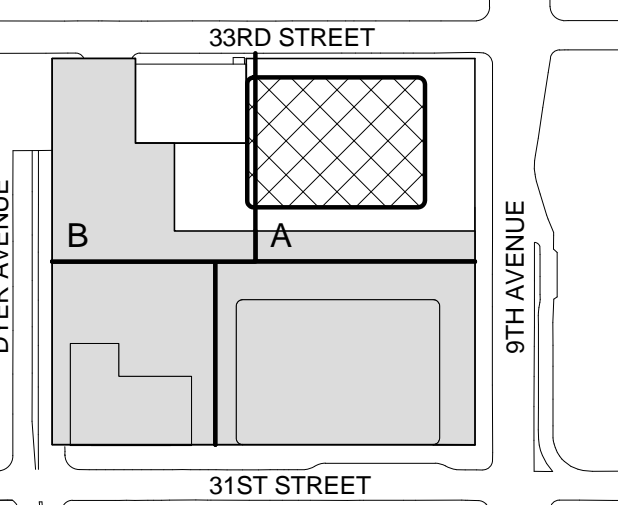
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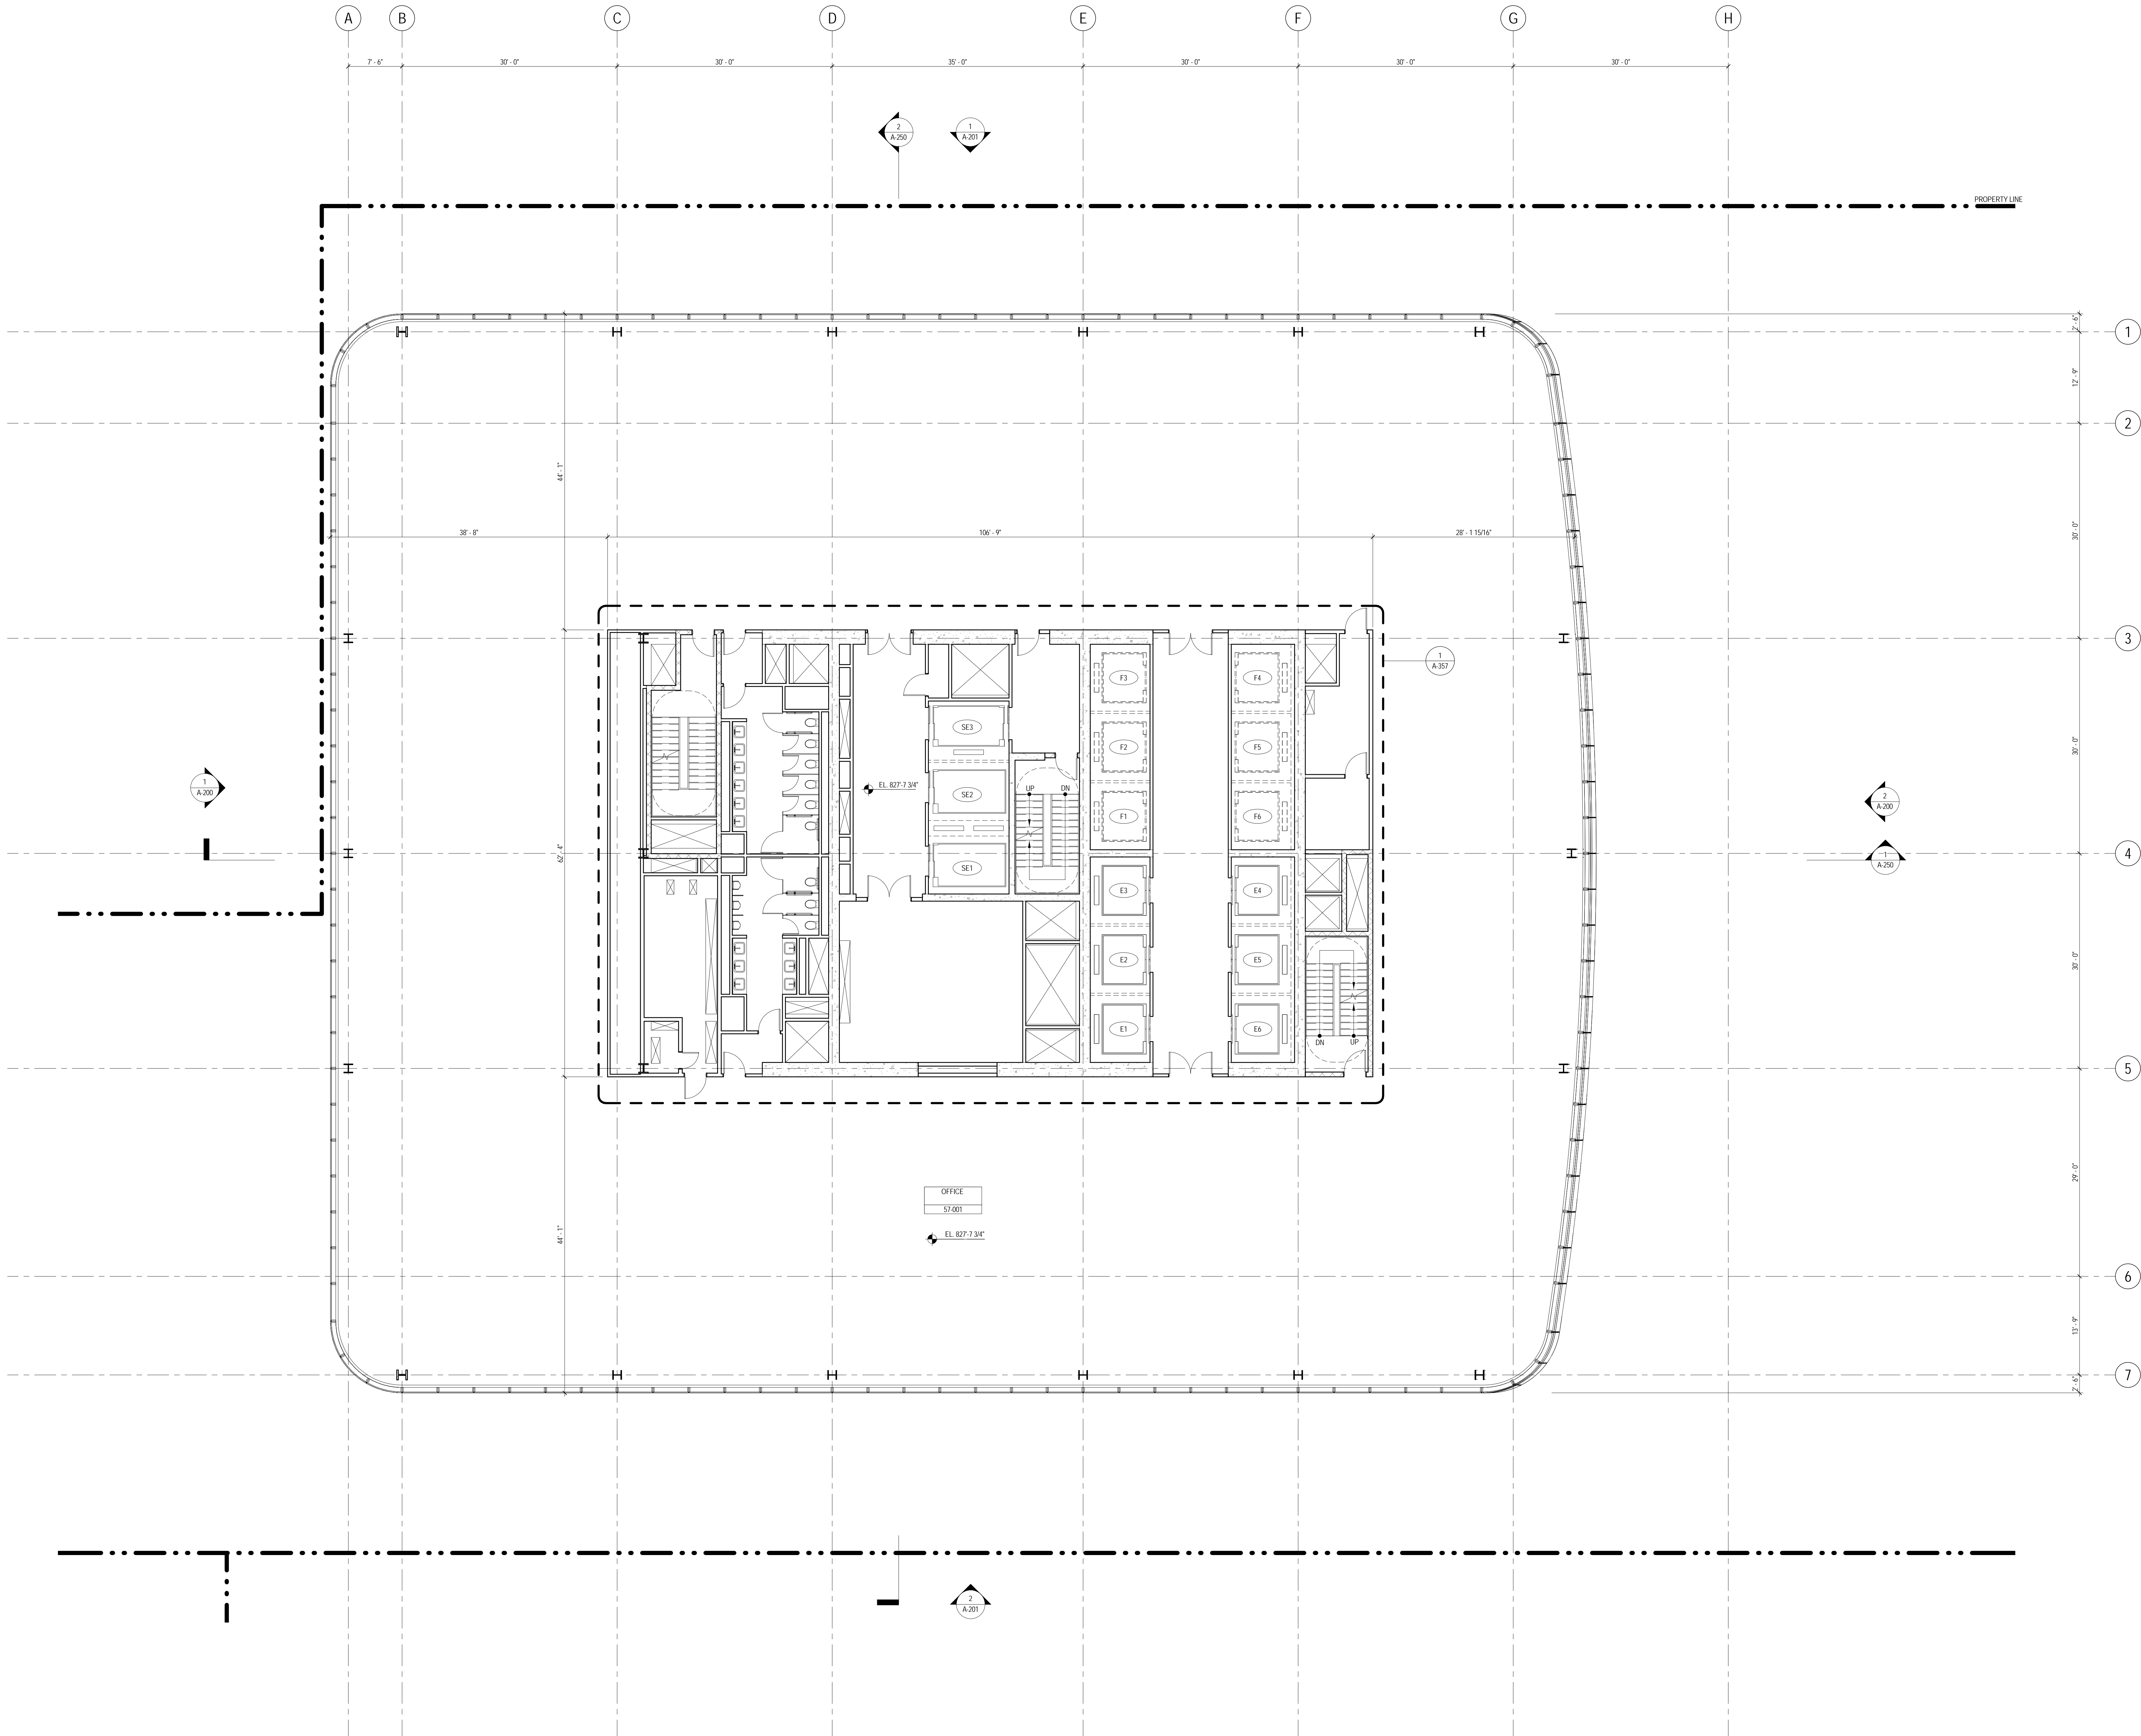
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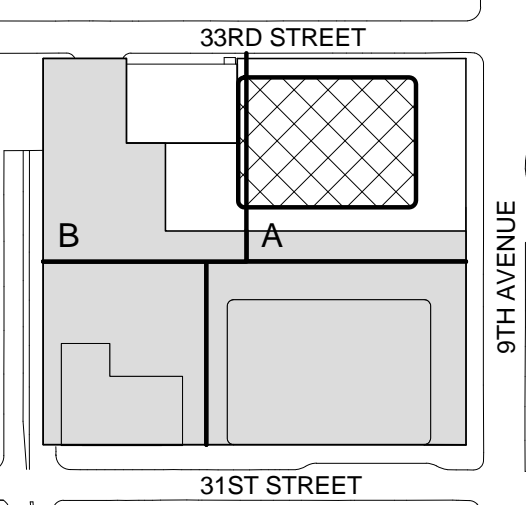
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| 4 | 20 JUN 2014 | ISSUED FOR FOUNDATION BID |
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| 2 | 20 DEC 2013 | ISSUED FOR FOUNDATION PERMIT |
| 1 | 18 NOV 2013 | ISSUED FOR 3D PROGRESS PRICING |

No. Date Description

Sheet Name:

**LEVEL 57-58
FLOOR PLAN -
TYPICAL
HIGH-RISE**

Project No.: 207150

Date: 20 JUN 2014

Scale: 1/8" = 1'-0"

File No.: A-157

B-SCAN Sheet No.:

A-157.00

Sheet No.:

A-157

Page No.: 50 OF 87

SHEET NOTES

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4. FOR ROOM FINISH SCHEDULE SEE A-700 SERIES DRAWINGS.
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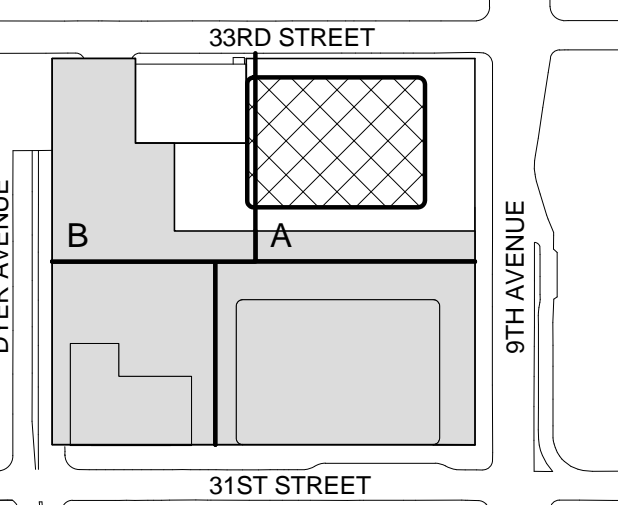
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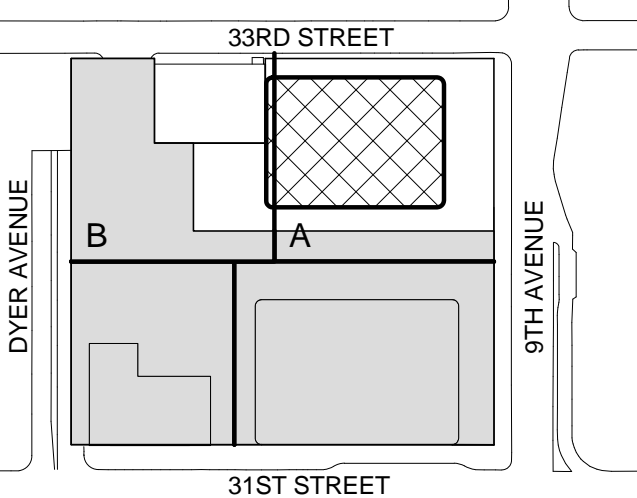
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No. Date Description
Sheet Name:

LEVEL 60-61
FLOOR PLAN -
HIGH-RISE
OVERRUN

Project No.:

Date:

Scale:

File No.:


B-SCAN Sheet No.:

A-160.00

Sheet No.:

A-160

Page No. 52 OF 87

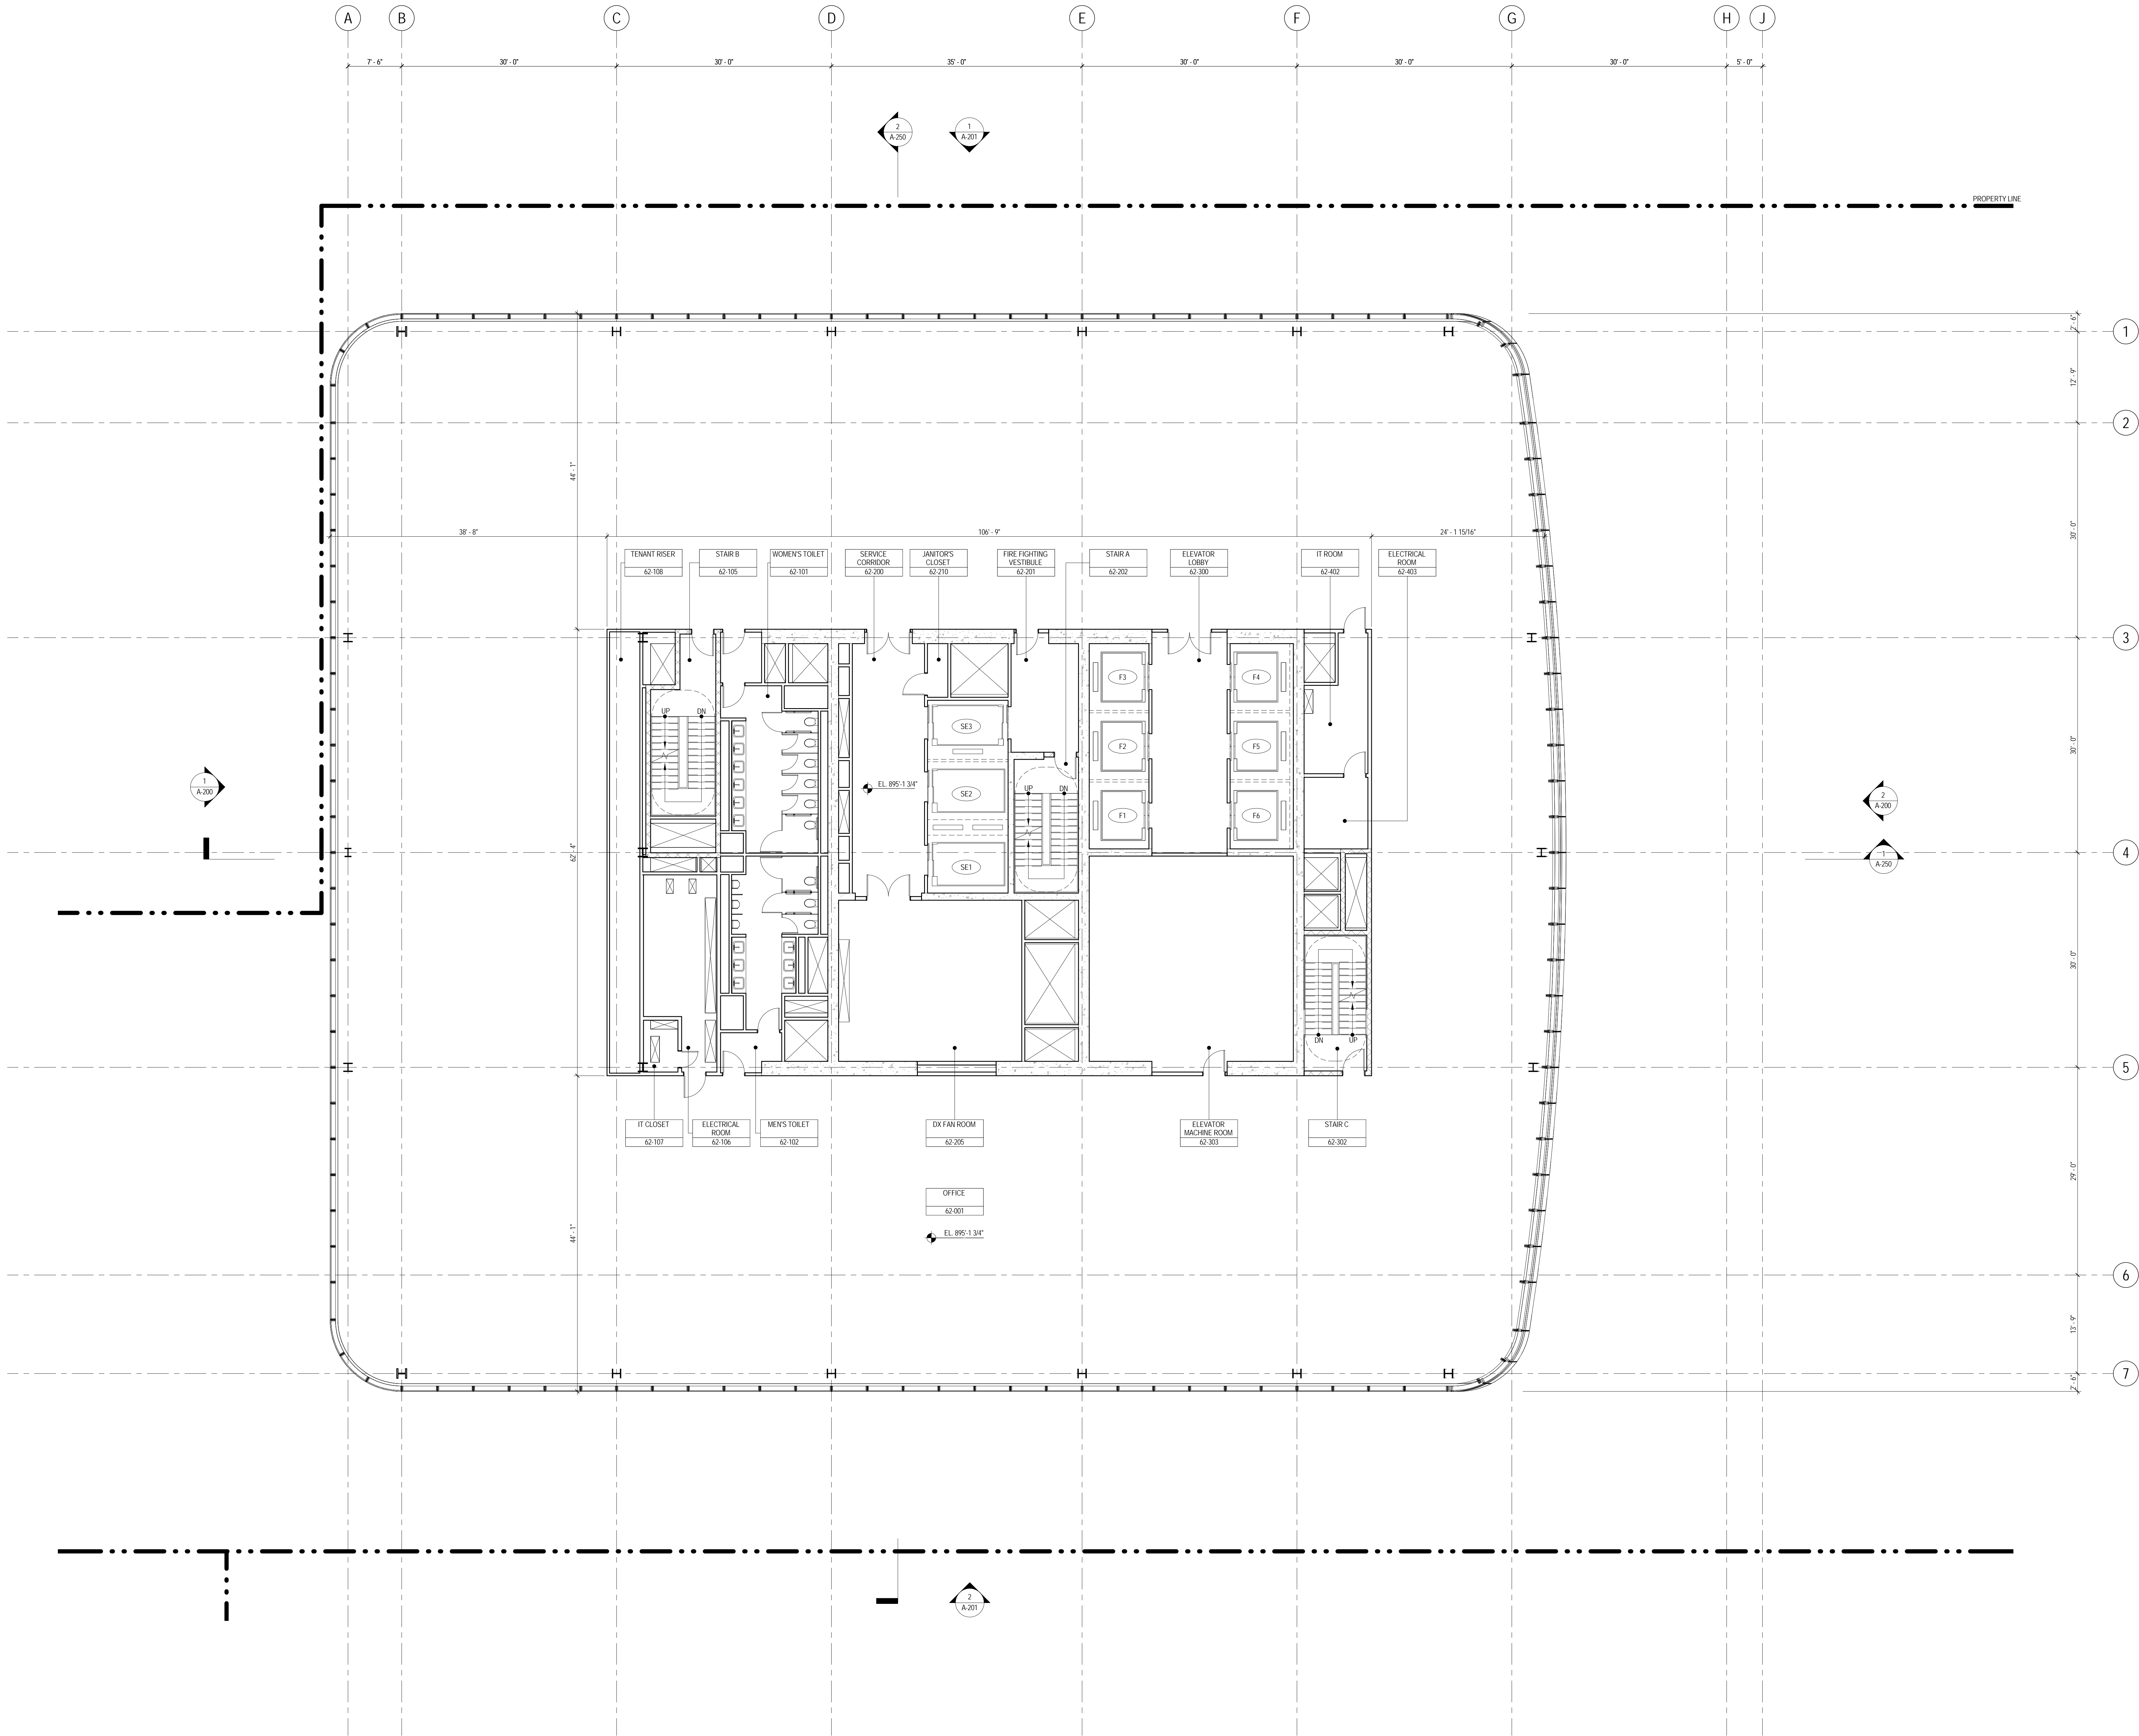

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5. FOR DOOR SCHEDULE SEE A 700 SERIES DRAWINGS. FOR DOOR HARDWARE SPECIFICATION SEE TECHNICAL SPECIFICATION SECTION (05100).
6. FOR PARTITION TYPES SEE A 700 SERIES DRAWINGS.
7. ALL PARTITIONS SHALL BE TYPE DR, LND.
8. FOR REFLECTED CEILING PLANS SEE A 600 SERIES DRAWINGS. IF RCP IS NOT PROVIDED SEE MEP/FIT/ASC/ITEL SERVICE DRAWINGS FOR LOCATIONS OR ALL CEILING/WALL MOUNTED DEVICES.
9. FOR STRUCTURAL COLUMNS, EDGE OF SLAB, AND CORE WORK POINTS SEE STRUCTURAL SERIES DRAWINGS, LND.
10. REFER TO STRUCTURAL SERIES DRAWINGS FOR ALL STRUCTURAL WALL DESIGNATIONS AND DIMENSIONS.
11. REFER TO MEP/FIT/ASC/ITEL SERVICE DRAWINGS FOR ALL MECHANICAL, ELECTRICAL, PLUMBING AND FIRE PROTECTION ROOM, RISER AND EQUIPMENT DESIGNATIONS.
12. FOR PROJECT WORK POINT REFER TO A 000 SERIES DRAWINGS.



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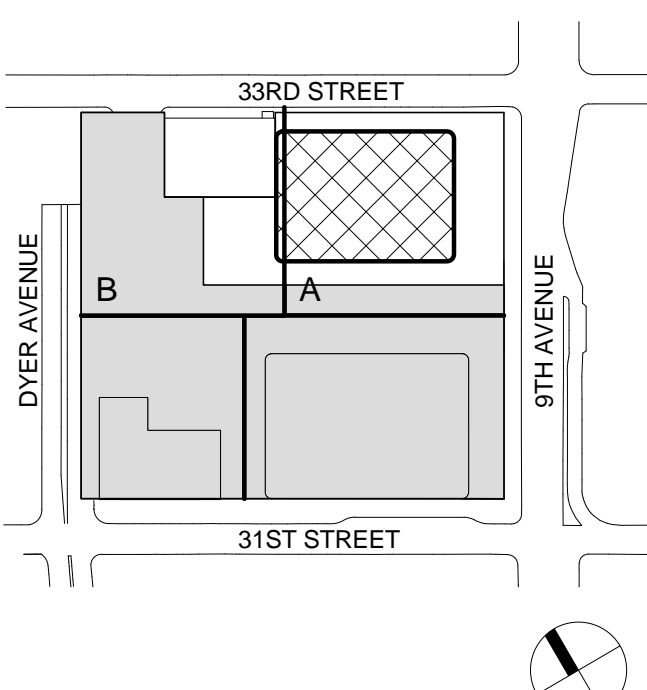
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Wind Tunnel Consultant
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1	19 MAR 2012	ISSUED FOR RECONCILIATION

No. Date Description
Sheet Name:

**LEVEL 62 FLOOR
PLAN - HIGH-RISE
EMR**

Project No.: 207150	B-SCAN Sheet No.: A-162.00
Date: 20 JUN 2014	Sheet No.: A-162
Scale: 1/8" = 1'-0"	Page No.: 53 OF 87
File No.: A-162	

SHEET NOTES

1. ALL BUILDING ELEVATIONS (IN FEET) REFERENCED TO THE NORTH AMERICAN VERTICAL DATUM OF 1988 (NAV88).
2. FOR GENERAL NOTES, BUILDING DEPARTMENT NOTES, AND CLARIFICATION OF THE WORK NOTES REFER TO SHEET NO. G-05.
3. FOR ARCHITECTURAL ABBREVIATIONS, LEGEND OF SYMBOLS & MATERIALS, AND MOUNTING HEIGHTS REFER TO SHEET NO. C-005.
4. FOR ROOM FINISH SCHEDULE SEE A-700 SERIES DRAWINGS.
5. FOR DOOR SCHEDULE SEE A-700 SERIES DRAWINGS. FOR DOOR HARDWARE SPECIFICATION SEE TECHNICAL SPECIFICATION SECTION (B-700).
6. FOR PARTITION TYPES SEE A-700 SERIES DRAWINGS.
7. ALL PARTITIONS SHALL BE TYPE DR UNO.
8. FOR REFLECTED CEILING PLANS SEE A-800 SERIES DRAWINGS. IF RCP IS NOT PROVIDED SEE MEP PHASE C (TEL. SERVICE) DRAWINGS FOR LOCATIONS OR ALL CEILING WALL MOUNTED DEVICES.
9. FOR STRUCTURAL COLUMNS, EDGE OF SLAB, AND CORE WORK POINTS SEE STRUCTURAL SERIES DRAWINGS, UNO.
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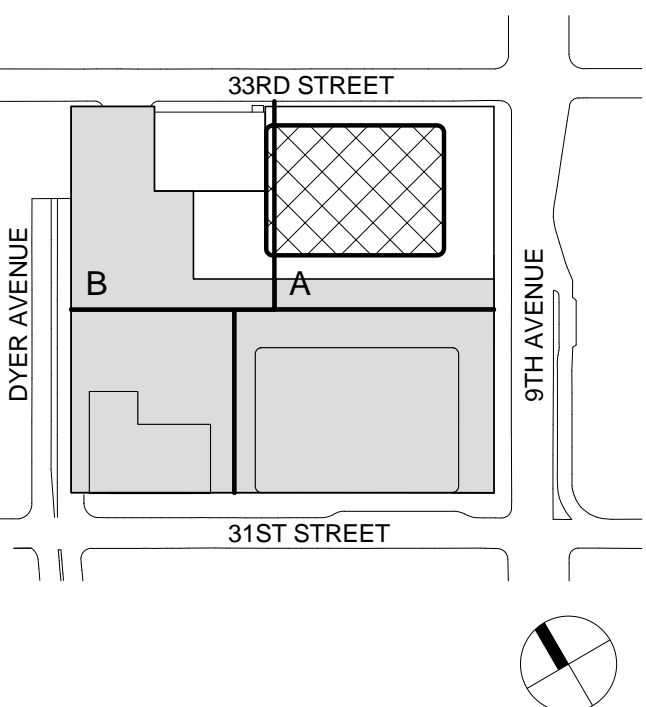
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4. FOR ROOM FINISH SCHEDULE SEE A-700 SERIES DRAWINGS.
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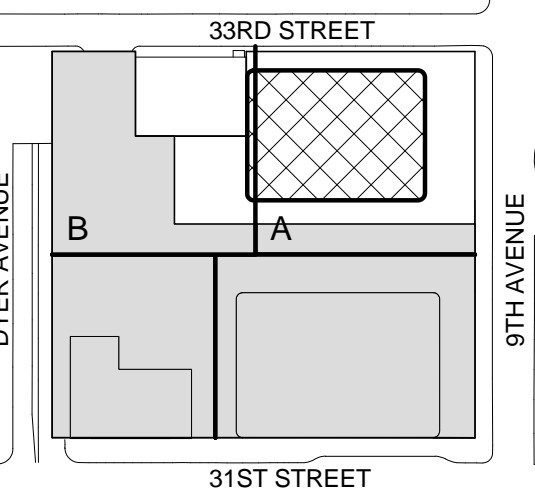
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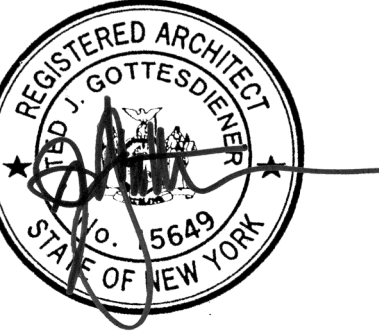
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1	19 MAR 2012	ISSUED FOR RECONCILIATION

No. Date Description
Sheet Name:

LEVEL 64-67
FLOOR PLAN -
TYPICAL
HIGH-RISE

Project No.:

207150

Date:

20 JUN 2014

Scale:

1/8" = 1'-0"

File No.:

A-164

B-SCAN Sheet No.:


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Sheet No.:

A-164

Page No.:

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SHEET NOTES

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4. FOR ROOM FINISH SCHEDULE SEE A-700 SERIES DRAWINGS.
5. FOR DOOR SCHEDULE SEE A-700 SERIES DRAWINGS. FOR DOOR HARDWARE SPECIFICATION SEE TECHNICAL SPECIFICATION SECTION 087010.
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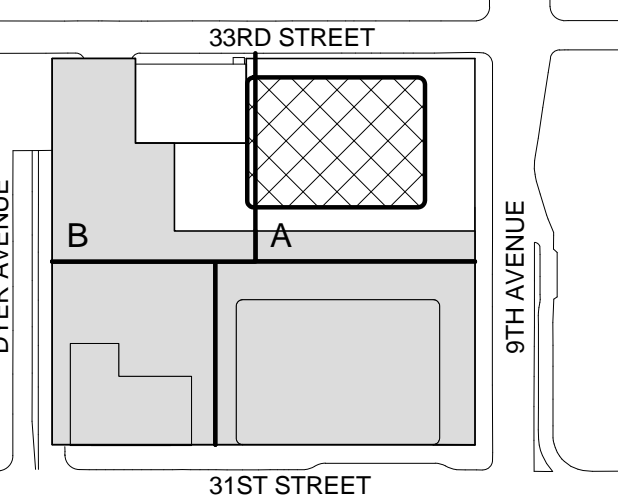
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1	19 MAR 2012	ISSUED FOR RECONCILIATION

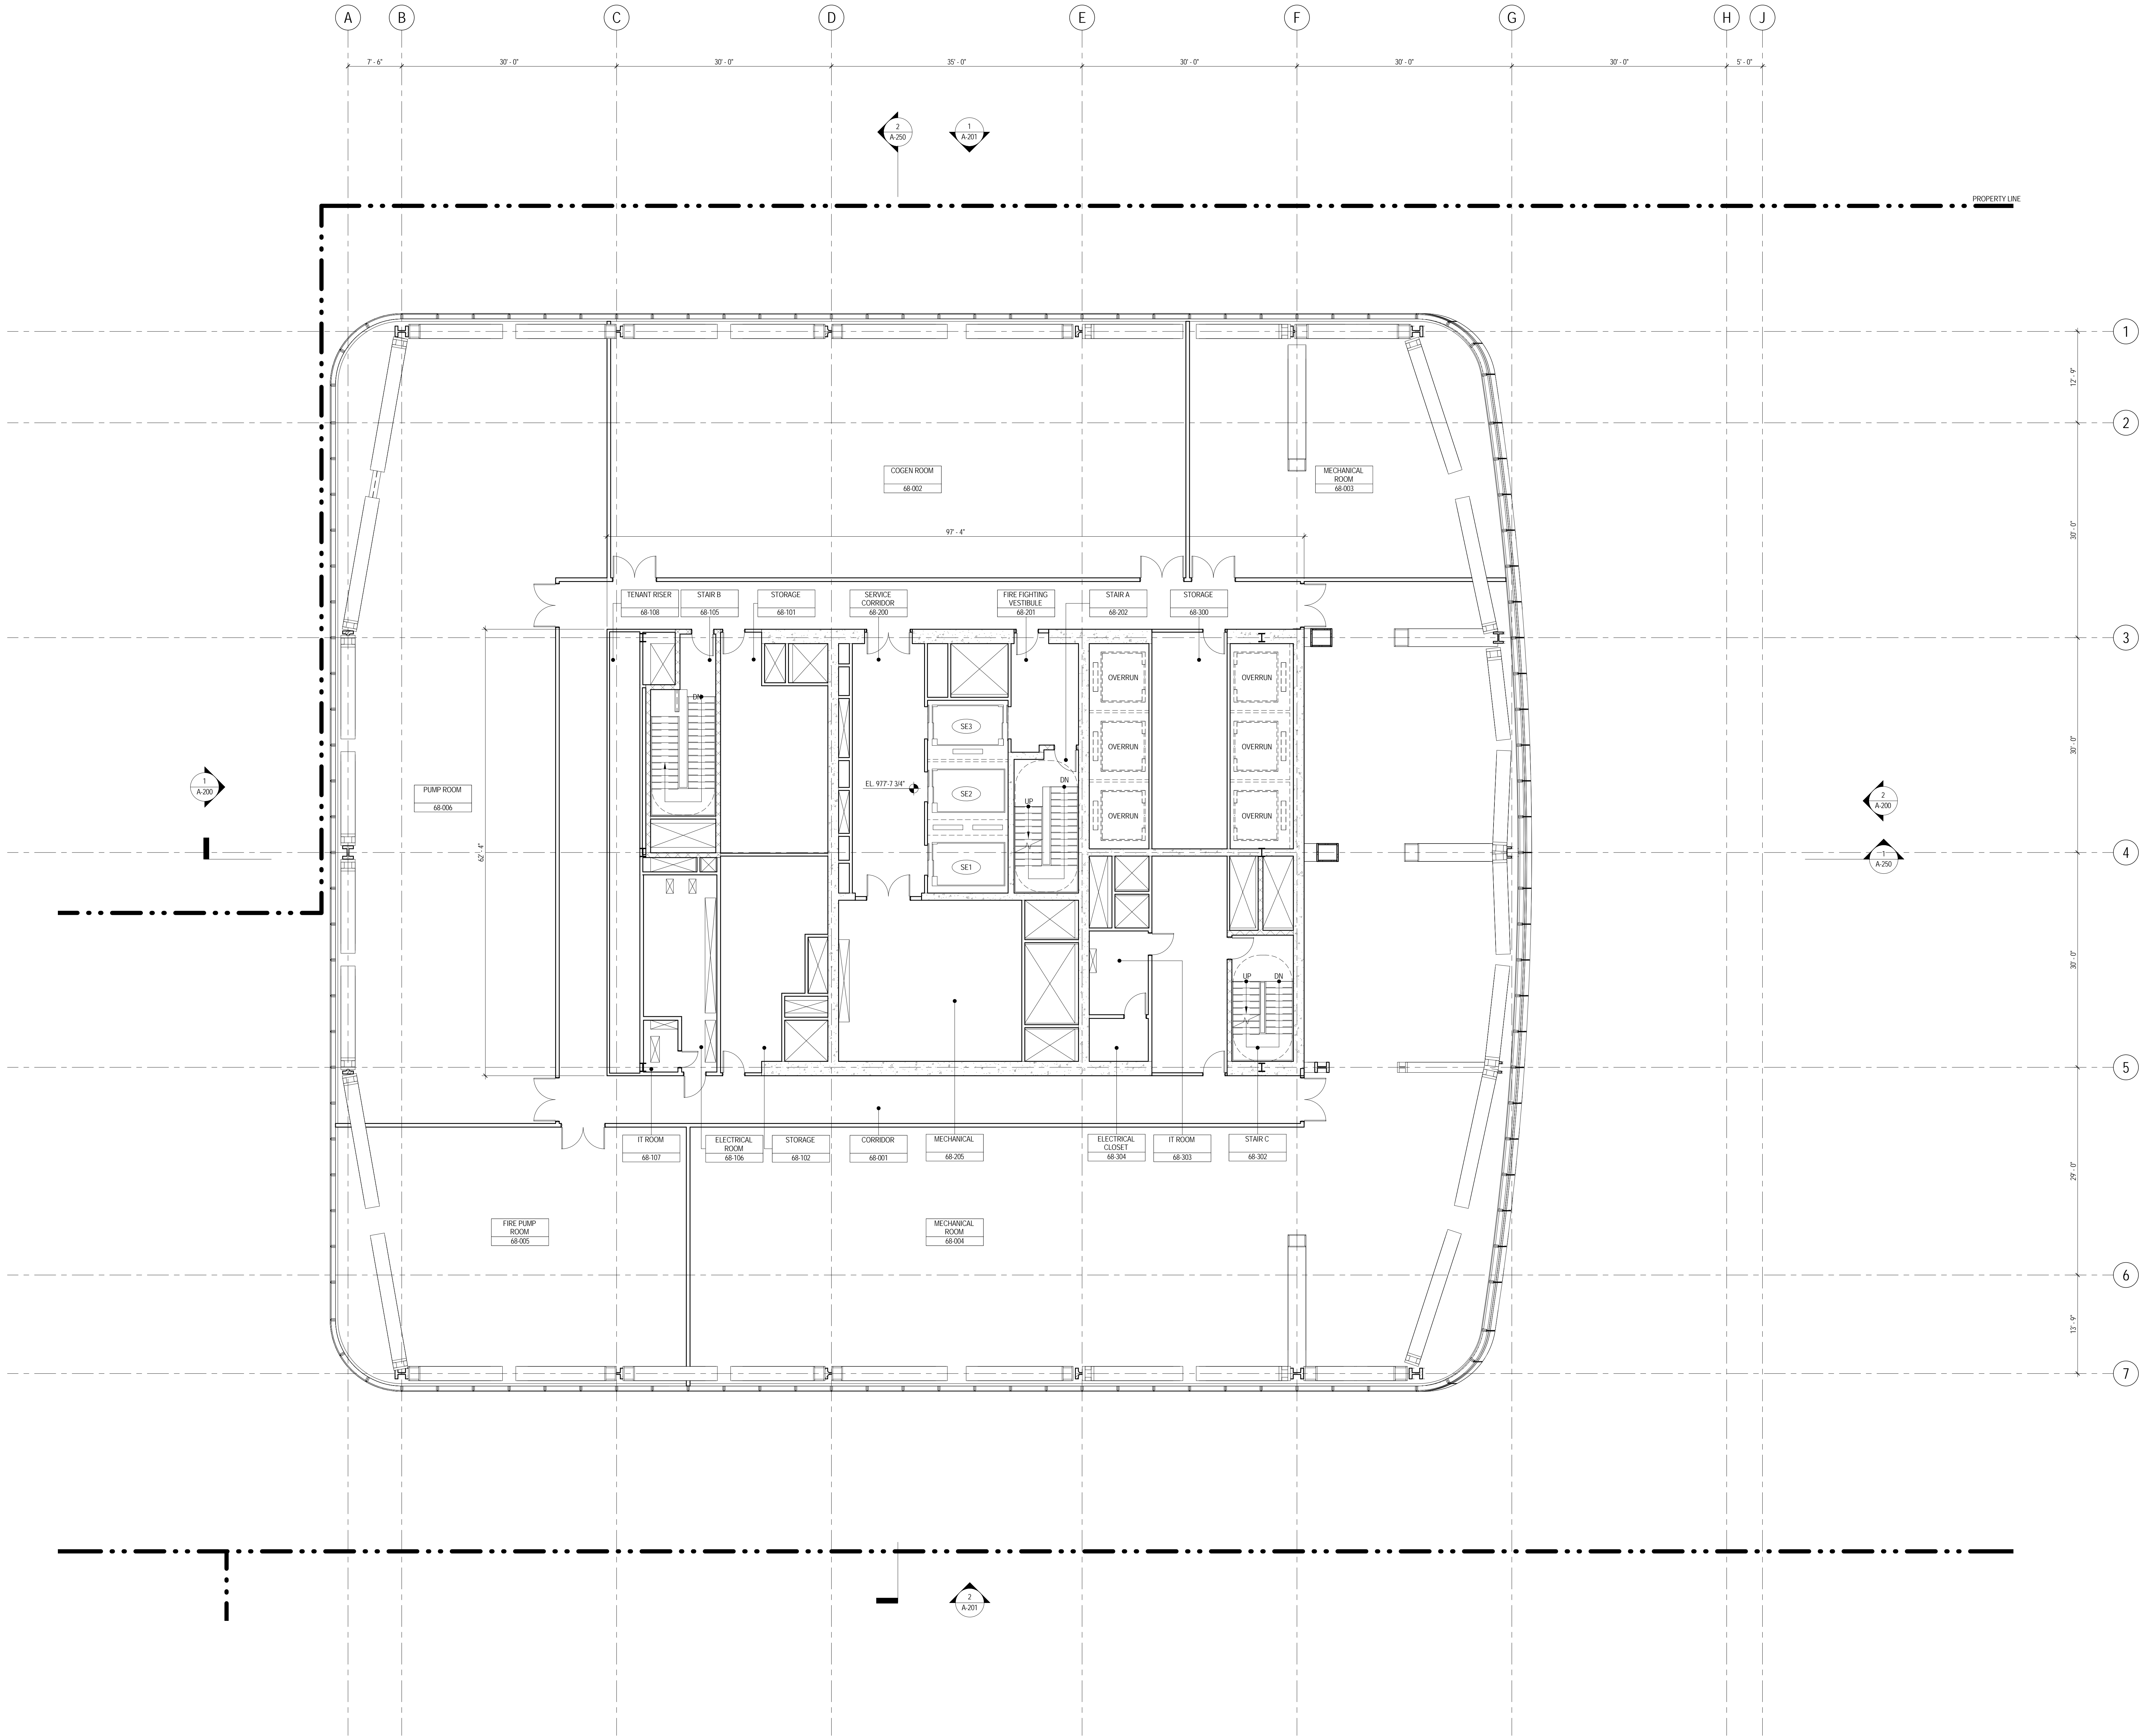No. Date Description
Sheet Name:

**LEVEL 68 FLOOR
PLAN -
MECHANICAL**

Project No.:

207150

Date:

20 JUN 2014

Scale:

1/8" = 1'-0"

File No.:

A-168

B-SCAN Sheet No.:


A-168.00

Sheet No.:

A-168

Page No.:

56 OF 87

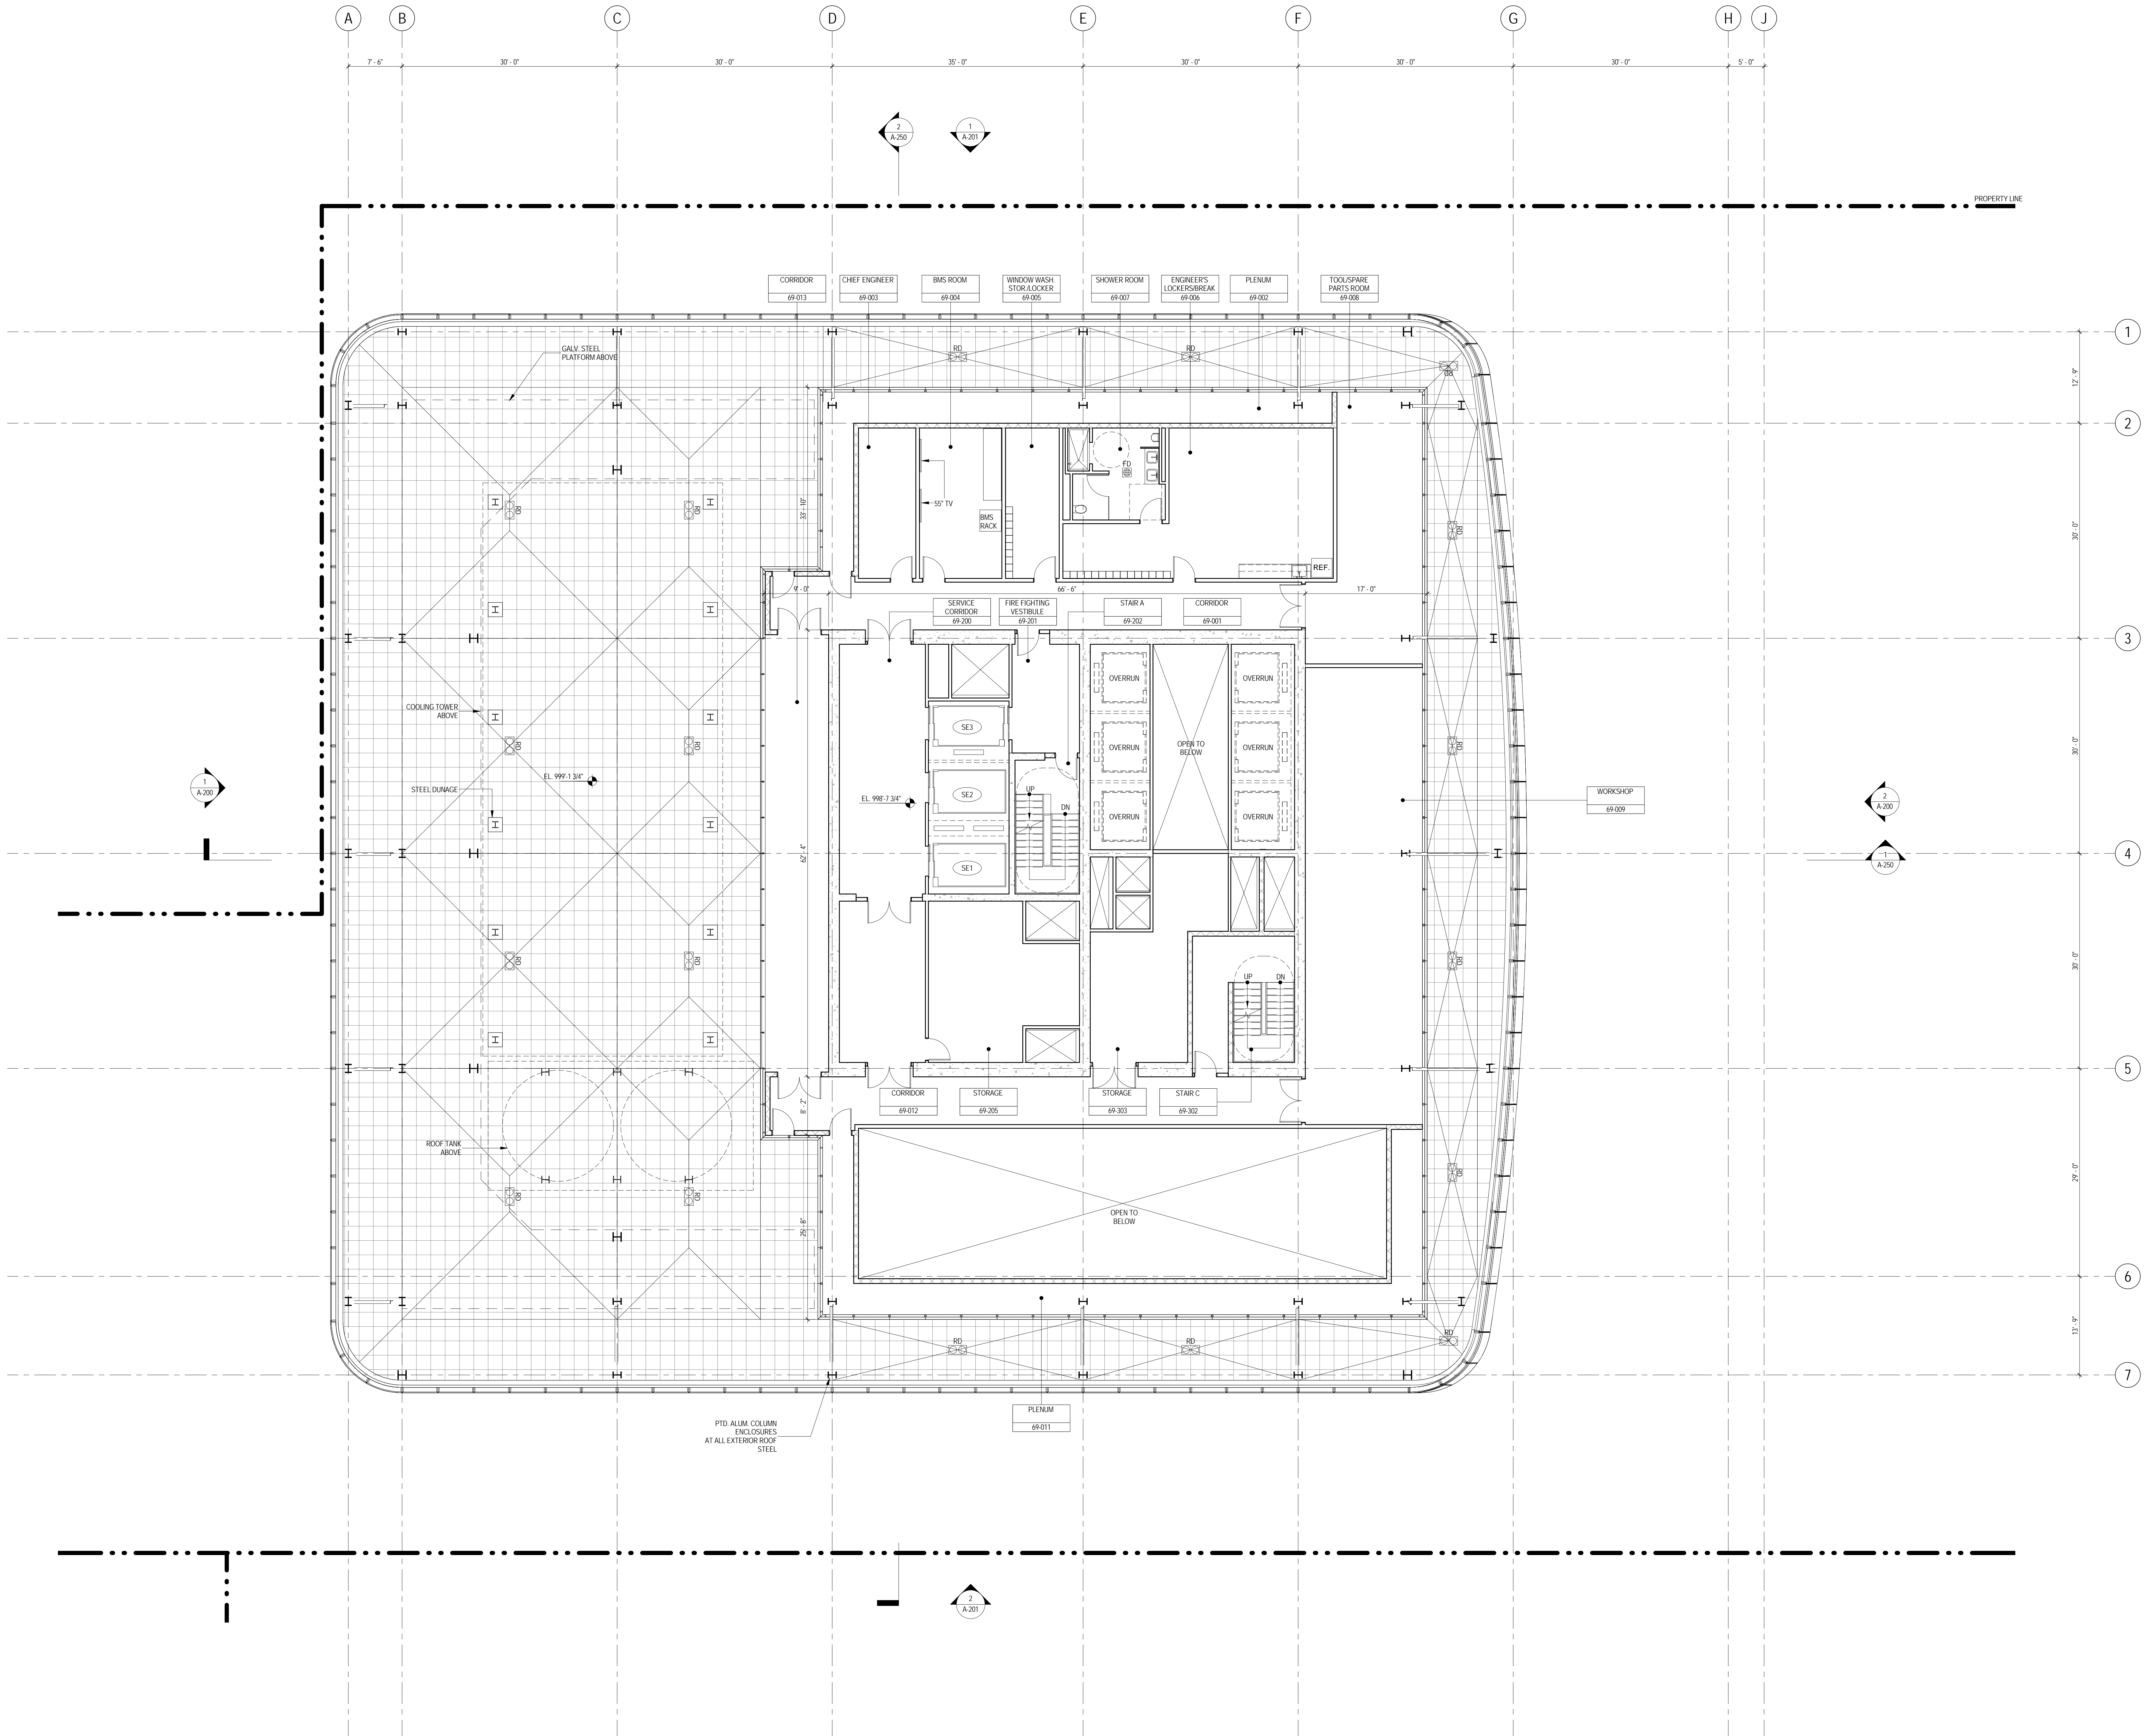

SHEET NOTES

1. ALL BUILDING ELEVATIONS (IN FEET) REFERENCED TO THE NORTH AMERICAN VERTICAL DATUM OF 1988 (NAV88).
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3. FOR ARCHITECTURAL ABBREVIATIONS, LEGEND OF SYMBOLS & MATERIALS, AND MOUNTING HEIGHTS REFER TO SHEET NO. C-006.
4. FOR ROOM FINISH SCHEDULE SEE A-700 SERIES DRAWINGS.
5. FOR DOOR SCHEDULE SEE A-700 SERIES DRAWINGS. FOR DOOR HARDWARE SPECIFICATION SEE TECHNICAL SPECIFICATION SECTION 051010.
6. FOR PARTITION TYPES SEE A-700 SERIES DRAWINGS.
7. ALL PARTITIONS SHALL BE TYPE DR. LND.
8. FOR REFLECTED CEILING PLANS SEE A-600 SERIES DRAWINGS. IF RCP IS NOT PROVIDED SEE MEPP/PAUSE/CITEL SERVICE DRAWINGS FOR LOCATIONS OR ALL CEILING/WALL MOUNTED DEVICES.
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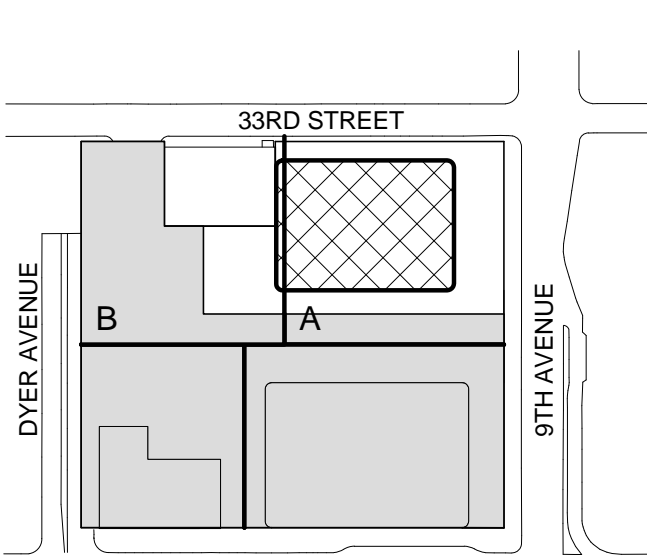
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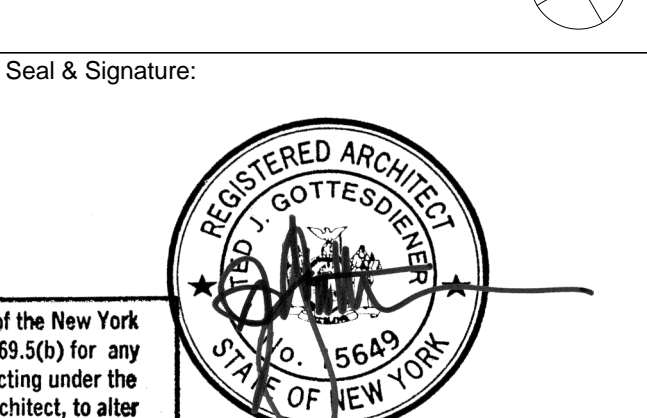
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No. Date Description
Sheet Name:

**LEVEL 69 FLOOR
PLAN -
MECHANICAL**

Project No.: 207150
Date: 20 JUN 2014
Scale: 1/8" = 1'-0"
File No.: A-169

B-SCAN Sheet No.:
A-169.00
Sheet No.:
A-169
Page No.: 57 OF 87

SHEET NOTES

1. ALL BUILDING ELEVATIONS (IN FEET) REFERENCED TO THE NORTH AMERICAN VERTICAL DATUM OF 1988 (NAV88).
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3. FOR ARCHITECTURAL ABBREVIATIONS, LEGEND OF SYMBOLS & MATERIALS, AND MOUNTING HEIGHTS REFER TO SHEET NO. G-006.
4. FOR ROOM FINISH SCHEDULE SEE A-700 SERIES DRAWINGS.
5. FOR DOOR SCHEDULE SEE A-700 SERIES DRAWINGS. FOR DOOR HARDWARE SPECIFICATION SEE TECHNICAL SPECIFICATION SECTION 051010.
6. FOR PARTITION TYPES SEE A-700 SERIES DRAWINGS.
7. ALL PARTITIONS SHALL BE TYPE DR-100.
8. FOR REFLECTED CEILING PLANS SEE A-600 SERIES DRAWINGS. IF RCP IS NOT PROVIDED SEE MEPP/PA/SC/TEL SERVICE DRAWINGS FOR LOCATIONS OR ALL CEILING/WALL MOUNTED DEVICES.
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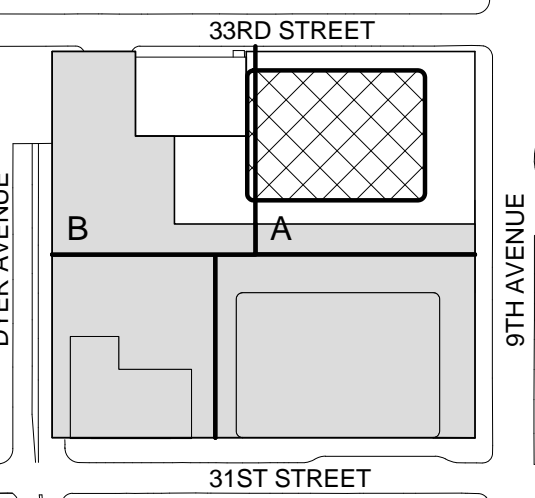
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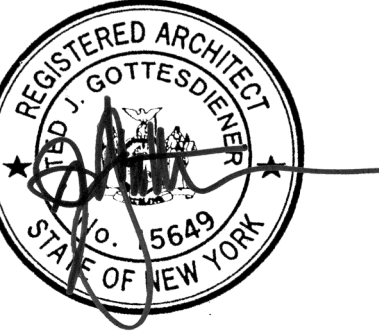
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No. Date Description
Sheet Name:

**ROOF PLAN -
MECHANICAL
PENTHOUSE**

Project No.:

201150

Date:

20 JUN 2014

Scale:

1/8" = 1'-0"

File No.:

A-170

B-SCAN Sheet No.:


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Sheet No.:

A-170

Page No.:

58 OF 87

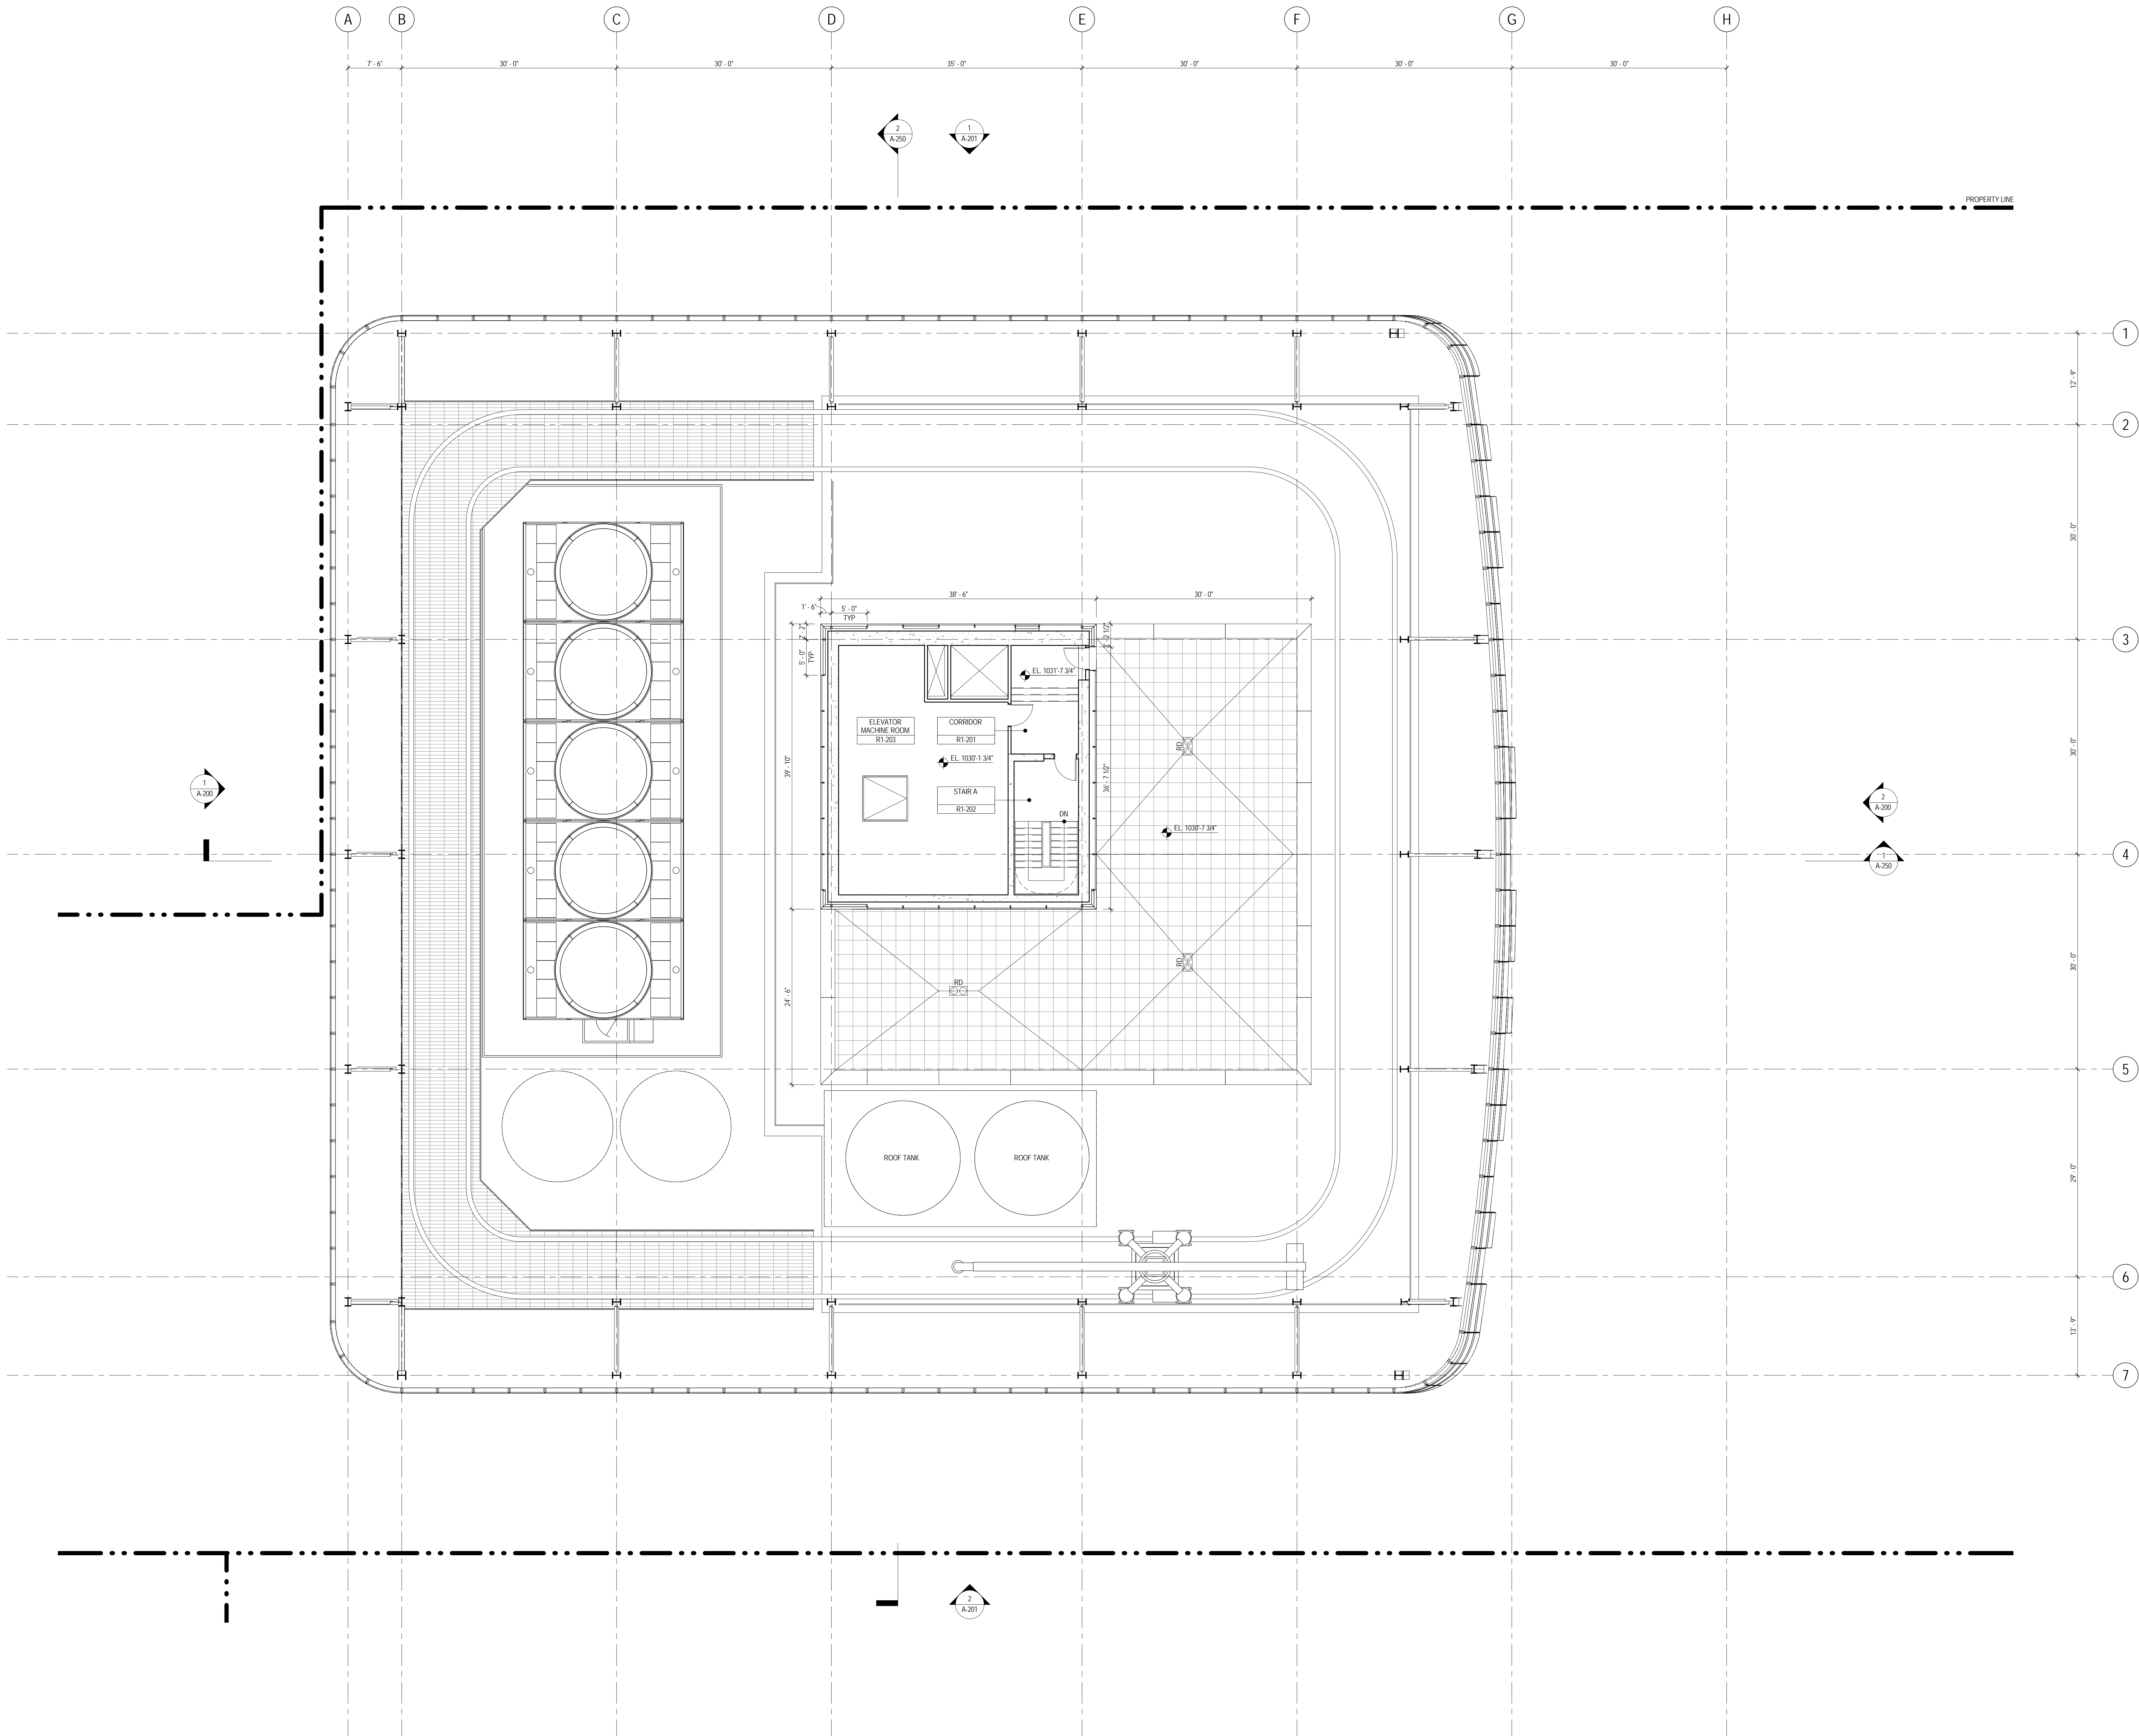

SHEET NOTES

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6. FOR PARTITION TYPES SEE A-700 SERIES DRAWINGS.
7. ALL PARTITIONS SHALL BE TYPE DR, UNO.
8. FOR REFLECTED CEILING PLANS SEE A-600 SERIES DRAWINGS. IF RCP IS NOT PROVIDED SEE MEPP/FFS/COTTE SERVICE DRAWINGS FOR LOCATIONS OR ALL CEILING/WALL MOUNTED DEVICES.
9. FOR STRUCTURAL COLUMNS, EDGE OF SLAB, AND CORE WORK POINTS SEE STRUCTURAL SERIES DRAWINGS, UNO.
10. REFER TO STRUCTURAL SERIES DRAWINGS FOR ALL STRUCTURAL WALL DESIGNATIONS AND DIMENSIONS.
11. REFER TO MEPP DRAWINGS FOR ALL MECHANICAL, ELECTRICAL, PLUMBING AND FIRE PROTECTION ROOM, RISER AND EQUIPMENT DESIGNATIONS.
12. FOR PROJECT WORK POINT REFER TO A-000 SERIES DRAWINGS.



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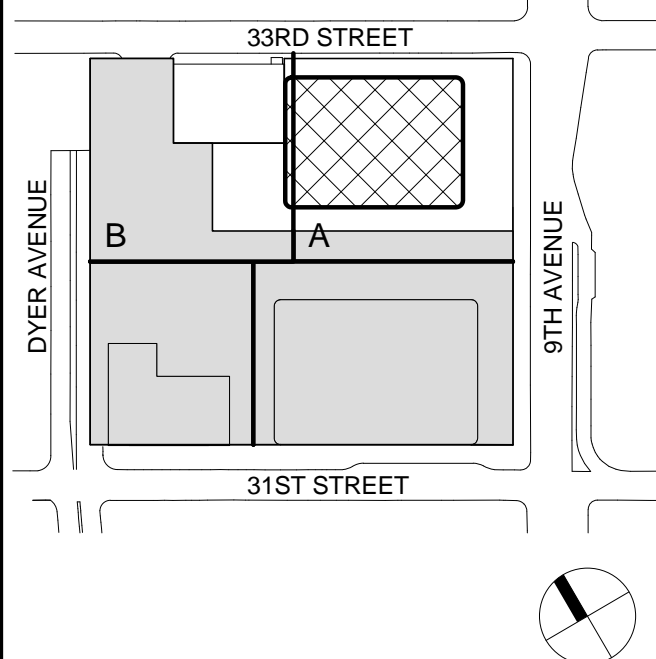
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No.	Date	Description
6	20 JUN 2014	ISSUED FOR FOUNDATION BID
5	20 JUN 2014	ISSUED FOR FOUNDATION PERMIT
4	20 DEC 2013	ISSUED FOR FOUNDATION PERMIT
3	15 NOV 2013	ISSUED FOR 30% PROGRESS PRICING
2	12 JUL 2013	ISSUED FOR 90% DESIGN DEVELOPMENT
1	19 MAR 2012	ISSUED FOR RECONCILIATION

Sheet Name:

**ROOF PLAN -
MECHANICAL
PENTHOUSE
ROOF**

Project No.:

207150

Date:

20 JUN 2014

Scale:

1/8" = 1'-0"

File No.:

A-171

B-SCAN Sheet No.:

A-171.00

Sheet No.:

A-171

Page No.:

99 OF 87

SHEET NOTES

1. ALL BUILDING ELEVATIONS (IN FEET) REFERENCED TO THE NORTH AMERICAN VERTICAL DATUM OF 1988 (NAV88).
2. FOR GENERAL NOTES, BUILDING DEPARTMENT NOTES, AND CLARIFICATION OF THE WORK NOTES REFER TO SHEET NO. G-005.
3. FOR ARCHITECTURAL ABBREVIATIONS, LEGEND OF SYMBOLS & MATERIALS, AND MOUNTING HEIGHTS REFER TO SHEET NO. C-006.
4. FOR ROOM FINISH SCHEDULE SEE A-700 SERIES DRAWINGS.
5. FOR DOOR SCHEDULE SEE A-700 SERIES DRAWINGS. FOR DOOR HARDWARE SPECIFICATION SEE TECHNICAL SPECIFICATION SECTION (05100).
6. FOR PARTITION TYPES SEE A-700 SERIES DRAWINGS.
7. ALL PARTITIONS SHALL BE TYPE DR, UNO.
8. FOR REFLECTED CEILING PLANS SEE A-600 SERIES DRAWINGS. IF RCP IS NOT PROVIDED SEE MEPP/FASE/CITL SERVICE DRAWINGS FOR LOCATIONS OR ALL CEILING/WALL MOUNTED DEVICES.
9. FOR STRUCTURAL COLUMNS, EDGE OF SLAB AND CORE WORK POINTS SEE STRUCTURAL SERIES DRAWINGS, UNO.
10. REFER TO STRUCTURAL SERIES DRAWINGS FOR ALL STRUCTURAL WALL DESIGNATIONS AND DIMENSIONS.
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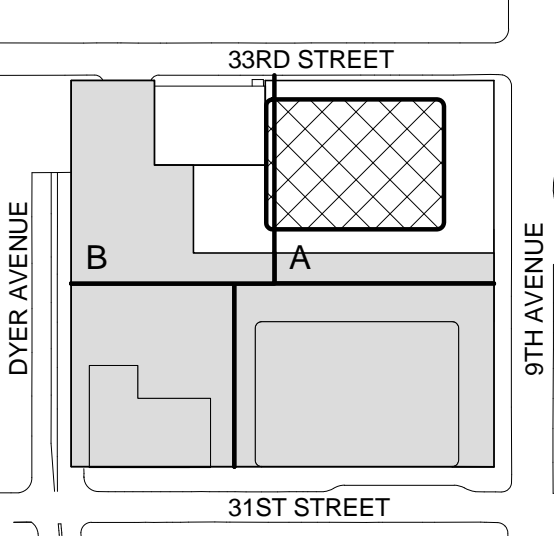
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4 20 JUN 2014 ISSUED FOR FOUNDATION BID
3 20 JUN 2014 ISSUED FOR FOUNDATION PERMIT
2 20 DEC 2013 ISSUED FOR FOUNDATION PERMIT
1 19 NOV 2013 ISSUED FOR BID PROGRESS PRICING

No. Date Description
Sheet Name:

ROOF PLAN

Project No.:

207150

Date:

20 JUN 2014

Scale:

1/8" = 1'-0"

File No.:

A-172

B-SCAN Sheet No.:

A-172.00


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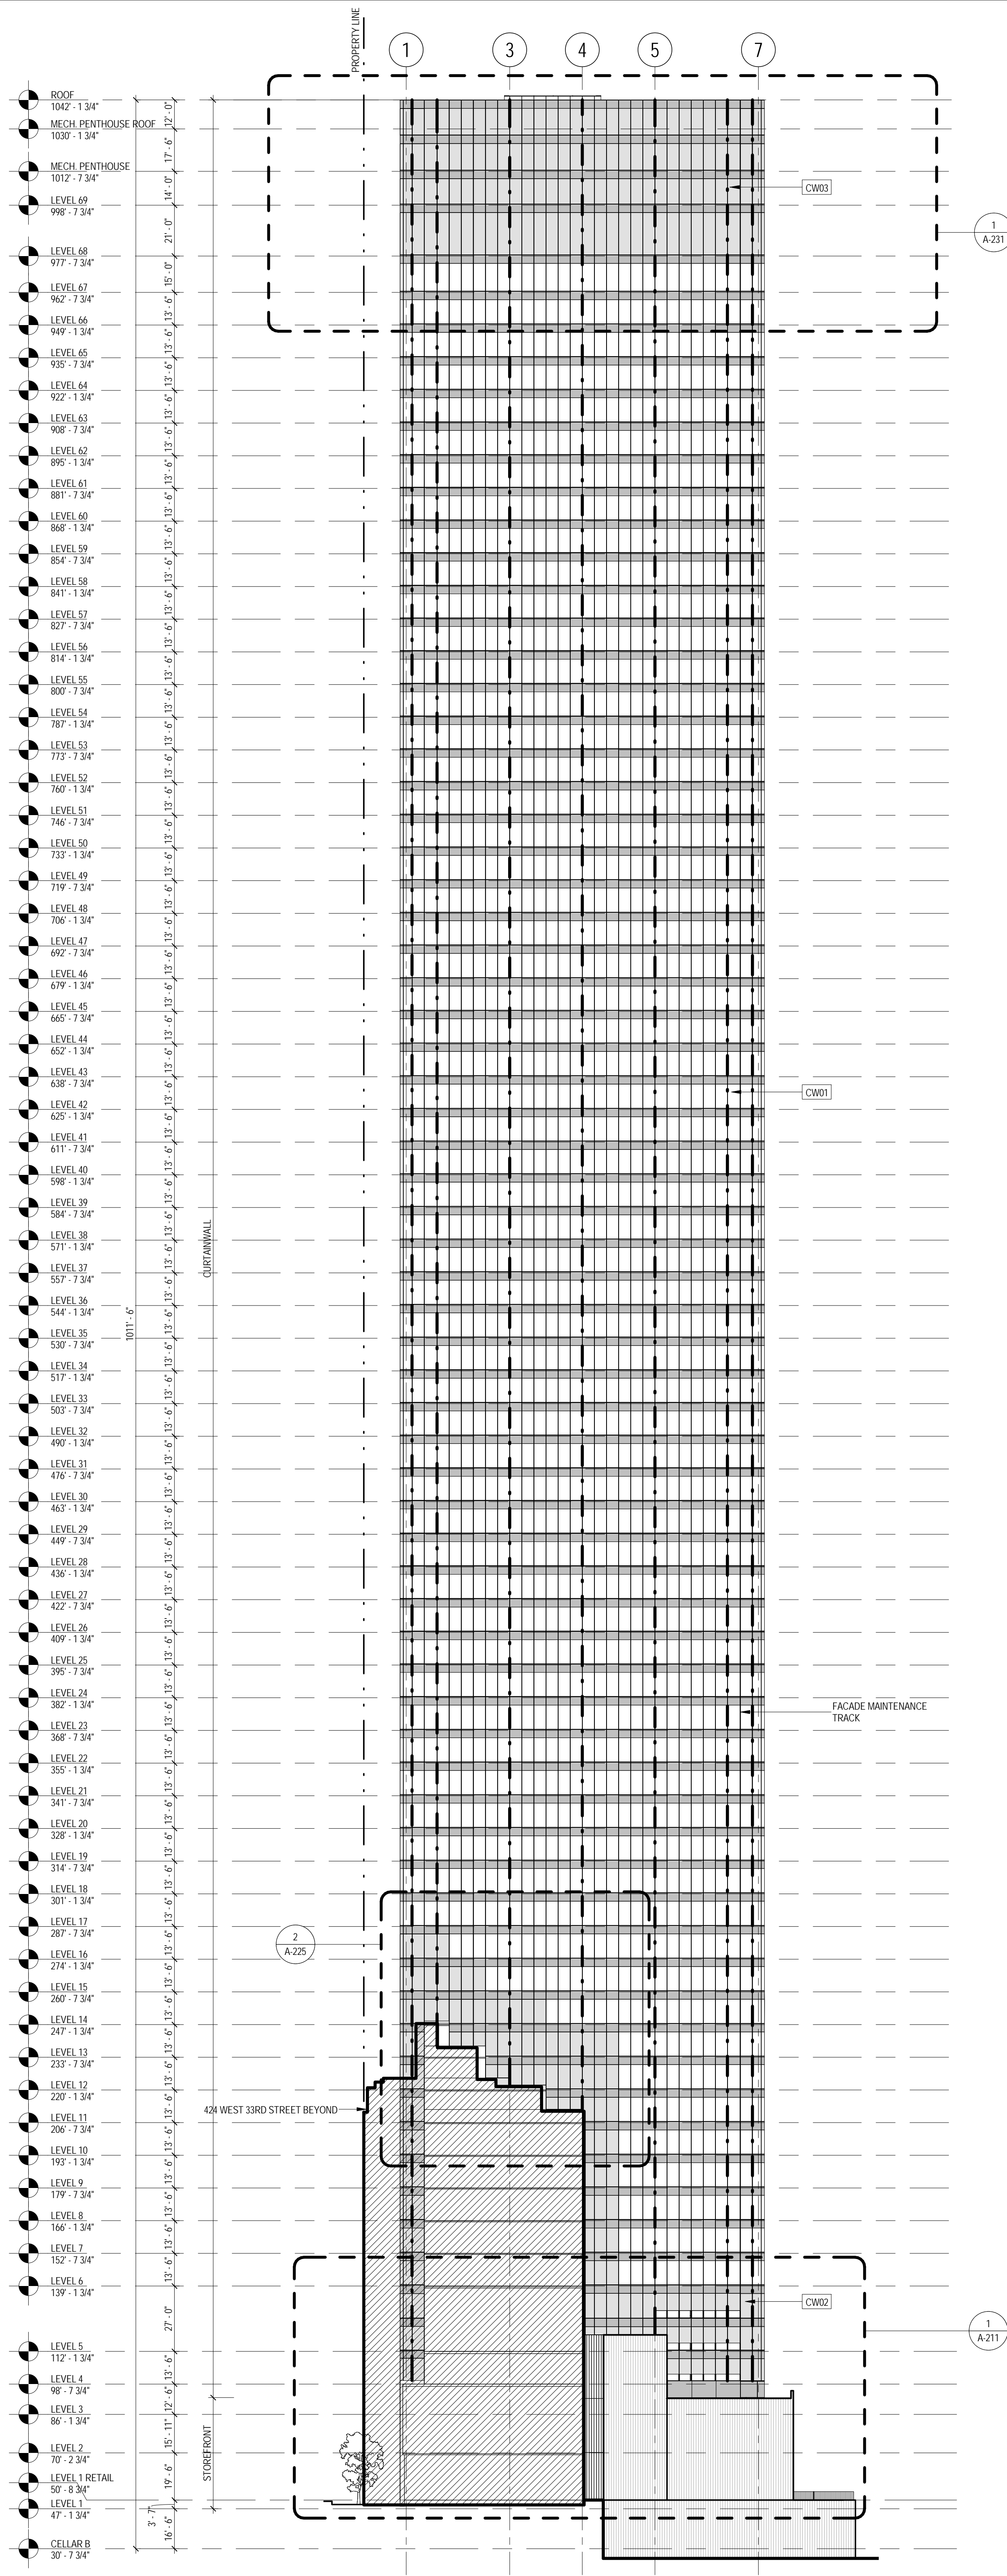
Page No.:

60 OF 87

2 EAST BUILDING ELEVATION
SCALE: 1/32" = 1'-0"



1 WEST BUILDING ELEVATION
SCALE: 1/32" = 1'-0"

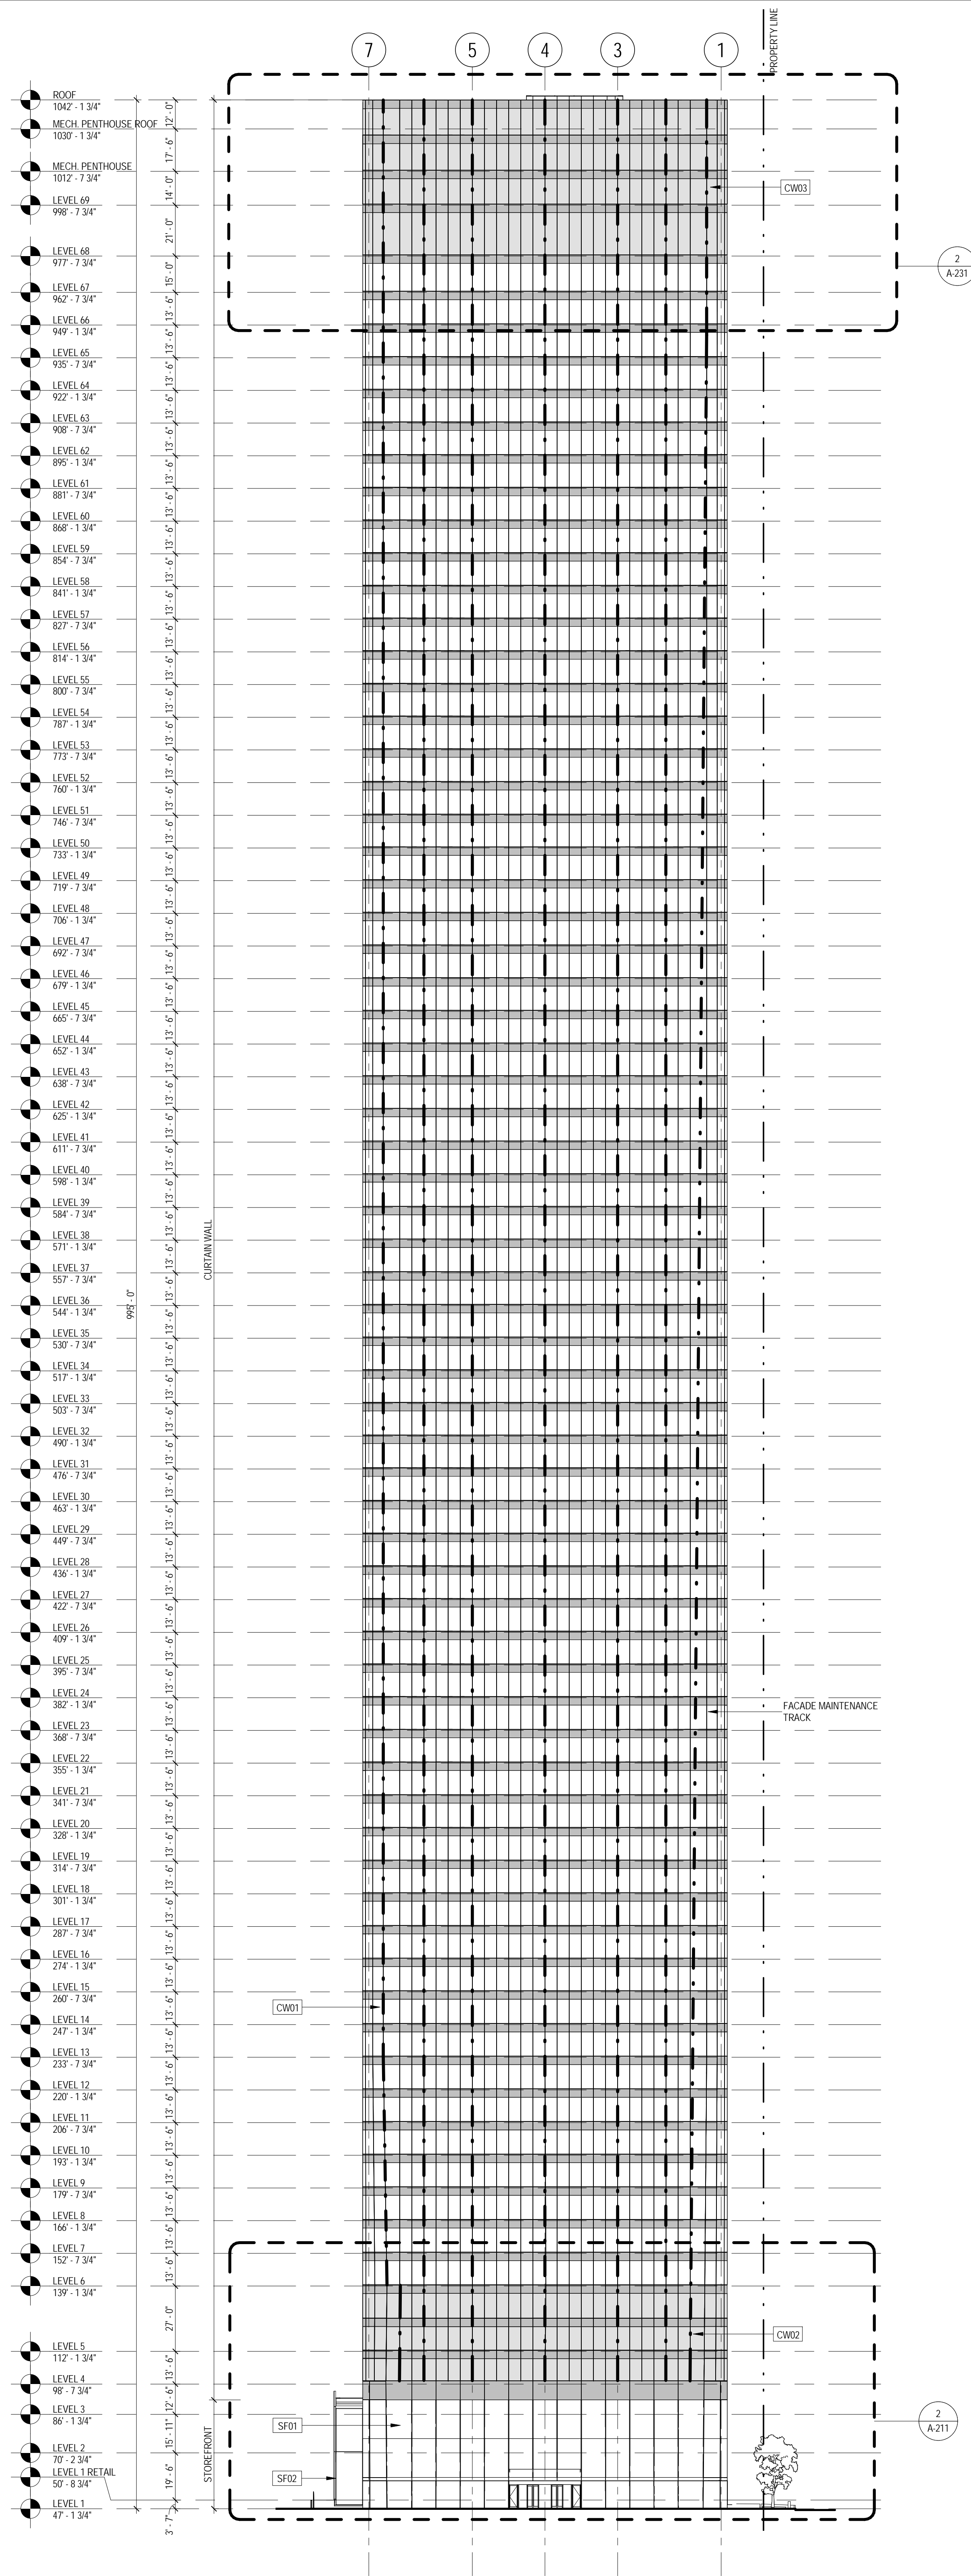

SHEET NOTES

1. SEE 500 SERIES FOR ENCLOSURE DETAILS.
2. ALL DOCUMENTATION OF 424 WEST 33RD STREET IS PRELIMINARY. VERIFY EXISTING CONDITIONS.
3. VERIFY EXISTING CONDITIONS OF ADJACENT LOFT BUILDING. LOCATION OF FOUNDATION WALL AND EXTENT OF CURTAIN WALL SEPARATIONS TO BE VERIFIED IN FIELD.
4. SEE FM SERIES FOR FACADE MAINTENANCE DETAILS.

- LEGEND
- SHADOW BOX 1
 - SHADOW BOX 2

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Key Plan:


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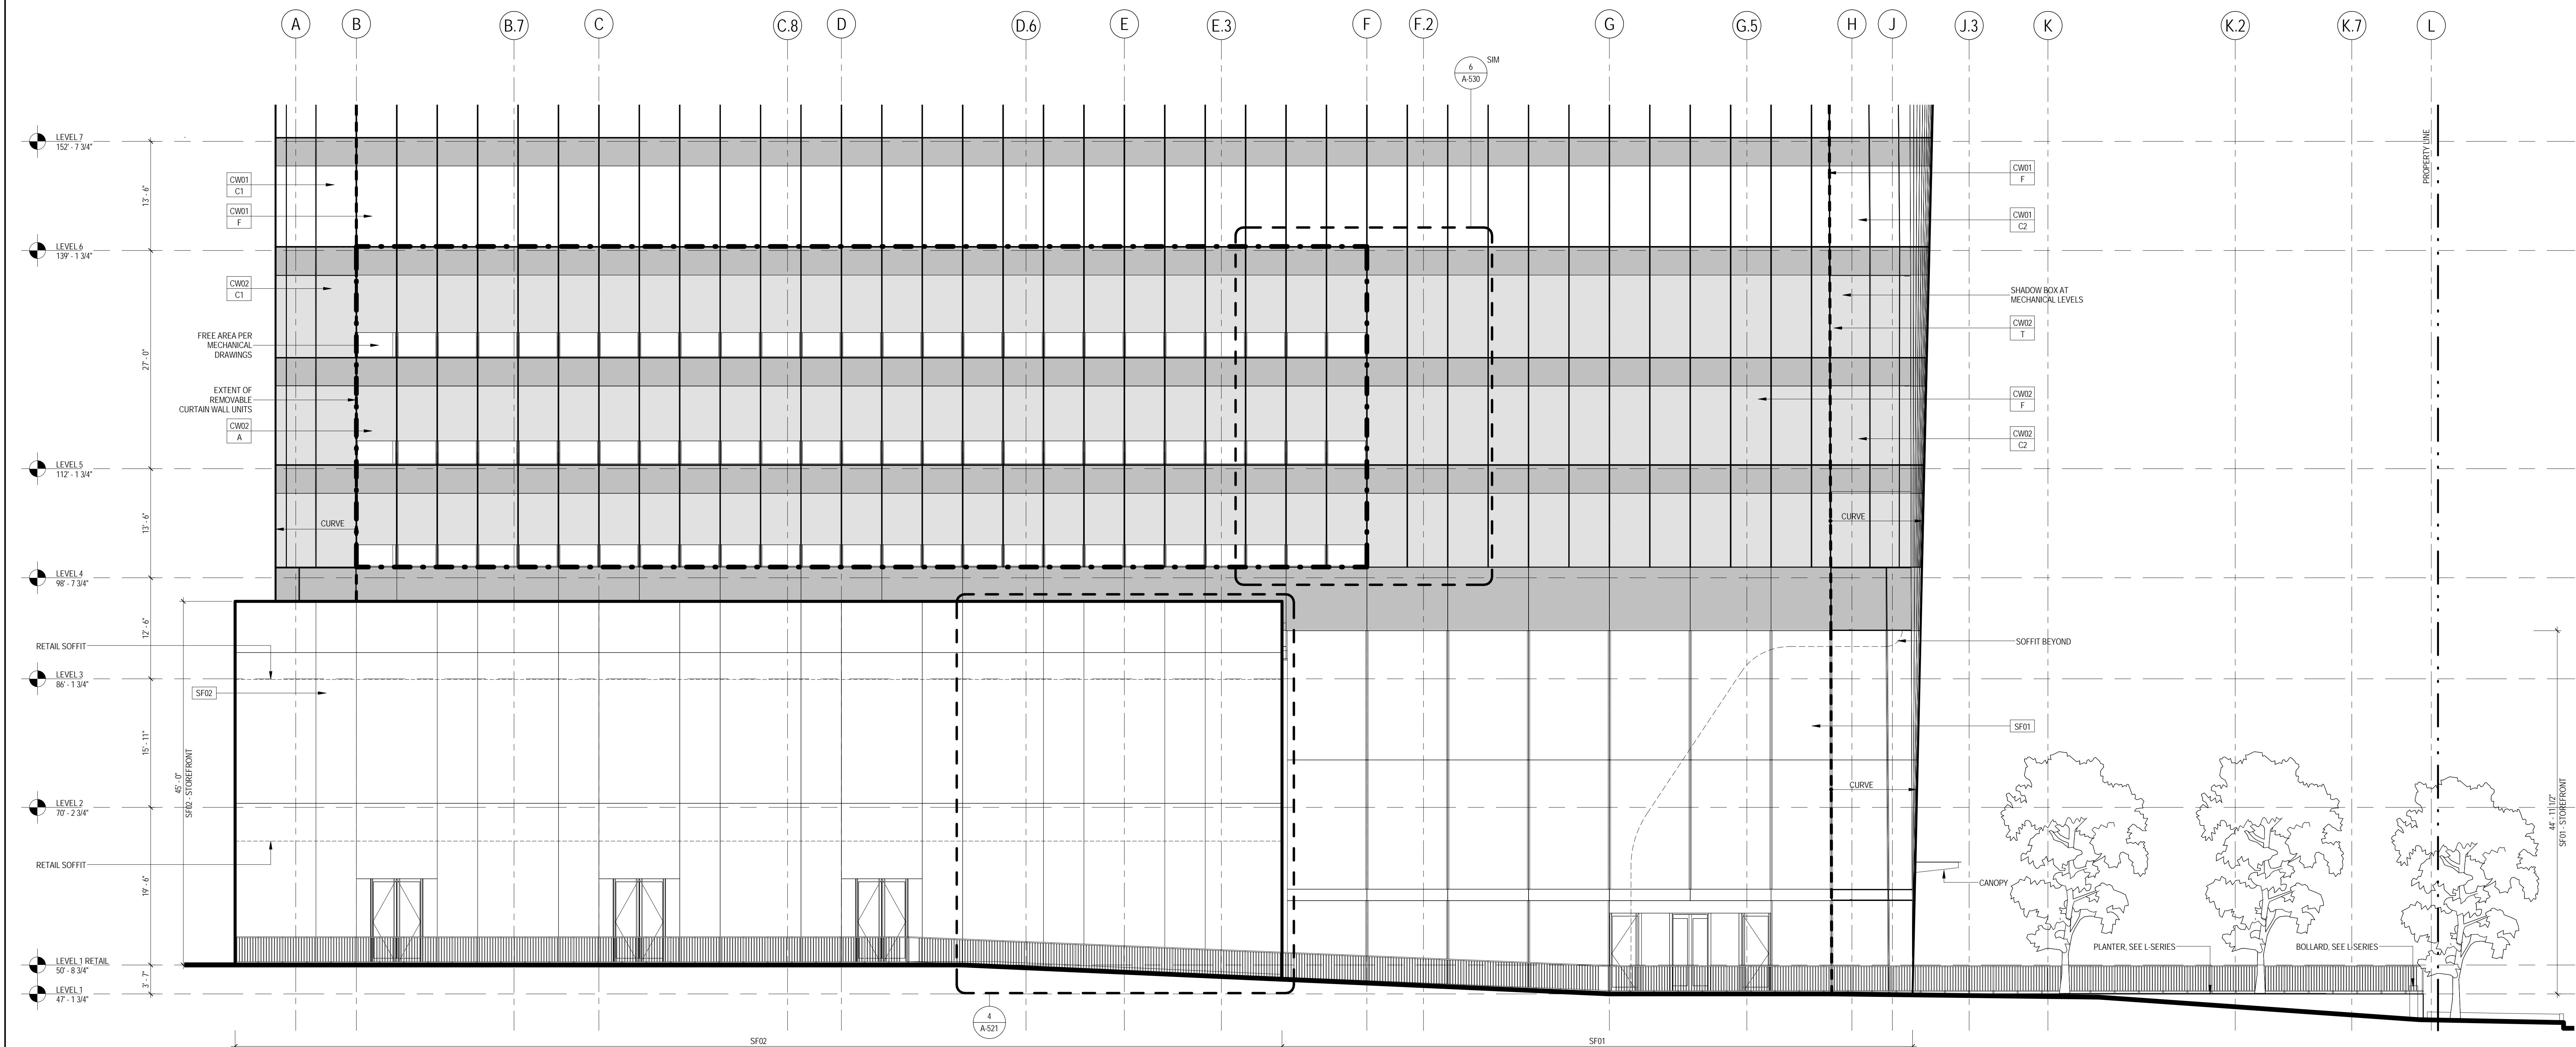
Project No.: 207150
Date: 12 SEPT 2014
Scale: 1/32" = 1'-0"
File No.: A-200

B-SCAN Sheet No.:
A-200.00
Sheet No.:
A-200
Page No.: 61 OF 30






2 ENLARGED ELEVATION AT GROUND FLOOR LOOKING SOUTH
SCALE: 1/8" = 1'-0"

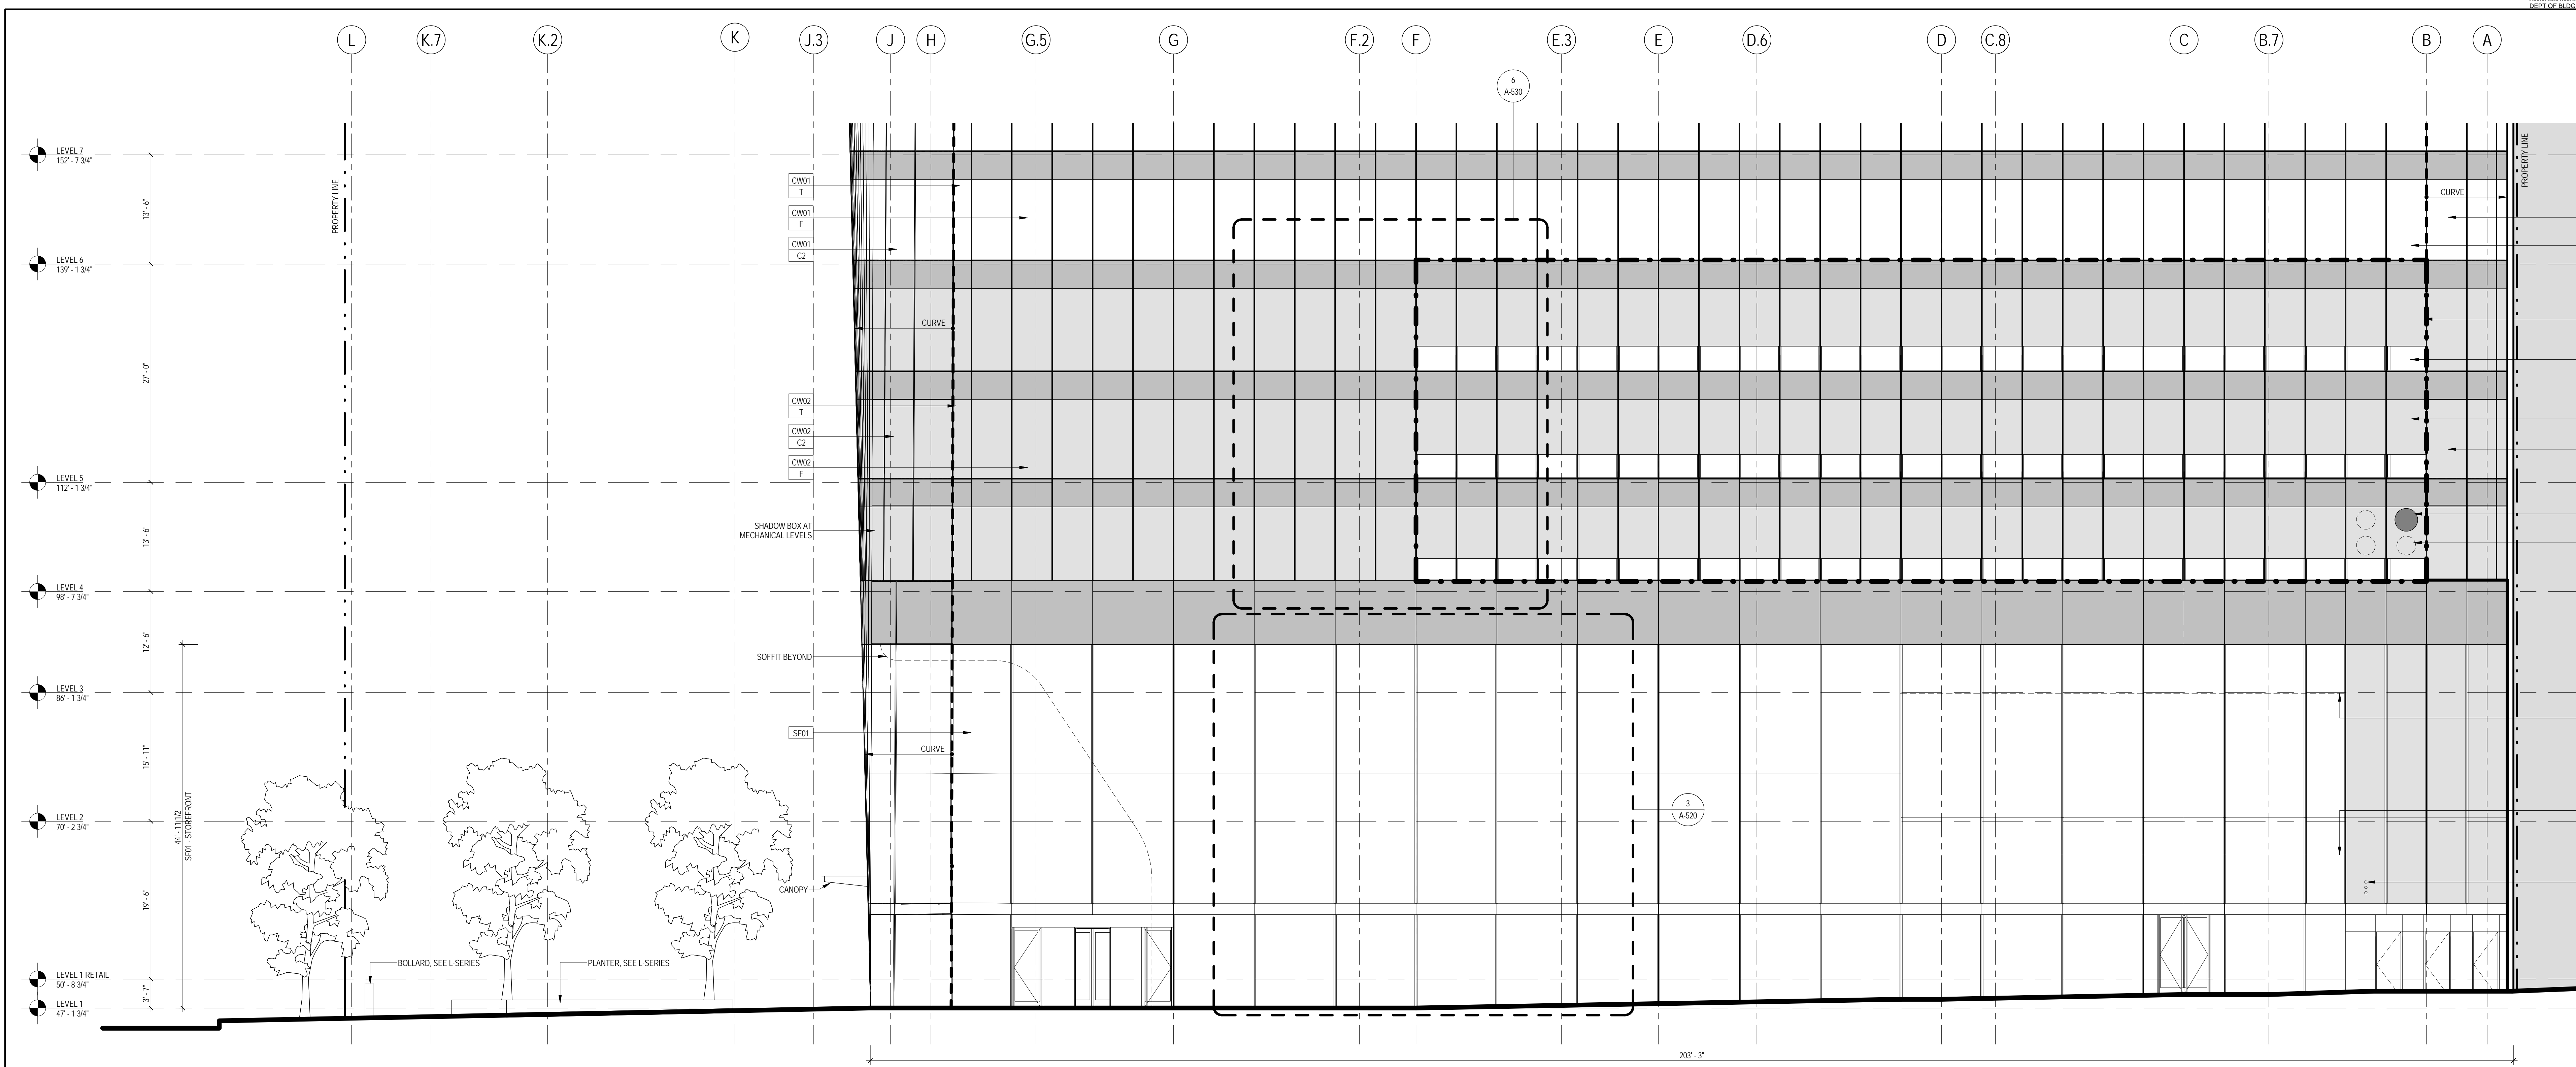

1 ENLARGED ELEVATION AT GROUND FLOOR LOOKING NORTH
SCALE: 1/8" = 1'-0"



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REGISTERED ARCHITECT
STATE OF NEW YORK
No. 123456789
Seal & Signature: [Signature]

4 12 SEPT 2014 ISSUED FOR FOUNDATION PERMIT
3 20 DEC 2013 ISSUED FOR FOUNDATION PERMIT
2 15 NOV 2013 ISSUED FOR DD PROGRESS PRICING
1 12 JUL 2013 ISSUED FOR 50% DESIGN DEVELOPMENT


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Sheet Name: _____

**ENLARGED
ELEVATIONS AT
GROUND FLOOR**

Project No.: 207150
Date: 12 SEPT 2014
Scale: 1/8" = 1'-0"
File No.: A-210


B-SCAN Sheet No.:
A-210.00
Sheet No.:
Page No.: 67 OF 30

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2 ENLARGED ELEVATION AT GROUND FLOOR LOOKING WEST

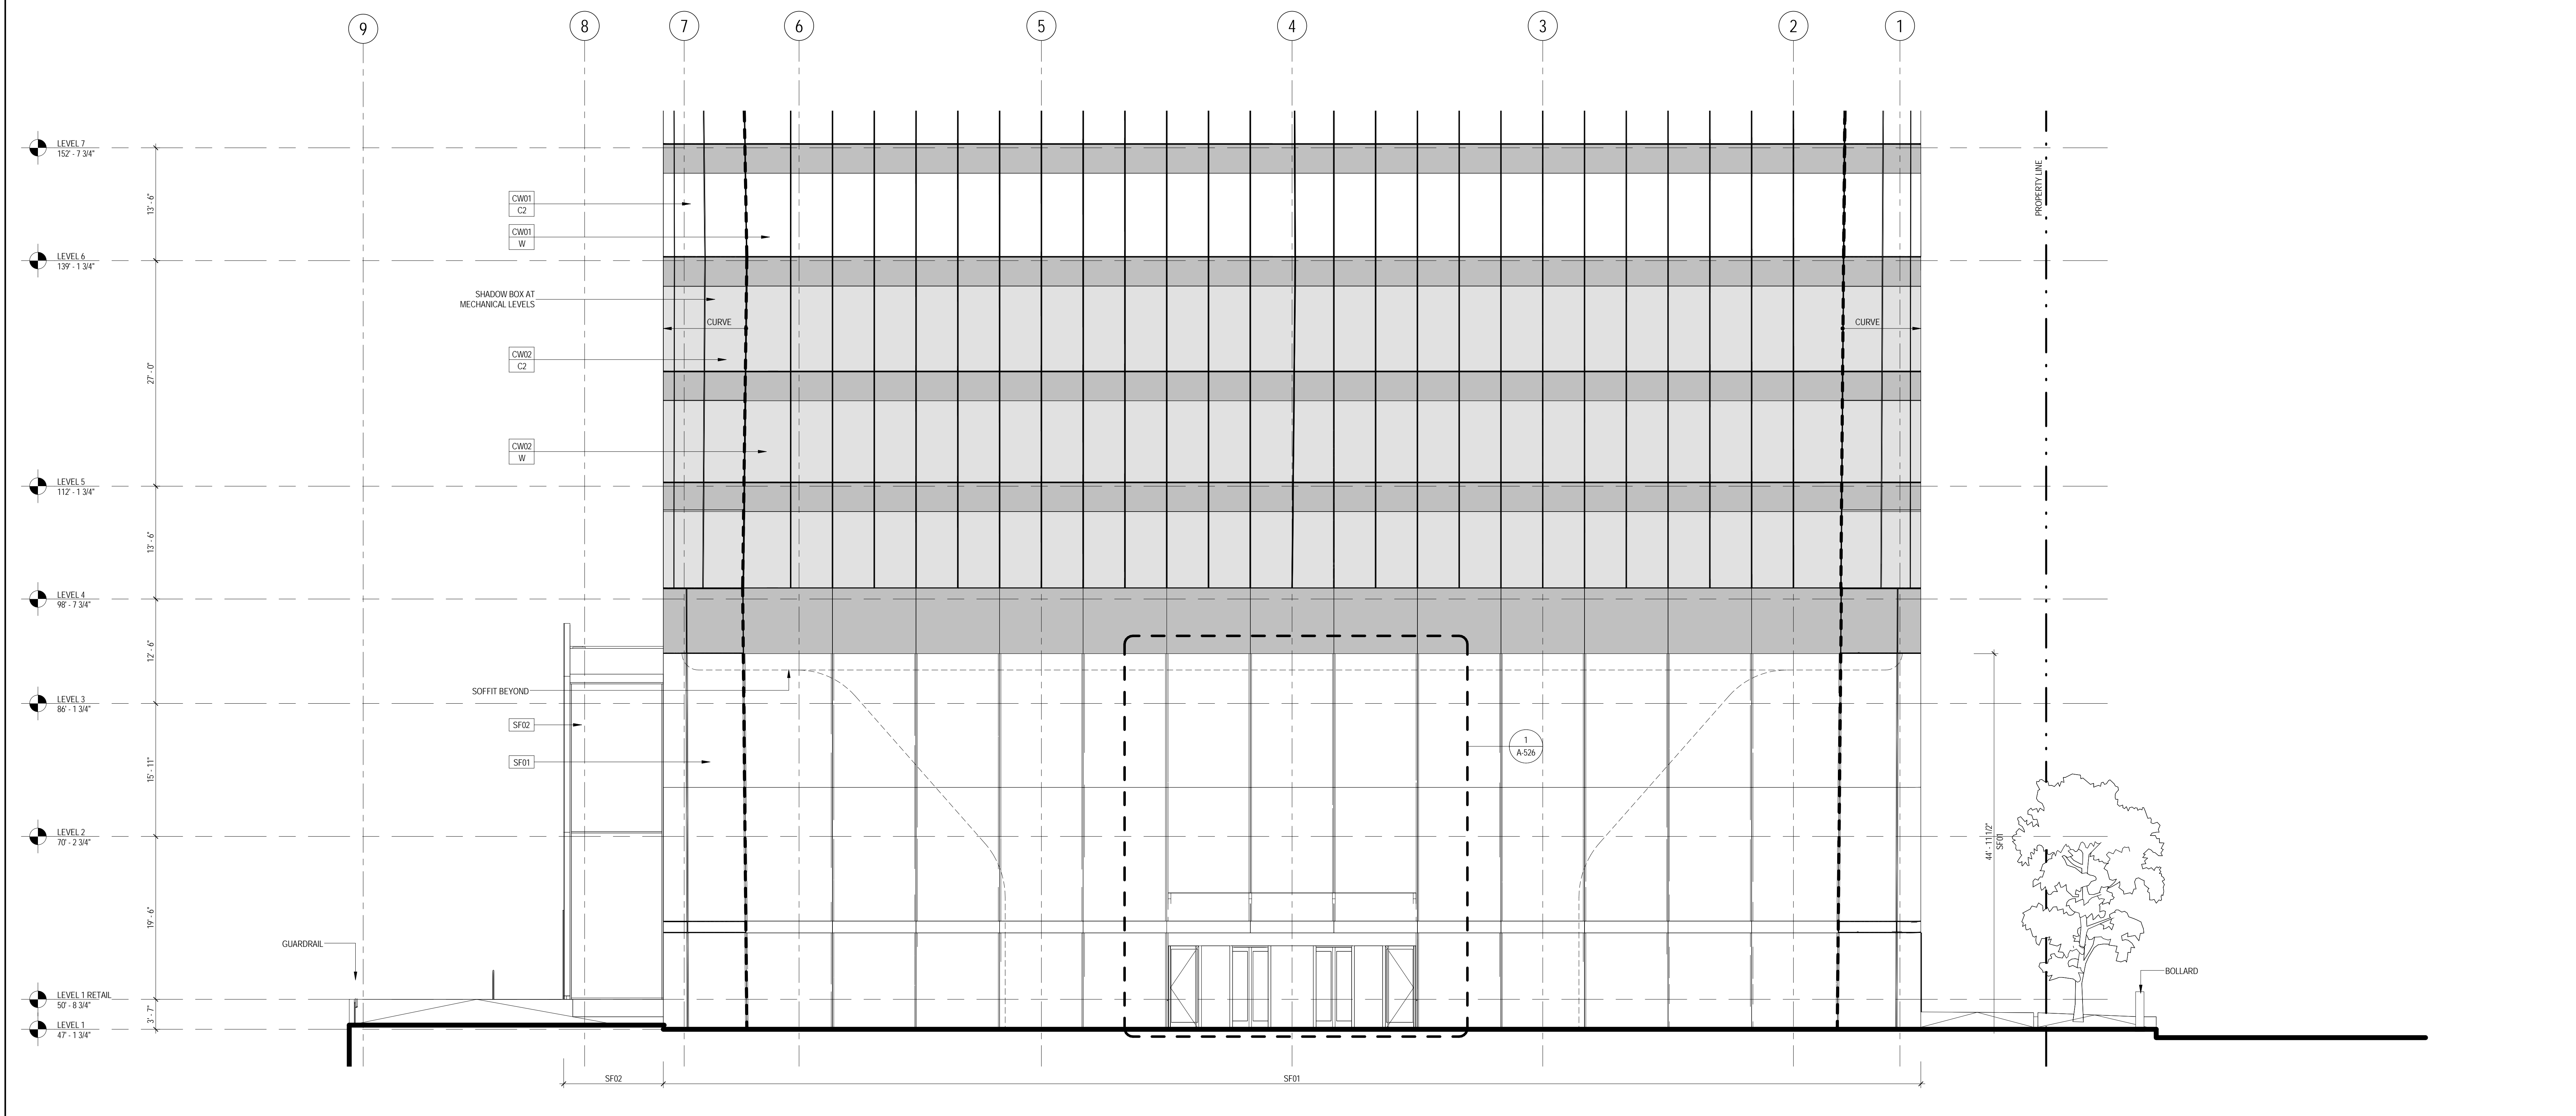SCALE: 1/8" = 1'-0"



1 ENLARGED ELEVATION AT GROUND FLOOR LOOKING EAST

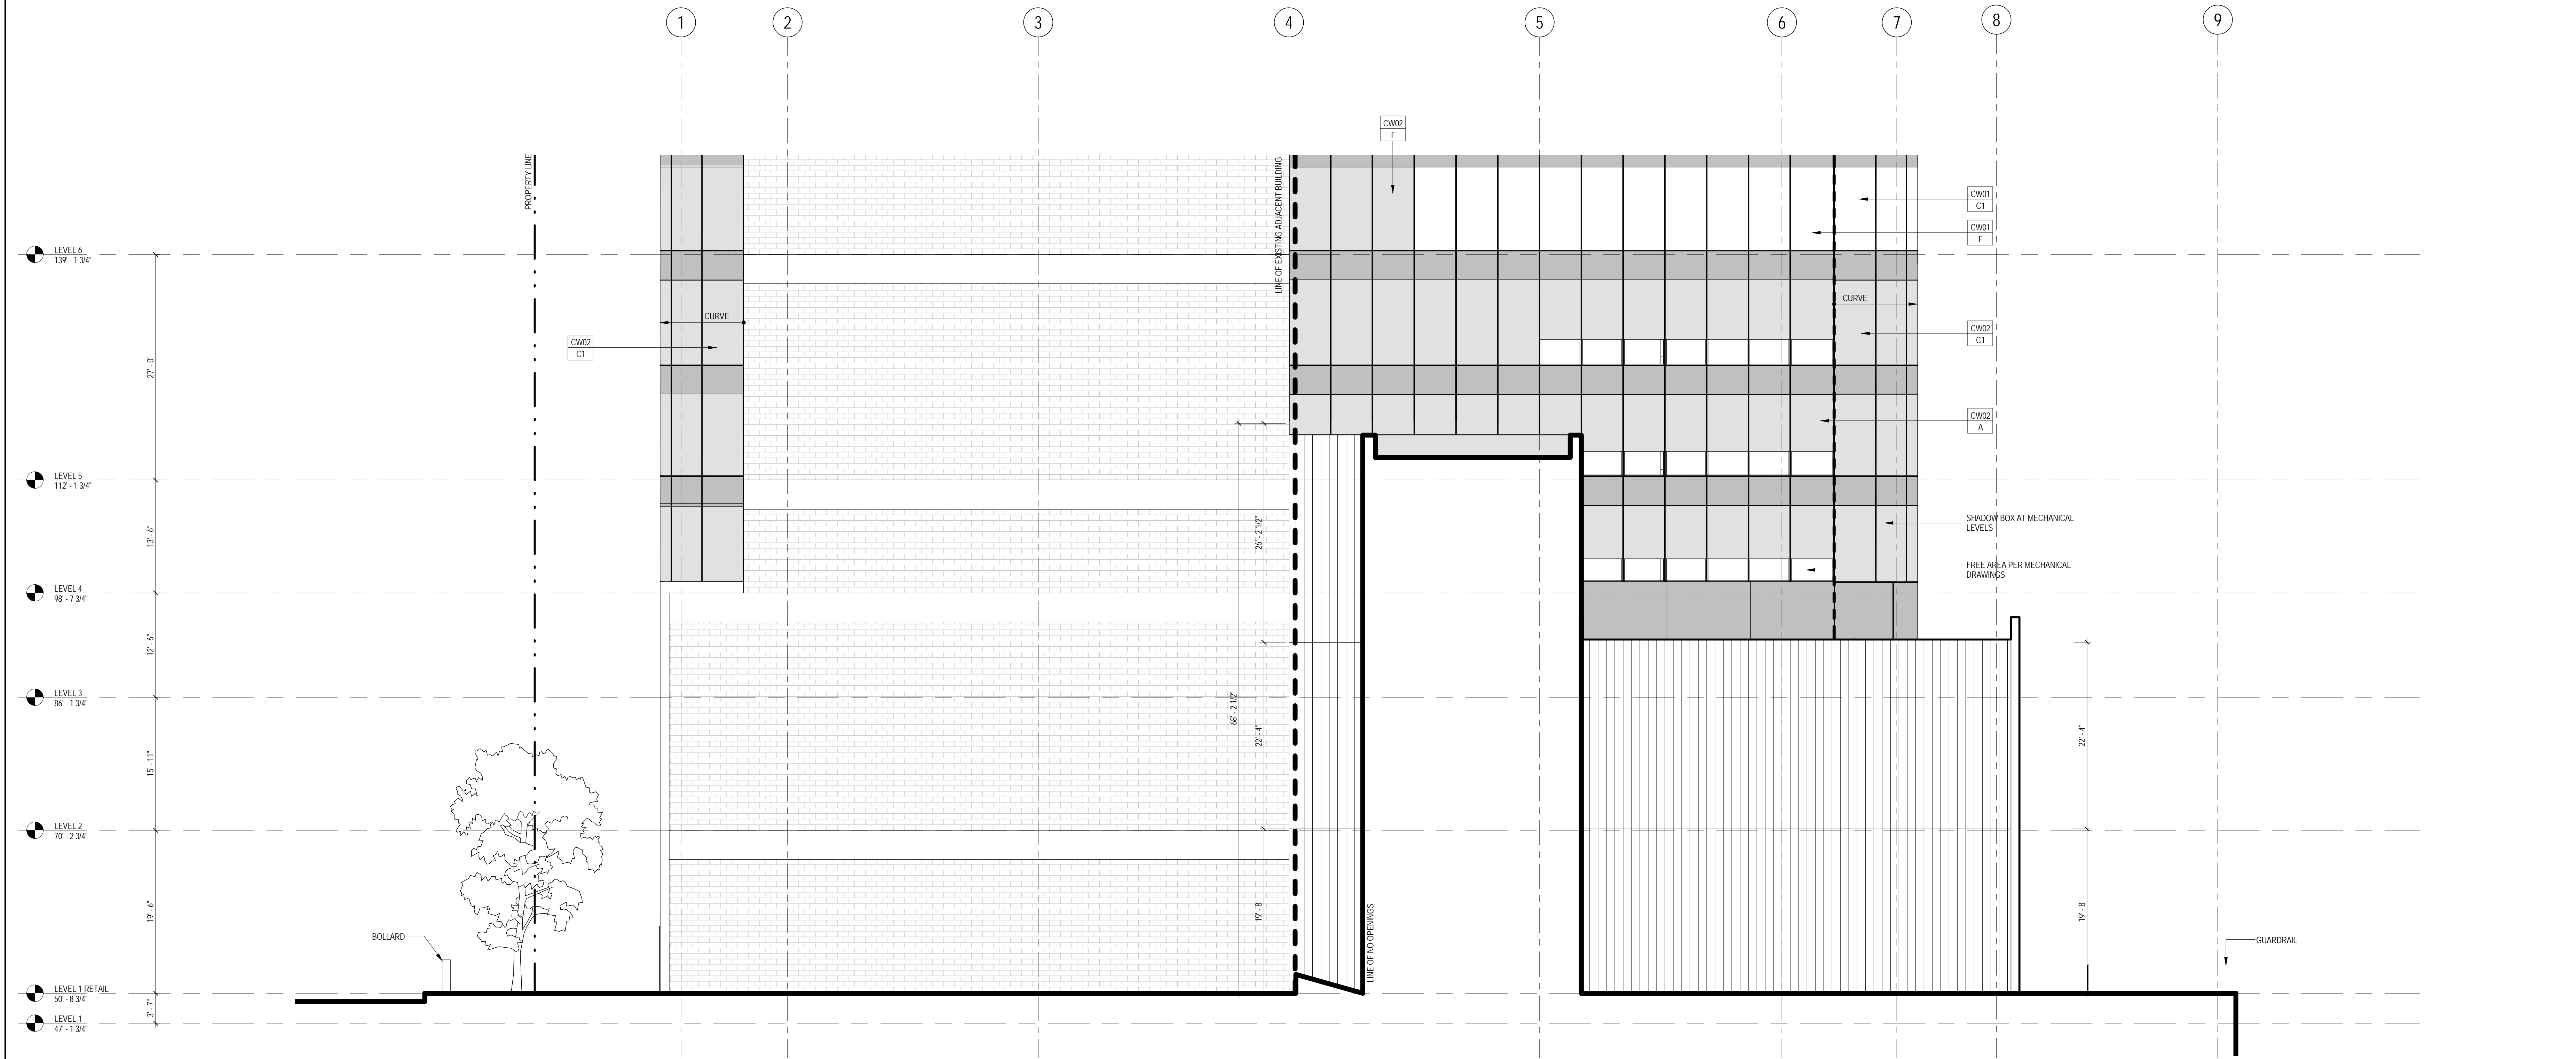SCALE: 1/8" = 1'-0"

SHEET NOTES

1. SEE 500 SERIES FOR ENCLOSURE DETAILS
2. ALL DOCUMENTATION OF 424 WEST 33RD STREET IS PRELIMINARY. VERIFY EXISTING CONDITIONS.
3. VERIFY EXISTING CONDITIONS OF ADJACENT LOFT BUILDING, LOCATION OF FOUNDATION WALL AND EXTENT OF CURTAIN WALL SEPARATIONS TO BE VERIFIED IN FIELD.
4. SEE FNA SERIES FOR FACADE MAINTENANCE DETAILS.



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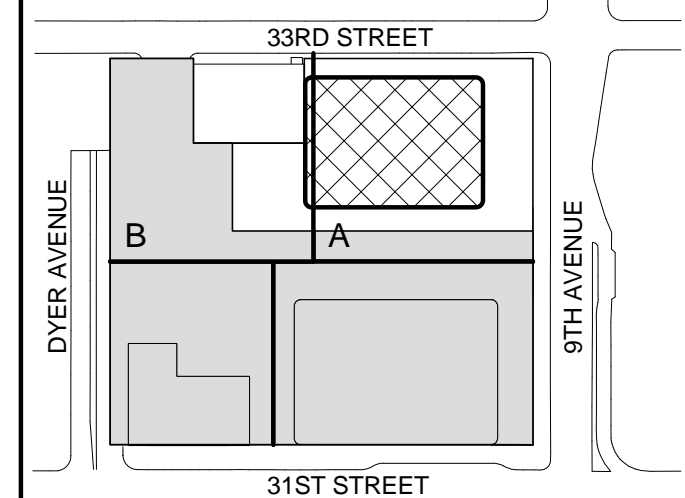
Entek Engineering LLC
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3 20 DEC 2013 ISSUED FOR FOUNDATION PERMIT
2 15 NOV 2013 ISSUED FOR DD PROGRESS PRICING
1 12 JUL 2013 ISSUED FOR 50% DESIGN DEVELOPMENT

No. Date Description

Sheet Name:

**ENLARGED
ELEVATIONS AT
GROUND FLOOR**

Project No.:

207150

Date:

12 SEPT 2014

Scale:

1/8" = 1'-0"

File No.:

A-211

B-SCAN Sheet No.:

A-211.00

Sheet No.:

A-211

Page No.:

68 OF 30

LEGEND

SHADOW BOX 1

SHADOW BOX 2

3 ENLARGED BUILDING ELEVATION AT RETAIL CORE LOOKING NORTH

1 ENLARGED BUILDING ELEVATION AT RETAIL CORE LOOKING SOUTH
SCALE: 1/8" = 1'-0"

Scale: 1/8" = 1'-0"	A-225
File No.:	Page No. 59 OF 30



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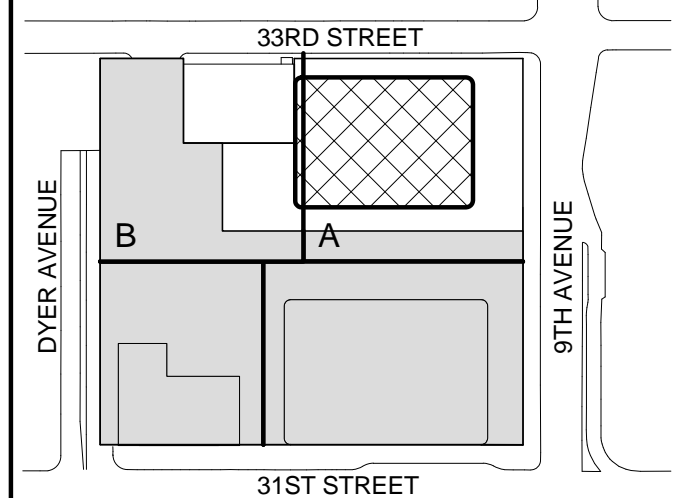
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Key Plan:





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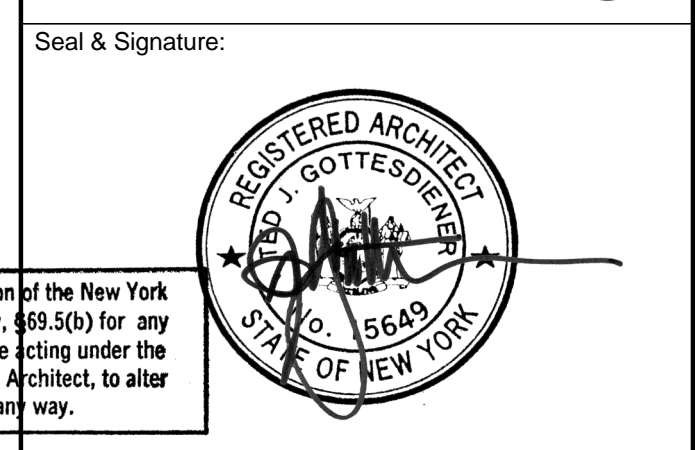
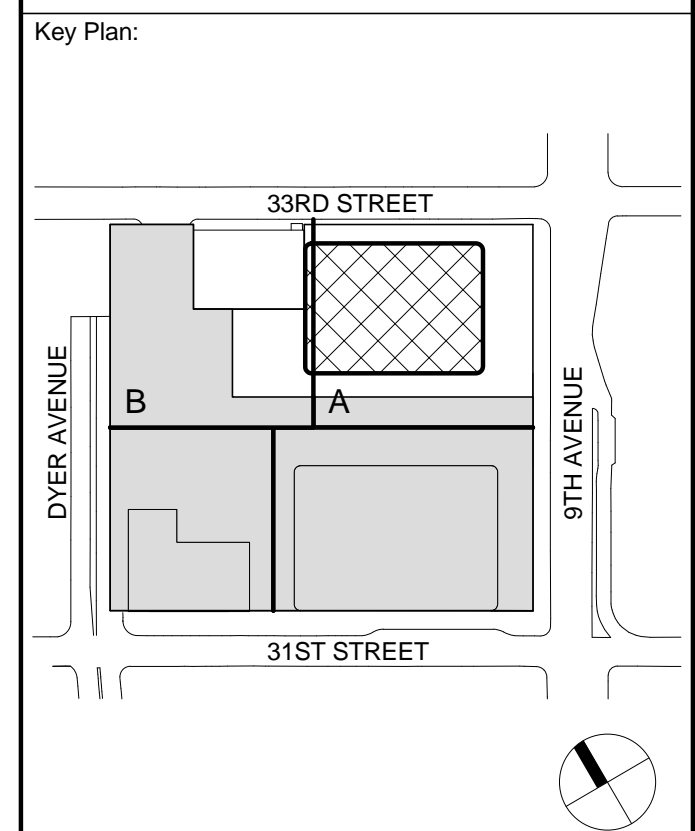
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No.	Date	Description
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3	20 DEC 2013	ISSUED FOR FOUNDATION PERMIT
2	15 NOV 2013	ISSUED FOR DD PROGRESS PRICING
1	12 JUL 2013	ISSUED FOR 50% DESIGN DEVELOPMENT

ENLARGED
ELEVATIONS AT
ROOF


Project No.: 207150	B-SCAN Sheet No.: A-231.00
Date: 12 SEPT 2014	Sheet No.: A-231
Scale: 1/8" = 1'-0"	Page No.: 71 OF 30
File No.: A-231	

SHEET NOTES


- SEE 500 SERIES FOR ENCLOSURE DETAILS
- ALL DOCUMENTATION OF 424 WEST 33RD STREET IS PRELIMINARY. VERIFY EXISTING CONDITIONS.
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- SEE FM SERIES FOR FACADE MAINTENANCE DETAILS.

LEGEND

- SHADOW BOX 1
- SHADOW BOX 2

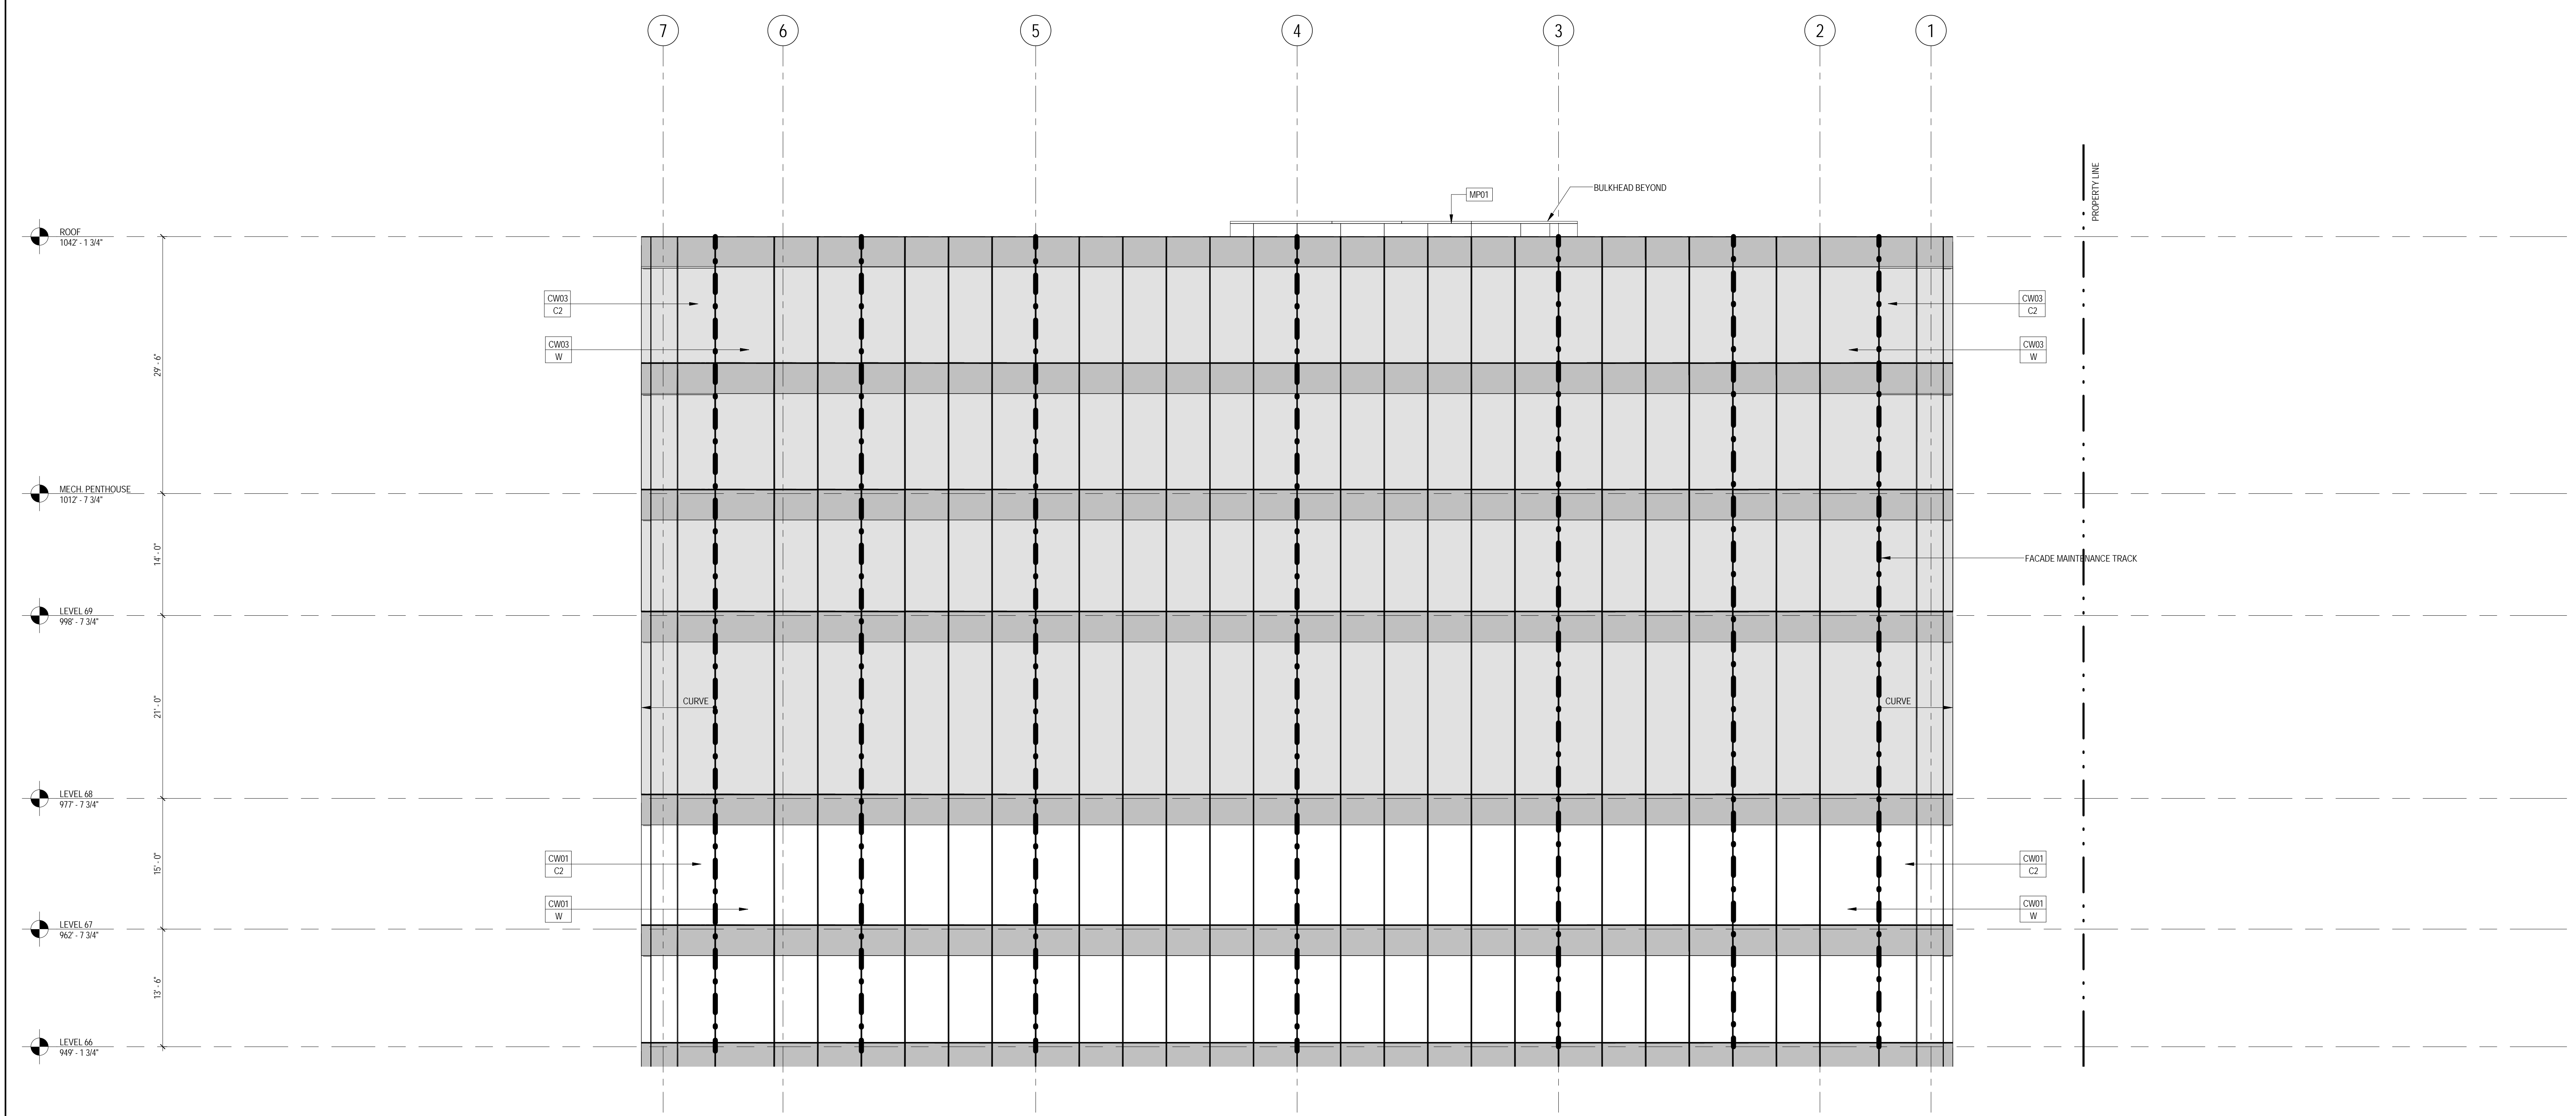


2 ENLARGED ELEVATION AT ROOF LOOKING WEST
SCALE: 1/8" = 1'-0"

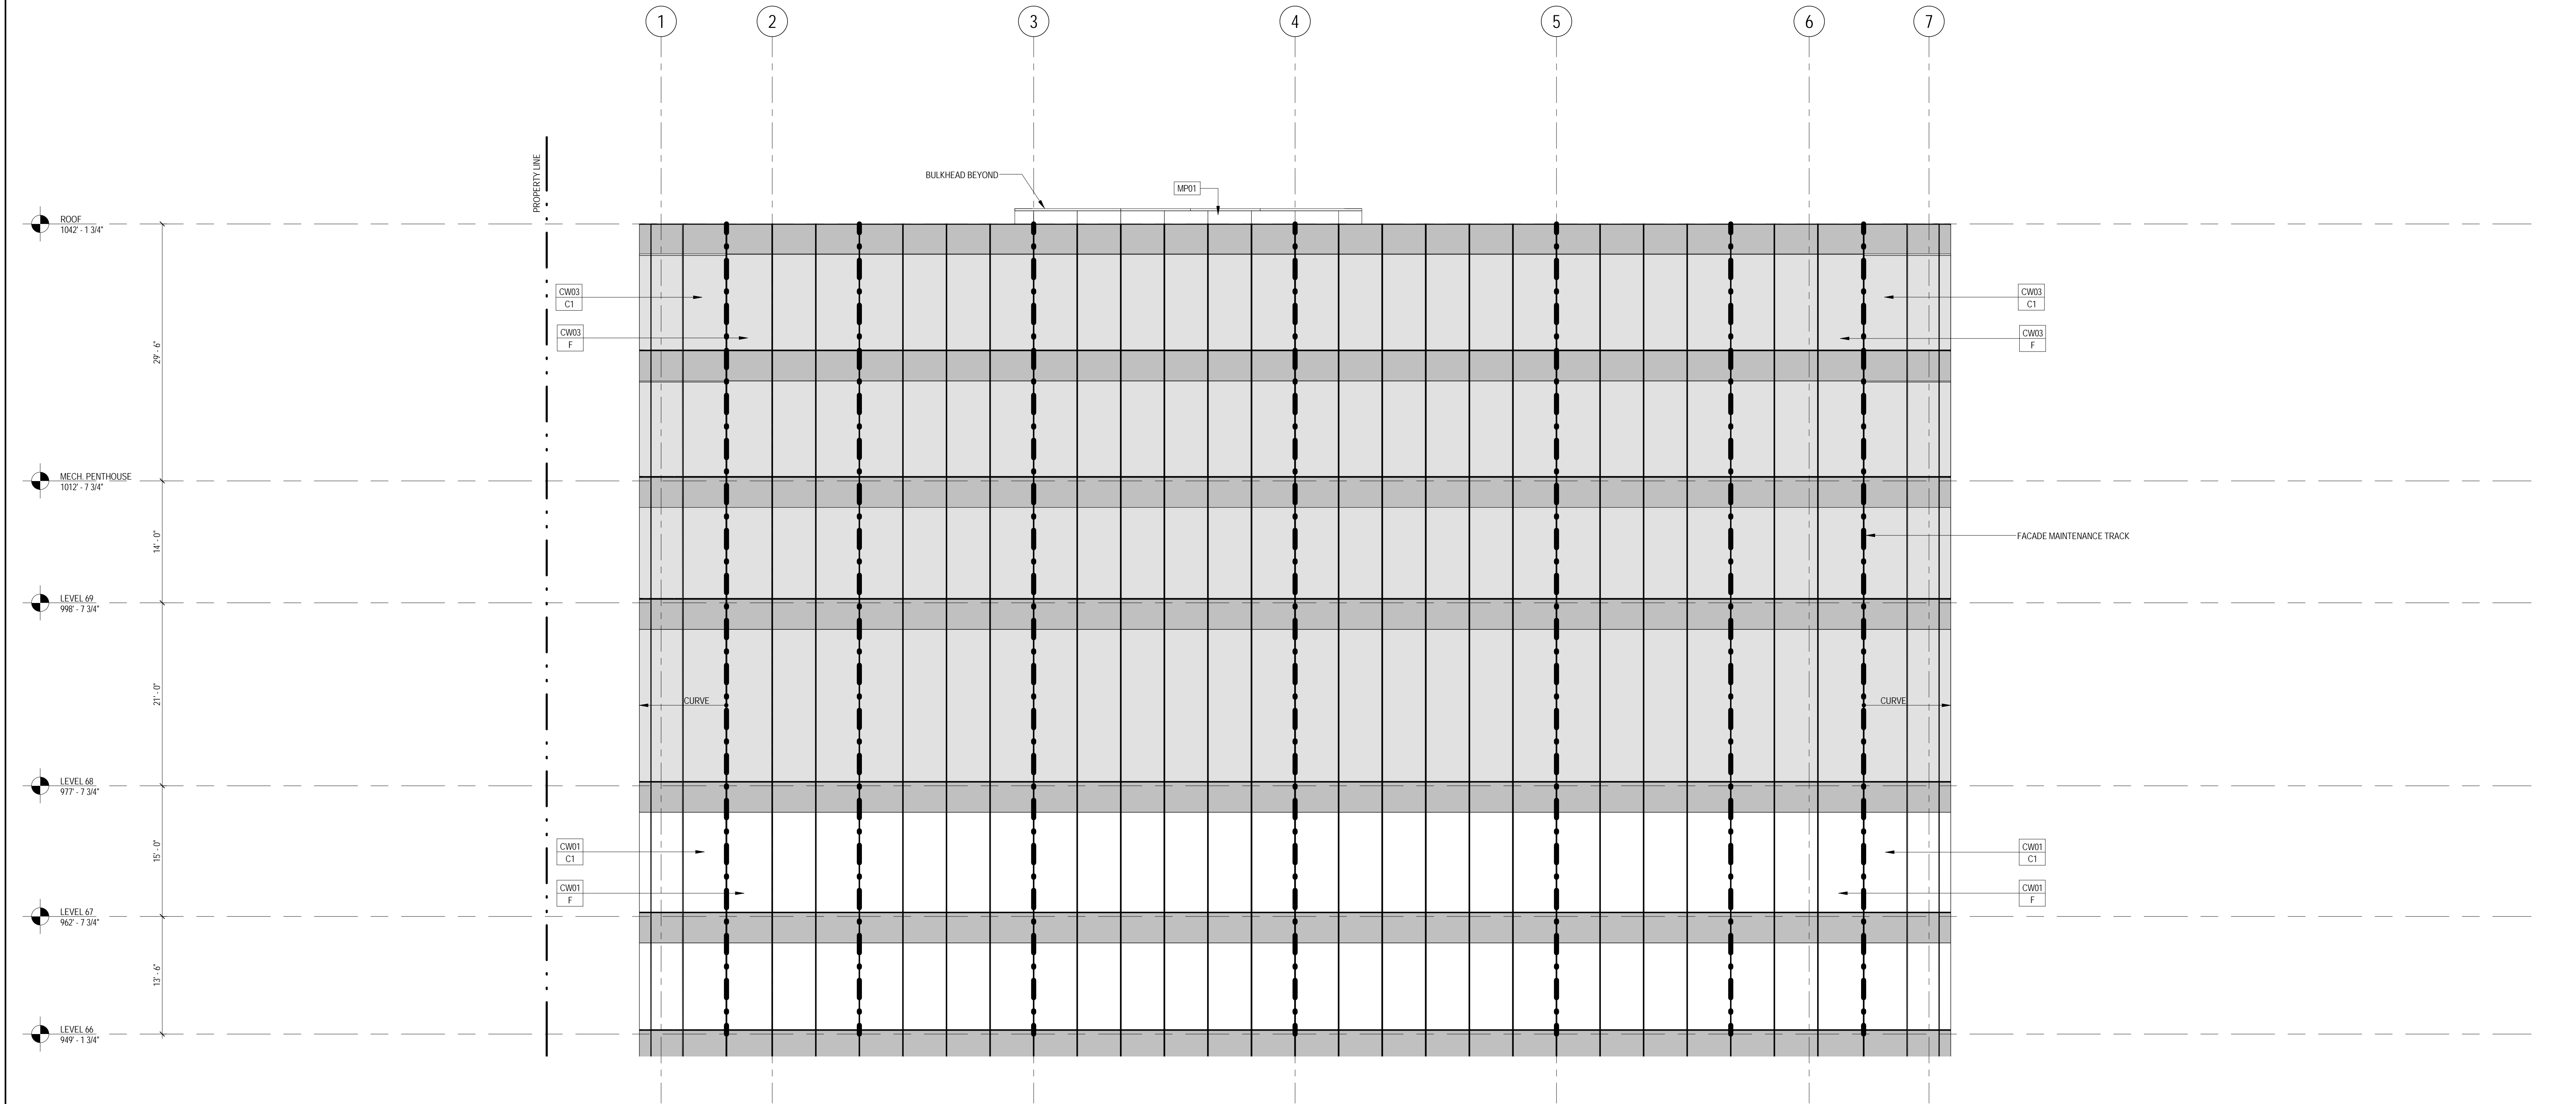


1 ENLARGED ELEVATION AT ROOF LOOKING EAST
SCALE: 1/8" = 1'-0"

ROOF 1042'-1.34"
MECH. PENTHOUSE ROOF 1030'-1.34"
MECH. PENTHOUSE 1017'-7.34"
LEVEL 69 998'-7.34"
LEVEL 68 977'-7.34"
LEVEL 67 962'-7.34"
LEVEL 66 949'-1.34"
LEVEL 65 935'-7.34"
LEVEL 64 922'-1.34"
LEVEL 63 908'-7.34"
LEVEL 62 895'-1.34"
LEVEL 61 881'-7.34"
LEVEL 60 868'-1.34"
LEVEL 59 854'-7.34"
LEVEL 58 841'-1.34"
LEVEL 57 827'-7.34"
LEVEL 56 814'-1.34"
LEVEL 55 800'-7.34"
LEVEL 54 787'-1.34"
LEVEL 53 772'-7.34"
LEVEL 52 760'-1.34"
LEVEL 51 746'-7.34"
LEVEL 50 733'-1.34"
LEVEL 49 719'-7.34"
LEVEL 48 706'-1.34"
LEVEL 47 692'-7.34"
LEVEL 46 679'-1.34"
LEVEL 45 665'-7.34"
LEVEL 44 652'-1.34"
LEVEL 43 638'-7.34"
LEVEL 42 625'-1.34"
LEVEL 41 611'-7.34"
LEVEL 40 598'-1.34"
LEVEL 39 584'-7.34"
LEVEL 38 571'-1.34"
LEVEL 37 557'-7.34"
LEVEL 36 544'-1.34"
LEVEL 35 530'-7.34"
LEVEL 34 517'-1.34"
LEVEL 33 503'-7.34"
LEVEL 32 490'-1.34"
LEVEL 31 476'-7.34"
LEVEL 30 462'-1.34"
LEVEL 29 449'-7.34"
LEVEL 28 436'-1.34"
LEVEL 27 422'-7.34"
LEVEL 26 409'-1.34"
LEVEL 25 395'-7.34"
LEVEL 24 382'-1.34"
LEVEL 23 368'-7.34"
LEVEL 22 355'-1.34"
LEVEL 21 341'-7.34"
LEVEL 20 328'-1.34"
LEVEL 19 314'-7.34"
LEVEL 18 301'-1.34"
LEVEL 17 287'-7.34"
LEVEL 16 274'-1.34"
LEVEL 15 260'-7.34"
LEVEL 14 247'-1.34"
LEVEL 13 233'-7.34"
LEVEL 12 220'-1.34"
LEVEL 11 206'-7.34"
LEVEL 10 192'-1.34"
LEVEL 9 179'-7.34"
LEVEL 8 166'-1.34"
LEVEL 7 152'-7.34"
LEVEL 6 139'-1.34"
LEVEL 5 122'-1.34"
LEVEL 4 98'-7.34"
LEVEL 3 86'-1.34"
LEVEL 2 70'-2.34"
LEVEL 1 RETAIL 50'-6.34"
LEVEL 1 47'-1.34"
CELLAR B 30'-7.34"
CELLAR B1 12'-7.34"
CELLAR B1 PITS 5'-4.14"

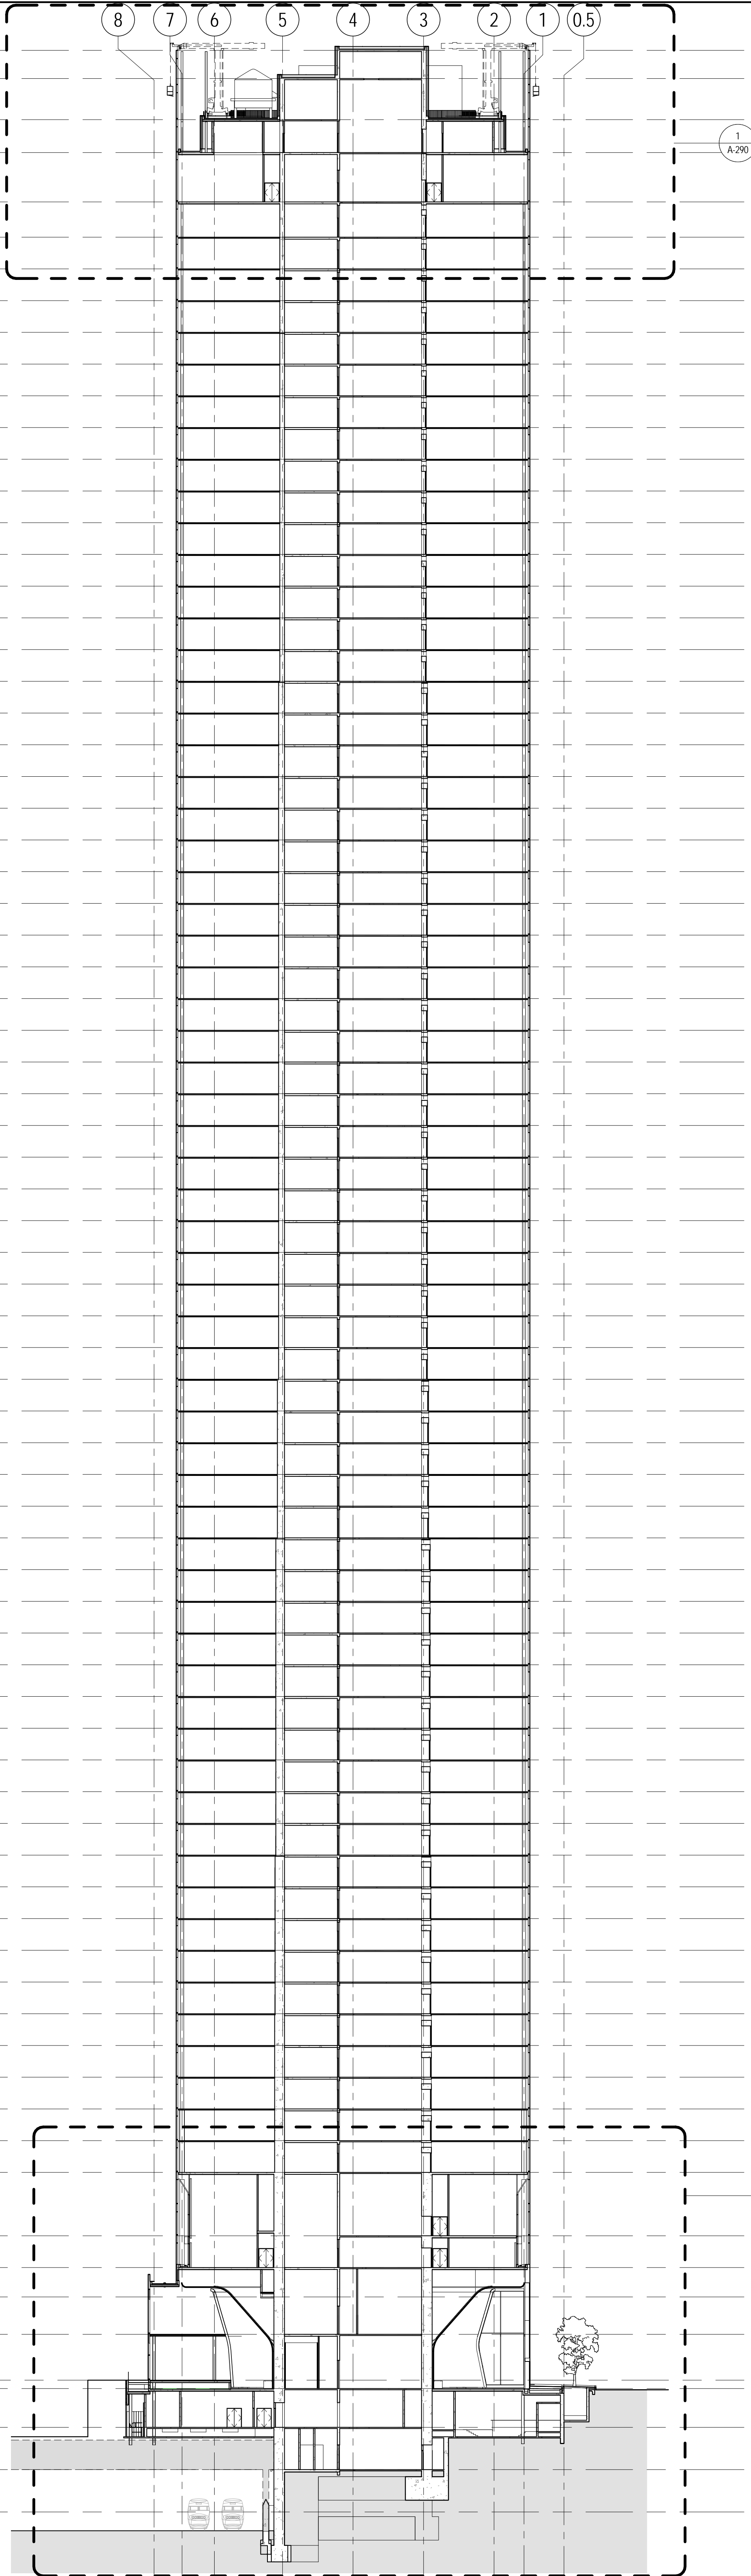


ROOF 1042'-1.34"
MECH. PENTHOUSE ROOF 1030'-1.34"
MECH. PENTHOUSE 1017'-7.34"
LEVEL 69 998'-7.34"
LEVEL 68 977'-7.34"
LEVEL 67 962'-7.34"
LEVEL 66 949'-1.34"
LEVEL 65 935'-7.34"
LEVEL 64 922'-1.34"
LEVEL 63 908'-7.34"
LEVEL 62 895'-1.34"
LEVEL 61 881'-7.34"
LEVEL 60 868'-1.34"
LEVEL 59 854'-7.34"
LEVEL 58 841'-1.34"
LEVEL 57 827'-7.34"
LEVEL 56 814'-1.34"
LEVEL 55 800'-7.34"
LEVEL 54 787'-1.34"
LEVEL 53 772'-7.34"
LEVEL 52 760'-1.34"
LEVEL 51 746'-7.34"
LEVEL 50 733'-1.34"
LEVEL 49 719'-7.34"
LEVEL 48 706'-1.34"
LEVEL 47 692'-7.34"
LEVEL 46 679'-1.34"
LEVEL 45 665'-7.34"
LEVEL 44 652'-1.34"
LEVEL 43 638'-7.34"
LEVEL 42 625'-1.34"
LEVEL 41 611'-7.34"
LEVEL 40 598'-1.34"
LEVEL 39 584'-7.34"
LEVEL 38 571'-1.34"
LEVEL 37 557'-7.34"
LEVEL 36 544'-1.34"
LEVEL 35 530'-7.34"
LEVEL 34 517'-1.34"
LEVEL 33 503'-7.34"
LEVEL 32 490'-1.34"
LEVEL 31 476'-7.34"
LEVEL 30 462'-1.34"
LEVEL 29 449'-7.34"
LEVEL 28 436'-1.34"
LEVEL 27 422'-7.34"
LEVEL 26 409'-1.34"
LEVEL 25 395'-7.34"
LEVEL 24 382'-1.34"
LEVEL 23 368'-7.34"
LEVEL 22 355'-1.34"
LEVEL 21 341'-7.34"
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LEVEL 1 RETAIL 50'-6.34"
LEVEL 1 47'-1.34"
CELLAR B 30'-7.34"
CELLAR B1 12'-7.34"
CELLAR B1 PITS 5'-4.14"

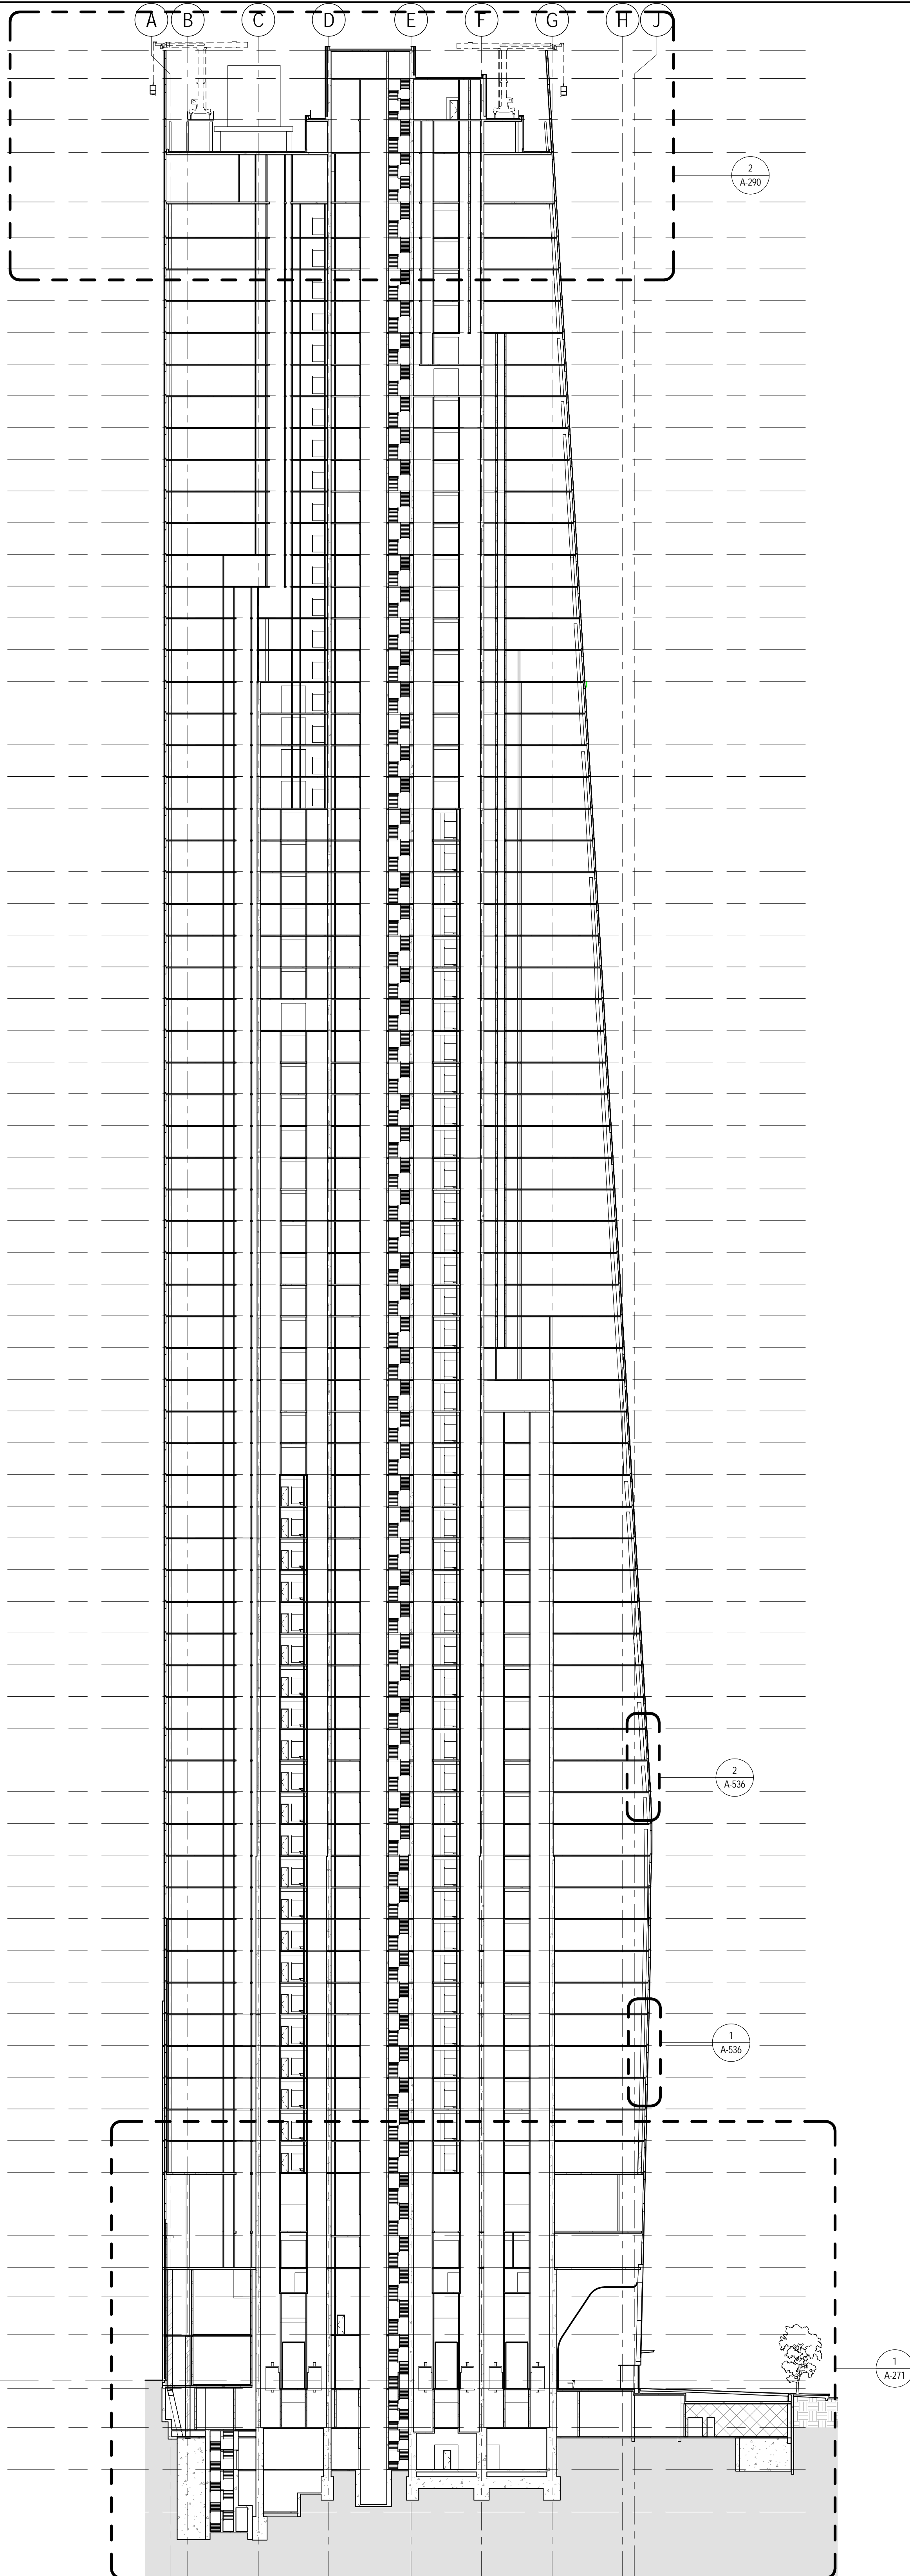

SHEET NOTES

1. SEE 500 SERIES FOR ENCLOSURE DETAILS.
2. ALL DOCUMENTATION OF 424 WEST 33RD STREET IS PRELIMINARY. VERIFY EXISTING CONDITIONS.
3. VERIFY EXISTING CONDITIONS OF ADJACENT LOFT BUILDING. LOCATION OF FOUNDATION WALL AND EXTENT OF CURTAIN WALL SEPARATIONS TO BE VERIFIED IN FIELD.
4. SEE FM SERIES FOR FACADE MAINTENANCE DETAILS.

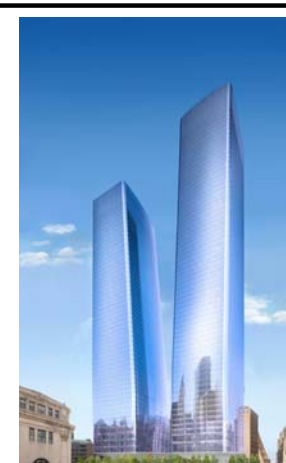

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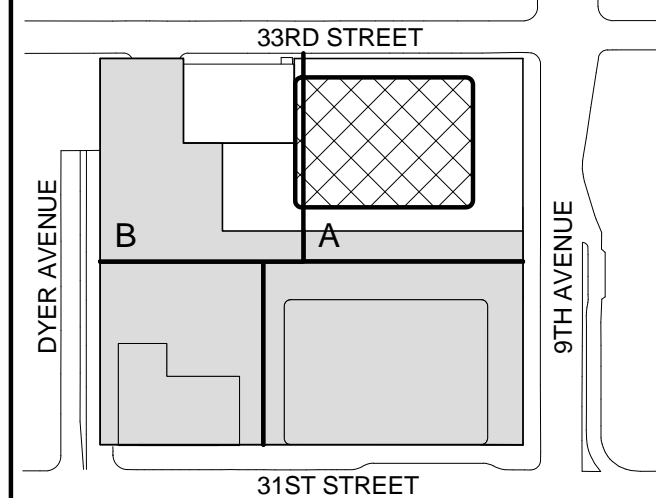
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Key Plan:



Seal & Signature:



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No.	Date	Description
7	12 SEPT 2014	ISSUED FOR FOUNDATION PERMIT
6	20 JUN 2014	ISSUED FOR FOUNDATION BID
5	20 JUN 2014	ISSUED FOR FOUNDATION PERMIT
4	20 DEC 2013	ISSUED FOR FOUNDATION PERMIT
3	15 NOV 2013	ISSUED FOR 50% PROGRESS PRICING
2	12 JUL 2013	ISSUED FOR 90% DESIGN DEVELOPMENT
1	19 MAR 2013	ISSUED FOR RECONCILIATION

Sheet Name:


BUILDING SECTIONS

Project No.: 207150	B-SCAN Sheet No.: A-250.00
Date: 12 SEPT 2014	Sheet No.: A-250
Scale: 1/32" = 1'-0"	Page No.: 63 OF 30
File No.: A-250	

1/1/2014 5:24 PM

1 ENLARGED SECTION AT GROUND FLOOR LOOKING WEST

SCALE: 1/8" = 1'-0"

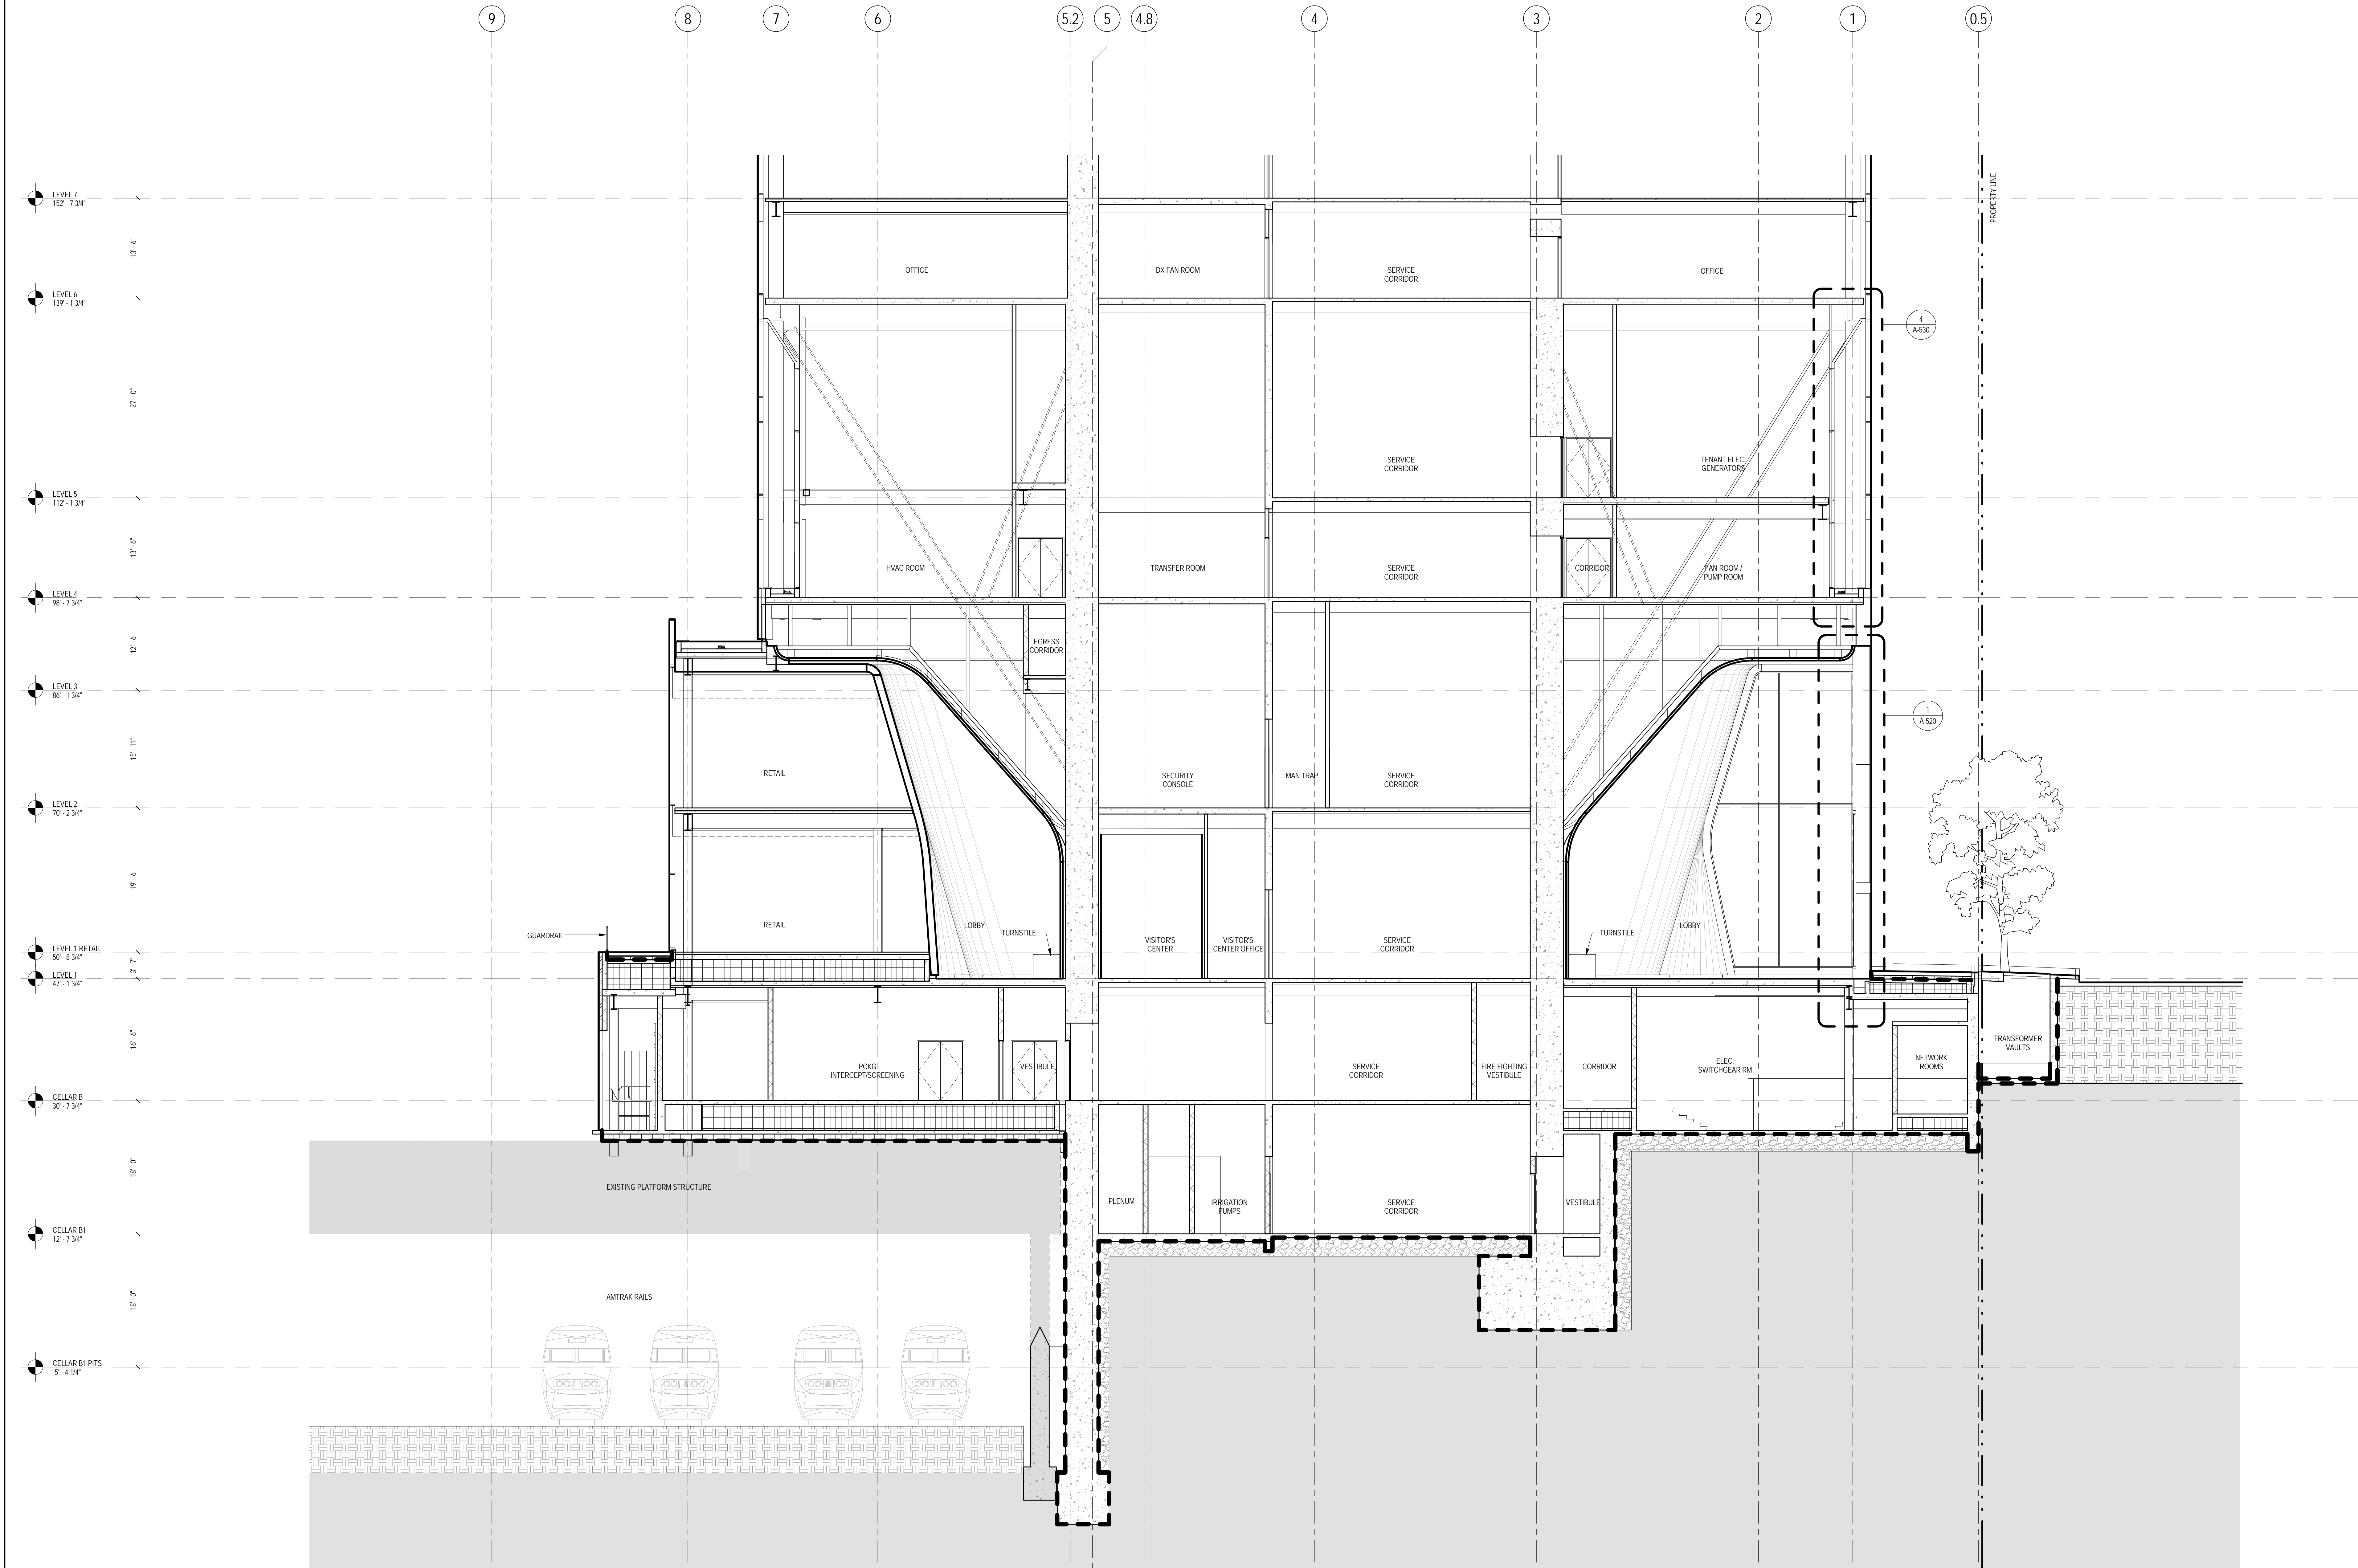

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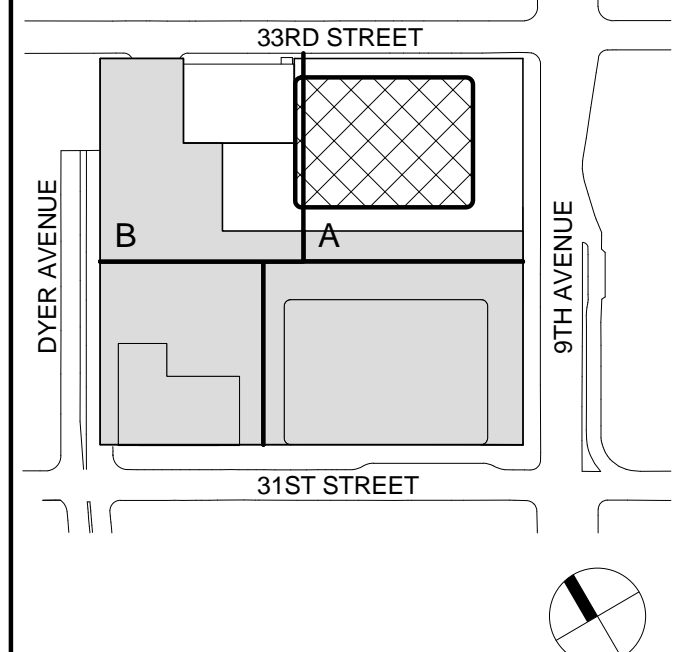
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3	15 NOV 2013	ISSUED FOR 30% PROGRESS PRICING
2	12 JUL 2013	ISSUED FOR 90% DESIGN DEVELOPMENT
1	19 MAR 2012	ISSUED FOR RECONCILIATION

No. Date Description

Sheet Name:

ENLARGED
SECTION AT
LOBBY


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Date: 12 SEPT 2014	Sheet No.: A-270
Scale: 1/8" = 1'-0"	Page No.: 64 OF 30
File No.: A-270	

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1

ENLARGED SECTION AT GROUND FLOOR LOOKING NORTH

SCALE: 1/8" = 1'-0"

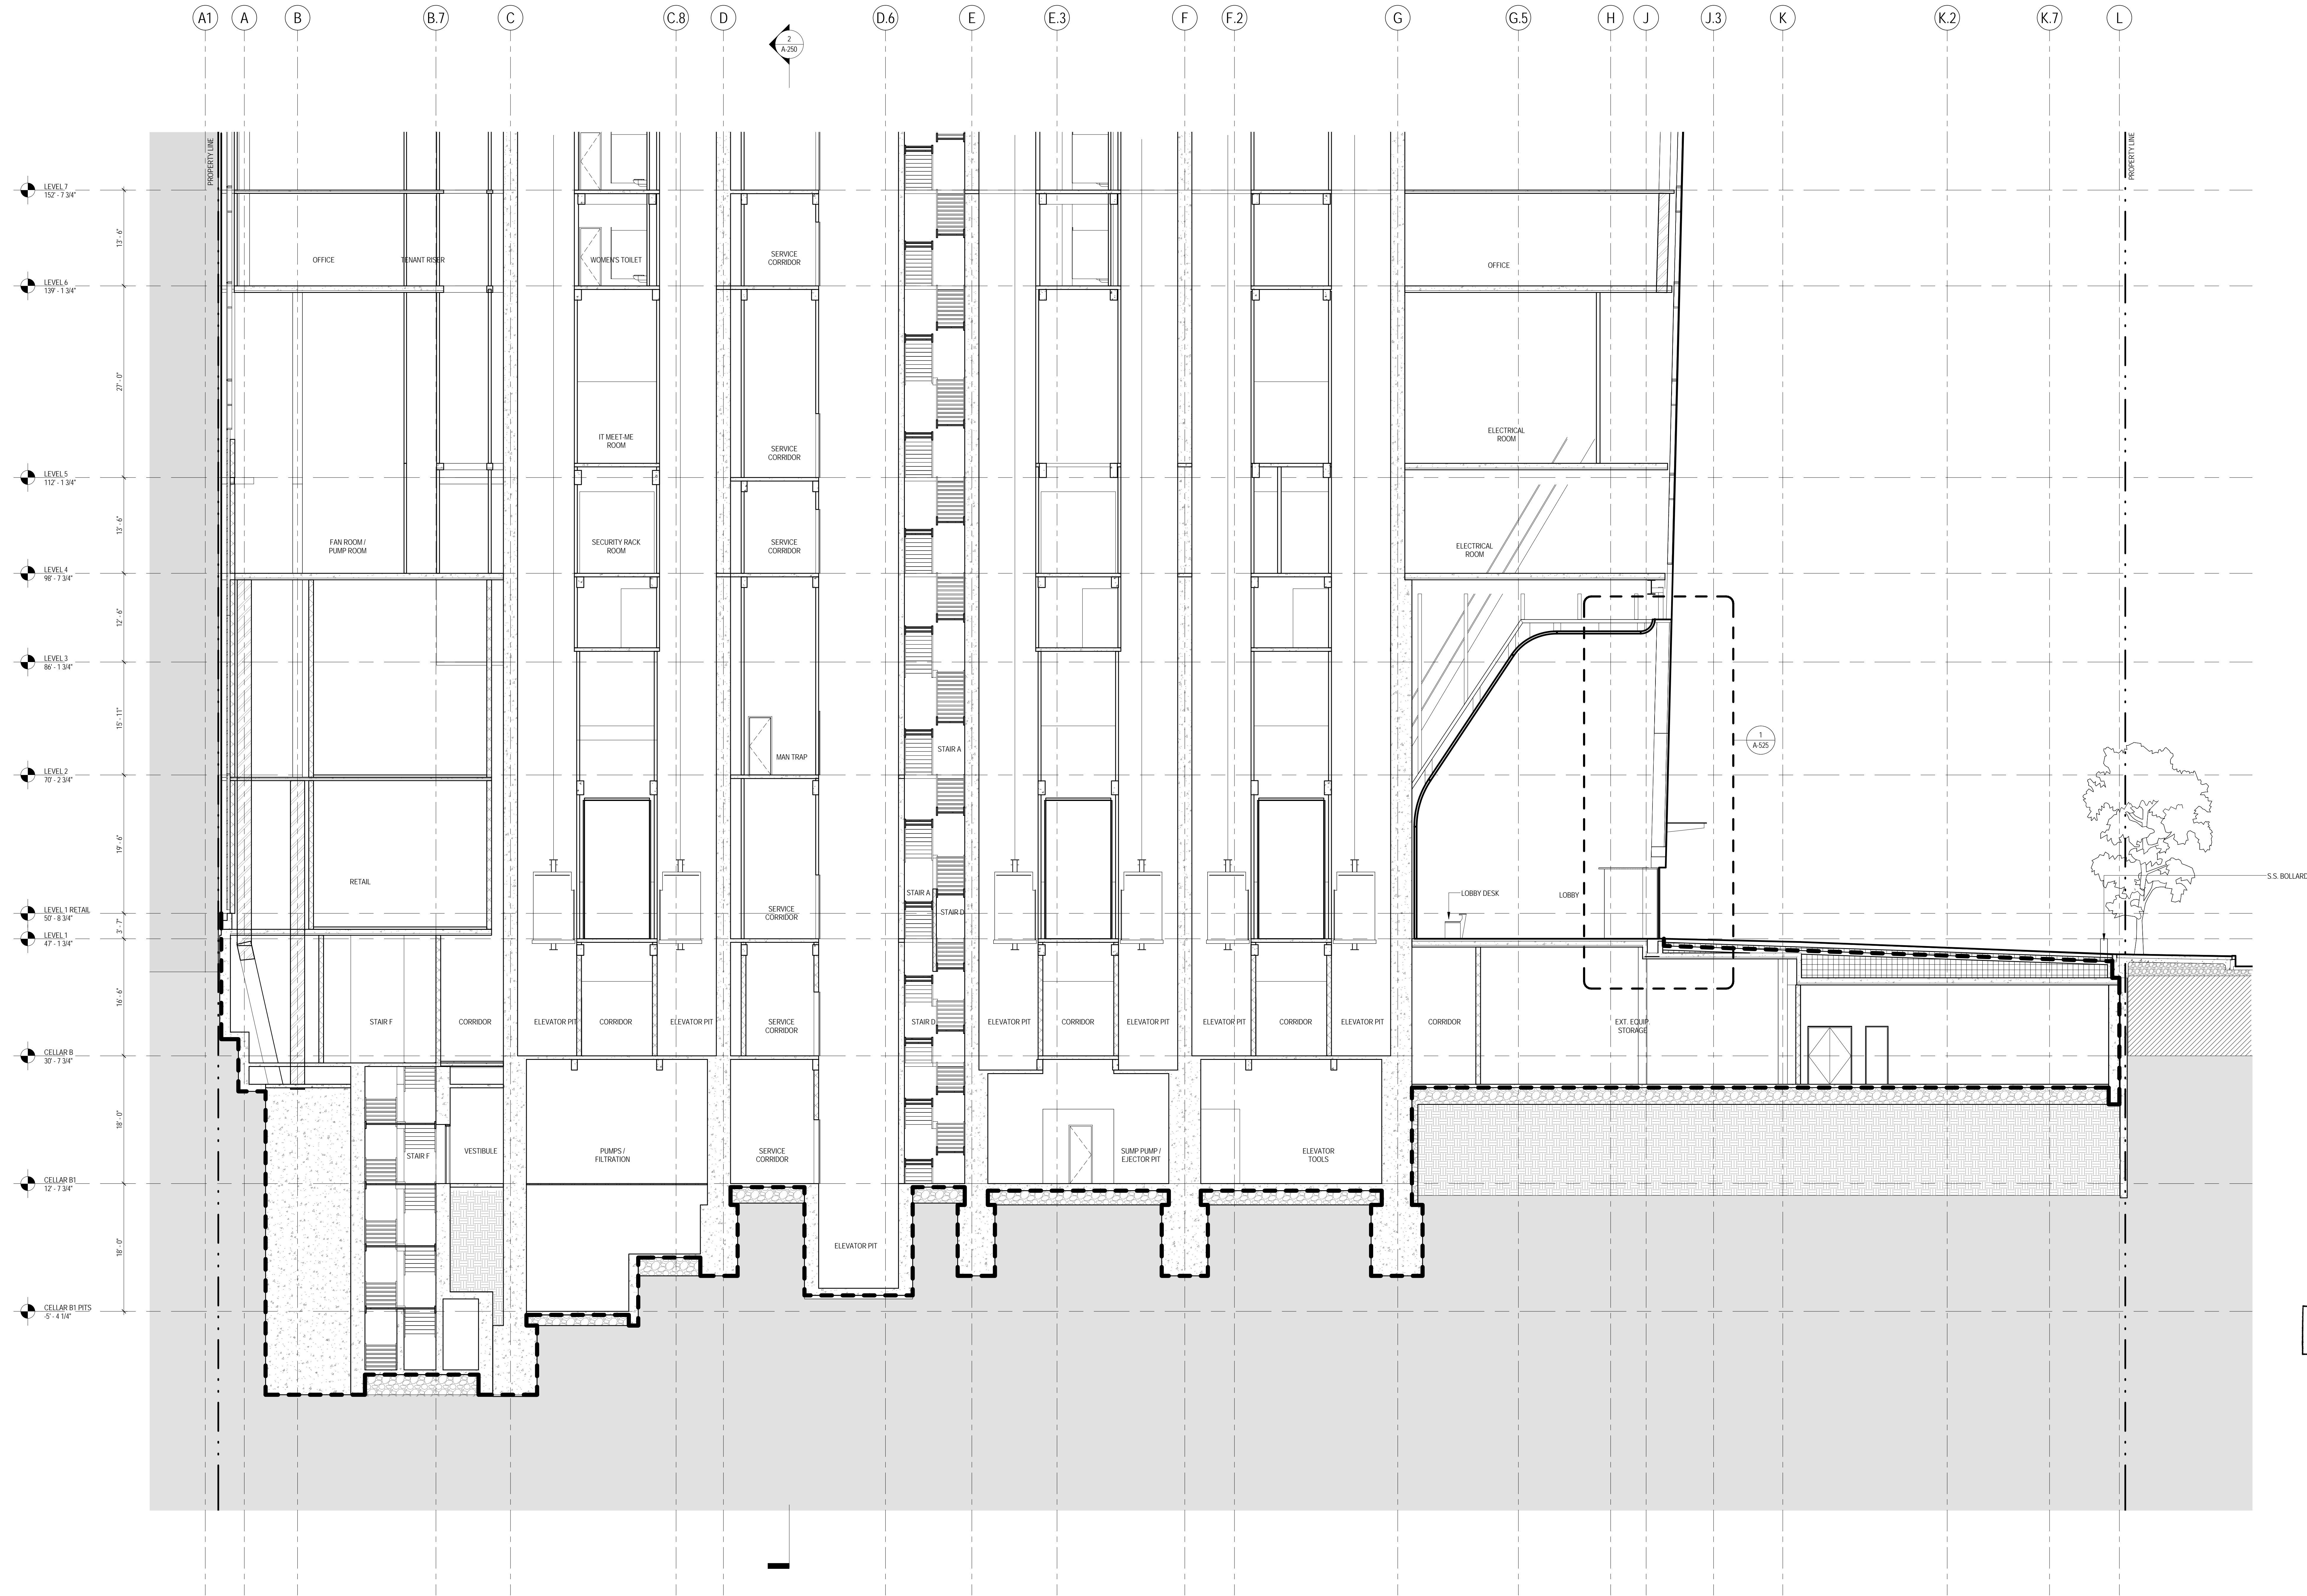

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Facade Maintenance Consultant


Entek Engineering LLC
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Key Plan:



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3	15 NOV 2013	ISSUED FOR 30% PROGRESS PRICING
2	12 JUL 2013	ISSUED FOR 90% DESIGN DEVELOPMENT
1	19 MAR 2012	ISSUED FOR RECONCILIATION

No. Date Description

Sheet Name:

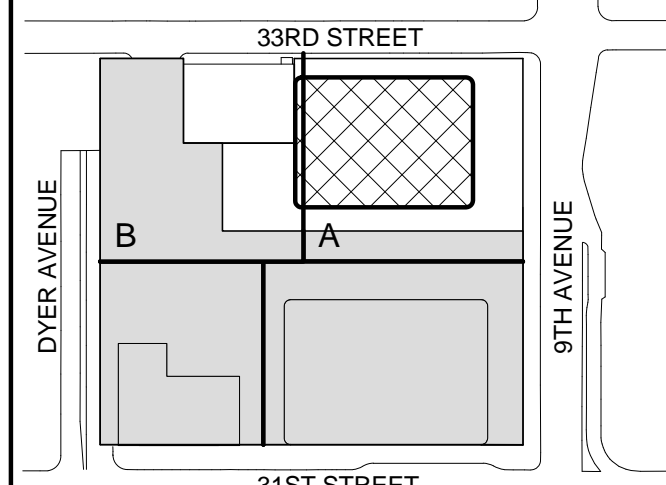ENLARGED
SECTION AT
LOBBY

Project No.: 207150

Date: 12 SEPT 2014


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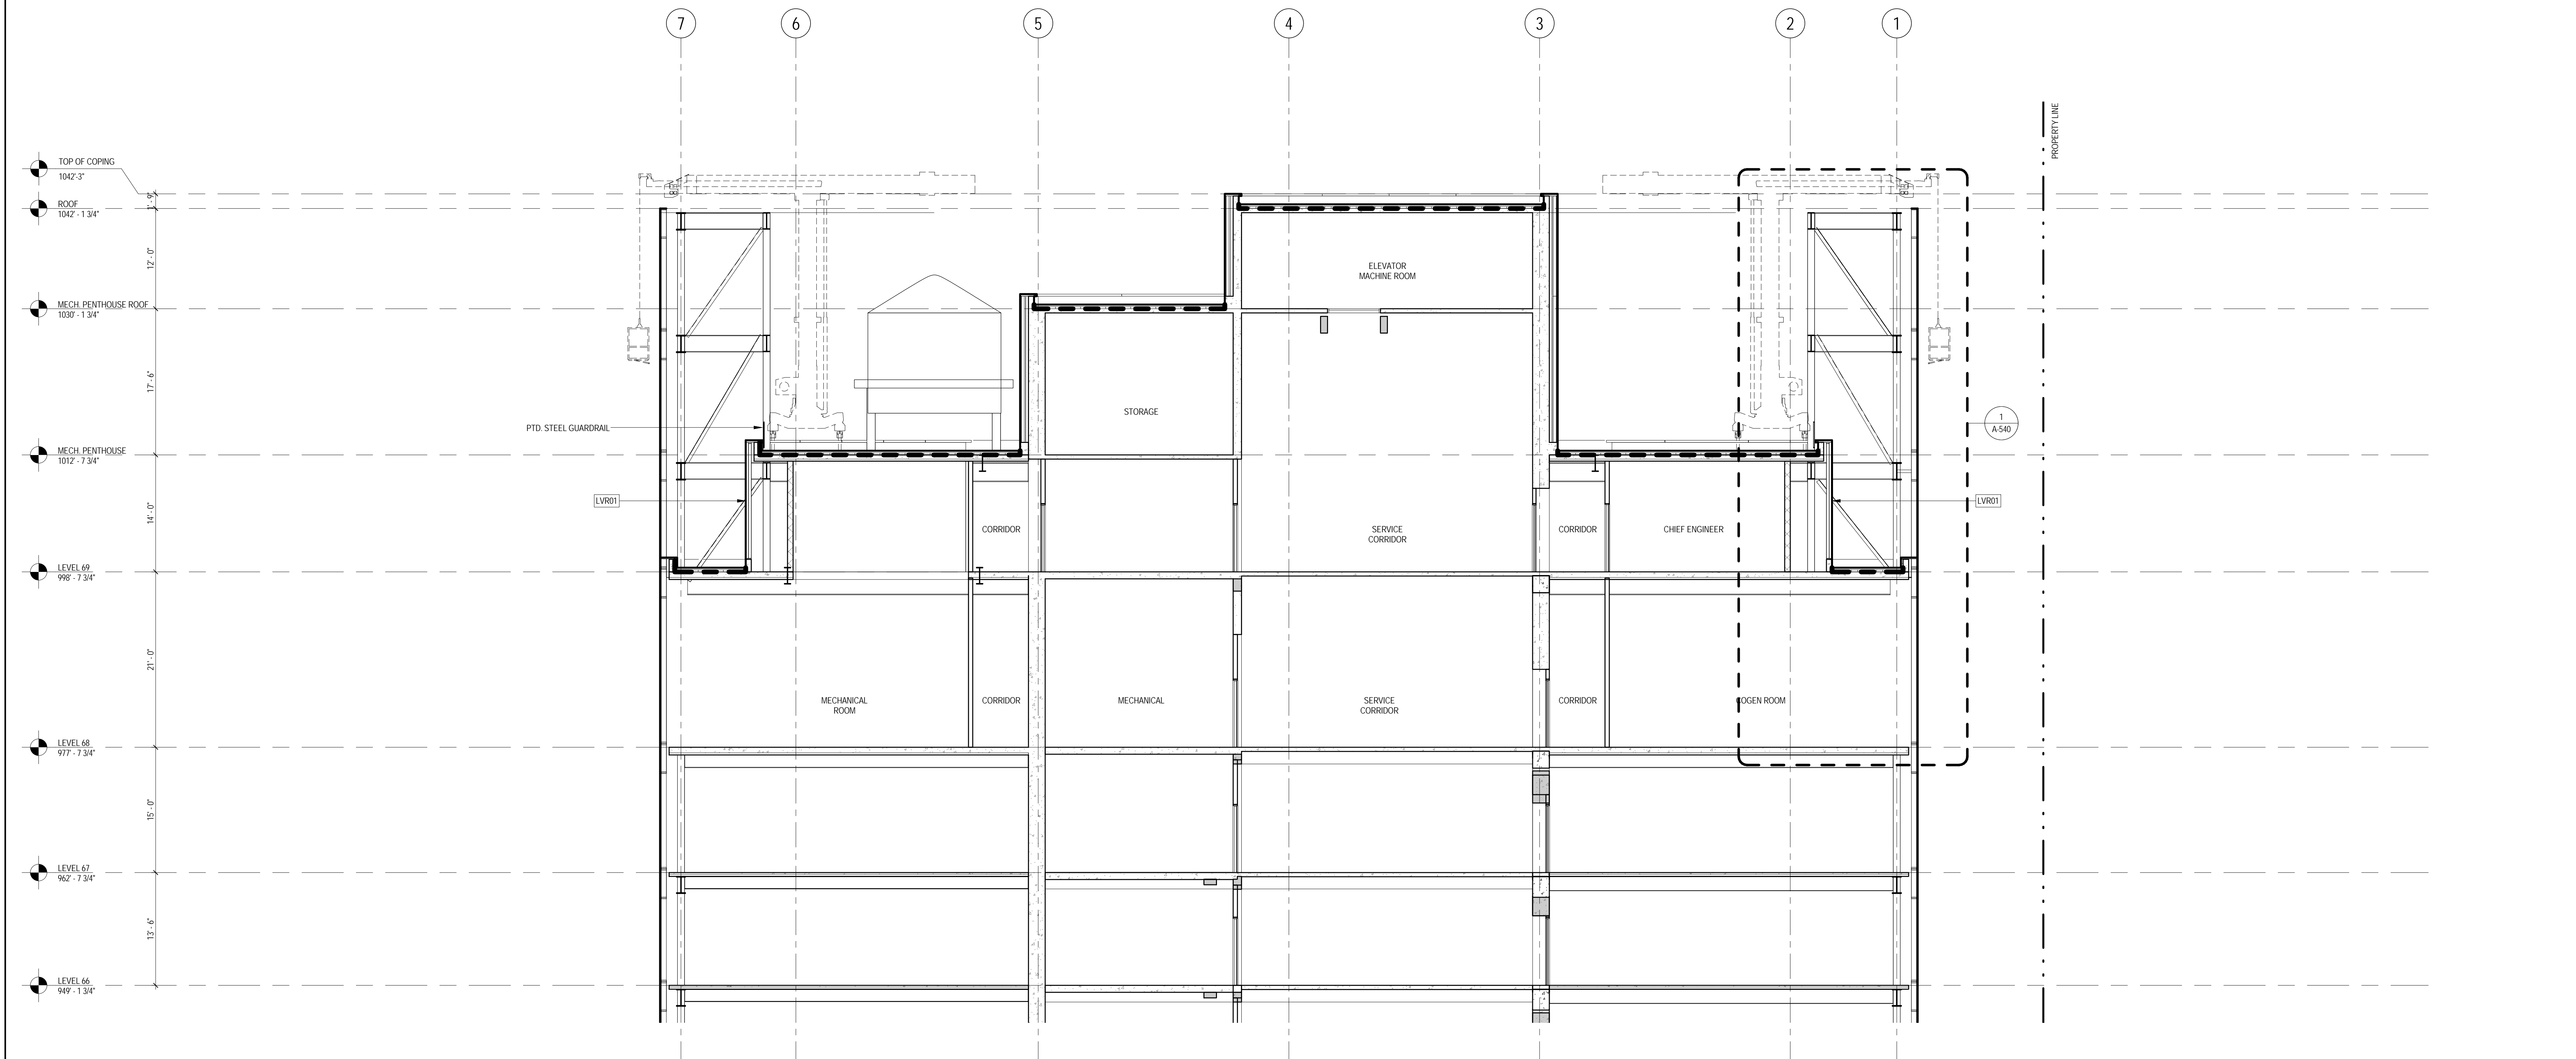
B-SCAN Sheet No.: A-271.00

Sheet No.: A-271

Page No.: 66 OF 30



2 ENLARGED SECTION AT ROOF LOOKING NORTH
SCALE: 1/8" = 1'-0"

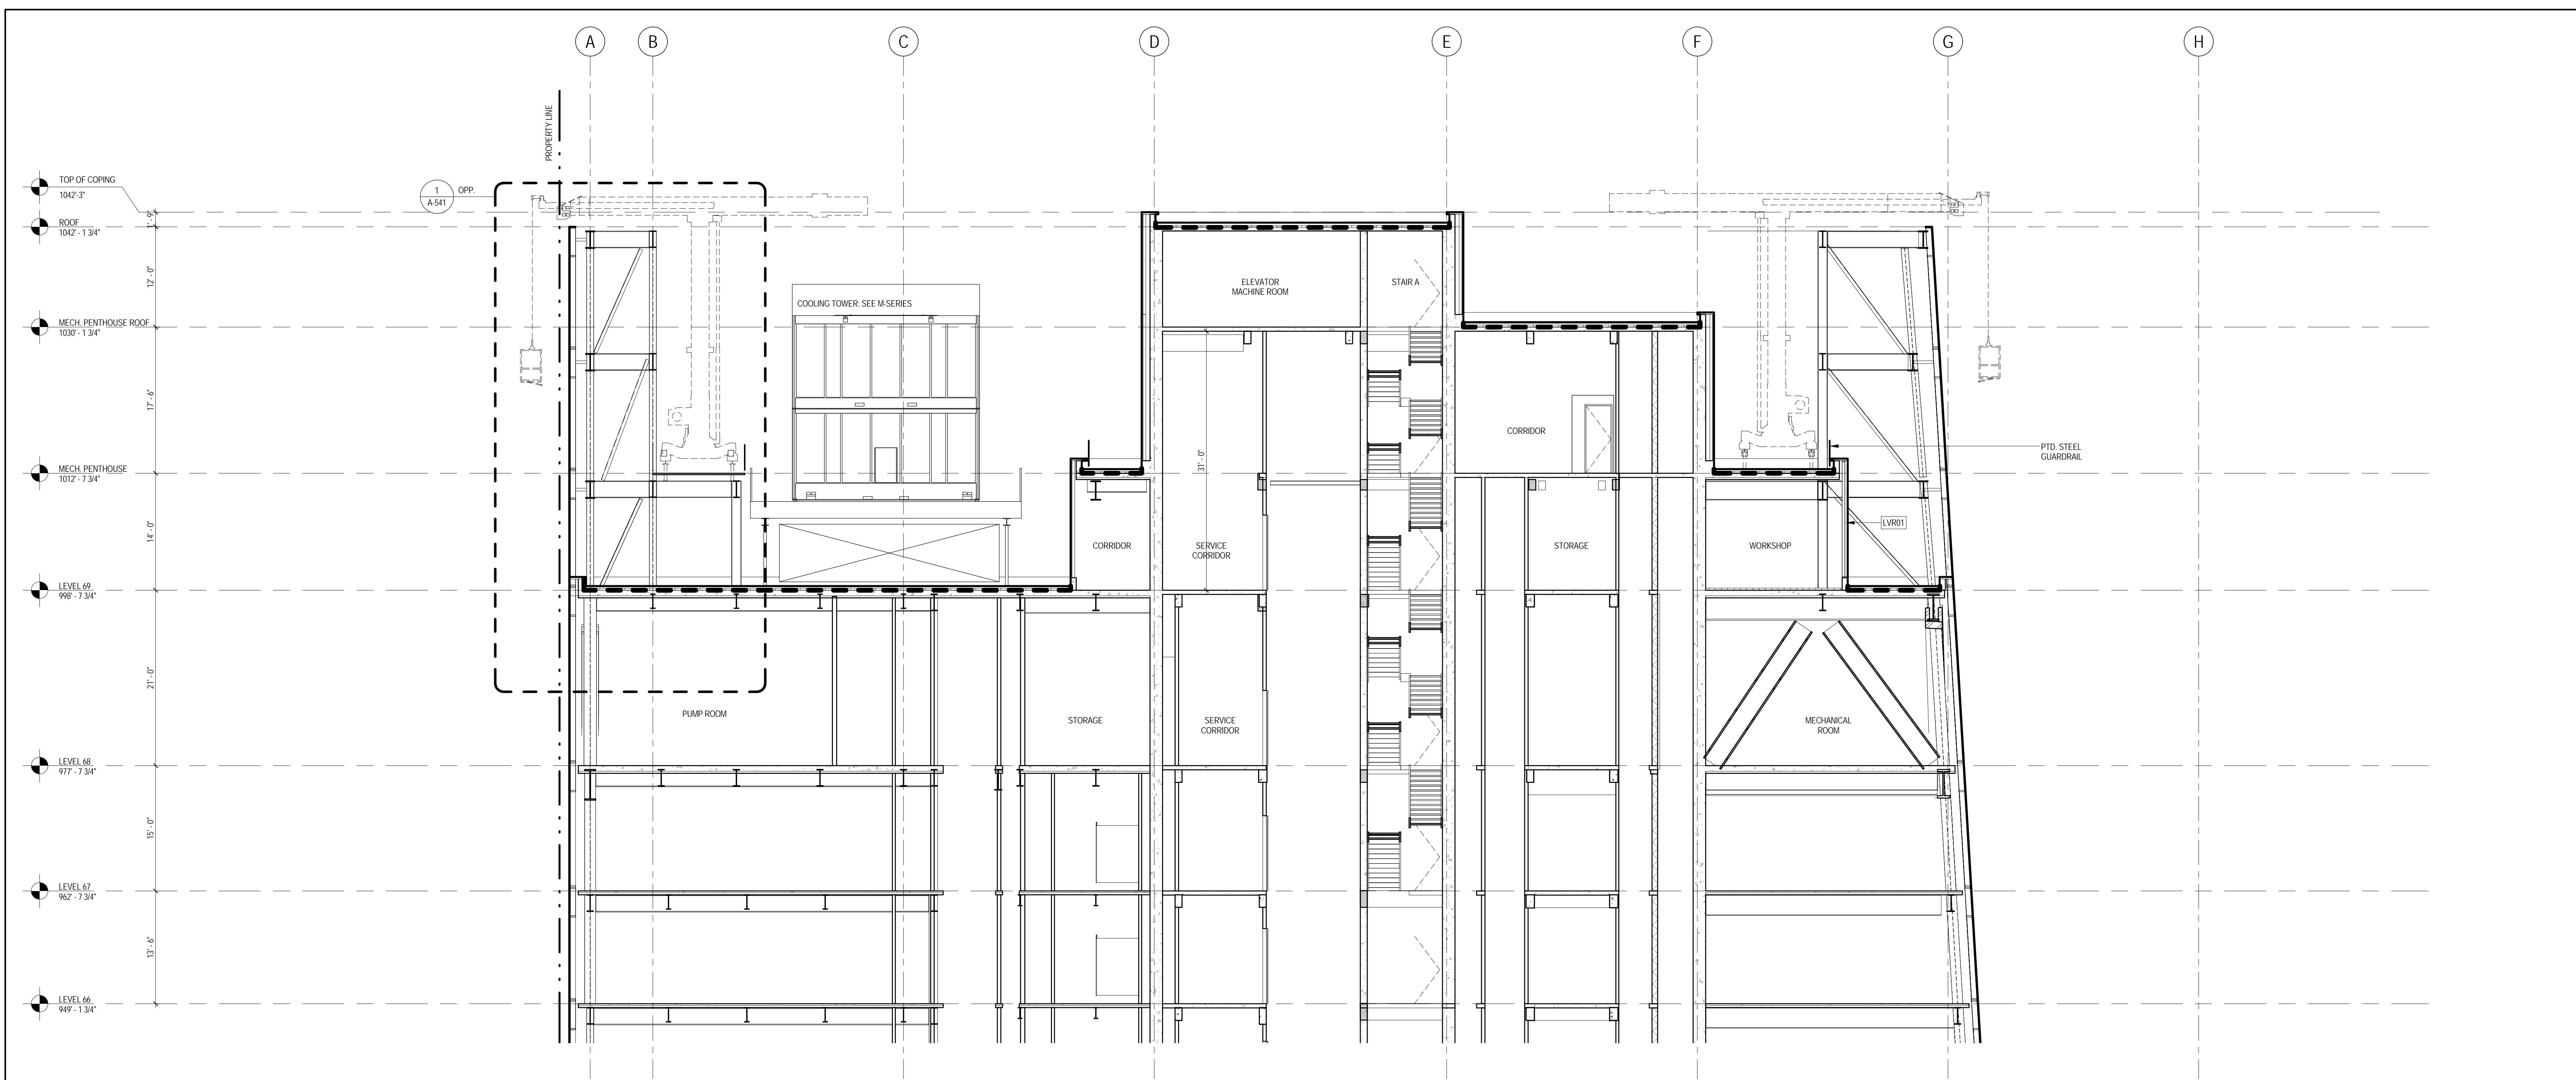

1 ENLARGED SECTION AT ROOF LOOKING EAST
SCALE: 1/8" = 1'-0"

SHEET NOTES

1. SEE S00 SERIES FOR ENCLOSURE DETAILS.
2. ALL DOCUMENTATION OF 424 WEST 13RD STREET IS PRELIMINARY. VERIFY EXISTING CONDITIONS.
3. VERIFY EXISTING CONDITIONS OF ADJACENT LOFT BUILDING LOCATION OF FOUNDATION WALL AND EXTENT OF CURTAIN WALL SEPARATIONS TO BE VERIFIED IN FIELD.
4. SEE FM SERIES FOR FACADE MAINTENANCE DETAILS.



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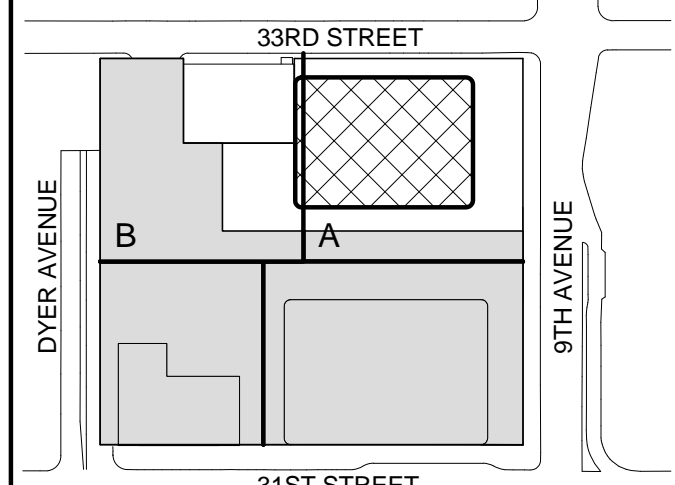
Entek Engineering LLC
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- | | | |
|---|--------------|-----------------------------------|
| 5 | 12 SEPT 2014 | ISSUED FOR FOUNDATION PERMIT |
| 4 | 20 DEC 2013 | ISSUED FOR FOUNDATION PERMIT |
| 3 | 15 NOV 2013 | ISSUED FOR 50% PROGRESS PRICING |
| 2 | 12 JUL 2013 | ISSUED FOR 90% DESIGN DEVELOPMENT |
| 1 | 19 MAR 2012 | ISSUED FOR RECONCILIATION |

No. Date Description
Sheet Name:

ENLARGED
SECTIONS AT
ROOF

Project No.: 207150	B-SCAN Sheet No.: A-290.00
Date: 12 SEPT 2014	Sheet No.: A-290
Scale: 1/8" = 1'-0"	Page No.: 79 OF 30
File No.: A-290	

SHEET NOTES

1. ALL BUILDING ELEVATIONS (IN FEET) REFERENCED TO THE NORTH AMERICAN VERTICAL DATUM OF 1988 (NAV88).
2. FOR GENERAL NOTES, BUILDING DEPARTMENT NOTES, AND CLARIFICATION OF THE WORK NOTES REFER TO SHEET NO. C-005.
3. FOR ARCHITECTURAL ABBREVIATIONS, LEGEND OF SYMBOLS & MATERIALS, AND MOUNTING HEIGHTS REFER TO SHEET NO. C-006.
4. FOR DOOR FINISH SCHEDULE SEE A-700 SERIES DRAWINGS.
5. FOR DOOR SCHEDULE SEE A-700 SERIES DRAWINGS. FOR DOOR HARDWARE SPECIFICATION SEE TECHNICAL SPECIFICATION SECTION B5070.
6. FOR PARTITION TYPES SEE A-700 SERIES DRAWINGS.
7. ALL PARTITIONS SHALL BE TYPE DR UNO.
8. FOR REFLECTED CEILING PLANS SEE A-600 SERIES DRAWINGS. IF RCP IS NOT PROVIDED SEE MEPP/FASC/TEL SERVICE DRAWINGS FOR LOCATIONS OR ALL CEILING WALL MOUNTED DEVICES.
9. FOR STRUCTURAL COLUMNS, EDGE OF SLAB, AND CORE WORK POINTS SEE STRUCTURAL SERIES DRAWINGS, UNO.
10. REFER TO STRUCTURAL SERIES DRAWINGS FOR ALL STRUCTURAL WALL DESIGNATIONS AND DIMENSIONS.
11. REFER TO MEPP DRAWINGS FOR ALL MECHANICAL, ELECTRICAL, PLUMBING AND FIRE PROTECTION ROOM, RISER AND EQUIPMENT DESIGNATIONS.
12. FOR PROJECT WORK POINT REFER TO A-000 SERIES DRAWINGS.



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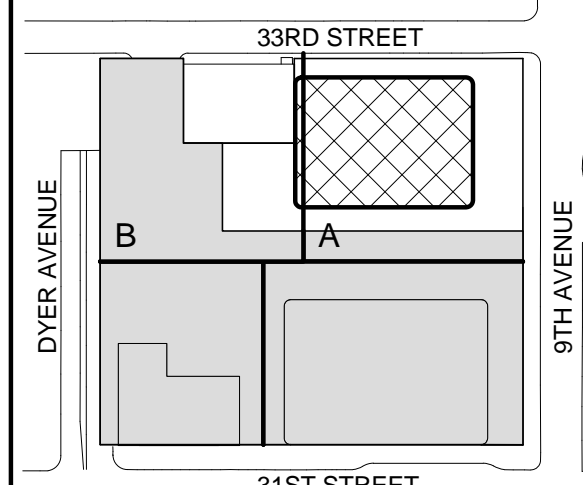
Entek Engineering LLC
166 Ames Street, Hackensack, NJ 07601

Wind Tunnel Consultant


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4	20 JUN 2014	ISSUED FOR FOUNDATION BID
3	20 JUN 2014	ISSUED FOR FOUNDATION PERMIT
2	20 DEC 2013	ISSUED FOR FOUNDATION PERMIT
1	19 NOV 2013	ISSUED FOR 00 PROGRESS PRICING

No. Date Description
Sheet Name:

CELLAR B1
ENLARGED PIT
PLAN

Project No.:

207150

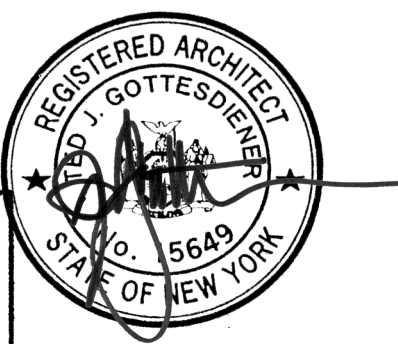Date:

20 JUN 2014

Scale:

1/4" = 1'-0"

File No.:

A-298

B-SCAN Sheet No.:


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Sheet No.:

A-298

Page No.:

66 OF 87

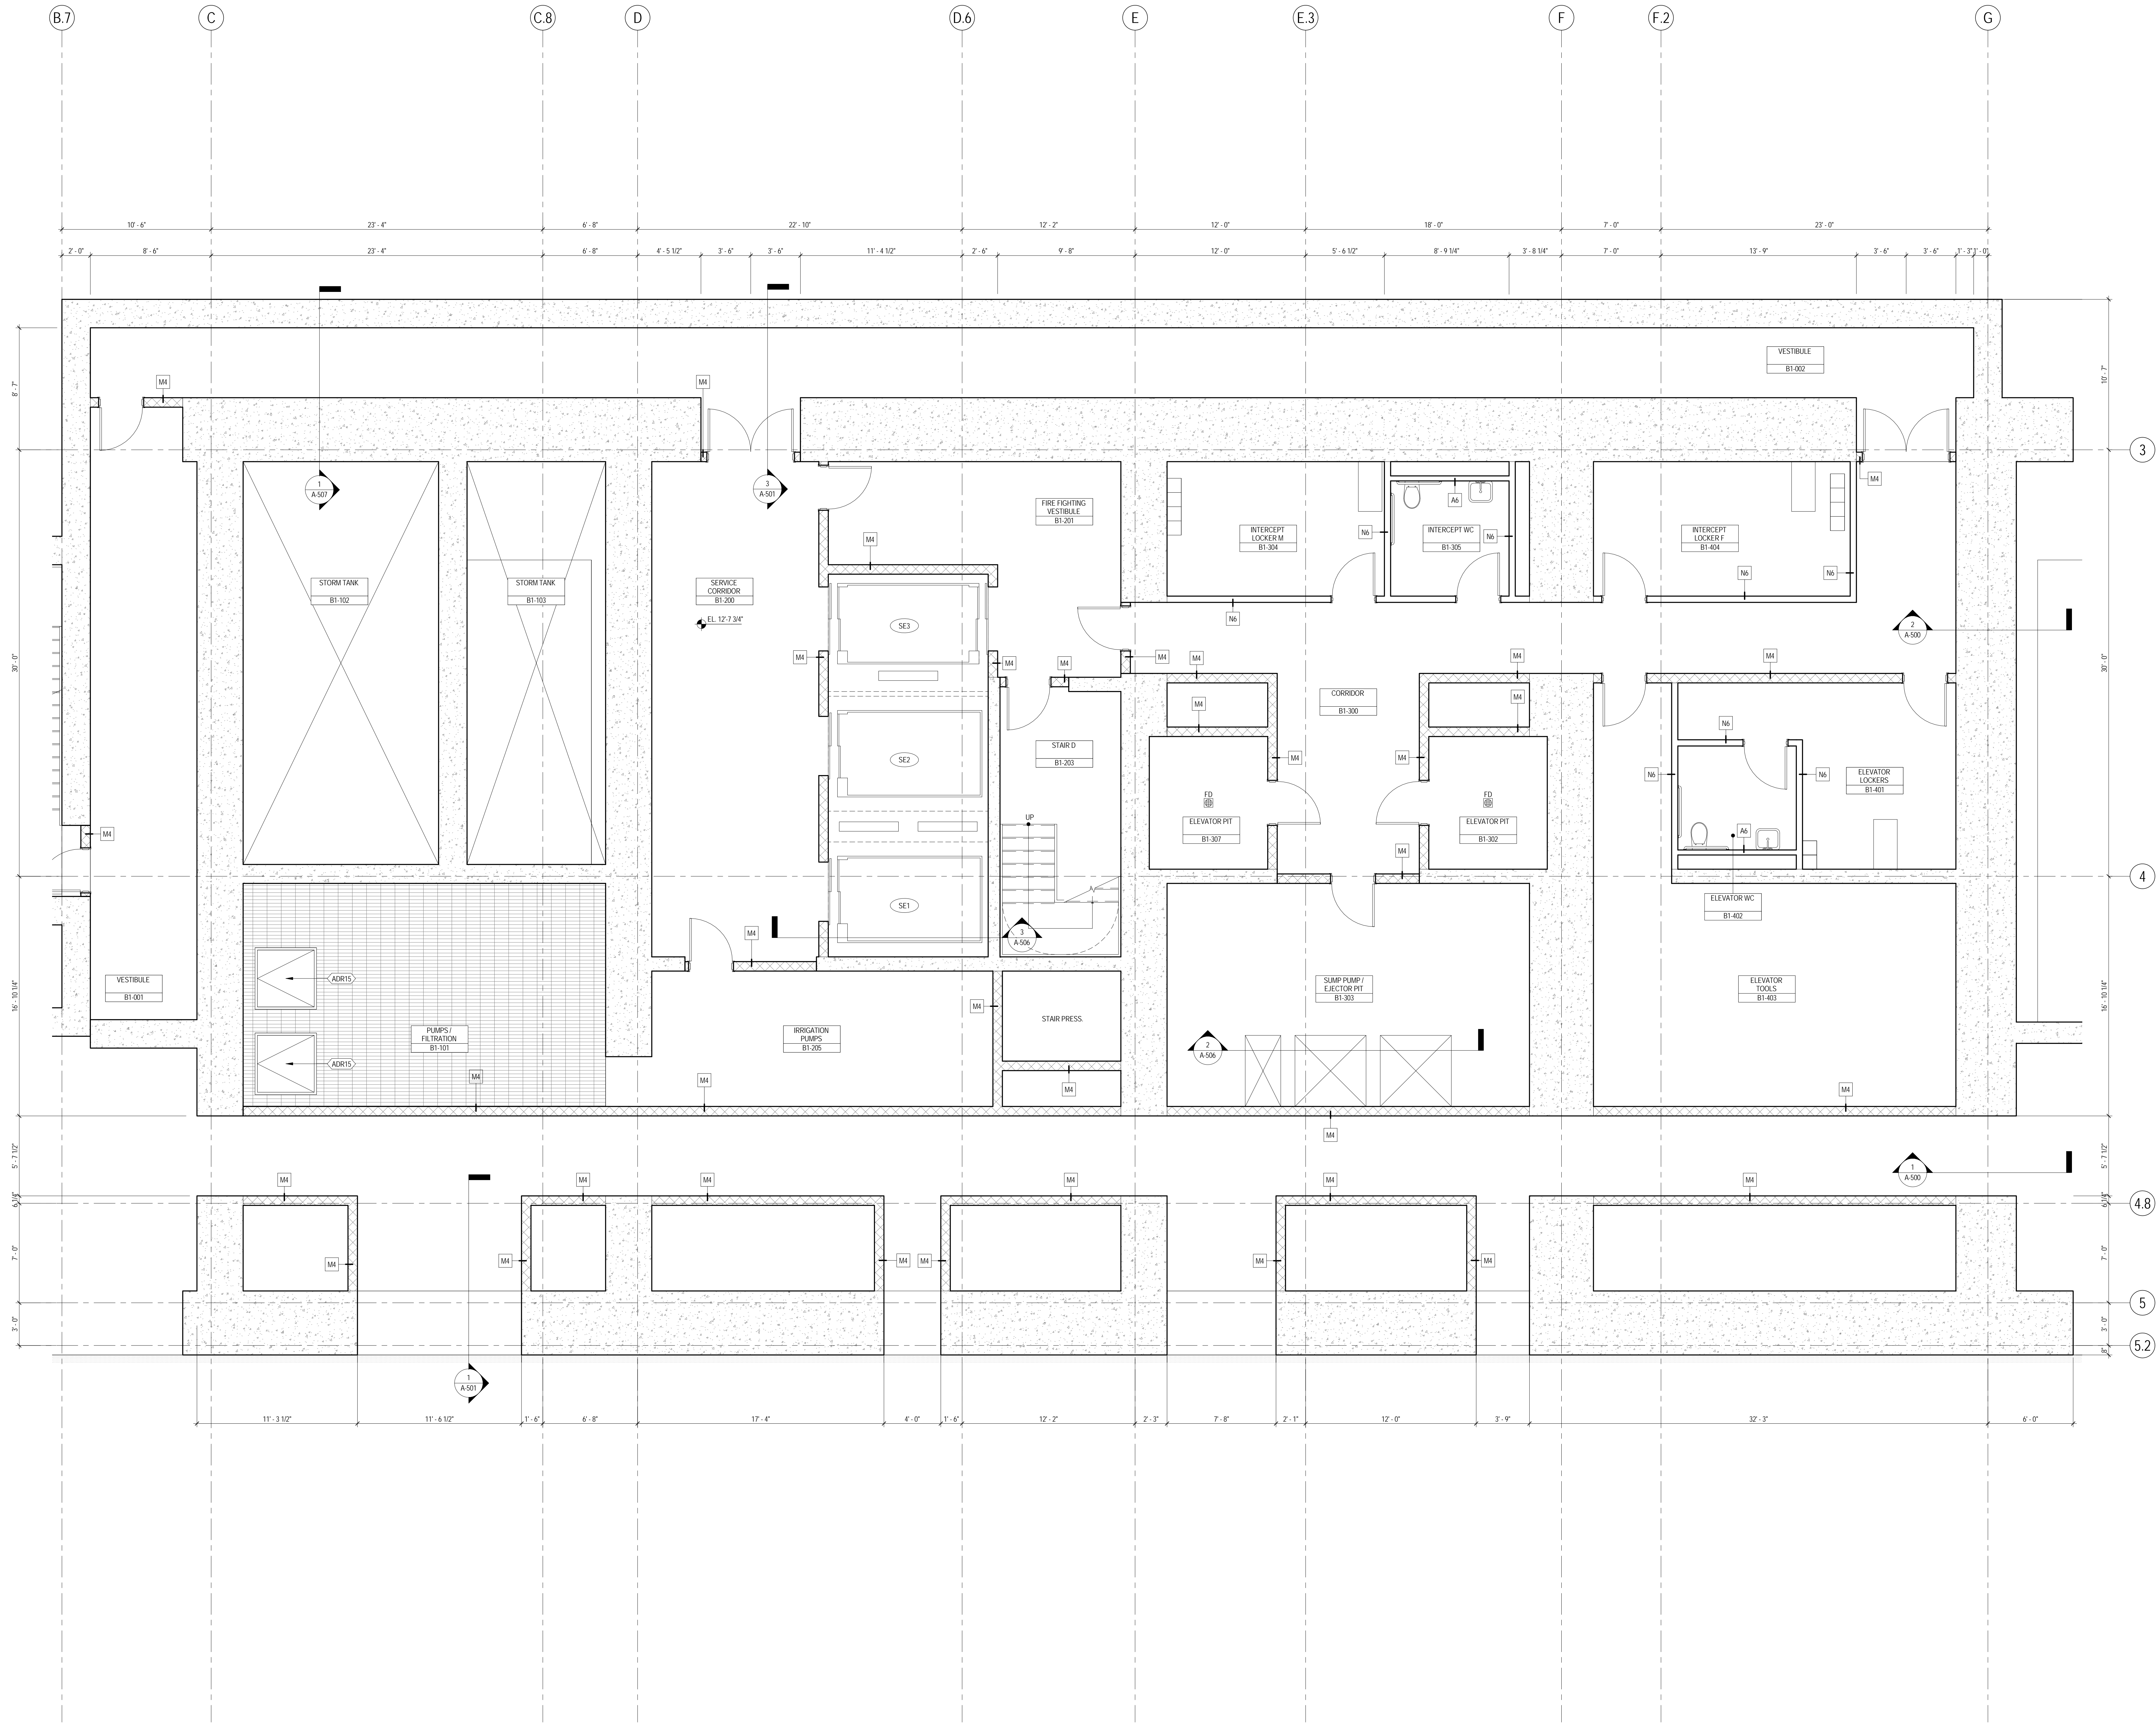

SHEET NOTES

1. ALL BUILDING ELEVATIONS (IN FEET) REFERENCED TO THE NORTH AMERICAN VERTICAL DATUM OF 1988 (NAV88).
2. FOR GENERAL NOTES, BUILDING DEPARTMENT NOTES, AND CLARIFICATION OF THE WORK NOTES REFER TO SHEET NO. G-005.
3. FOR ARCHITECTURAL ABBREVIATIONS, LEGEND OF SYMBOLS & MATERIALS, AND MOUNTING HEIGHTS REFER TO SHEET NO. G-006.
4. FOR ROOM FINISH SCHEDULE SEE A-700 SERIES DRAWINGS.
5. FOR DOOR SCHEDULE SEE A-700 SERIES DRAWINGS. FOR DOOR HARDWARE SPECIFICATION SEE TECHNICAL SPECIFICATION SECTION (B700).
6. FOR PARTITION TYPES SEE A-700 SERIES DRAWINGS.
7. ALL PARTITIONS SHALL BE TYPE DR, UNO.
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9. FOR STRUCTURAL COLUMNS, EDGE OF SLAB, AND CORE WORK POINTS SEE STRUCTURAL SERIES DRAWINGS, UNO.
10. REFER TO STRUCTURAL SERIES DRAWINGS FOR ALL STRUCTURAL WALL DESIGNATIONS AND DIMENSIONS.
11. REFER TO MEPP DRAWINGS FOR ALL MECHANICAL, ELECTRICAL, PLUMBING AND FIRE PROTECTION WORK, RISER AND EQUIPMENT DESIGNATIONS.
12. FOR PROJECT WORK POINT REFER TO A-000 SERIES DRAWINGS.



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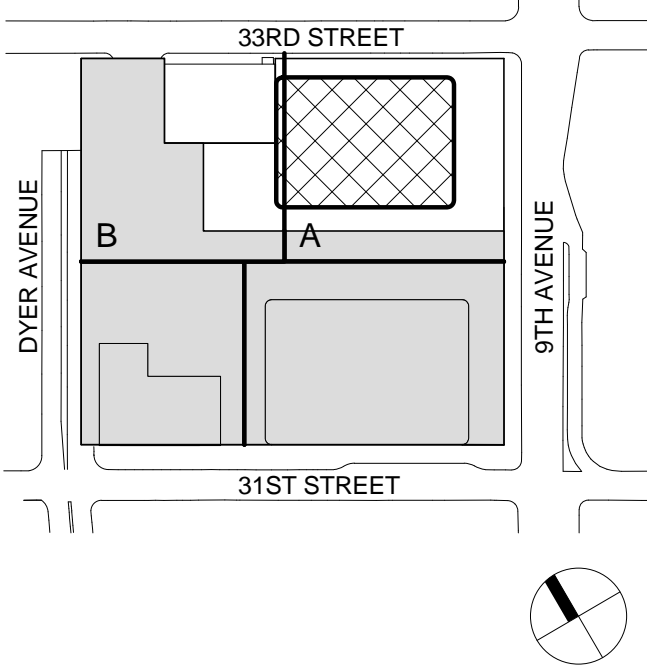
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2	15 NOV 2013	ISSUED FOR DD PROGRESS PRICING
1	12 JUL 2013	ISSUED FOR 50% DESIGN DEVELOPMENT

No. Date Description
Sheet Name:

**CELLAR B1
ENLARGED CORE
PLAN**

Project No.: 207150	B-SCAN Sheet No.: A-299.00
Date: 20 JUN 2014	Sheet No.: A-299
Scale: 1/4" = 1'-0"	Page No.: 67 OF 87
File No.: A-299	

SHEET NOTES

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3. FOR ARCHITECTURAL ABBREVIATIONS, LEGEND OF SYMBOLS & MATERIALS, AND MOUNTING HEIGHTS REFER TO SHEET NO. C008.
4. FOR ROOM FINISH SCHEDULE SEE A-700 SERIES DRAWINGS.
5. FOR DOOR SCHEDULE SEE A-700 SERIES DRAWINGS. FOR DOOR HARDWARE SPECIFICATION SEE TECHNICAL SPECIFICATION SECTION 051010.
6. FOR PARTITION TYPES SEE A-700 SERIES DRAWINGS.
7. ALL PARTITIONS SHALL BE TYPE DR UNO.
8. FOR REFLECTED CEILING PLANS SEE A-600 SERIES DRAWINGS. IF RCP IS NOT PROVIDED SEE MEPP/PT/AG/CTEL SERVICE DRAWINGS FOR LOCATIONS OR ALL CEILING WALL MOUNTED SERVICES.
9. FOR STRUCTURAL COLUMNS, EDGE OF SLAB AND CORE WORK POINTS SEE STRUCTURAL SERIES DRAWINGS, UNO.
10. REFER TO STRUCTURAL SERIES DRAWINGS FOR ALL STRUCTURAL WALL DESIGNATIONS AND DIMENSIONS.
11. REFER TO MEPP DRAWINGS FOR ALL MECHANICAL, ELECTRICAL, PLUMBING AND FIRE PROTECTION ROOM, RISER AND EQUIPMENT DESIGNATIONS.
12. FOR PROJECT WORK POINT REFER TO A-000 SERIES DRAWINGS.



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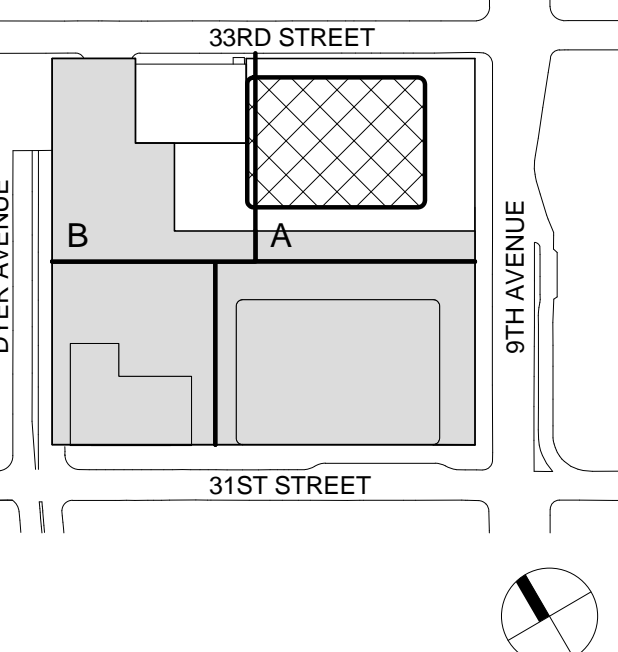
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3	20 DEC 2013	ISSUED FOR FOUNDATION PERMIT
2	15 NOV 2013	ISSUED FOR DD PROGRESS PRICING
1	12 JUL 2013	ISSUED FOR 50% DESIGN DEVELOPMENT

No. Date Description

Sheet Name:

CELLAR B
ENLARGED CORE
PLAN

Project No.:

207150

Date:

20 JUN 2014

Scale:

1/4" = 1'-0"

File No.:

A-300

B-SCAN Sheet No.:

A-300.00

Sheet No.:

A-300

Page No.:

68 OF 87

SHEET NOTES

1. ALL BUILDING ELEVATIONS (IN FEET) REFERENCED TO THE NORTH AMERICAN VERTICAL DATUM OF 1988 (NAV88).
2. FOR GENERAL NOTES, BUILDING DEPARTMENT NOTES, AND CLARIFICATION OF THE WORK NOTES REFER TO SHEET NO. C-005.
3. FOR ARCHITECTURAL ABBREVIATIONS, LEGEND OF SYMBOLS & MATERIALS, AND MOUNTING HEIGHTS REFER TO SHEET NO. C-006.
4. FOR ROOM FINISH SCHEDULE SEE A-700 SERIES DRAWINGS.
5. FOR DOOR SCHEDULE SEE A-700 SERIES DRAWINGS. FOR DOOR HARDWARE SPECIFICATION SEE TECHNICAL SPECIFICATION SECTION (B-070).
6. FOR PARTITION TYPES SEE A-700 SERIES DRAWINGS.
7. ALL PARTITIONS SHALL BE TYPE DR, LINO.
8. FOR REFLECTED CEILING PLANS SEE A-600 SERIES DRAWINGS. IF RCP IS NOT PROVIDED SEE MEPP/FACE/CTL. SERVICE DRAWINGS FOR LOCATIONS OR ALL CEILING/IN-WALL MOUNTED SERVICES.
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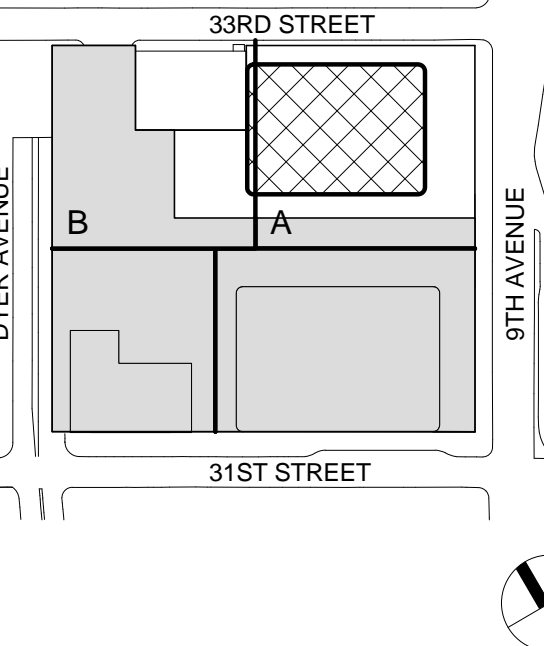
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4. FOR ROOM FINISH SCHEDULE SEE A-700 SERIES DRAWINGS.
5. FOR DOOR SCHEDULE SEE A-700 SERIES DRAWINGS. FOR DOOR HARDWARE SPECIFICATION SEE TECHNICAL SPECIFICATION SECTION B5700.
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8. FOR REFLECTED CEILING PLANS SEE A-600 SERIES DRAWINGS. IF RCP IS NOT PROVIDED SEE MEPP PAGE CTE1. SERVICE DRAWINGS FOR LOCATIONS OR ALL CEILING WALL MOUNTED SERVICES.
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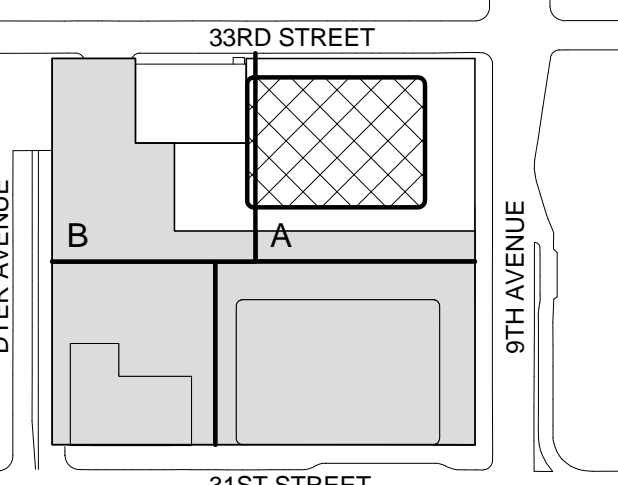
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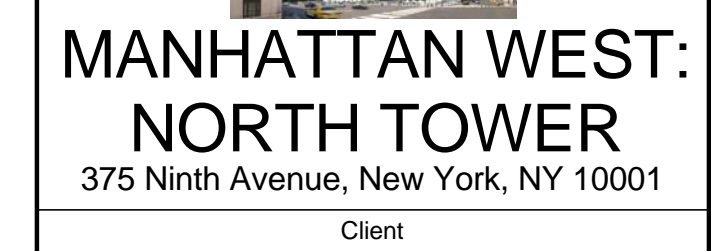
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3	20 DEC 2013	ISSUED FOR FOUNDATION PERMIT
2	15 NOV 2013	ISSUED FOR DD PROGRESS PRICING
1	12 JUL 2013	ISSUED FOR 50% DESIGN DEVELOPMENT

No. Date Description
Sheet Name:

LEVEL 6-16
ENLARGED CORE
PLAN - TYPICAL
LOW-RISE

Project No.: 207150	B-SCAN Sheet No.: A-306.00
Date: 20 JUN 2014	Sheet No.: A-306
Scale: 1/4" = 1'-0"	Page No.: 76 OF 87
File No.: A-306	



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Ontario, Canada N1K 1B8

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Key Plan:

33RD STREET

A map showing the location of the property on 31st Street. The street is labeled "31ST STREET" and runs horizontally. The property is located on the north side of the street, between two vertical lines representing other streets.

Seal & Signature:

of the New York
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any way.

4	20 JUN 2014	ISSUED FOR FOUNDATION BID
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2	20 DEC 2013	ISSUED FOR FOUNDATION PERMIT
1	15 NOV 2013	ISSUED FOR DD PROGRESS PRICING
No.	Date	Description

Sheet Name:


LEVEL 28
ENLARGED CORE
PLAN - LOW RISE


PLAN - LOW-RISE & MID-RISE

Project No.: 207120	B-SCAN Sheet No.:
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Date: 20 JUN 2014	<div style="text-align: center;"> <h1>A-328.00</h1> <p>Sheet No.: A-328</p> </div>
Scale: 1/4" = 1'-0"	

File No.: A-328	Page No.: 71 OF 87
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SHEET NOTES

1. ALL BUILDING ELEVATIONS (IN FEET) REFERENCED TO THE NORTH AMERICAN VERTICAL DATUM OF 1988 (NAV88).
2. FOR GENERAL NOTES, BUILDING DEPARTMENT NOTES, AND CLARIFICATION OF THE WORK NOTES REFER TO SHEET NO. G-005.
3. FOR ARCHITECTURAL ABBREVIATIONS, LEGEND OF SYMBOLS & MATERIALS, AND MOUNTING HEIGHTS REFER TO SHEET NO. G-005.
4. FOR ROOM FINISH SCHEDULE SEE A-700 SERIES DRAWINGS.
5. FOR DOOR SCHEDULE SEE A-700 SERIES DRAWINGS. FOR DOOR HARDWARE SPECIFICATION SEE TECHNICAL SPECIFICATION SECTION 051010.
6. FOR PARTITION TYPES SEE A-700 SERIES DRAWINGS.
7. ALL PARTITIONS SHALL BE TYPE DR, UNO.
8. FOR REFLECTED CEILING PLANS SEE A-400 SERIES DRAWINGS. IF RCP IS NOT PROVIDED SEE MEPP/FAC/OTEL SERVICE DRAWINGS FOR LOCATIONS OR ALL CEILING/PAINT MOUNTED SERVICES.
9. FOR STRUCTURAL COLUMNS, EDGE OF SLAB AND CORE WORK POINTS SEE STRUCTURAL SERIES DRAWINGS, UNO.
10. REFER TO STRUCTURAL SERIES DRAWINGS FOR ALL STRUCTURAL WALL DESIGNATIONS AND DIMENSIONS.
11. REFER TO MEPP/FAC/OTEL SERVICE DRAWINGS FOR ALL MECHANICAL, ELECTRICAL, PLUMBING AND FIRE PROTECTION ROOM, RISER AND EQUIPMENT DESIGNATIONS.
12. FOR PROJECT WORK POINT REFER TO A-000 SERIES DRAWINGS.

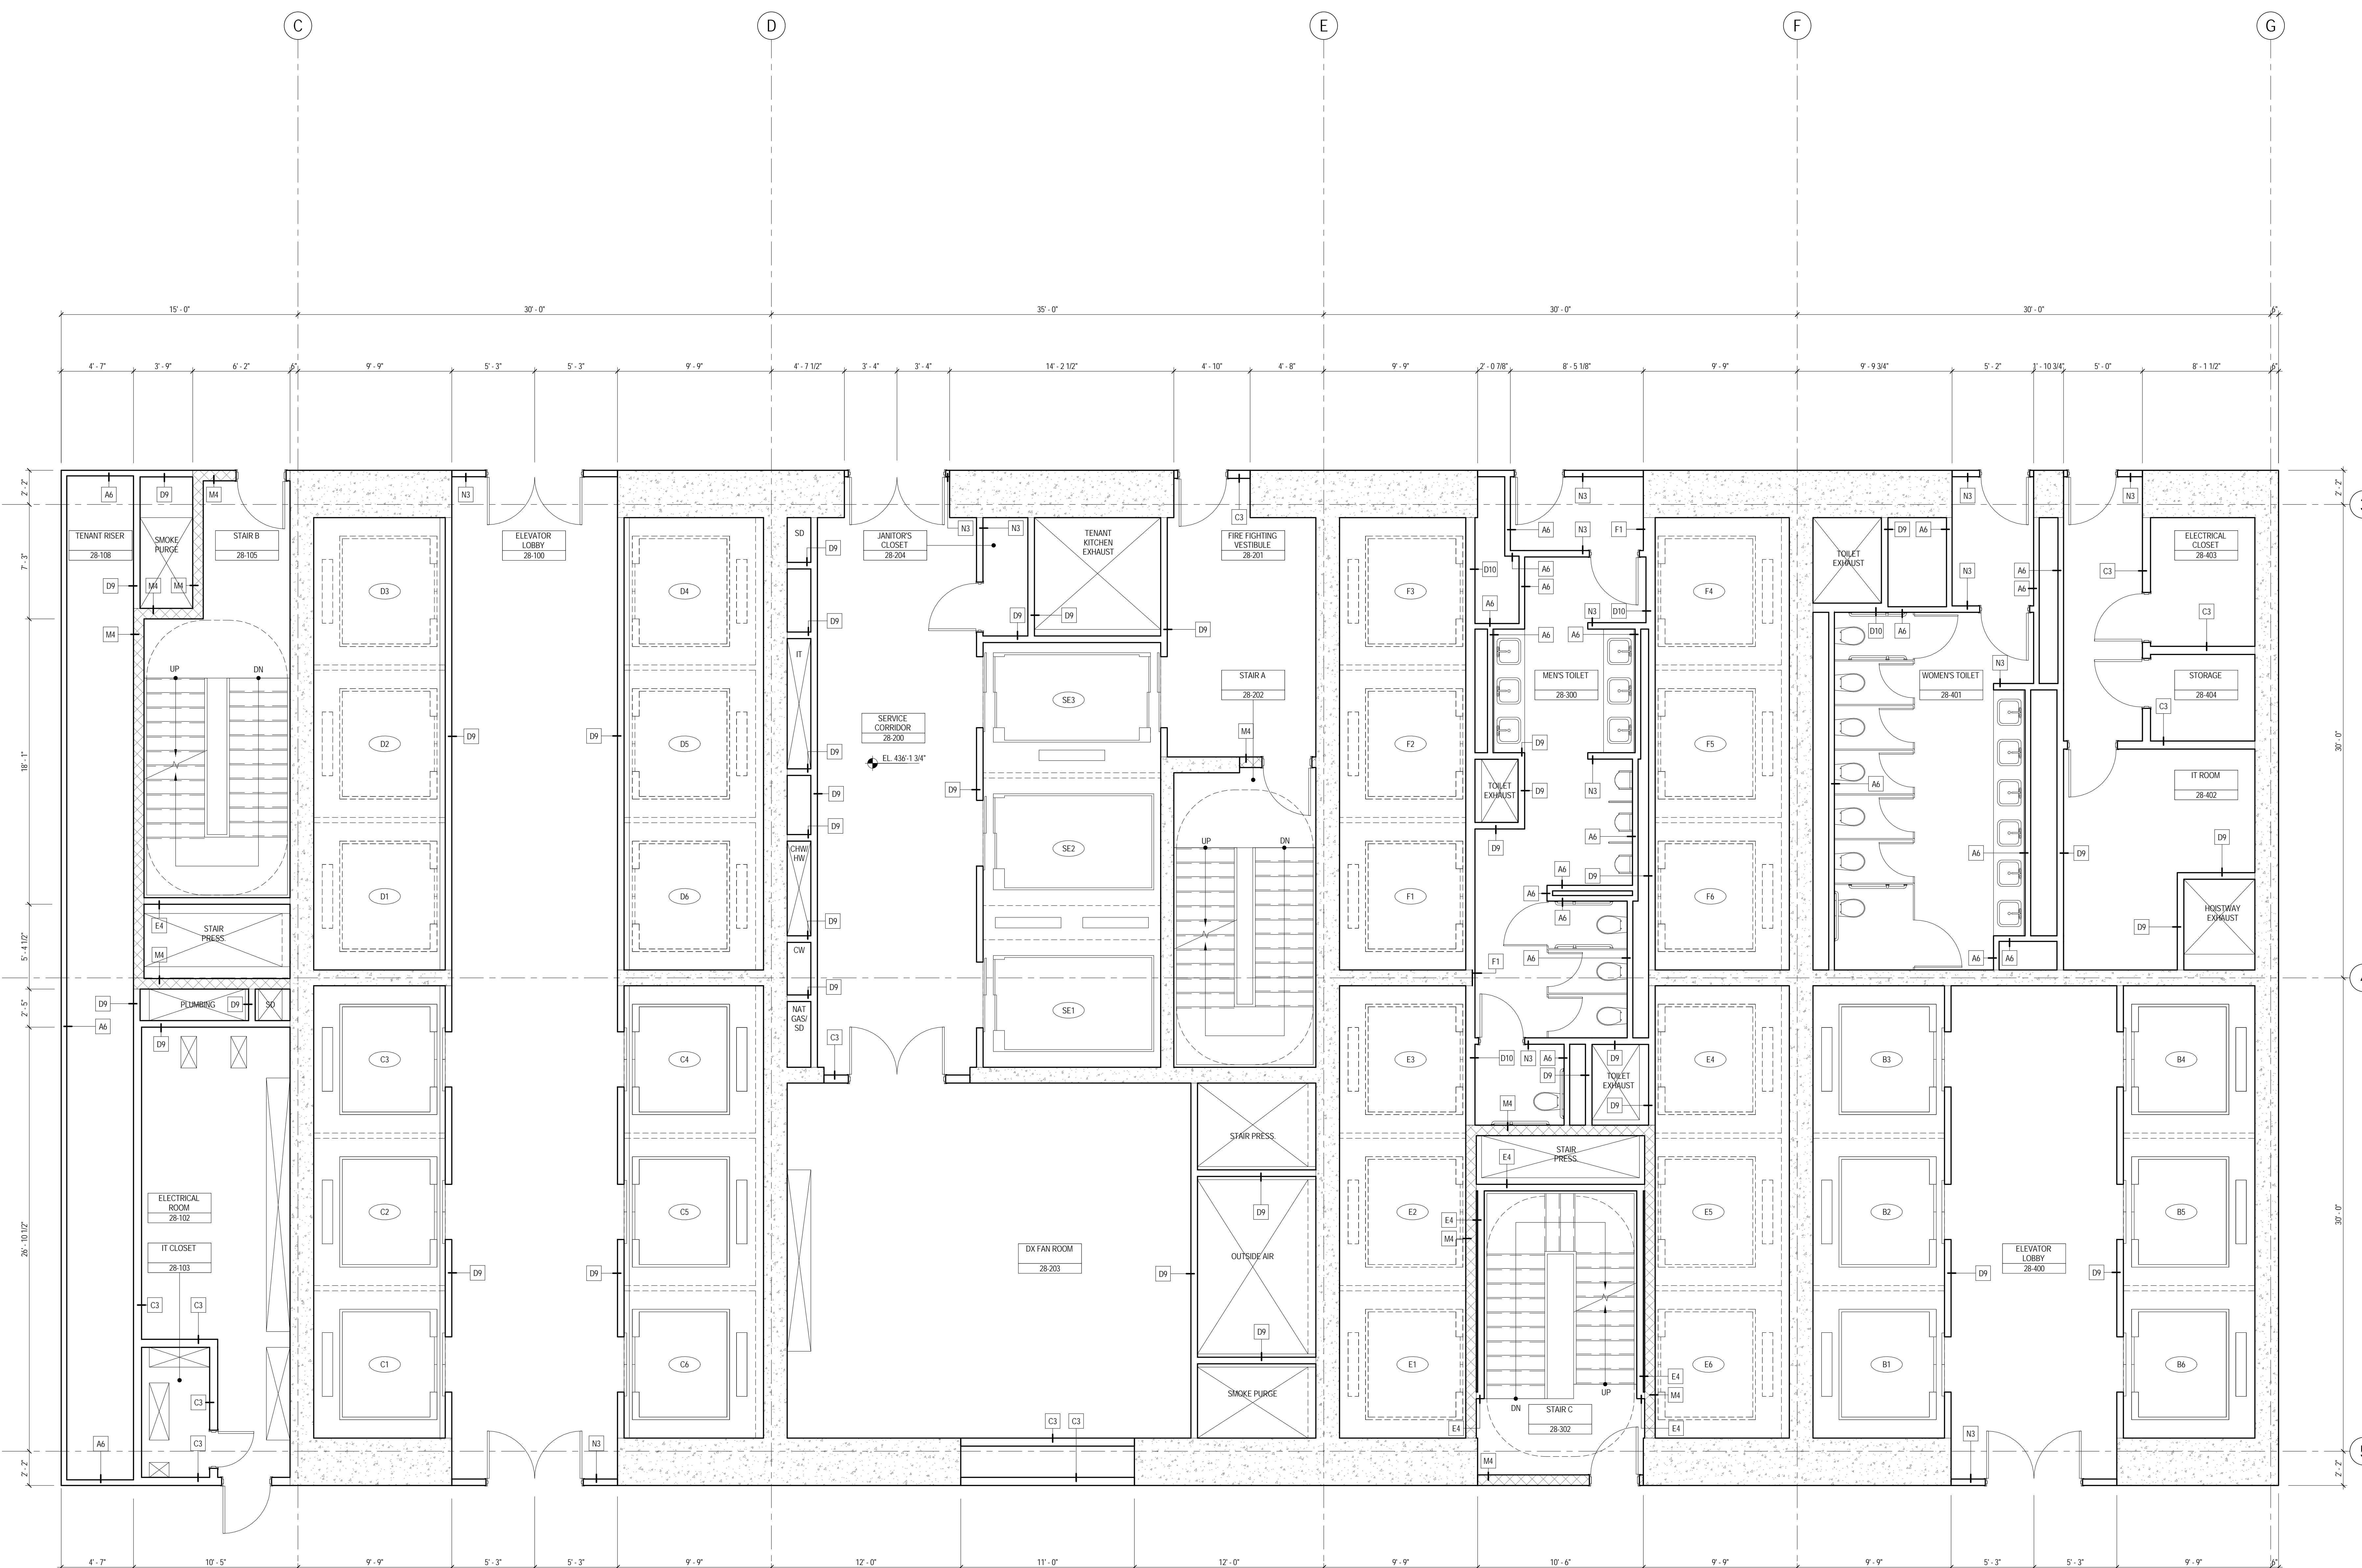
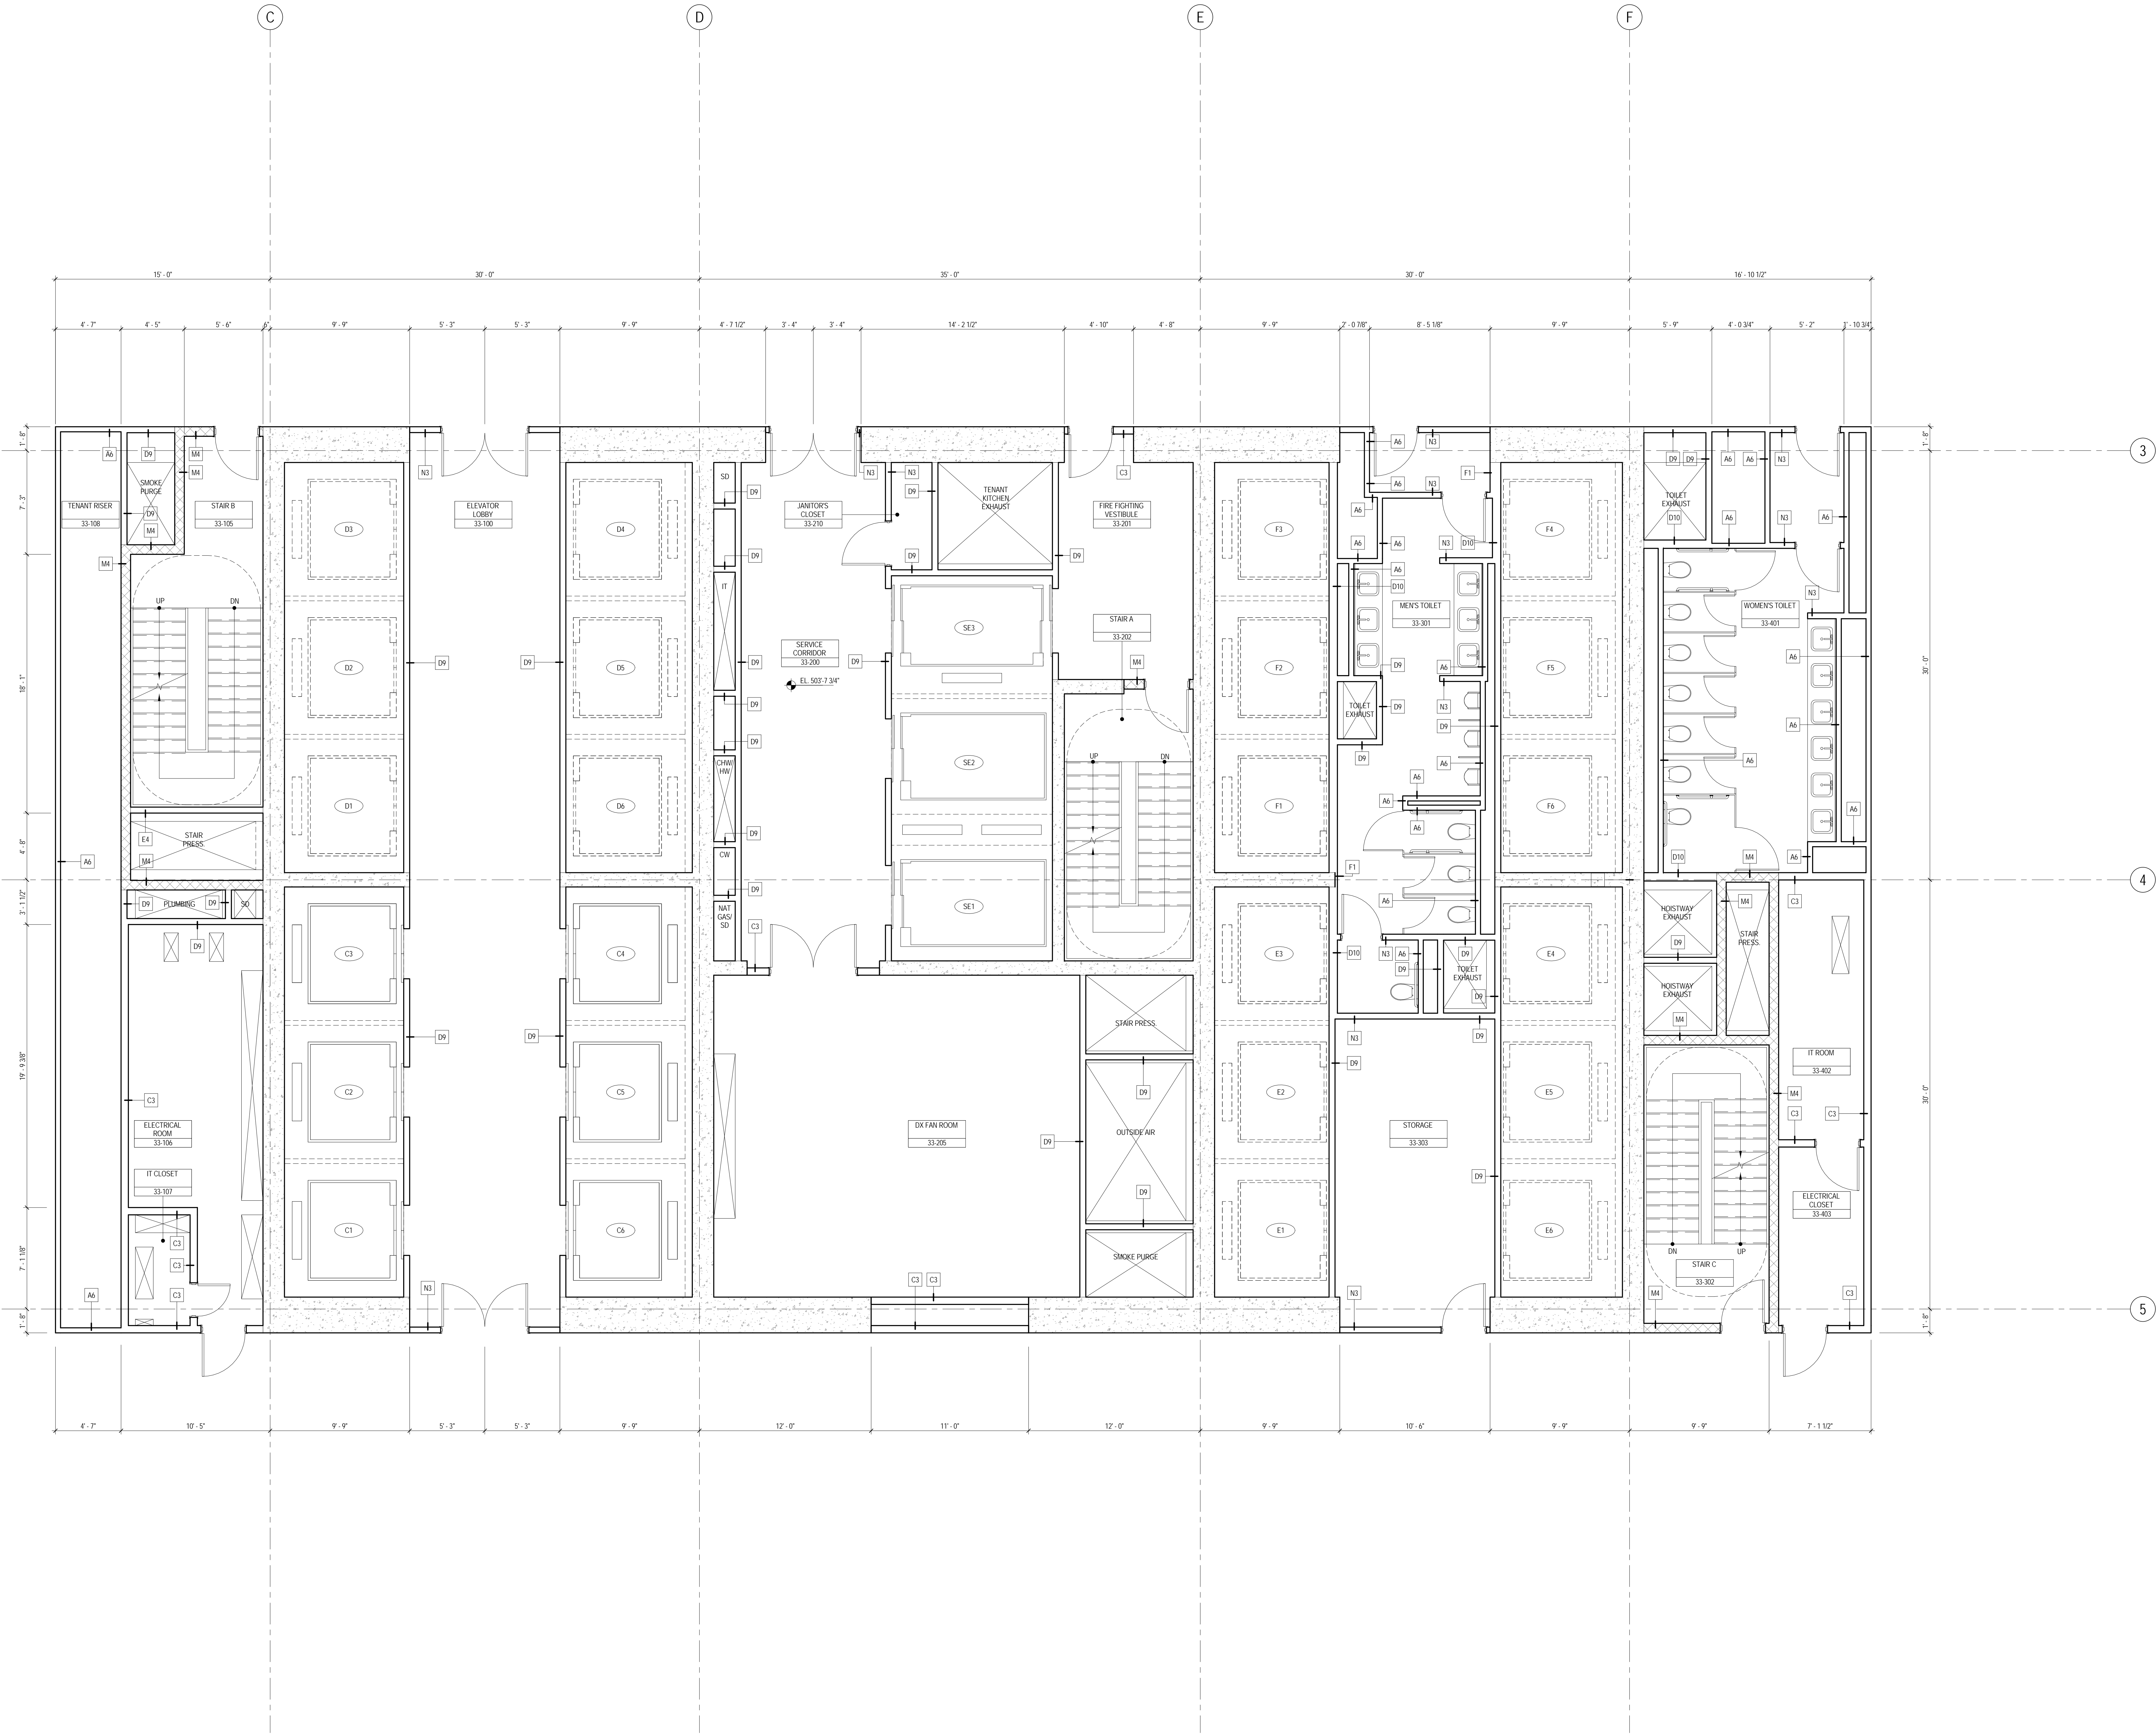
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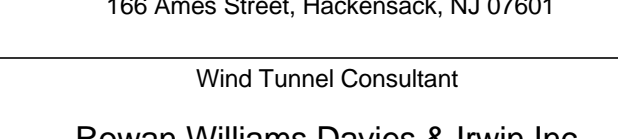
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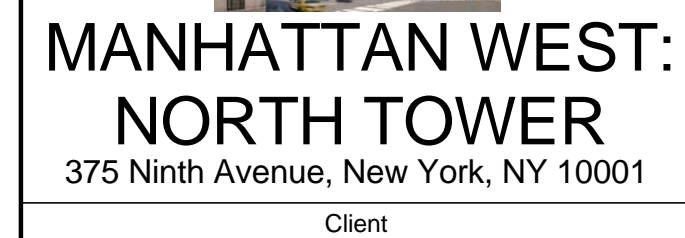
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JUN 10 2014

Project No.: 207150
Date: 20 JUN 2014
Scale: 1/4" = 1'-0"

B-SCAN Sheet No.: A-333.00
Sheet No.: A-333
Page No.: 72 OF 87

LEVEL 33-38
ENLARGED CORE
PLAN - TYPICAL
MID-RISE

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2. FOR GENERAL NOTES, BUILDING DEPARTMENT NOTES, AND NOTATION OF THE WORK, REFER TO SHEET NO. G-005.
3. FOR ARCHITECTURAL ABBREVIATIONS, HEIGHTS OF SYMBOLS & MATERIALS, AND MOUNTING HEIGHTS REFER TO SHEET NO. G-005.
4. FOR ROOM FINISH SCHEDULE SEE A 700 SERIES DRAWINGS.
5. FOR DOOR SCHEDULE SEE A 700 SERIES DRAWINGS.
6. FOR WINDOW SCHEDULE SEE TECHNICAL SPECIFICATION SECTION 08700.
7. FOR PARTITION TYPES SEE A 700 SERIES DRAWINGS.
8. ALL PARTITIONS SHALL BE TYPE PD, UNO.
9. FOR REFLECTED CEILING PLANS, SEE A 400 SERIES DRAWINGS. IF ROOM IS NOT PROVIDED SEE MECHANICAL SERVICES DRAWINGS FOR LOCATIONS AND ALL CEILINGWALL MOUNTED DEVICES.
10. FOR STRUCTURAL COLUMN, EDGE OF SLAB, AND CORE WORK POINTS SEE STRUCTURAL SERIES DRAWINGS, UNO.
11. REFER TO STRUCTURAL SERIES DRAWINGS FOR ALL STRUCTURAL, STEEL, CONCRETE, AND MASONRY.
12. REFER TO MECHANICAL DRAWINGS FOR ALL MECHANICAL, ELECTRICAL, PLUMBING AND FIRE PROTECTION ROOM, RISER AND EQUIPMENT DESIGNATIONS.
13. FOR LOCK POINT WORK POINT REFER TO A 600 SERIES DRAWINGS.



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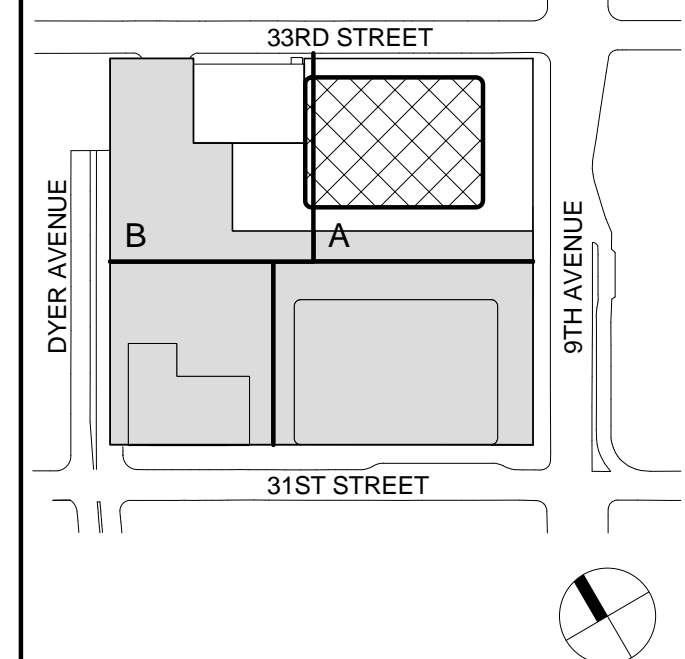
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Sheet Name	

LEVEL 49
ENLARGED CORE
PLAN - MID-RISE
& HIGH-RISE

Project No.: _____

Date: 20/12

20 JUN 2

Scale:
 $1/4" = 1'$

B-SCAN Sheet No.:

A-349 00


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A-349

Page No.: 73 OF 87

SHEET NOTES

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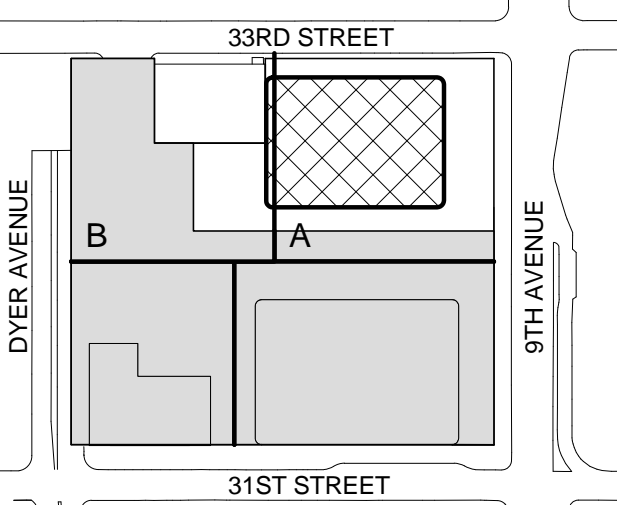
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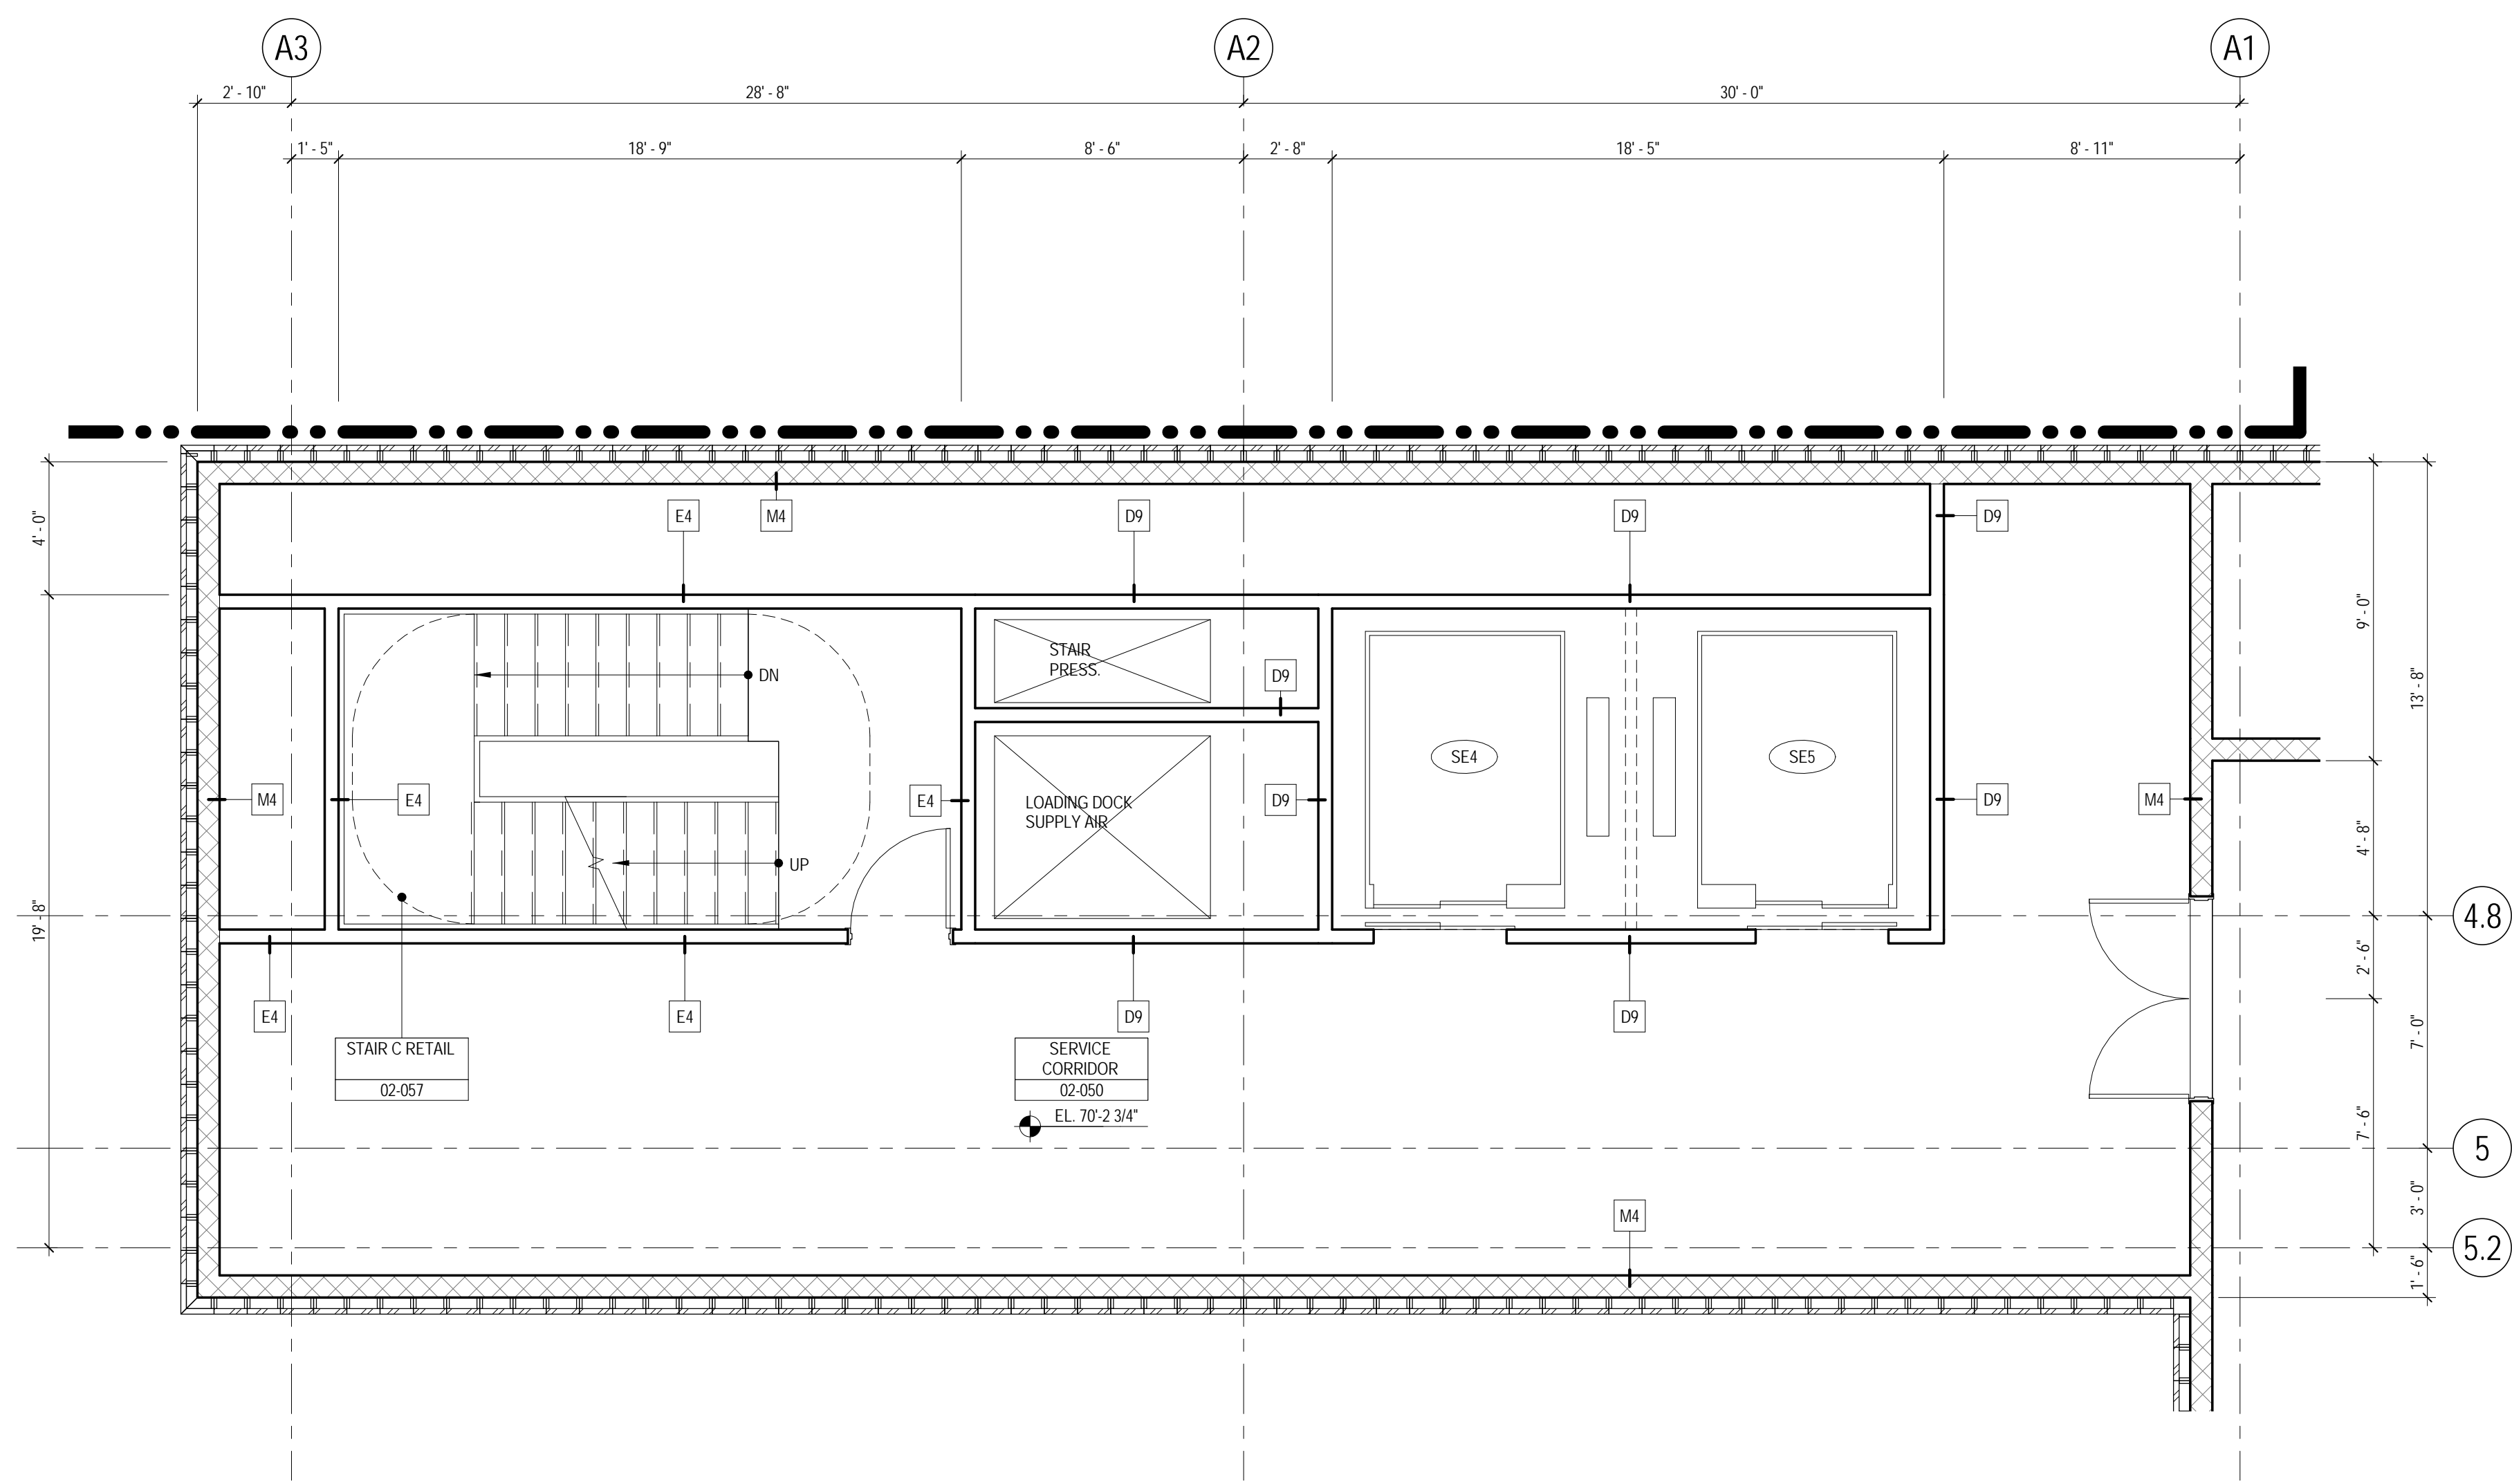
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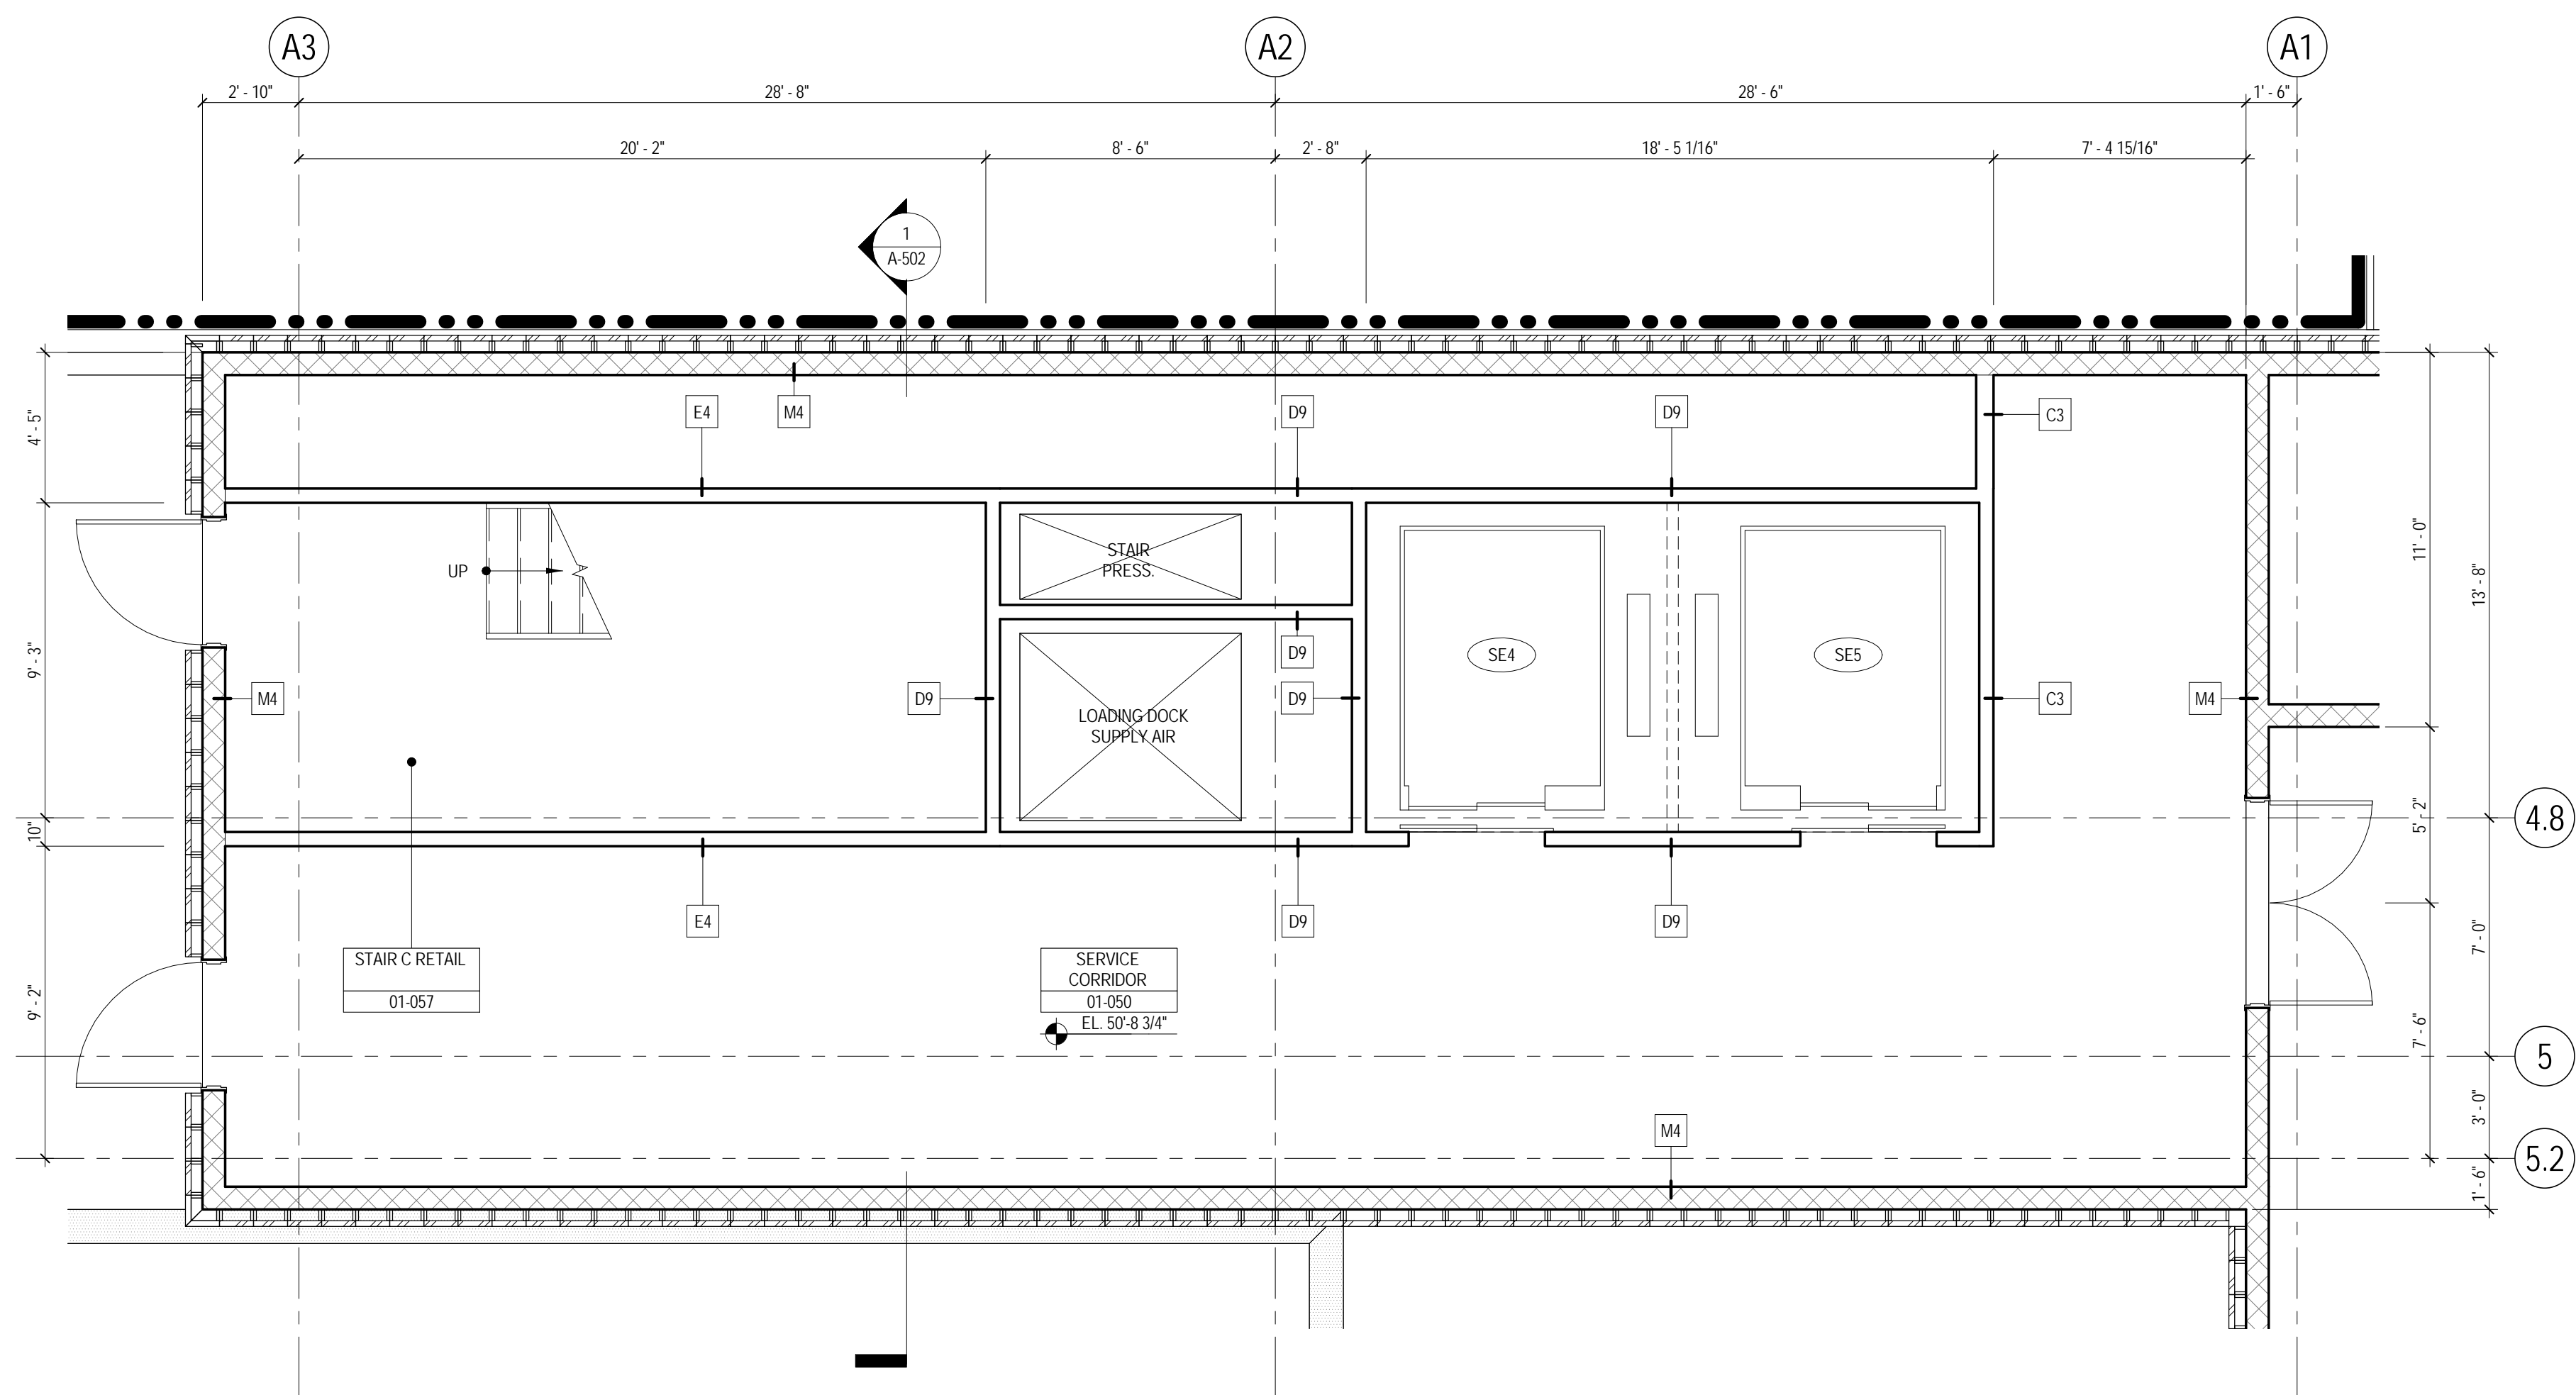
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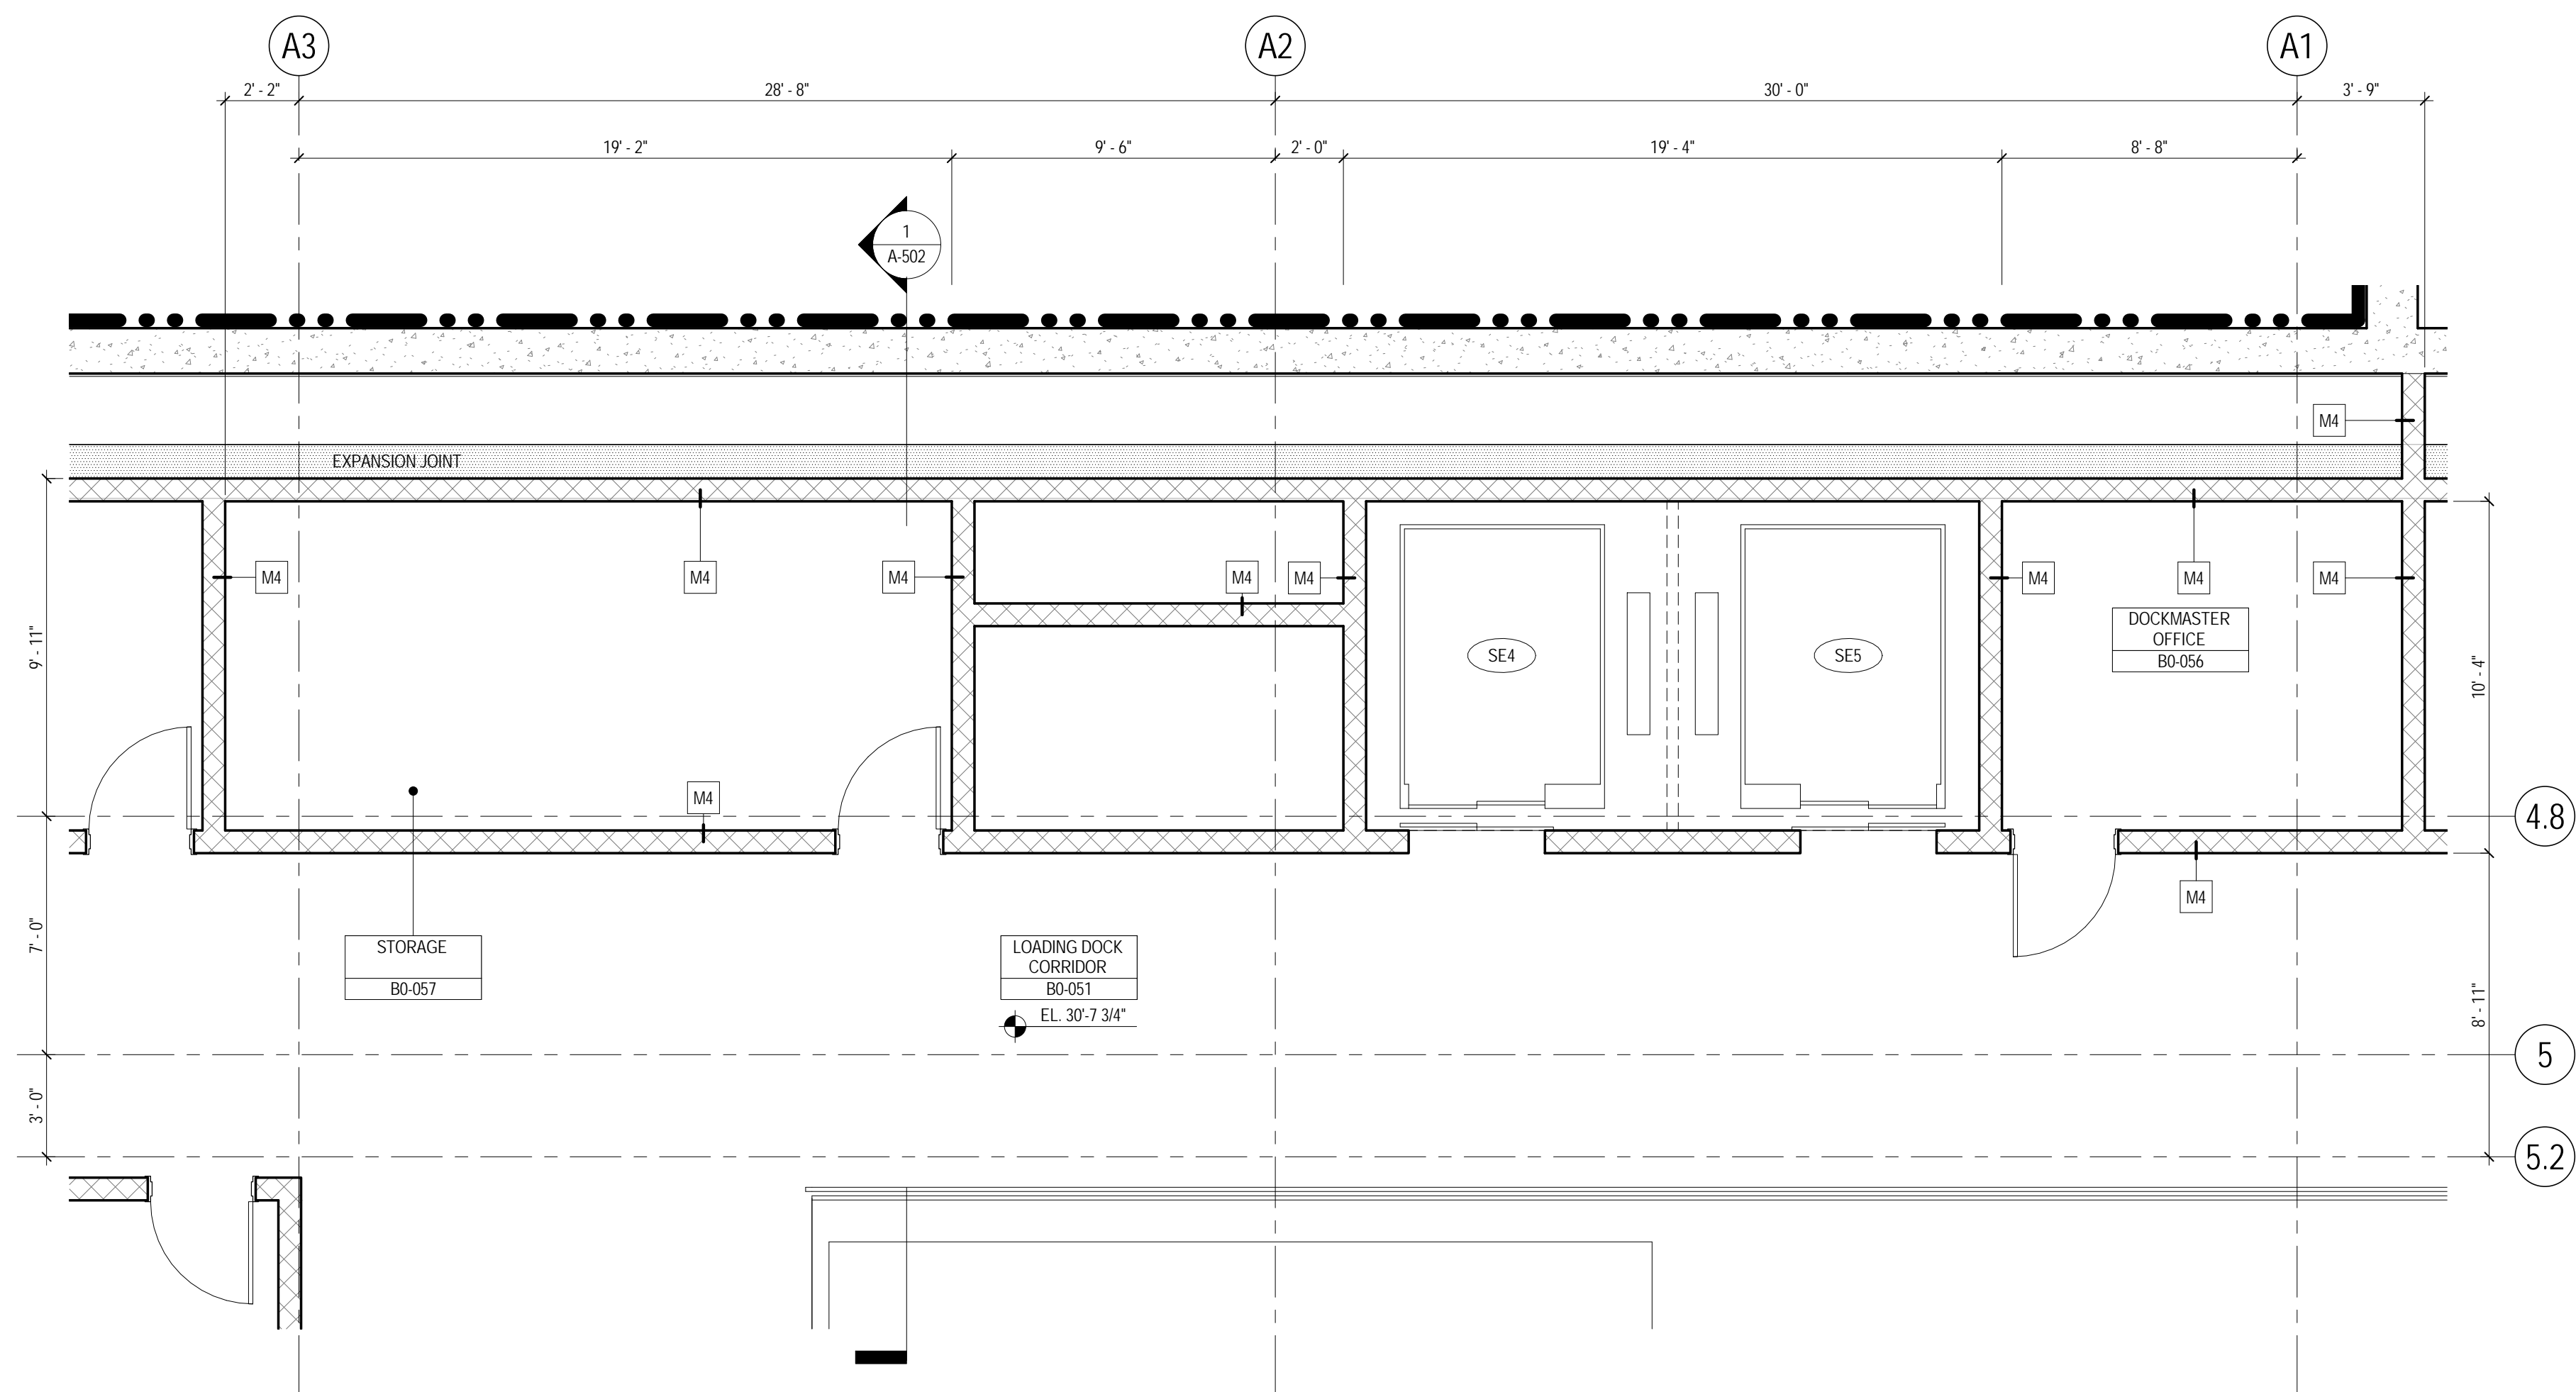


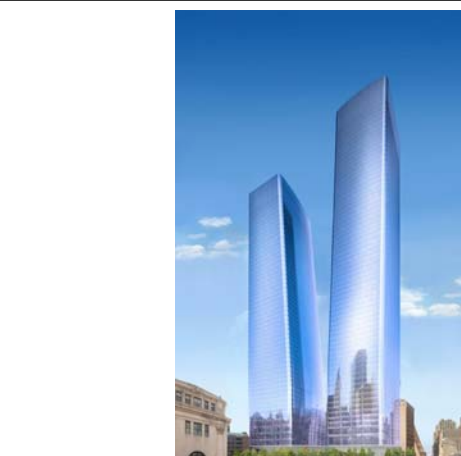


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SCALE: 1/4" = 1'-0"




2 LEVEL 1 ENLARGED RETAIL CORE PLAN
SCALE: 1/4" = 1'-0"



1 CELLAR B ENLARGED RETAIL CORE PLAN
SCALE: 1/4" = 1'-0"

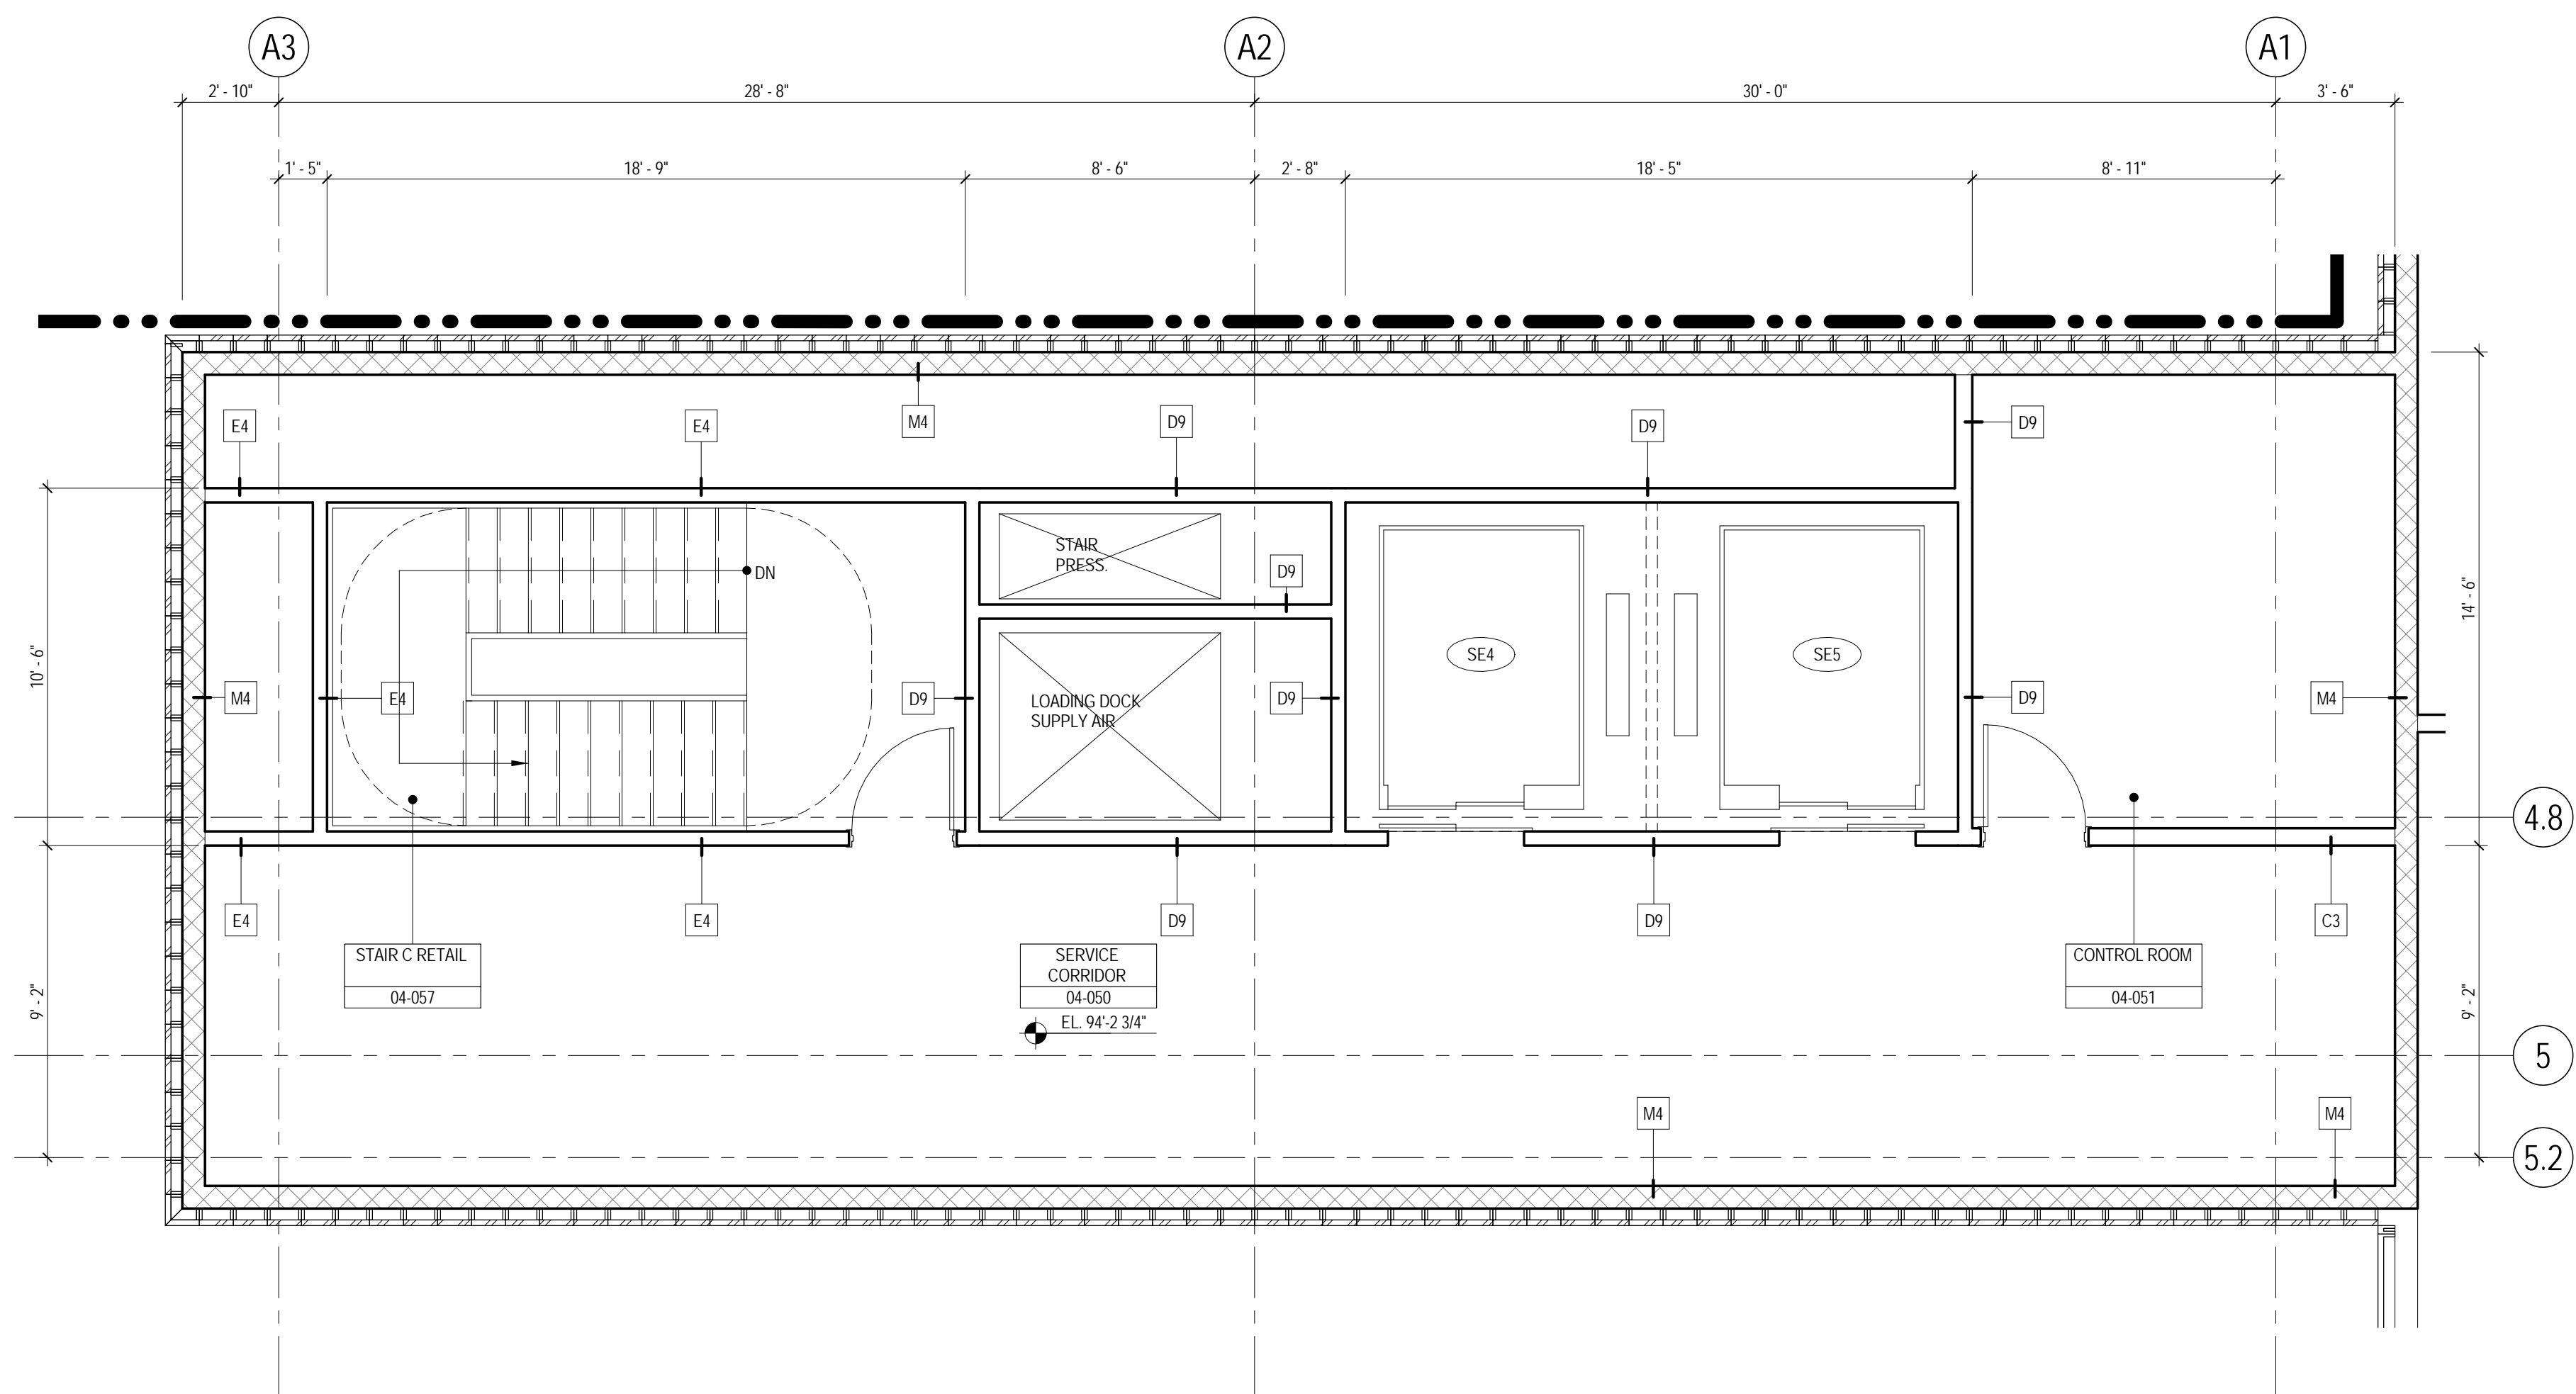

5 LEVEL 4 ENLARGED RETAIL CORE PLAN
SCALE: 1/4" = 1'-0"

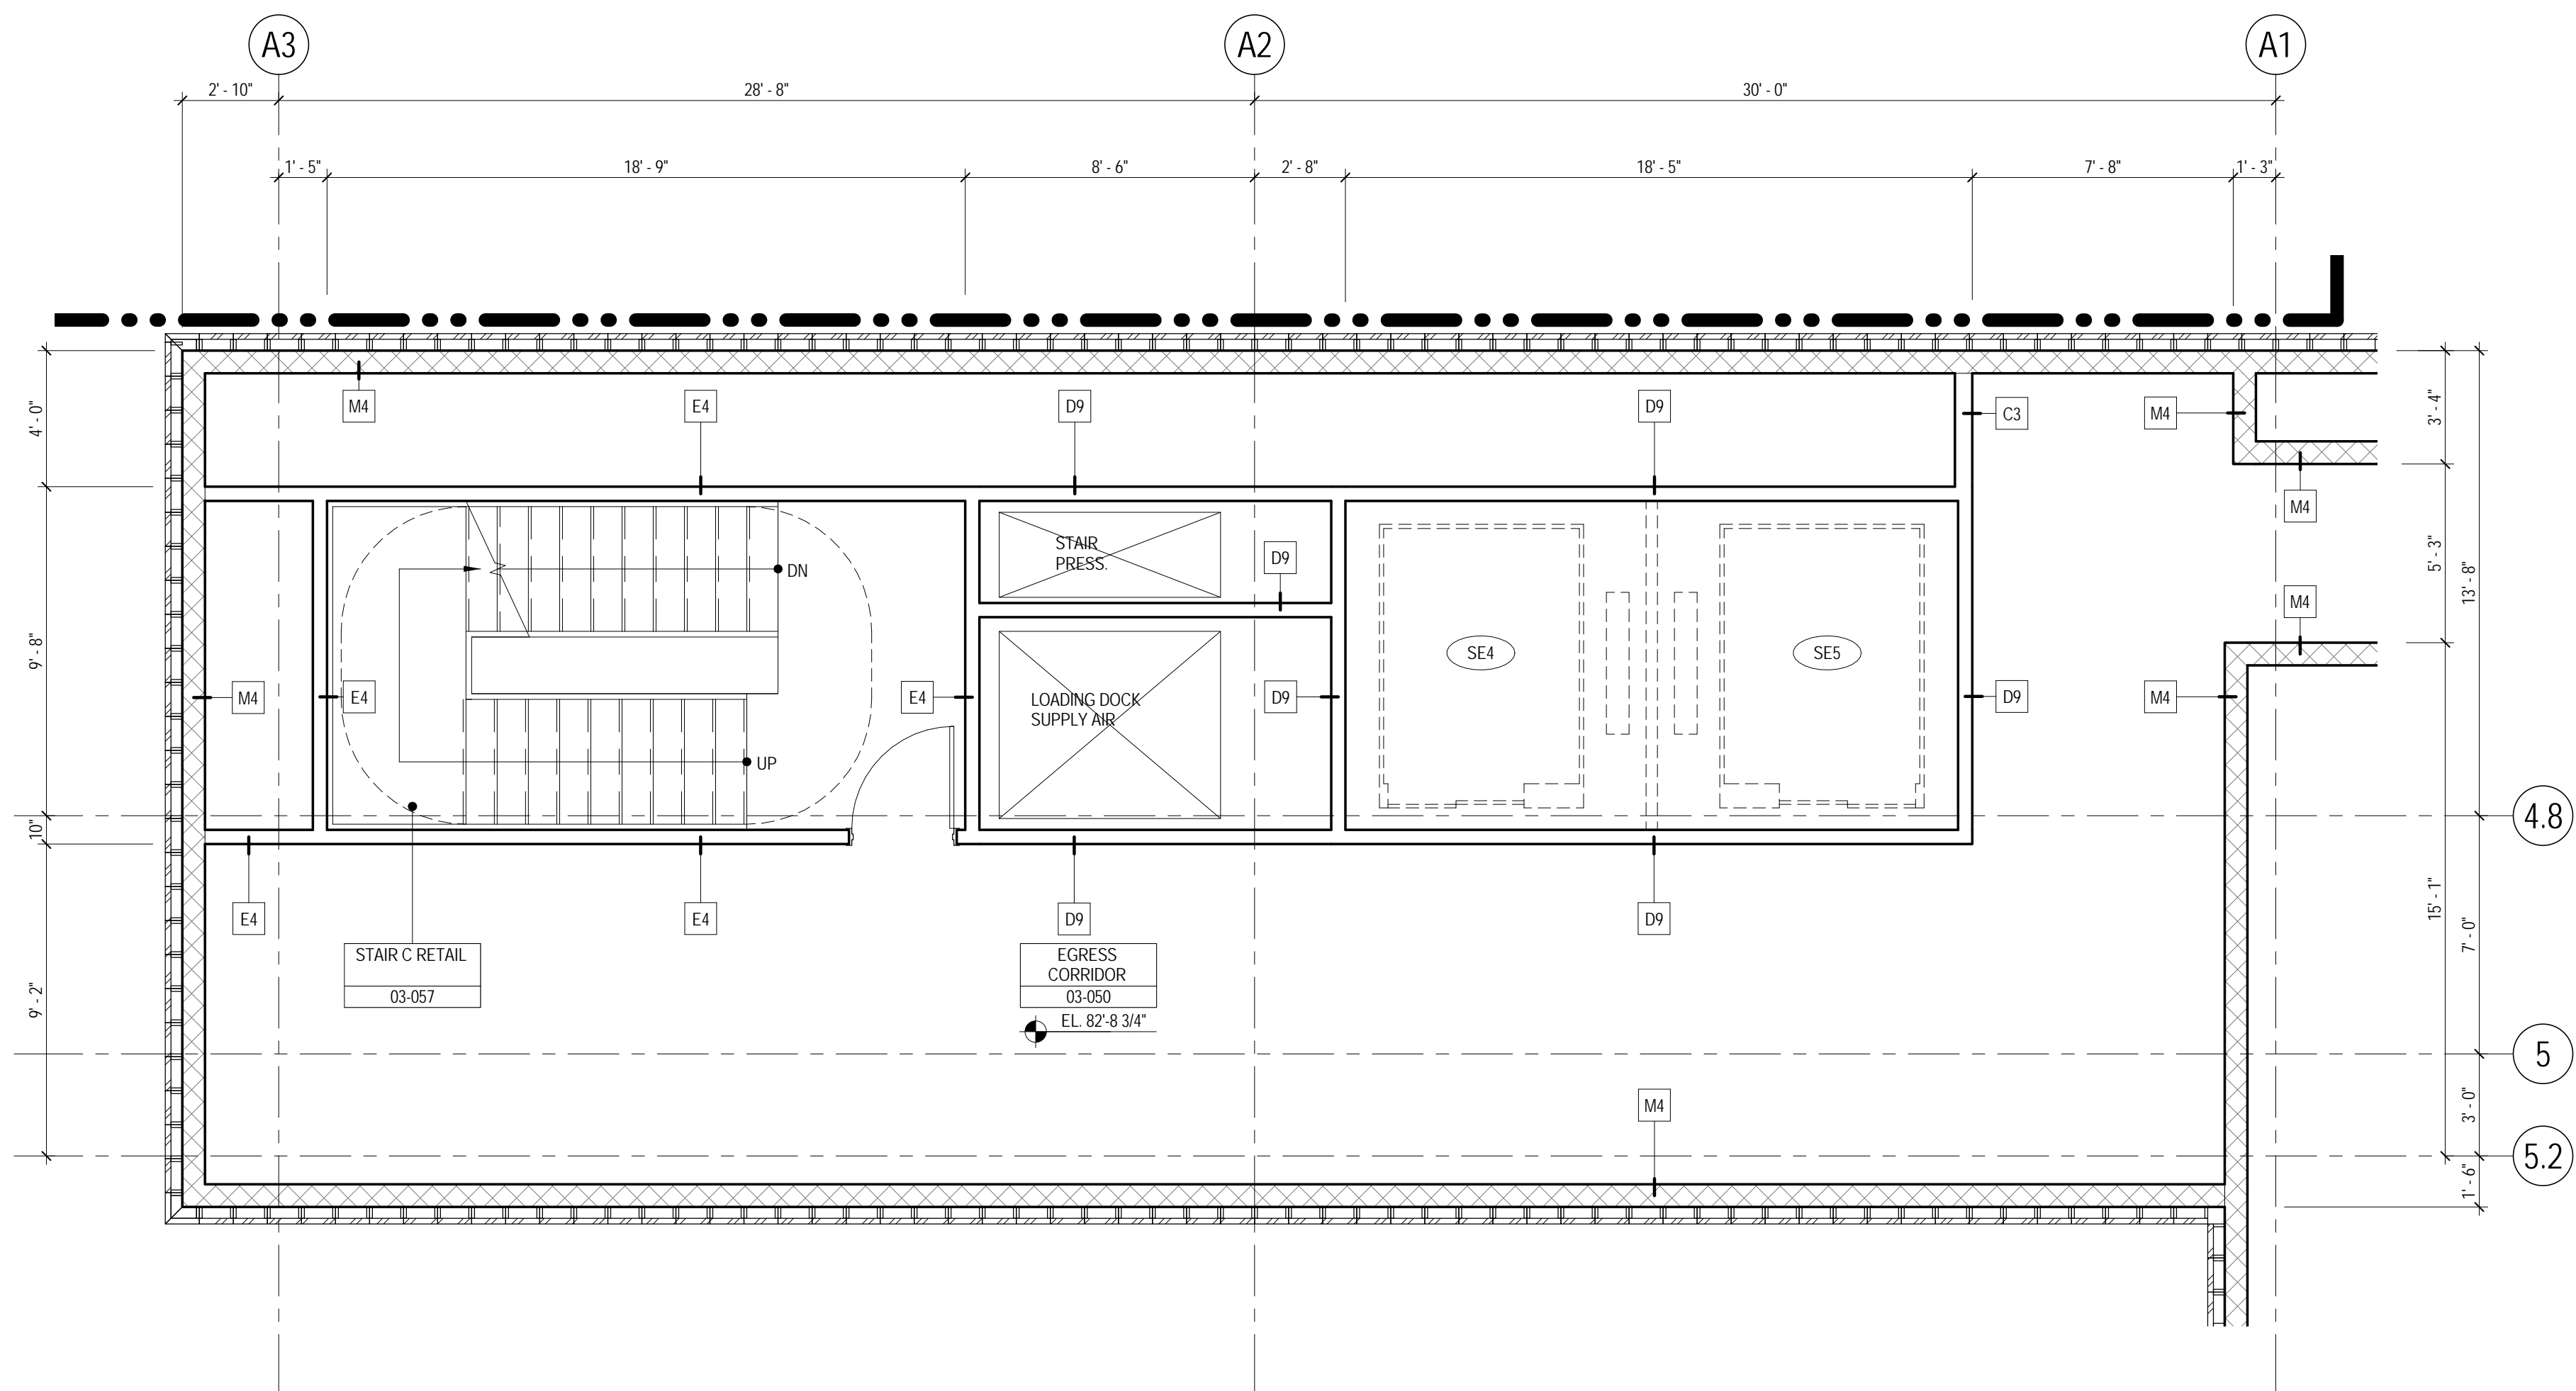

4 LEVEL 3 ENLARGED RETAIL CORE PLAN
SCALE: 1/4" = 1'-0"

SHEET NOTES

1. ALL BUILDING ELEVATIONS (IN FEET) REFERENCED TO THE NORTH AMERICAN VERTICAL DATUM OF 1988 (NAV88).
2. FOR GENERAL NOTES, BUILDING DEPARTMENT NOTES, AND CLARIFICATION OF THE WORK NOTES REFER TO SHEET NO. G-005.
3. FOR ARCHITECTURAL ABBREVIATIONS, LEGEND OF SYMBOLS & MATERIALS, AND MOUNTING HEIGHTS REFER TO SHEET NO. G-006.
4. FOR ROOM FINISH SCHEDULE SEE A-700 SERIES DRAWINGS.
5. FOR DOOR SCHEDULE SEE A-700 SERIES DRAWINGS. FOR DOOR HARDWARE SPECIFICATION SEE TECHNICAL SPECIFICATION SECTION B0700.
6. FOR PARTITION TYPES SEE A-700 SERIES DRAWINGS.
7. ALL PARTITIONS SHALL BE TYPE DR UNO.
8. FOR REFLECTED CEILING PLANS SEE A-400 SERIES DRAWINGS. IF RCP IS NOT PROVIDED SEE MEPPF PAGE CTEL. SERVICE DRAWINGS FOR LOCATIONS OR ALL CEILING WALL MOUNTED SERVICES.
9. FOR STRUCTURAL COLUMNS, EDGE OF SLAB AND CORE WORK POINTS SEE STRUCTURAL SERIES DRAWINGS, UNO.
10. REFER TO STRUCTURAL SERIES DRAWINGS FOR ALL STRUCTURAL WALL DESIGNATIONS AND DIMENSIONS.
11. REFER TO MEPPF DRAWINGS FOR ALL MECHANICAL, ELECTRICAL, PLUMBING AND FIRE PROTECTION ROOM, RISER AND EQUIPMENT DESIGNATIONS.
12. FOR PROJECT WORK POINT REFER TO A-000 SERIES DRAWINGS.



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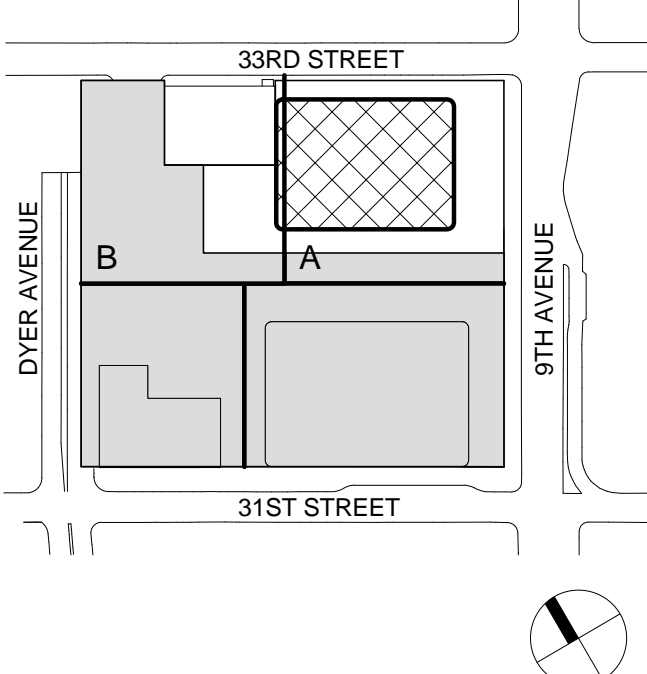
Code Consultant
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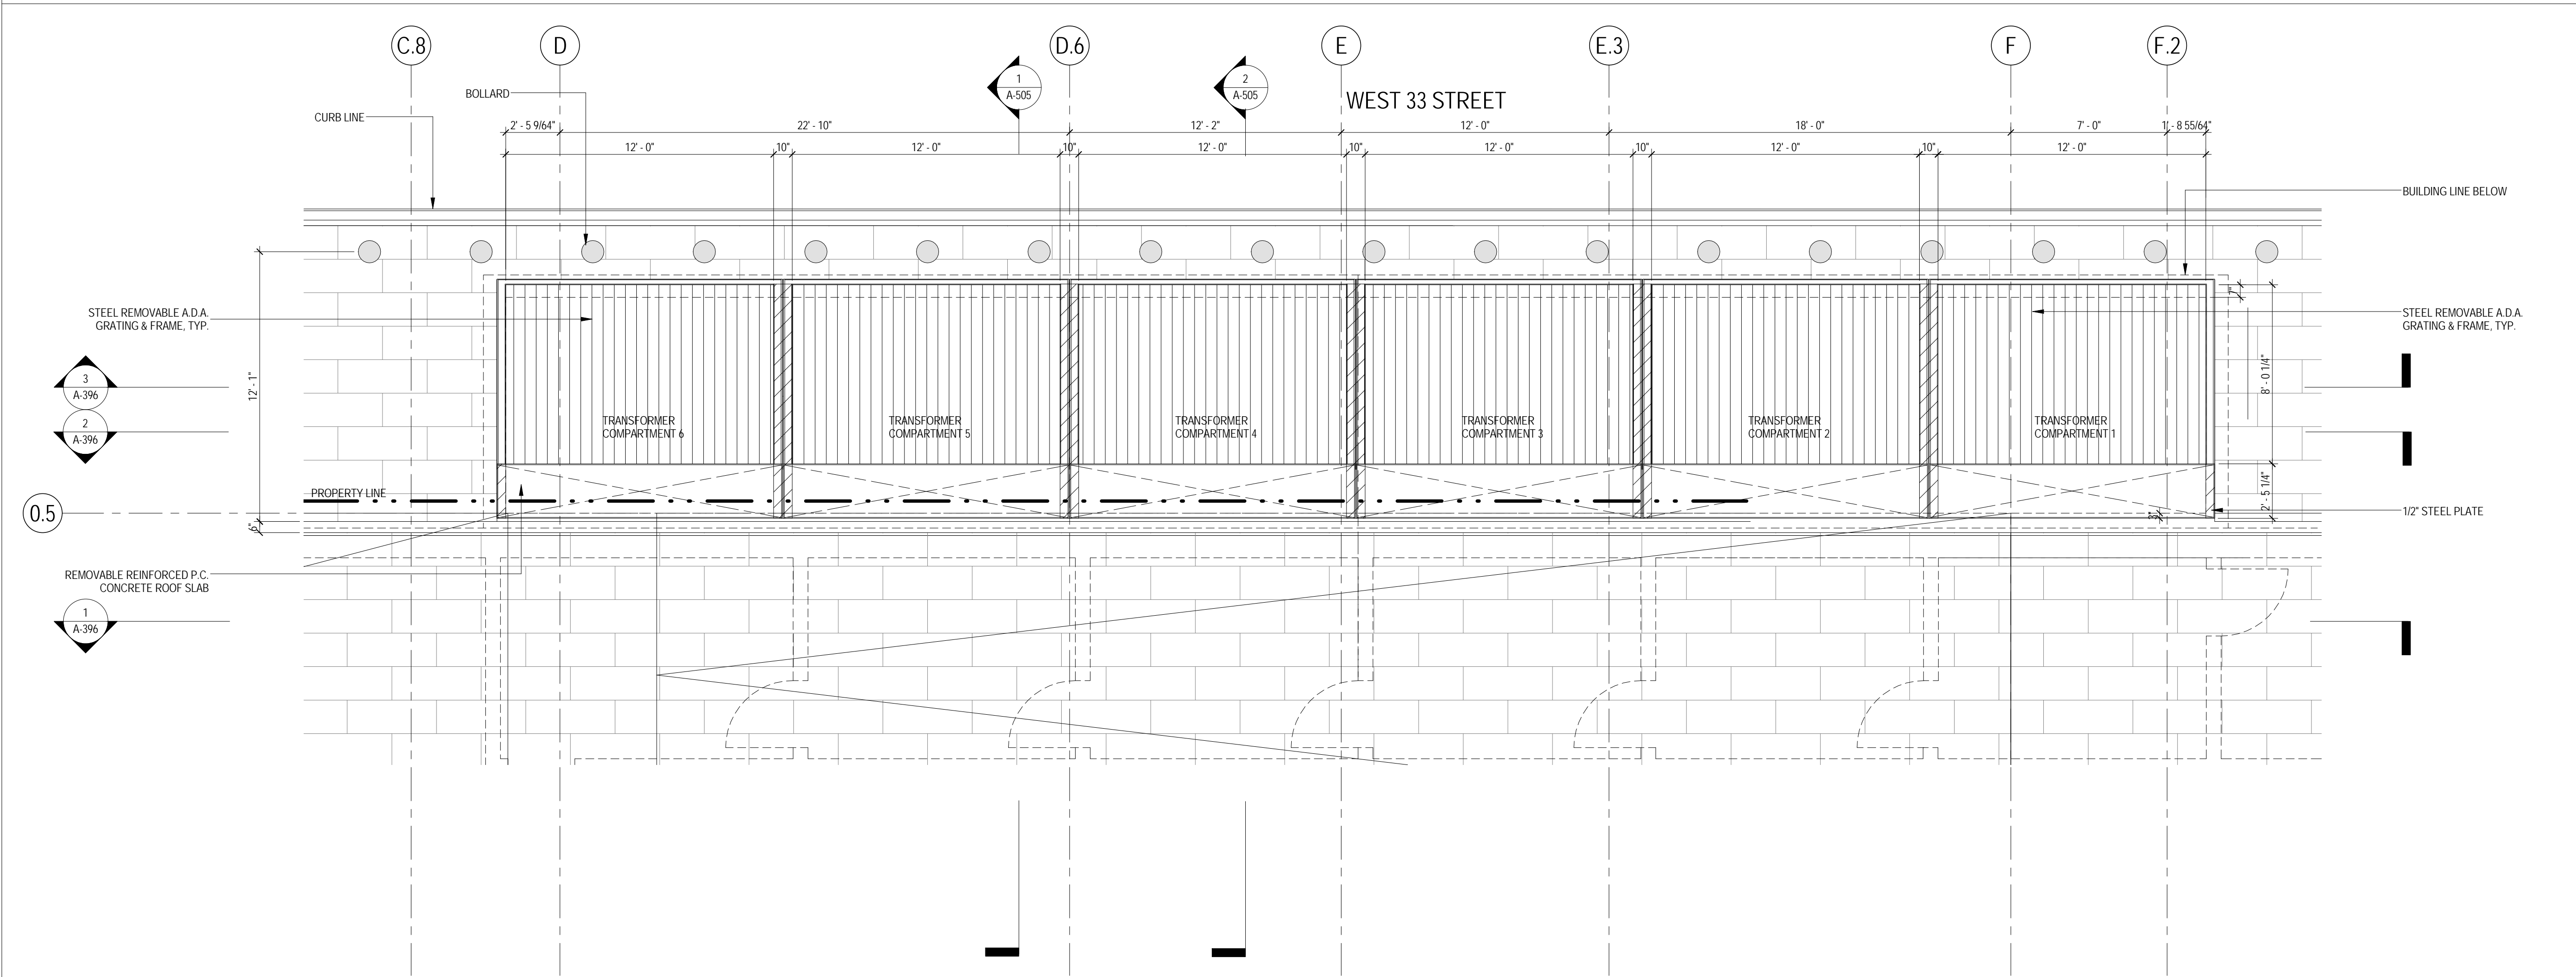


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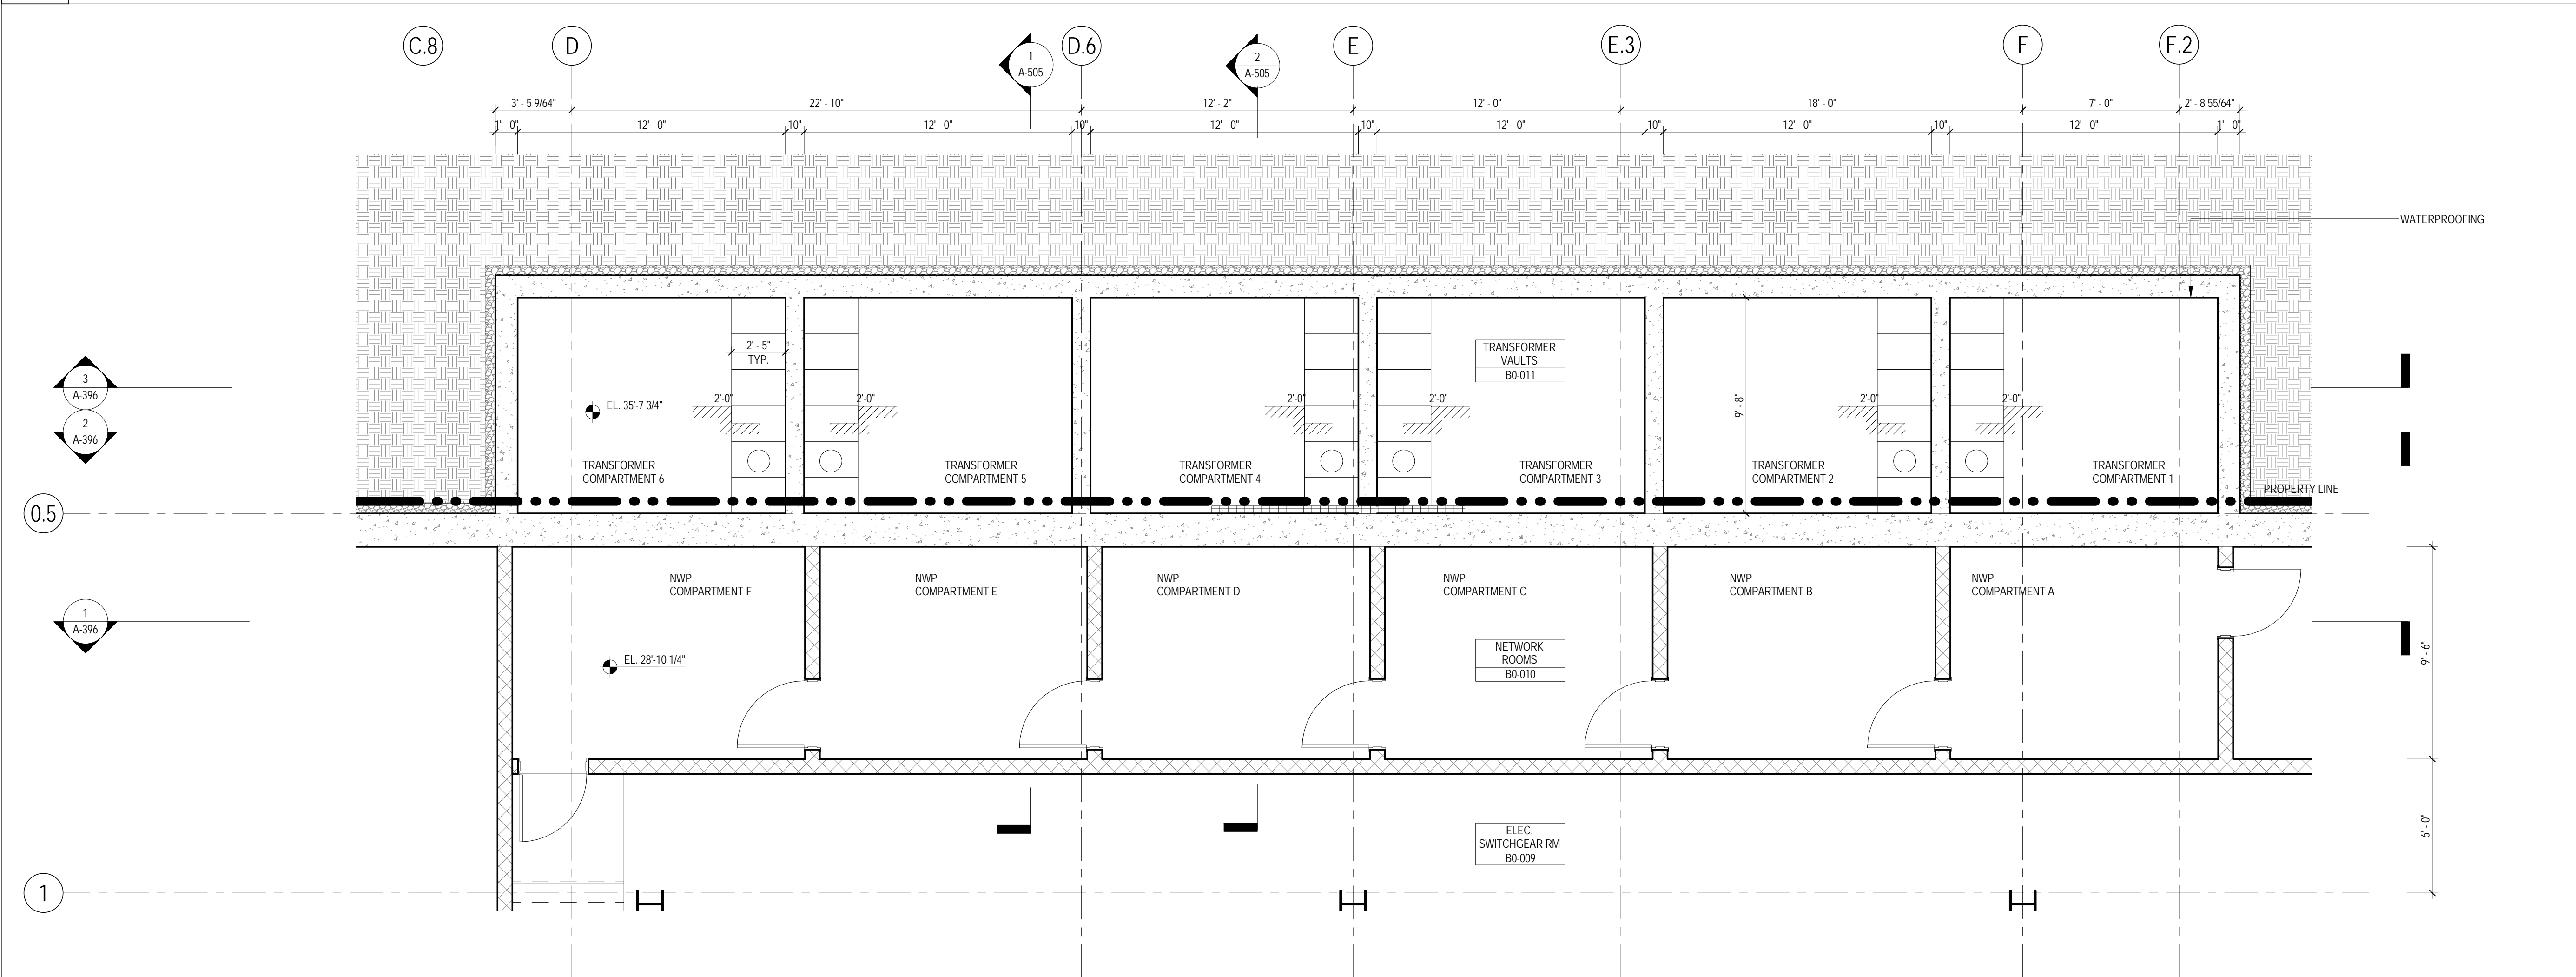
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3 20 JUN 2014 ISSUED FOR FOUNDATION PERMIT
2 20 DEC 2013 ISSUED FOR FOUNDATION PERMIT
1 18 NOV 2013 ISSUED FOR BID PROGRESS PRICING

No. Date Description
Sheet Name:
**ENLARGED
RETAIL CORE
PLANS**

Project No.: 207150
Date: 20 JUN 2014
Scale: 1/4" = 1'-0"
File No.: A-372
B-SCAN Sheet No.: A-372.00
Sheet No.: A-372
Page No.: 76 OF 87



2 ENLARGED PLAN AT GROUND FLOOR TRANSFORMER VAULT
SCALE: 1/4" = 1'-0"



1 ENLARGED PLAN AT CELLAR B TRANSFORMER VAULT
SCALE: 1/4" = 1'-0"

SHEET NOTES

1. REFER TO THE APPROVED CON Edison DRAWINGS FOR ALL TRANSFORMER VAULT AND NETWORK REQUIREMENTS.
2. REFER TO ALL APPLICABLE CON Edison REFERENCE STANDARDS.



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Cerami & Associates
404 Fifth Avenue #8, New York, NY 10016


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65 Broadway, Suite 401, New York, NY 10006

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Code Consultants Professional Engineers PC
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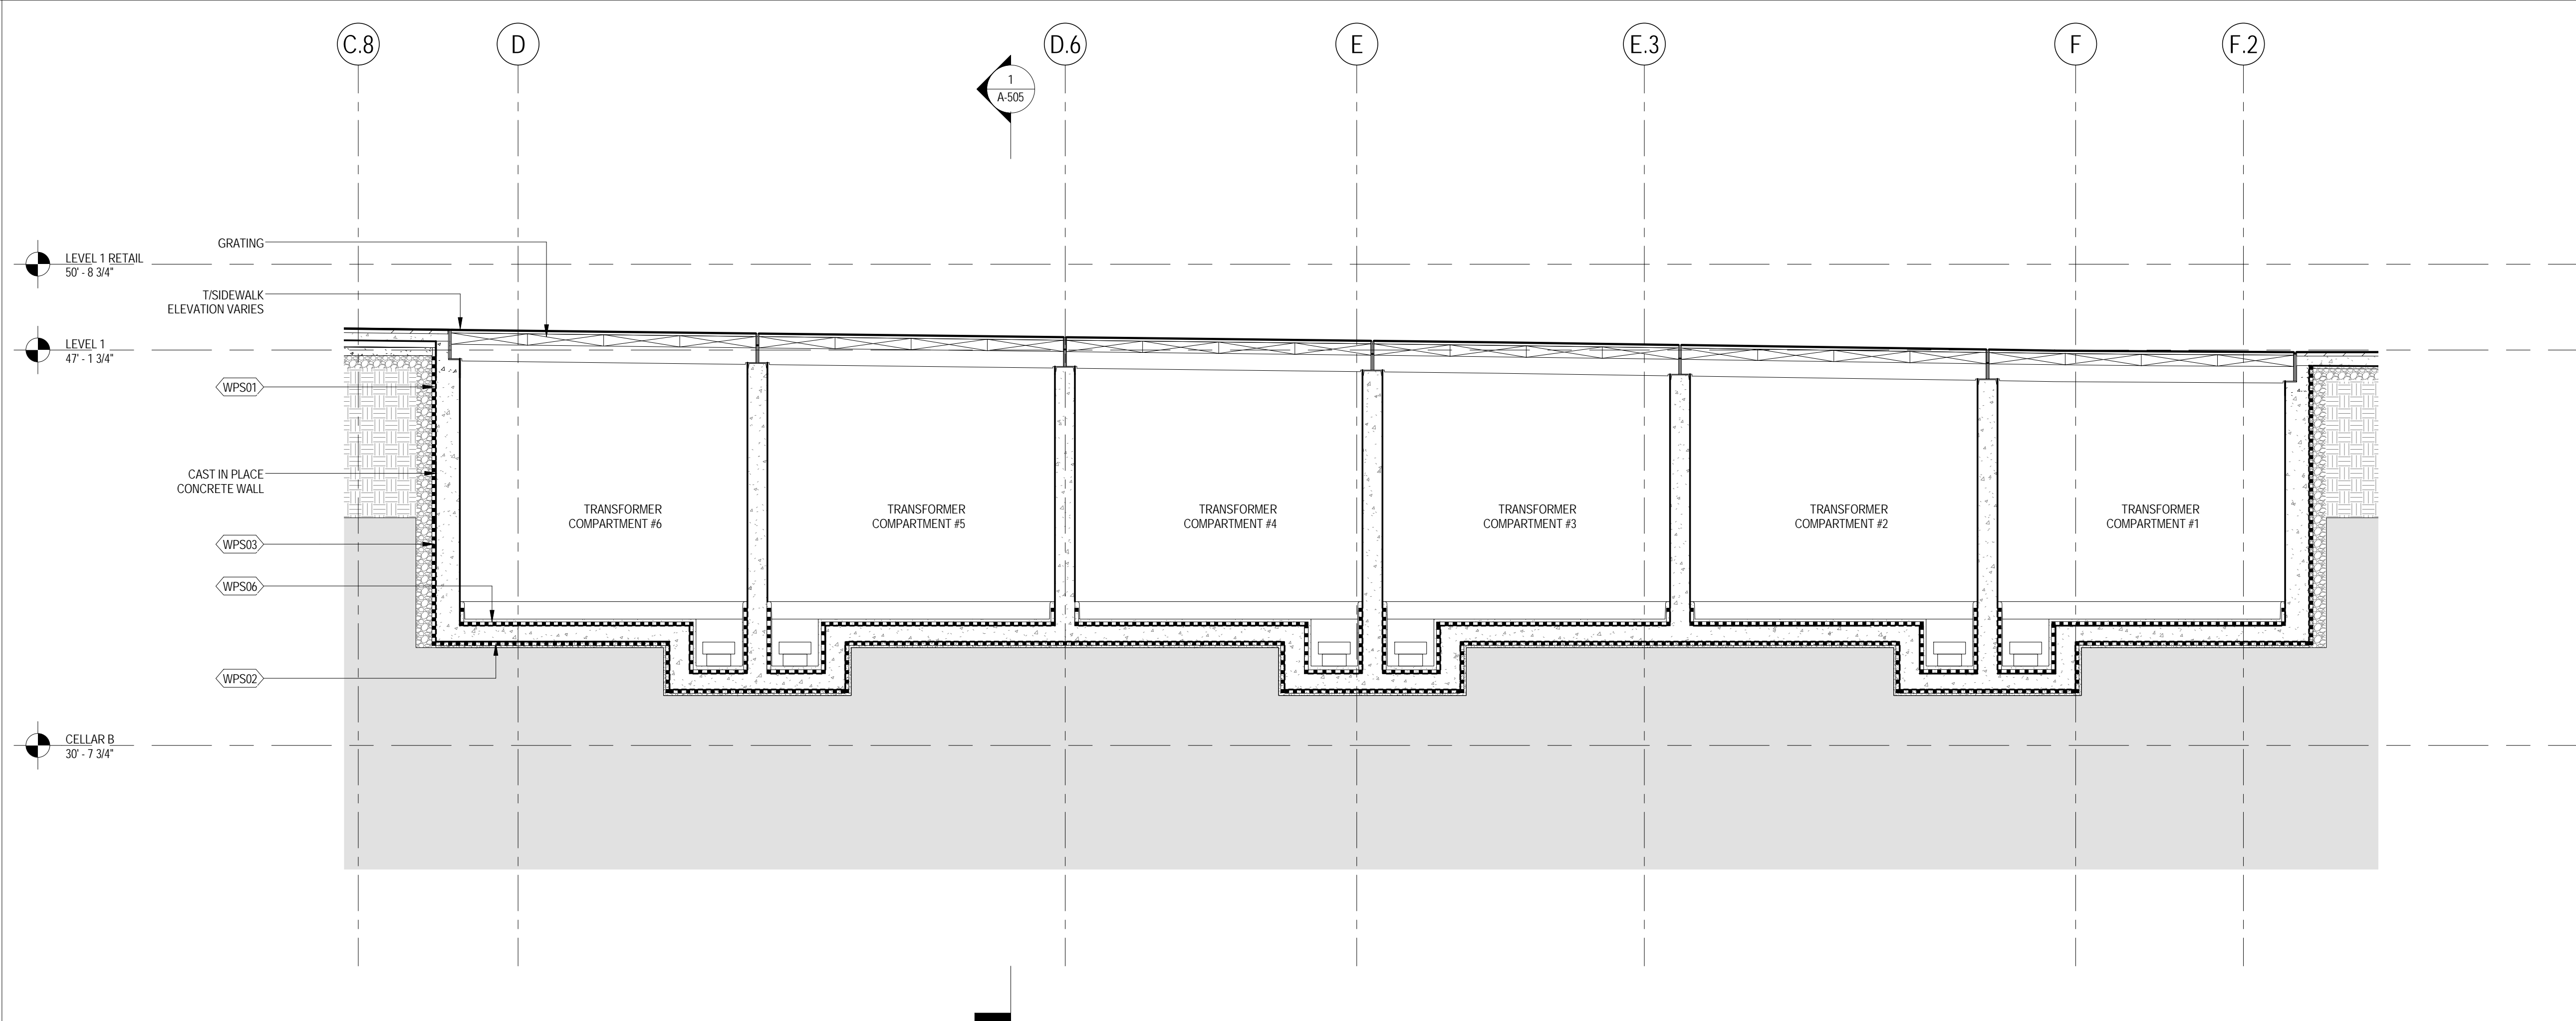
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3	20 JUN 2014	ISSUED FOR FOUNDATION PERMIT
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Sheet Name:		


**ENLARGED
TRANSFORMER
VAULT PLANS**

Project No.: 207120	B-SCAN Sheet No.: A-395.00
Date: 20 JUN 2014	Sheet No.: A-395
Scale: 1/4" = 1'-0"	Page No.: 77 OF 87
File No.: A-395	


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3 TRANSFORMER VAULT SECTION - NORTH

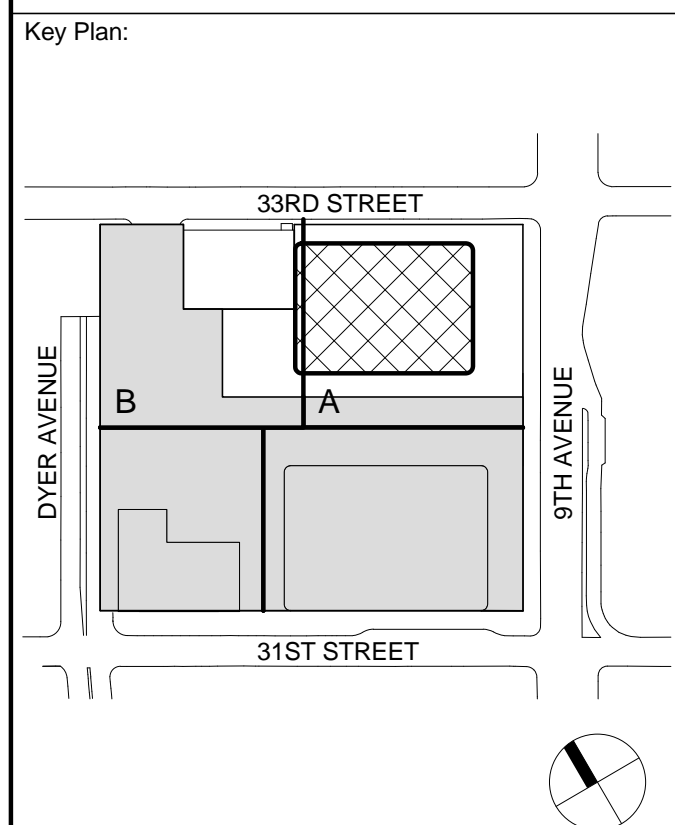

2 TRANSFORMER VAULT SECTION - SOUTH

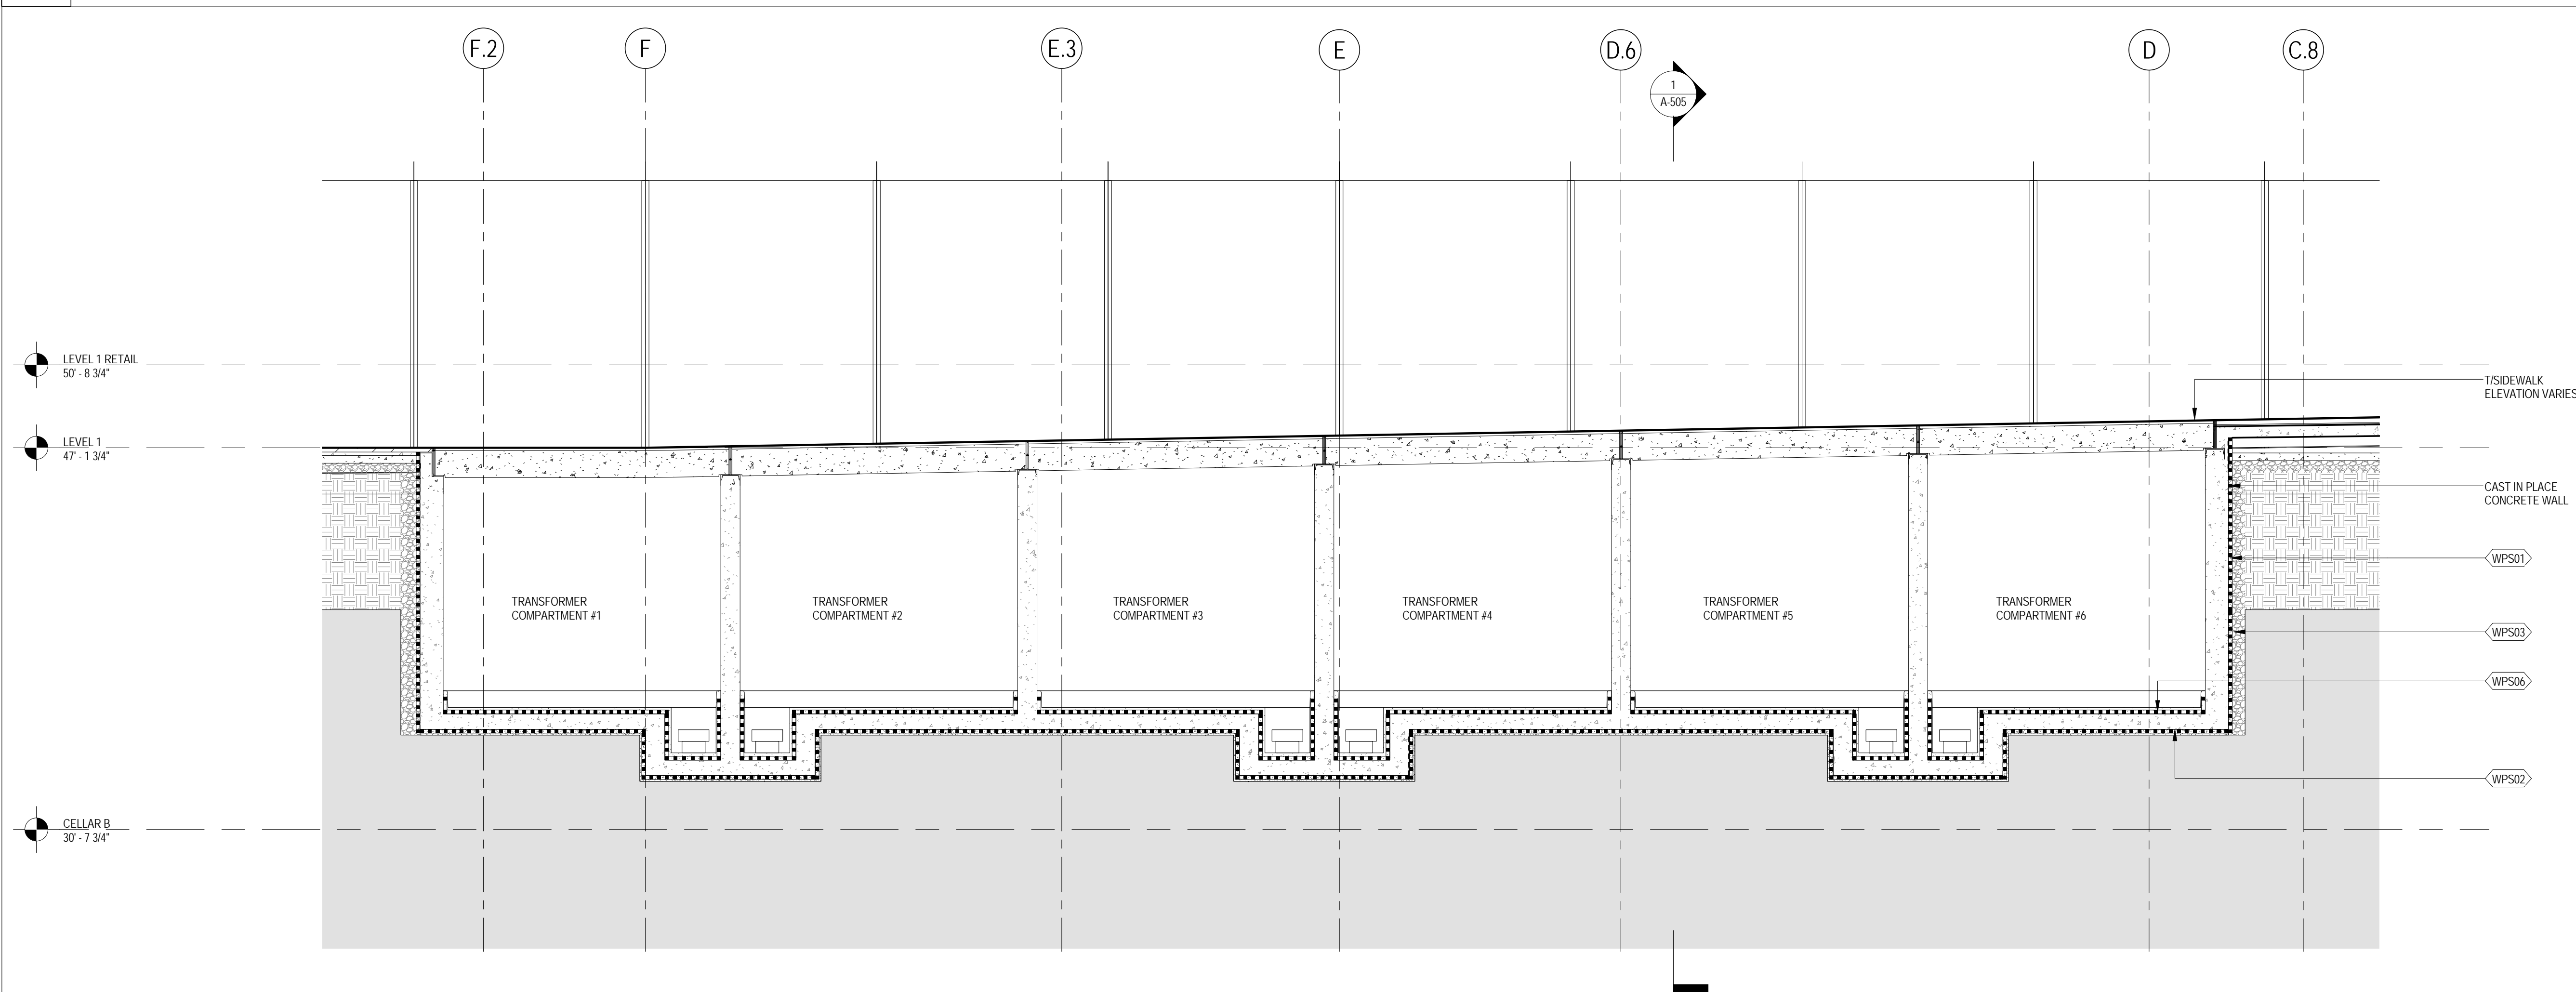

1 NETWORK PROTECTOR COMPARTMENT SECTION

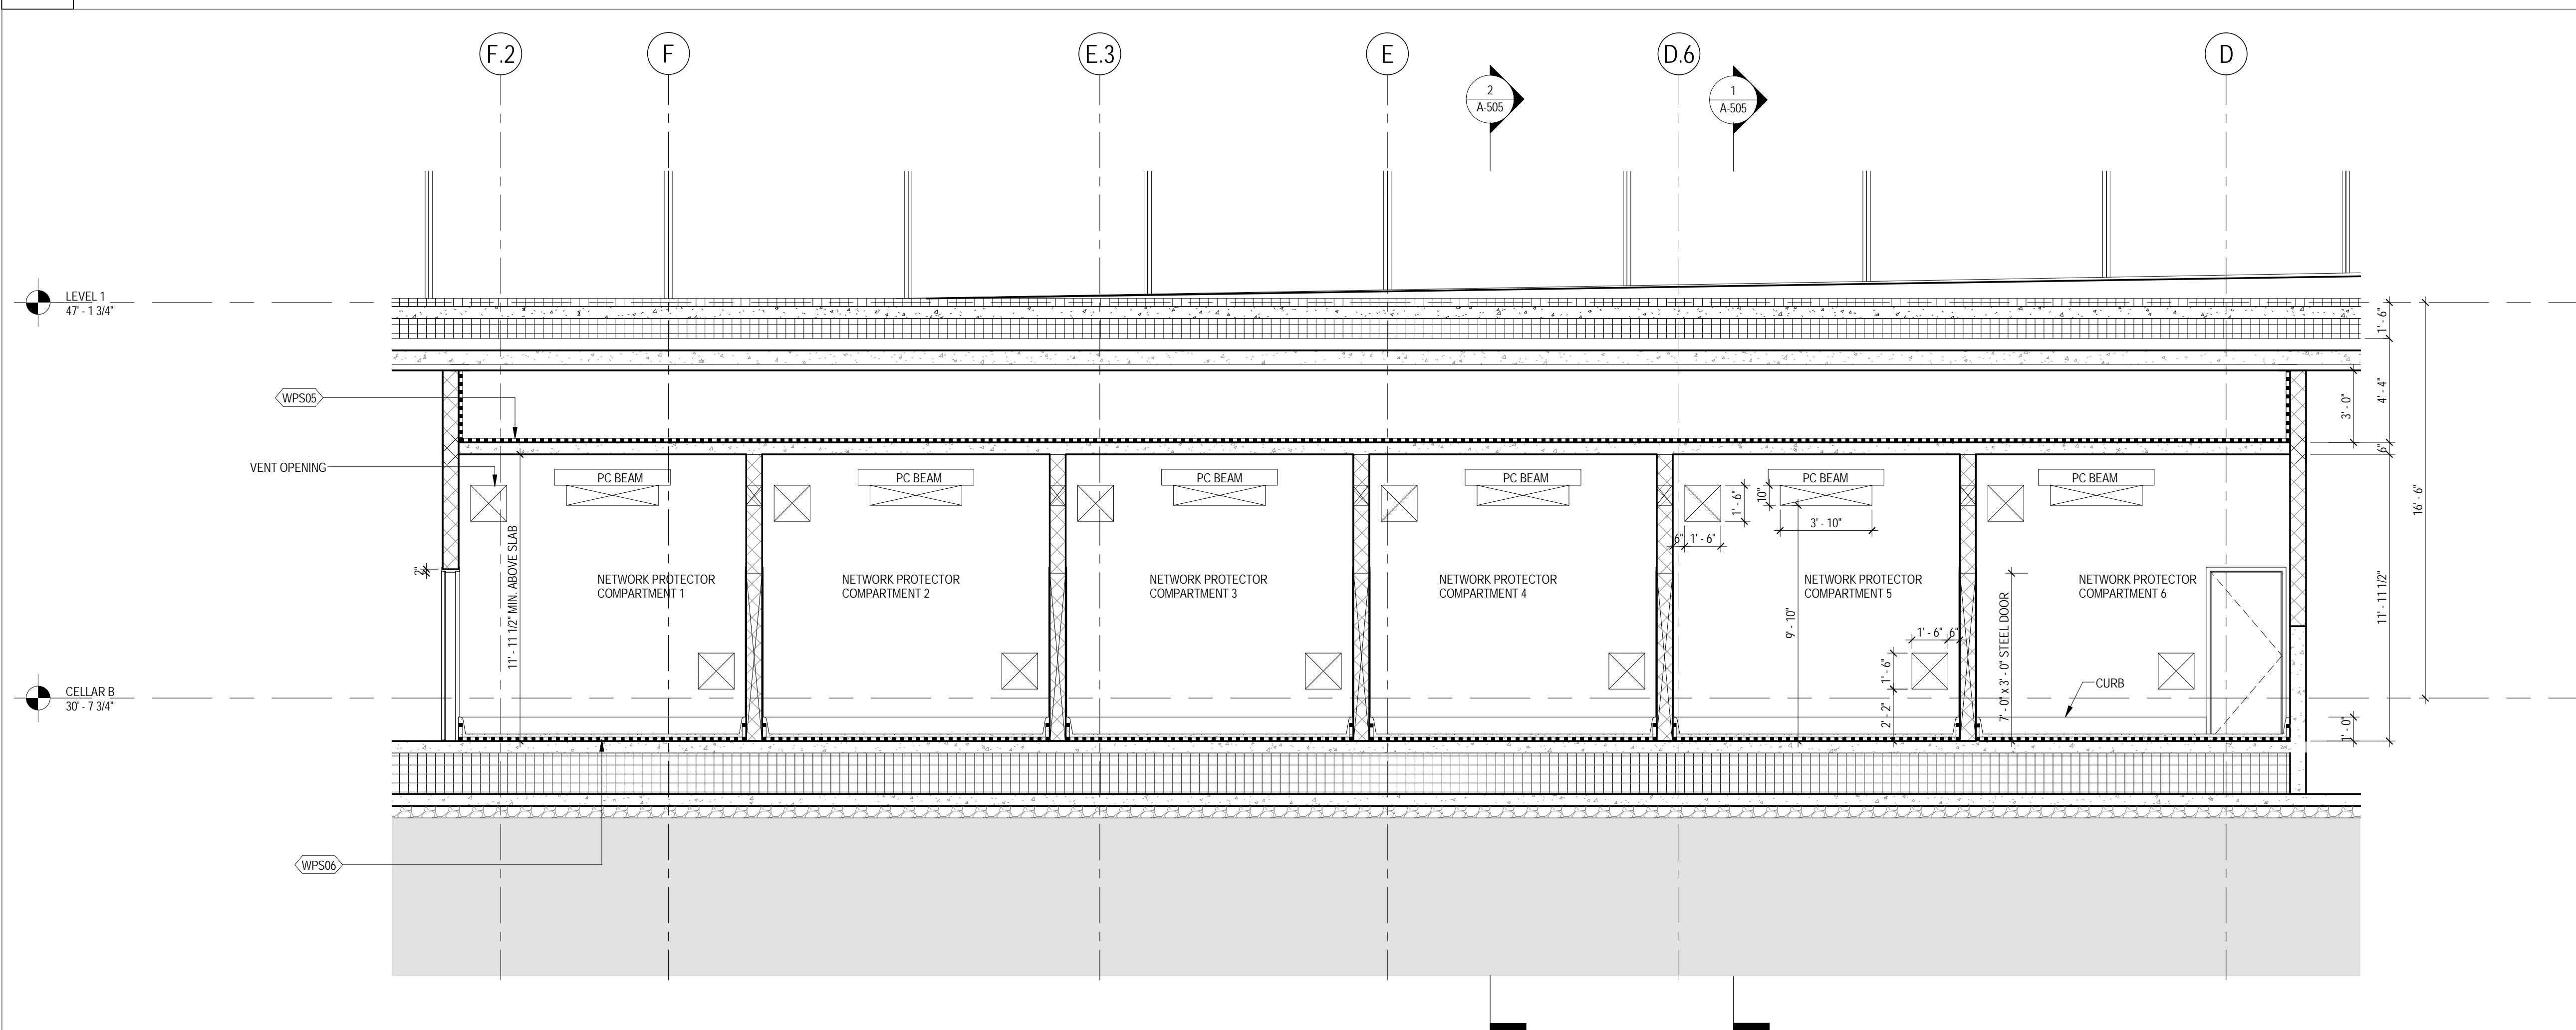SHEET NOTES

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Facade Maintenance Consultant


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3	20 JUN 2014	ISSUED FOR FOUNDATION PERMIT
2	20 DEC 2013	ISSUED FOR FOUNDATION PERMIT
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No. Date Description

Sheet Name:

ENLARGED
TRANSFORMER
VAULT SECTIONS

Project No.:

207150

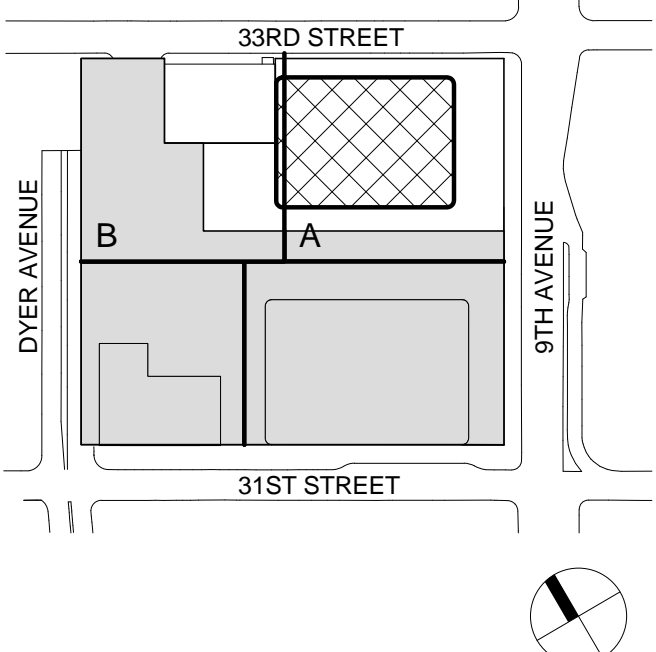Date:

20 JUN 2014

Scale:

1/4" = 1'-0"

File No.:

A-396

B-SCAN Sheet No.:



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Sheet No.:

A-396

Page No.:


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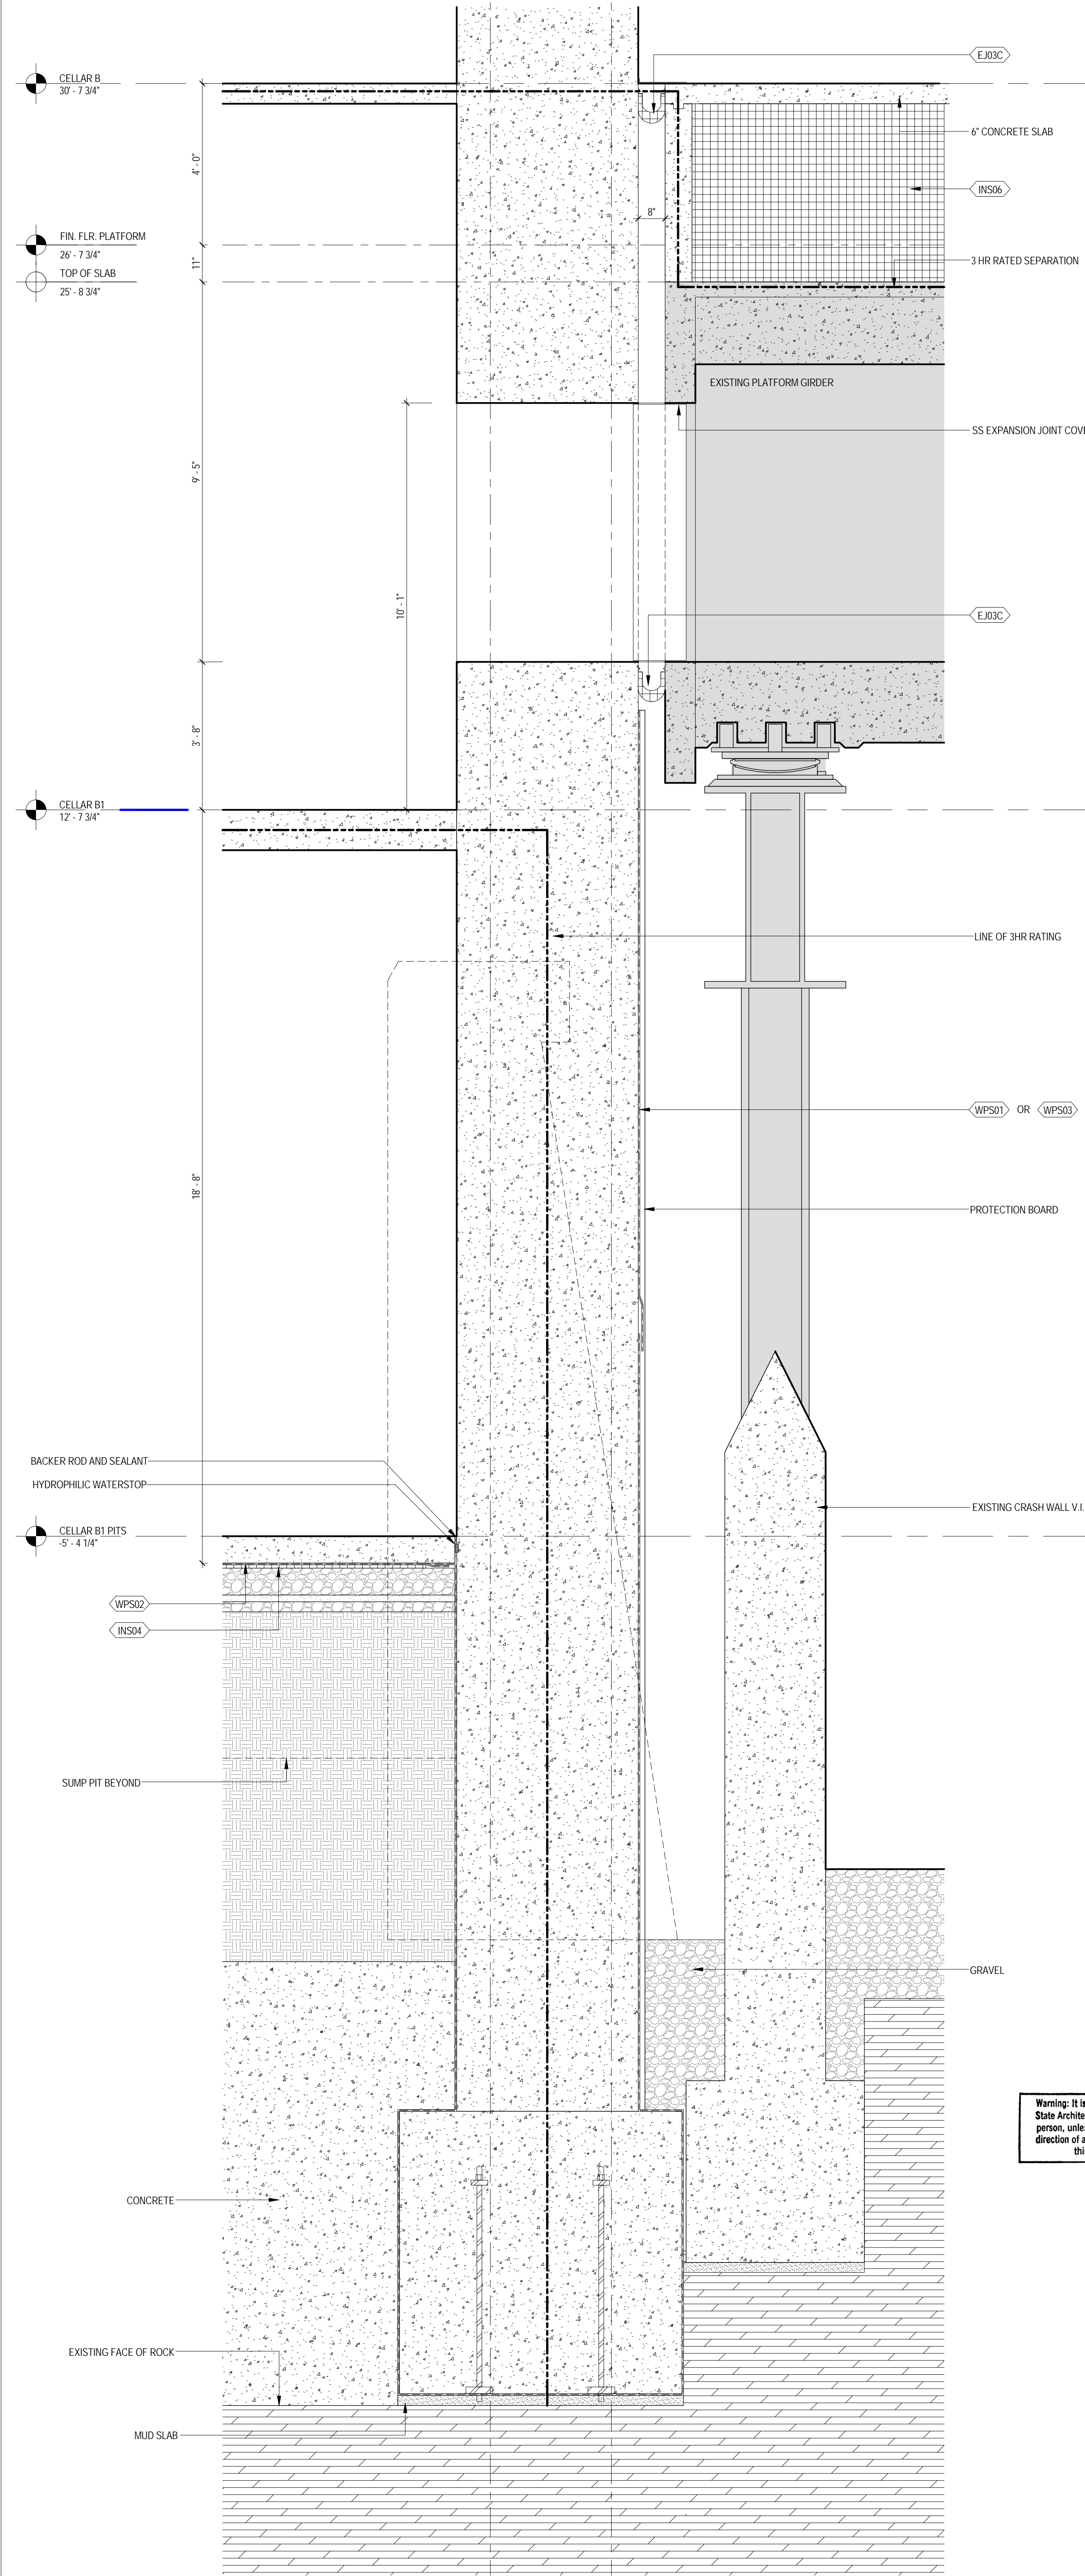
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


1

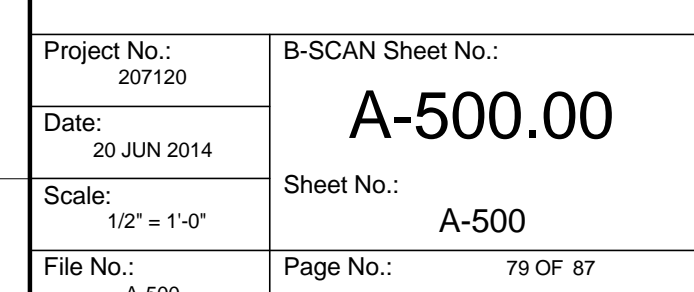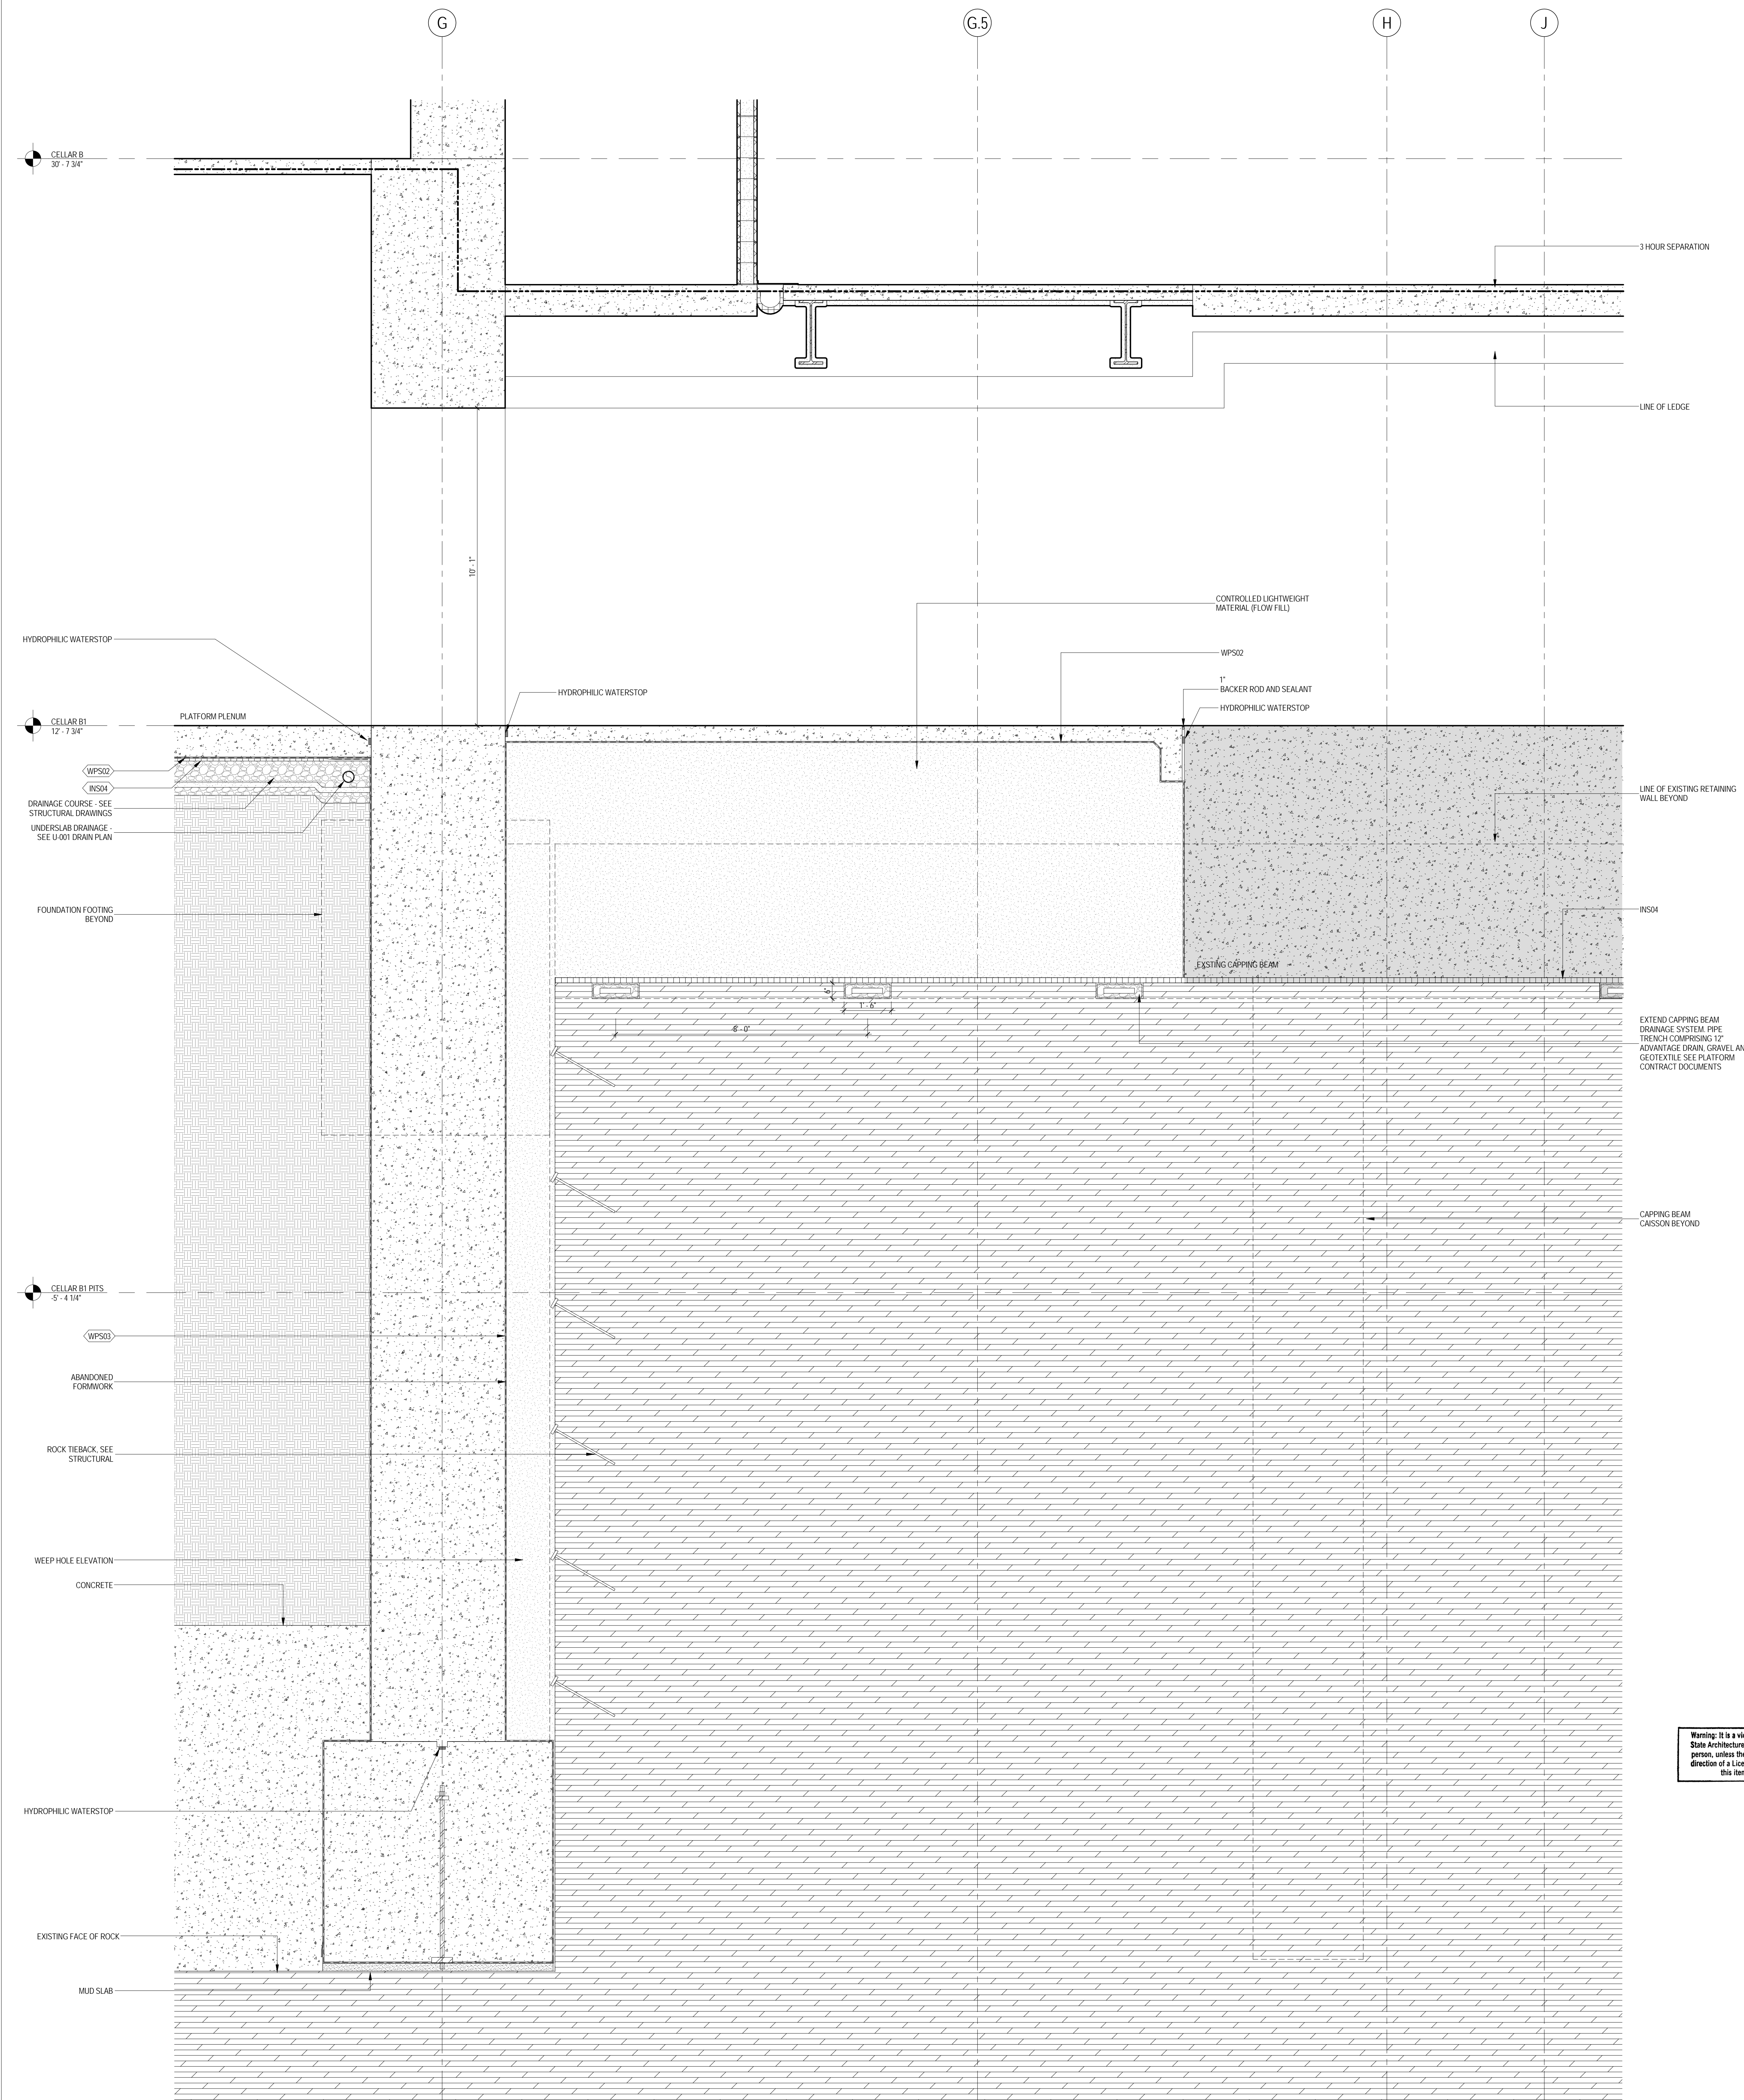FOUNDATION SECTION AT CORE

SCALE: 1/2" = 1'-0"



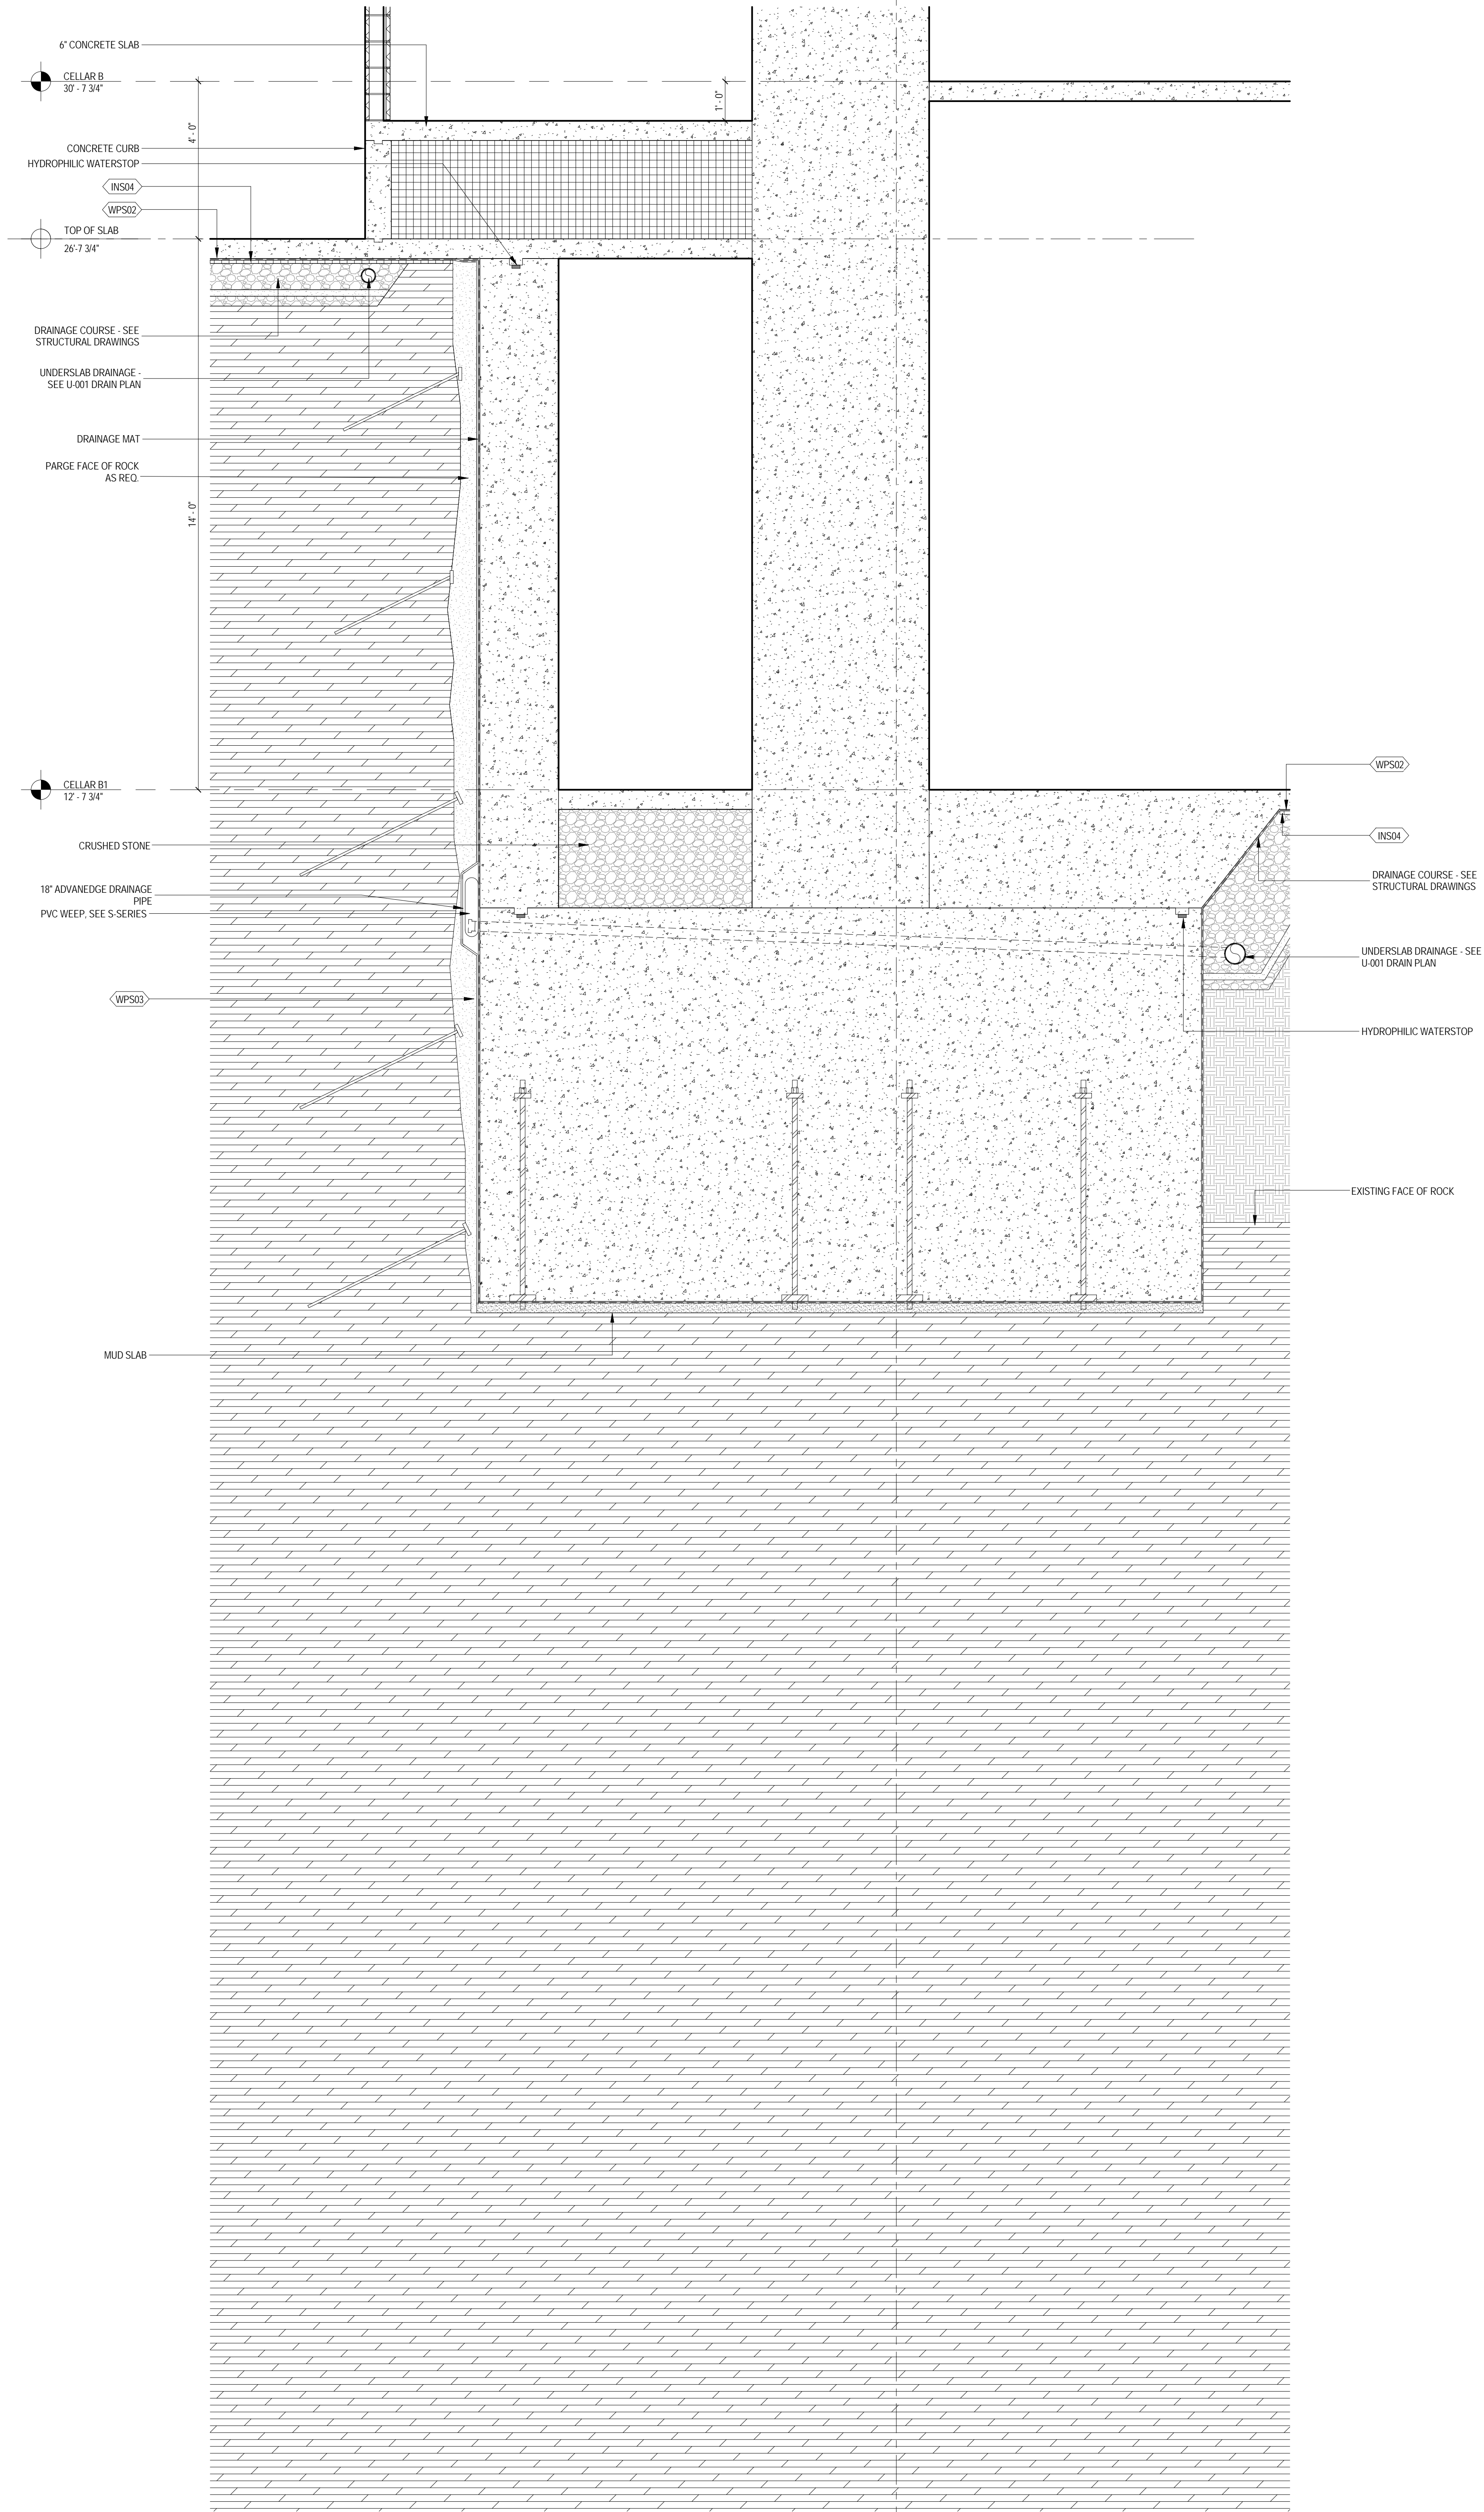

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
Facade Maintenance Consultant
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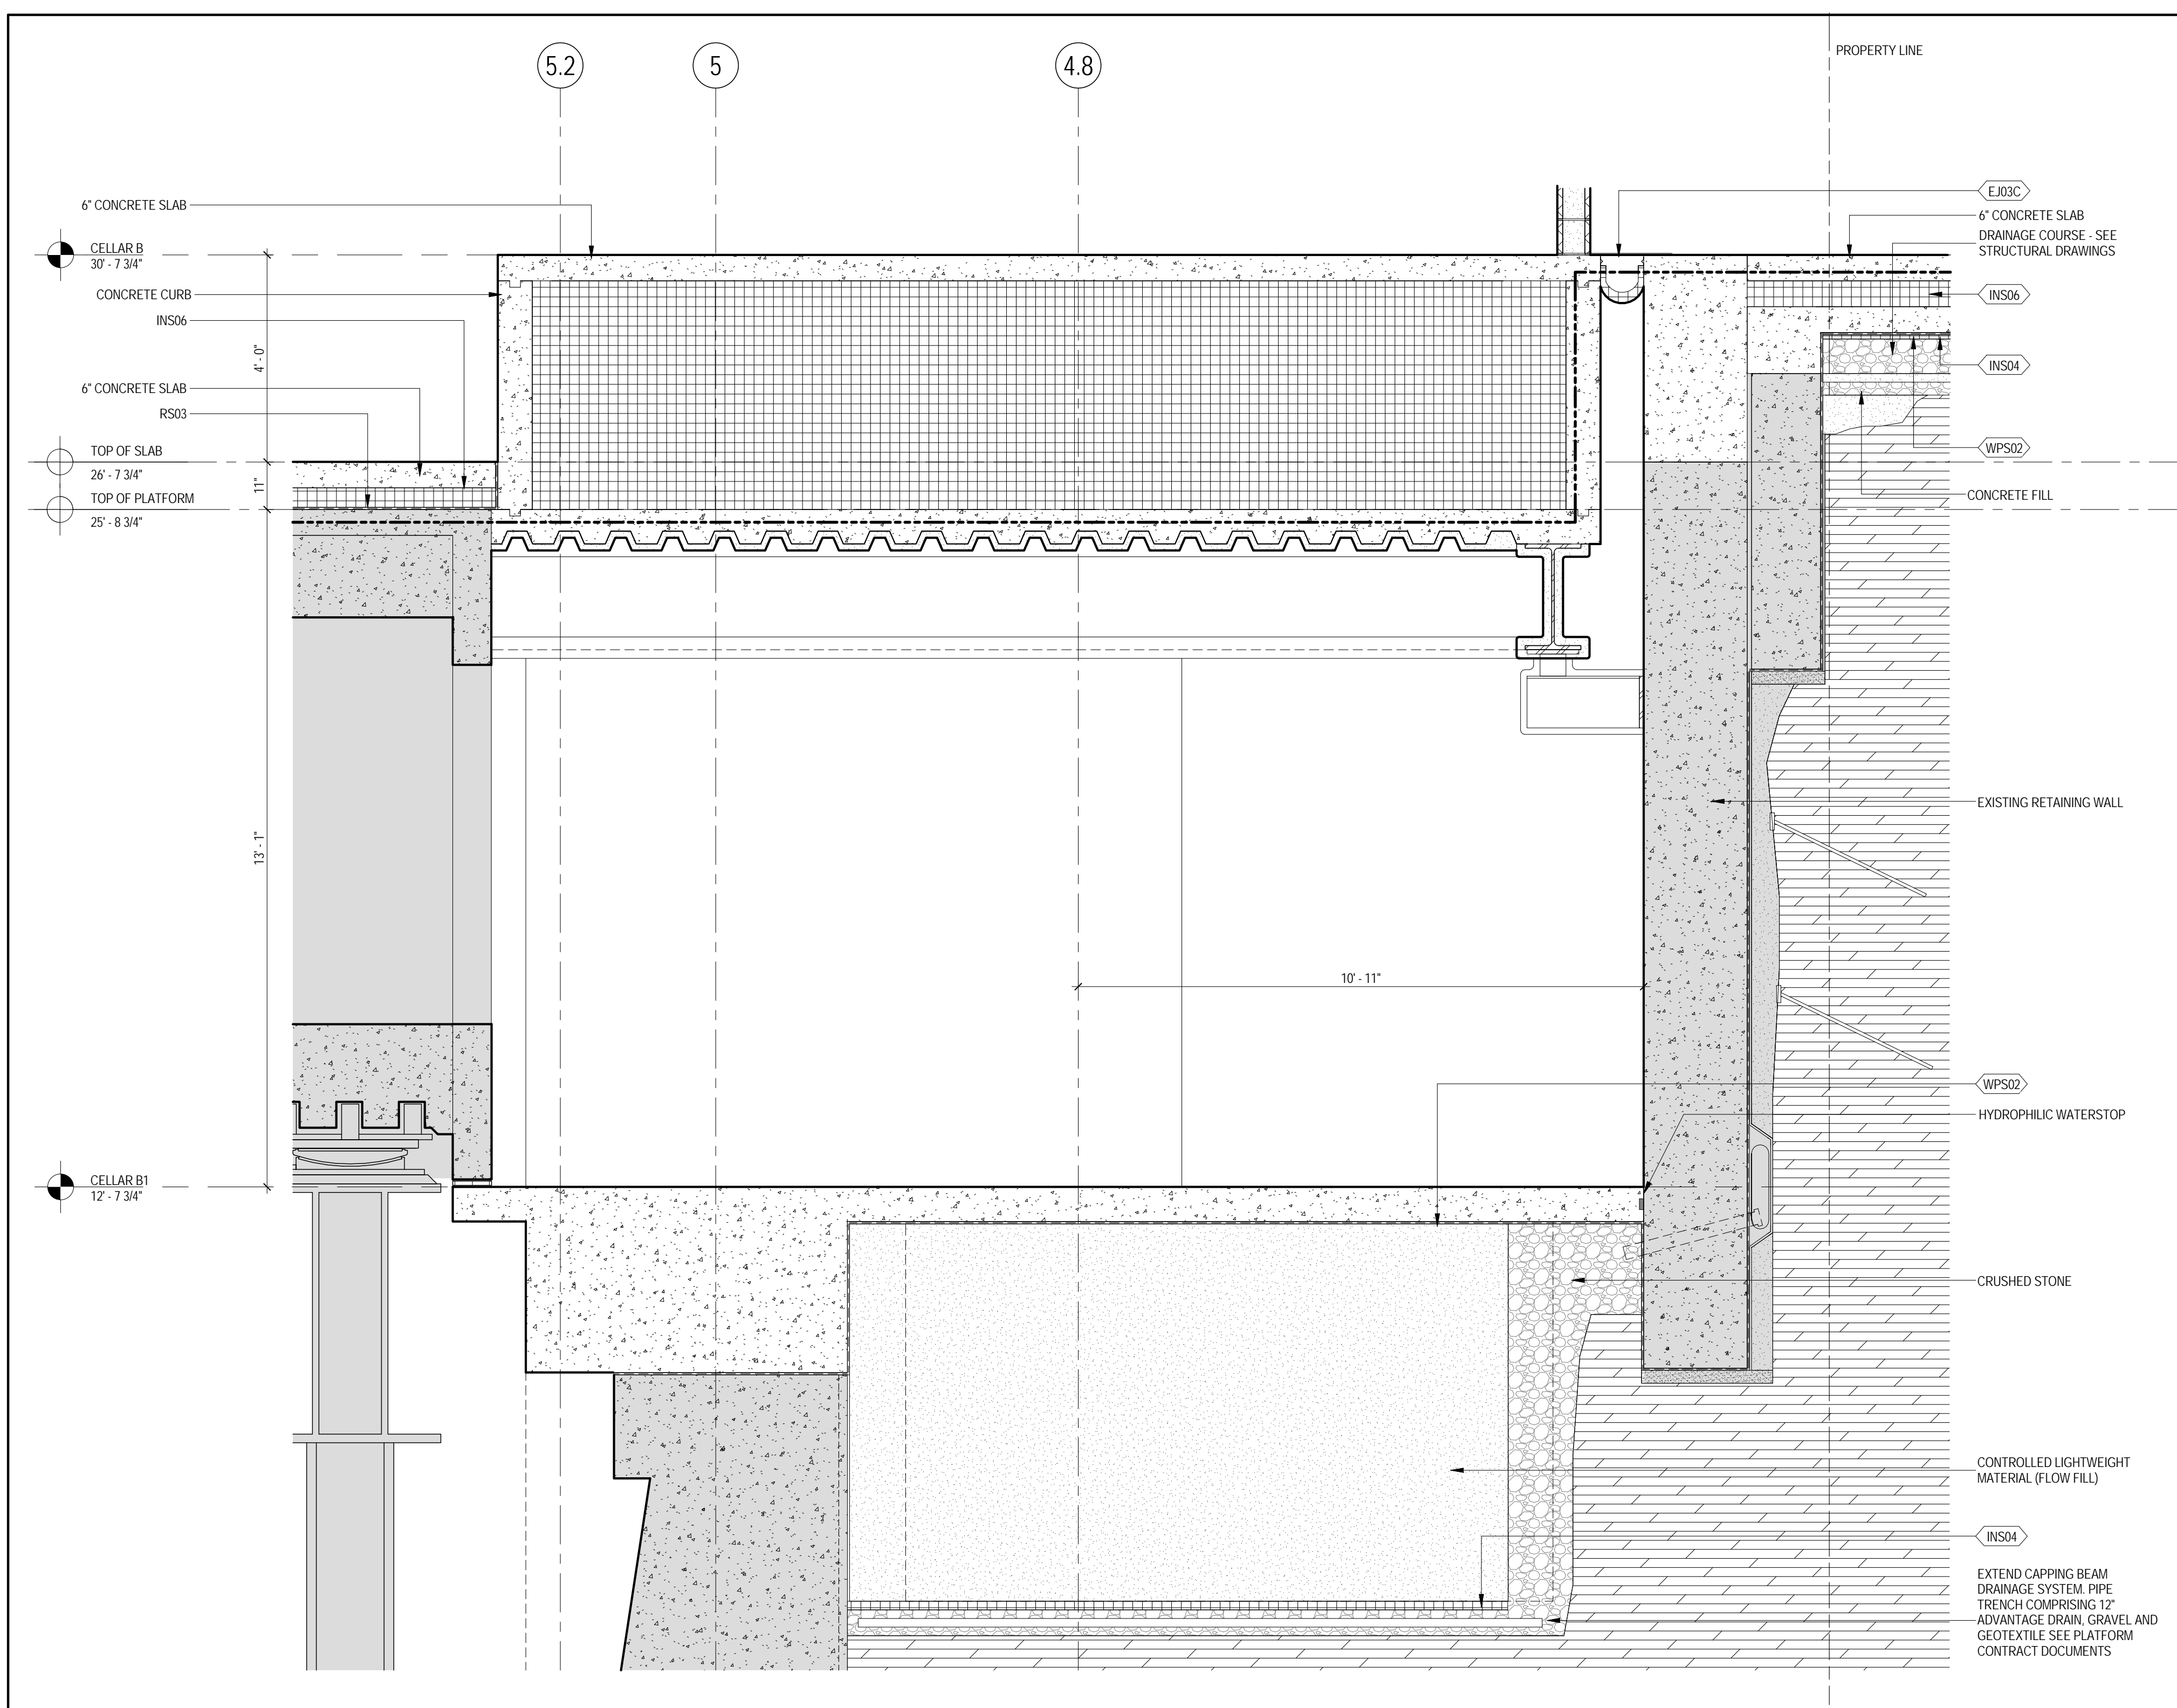
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4	20 JUN 2014	ISSUED FOR FOUNDATION PERMIT
3	20 DEC 2013	ISSUED FOR FOUNDATION PERMIT
2	15 NOV 2013	ISSUED FOR DD PROGRESS PRICING
1	12 JUL 2013	ISSUED FOR 50% DESIGN DEVELOPMENT

No. Date Description


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**FOUNDATION
WALL SECTIONS**


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Date: 20 JUN 2014	Sheet No.: A-501
Scale: 1/2" = 1'-0"	Page No.: 80 OF 87
File No.: A-501	




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2 FOUNDATION SECTION
SCALE: 1/2" = 1'-0"

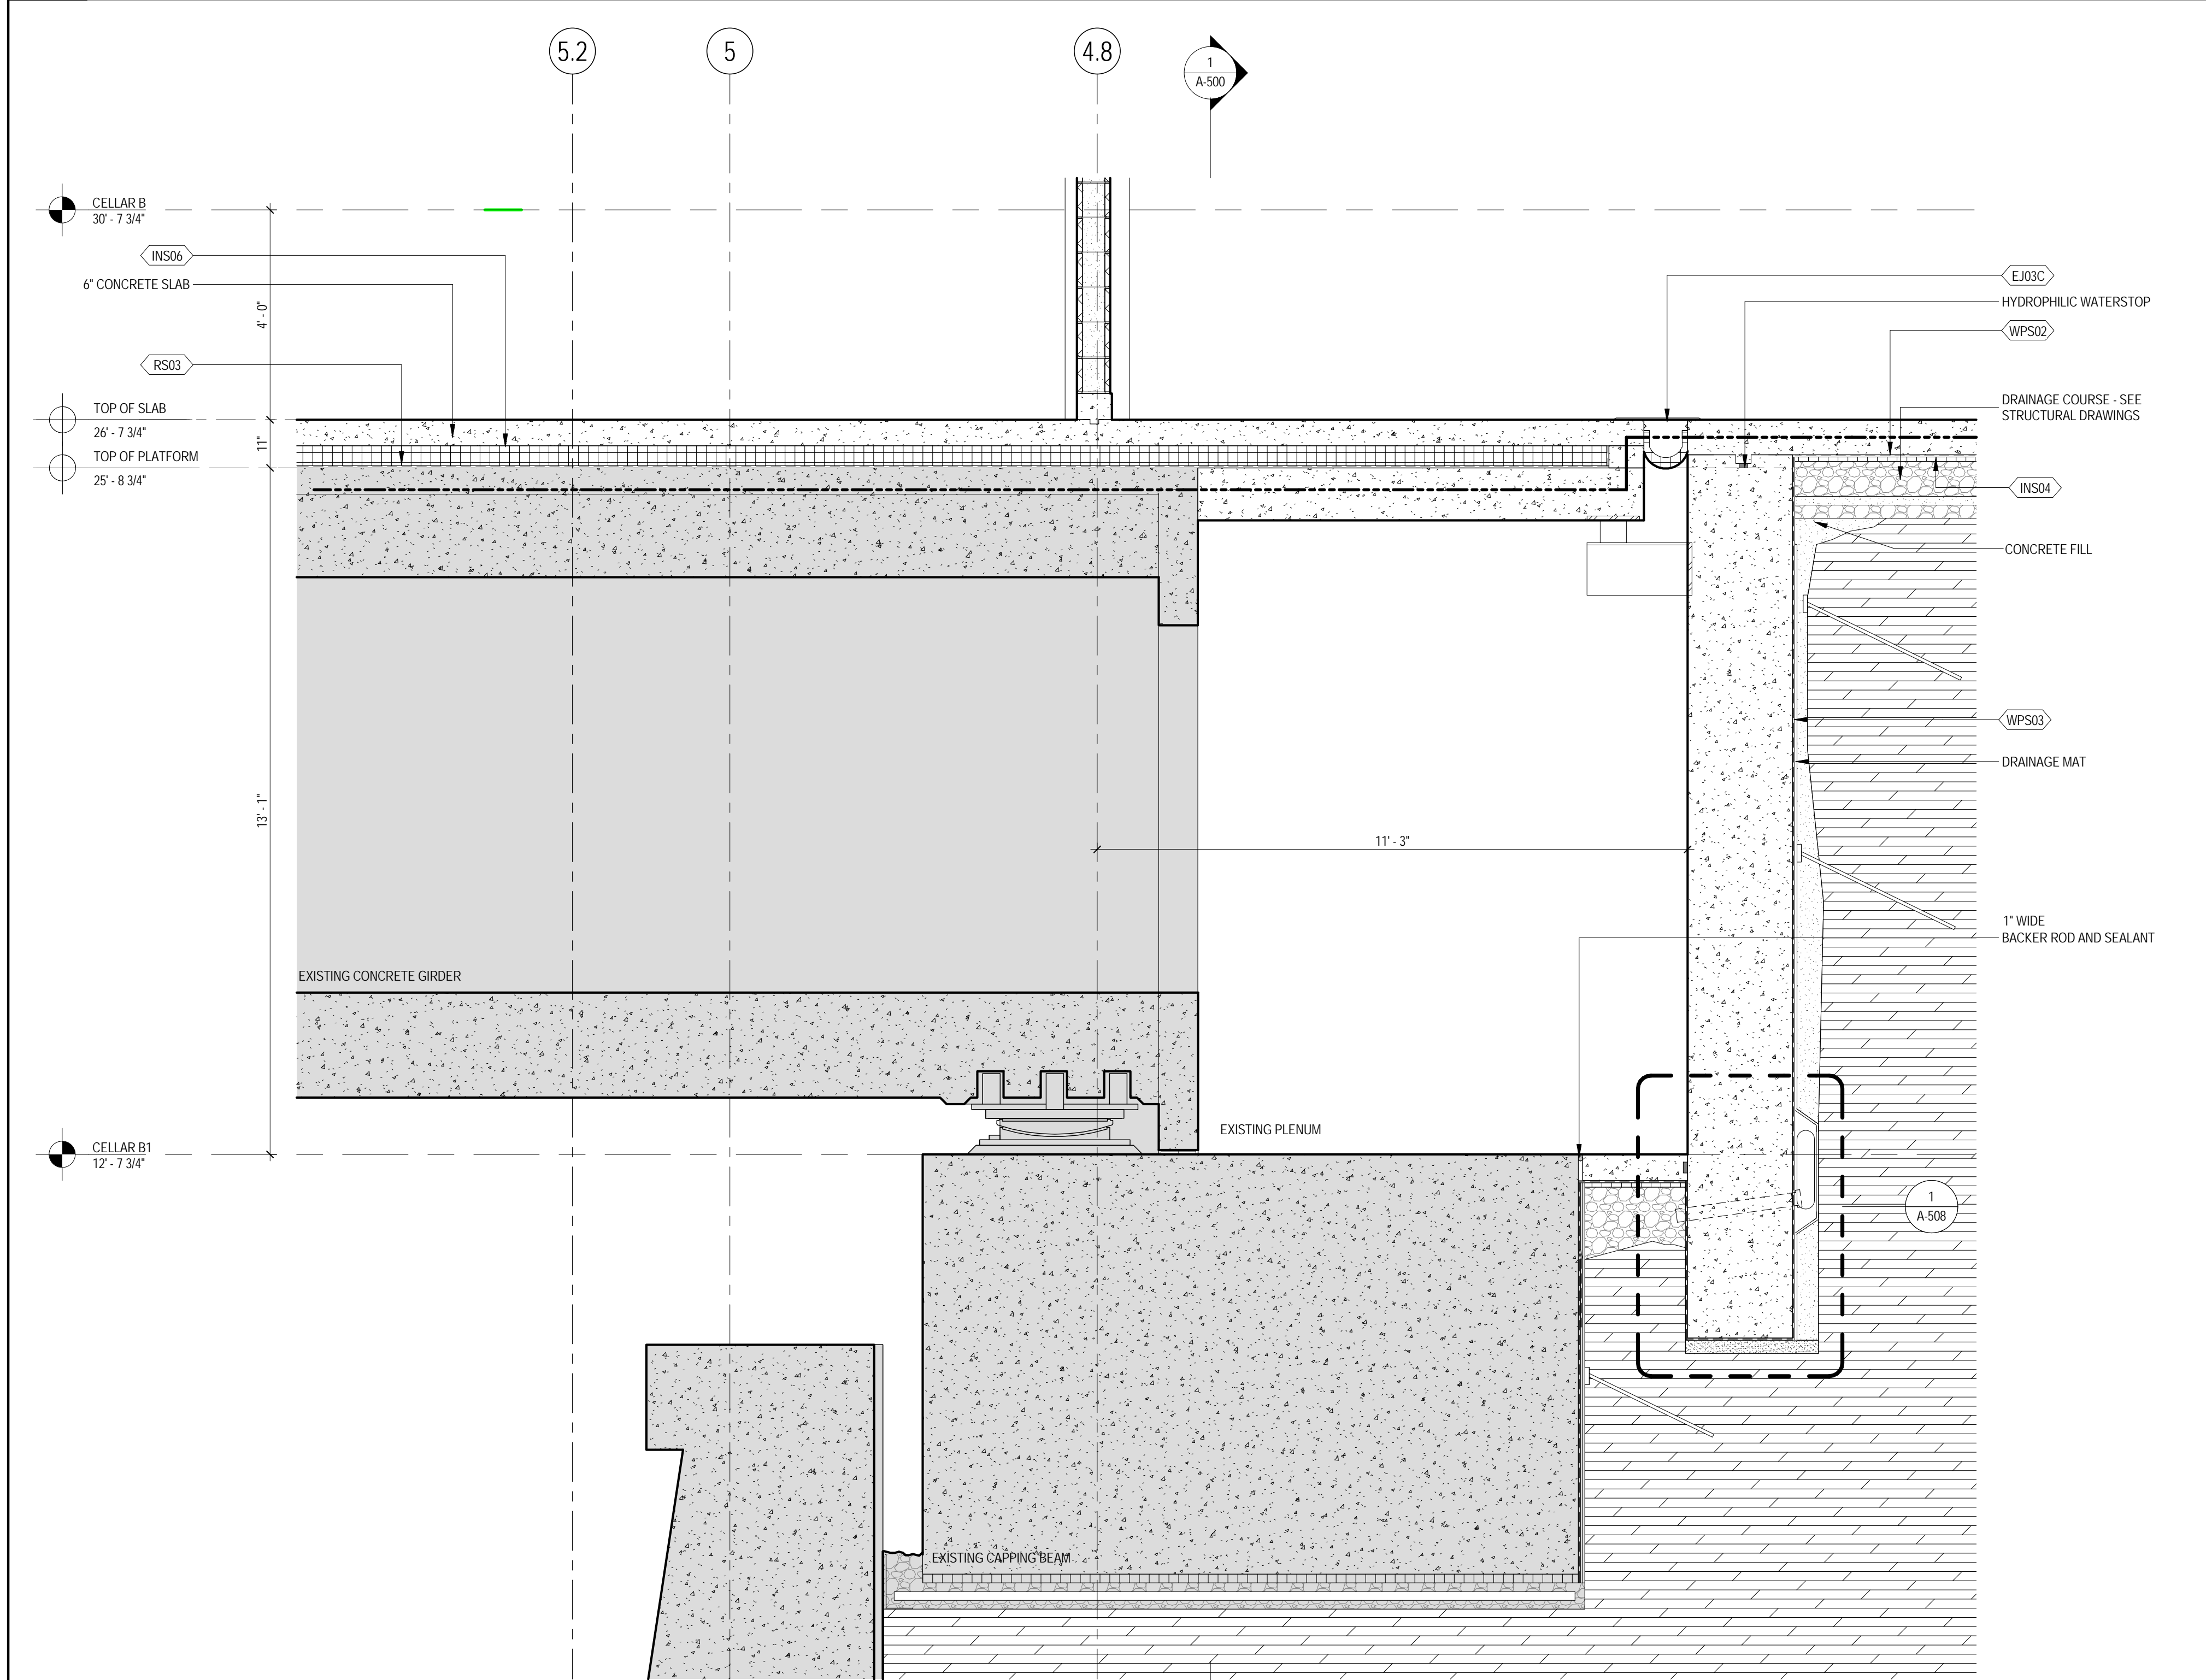

1 FOUNDATION SECTION
SCALE: 1/2" = 1'-0"

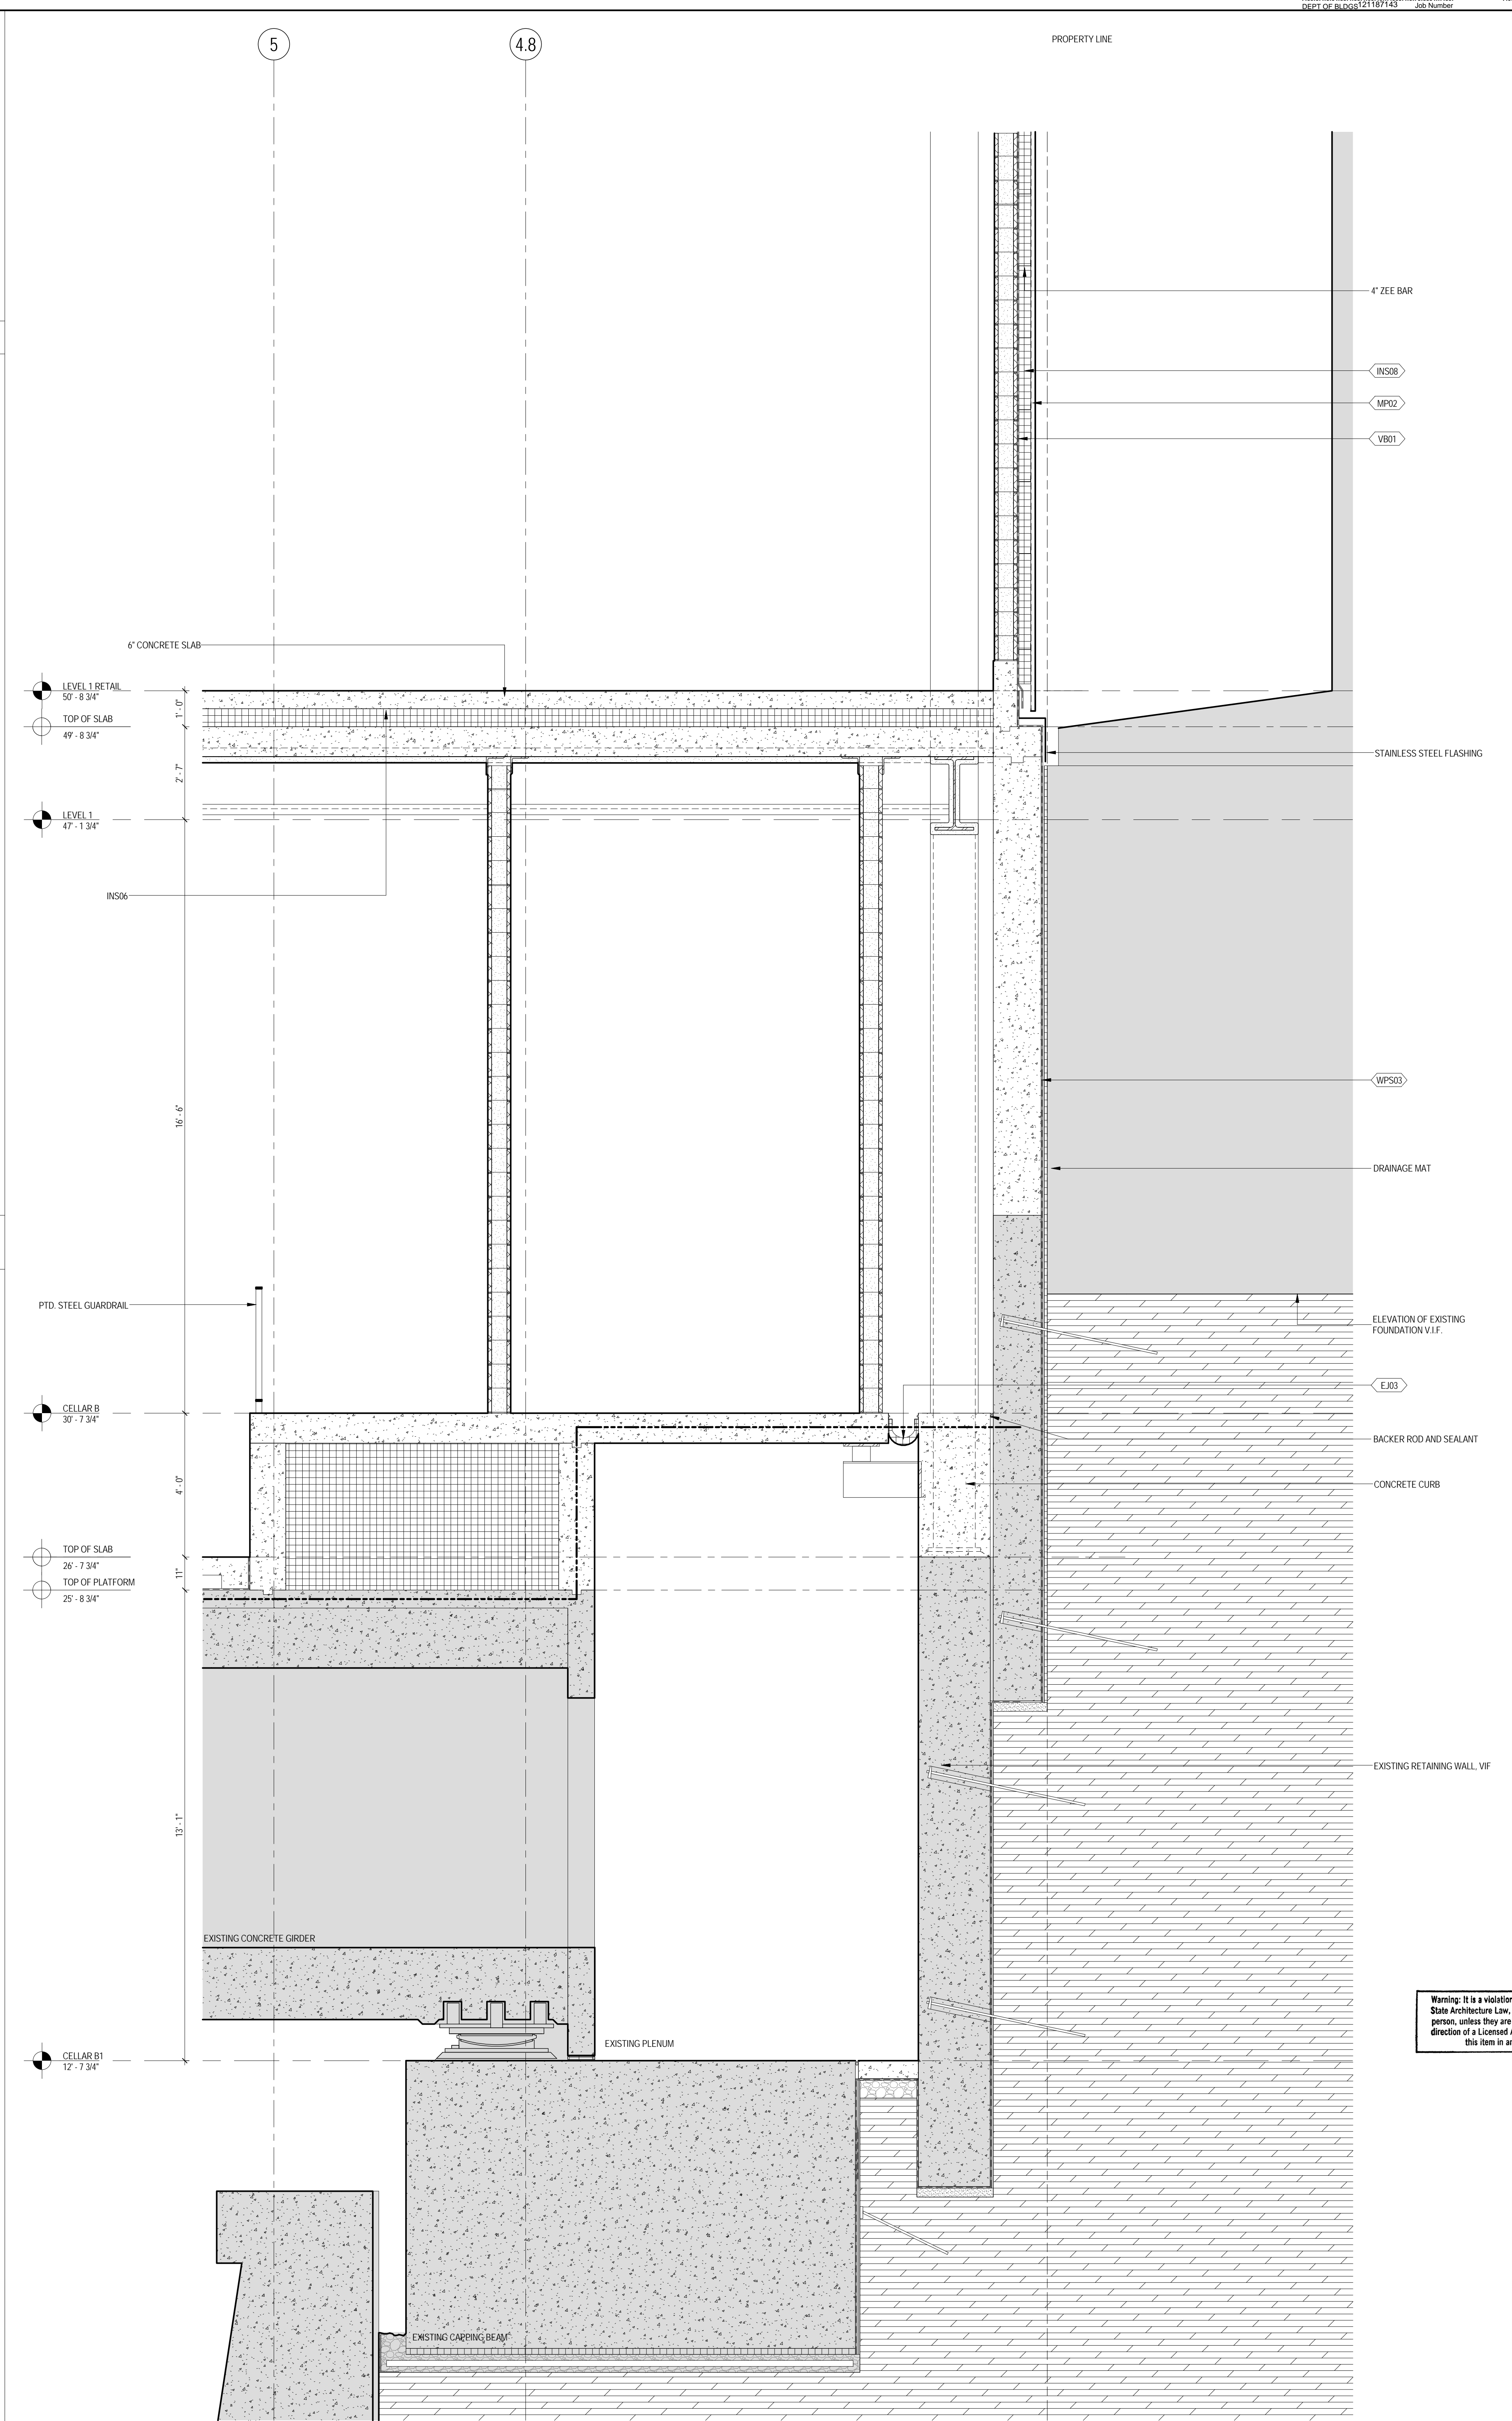

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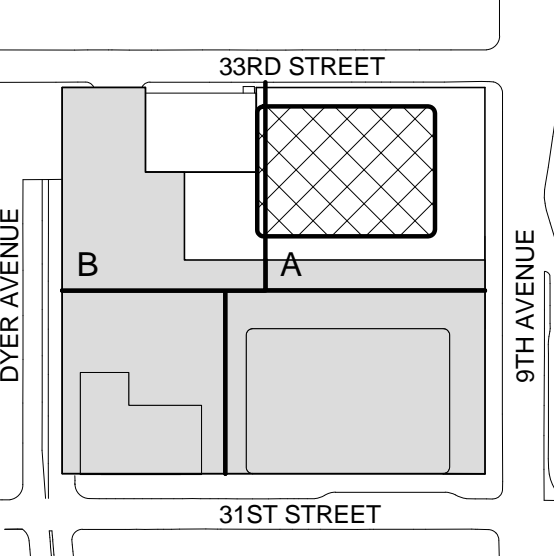
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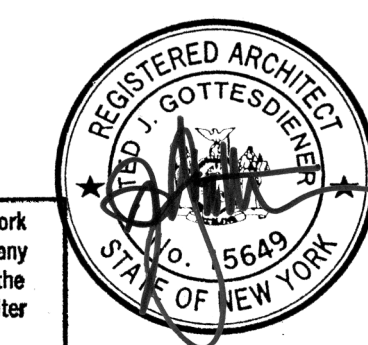
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2	15 NOV 2013	ISSUED FOR DD PROGRESS PRICING
1	12 JUL 2013	ISSUED FOR 50% DESIGN DEVELOPMENT

Sheet Name:

**FOUNDATION
WALL SECTIONS**

Project No.:	B-SCAN Sheet No.:
207150	A-502.00
Date:	20 JUN 2014
Scale:	1/2" = 1'-0"
File No.:	A-502

Sheet No.:	Page No.:
A-502	81 OF 87

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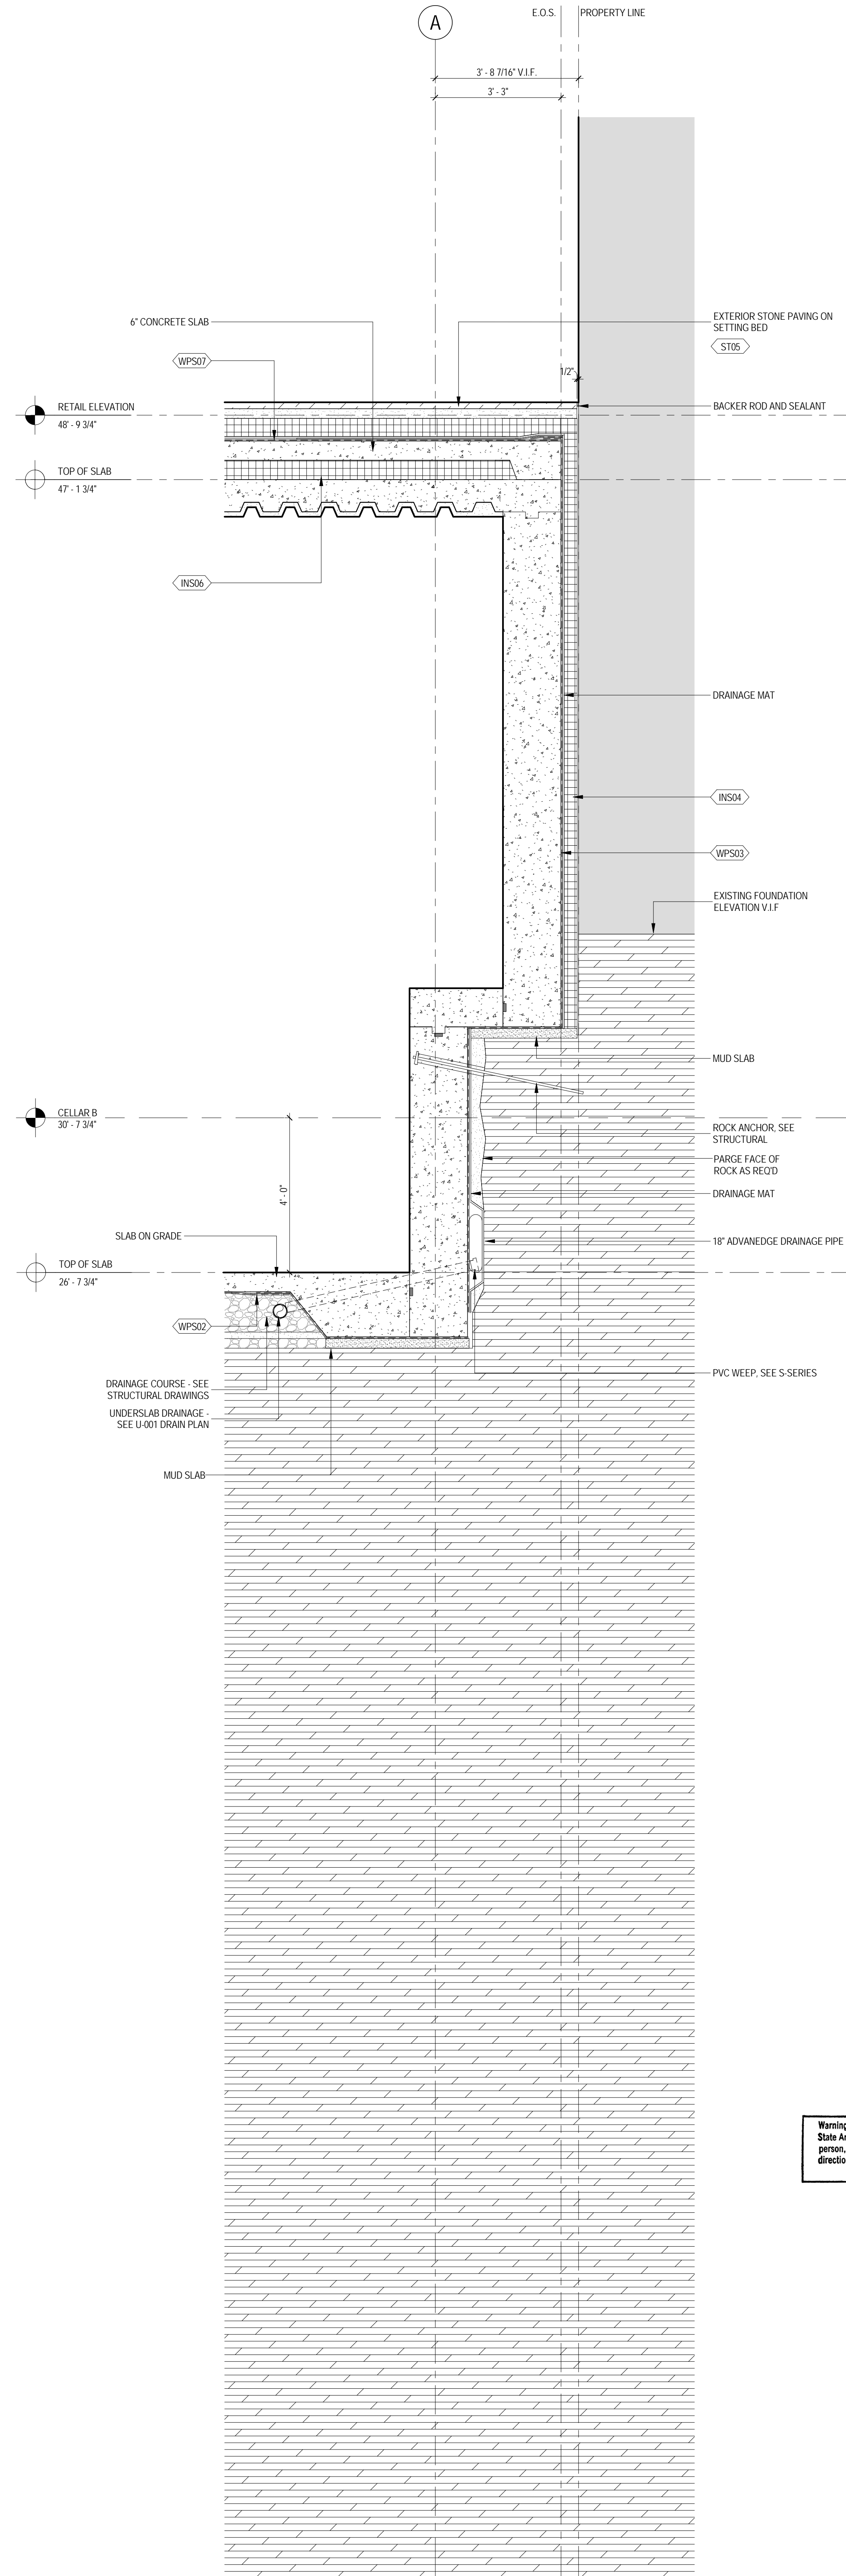
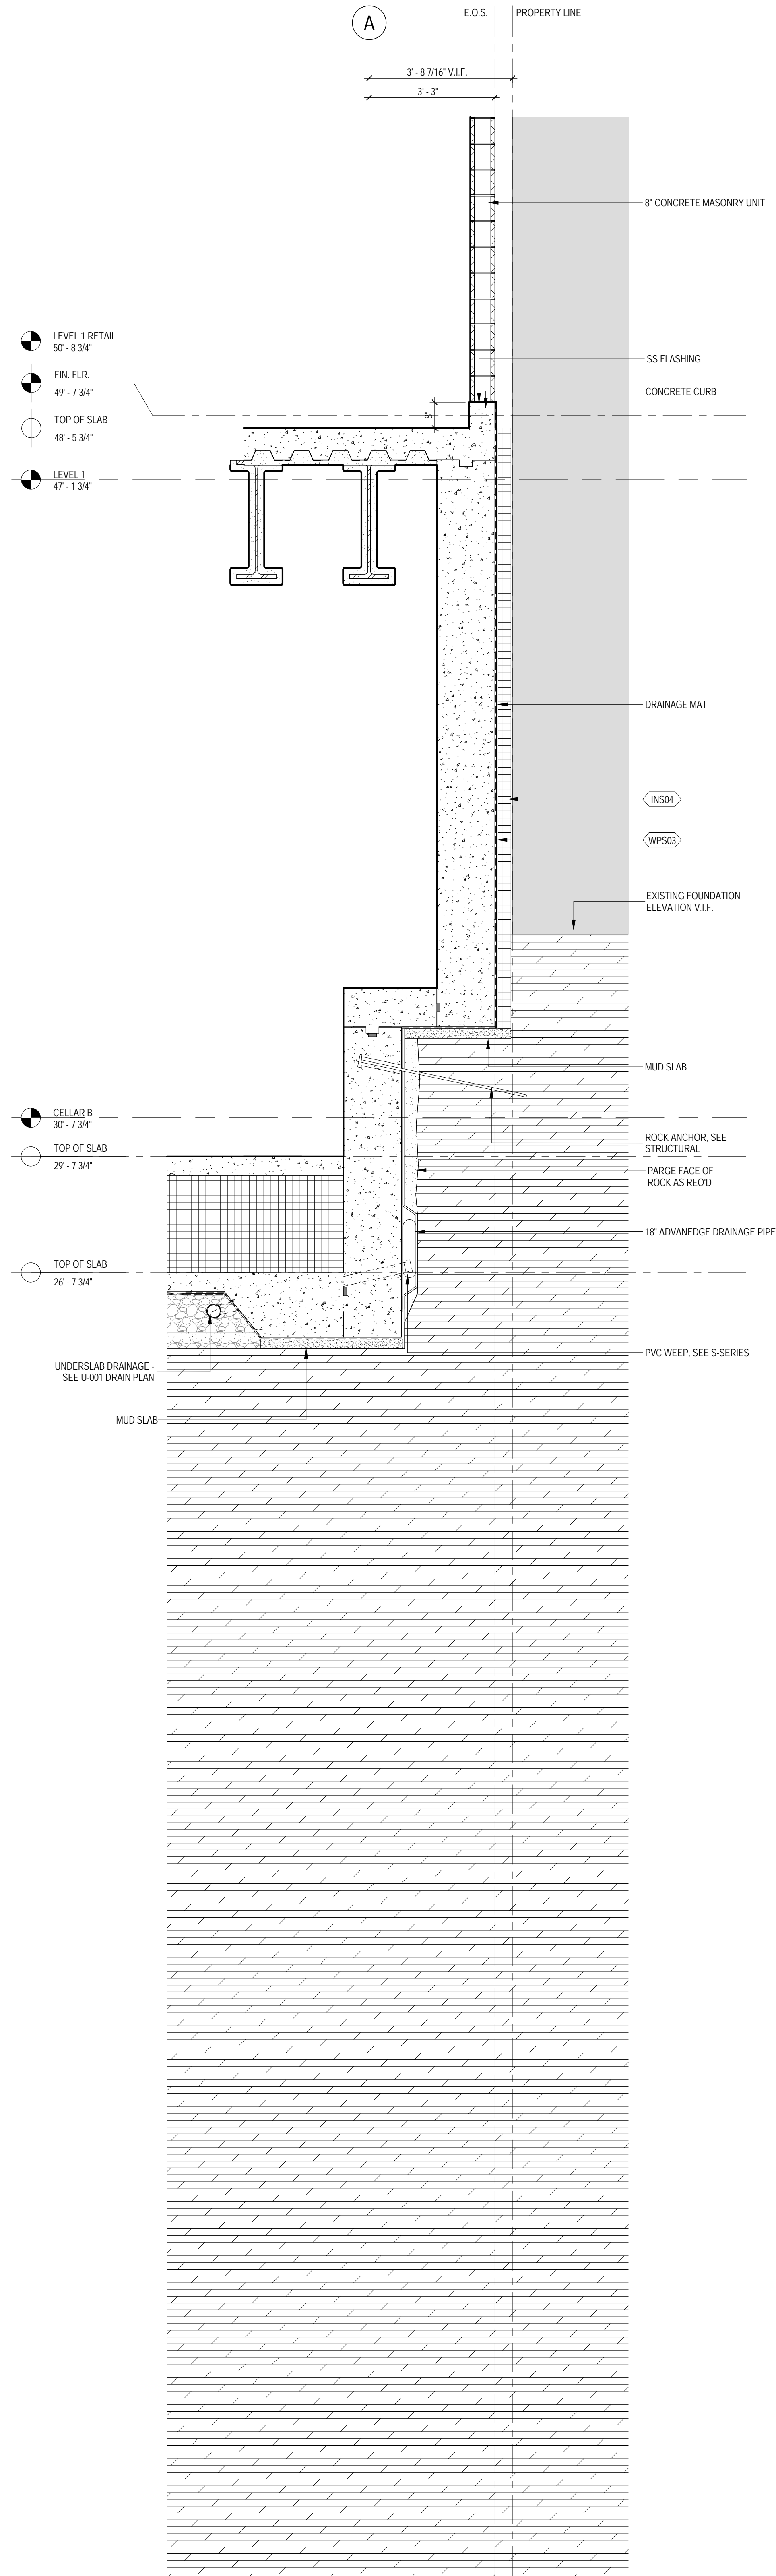
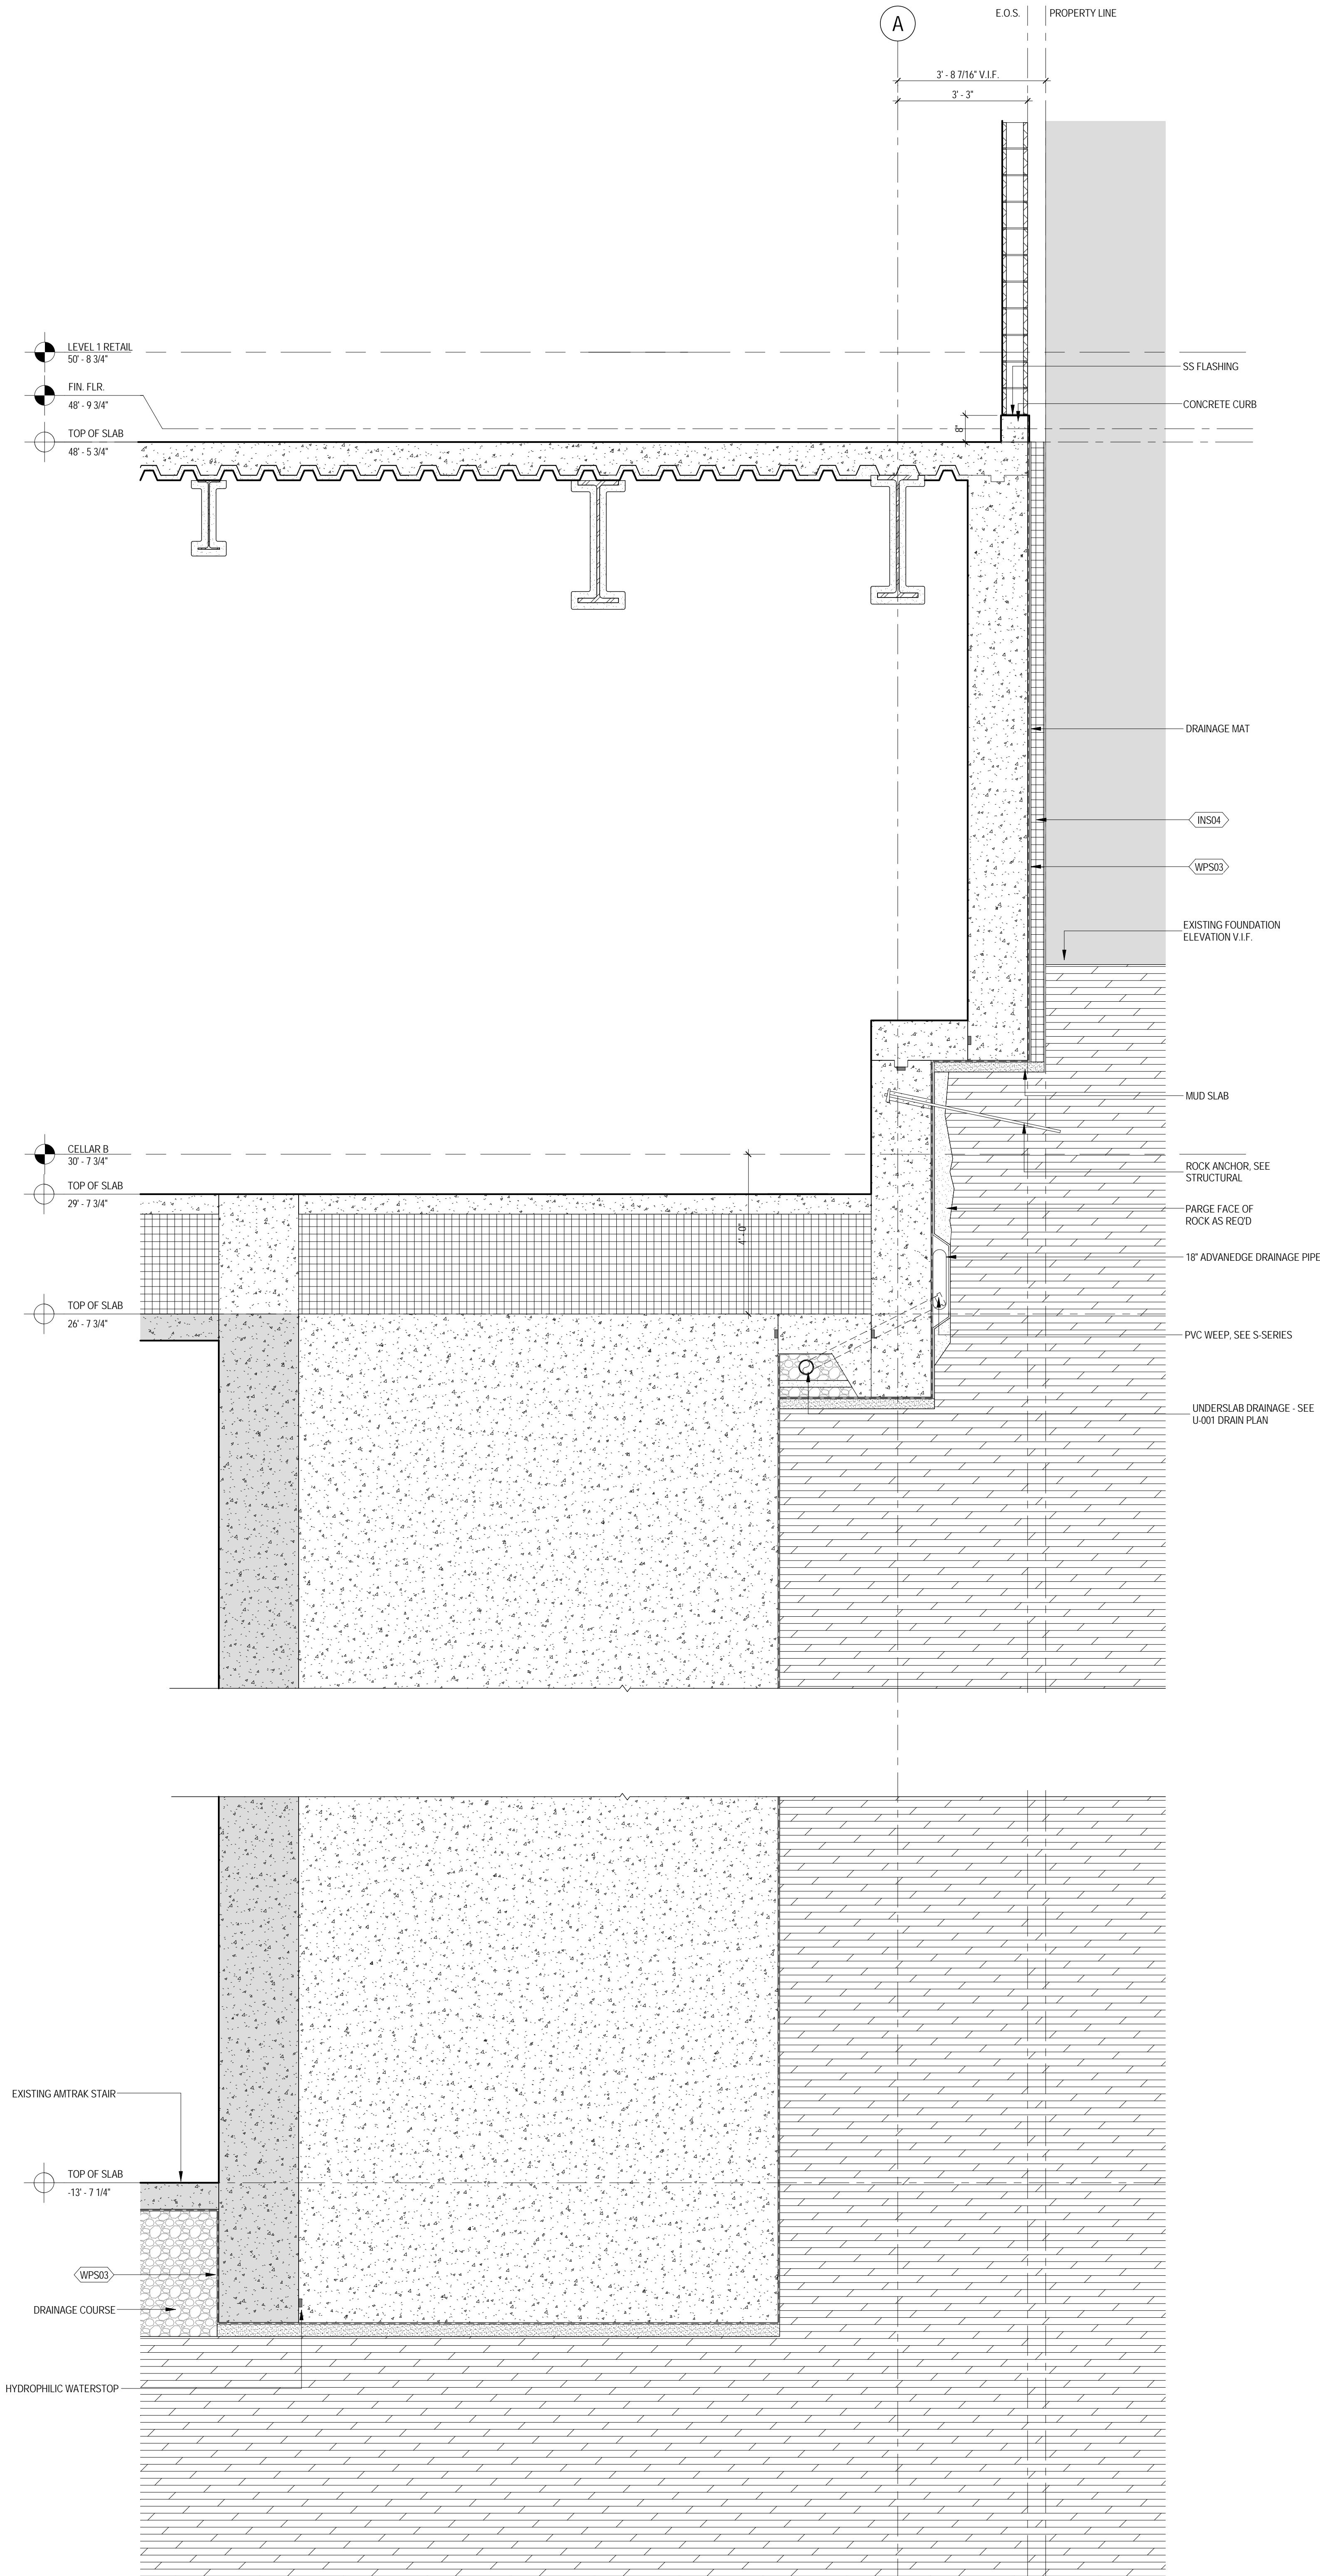
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
2 FOUNDATION SECTION AT LOFT

SCALE: 1/2" = 1'-0"

1 FOUNDATION SECTION AT LOFT

SCALE: 1/2" = 1'-0"





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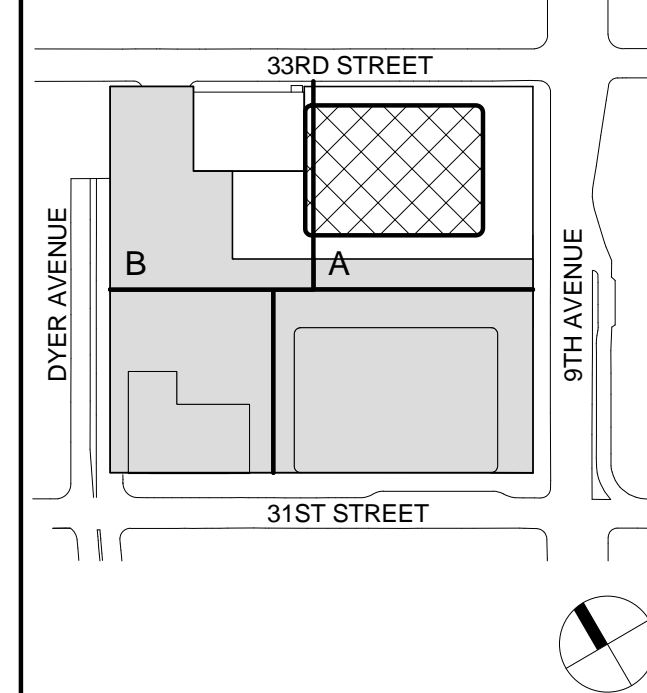
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
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Sheet Name:
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WALL SECTIONS**

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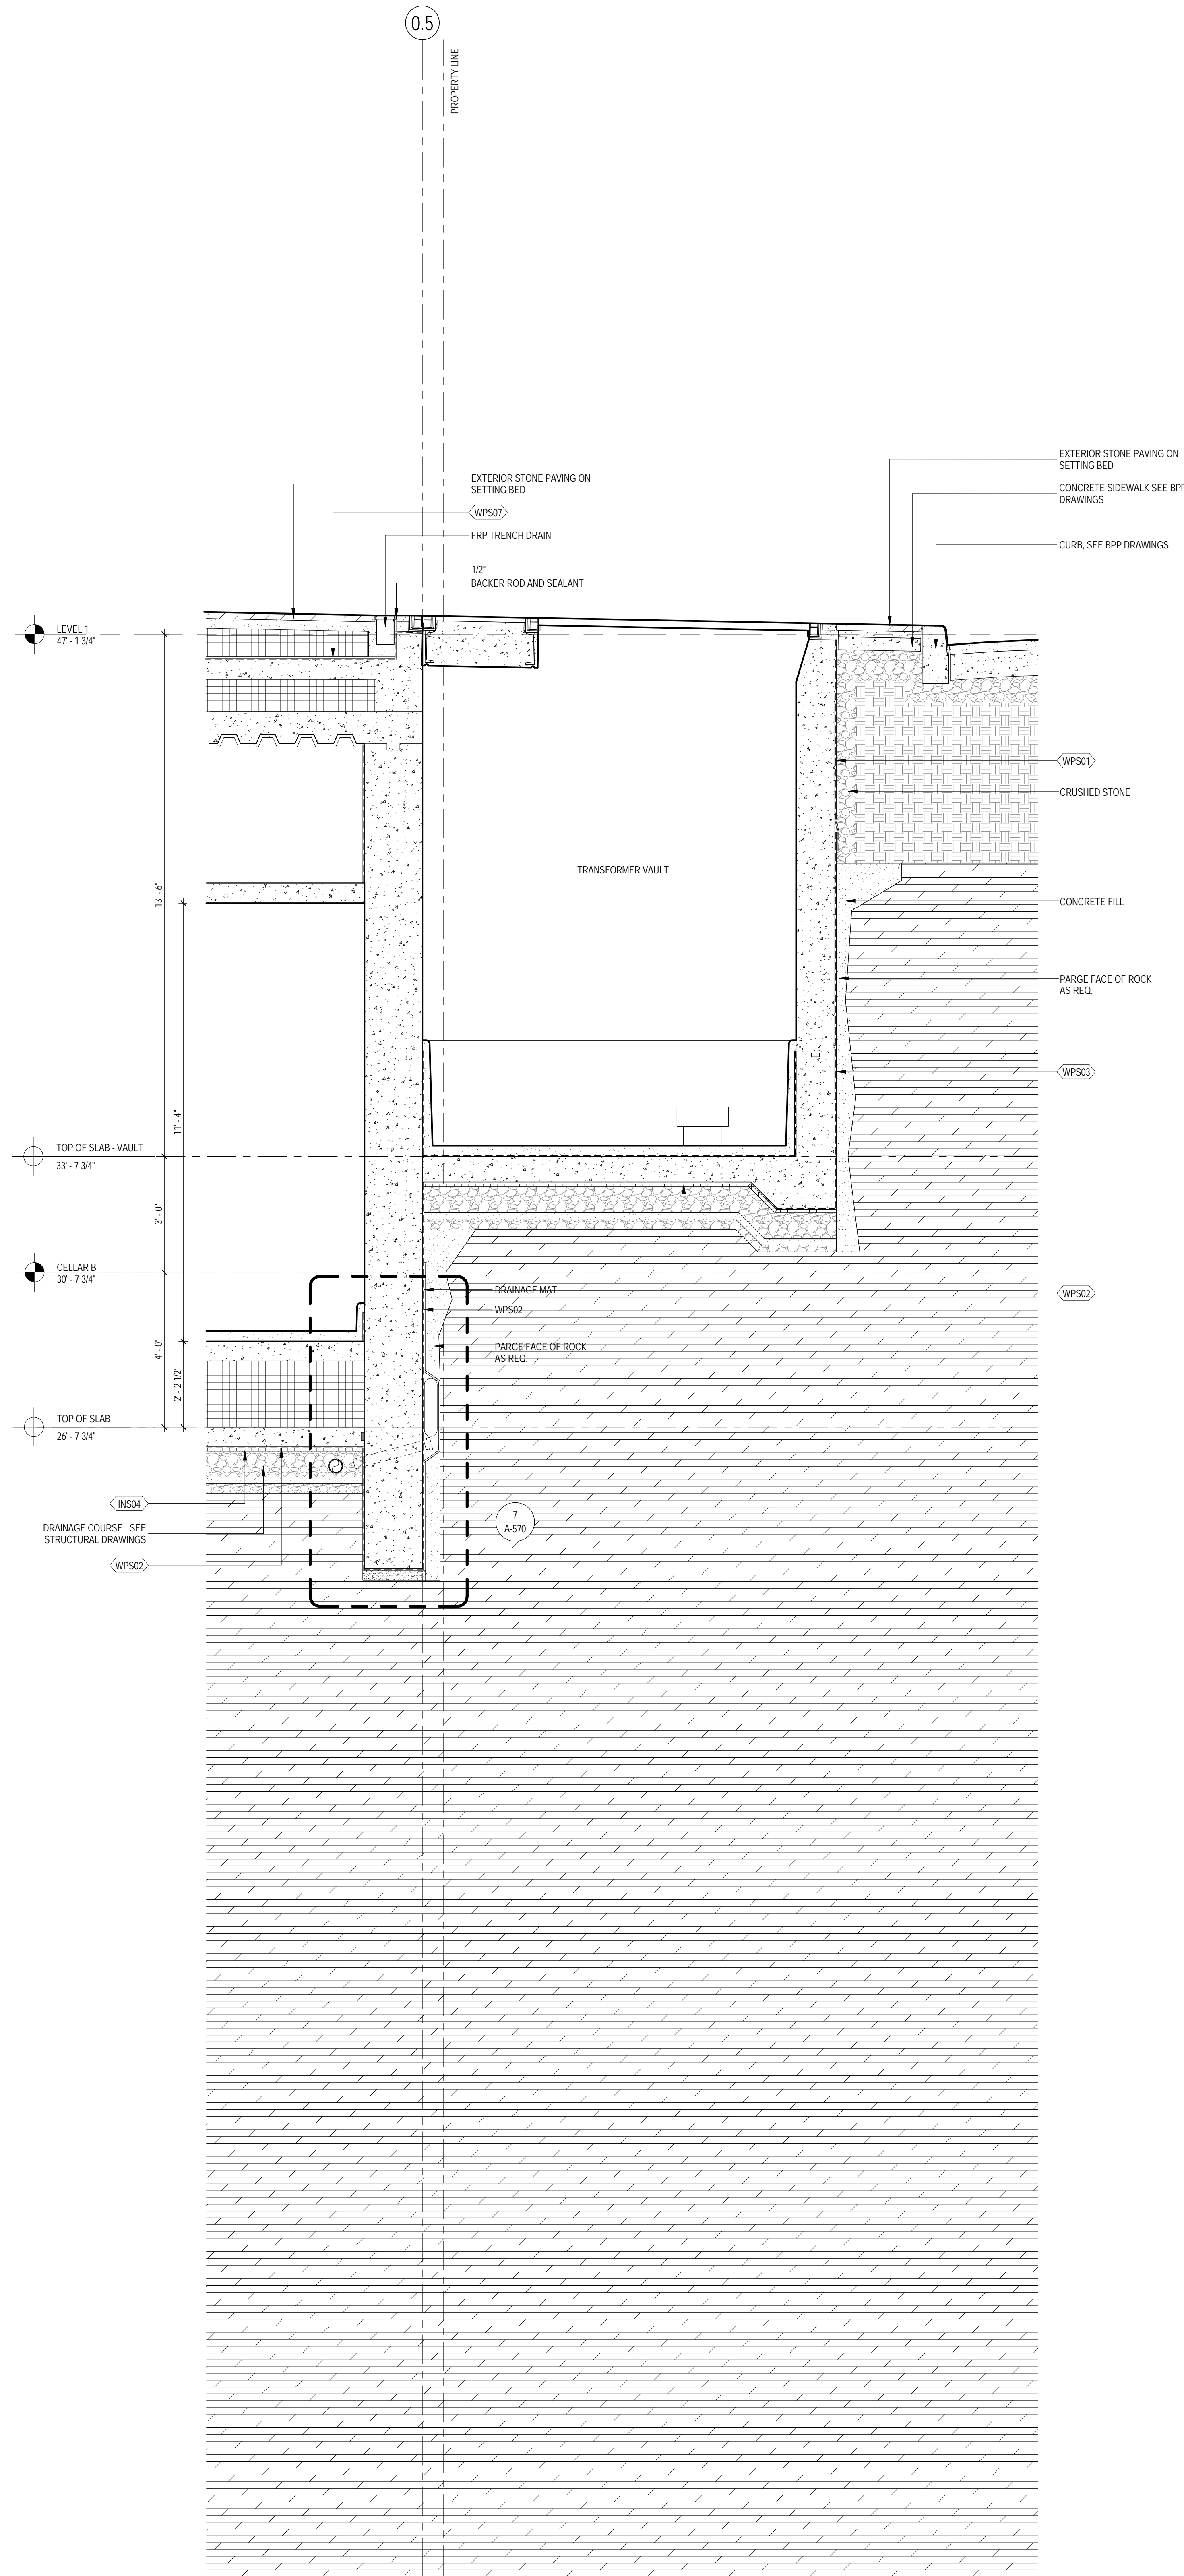
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20 JUN 2014	A-504

Scale:	Page No.:
1/2" = 1'-0"	83 OF 87

File No.:	Page No.:
A-504	83 OF 87


2 FOUNDATION SECTION

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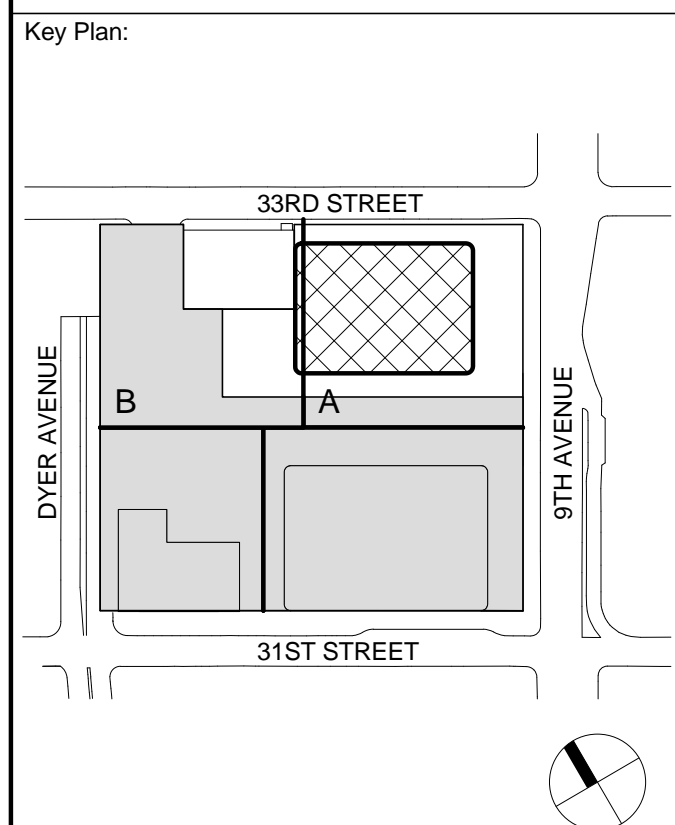


1 FOUNDATION SECTION

SCALE: 1/2" = 1'-0"

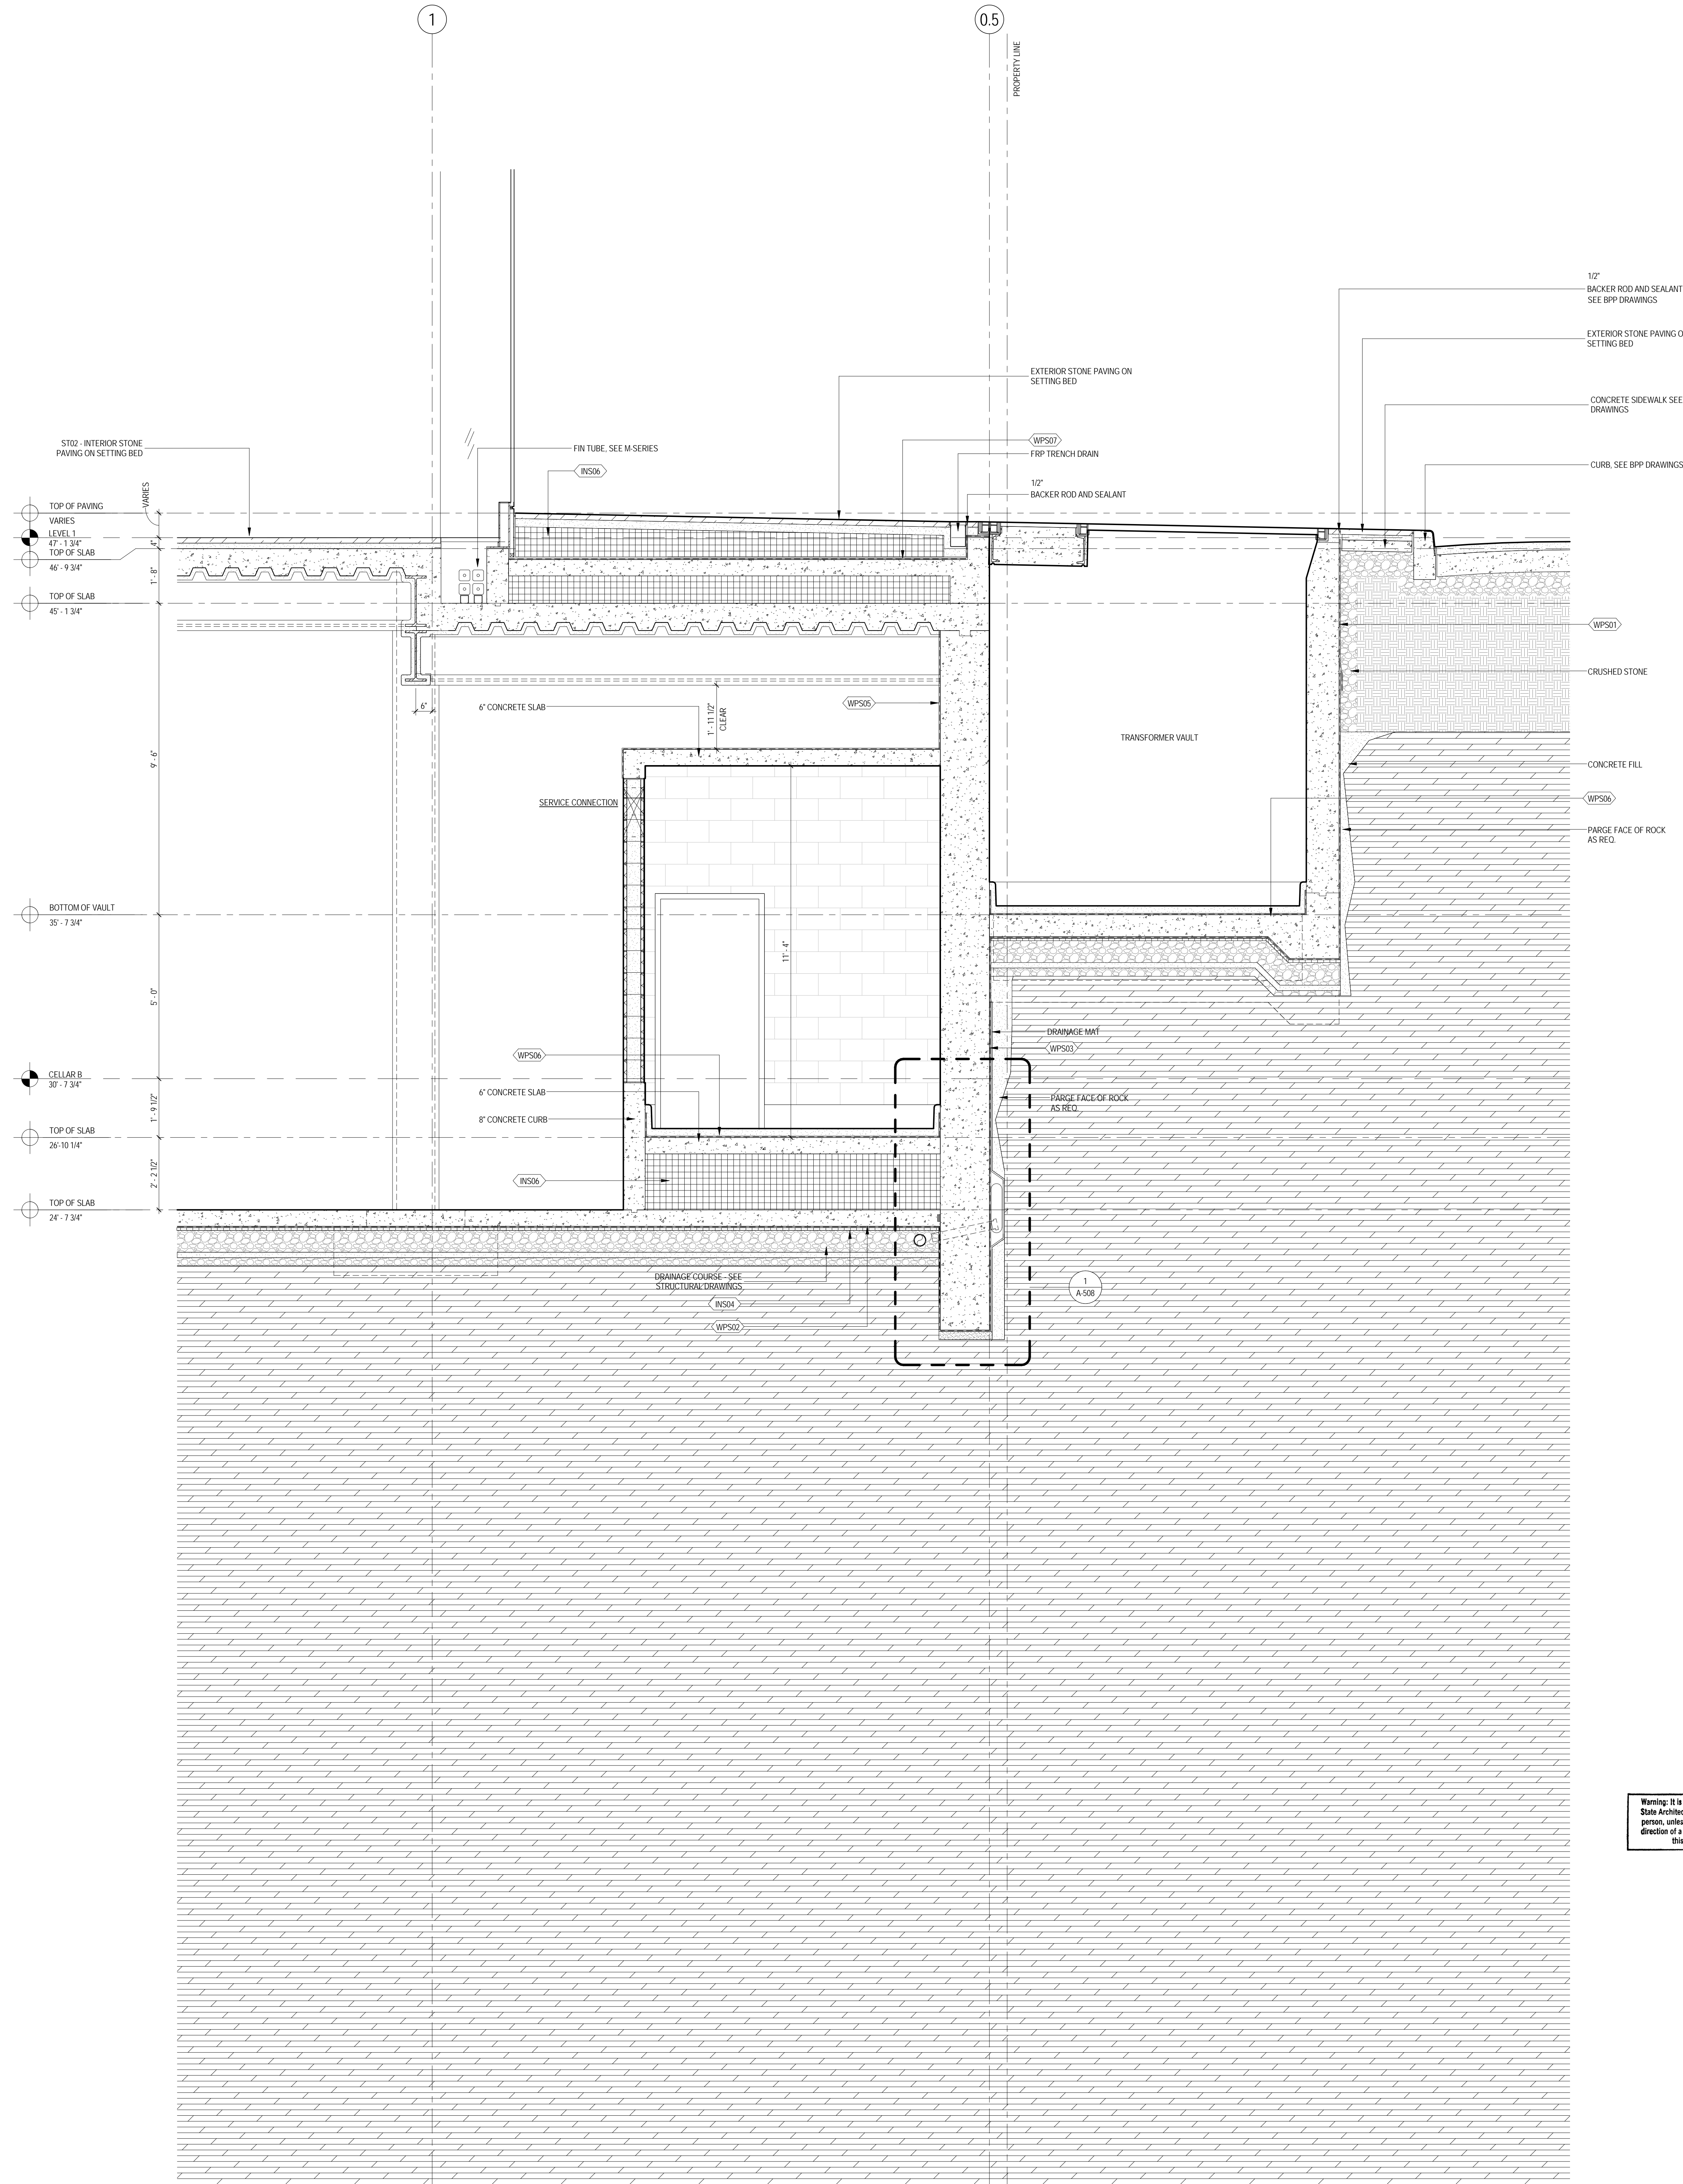

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4	20 JUN 2014	ISSUED FOR FOUNDATION BID
3	20 JUN 2014	ISSUED FOR FOUNDATION PERMIT
2	20 DEC 2013	ISSUED FOR FOUNDATION PERMIT
1	19 NOV 2013	ISSUED FOR BID PROGRESS PRICING

No. Date Description

Sheet Name:


FOUNDATION
WALL SECTIONS

Project No.: 207150	B-SCAN Sheet No.: A-505.00
Date: 20 JUN 2014	Sheet No.: A-505
Scale: 1/2" = 1'-0"	Page No.: 84 OF 87
File No.: A-505	

6/9/2014 11:26:27 AM

1 FOUNDATION SECTION AT CORE

SCALE: 1/2" = 1'-0"

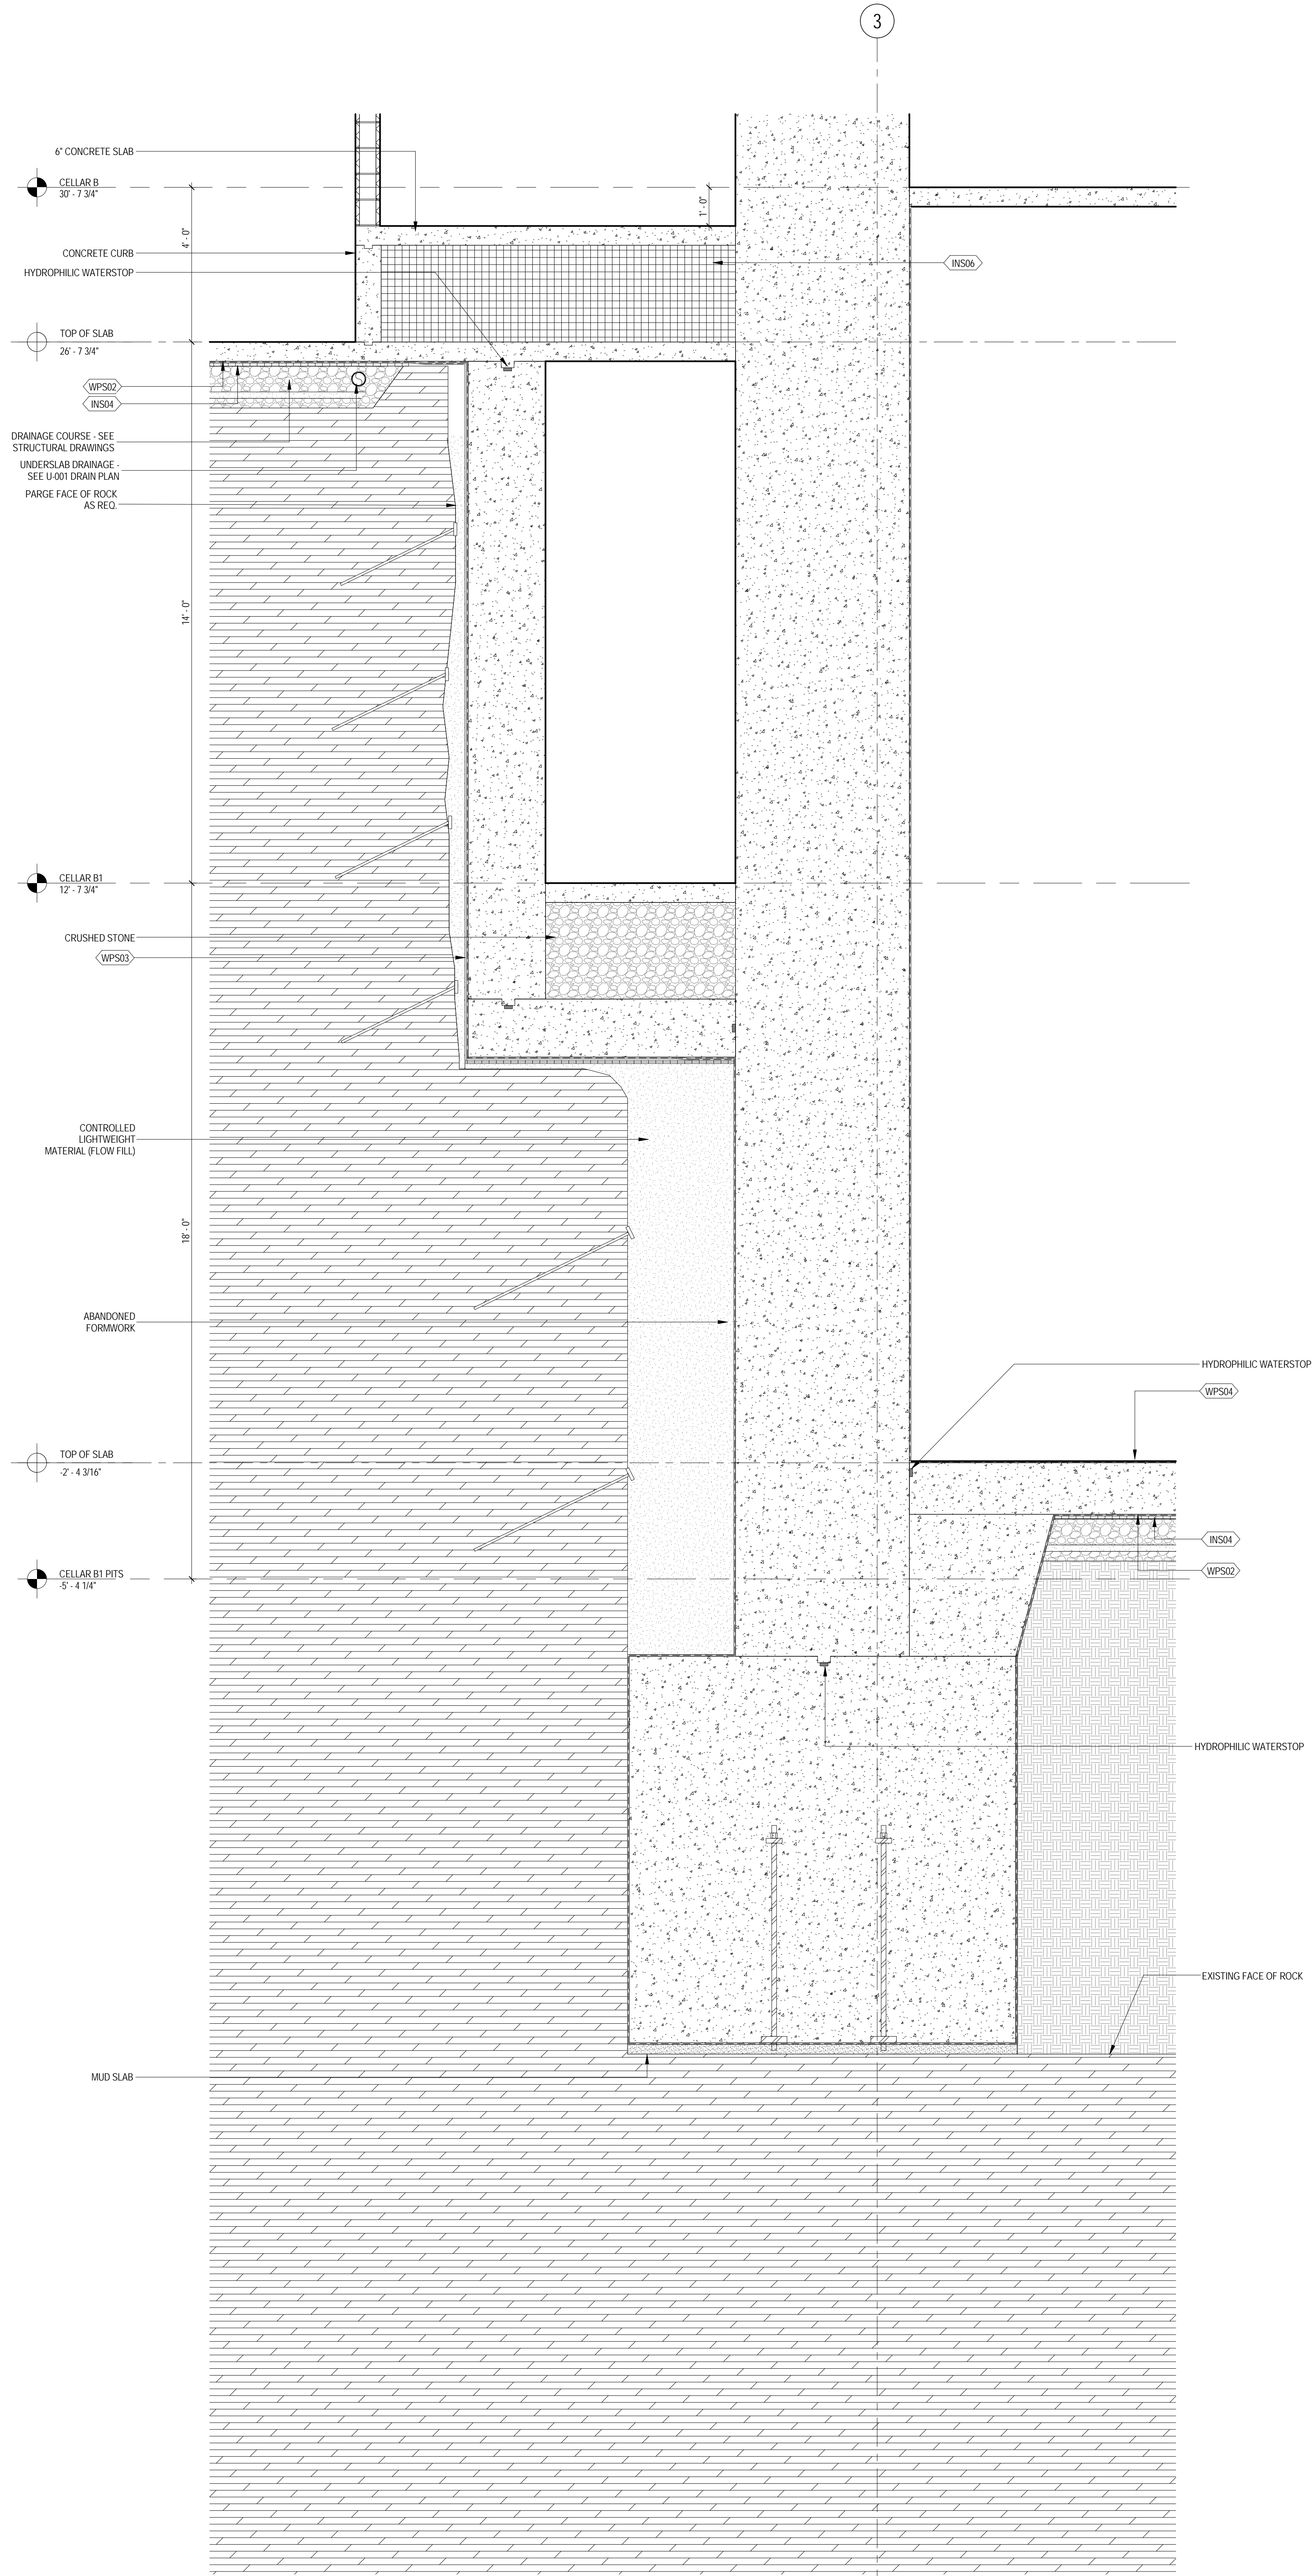

MANHATTAN WEST:
NORTH TOWER
375 Ninth Avenue, New York, NY 10001
Client

Brookfield
250 Vesey Street, 15th Floor, New York, NY 10021

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Philip Habb & Associates
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Jaros Baum & Bolles
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Ducibella, Vantor & Santoro
250 State Street #F1, North Haven, CT 06473

Blast Consultant
Weidinger Associates, Inc.
40 Wall Street, New York, NY 10005

Acoustical Consultant
Cerami & Associates
404 Fifth Avenue #8, New York, NY 10016


Vibration Consultant
Wilson, Uhrig & Associates, Inc.
65 Broadway, Suite 401, New York, NY 10006

Code Consultant
Code Consultants Professional Engineers PC
215 West 40th Street, 15th Floor, New York, NY 10018

Facade Maintenance Consultant
Entek Engineering LLC
166 Ames Street, Hackensack, NJ 07601

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Rowan Williams Davies & Irwin Inc.
650 Woodlawn Road West, Guelph Ontario, Canada N1K 1B8

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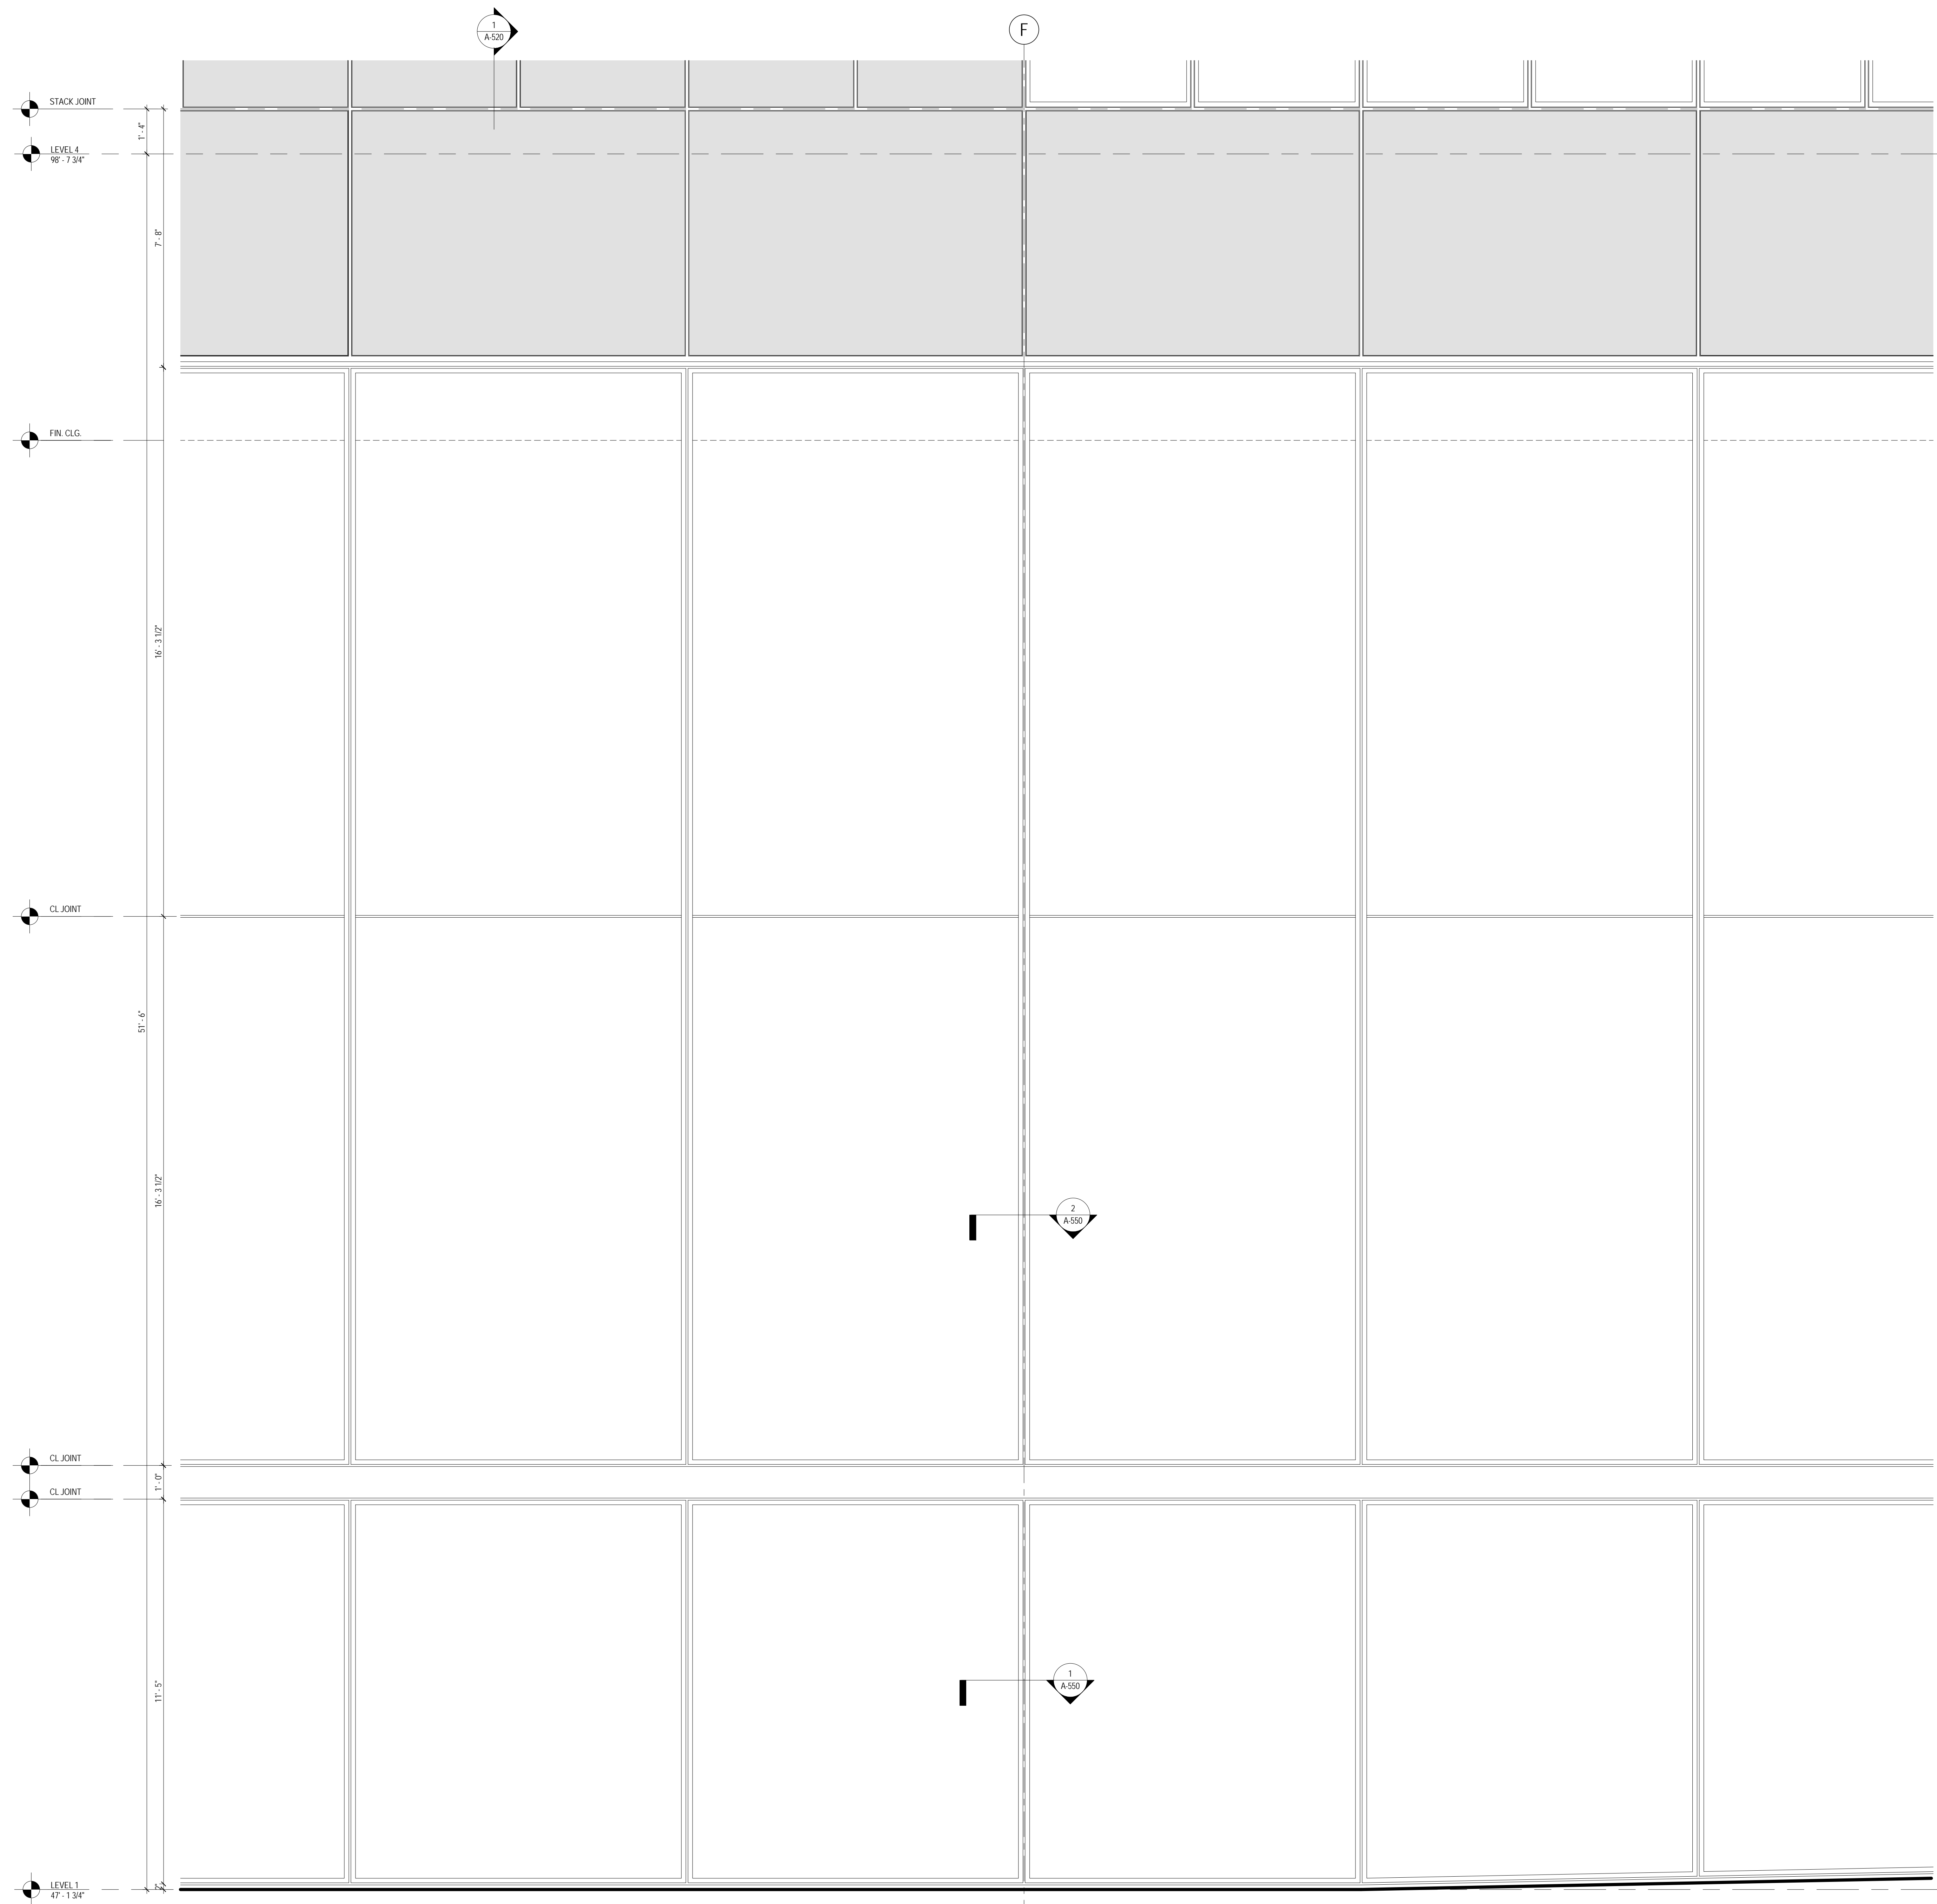
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1	20 JUN 2014	ISSUED FOR FOUNDATION PERMIT
No.	Date	Description
Sheet Name:		

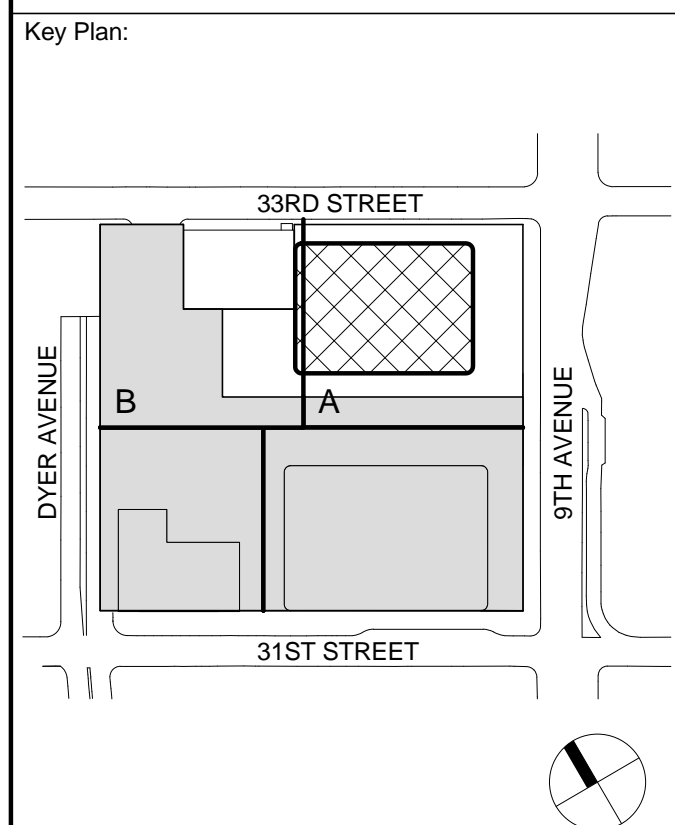
FOUNDATION
WALL SECTIONS

Project No.: 207150	B-SCAN Sheet No.: A-507.00
Date: 20 JUN 2014	Sheet No.: A-507
Scale: 1/2" = 1'-0"	Page No.: 86 OF 87
File No.: A-507	


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
3 ENLARGED ELEVATION AT STOREFRONT (SF01)
SCALE: 1/2" = 1'-0"



2 ENLARGED PLAN AT STOREFRONT (SF01)
SCALE: 1/2" = 1'-0"

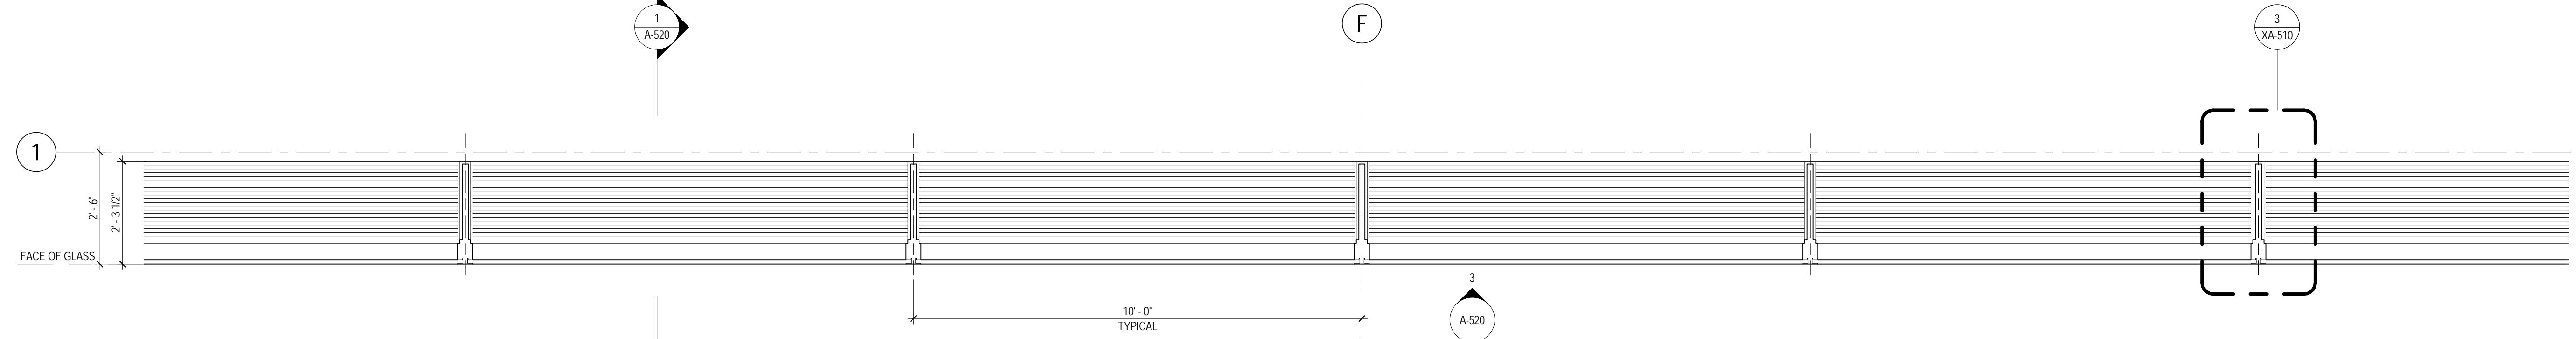

1 ENLARGED SECTION AT STOREFRONT (SF01)
SCALE: 1/2" = 1'-0"

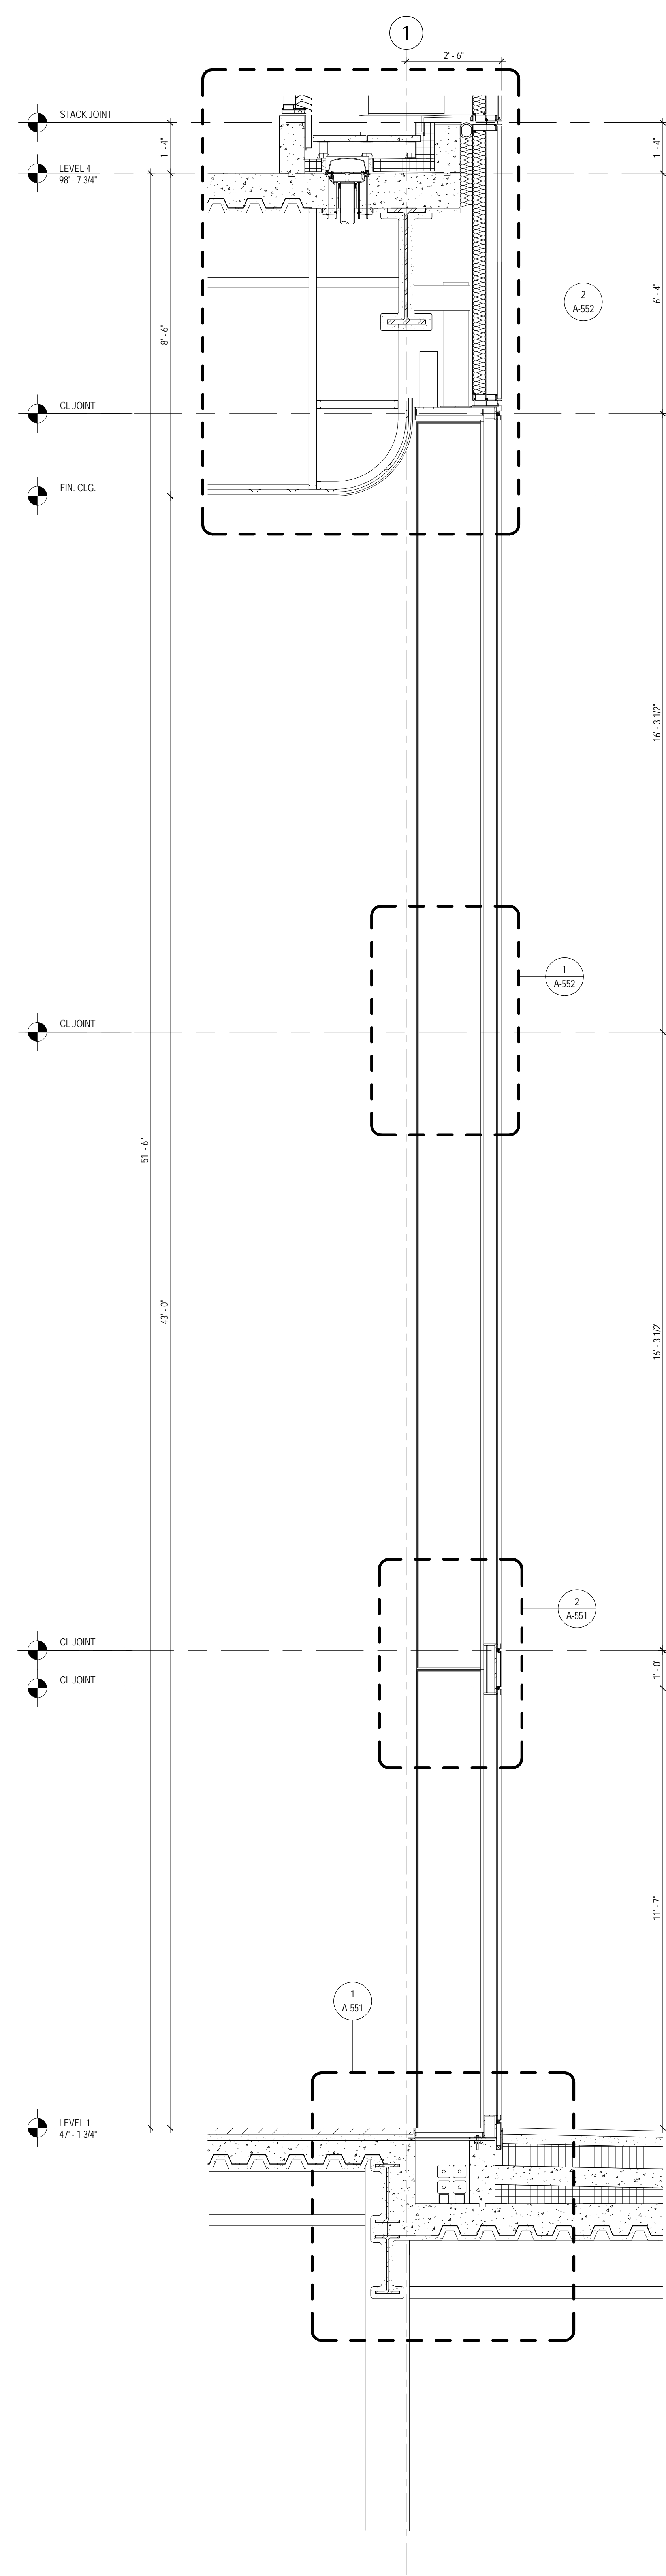

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Philip Habib & Associates
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Cerami & Associates
404 Fifth Avenue #8, New York, NY 10016

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Wilson, Uhrig & Associates, Inc.
65 Broadway, Suite 401, New York, NY 10006


Code Consultant
Code Consultants Professional Engineers PC
215 West 40th Street, 15th Floor, New York, NY 10018

Facade Maintenance Consultant
Entek Engineering LLC
166 Ames Street, Hackensack, NJ 07601


Wind Tunnel Consultant
Rowan Williams Davies & Irwin Inc.
650 Woodlawn Road West, Guelph, Ontario, Canada N1K 1B8

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Key Plan:

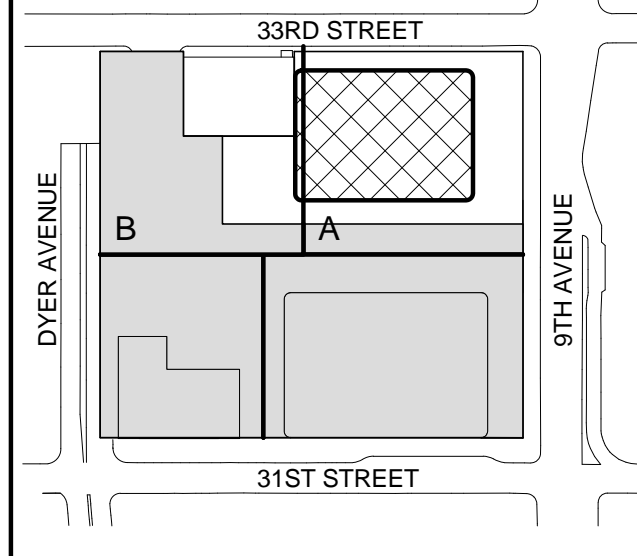


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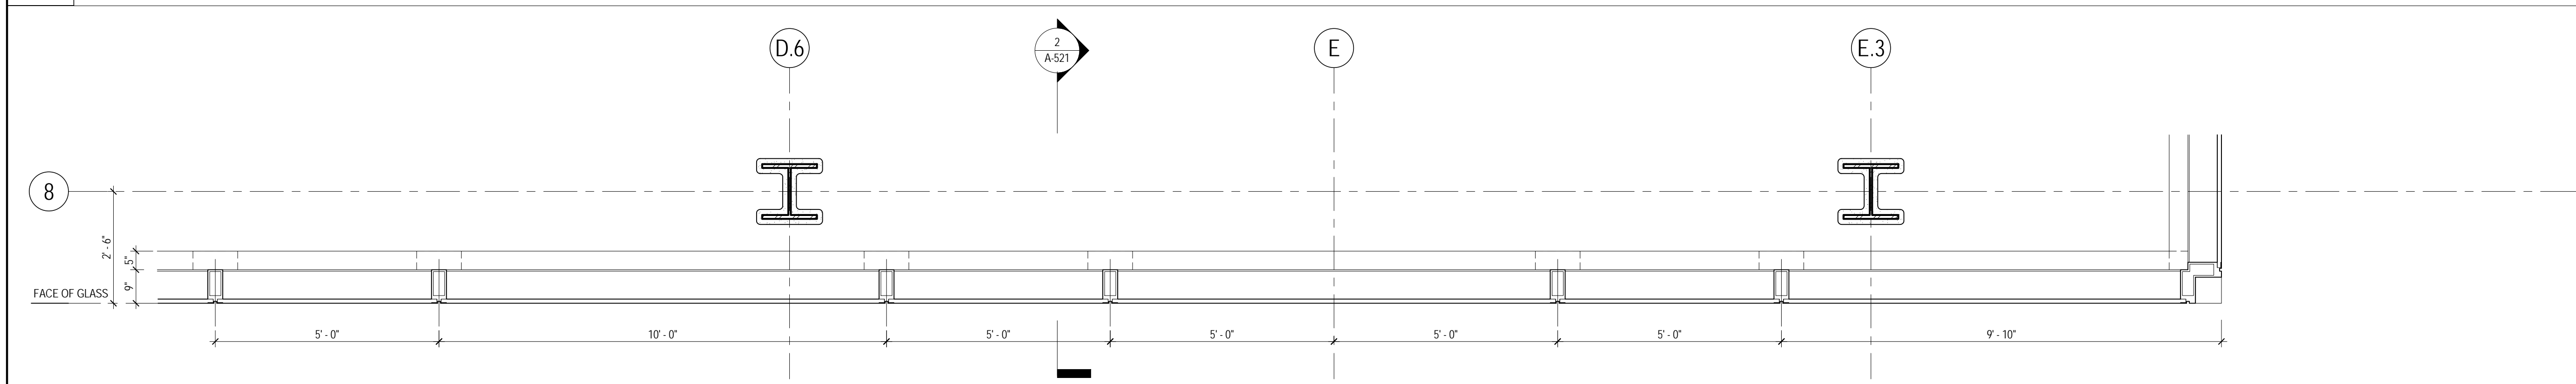


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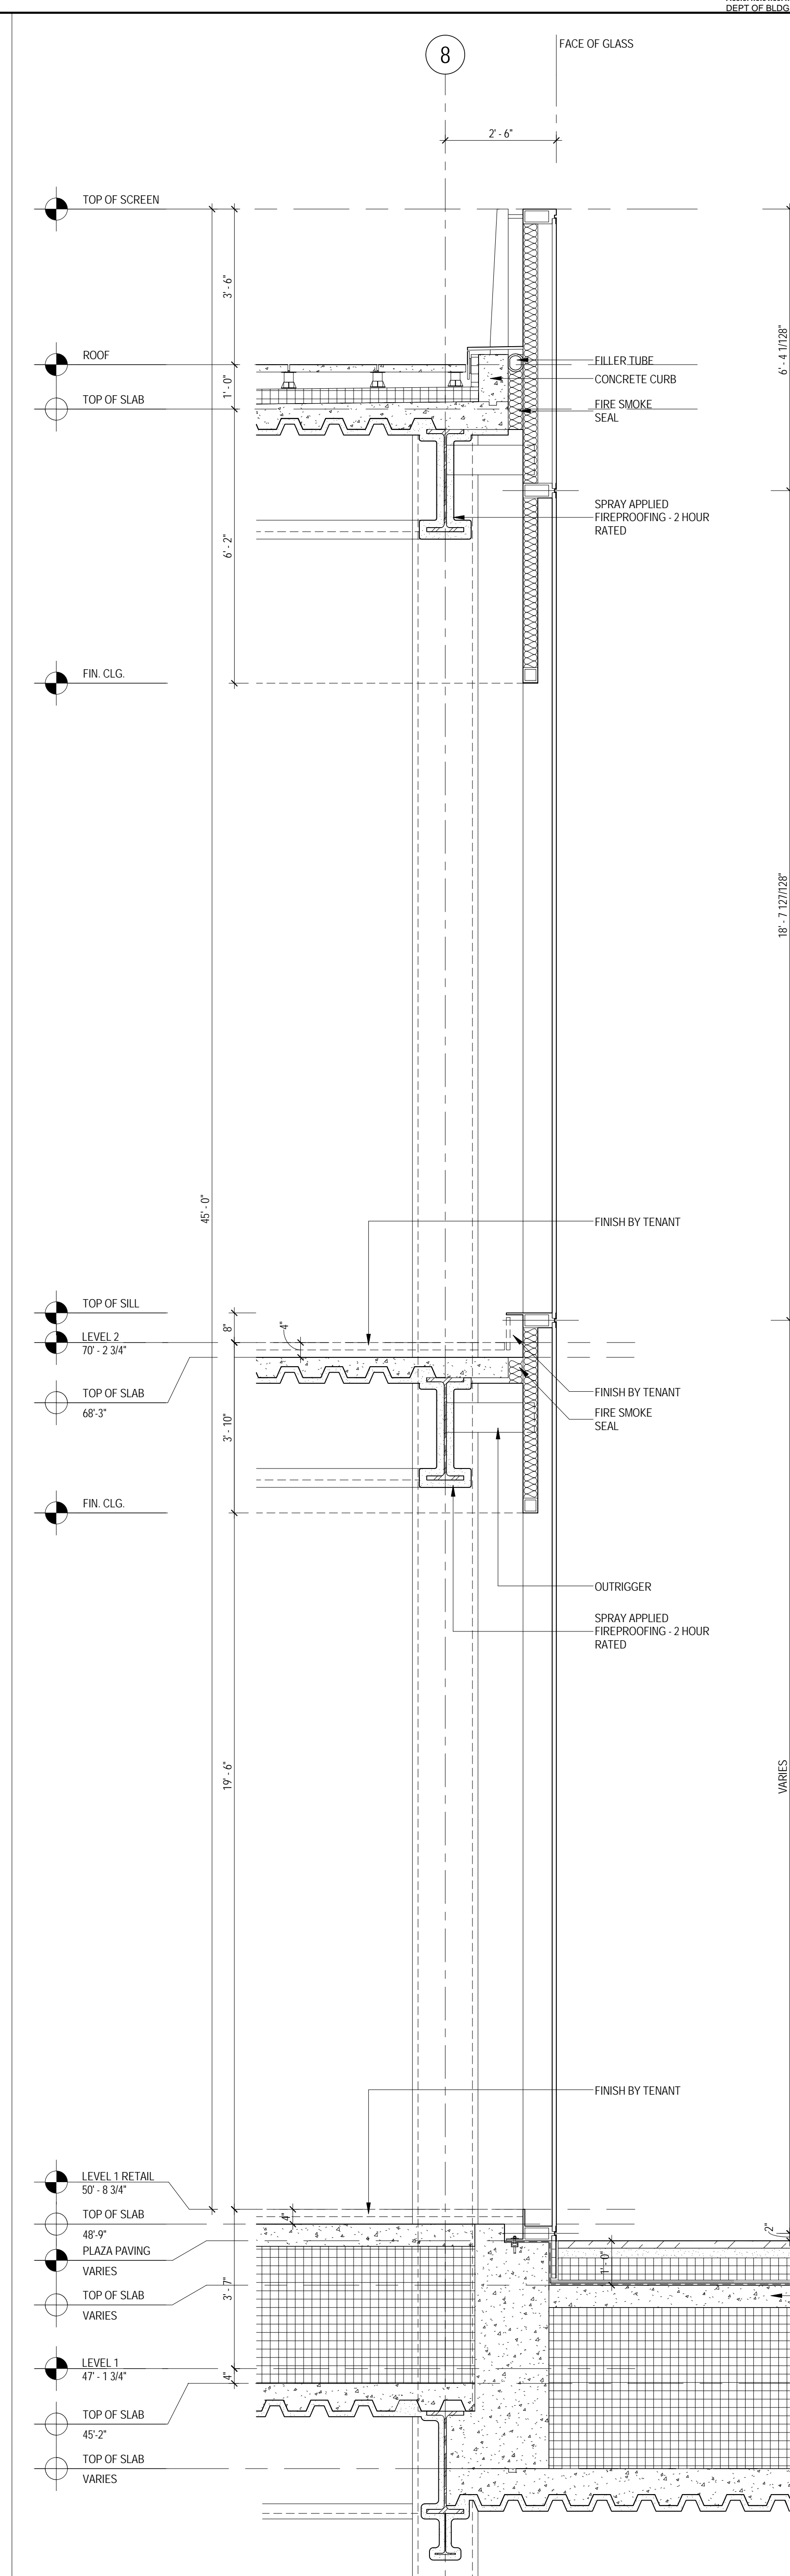
Project No.: 207150	B-SCAN Sheet No.: A-520.00
Date: 12 SEPT 2014	Sheet No.: A-520
Scale: 1/2" = 1'-0"	Page No.: 30
File No.: A-520	



4 ENLARGED ELEVATION AT STOREFRONT (SF02)
SCALE: 1/2" = 1'-0"

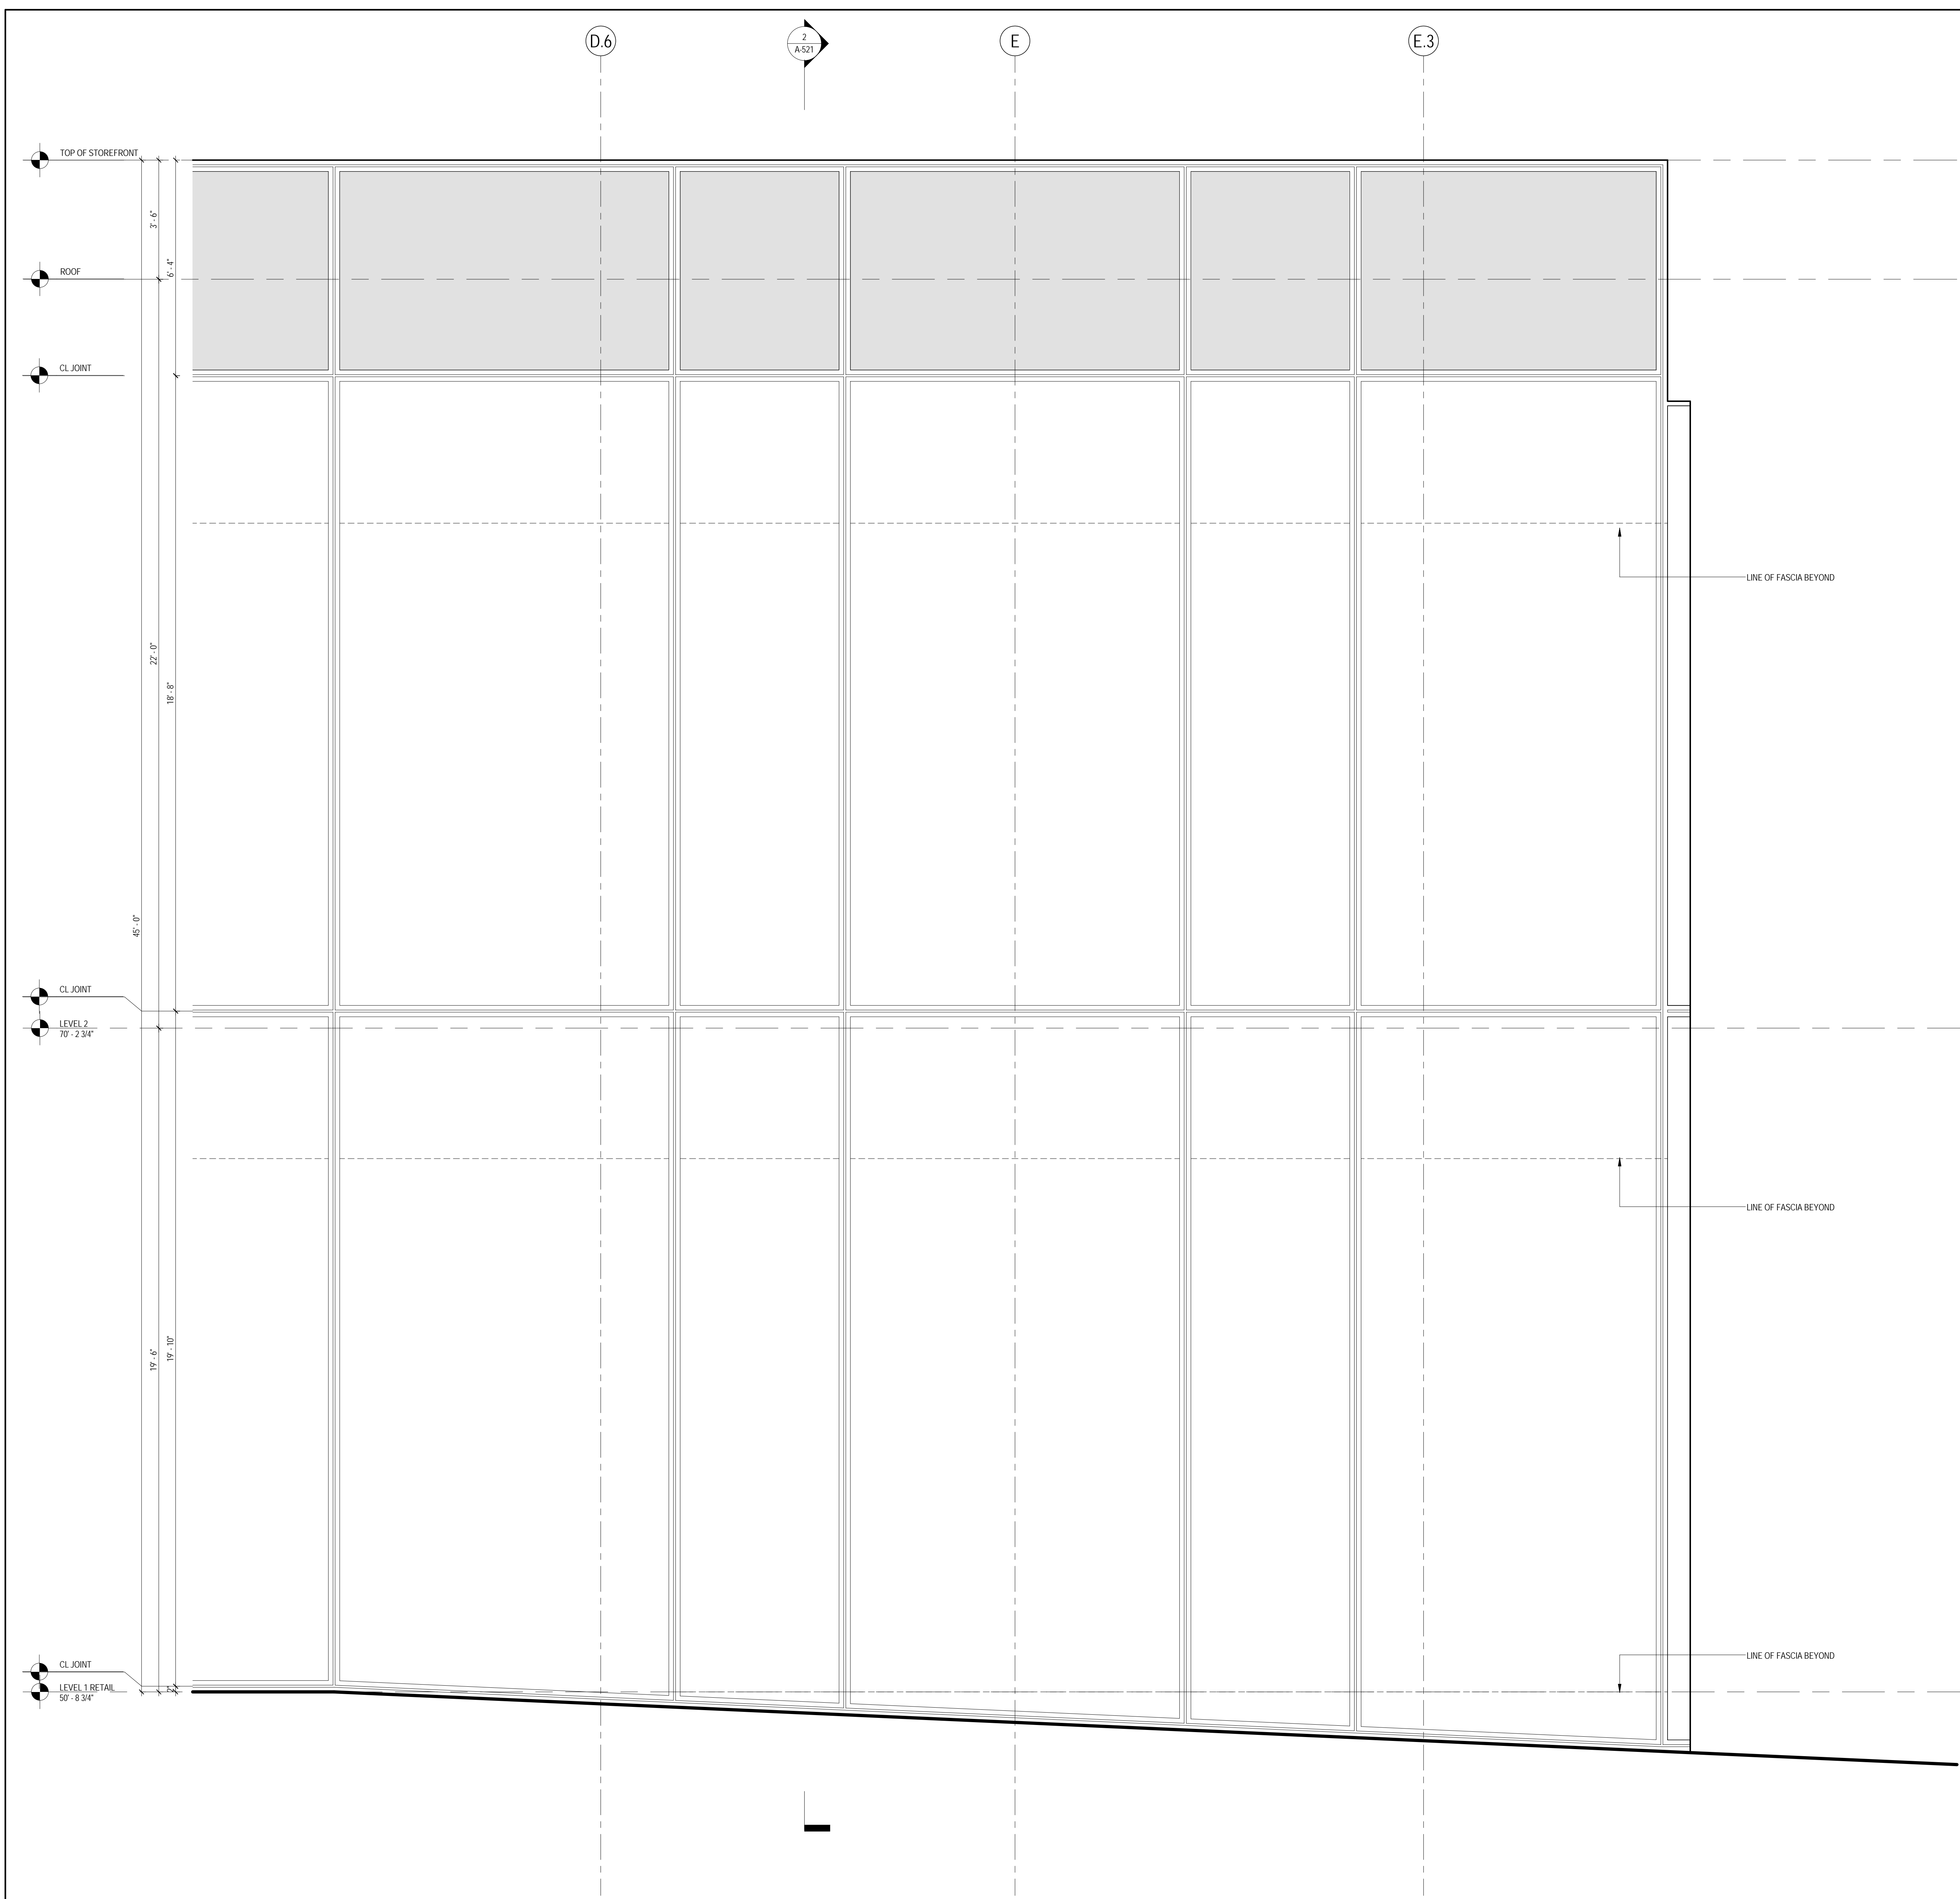

3 ENLARGED PLAN AT STOREFRONT (SF02)
SCALE: 1/2" = 1'-0"



2 ENLARGED SECTION AT STOREFRONT (SF02)
SCALE: 1/2" = 1'-0"

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Jaros Baum & Bolles
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102 East Blithedale Ave, Suite 1, Mill Valley, California 94041

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Mueser Rutledge Consulting Engineers
14 Penn Plaza, 225 W. 34th Street, New York, NY 10122

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Cerami & Associates
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Rowan Williams Davies & Irwin Inc.
650 Woodlawn Road West, Guelph, Ontario, Canada N1K 1B8

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Key Plan:




Seal & Signature:

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No.	Date	Description
2	12 SEPT 2014	ISSUED FOR FOUNDATION PERMIT
1	18 NOV 2013	ISSUED FOR 30 PROGRESS PRICING

Sheet Name:
TYPICAL STOREFRONT

Project No.:	B-SCAN Sheet No.:
207120	A-521.00
Date:	Sheet No.:
12 SEPT 2014	A-521
Scale:	Page No.:
1/2" = 1'-0"	30
File No.:	
A-521	

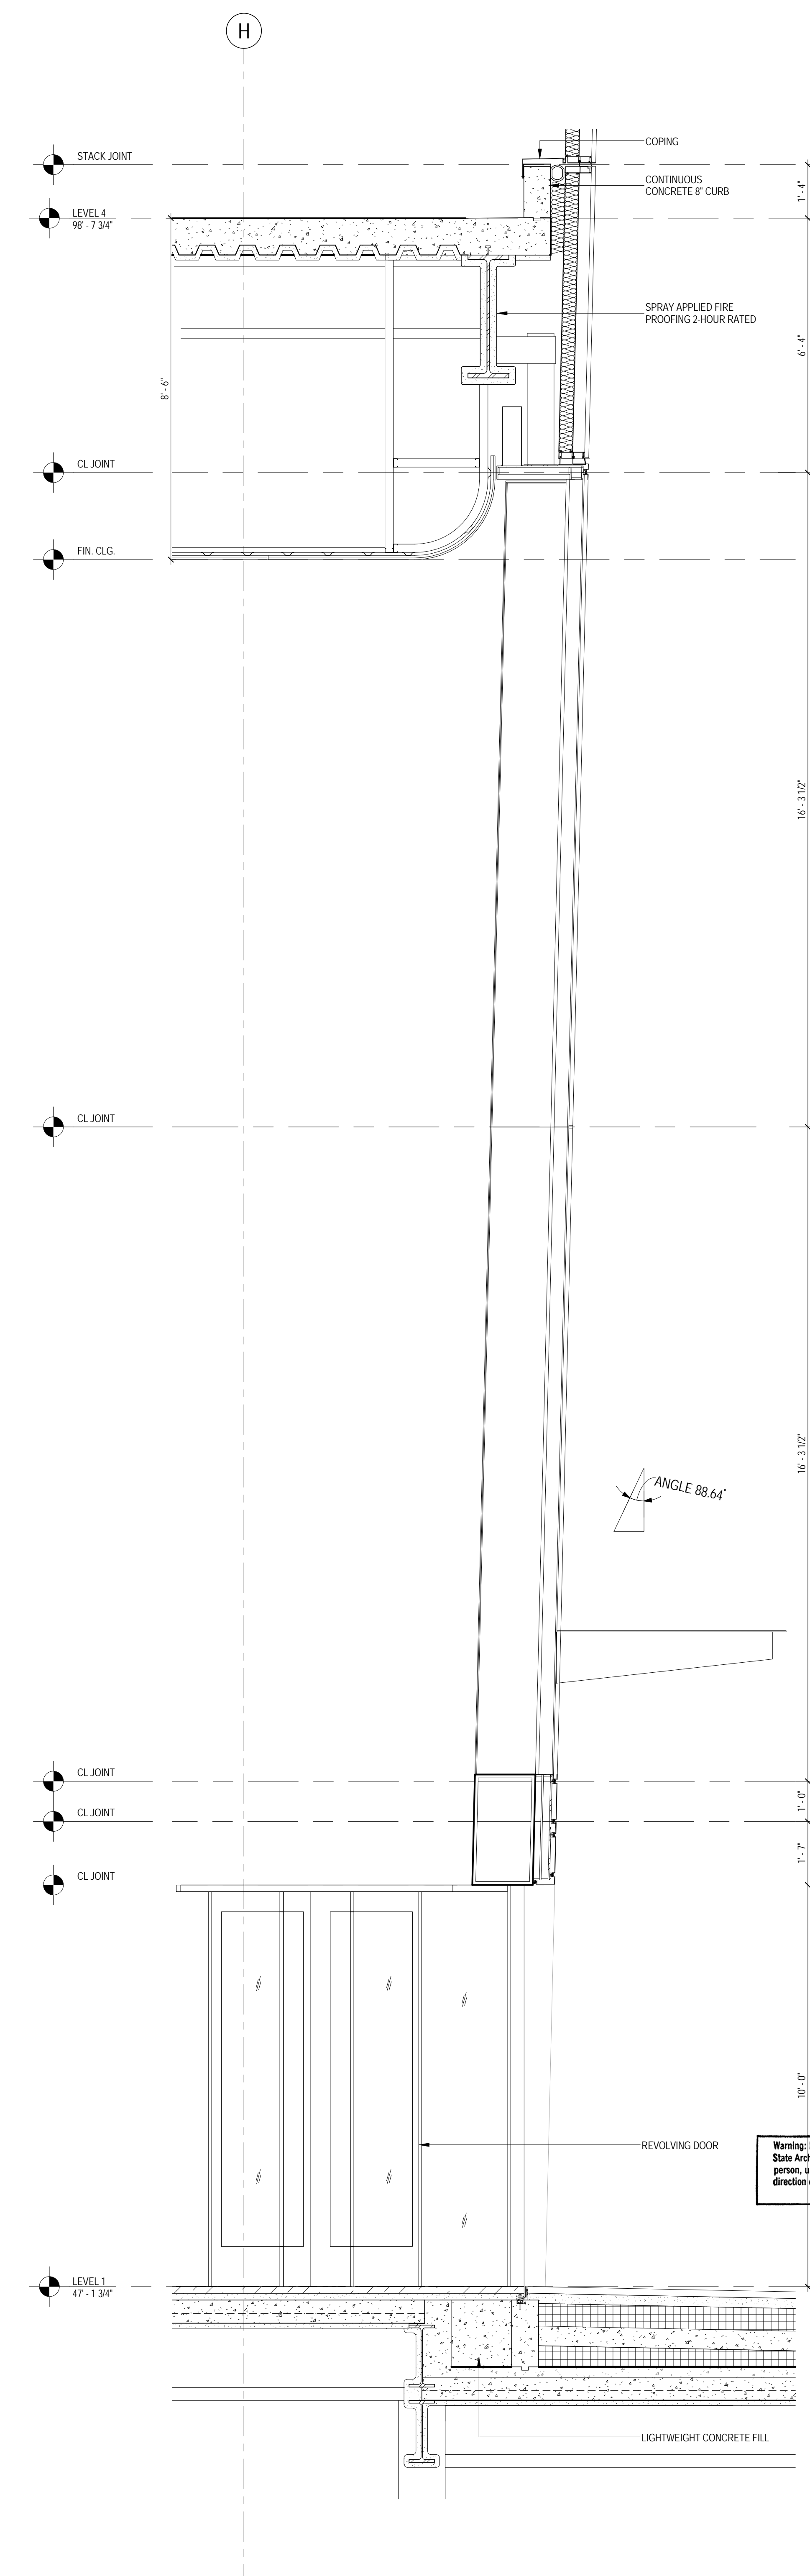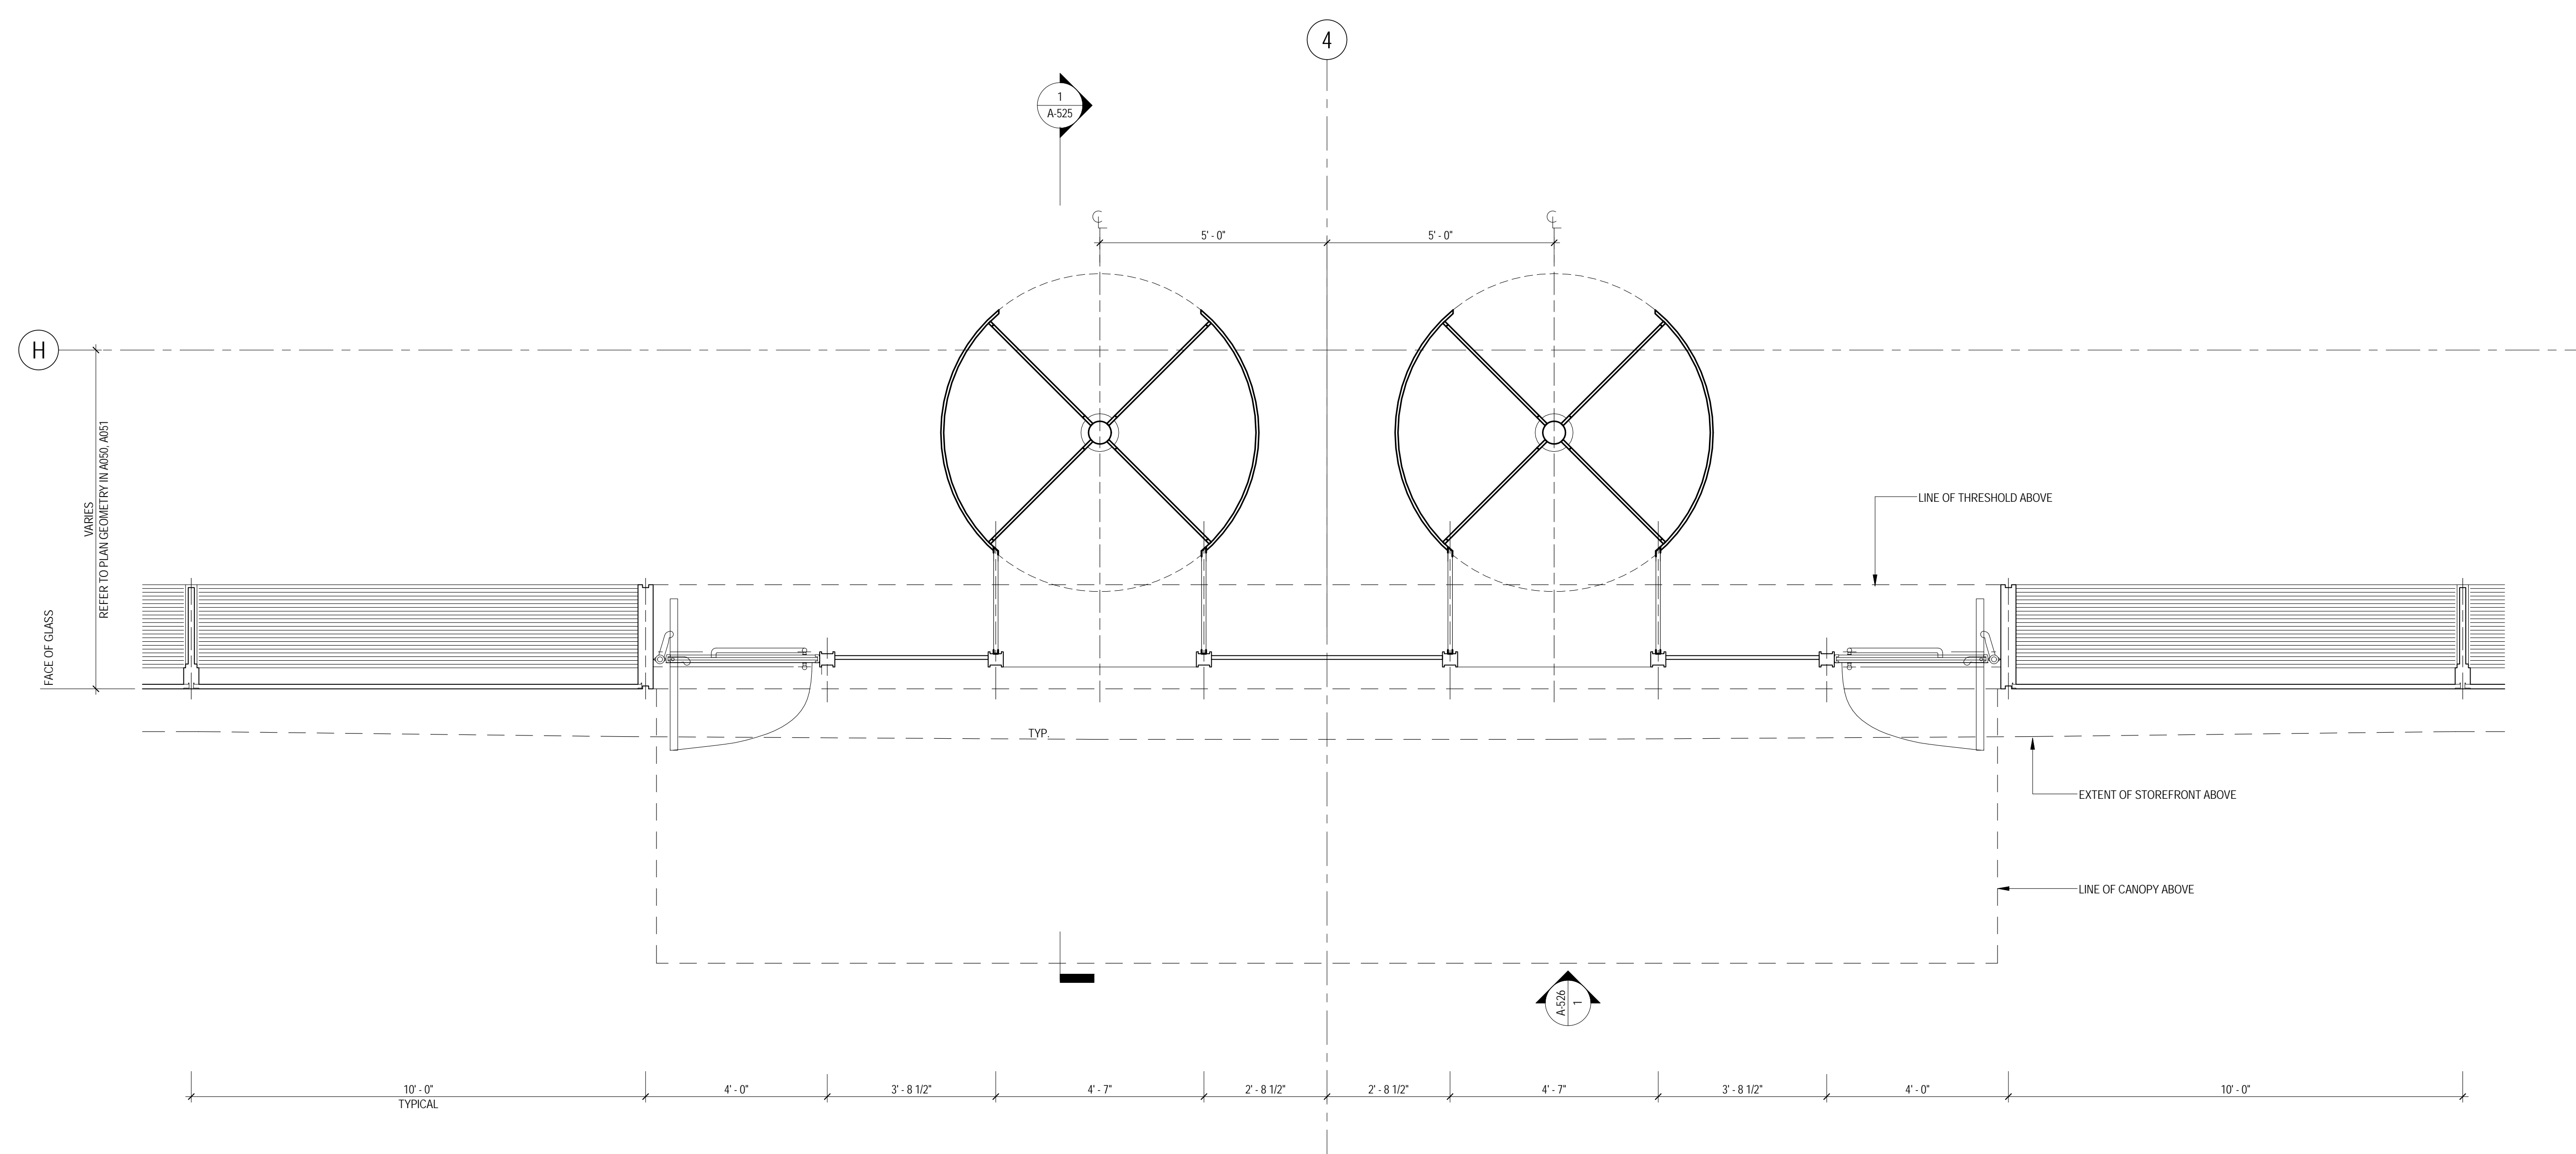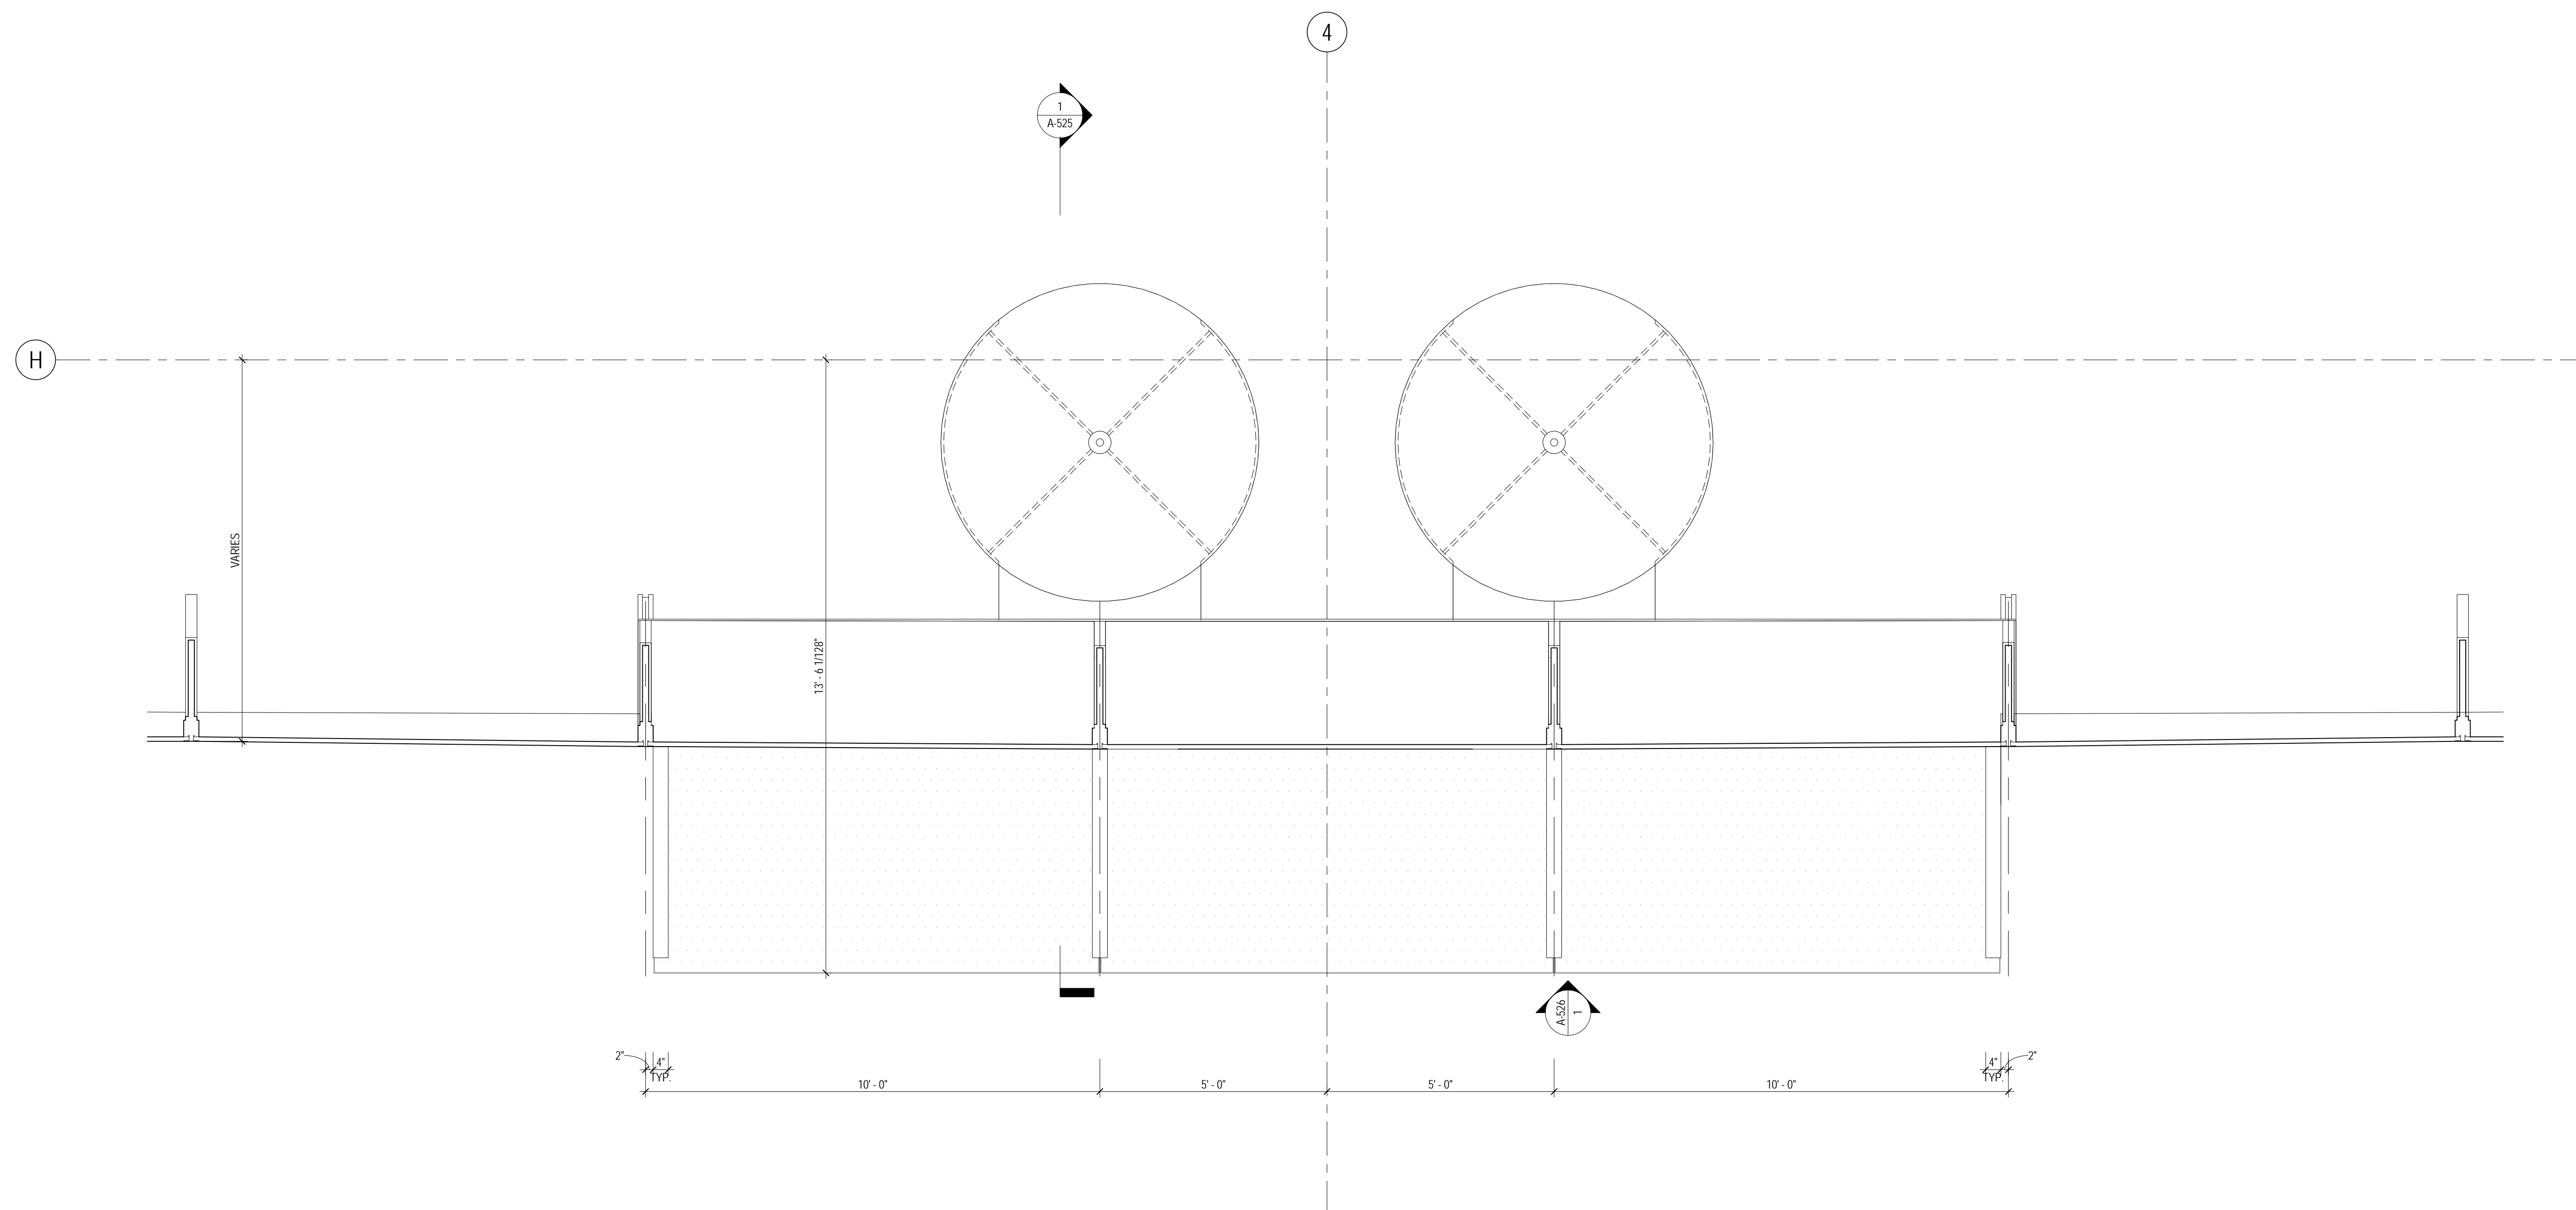

**MANHATTAN WEST:
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14 Penn Plaza, 225 W. 34th Street, New York, NY 10001

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Ducibella, Vantor & Santore

250 State Street #F1, North Haven, CT 06473

Weidinger Associates, Inc.
40 Wall Street, New York, NY 10005

Acoustical Consultant


Cerami & Associates
404 Fifth Avenue #8, New York, NY 10018
Vibration Consultant

Wilson, Uhrig & Associates, Inc.
65 Broadway, Suite 401, New York, NY 10006

Code Consultants
Code Consultants Professional Engineers PC
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Entek Engineering LLC
166 Ames Street, Hackensack, NJ 07601

Wind Tunnel Consultant
Rowan Williams Davies & Irwin Inc.

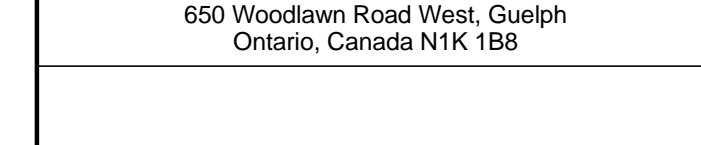

1

PRELIMINARY
CONSTRUCTION

NOT FOR


Key Plan:

A map showing the location of the property on 33rd Street. The street is labeled "33RD STREET" and runs horizontally. A shaded rectangular area represents the property, located on the south side of the street. A small square symbol is located at the northeast corner of the property, indicating a corner or boundary.

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1

ENLARGED ELEVATION AT EAST ENTRY
SCALE: 1/2" = 1'-0"

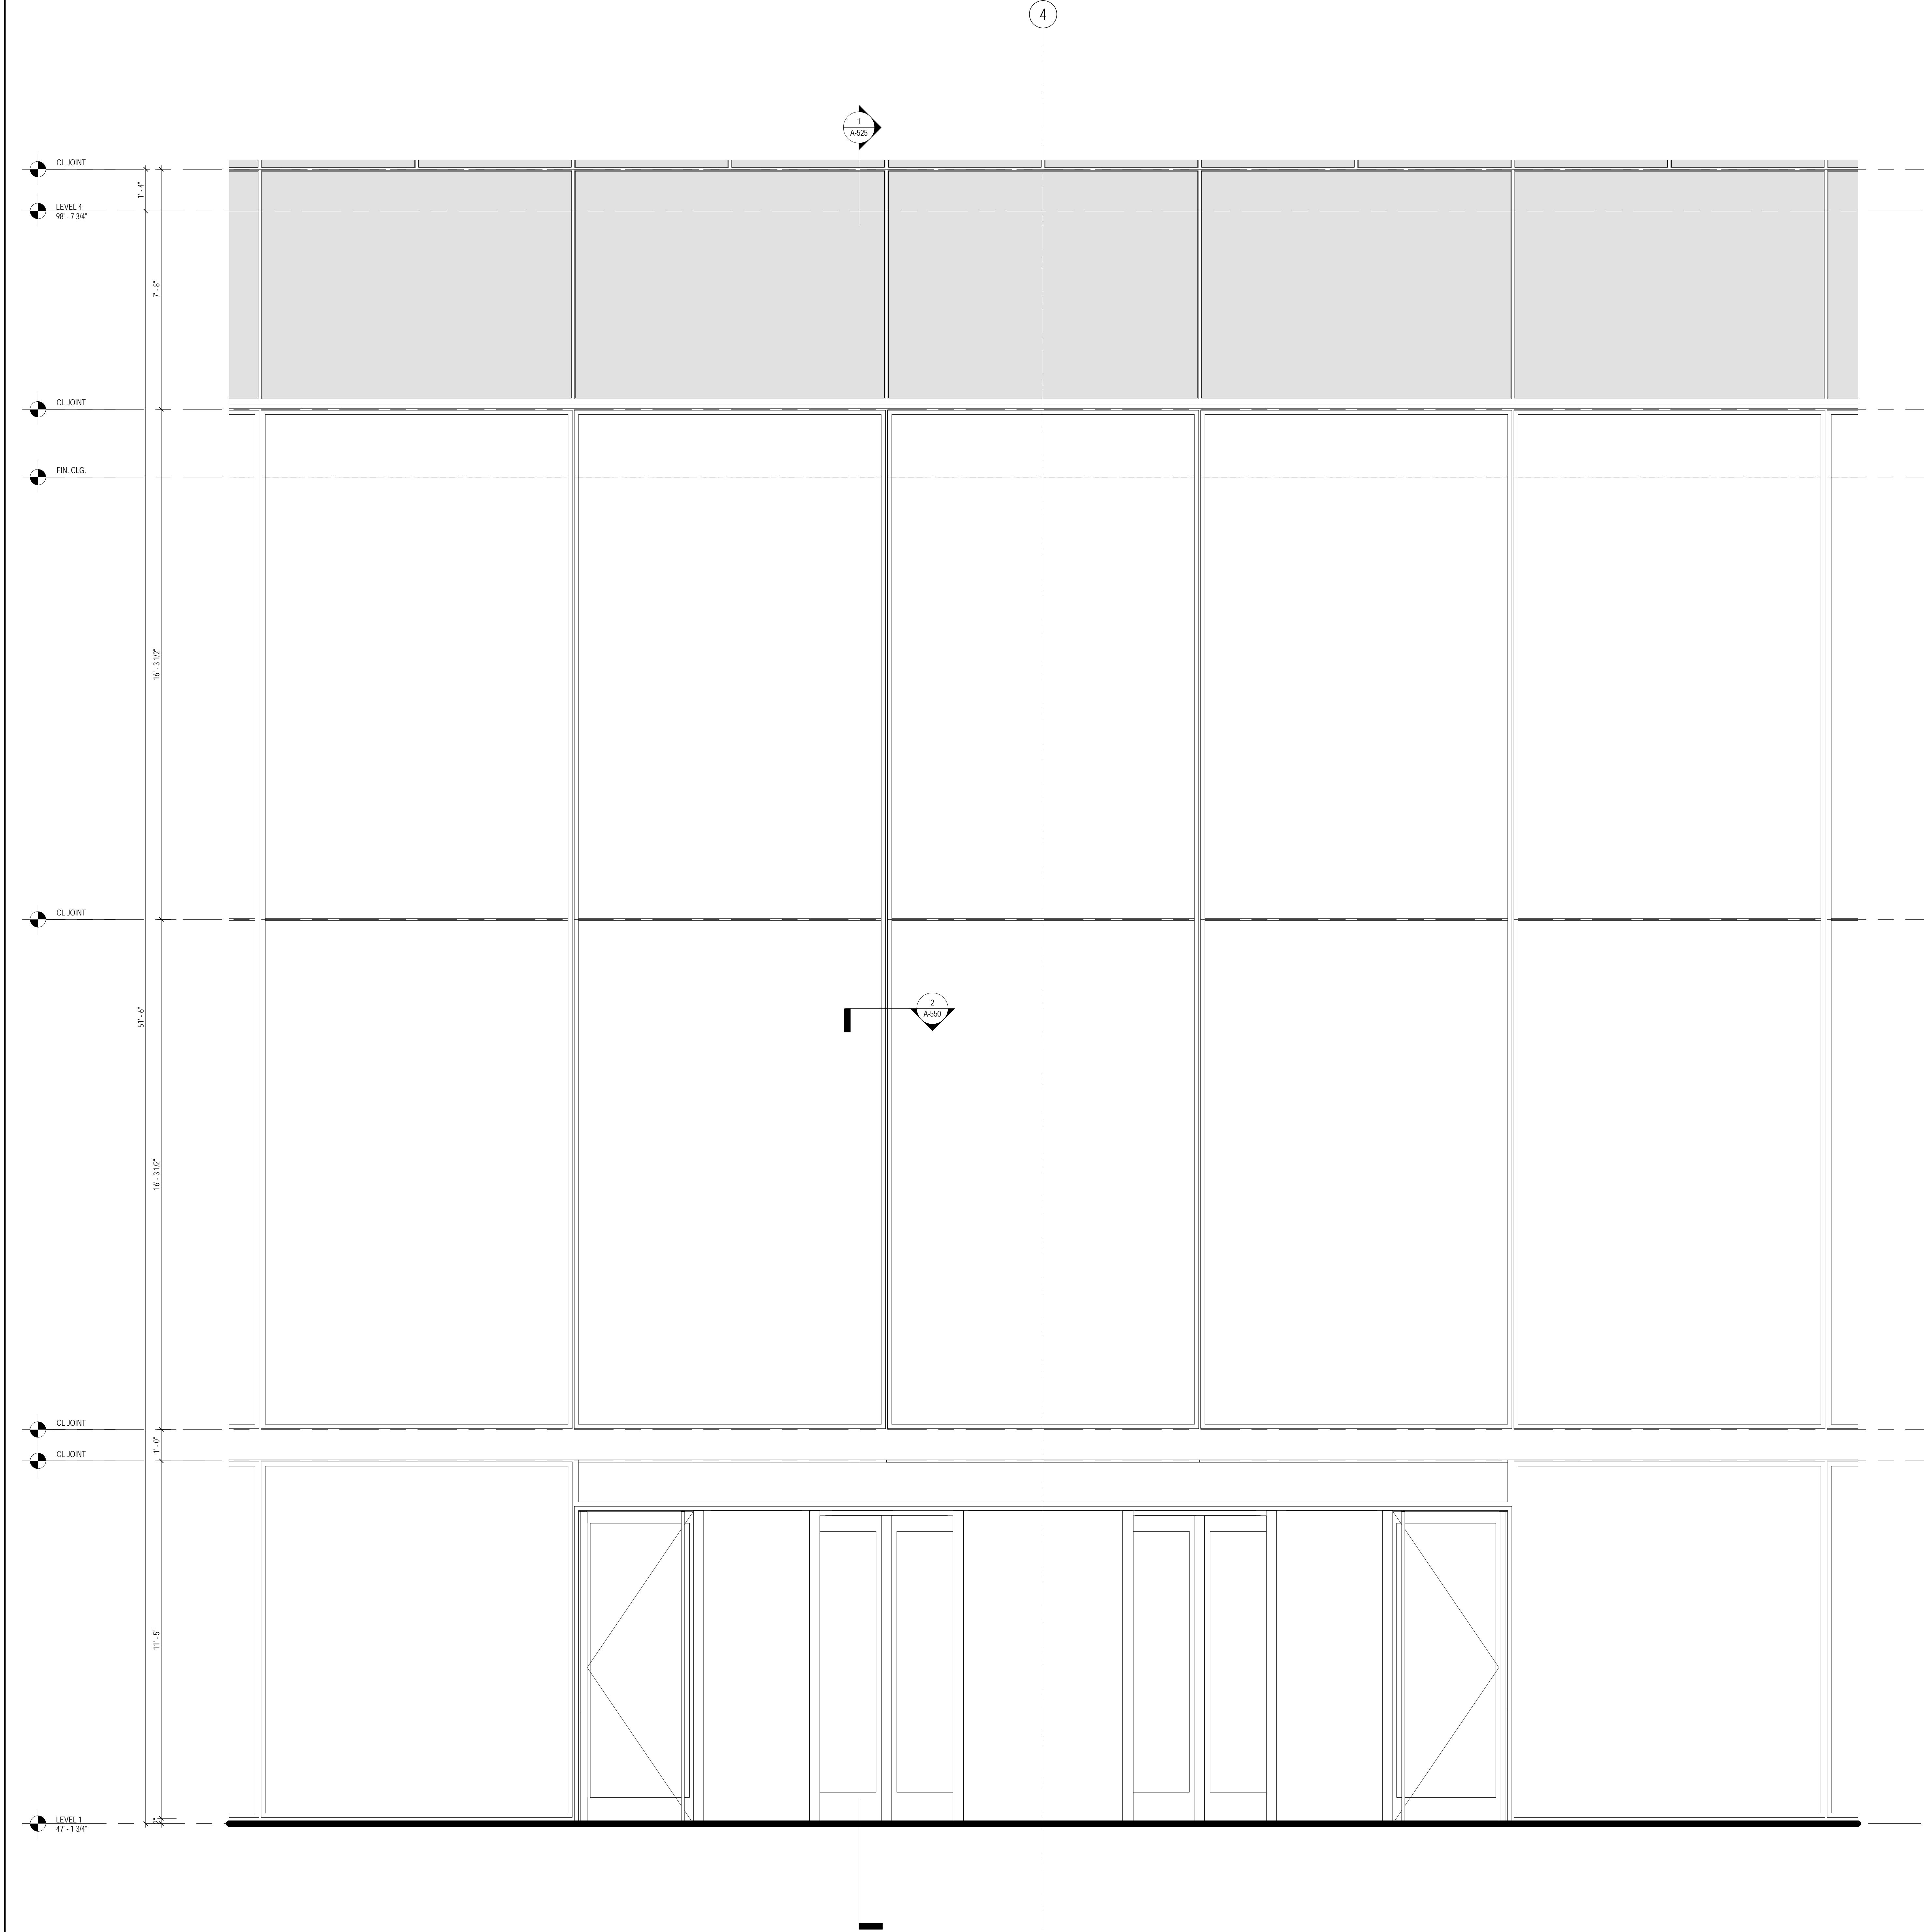

Sheet No. 2187143



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NORTH TOWER
375 Ninth Avenue, New York, NY 10001
Client

Brookfield
Brookfield Place
250 Vesey Street, 15th Floor, New York, NY 10021

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Skidmore, Owings & Merrill LLP
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Philip Habib & Associates
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Field Operations
475 10th Avenue, New York, NY 10018

Security Consultant
Ducibella, Vantor & Santoro
250 State Street #F1, North Haven, CT 06473

Blast Consultant
Weidinger Associates, Inc.
40 Wall Street, New York, NY 10005

Acoustical Consultant
Cerami & Associates
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Code Consultants Professional Engineers PC
215 West 40th Street, 15th Floor, New York, NY 10018

Facade Maintenance Consultant
Entek Engineering LLC
166 Ames Street, Hackensack, NJ 07601

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Rowan Williams Davies & Irwin Inc.
650 Woodlawn Road West, Guelph, Ontario, Canada N1K 1B8

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Key Plan:



Seal & Signature:




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1	18 NOV 2013	ISSUED FOR 3D PROGRESS PRICING
No.	Date	Description
Sheet Name:		


STOREFRONT
ENTRANCES

Project No.: 207150
Date: 12 SEPT 2014
Scale: 1/2" = 1'-0"
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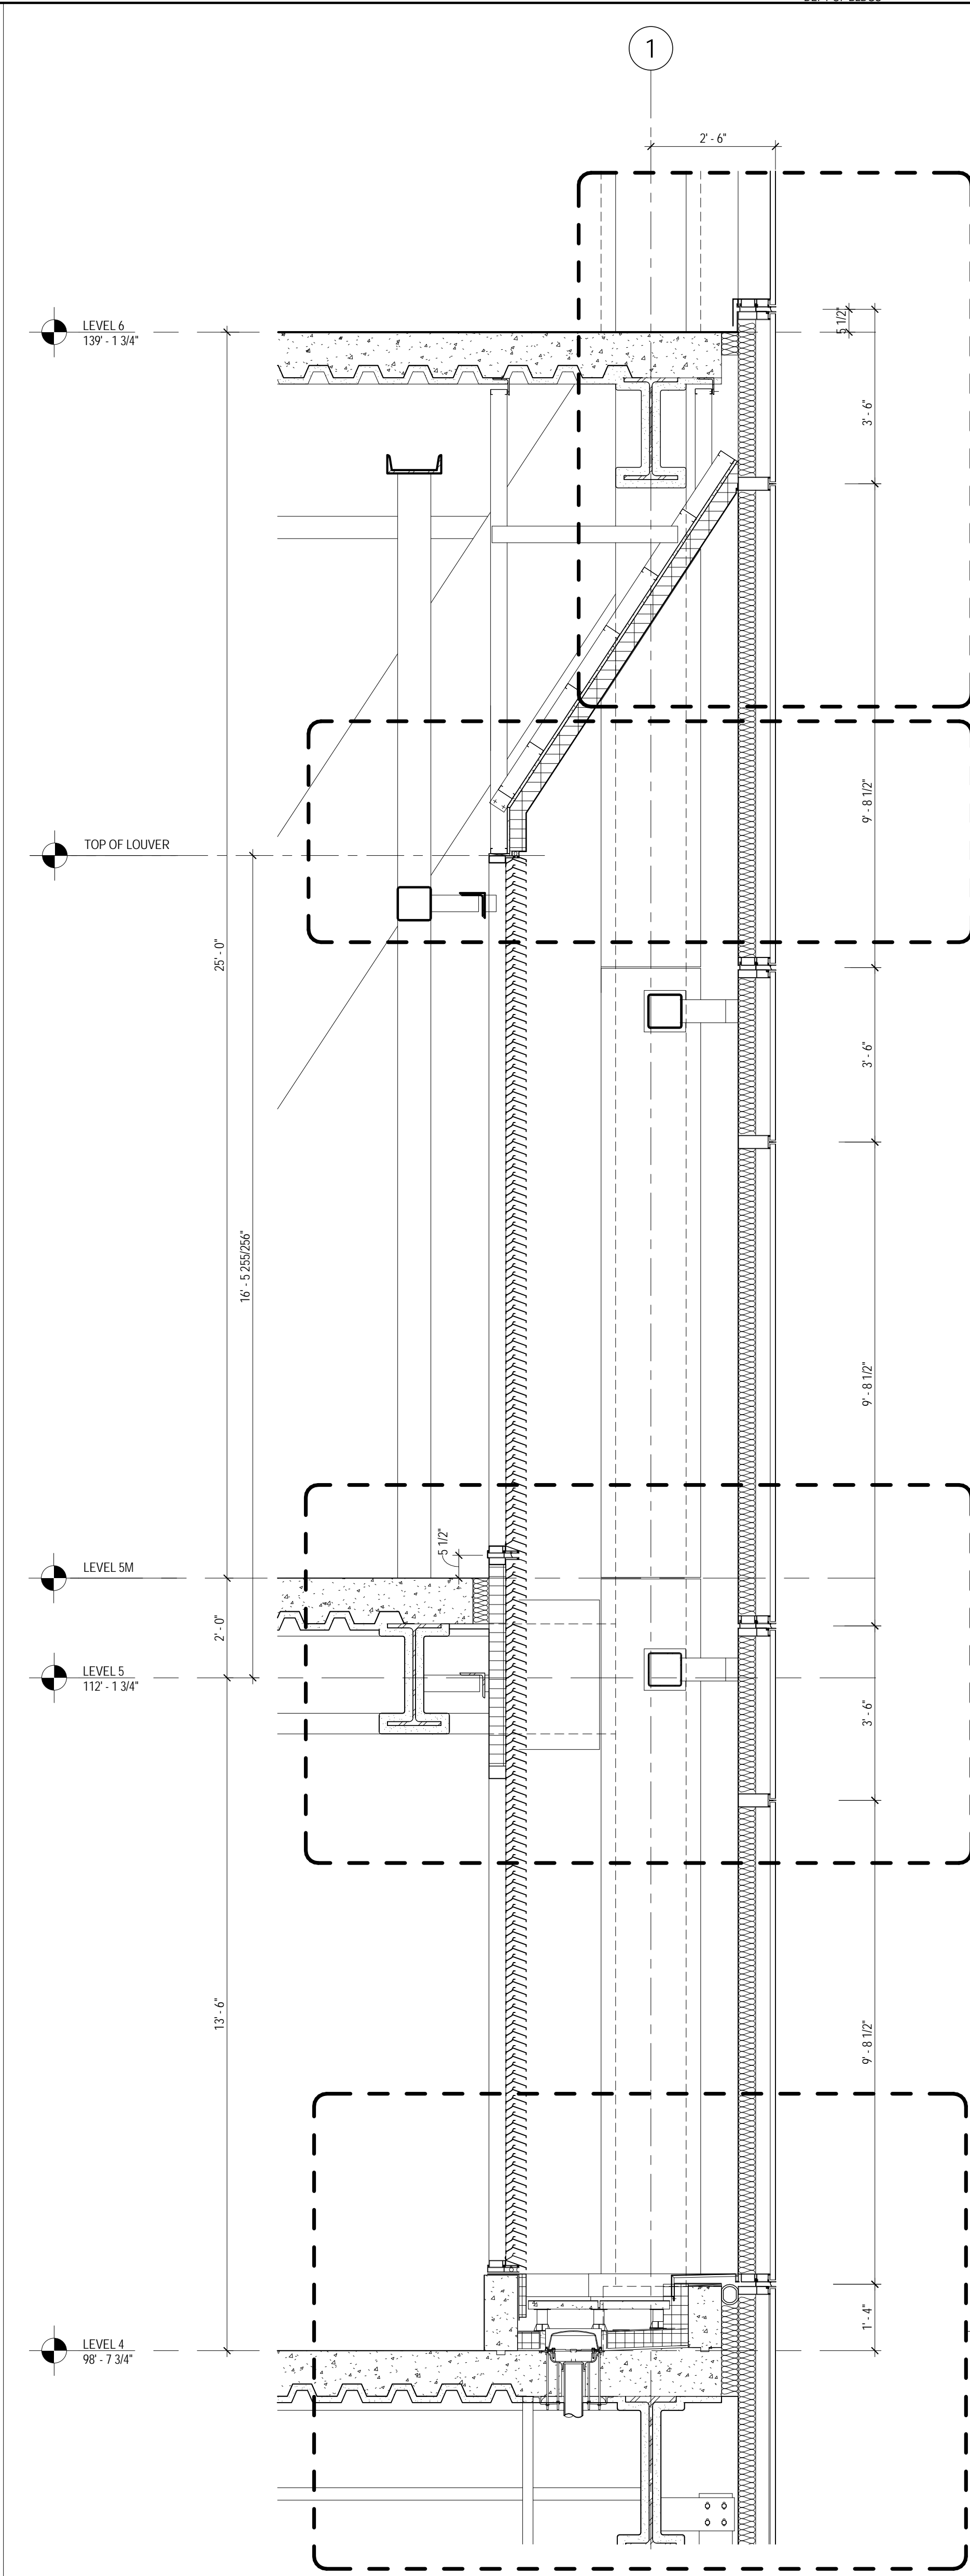
B-SCAN Sheet No.: A-526.00
Sheet No.: A-526
Page No.: 30



6 ENLARGED ELEVATION AT MECHANICAL LEVEL
SCALE: 1/2" = 1'-0"

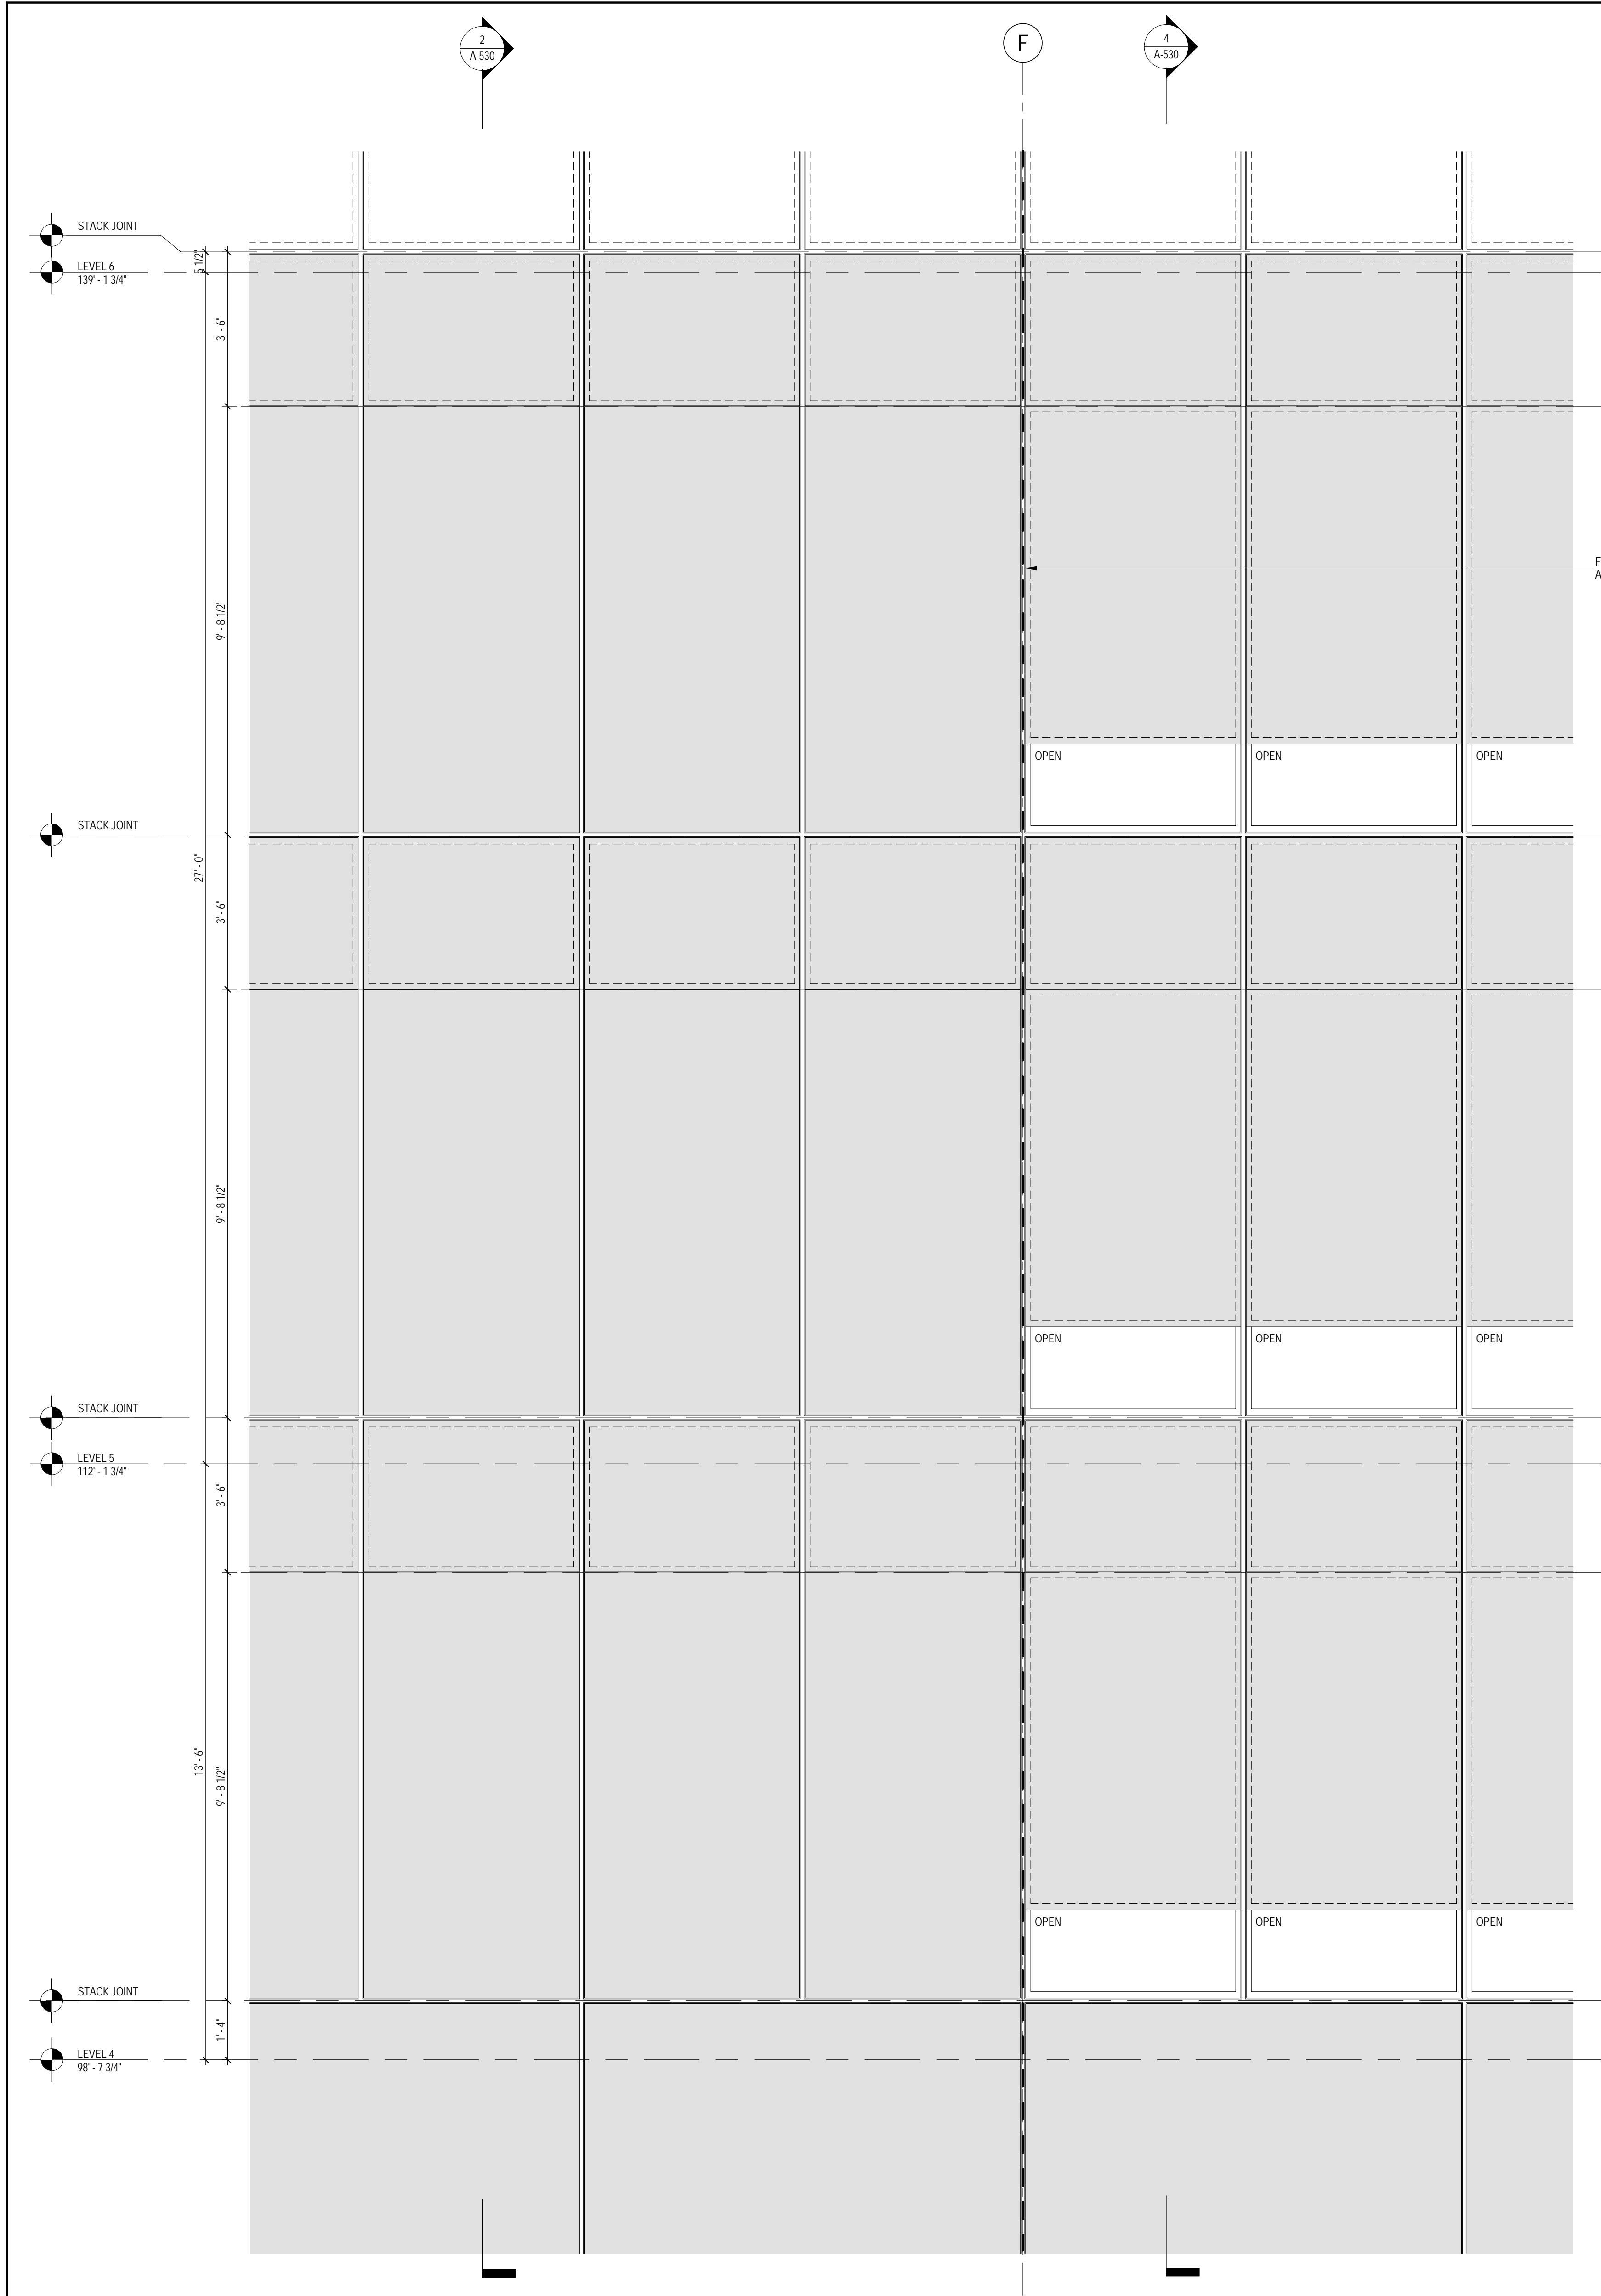

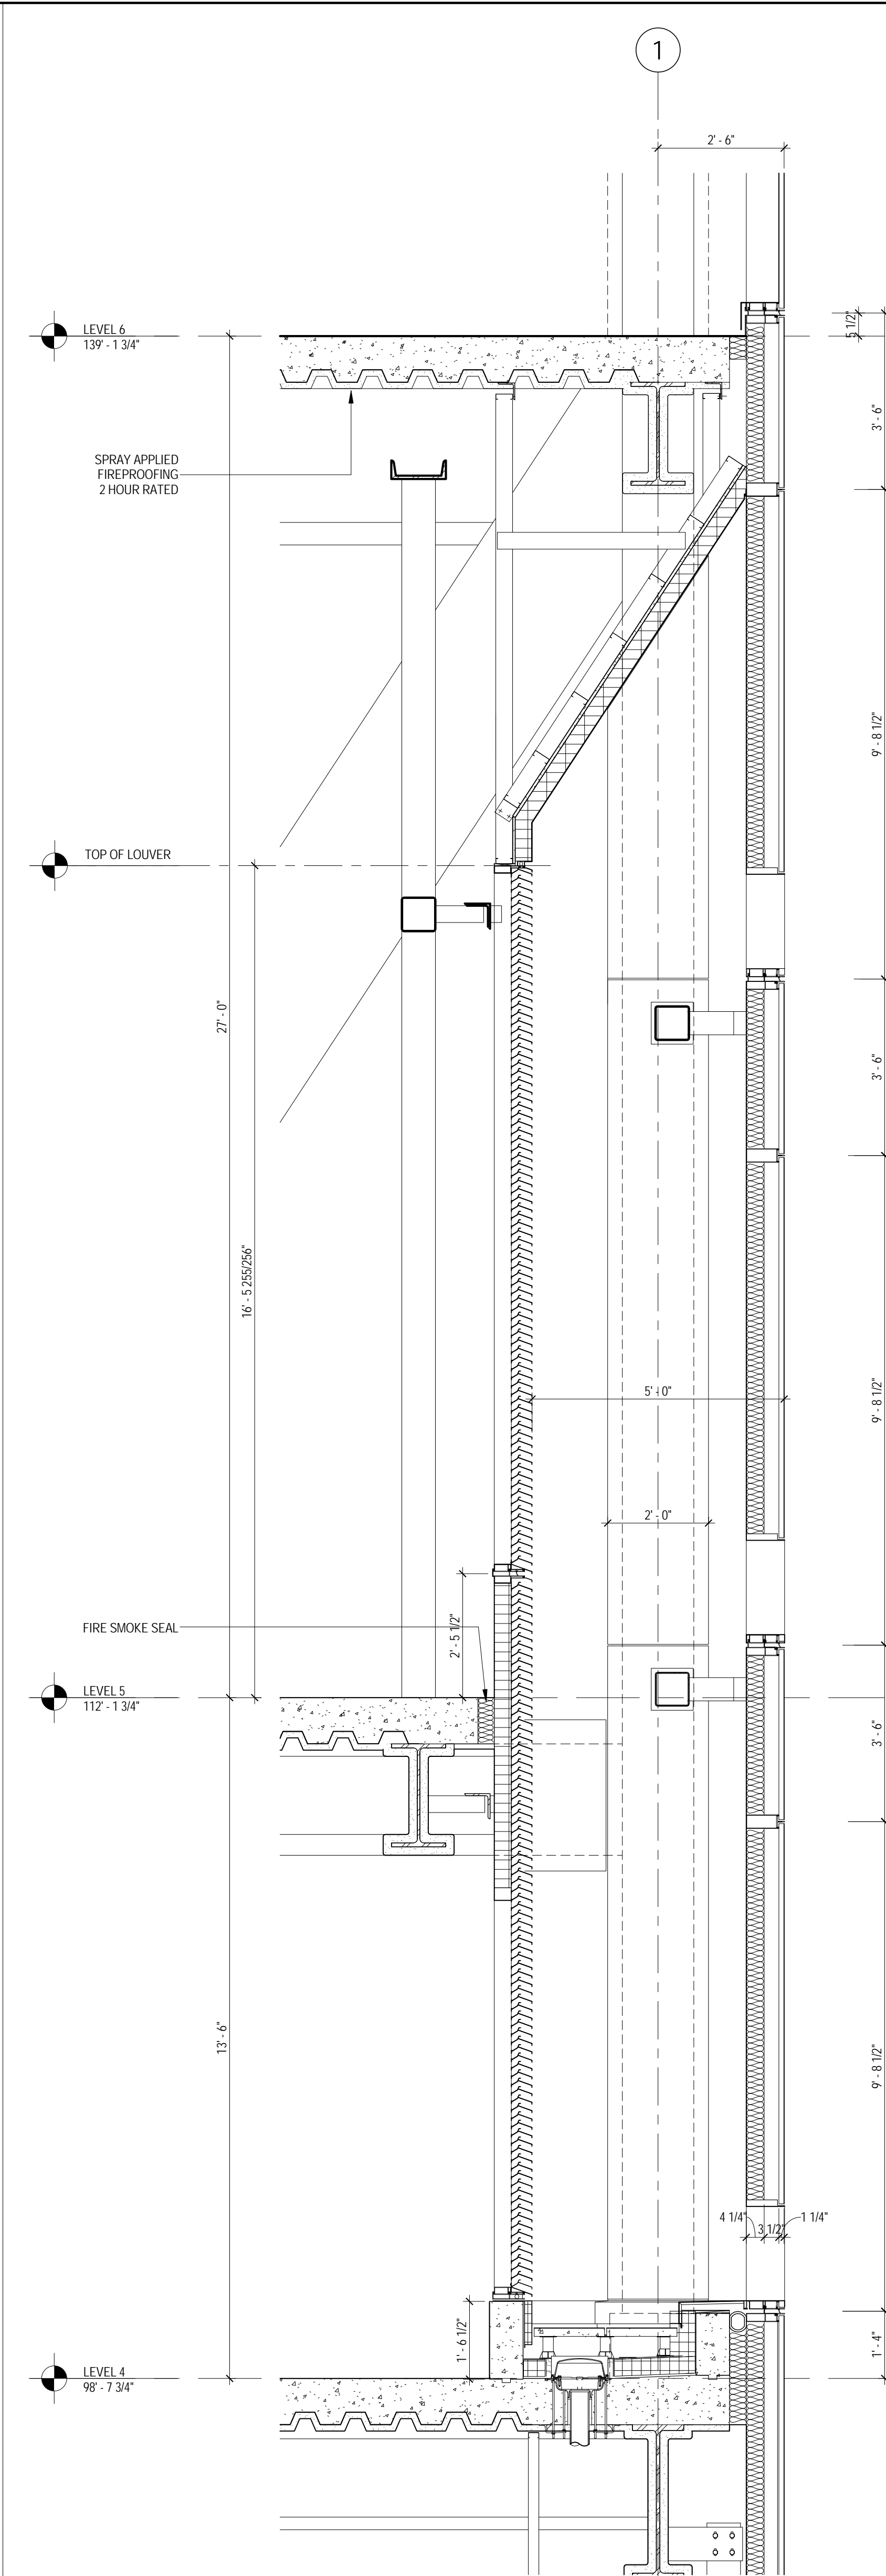4 ENLARGED SECTION AT MECHANICAL AREAWAY
SCALE: 1/2" = 1'-0"



2 ENLARGED SECTION AT MECHANICAL
SCALE: 1/2" = 1'-0"

**MANHATTAN WEST:
NORTH TOWER**
375 Ninth Avenue, New York, NY 10001
Client

Brookfield
Brookfield Place
250 Vesey Street, 15th Floor, New York, NY 10021

Architecture/Structural Engineering
SOM
Skidmore, Owings & Merrill LLP
14 Wall Street, New York, NY 10005

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Philip Habb & Associates
102 Madison Avenue #11, New York, NY 10016

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80 Pine Street, New York, NY 10005

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Edgett Williams Consulting Group, Inc.
102 East Bluffside Ave., Suite 1, Mill Valley, California 94941

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Viridian Energy & Environmental
50 Washington Street, Newark, CT 06854

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Mueser Rutledge Consulting Engineers
14 Penn Plaza, 225 W. 34th Street, New York, NY 10122

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Entek Engineering LLC
166 Ames Street, Hackensack, NJ 07601

Wind Tunnel Consultant
Rowan Williams Davies & Irwin Inc.
650 Woodlawn Road West, Guelph, Ontario, Canada N1K 1B8

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Key Plan:

Key Plan:
33RD STREET
DYER AVENUE
31ST STREET
9TH AVENUE

Seal & Signature:

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No.	Date	Description
2	12 SEPT 2014	ISSUED FOR FOUNDATION PERMIT
1	18 NOV 2013	ISSUED FOR 03 PROGRESS PRICING




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AT LEVEL 2
MECHANICAL
AREAWAY**

Project No.:	B-SCAN Sheet No.:
207150	A-530.00

Date:	Sheet No.:
12 SEPT 2014	A-530

Scale:	Page No.:
1/2" = 1'-0"	30

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Skidmore, Owings & Merrill LLP
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Mueser Rutledge Consulting Engineers
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Wind Tunnel Consultant
Rowan Williams Davies & Irwin Inc.
650 Woodlawn Road West, Guelph Ontario, Canada N1K 1B8
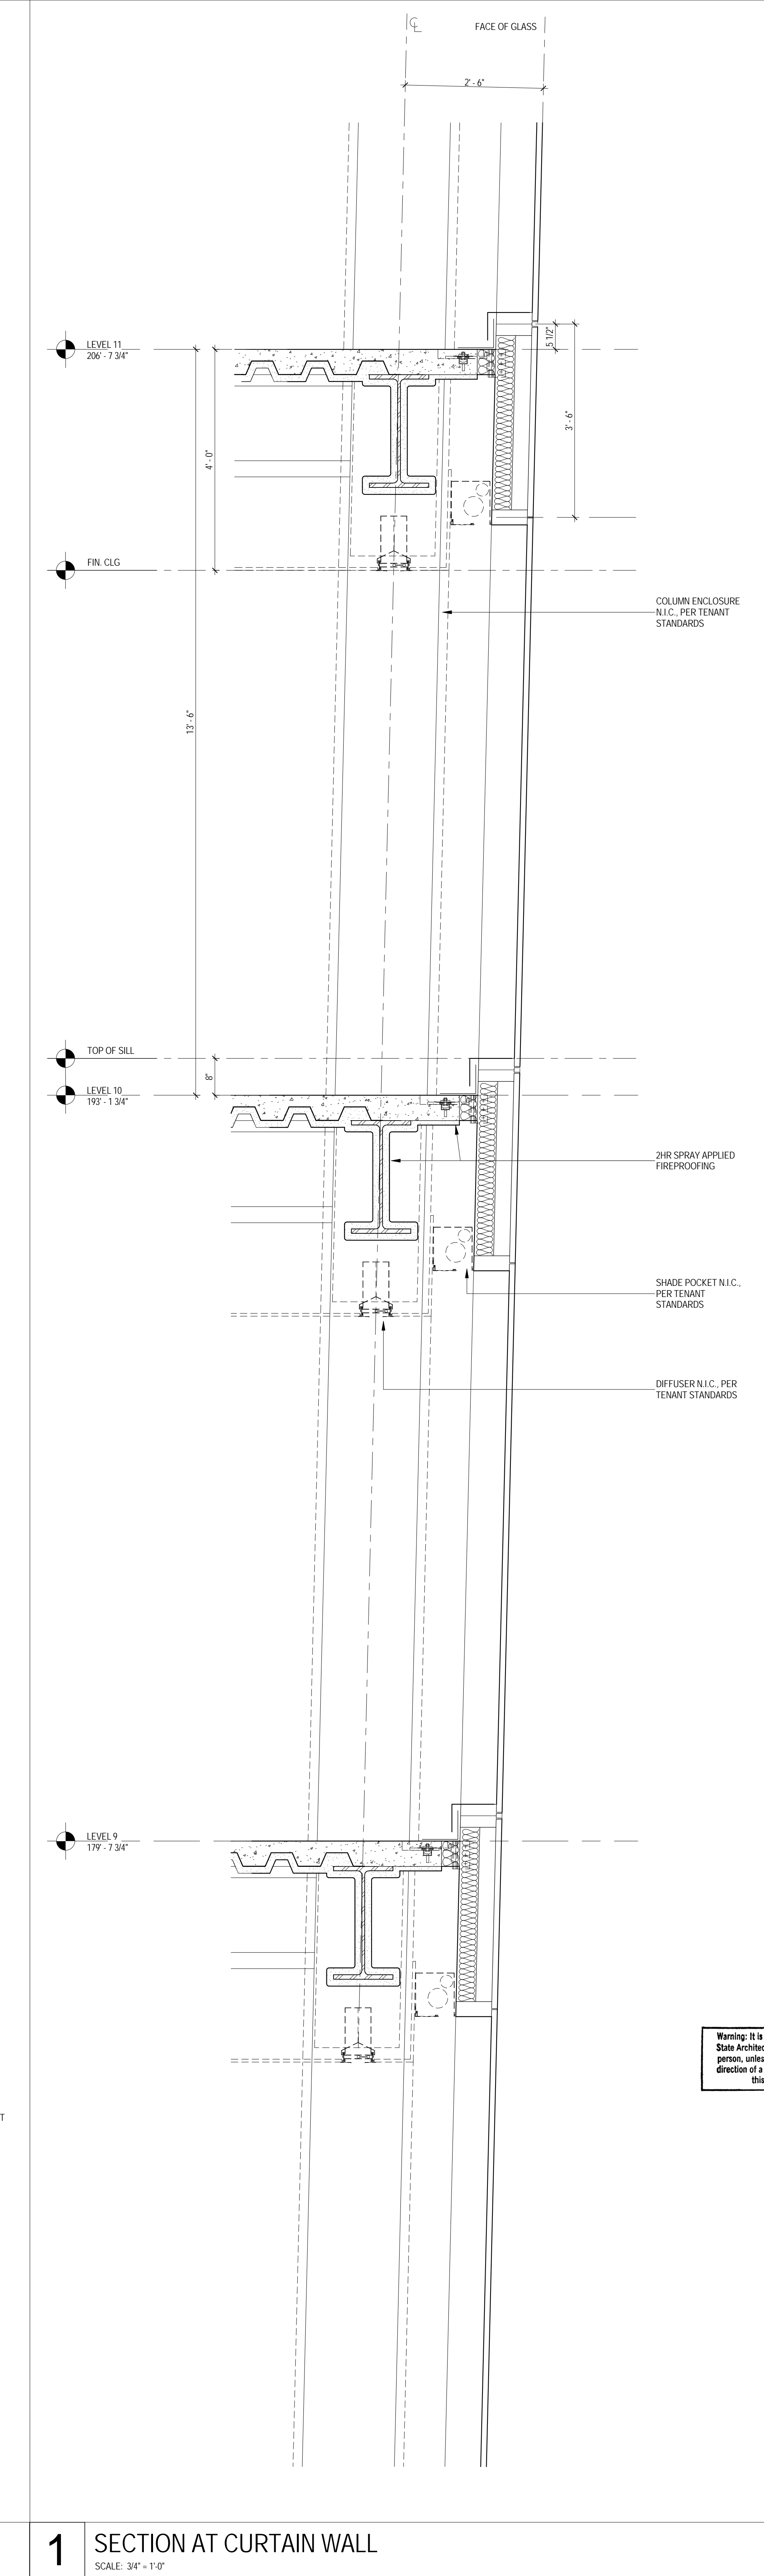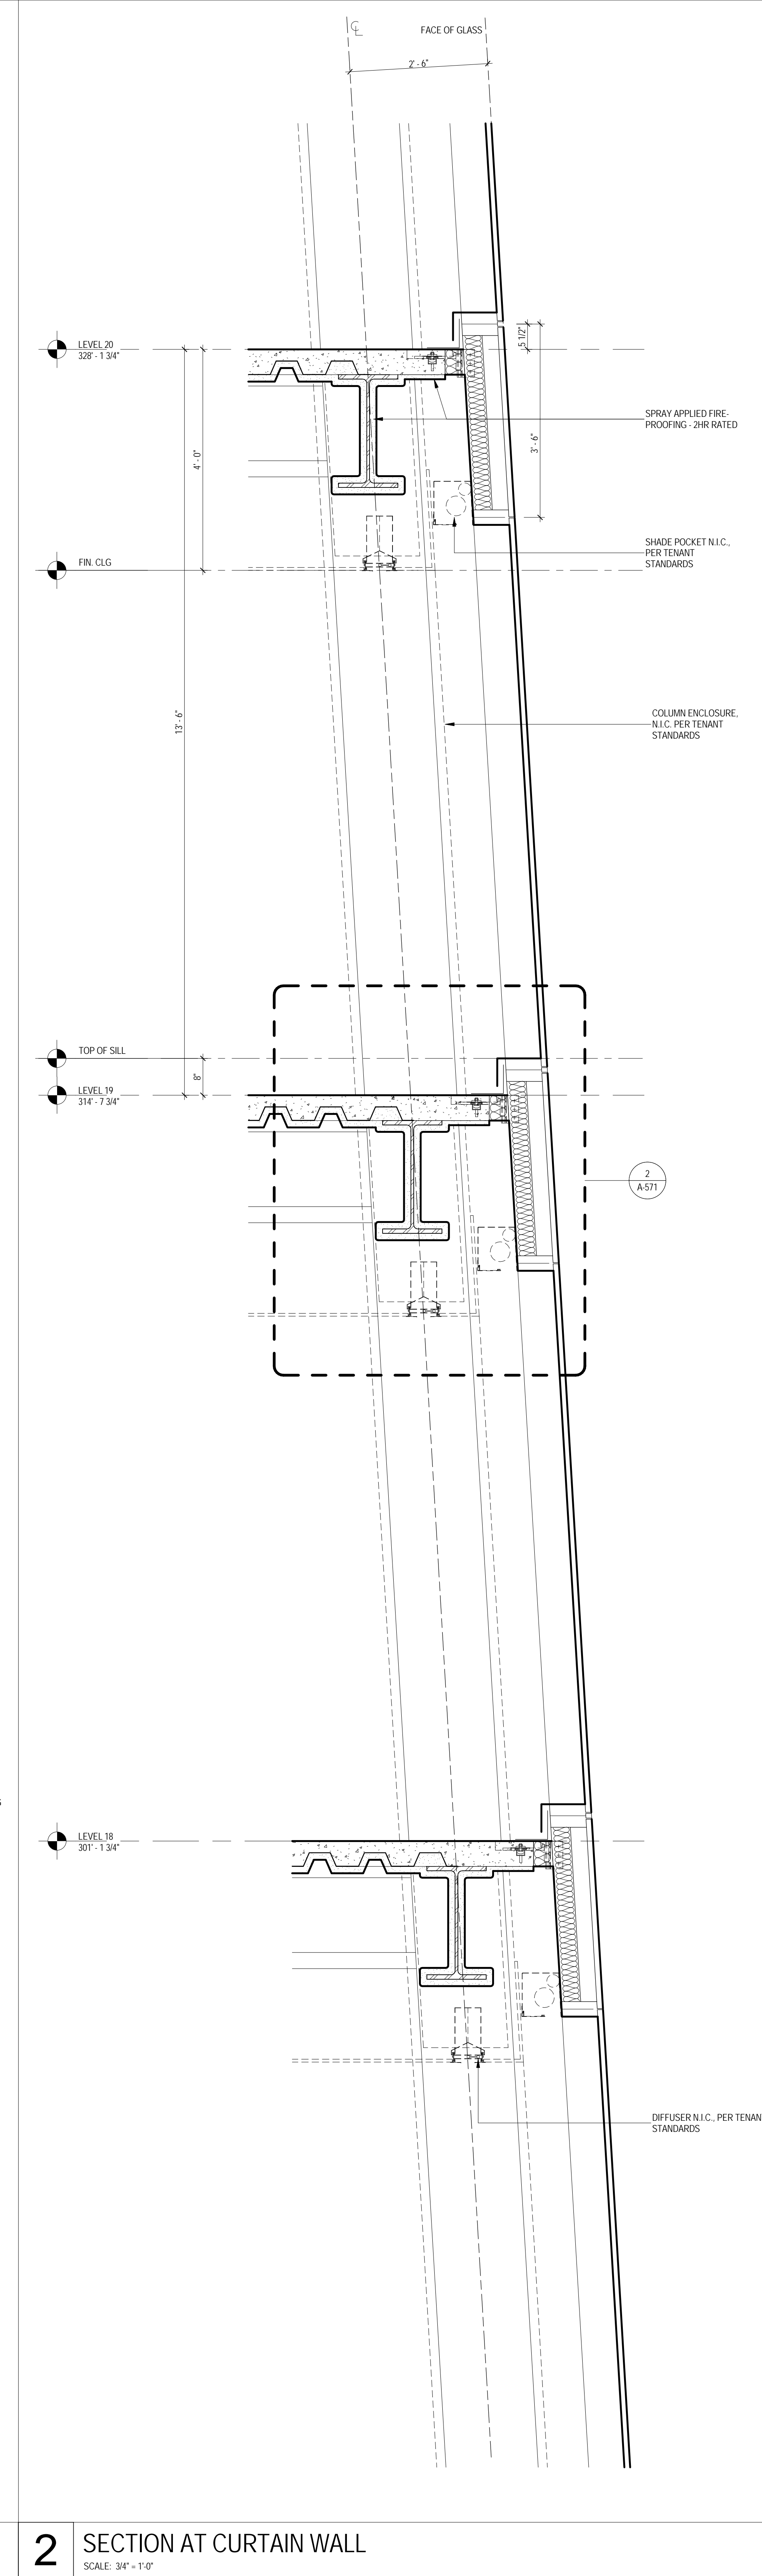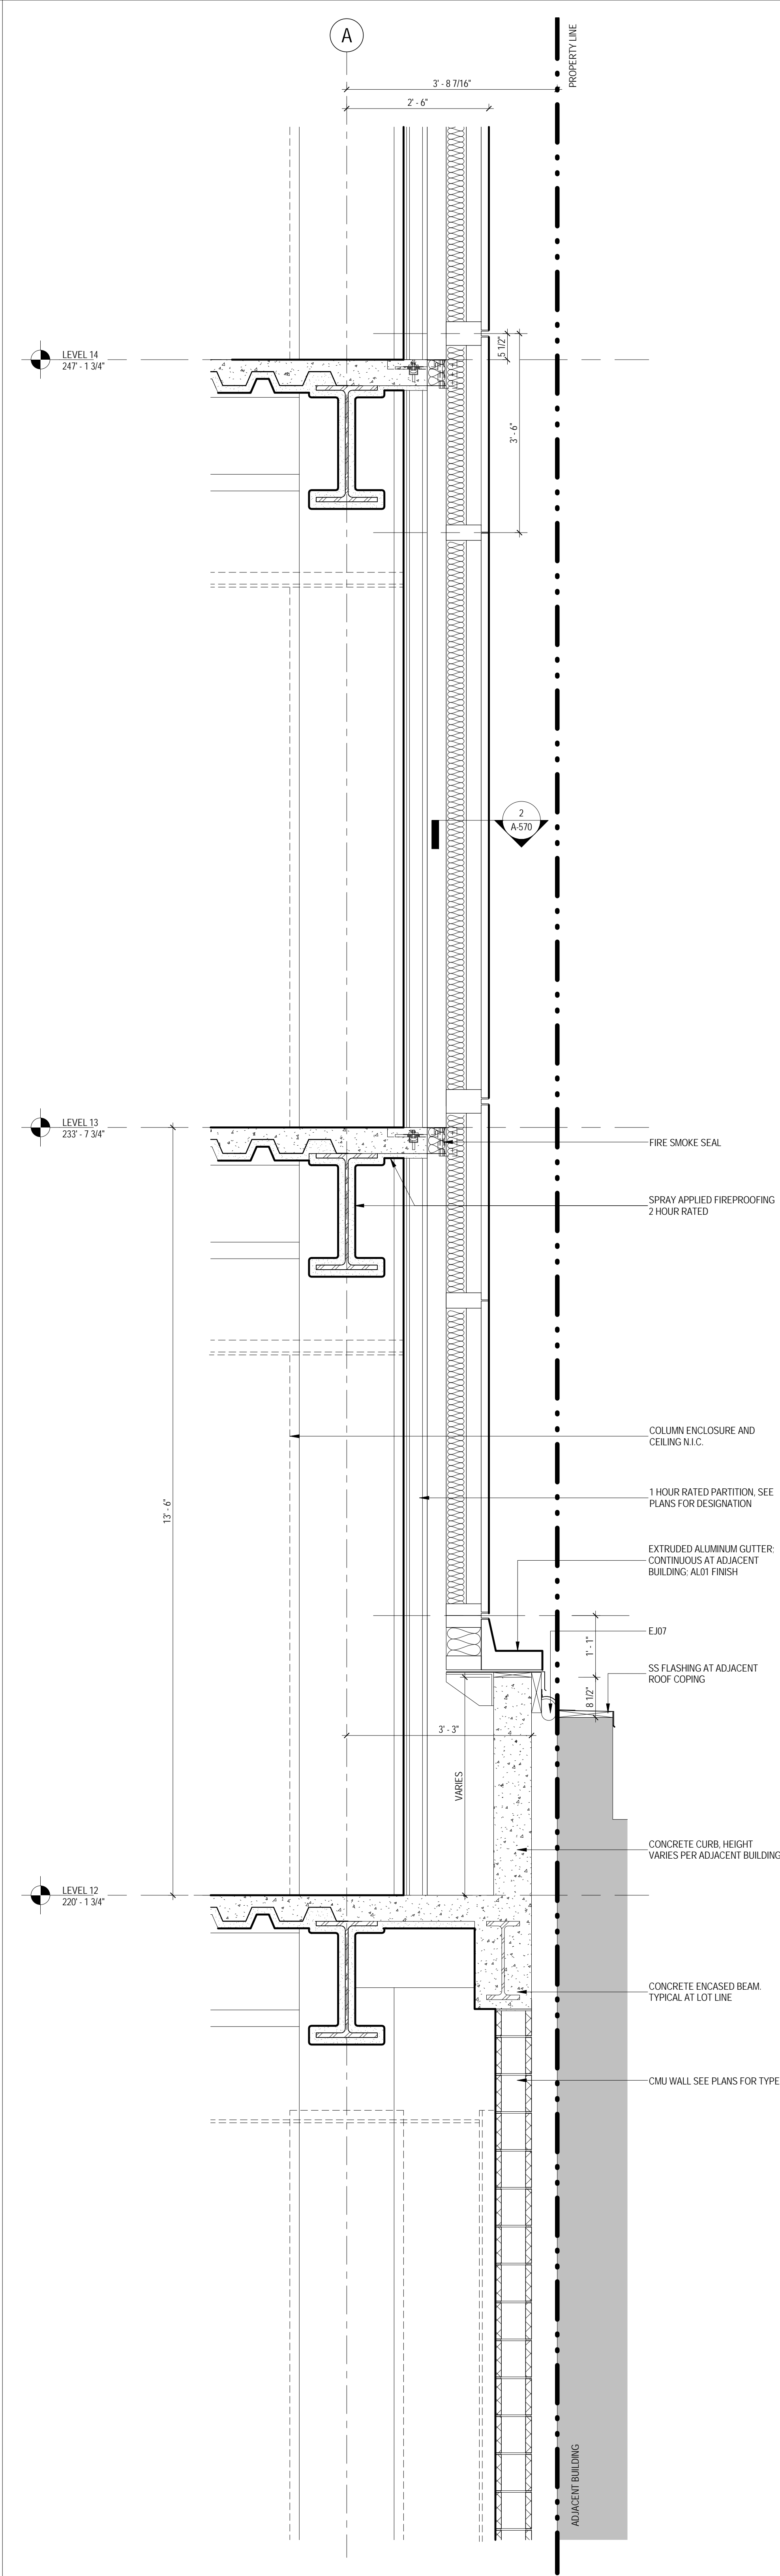
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Key Plan:

Seal & Signature:


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REGISTERED ARCHITECT
STATE OF NEW YORK
A-536


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No.	Date	Description
Sheet Name:		

TYPICAL CURTAIN WALL SECTIONS

Project No.: 207150	B-SCAN Sheet No.: A-536.00
Date: 12 SEPT 2014	Sheet No.: A-536
Scale: 3/4" = 1'-0"	Page No.: 30
File No.: A-536	

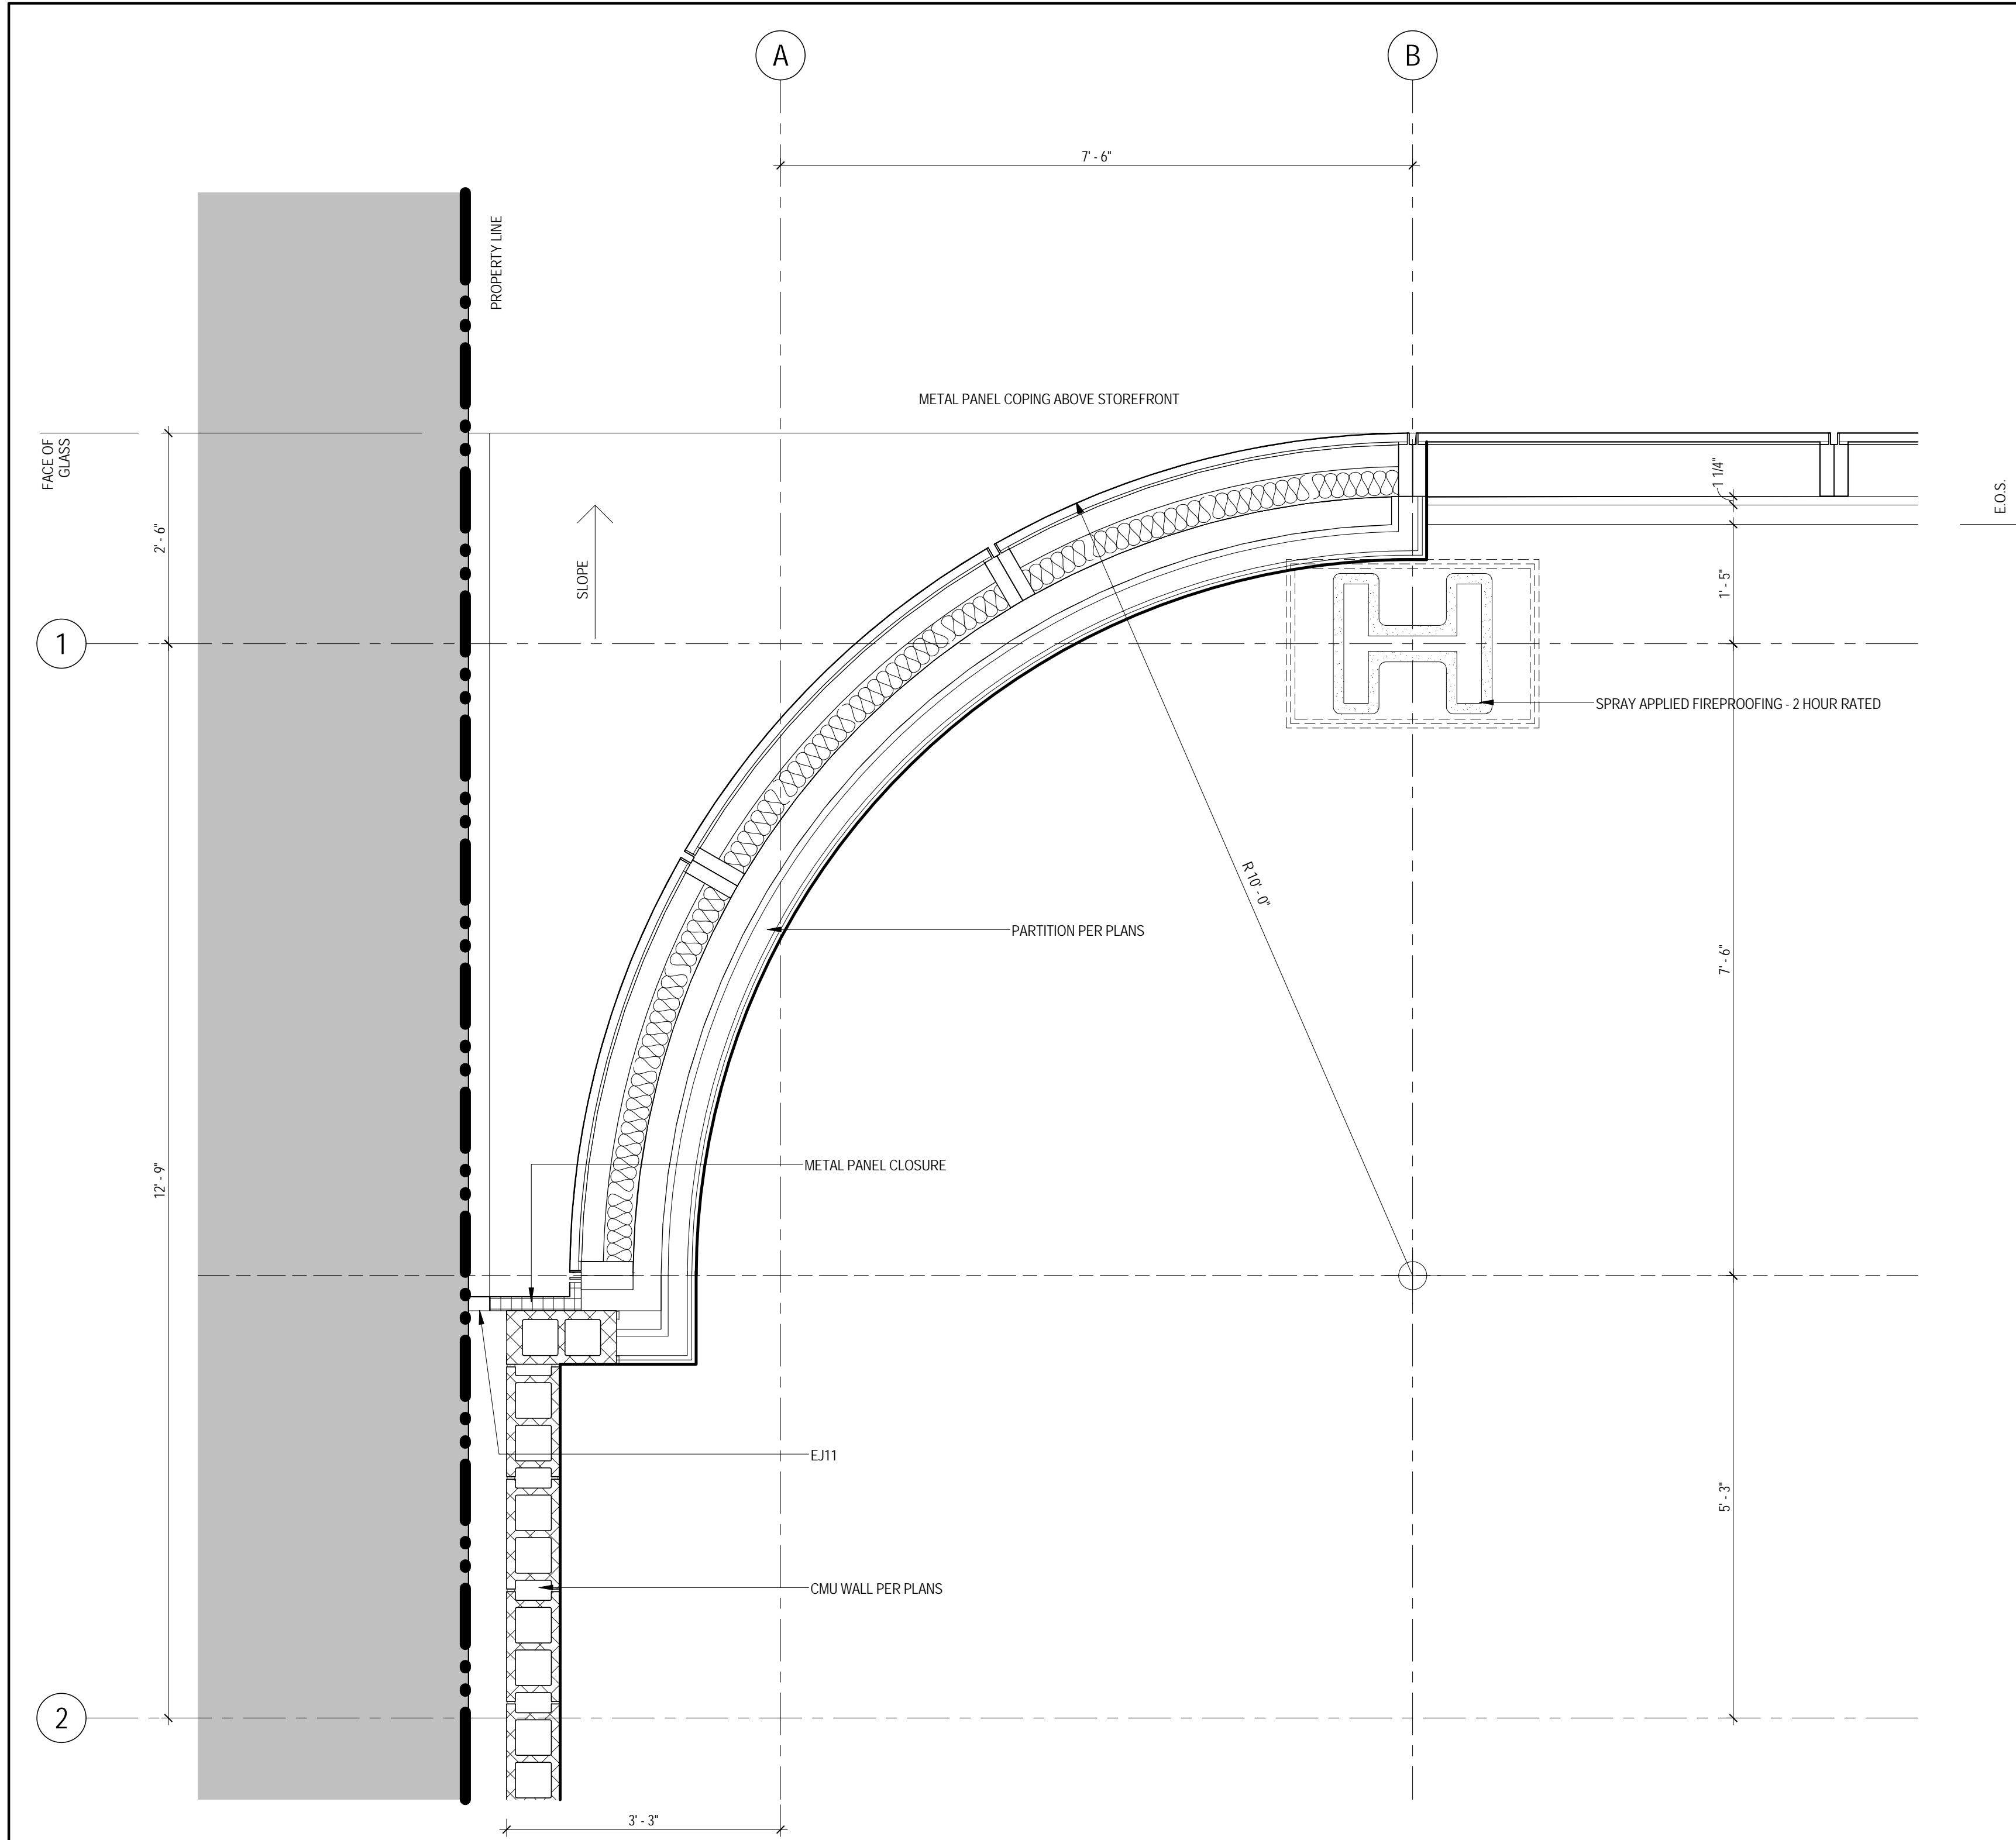


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SCALE: 3/4" = 1'-0"

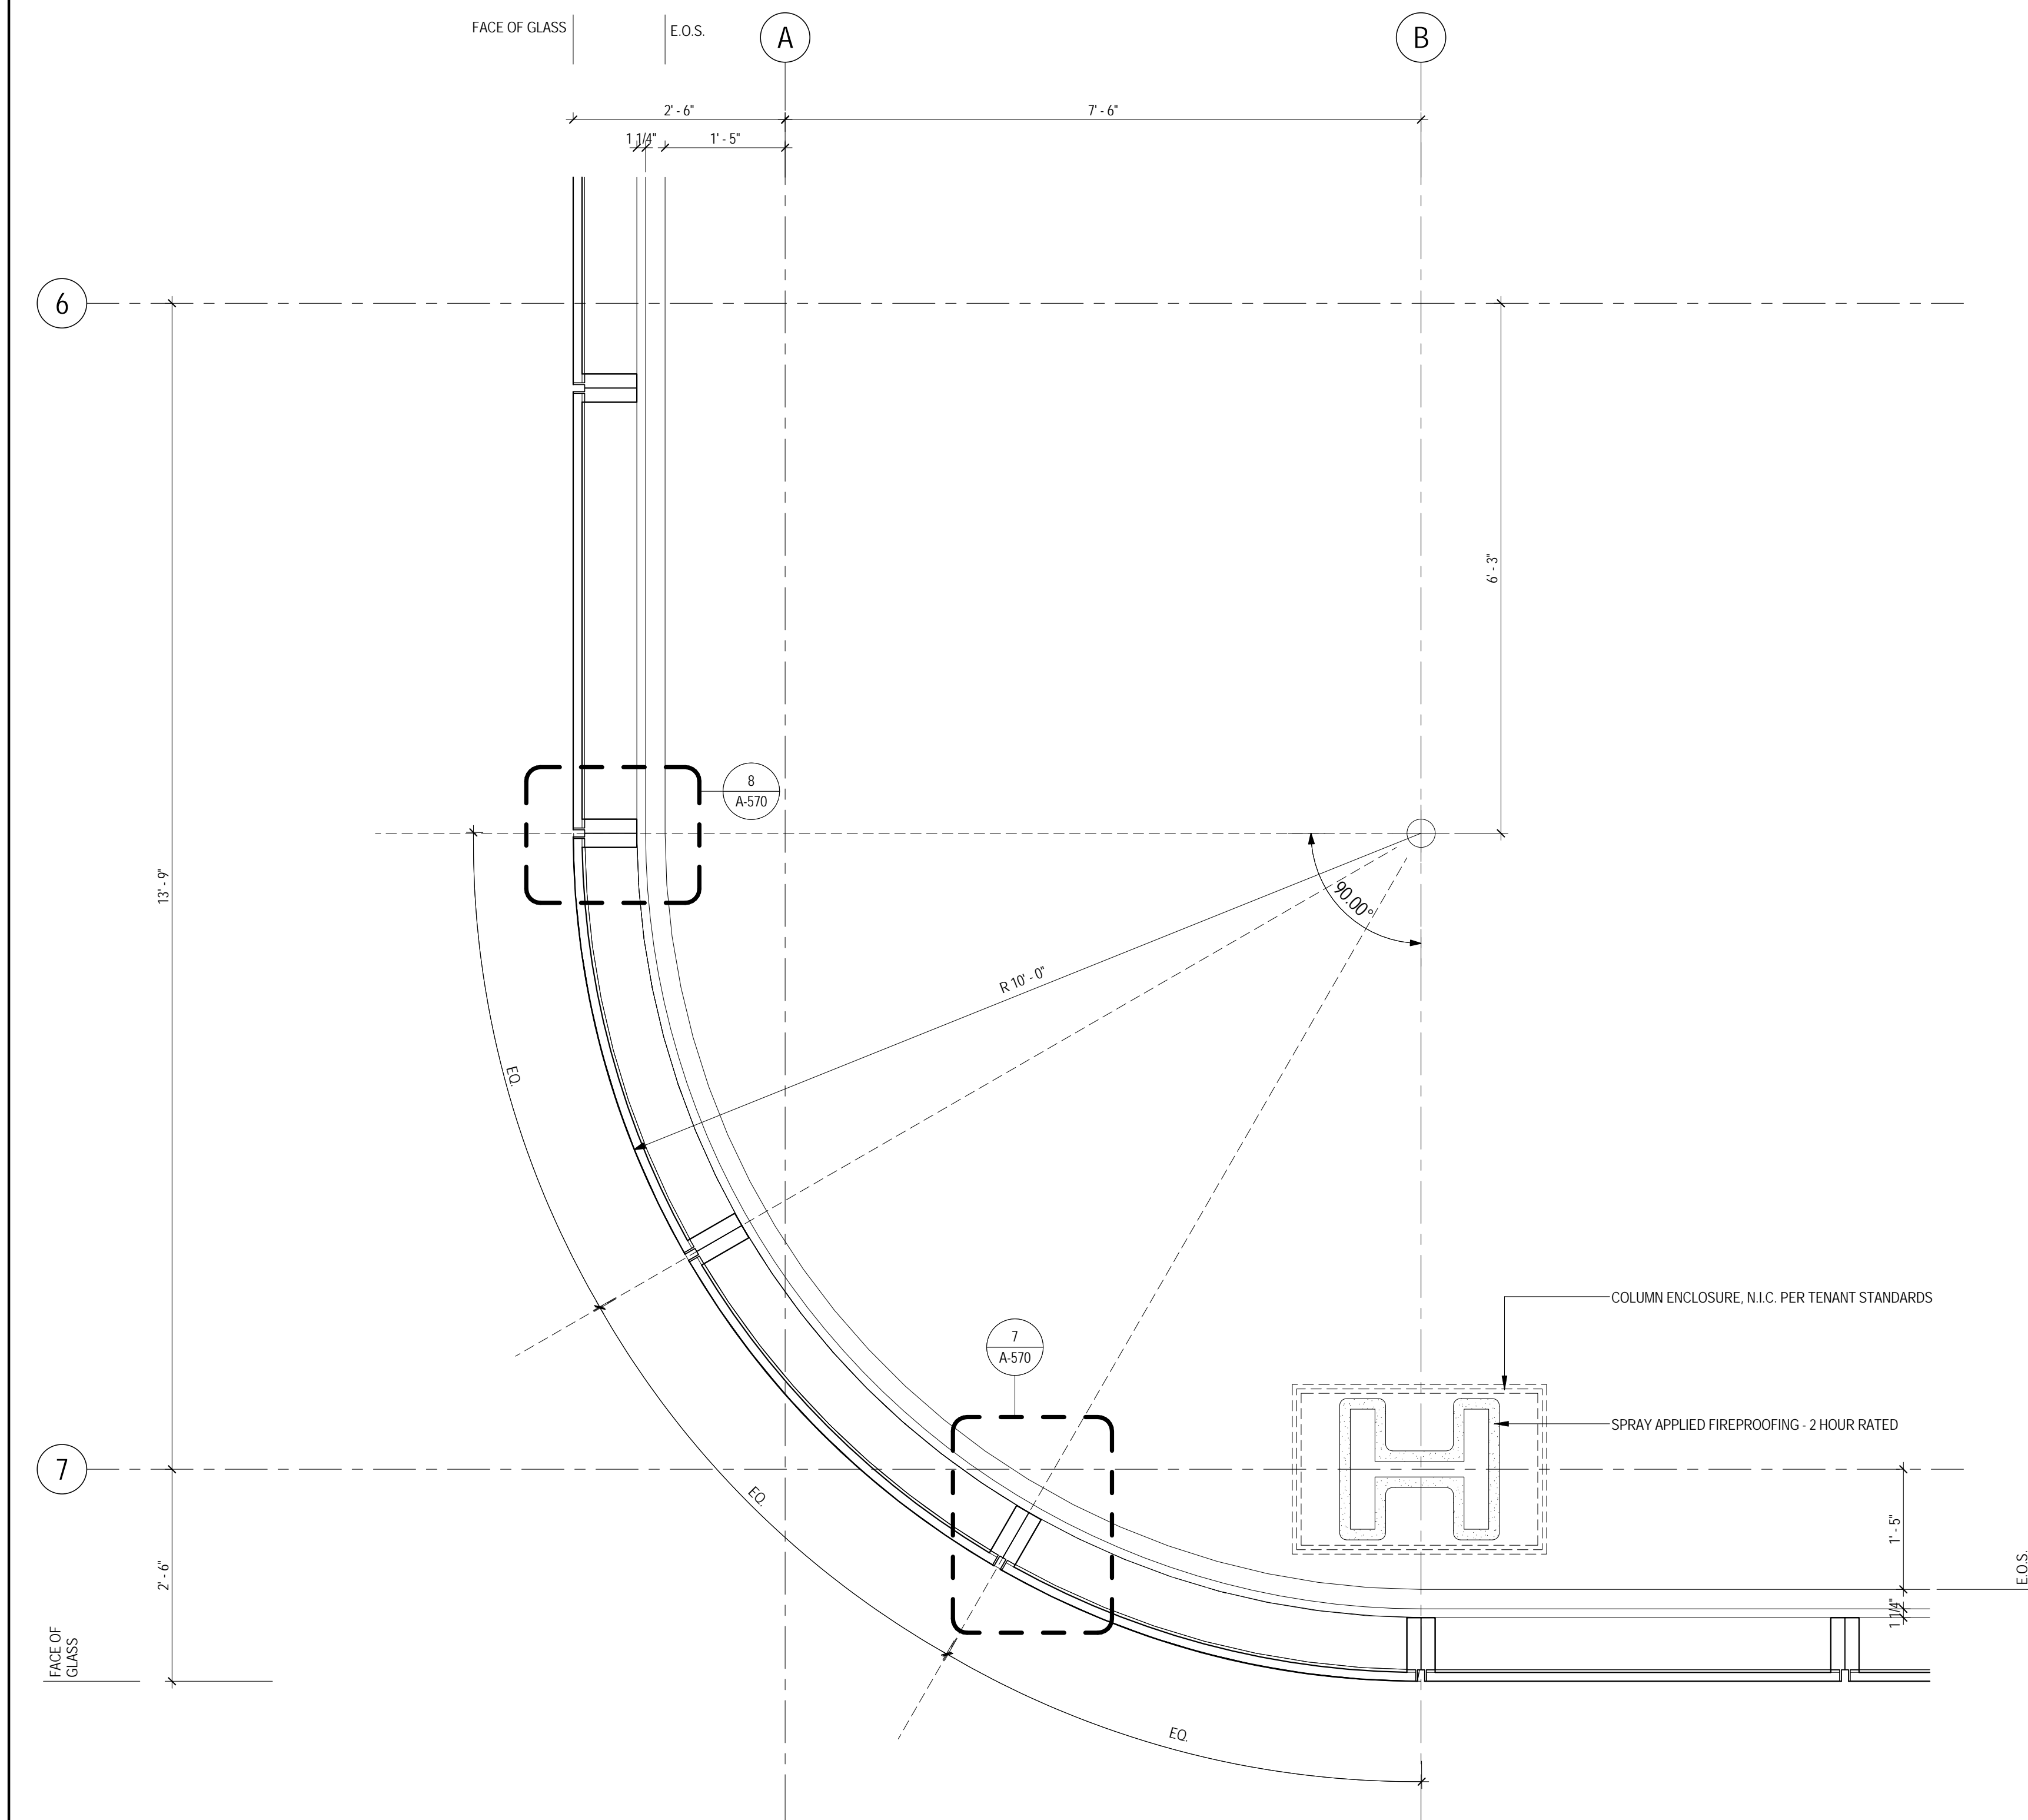

2 ENLARGED PLAN AT SOUTHWEST CORNER
SCALE: 3/4" = 1'-0"




1 ENLARGED PLAN AT SOUTHEAST CORNER
SCALE: 3/4" = 1'-0"

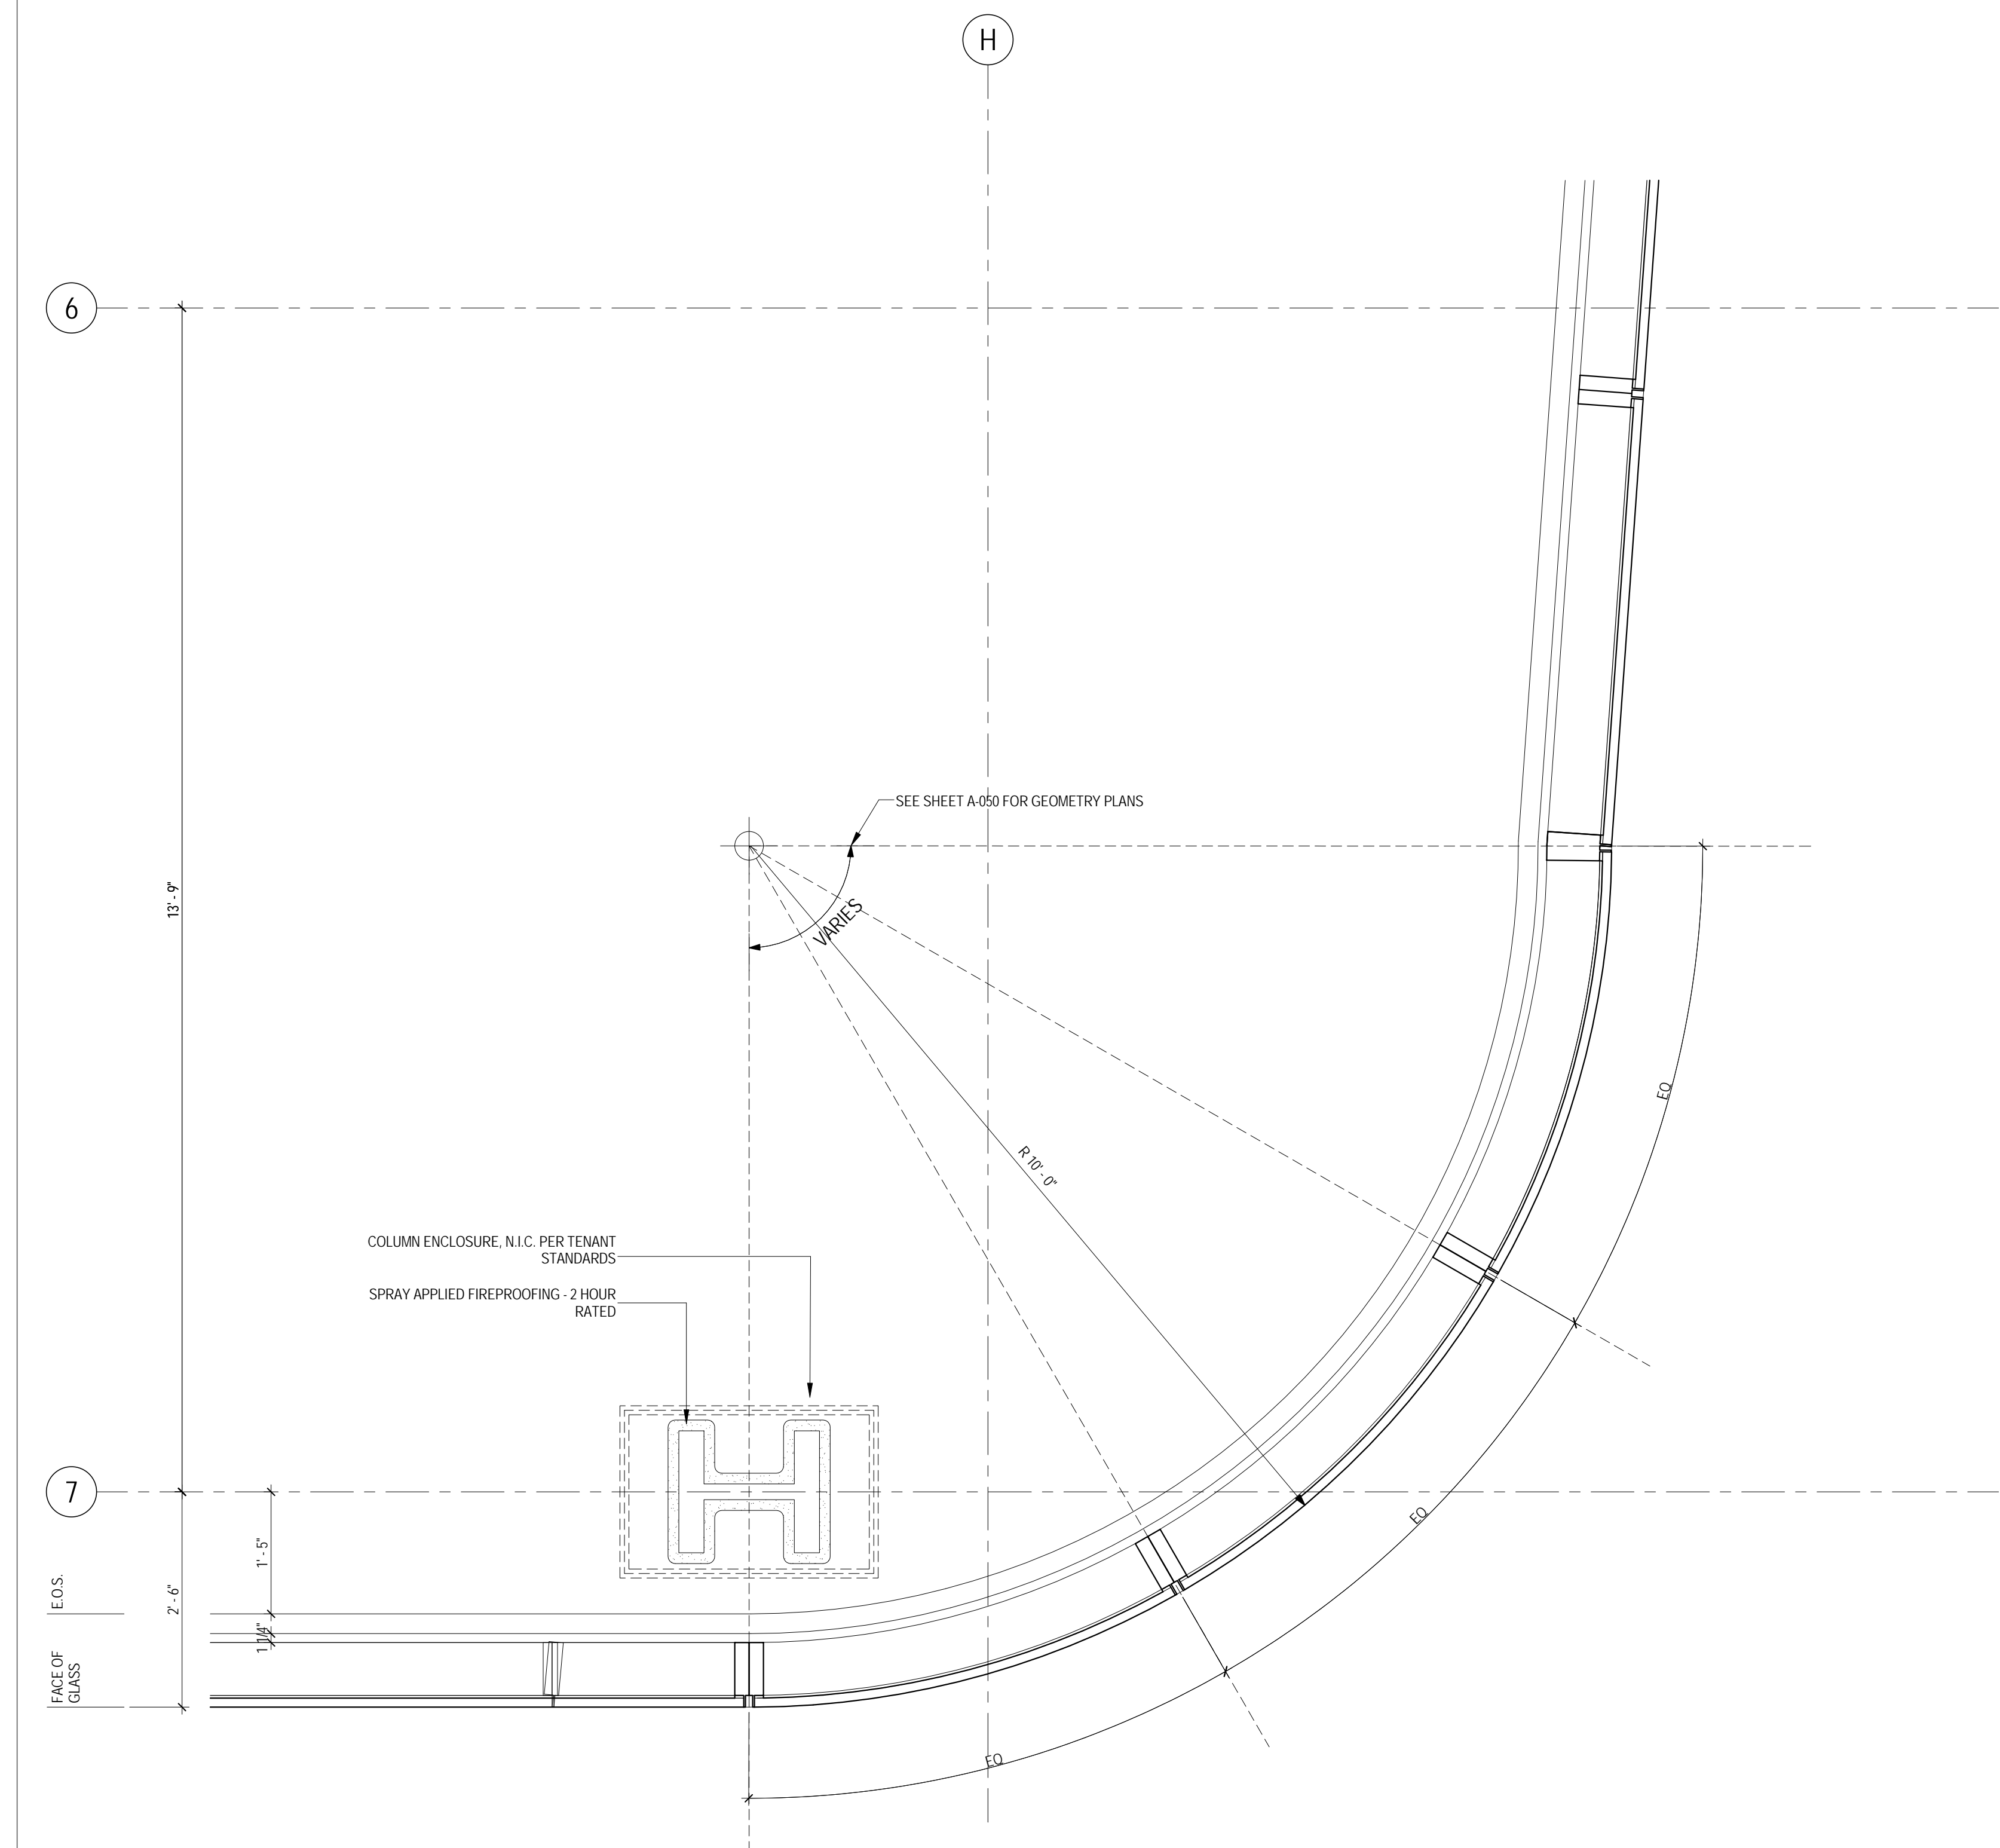

1 ENLARGED PLAN AT SOUTHEAST CORNER
SCALE: 3/4" = 1'-0"

SHEET NOTES

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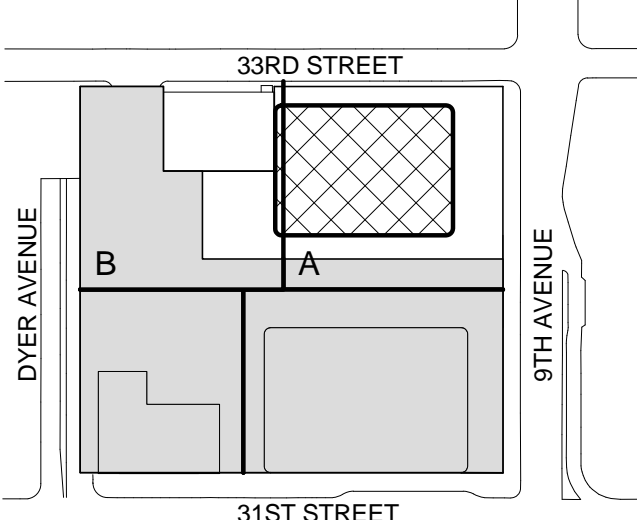
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Wilson, Uhrig & Associates, Inc.
65 Broadway, Suite 401, New York, NY 10006


Code Consultant
Code Consultants Professional Engineers PC
215 West 40th Street, 15th Floor, New York, NY 10018

Facade Maintenance Consultant
Entek Engineering LLC
166 Ames Street, Hackensack, NJ 07601

Wind Tunnel Consultant
Rowan Williams Davies & Irwin Inc.
650 Woodlawn Road West, Guelph Ontario, Canada N1K 1B6

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Key Plan:


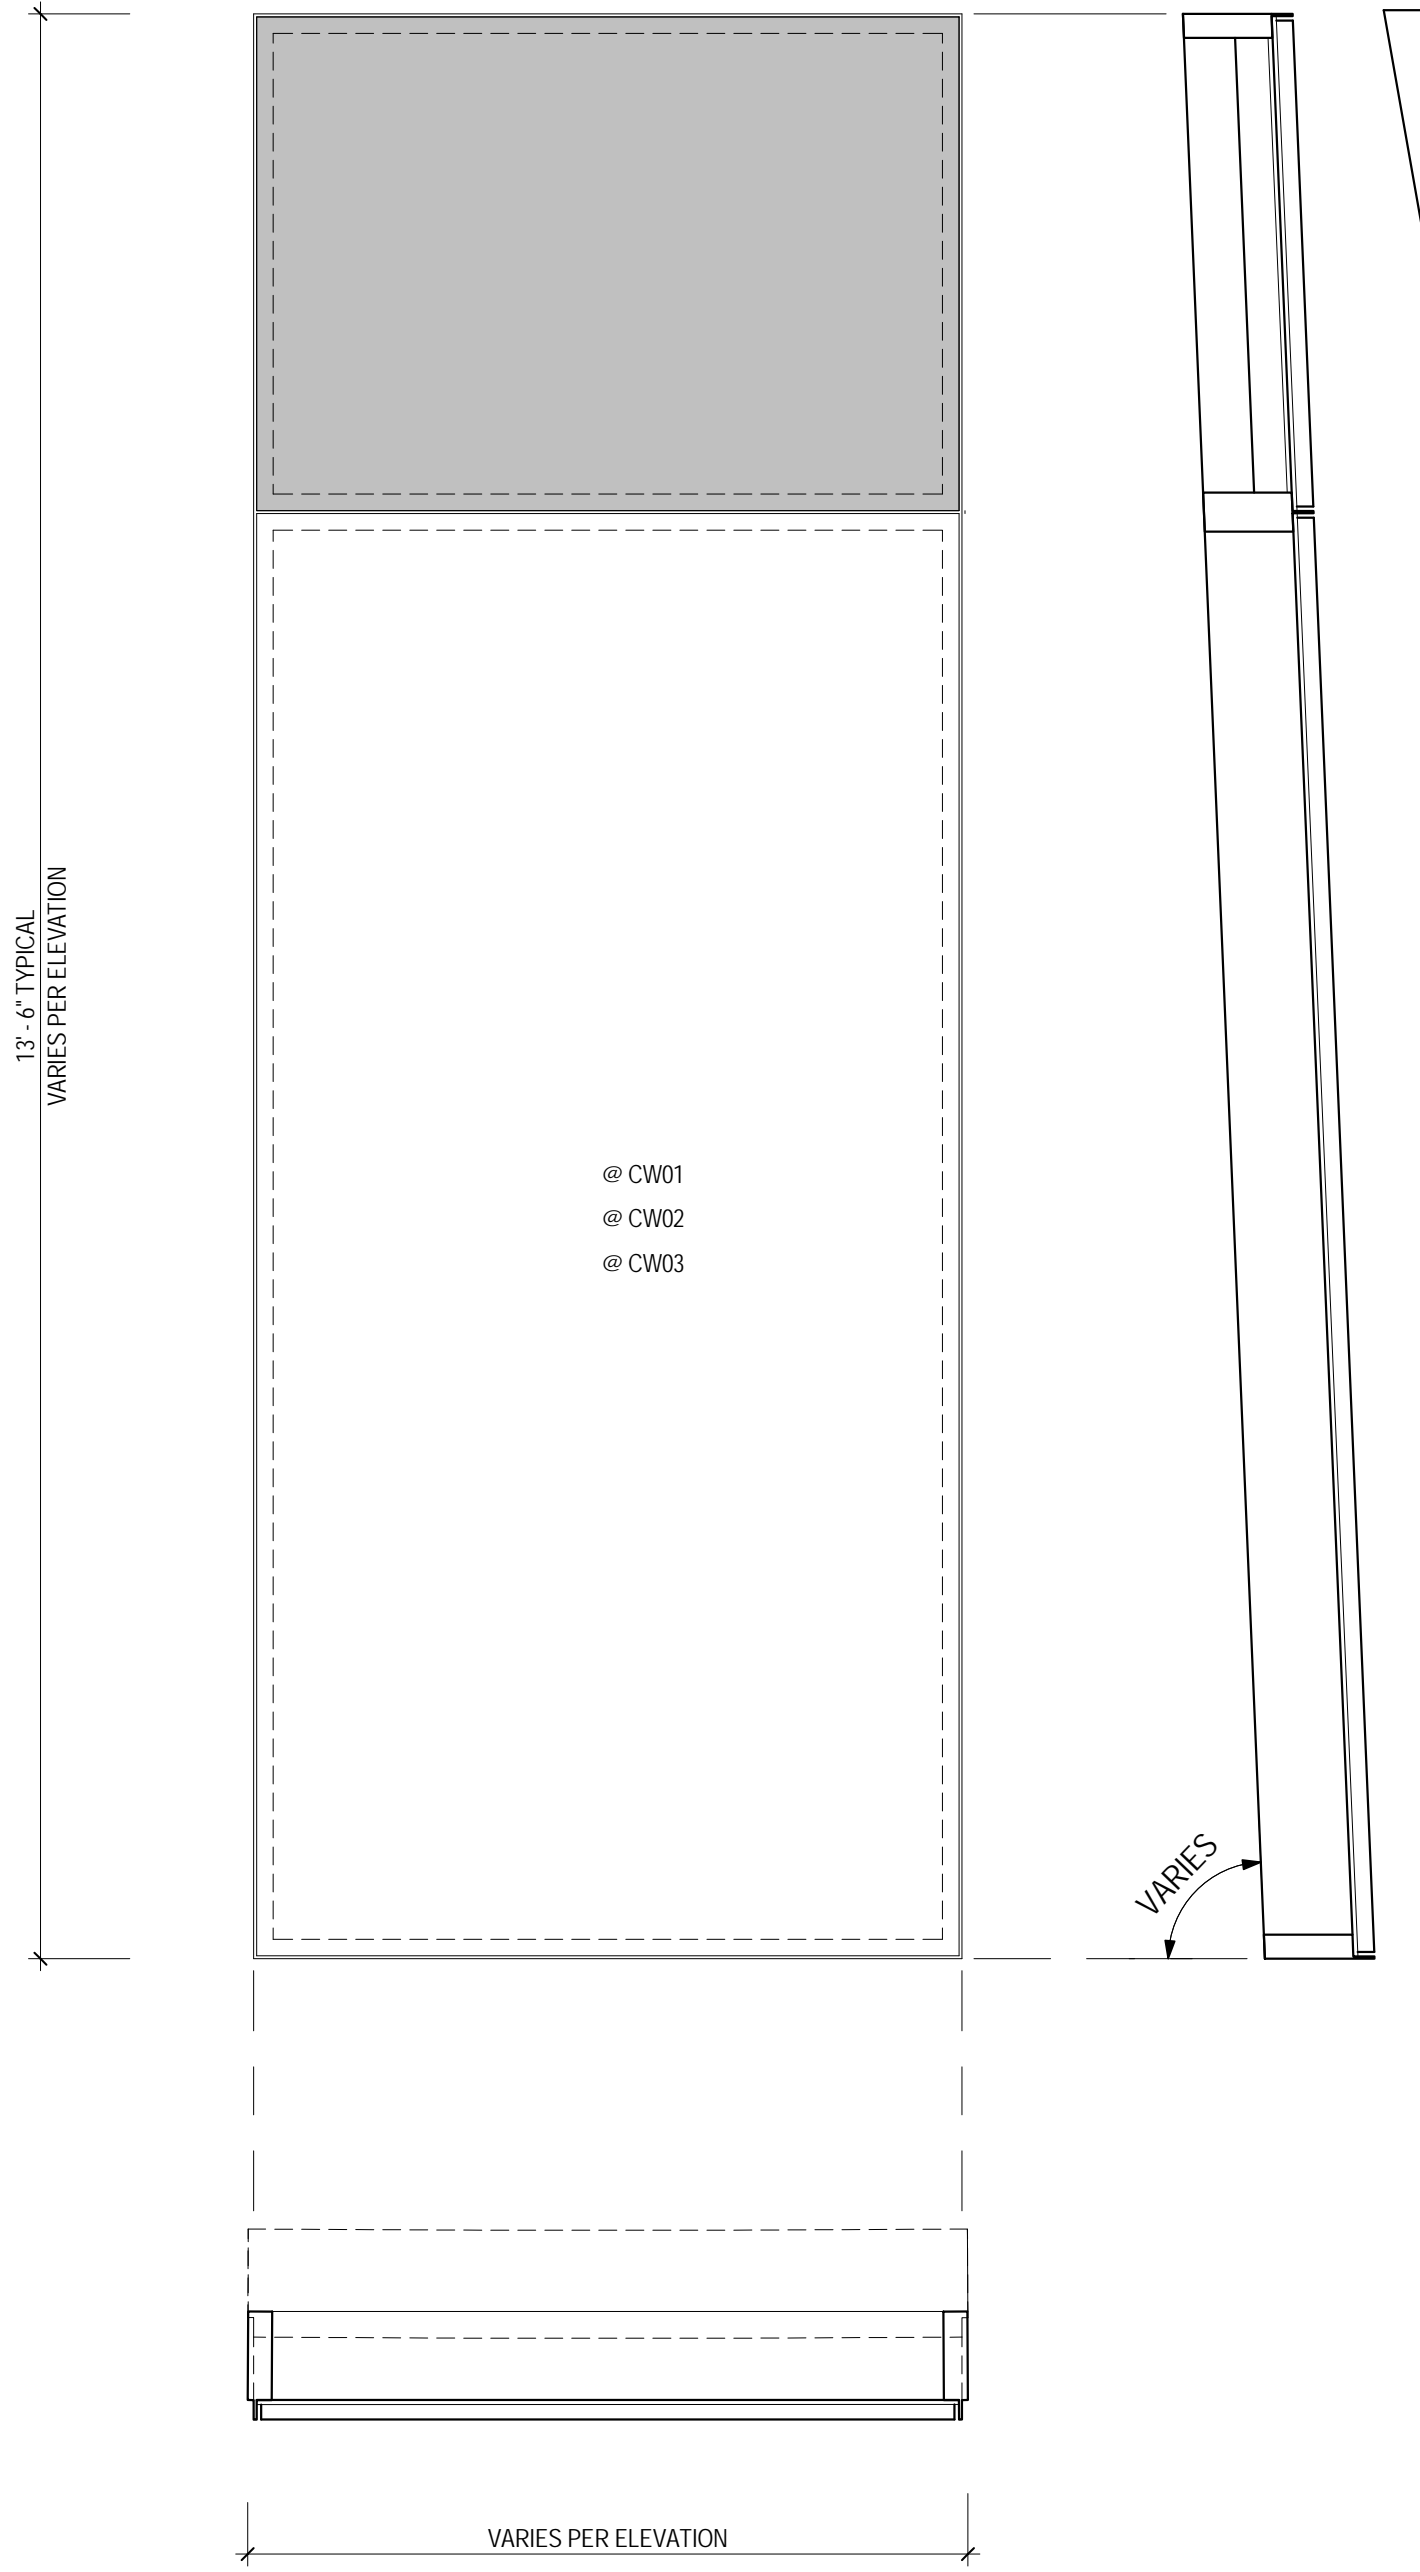
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Sheet Name:
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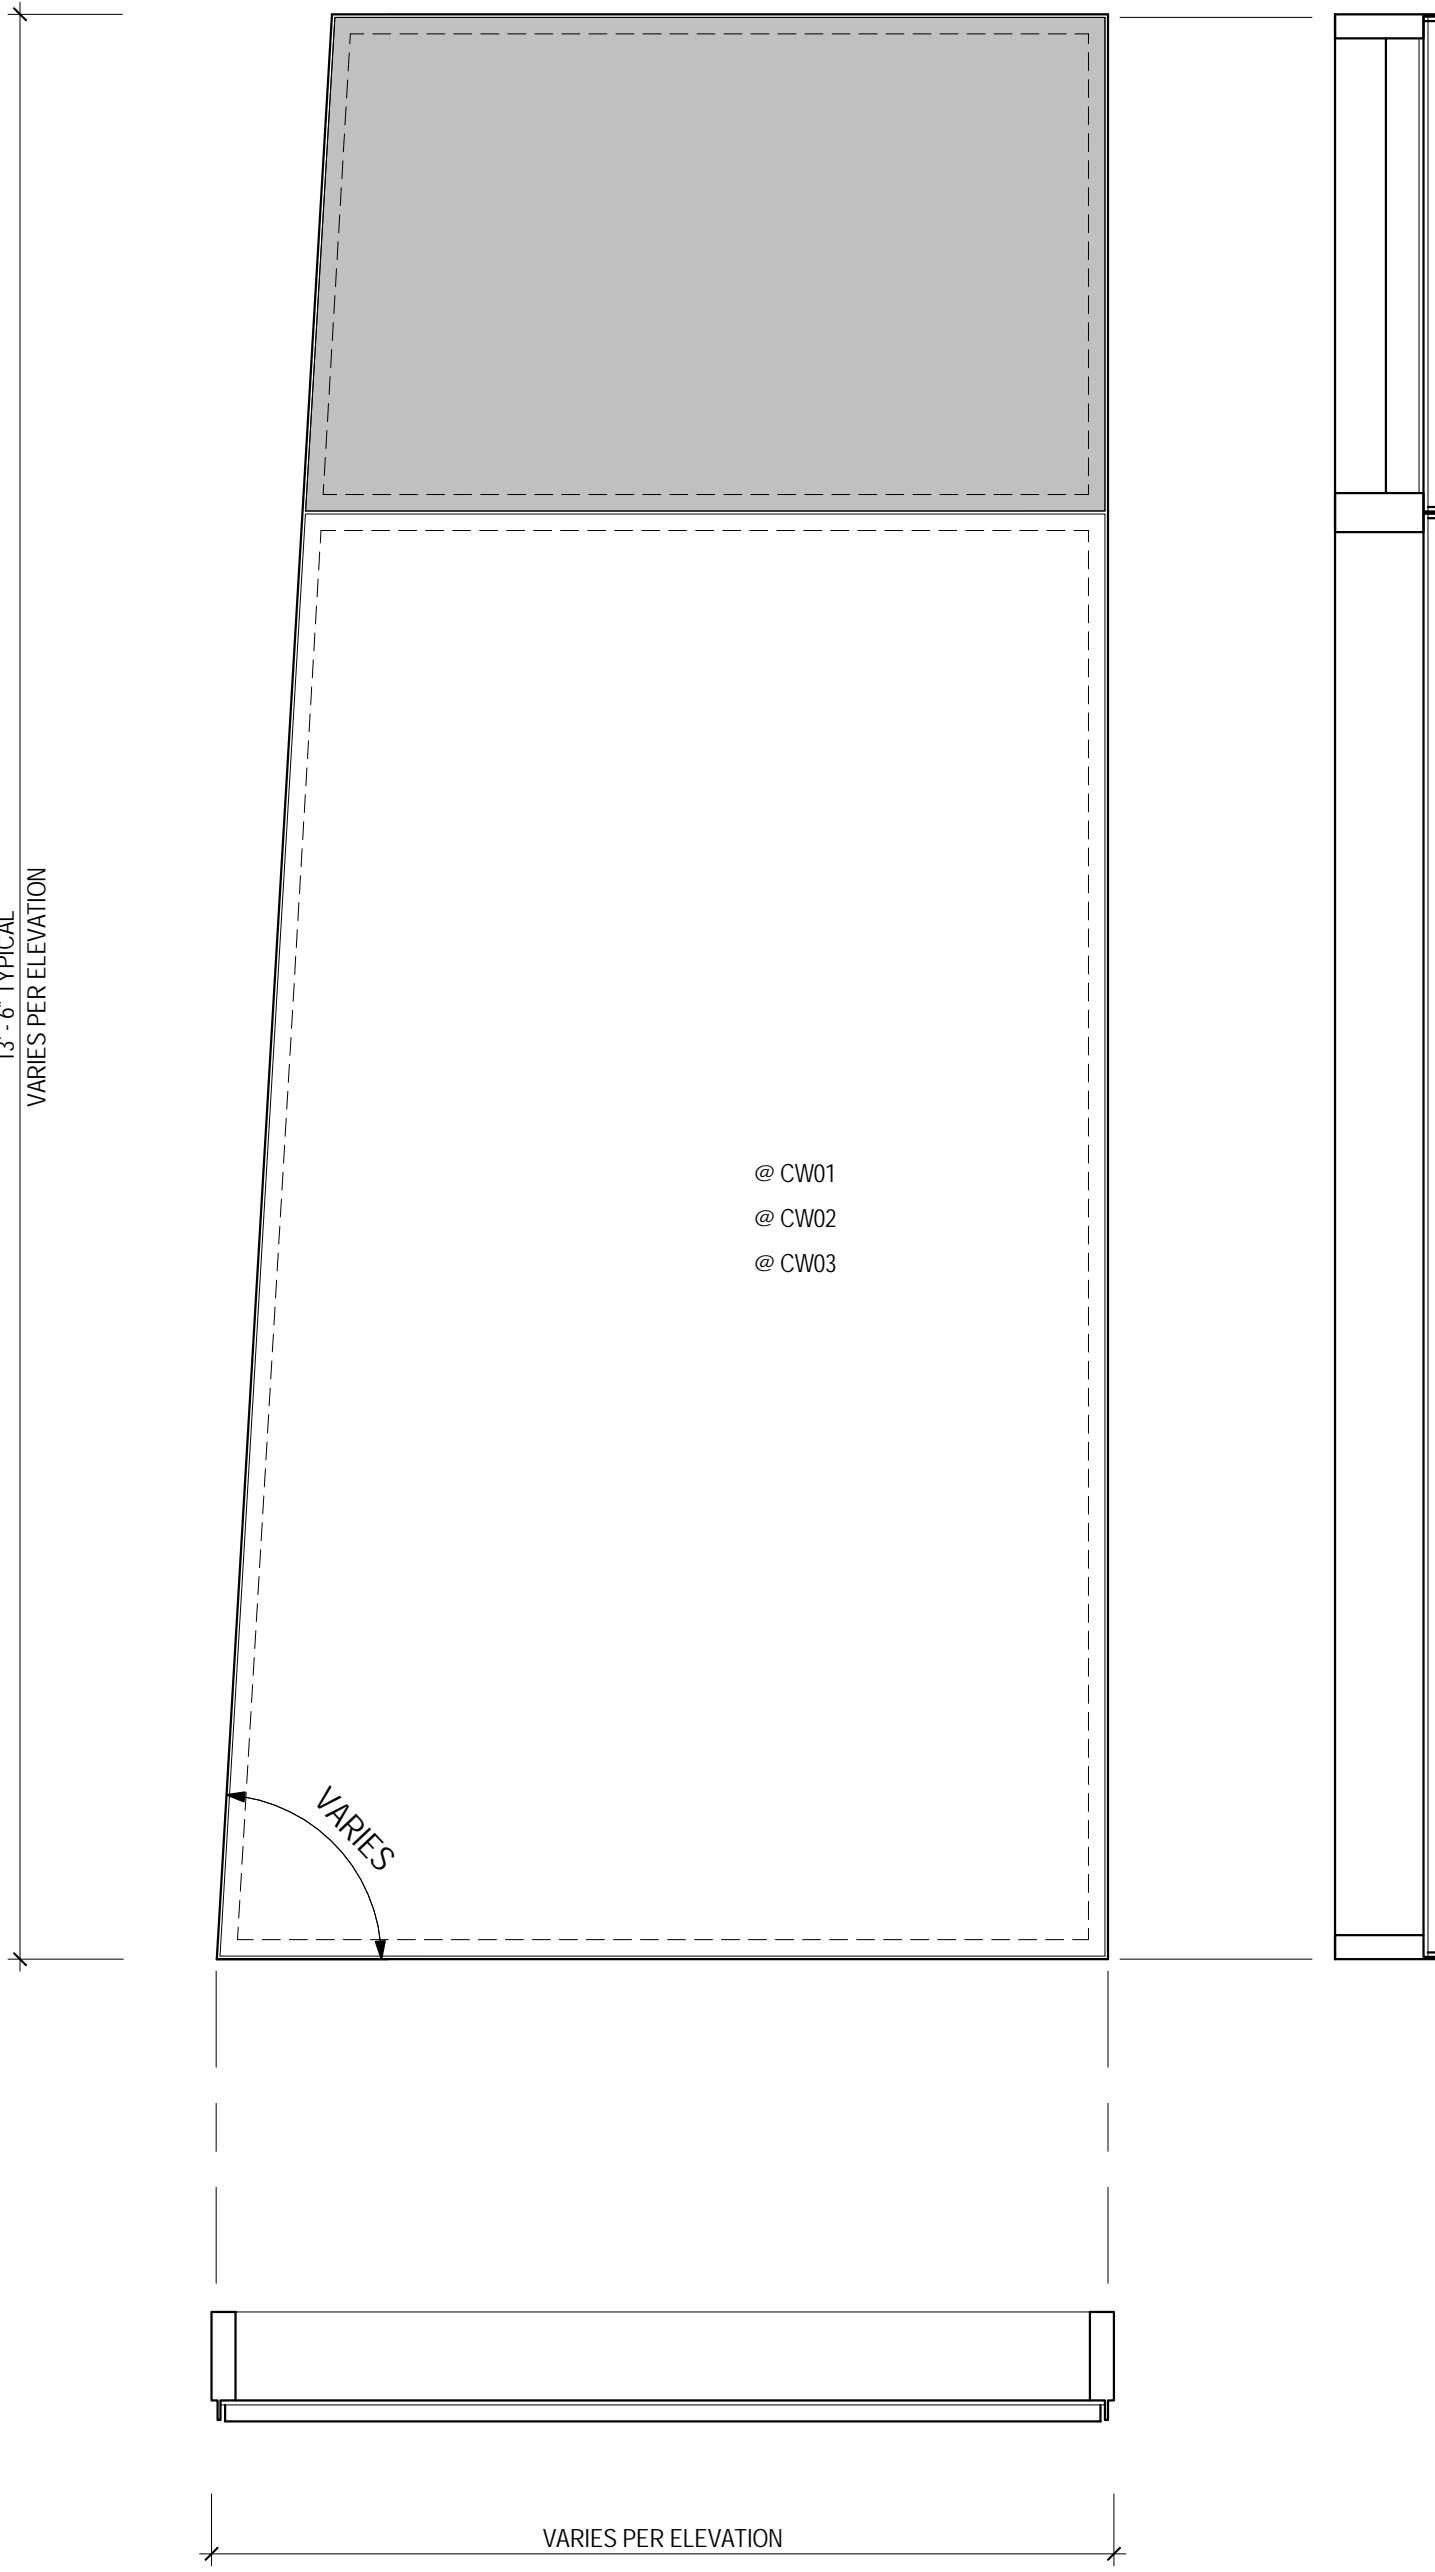
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207150	A-537.00
Date: 12 SEPT 2014	Sheet No.:
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File No.:	Page No.: 30

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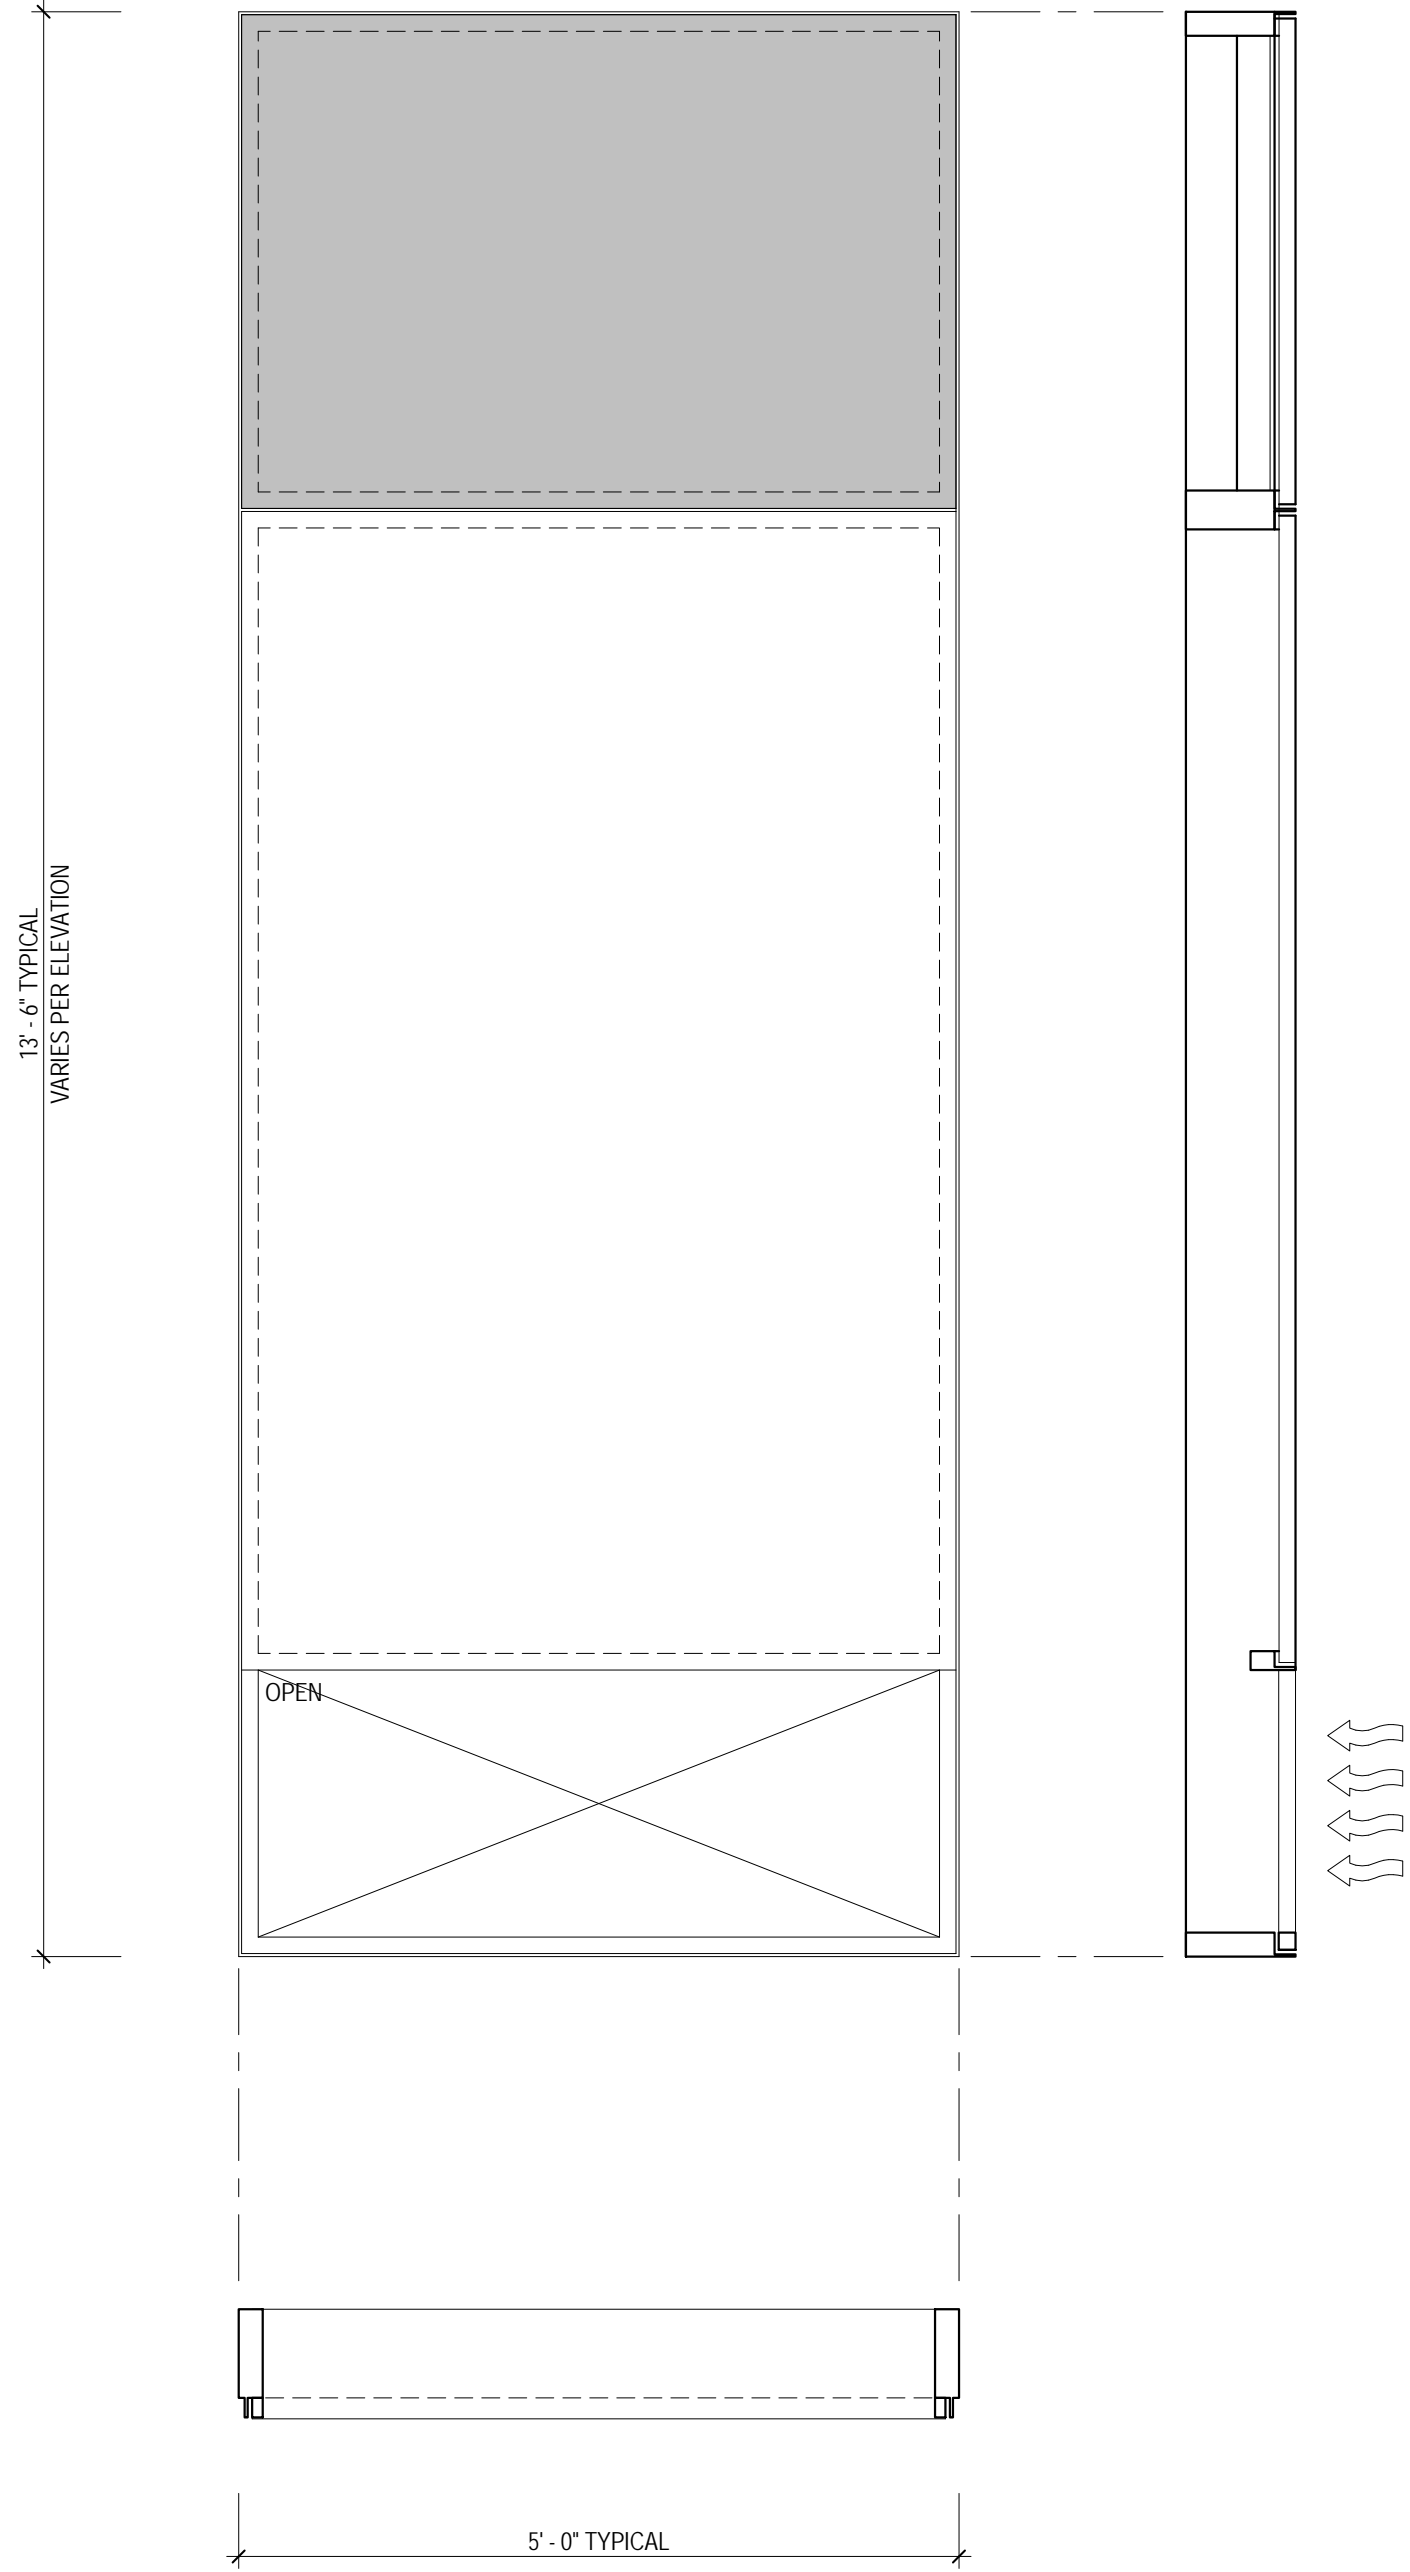
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* REFER TO A550 AND A551 FOR PLAN PROFILES

6 GEOMETRY W PANEL (WARPED)
SCALE: 3/4" = 1'-0"




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4 GEOMETRY T PANEL (TRAPEZOIDAL)
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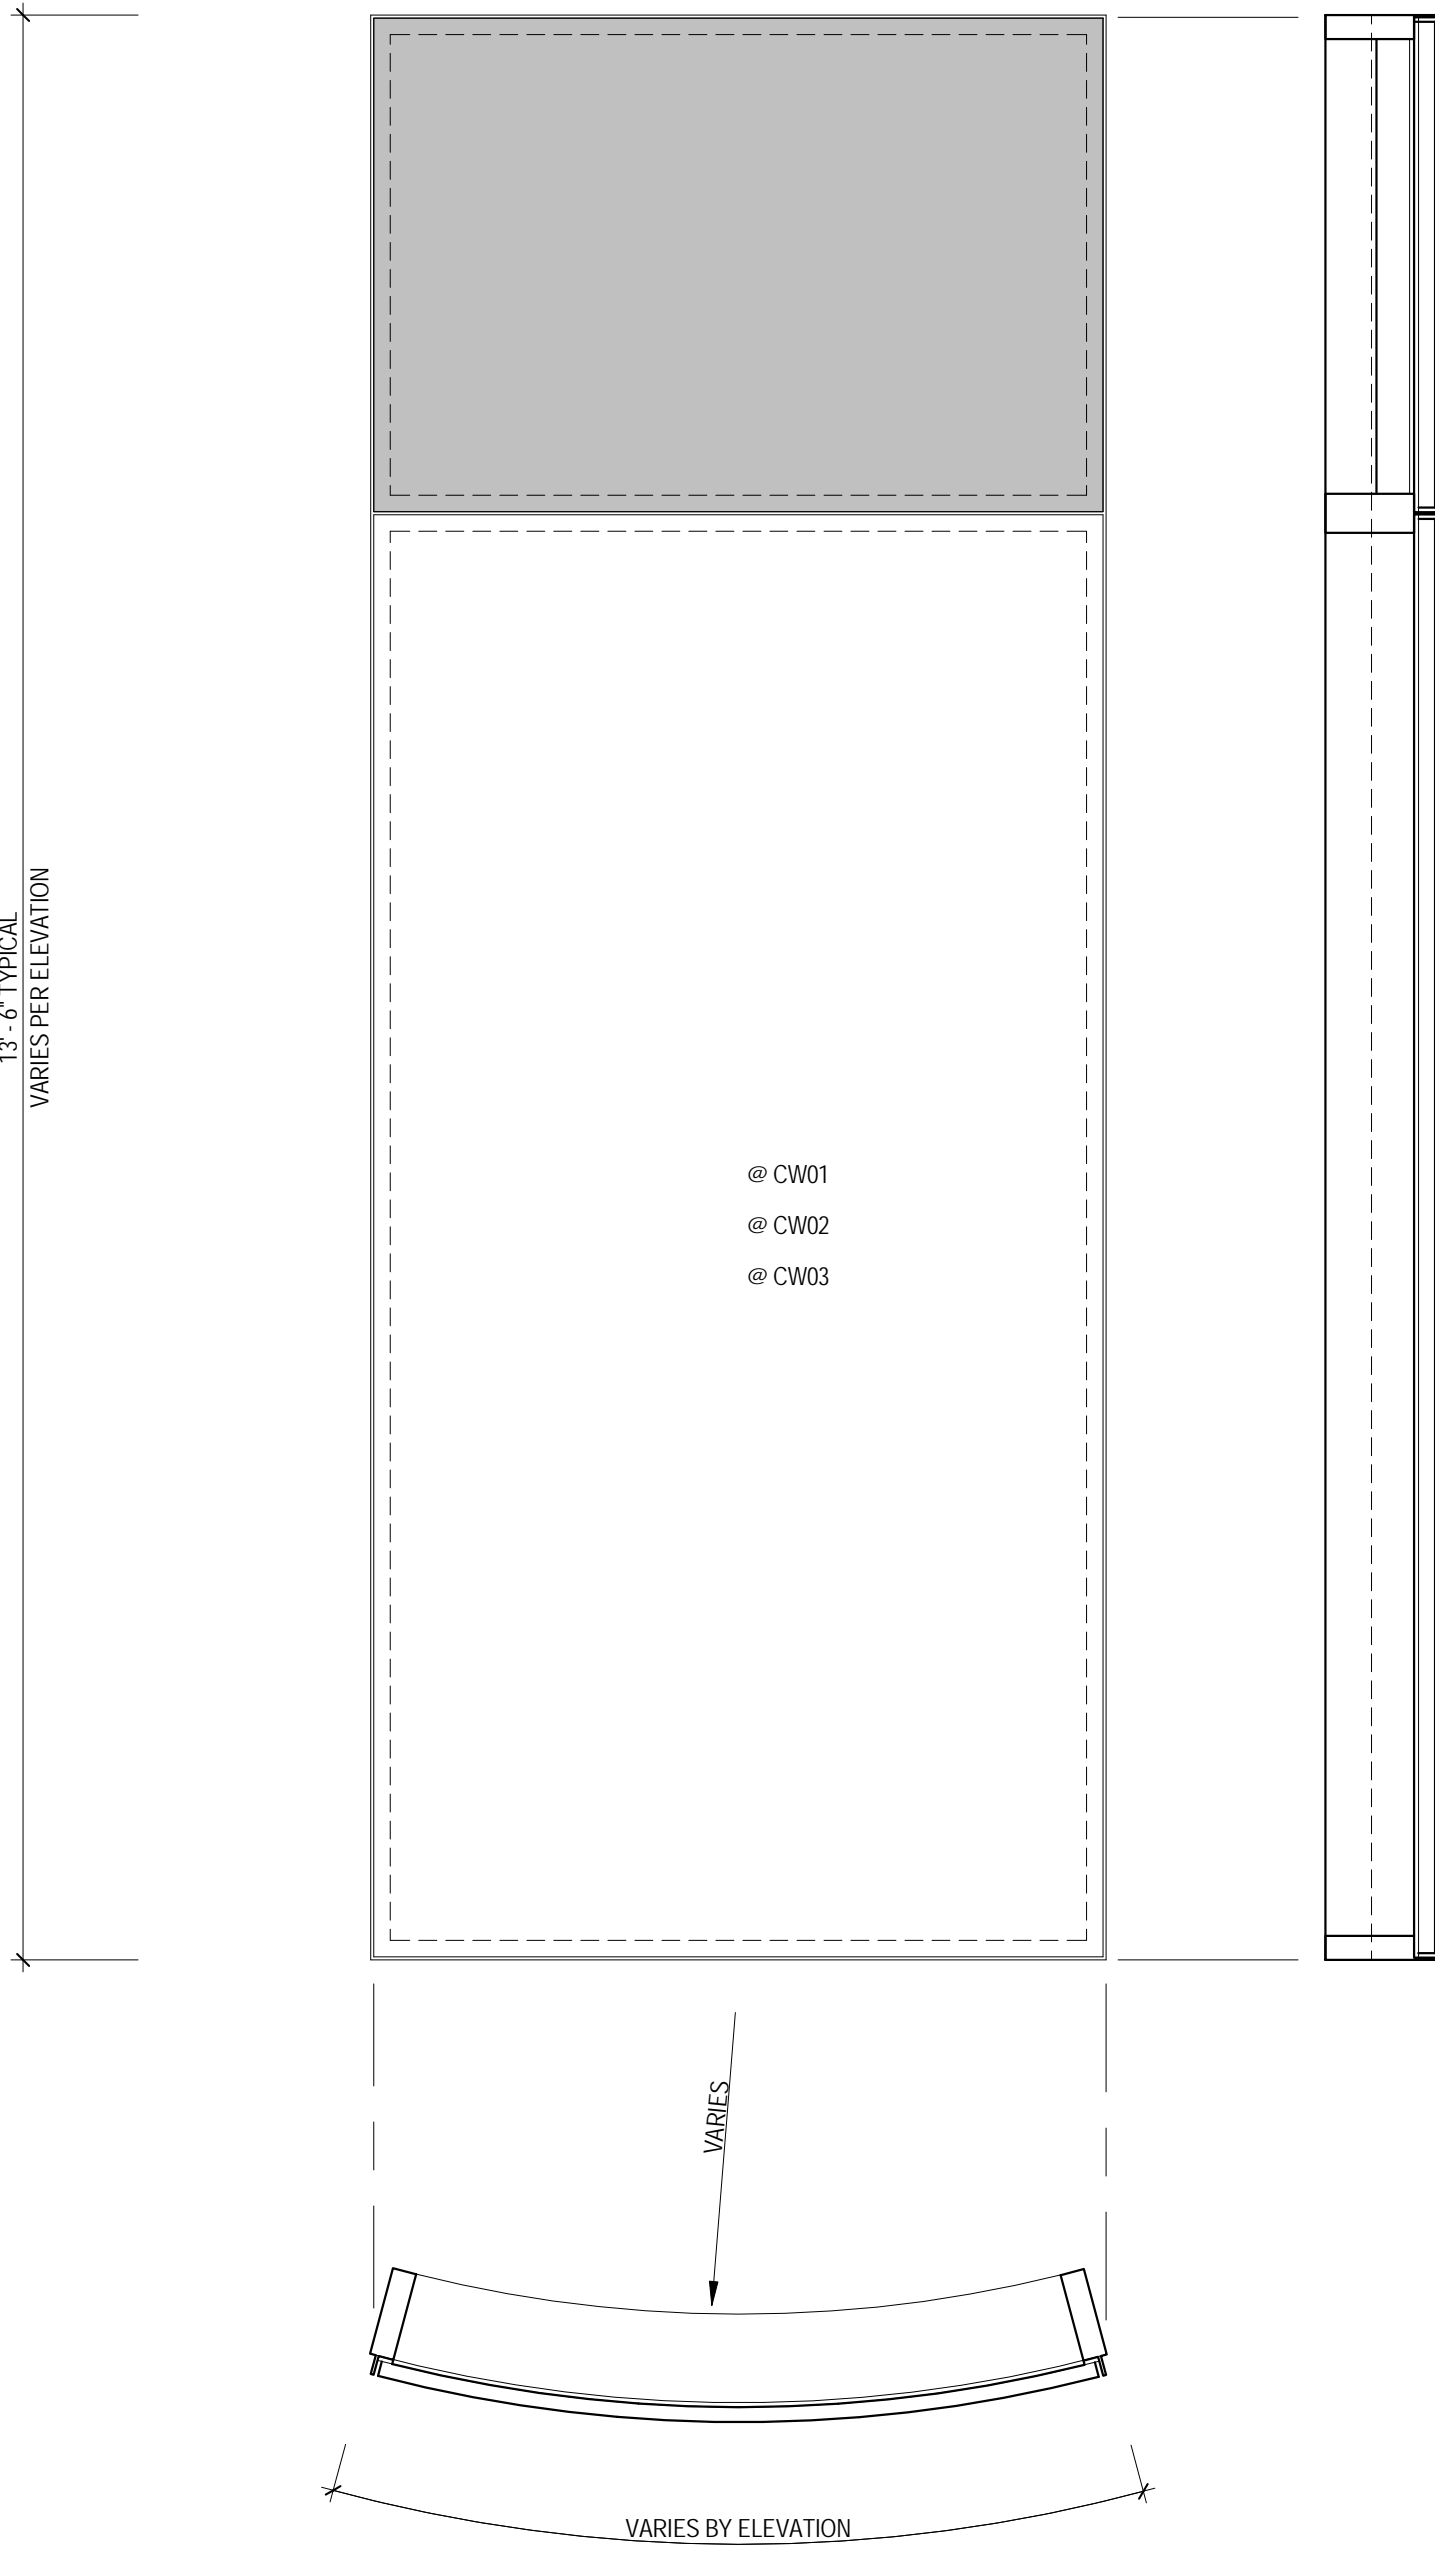


2 GEOMETRY A PANEL (FLAT - AIR SLOT)
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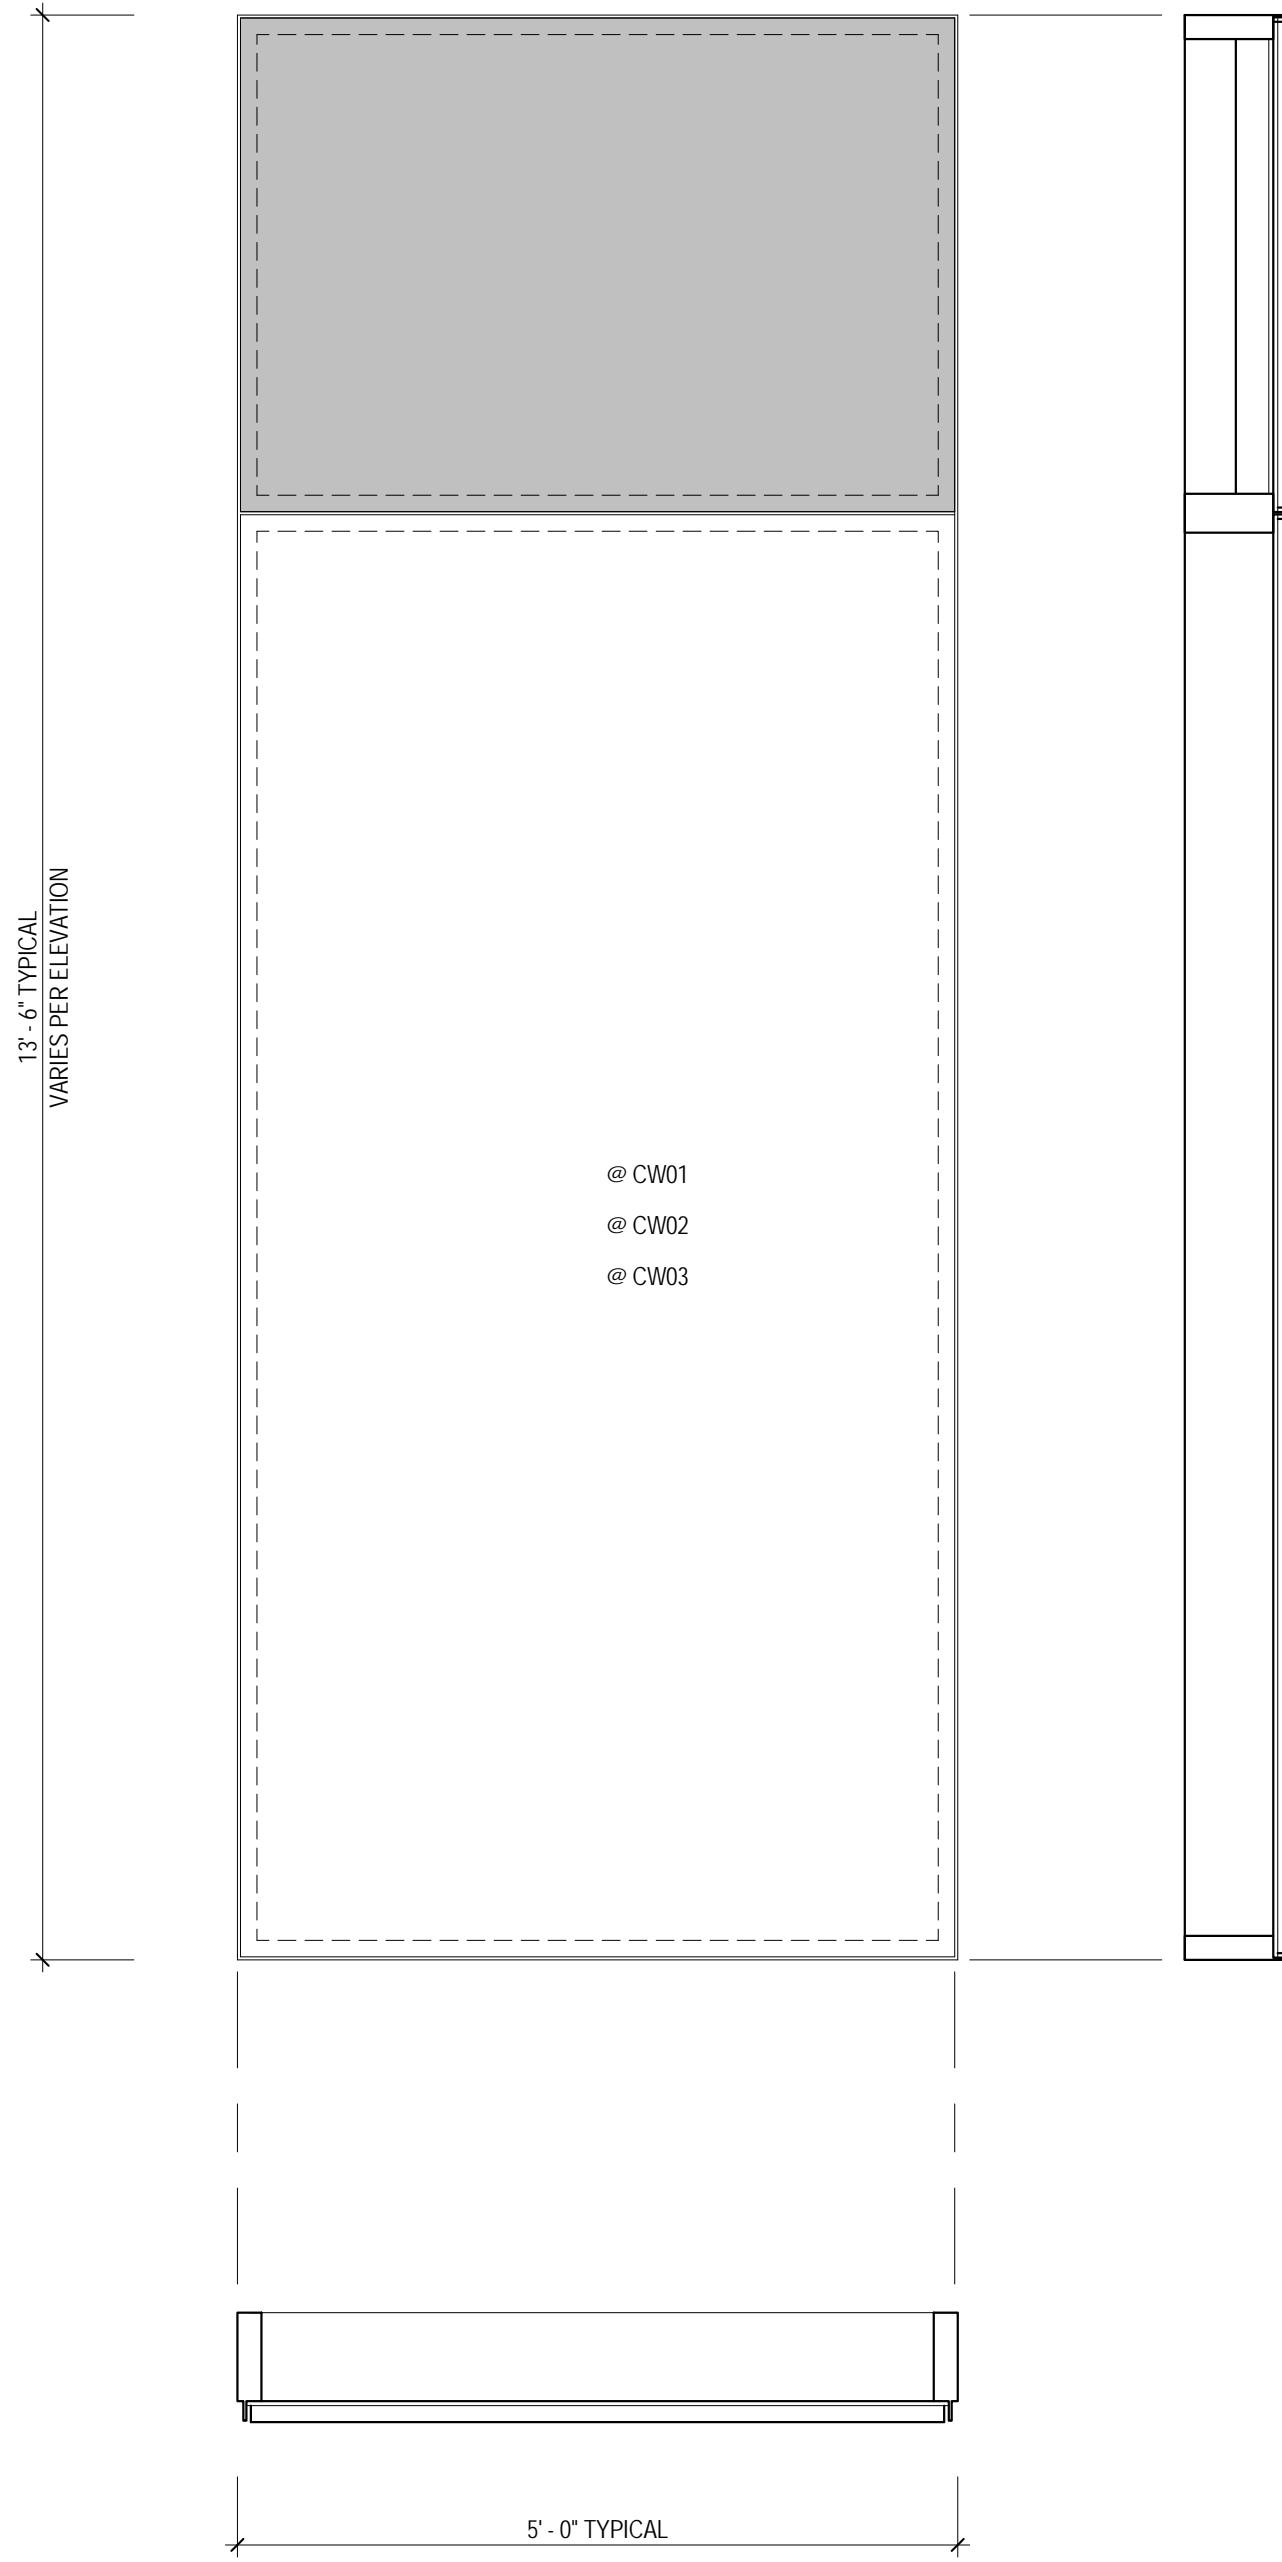
* REFER TO A550 AND A551 FOR PLAN PROFILES

5 GEOMETRY C2 PANEL (THERMALLY CURVED WARPED)
SCALE: 3/4" = 1'-0"

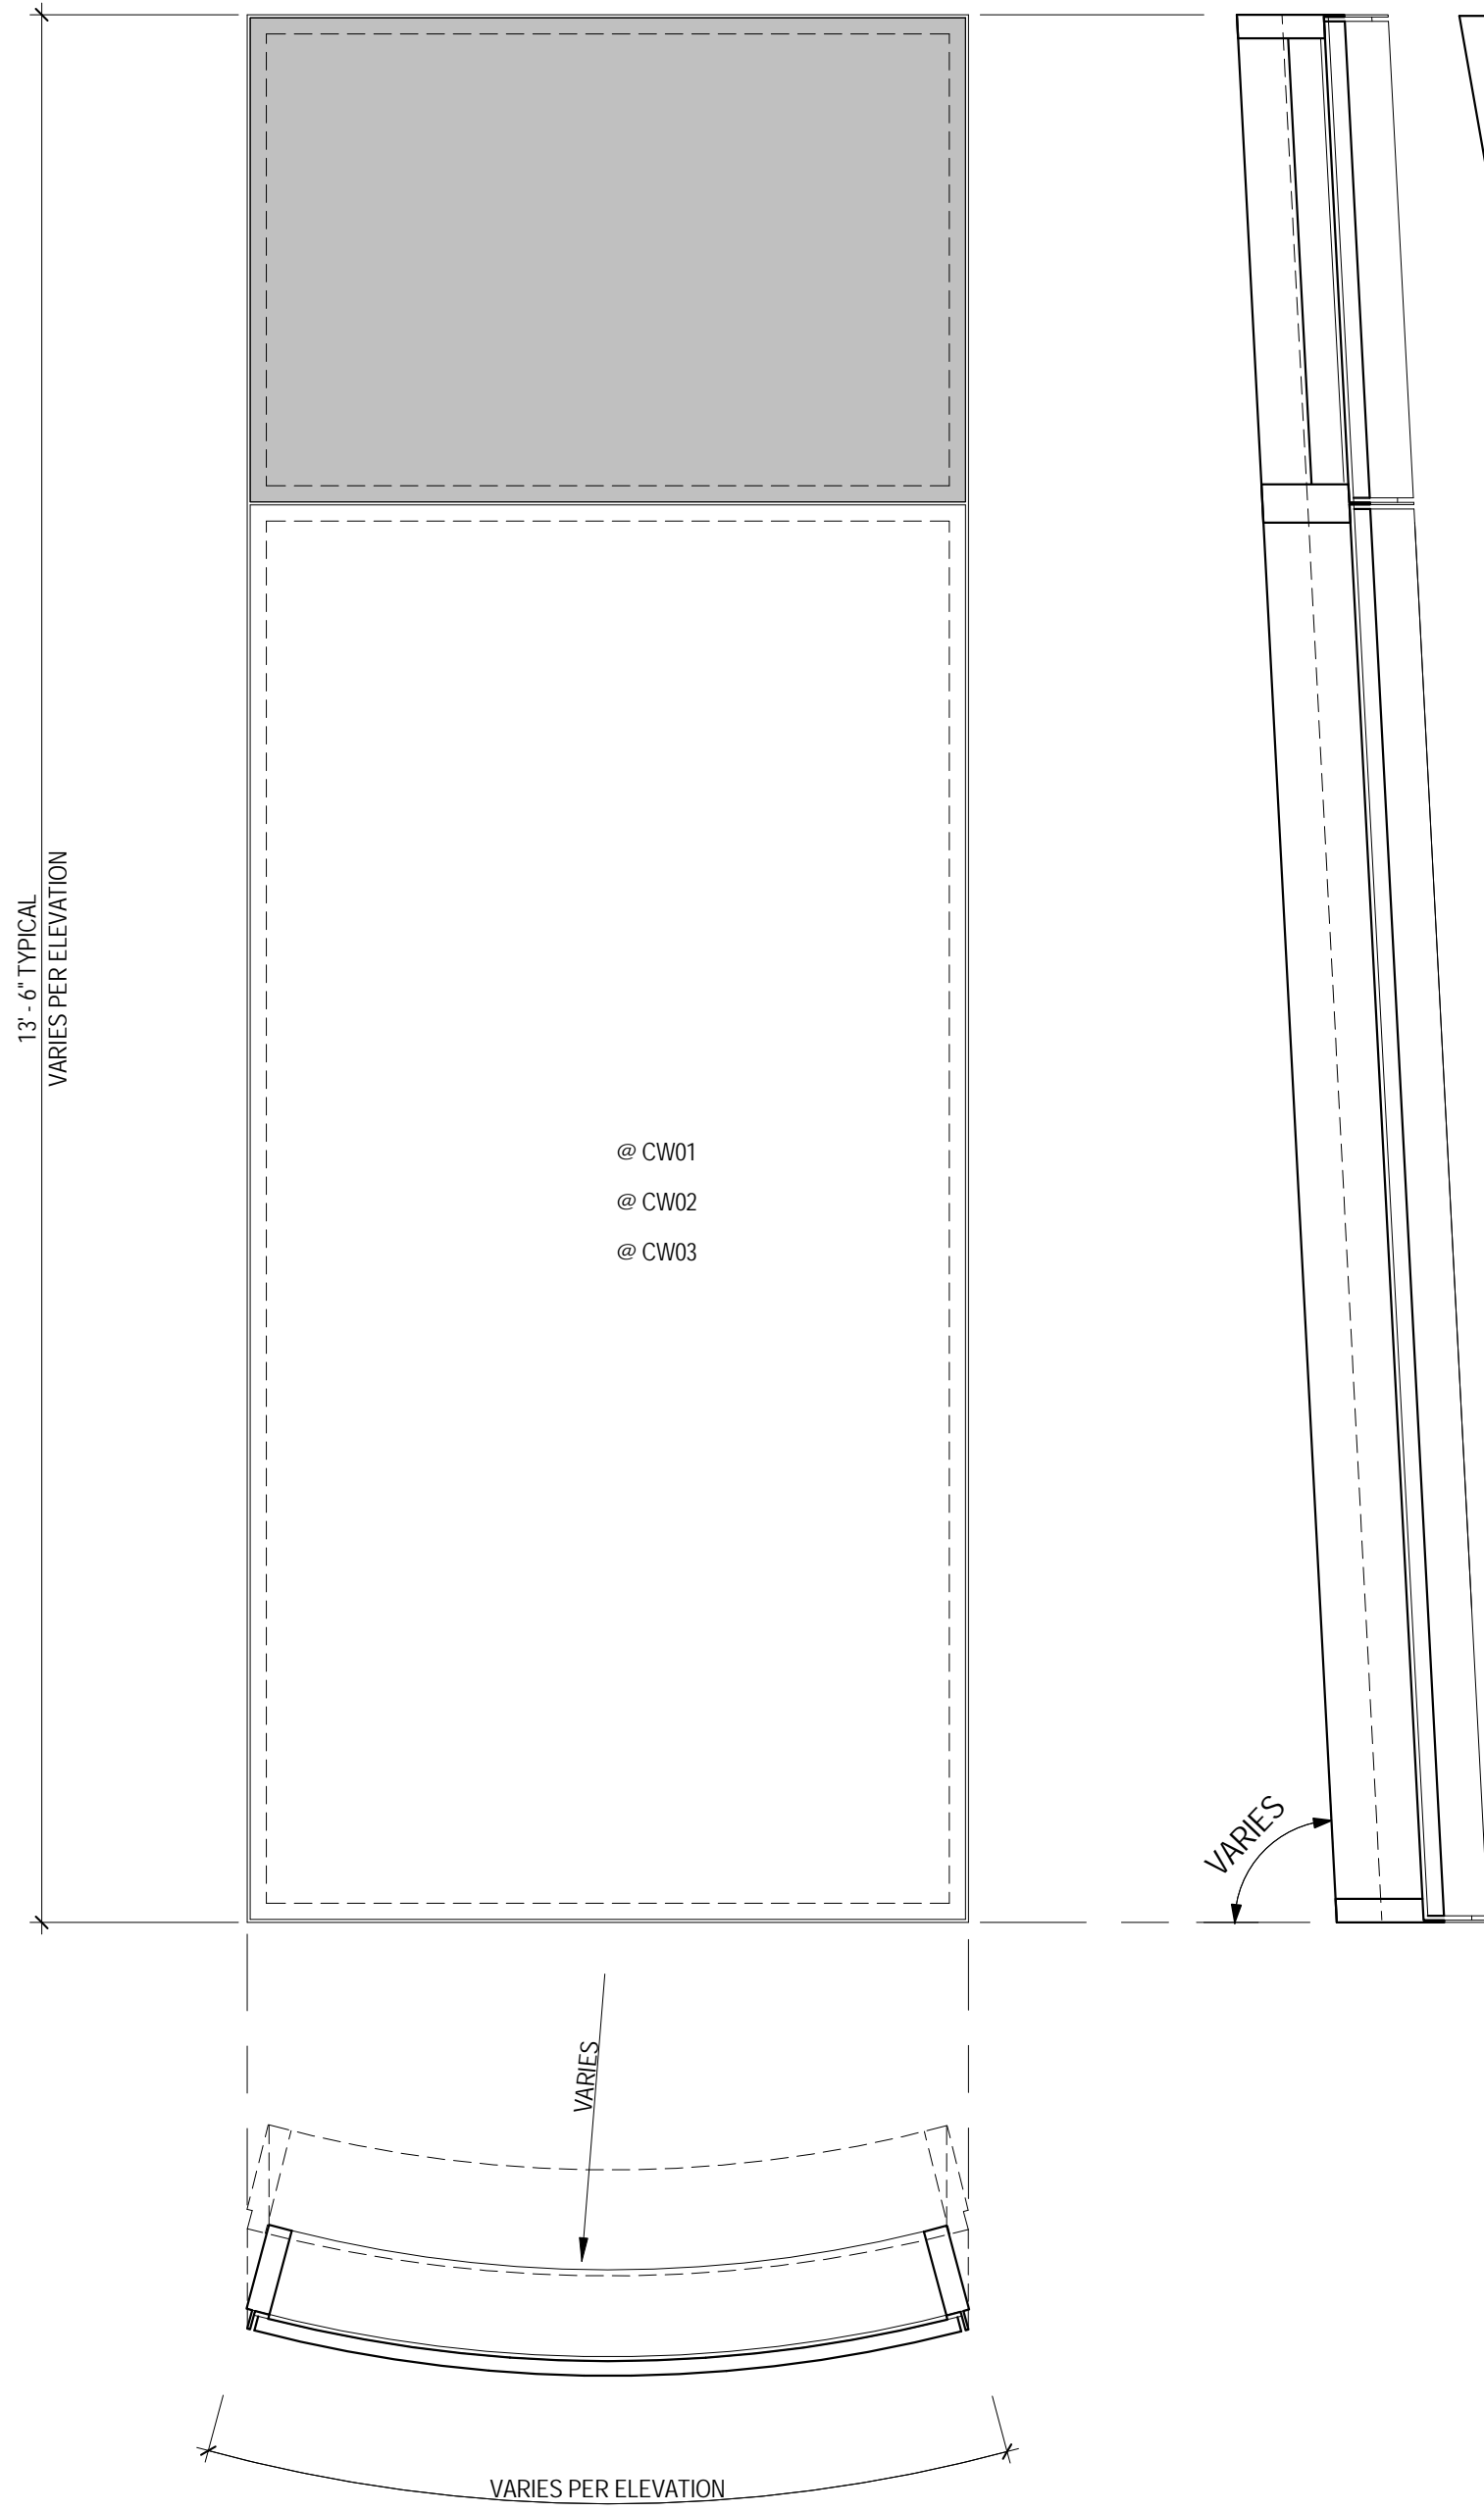

* REFER TO A550 AND A551 FOR PLAN PROFILES

3 GEOMETRY C1 PANEL (THERMALLY WARPED)
SCALE: 3/4" = 1'-0"



1 GEOMETRY F PANEL (FLAT)
SCALE: 3/4" = 1'-0"

Sheet No. 2187143



MANHATTAN WEST:
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375 Ninth Avenue, New York, NY 10001
Client

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Brookfield Place
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Skidmore, Owings & Merrill LLP
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Edgett Williams Consulting Group, Inc.
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Viridian Energy & Environmental
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Mueser Rutledge Consulting Engineers
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Weidinger Associates, Inc.
40 Wall Street, New York, NY 10005

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Cerami & Associates
404 Fifth Avenue #B, New York, NY 10016

Vibration Consultant
Wilson, Uhrig & Associates, Inc.
65 Broadway, Suite 401, New York, NY 10006


Code Consultant
Code Consultants Professional Engineers PC
215 West 40th Street, 15th Floor, New York, NY 10018

Facade Maintenance Consultant
Entek Engineering LLC
166 Ames Street, Hackensack, NJ 07601

Wind Tunnel Consultant
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Key Plan:



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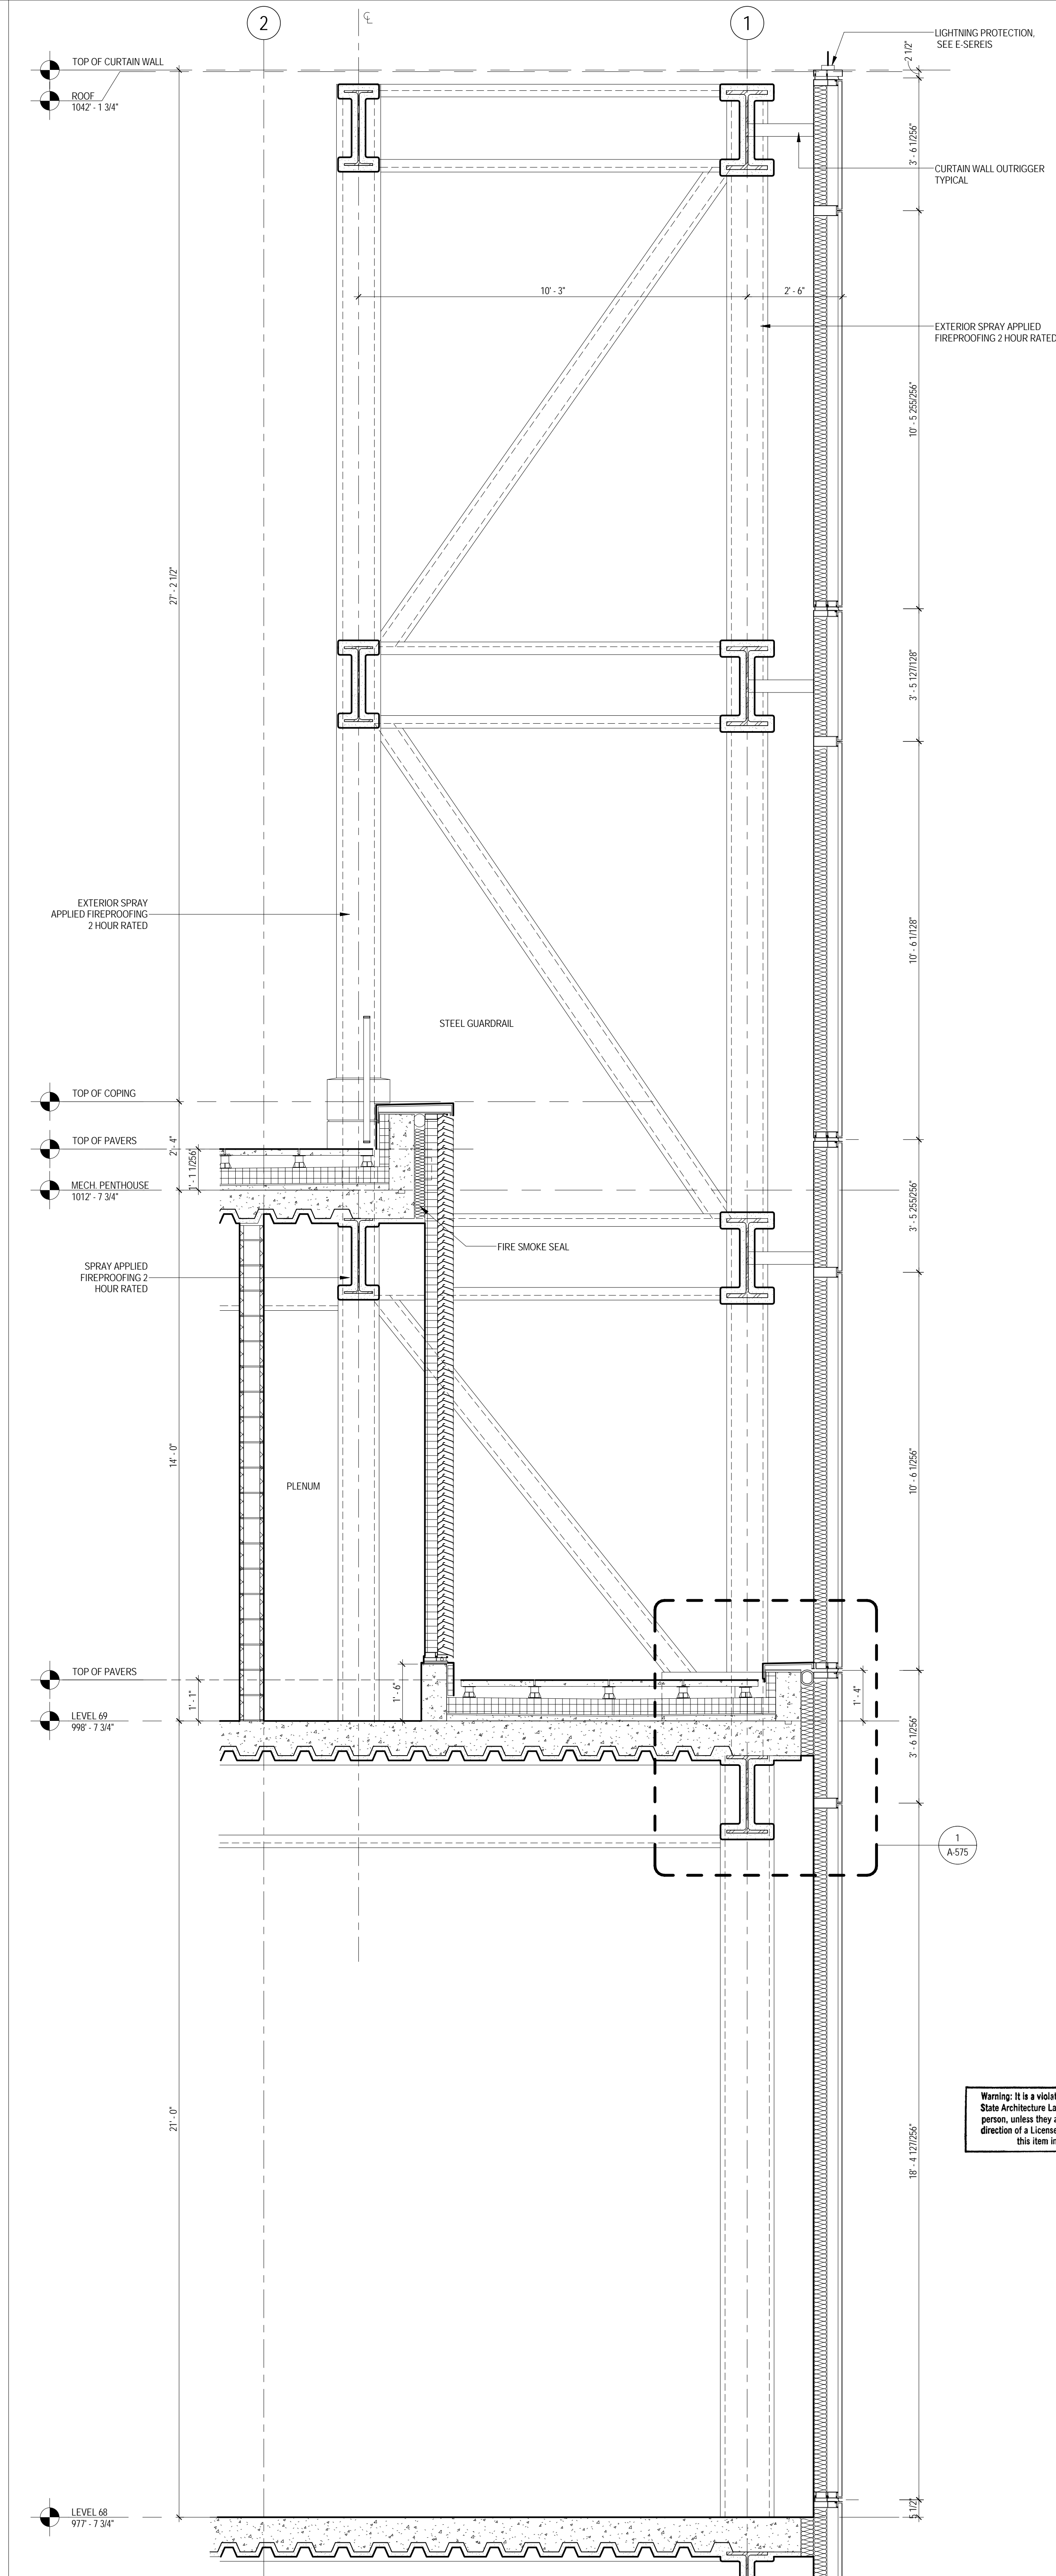
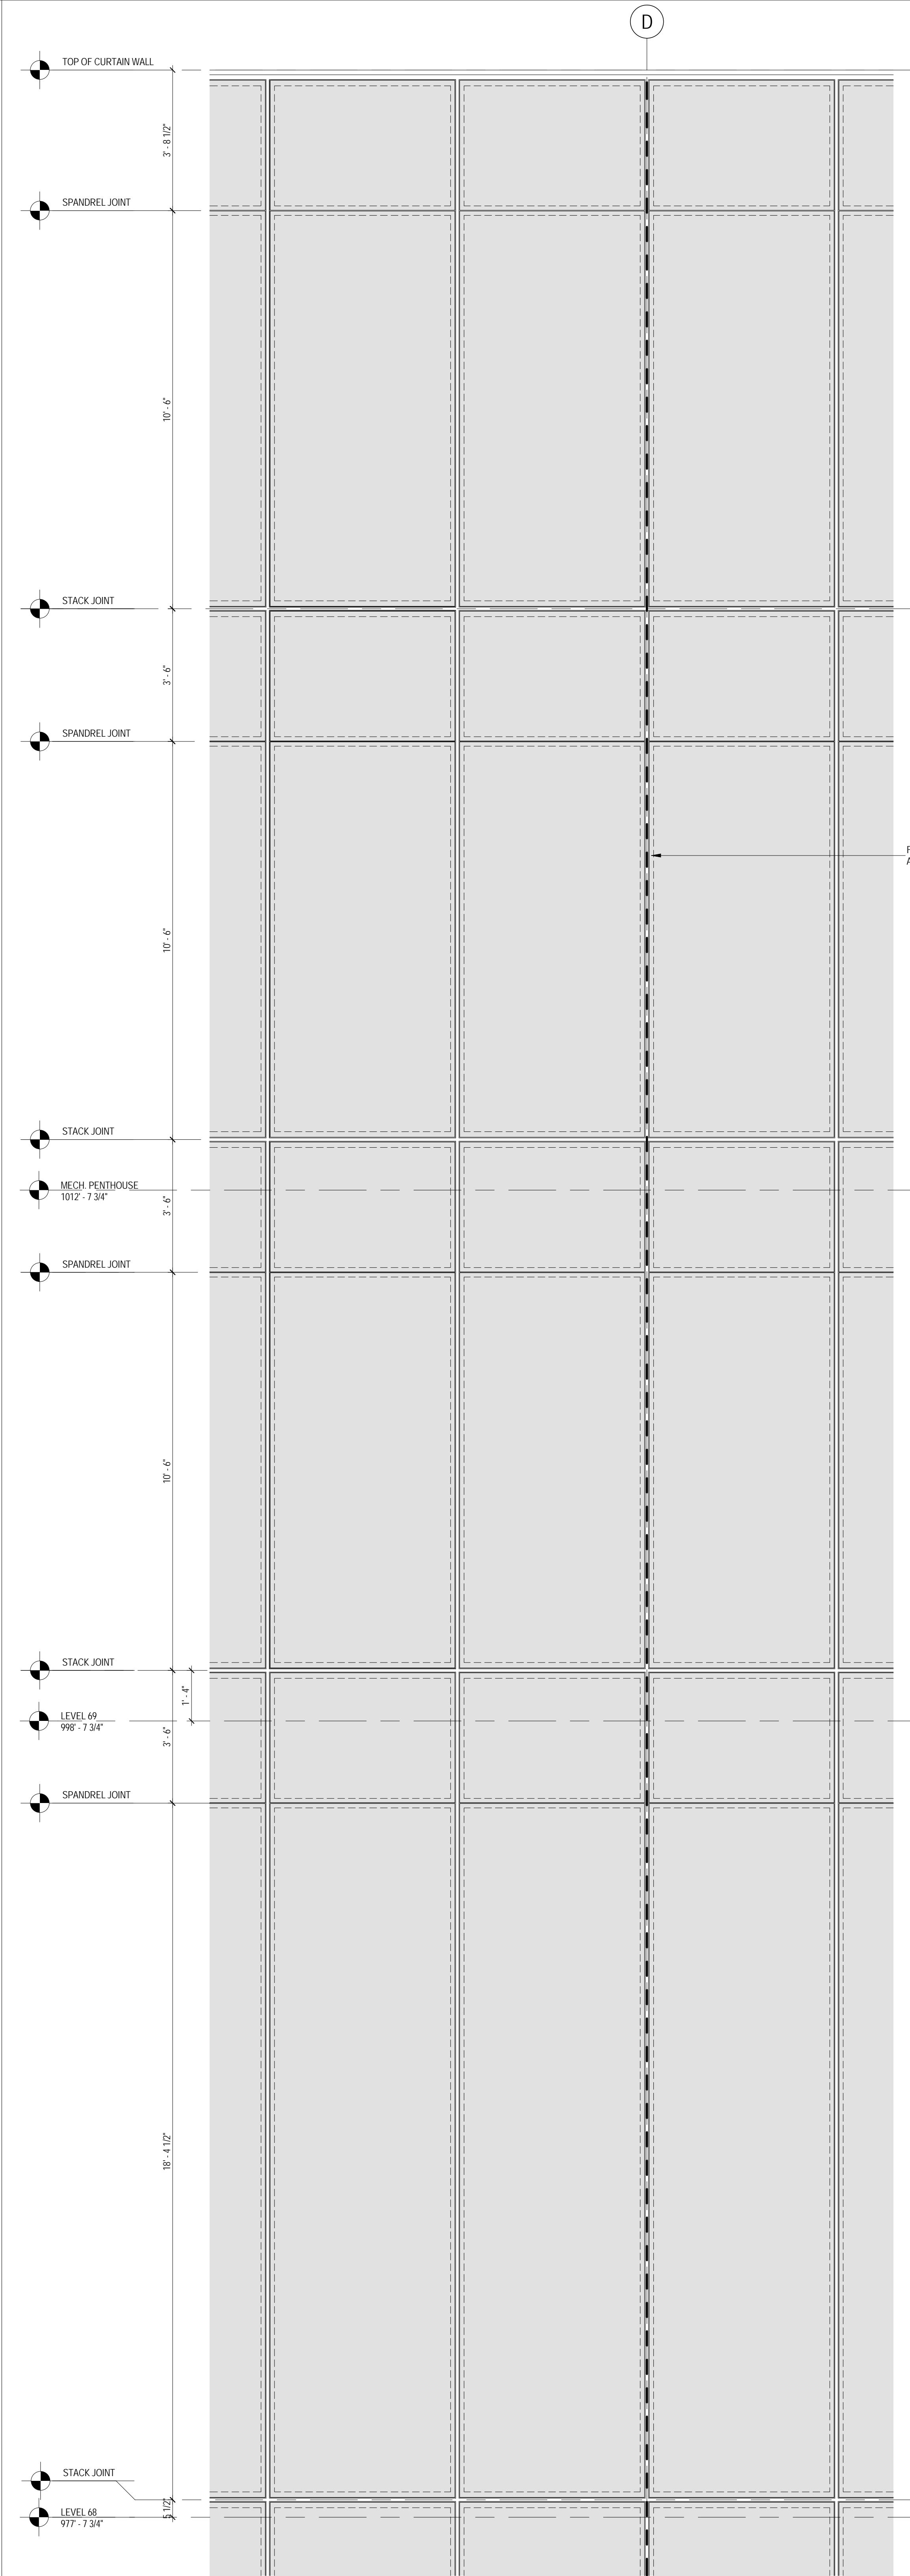
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No. Date Description
Sheet Name:

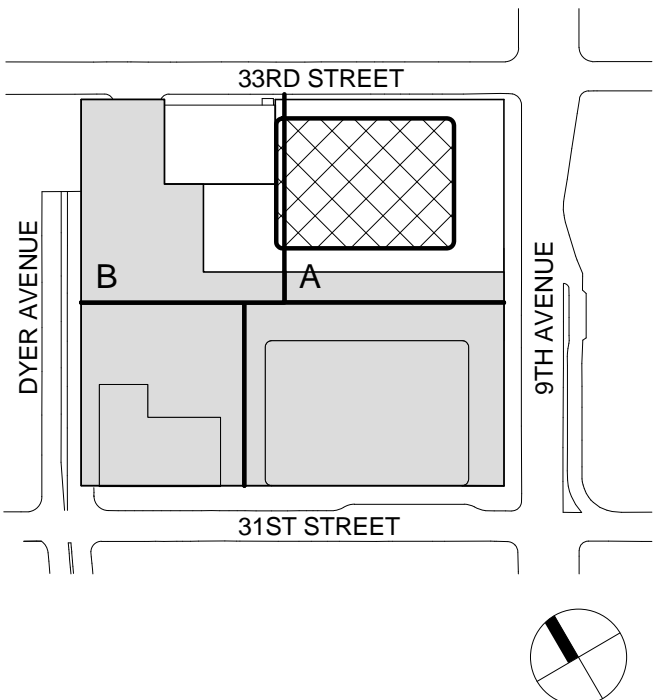PANEL TYPES

Project No.: 207150
Date: 12 SEPT 2014
Scale: 3/4" = 1'-0"
File No.: A-538

B-SCAN Sheet No.: A-538.00
Sheet No.: A-538
Page No.: 30

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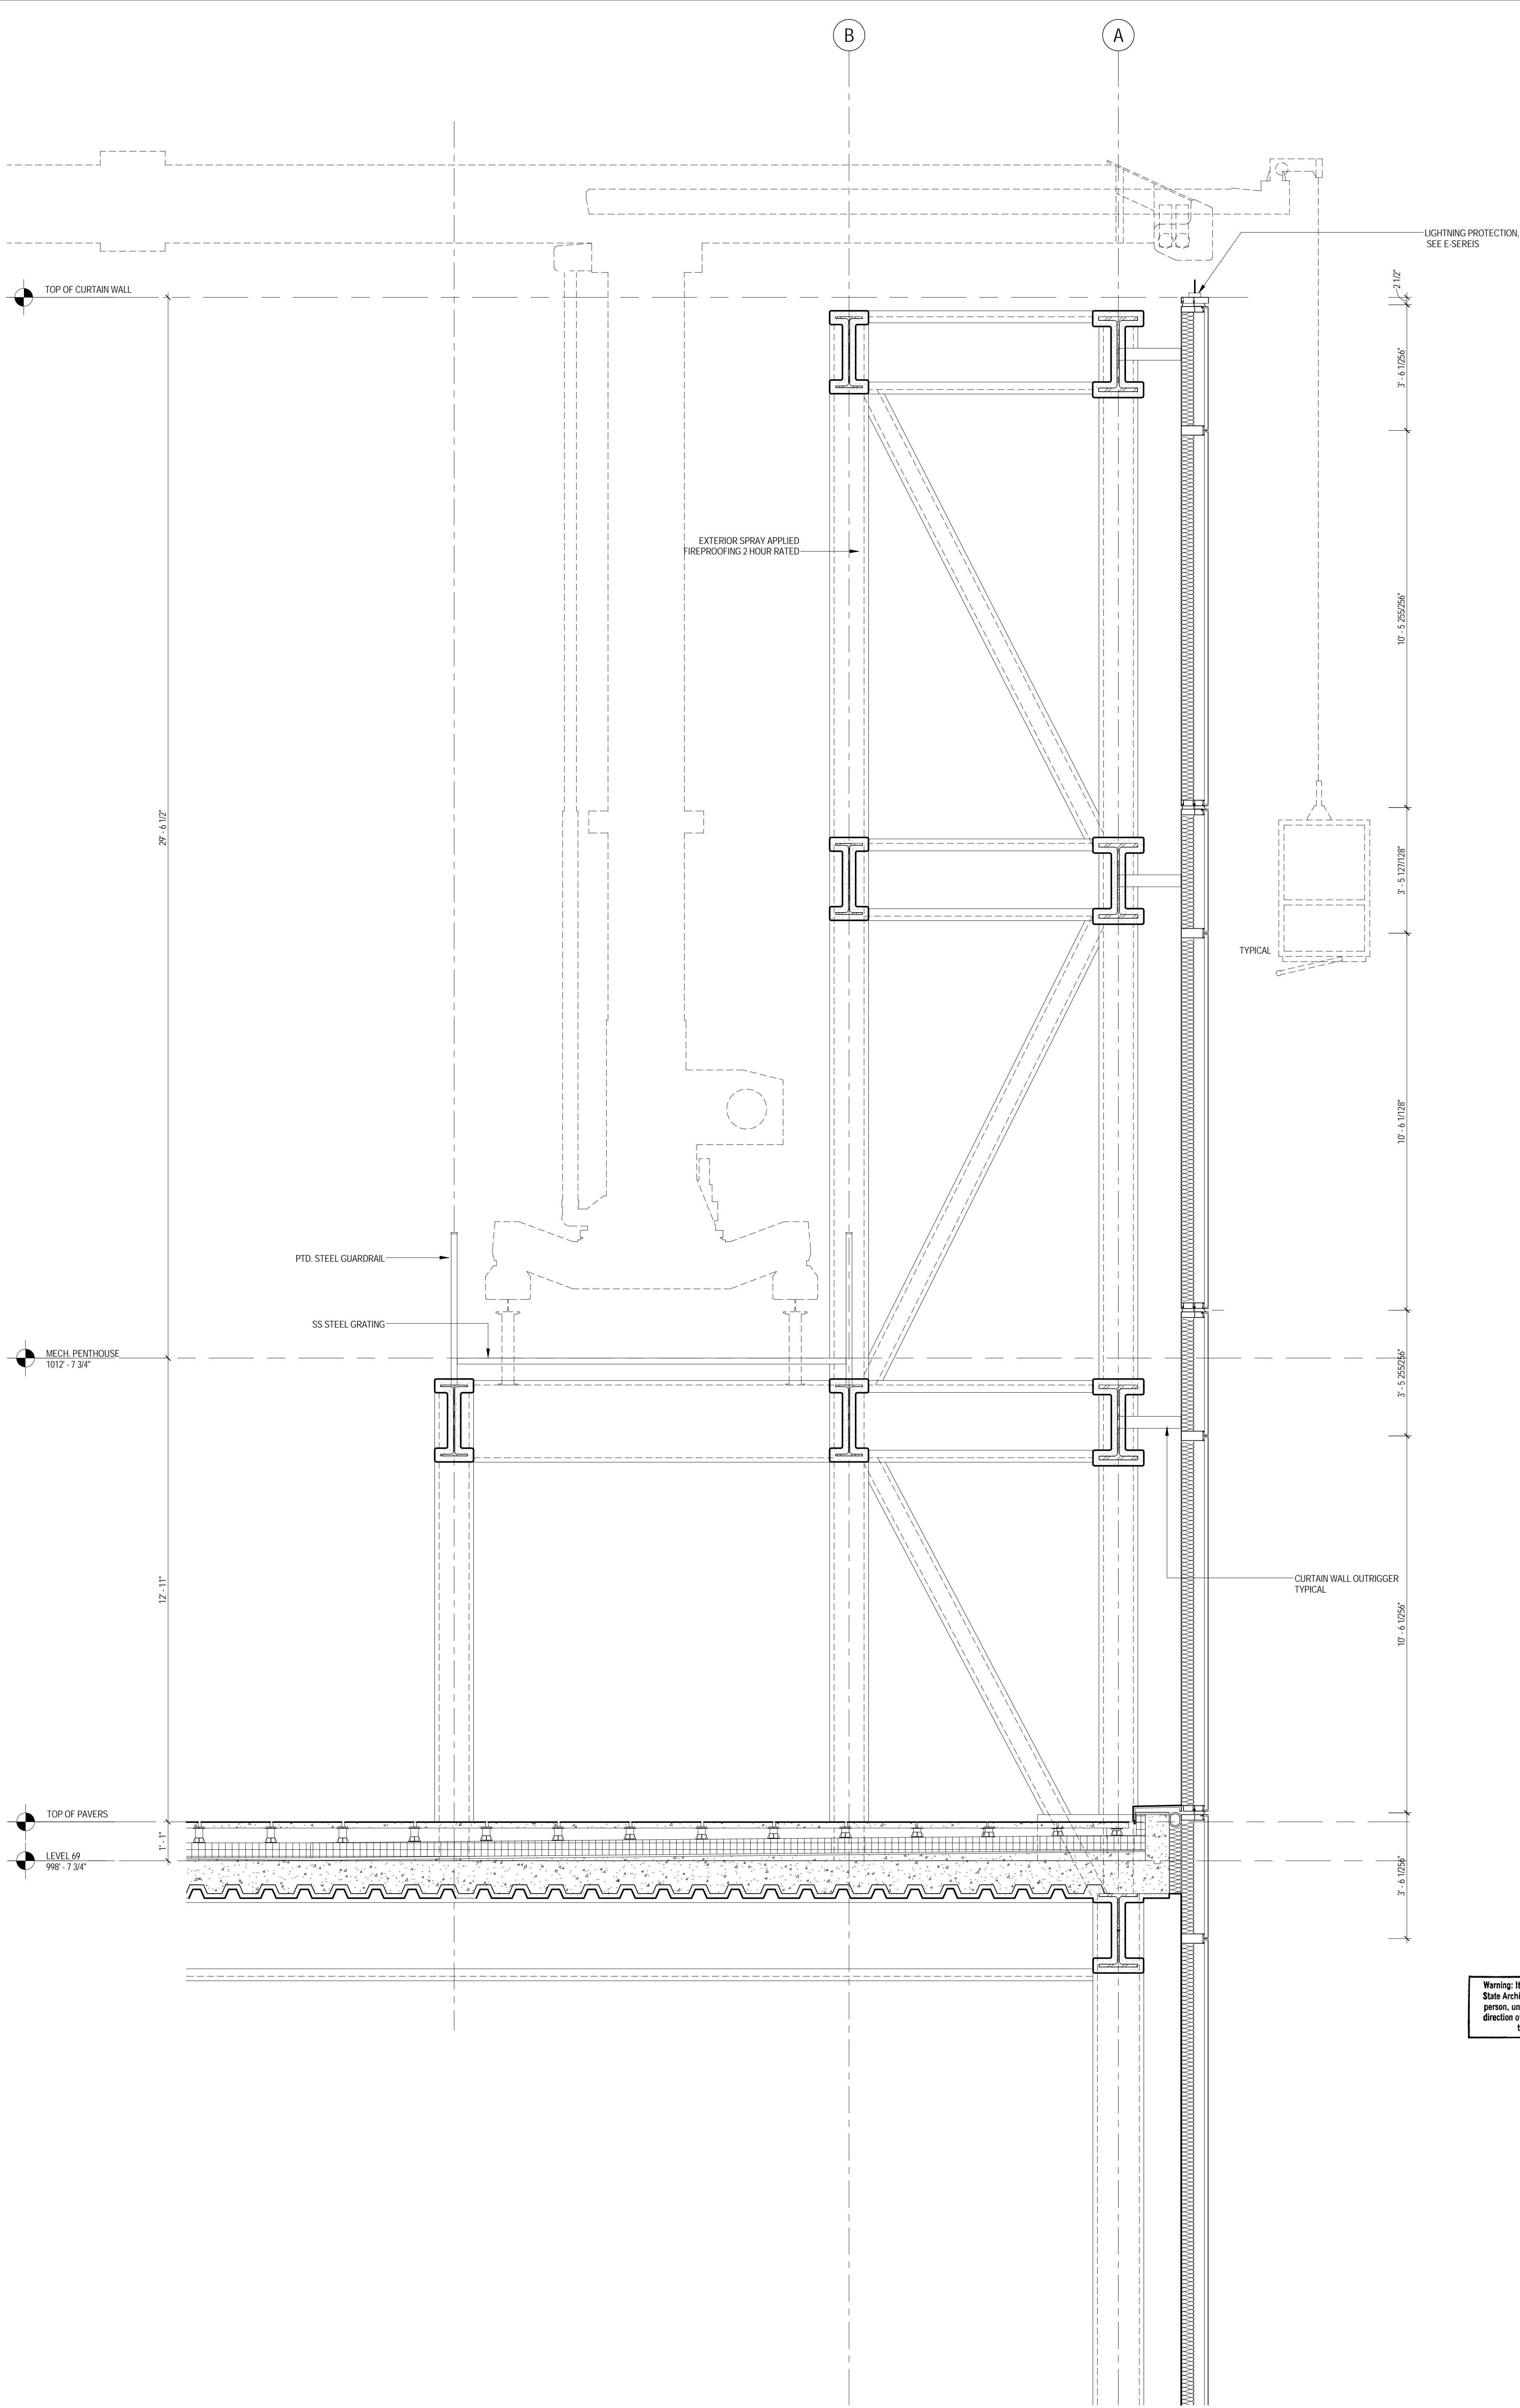
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Sheet Name:


**CURTAIN WALL
AT ROOF**

Project No.: 207150	B-SCAN Sheet No.: A-540.00
Date: 12 SEPT 2014	Sheet No.: A-540
Scale: 1/2" = 1'-0"	Page No.: 30
File No.: A-540	

9/11/2014 5:36:08 PM



1 ENLARGED SECTION AT ROOF LOOKING SOUTH
SCALE: 1/2" = 1'-0"



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Cerami & Associates
404 Fifth Avenue #8, New York, NY 10016

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65 Broadway, Suite 401, New York, NY 10006


Code Consultant
Code Consultants Professional Engineers PC
215 West 40th Street, 15th Floor, New York, NY 10018

Facade Maintenance Consultant
Entek Engineering LLC
166 Ames Street, Hackensack, NJ 07601


Wind Tunnel Consultant
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Sheet Name:		


**CURTAIN WALL
AT ROOF**

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Date: 12 SEPT 2014	Sheet No.: A-541
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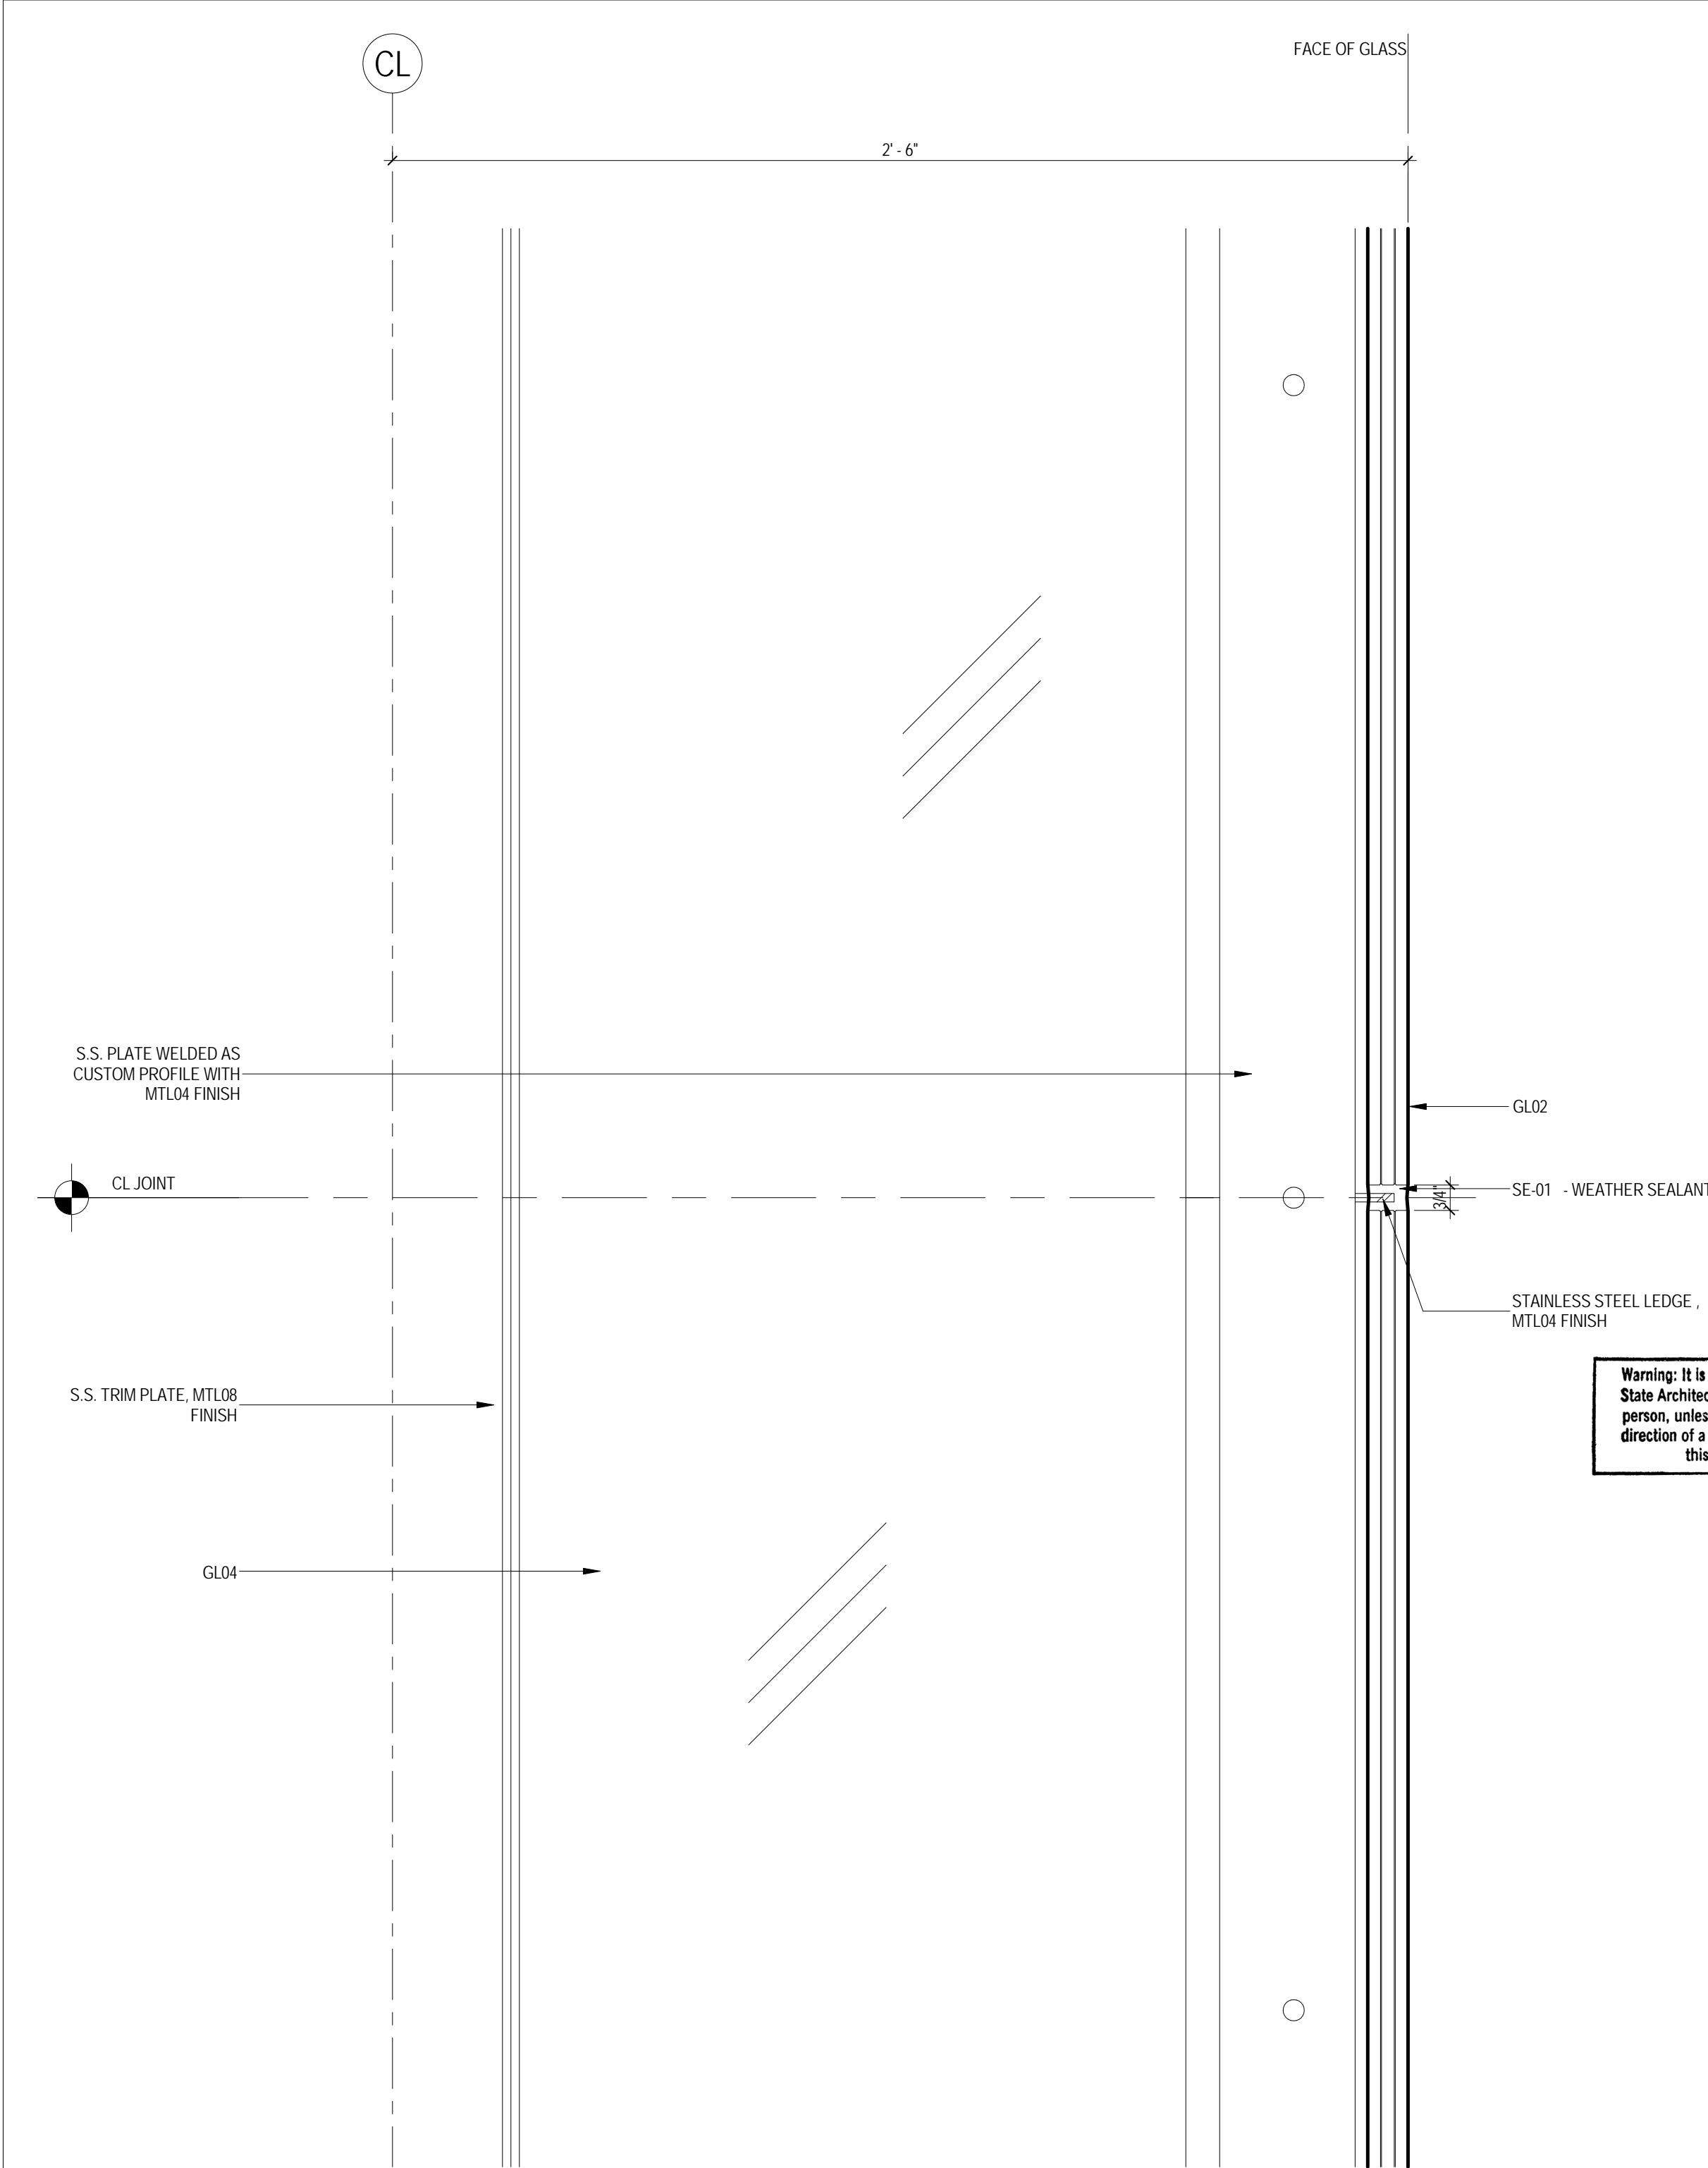
2 STOREFRONT SECTION DETAIL

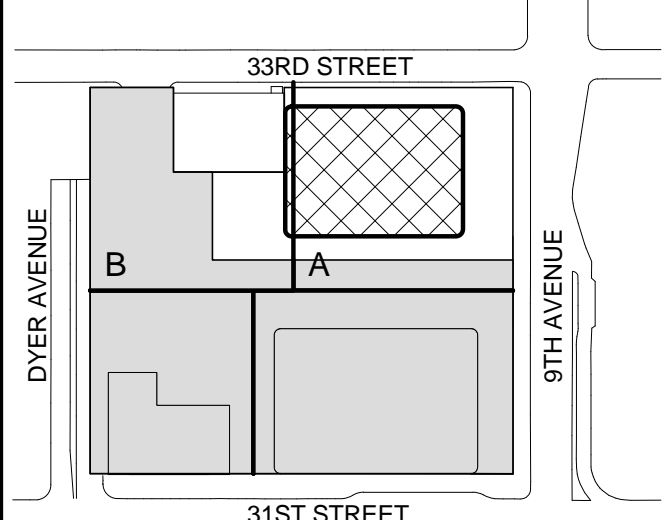
SCALE: 3" = 1'-0"



1 STOREFRONT SECTION DETAIL

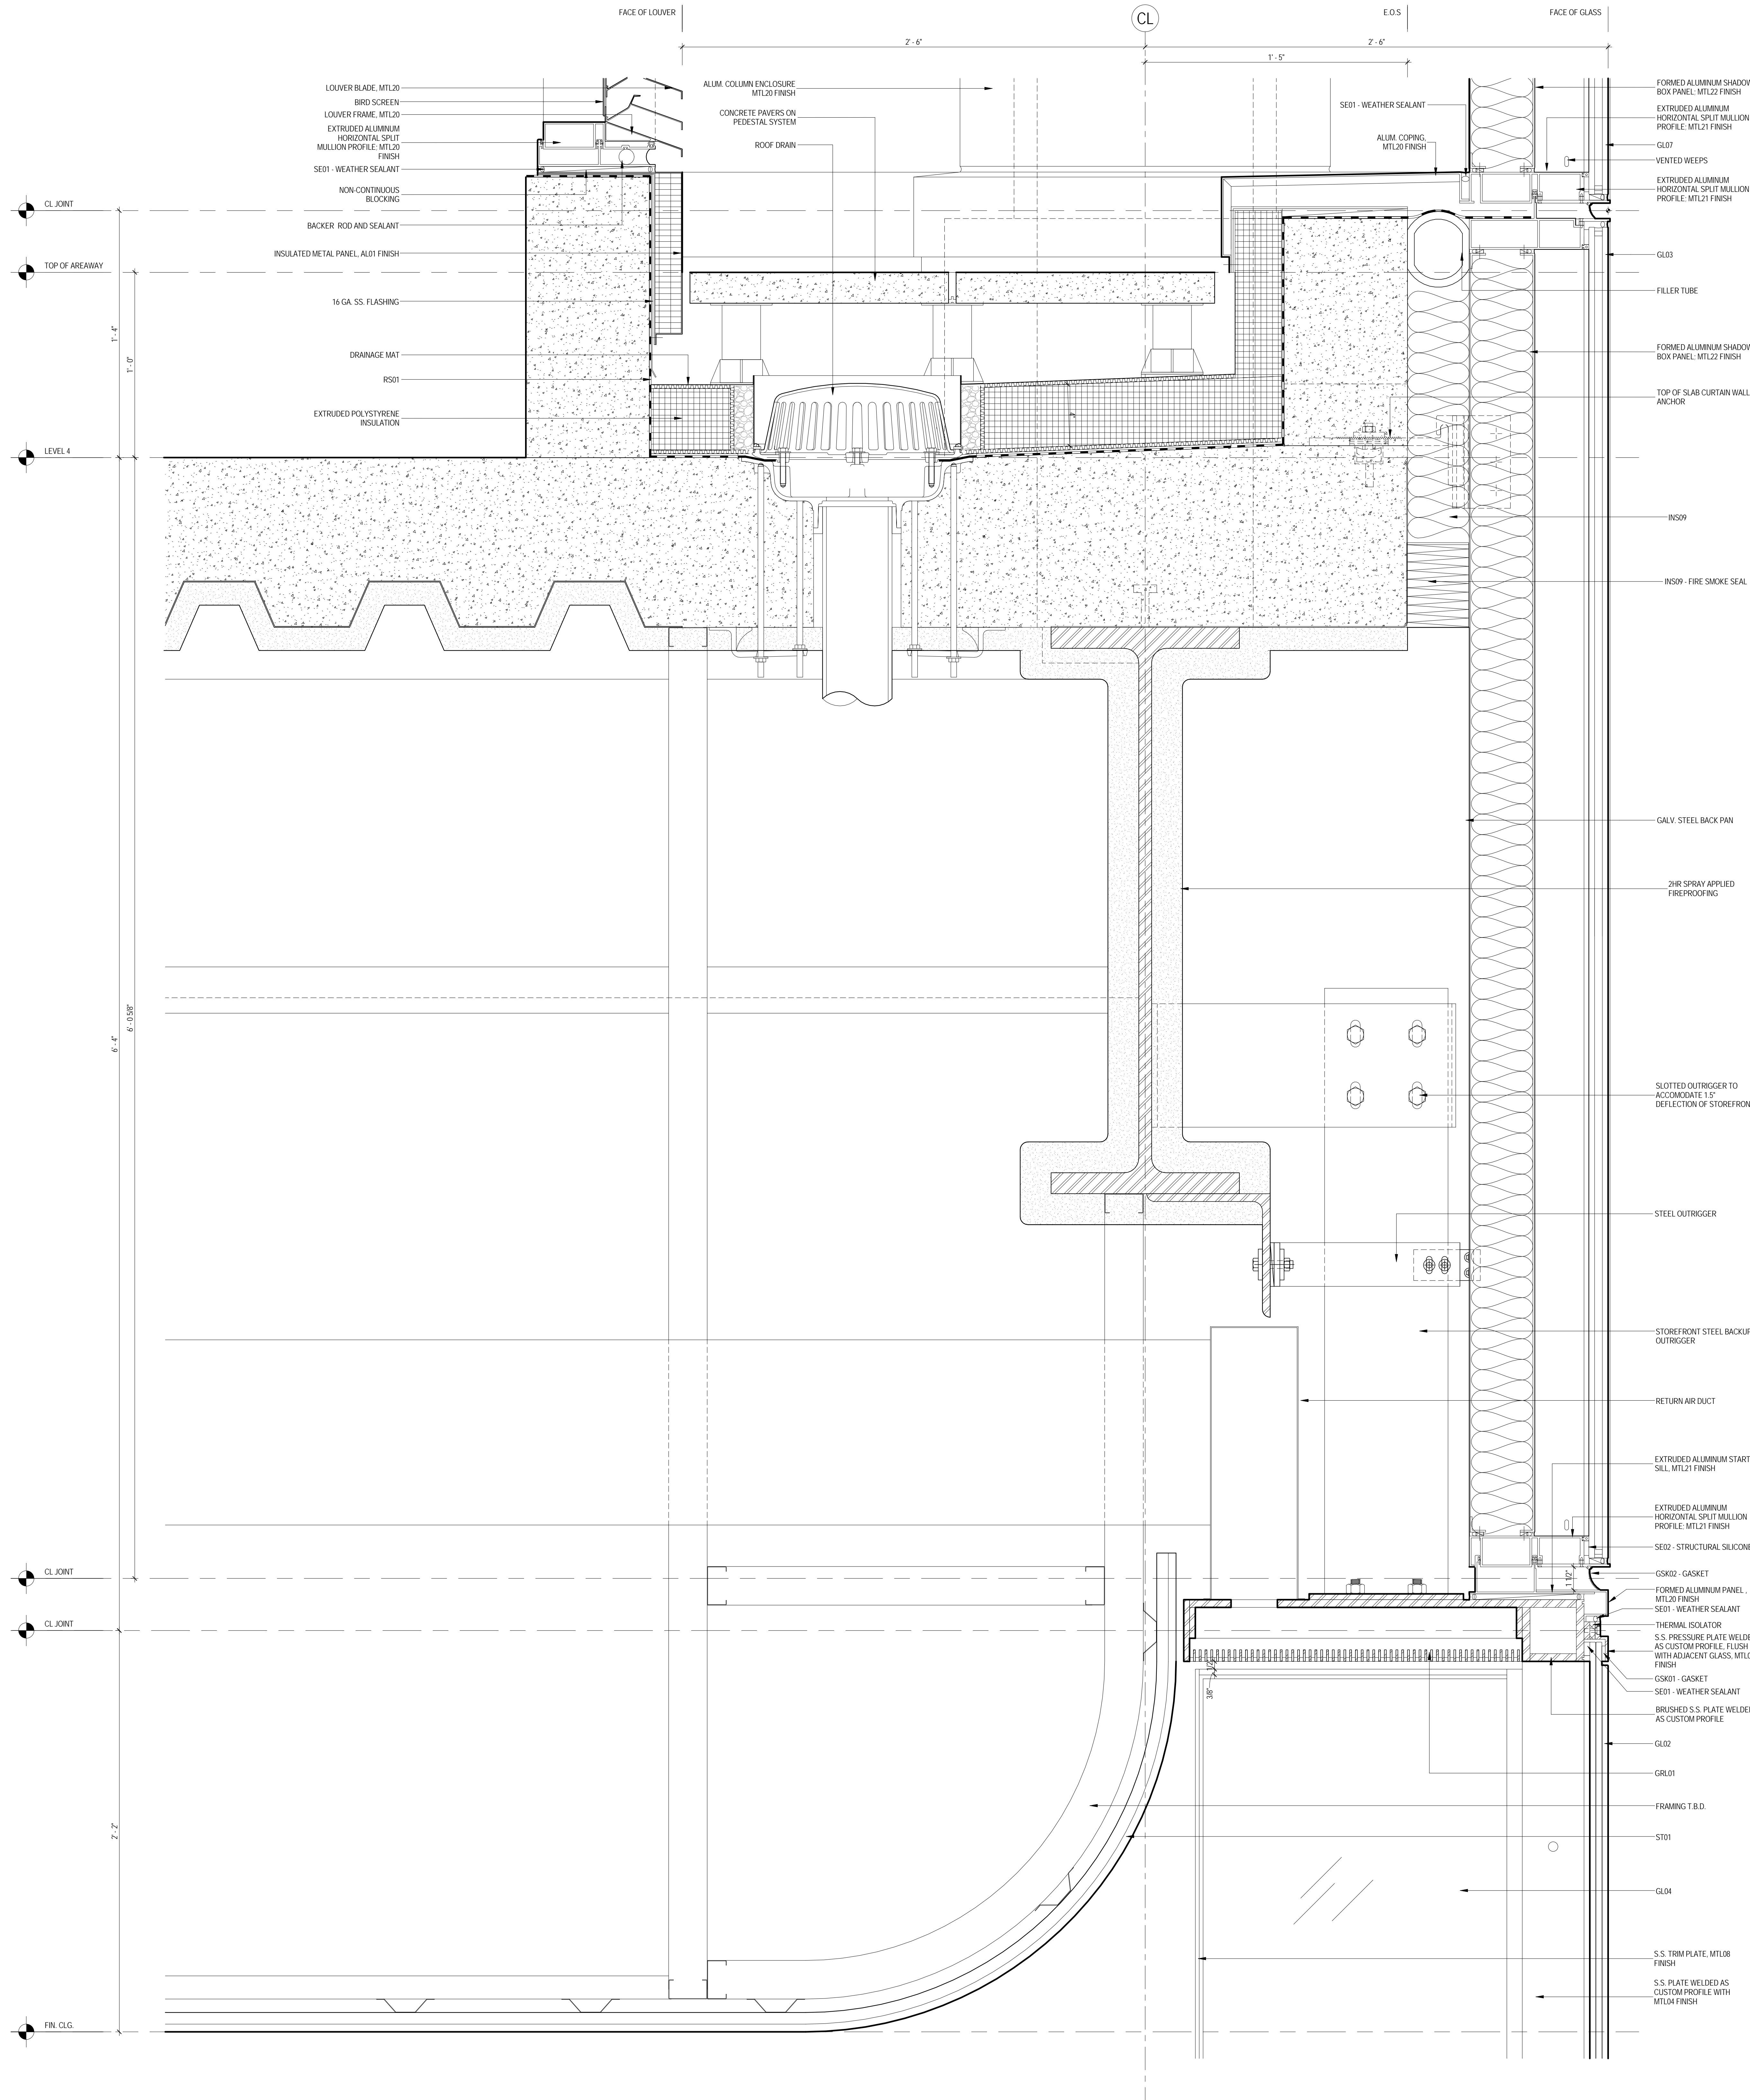SCALE: 3" = 1'-0"





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NORTH TOWER**
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Brookfield Place
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Philip Habib & Associates
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Edgett Williams Consulting Group, Inc.
102 East Blithedale Ave., Suite 1, Mill Valley, California 94041

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Viridian Energy & Environmental
50 Washington Street, Newark, CT 06854

Geotechnical Engineering
Mueser Rutledge Consulting Engineers
14 Penn Plaza, 225 W. 34th Street, New York, NY 10122

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Field Operations
475 10th Avenue, New York, NY 10018

Security Consultant
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250 State Street #F1, North Haven, CT 06473

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40 Wall Street, New York, NY 10005

Acoustical Consultant
Cerami & Associates
404 Fifth Avenue #8, New York, NY 10016

Vibration Consultant
Wilson, Uhrig & Associates, Inc.
65 Broadway, Suite 401, New York, NY 10006


Code Consultant
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215 West 40th Street, 15th Floor, New York, NY 10018

Facade Maintenance Consultant
Entek Engineering LLC
166 Ames Street, Hackensack, NJ 07601


Wind Tunnel Consultant
Rowan Williams Davies & Irwin Inc.
650 Woodlawn Road West, Guelph, Ontario, Canada N1K 1B6

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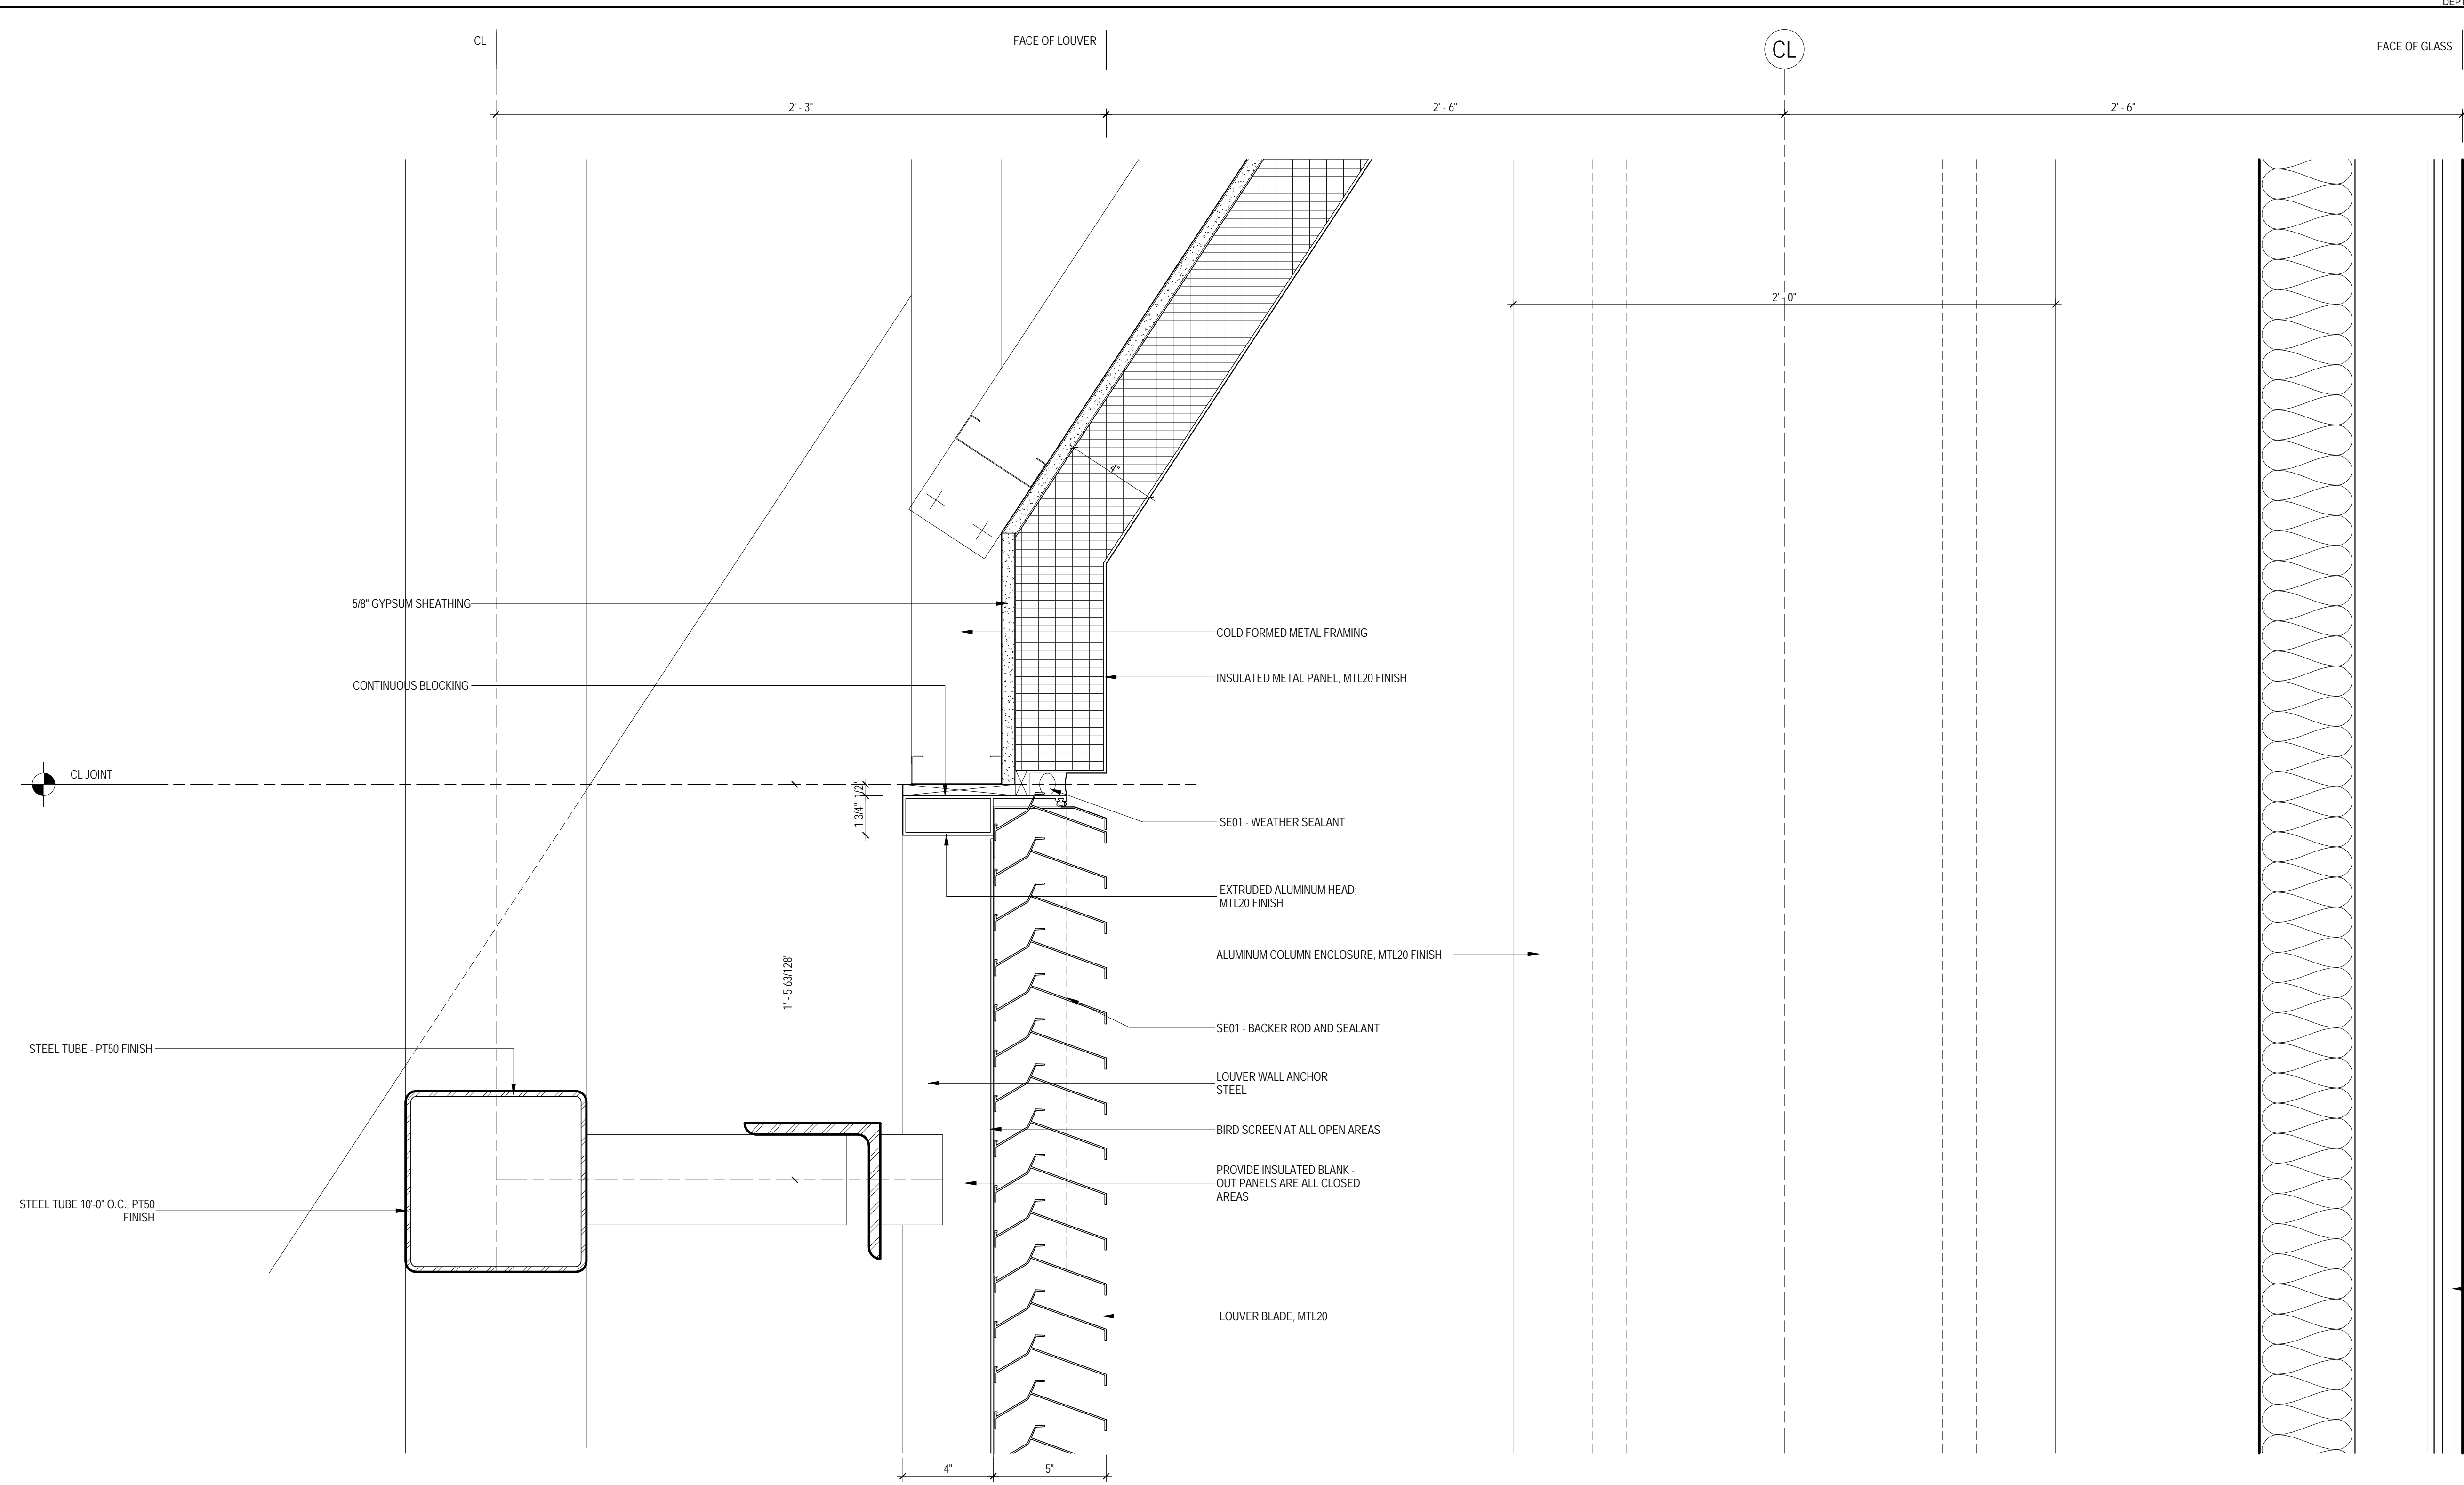
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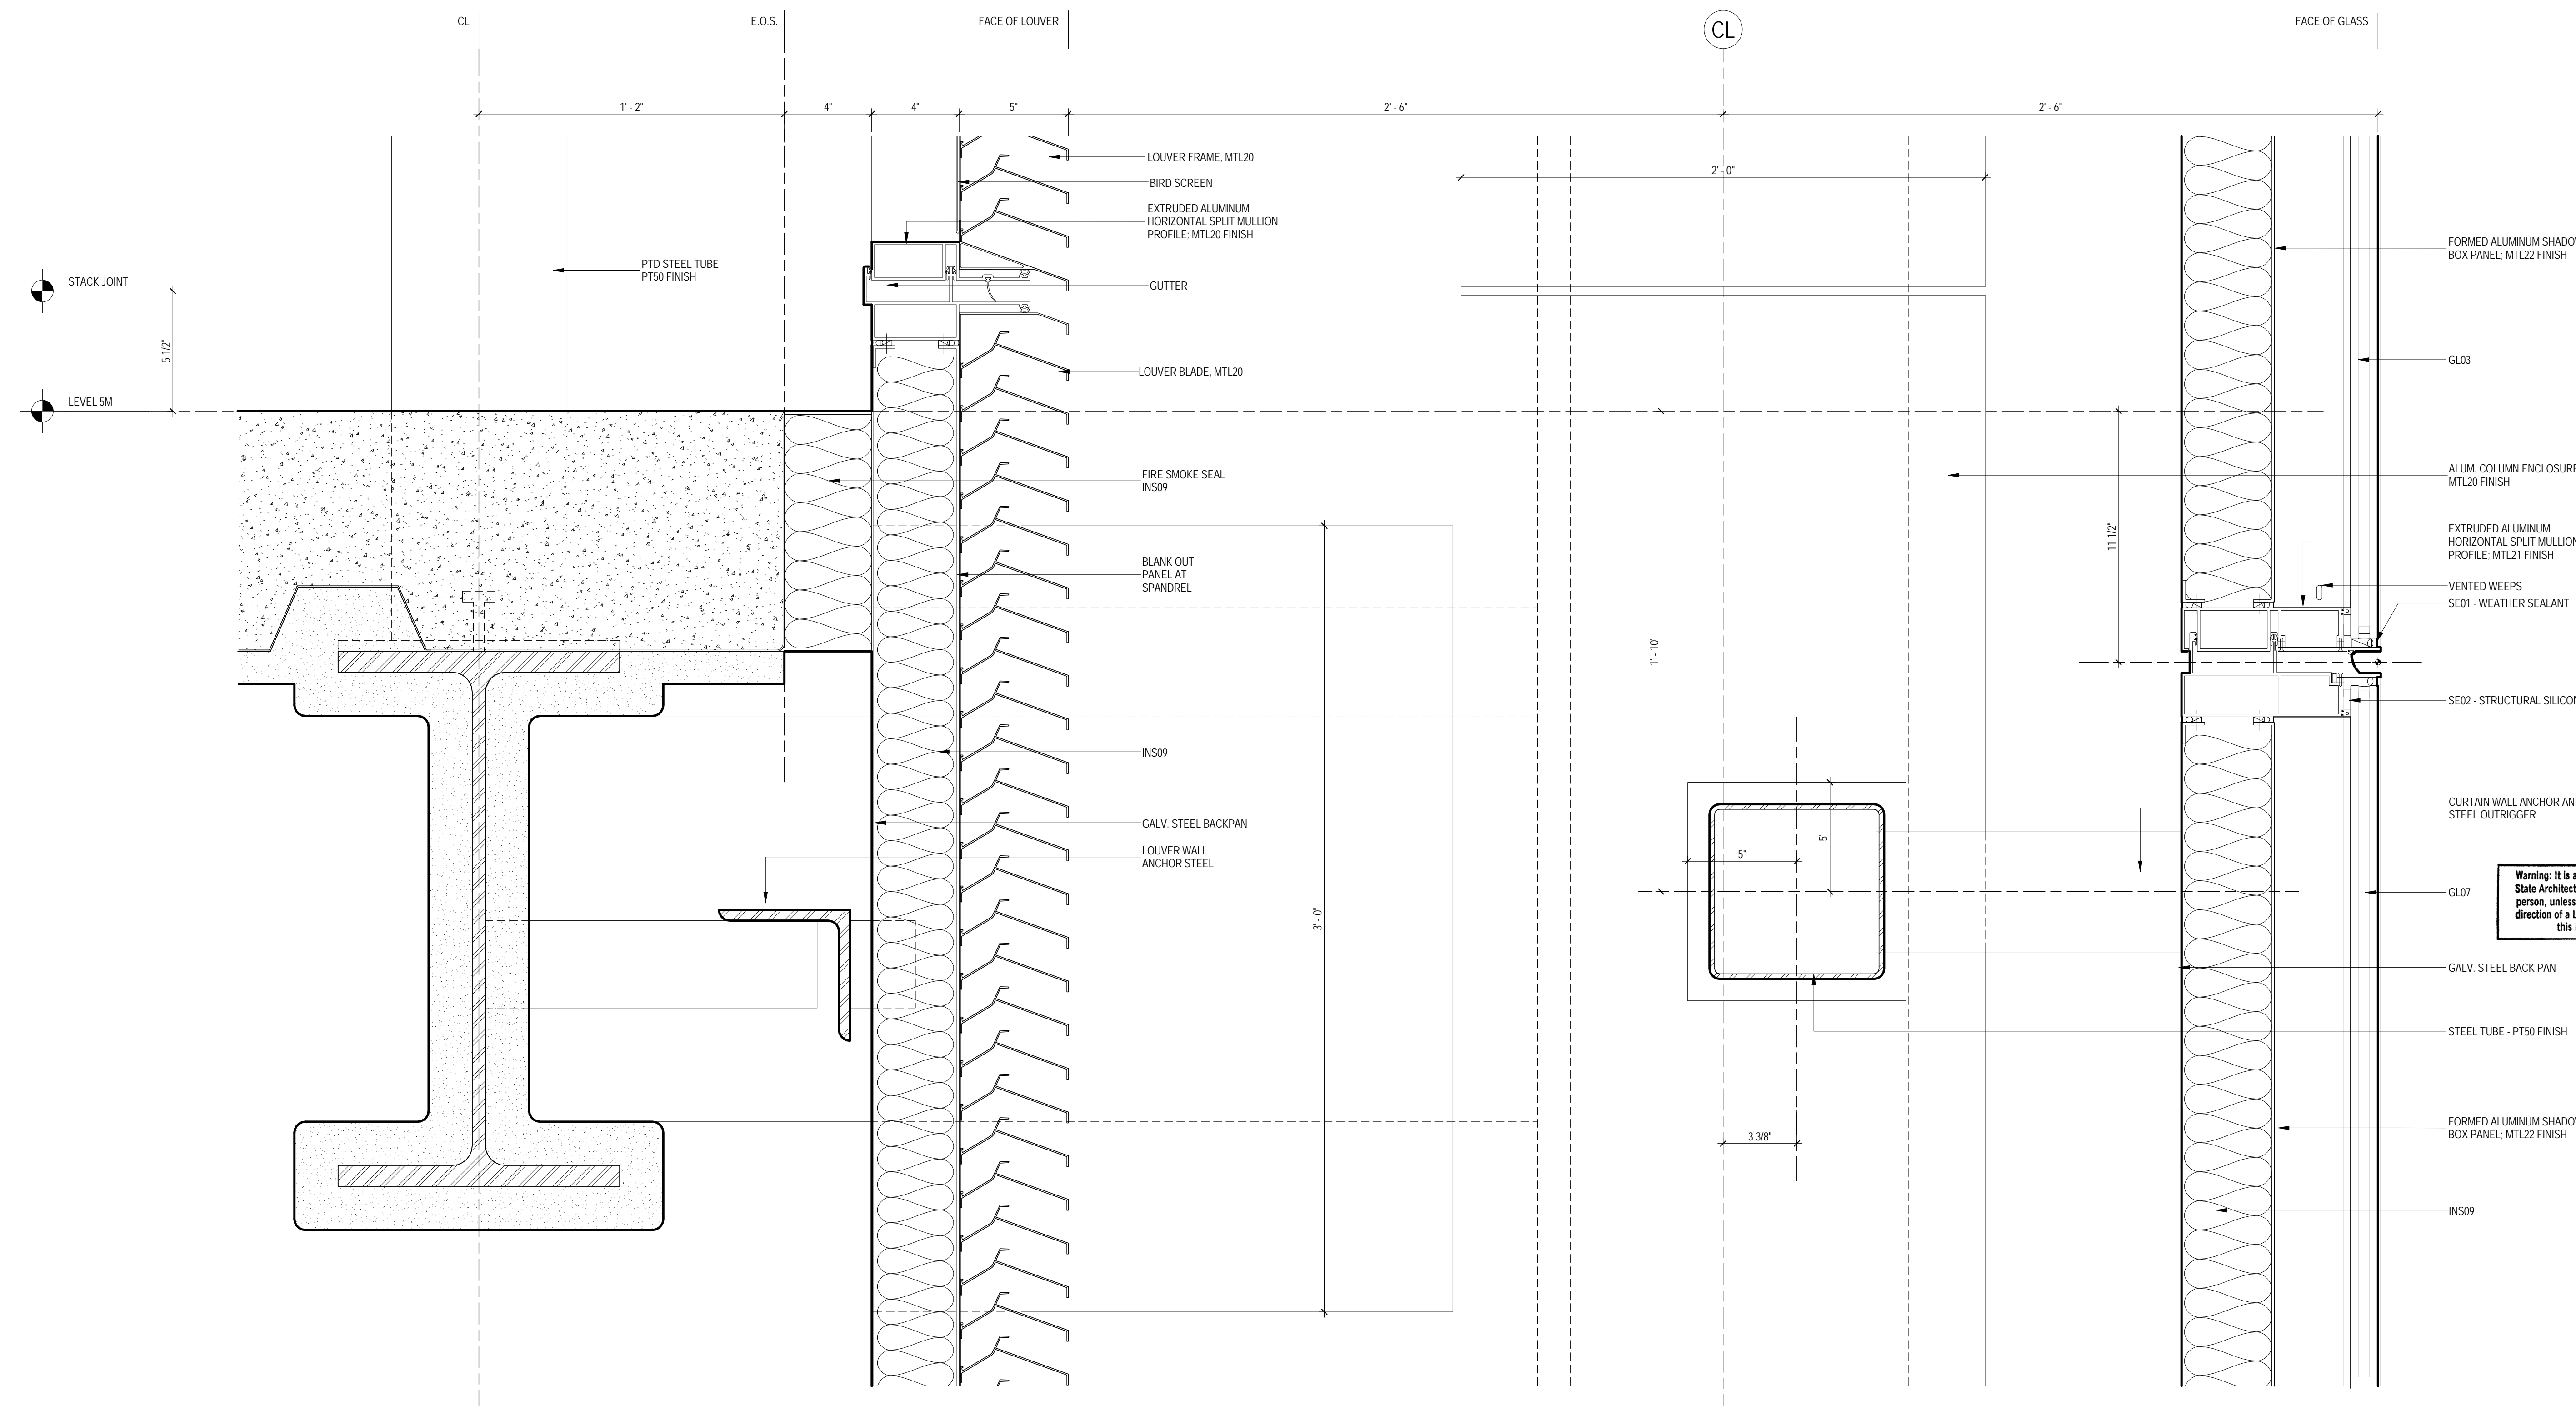
**STOREFRONT
DETAILS**

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Date:	Sheet No.:
12 SEPT 2014	A-552
Scale:	Page No.:
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File No.:	
A-552	
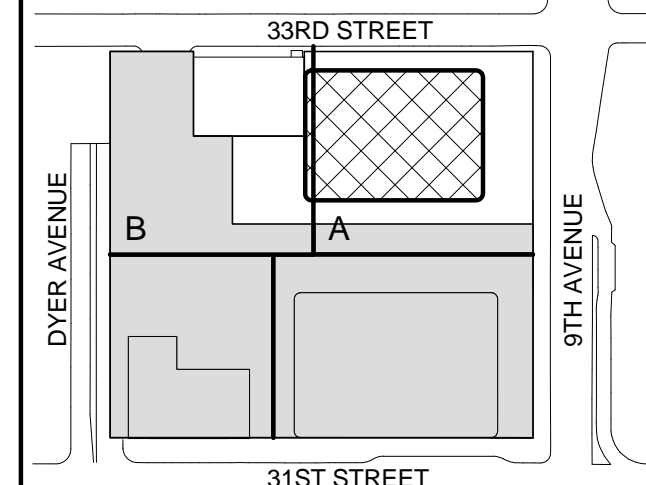
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2 CURTAIN WALL DETAILS
SCALE: 3" = 1'-0"



1 CURTAIN WALL SECTION DETAIL
SCALE: 3" = 1'-0"



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Client

Brookfield
Brookfield Place
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SOM
Skidmore, Owings & Merrill LLP
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Philip Habb & Associates
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Jaros Baum & Bolles
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Viridian Energy & Environmental
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Mueser Rutledge Consulting Engineers
14 Penn Plaza, 225 W. 34th Street, New York, NY 10122

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475 10th Avenue, New York, NY 10018

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250 State Street #F1, North Haven, CT 06473

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Weidinger Associates, Inc.
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Acoustical Consultant
Cerami & Associates
404 Fifth Avenue #8, New York, NY 10016

Vibration Consultant
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65 Broadway, Suite 401, New York, NY 10006


Code Consultant
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Entek Engineering LLC
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Rowan Williams Davies & Irwin Inc.
650 Woodlawn Road West, Guelph
Ontario, Canada N1K 1B8

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Key Plan:



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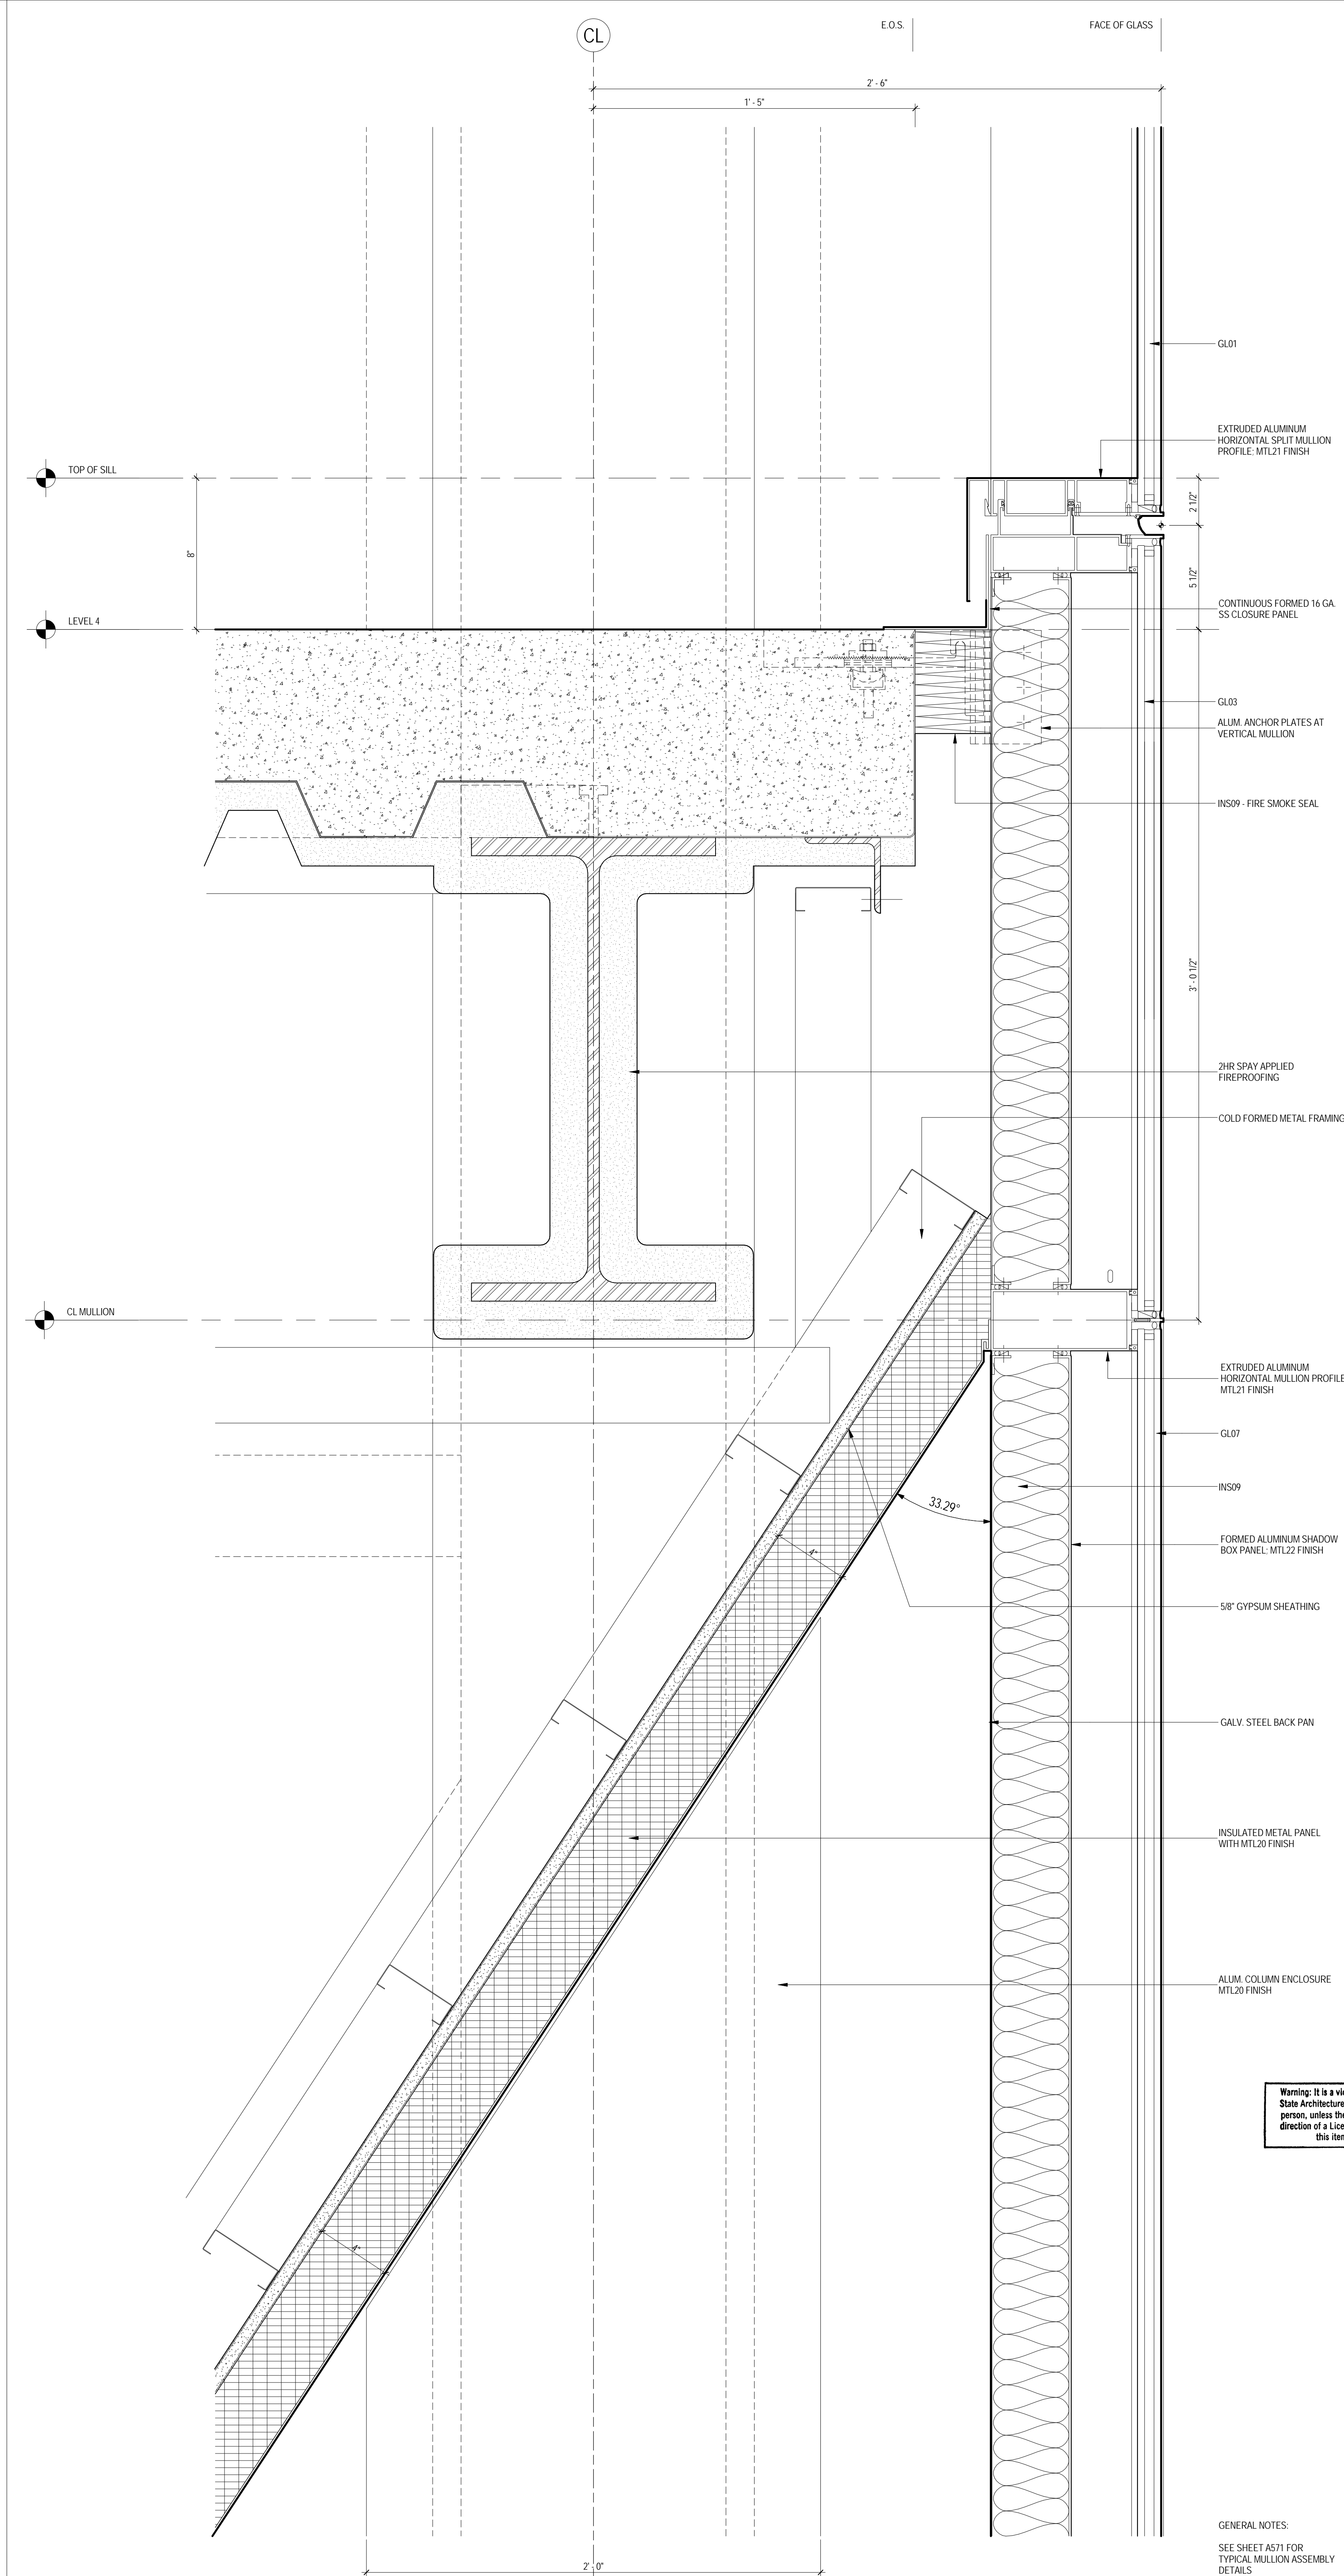
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2 12 SEPT 2014 ISSUED FOR FOUNDATION PERMIT
1 15 NOV 2013 ISSUED FOR 3D PROGRESS PRICING
No. Date Description
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
**CURTAIN WALL
DETAILS**

Project No.: 207150
Date: 12 SEPT 2014
Scale: 3" = 1'-0"
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B-SCAN Sheet No.:
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Sheet No.:
A-560
Page No.: 30
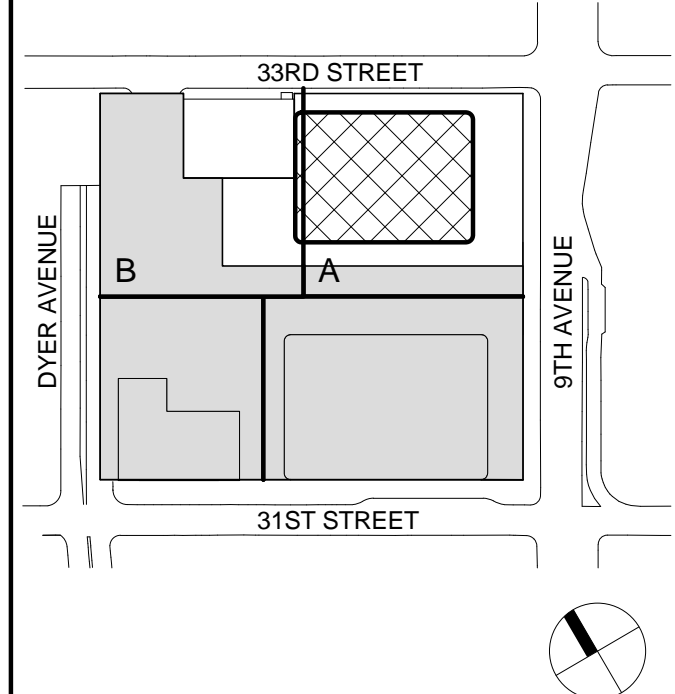
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1 CURTAIN WALL SECTION DETAIL
SCALE: 3" = 1'-0"



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Brookfield
Brookfield Place
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Skidmore, Owings & Merrill LLP
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Edgett Williams Consulting Group, Inc.
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Mueser Rutledge Consulting Engineers
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Cerami & Associates
404 Fifth Avenue #8, New York, NY 10016

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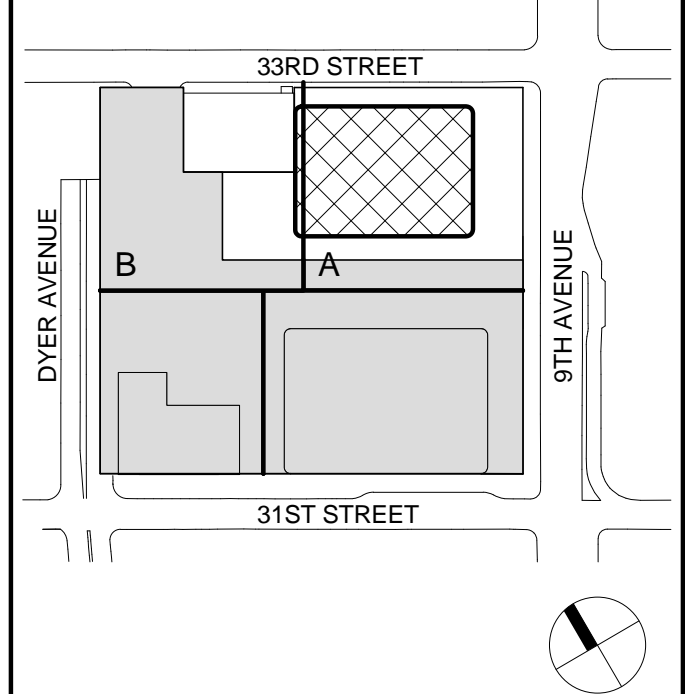
Code Consultant
Code Consultants Professional Engineers PC
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Entek Engineering LLC
166 Ames Street, Hackensack, NJ 07601


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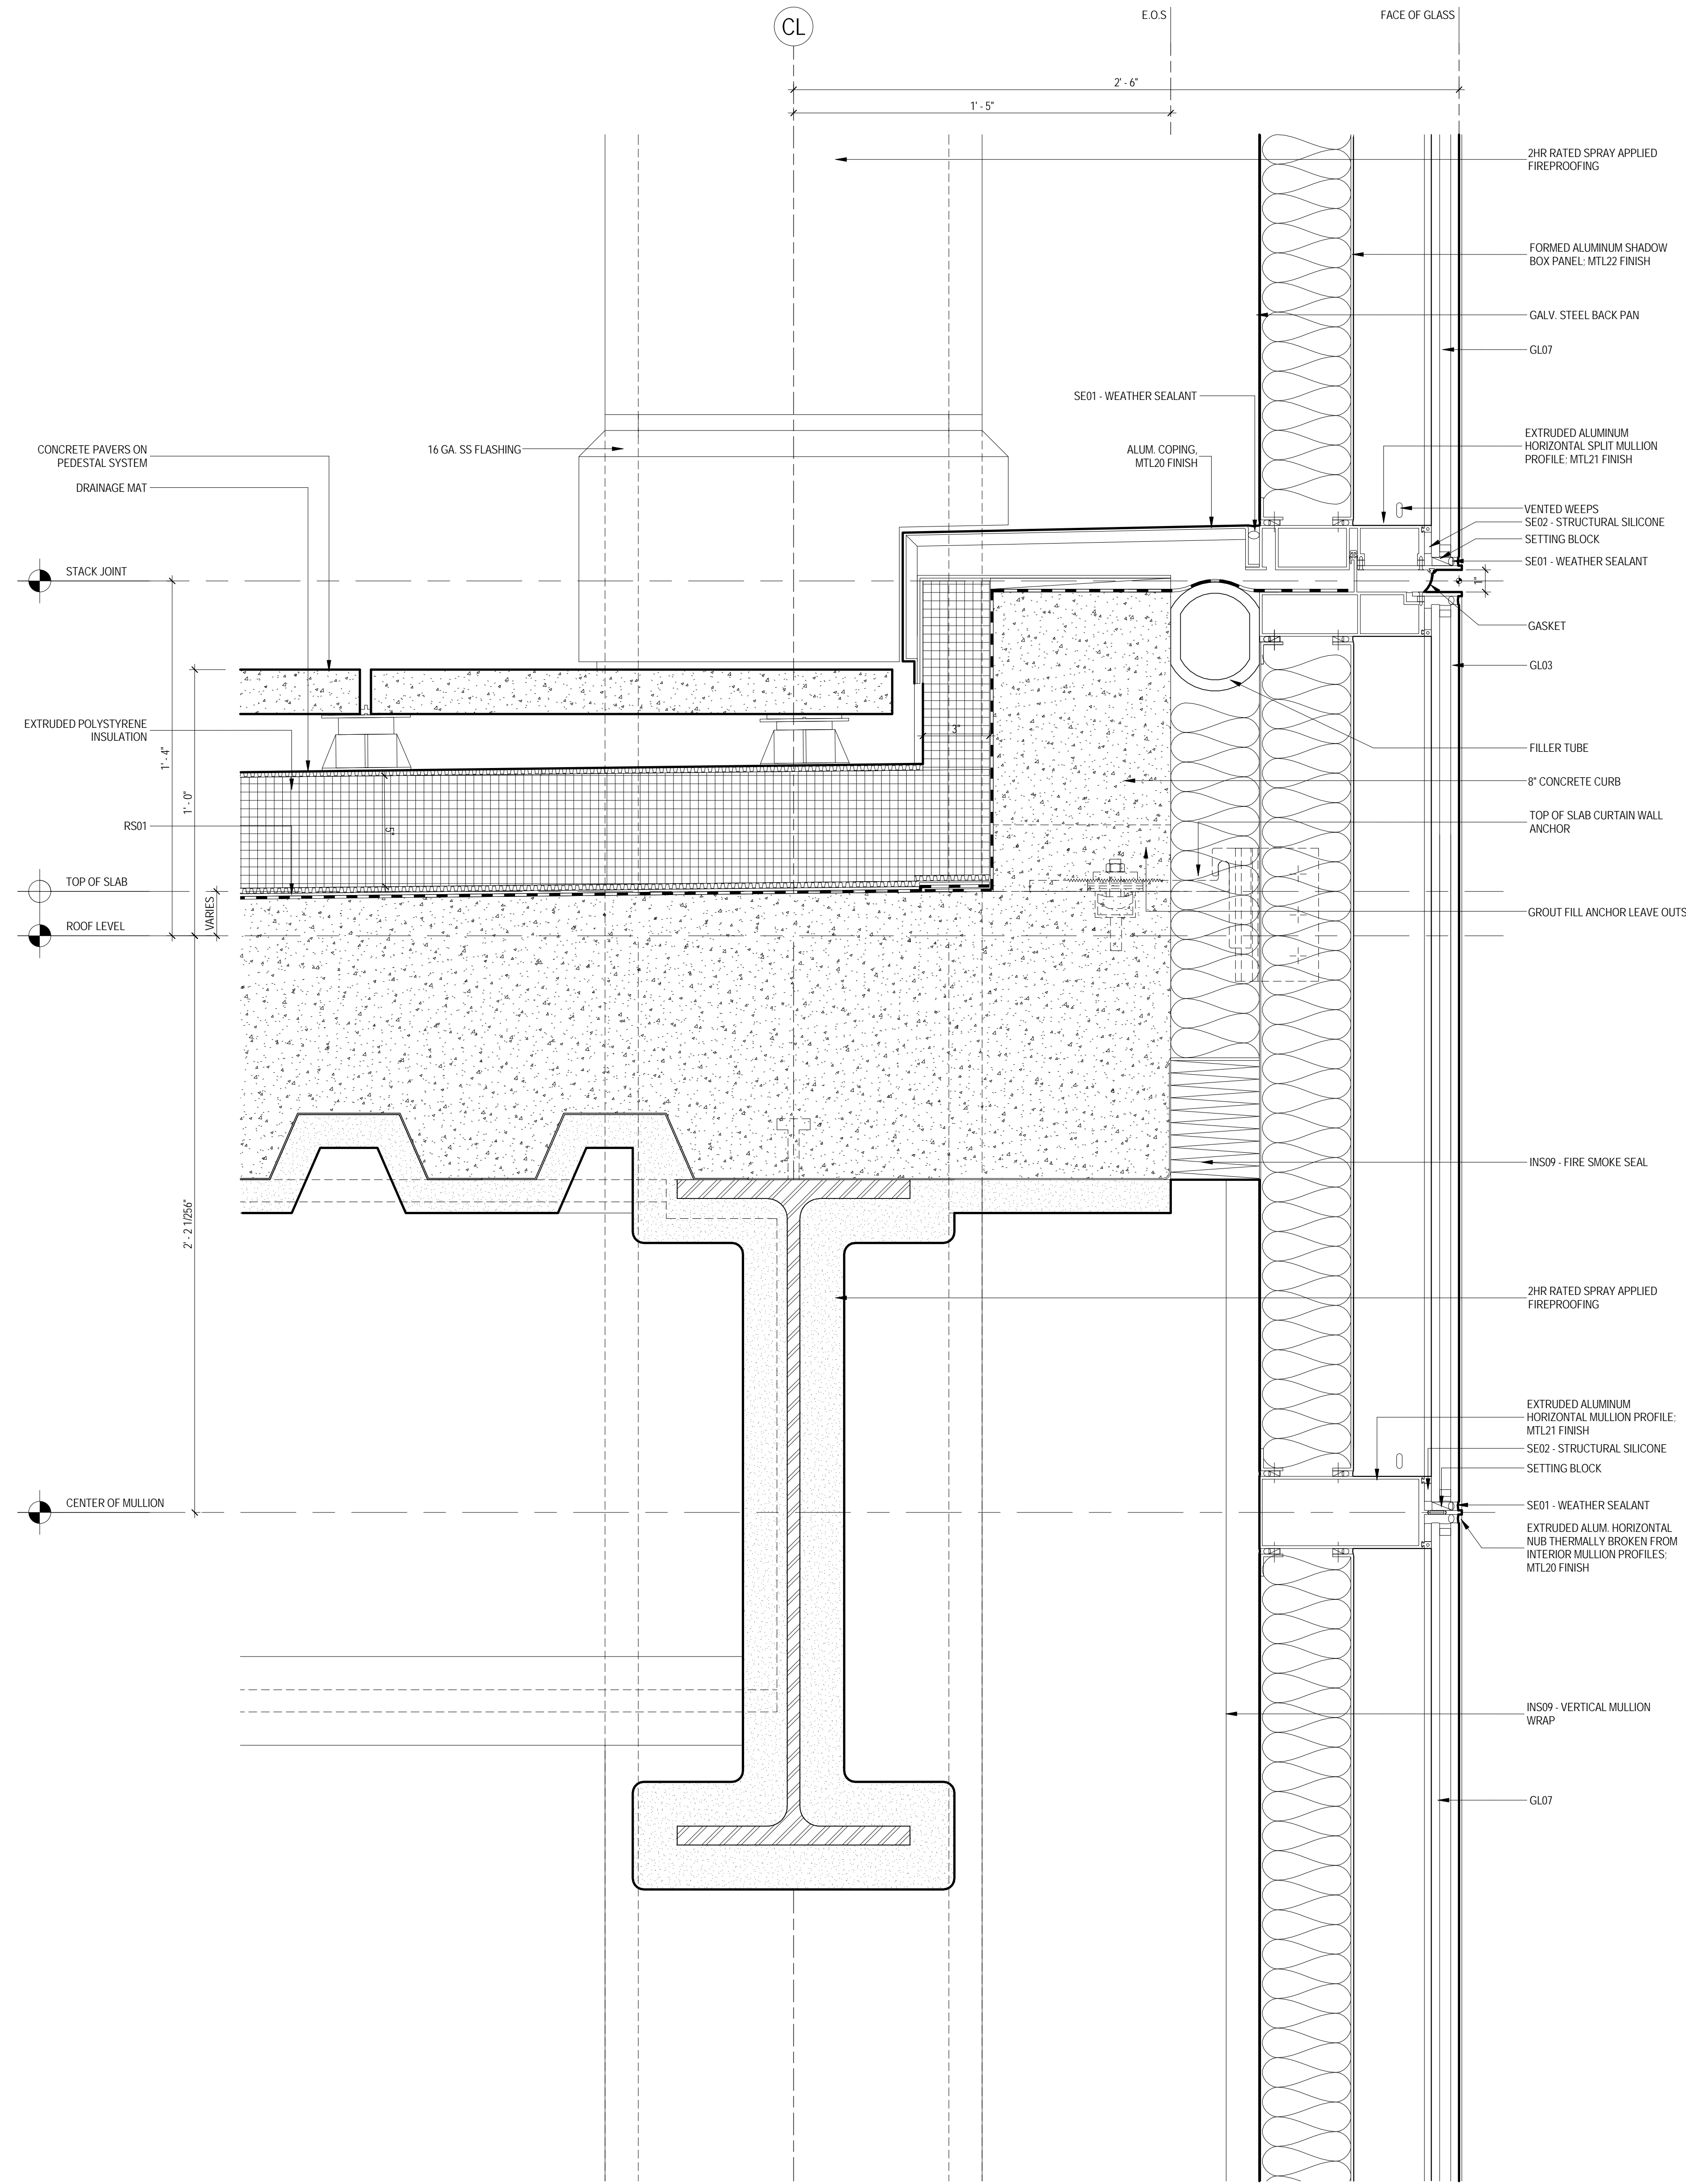
GENERAL NOTES:
SEE SHEET A571 FOR
TYPICAL MULLION ASSEMBLY
DETAILS

Project No.: 207120
Date: 12 SEPT 2014
Scale: 3" = 1'-0"
File No.: A-561

B-SCAN Sheet No.:
A-561.00
Sheet No.:
A-561
Page No.: 30


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1 CURTAIN WALL SECTION DETAIL
SCALE: 3" = 1'-0"



SHEET NOTES

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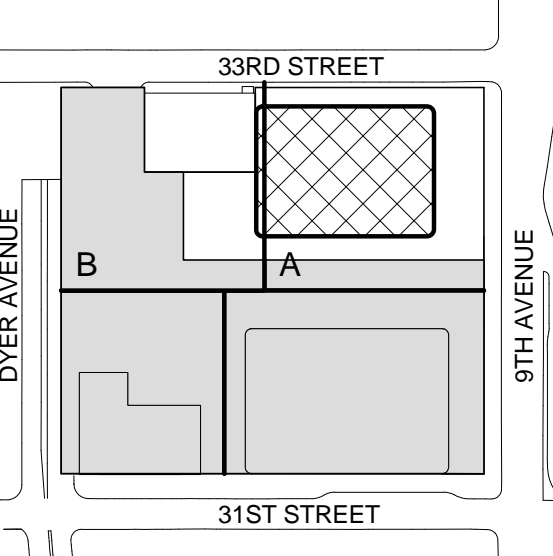
Code Consultant
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Entek Engineering LLC
166 Ames Street, Hackensack, NJ 07601


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650 Woodlawn Road West, Guelph Ontario, Canada N1K 1B8

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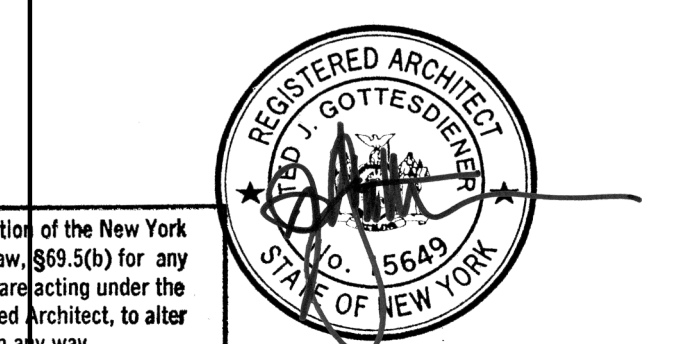
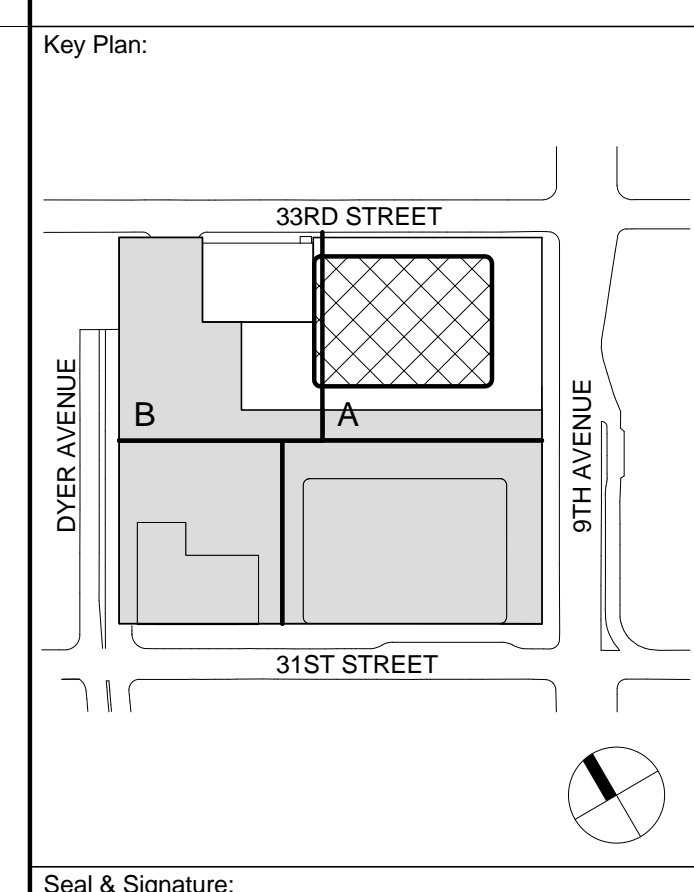
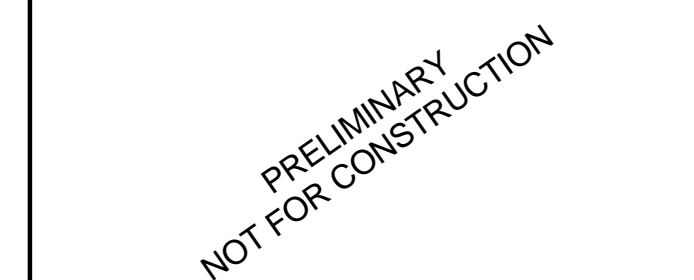
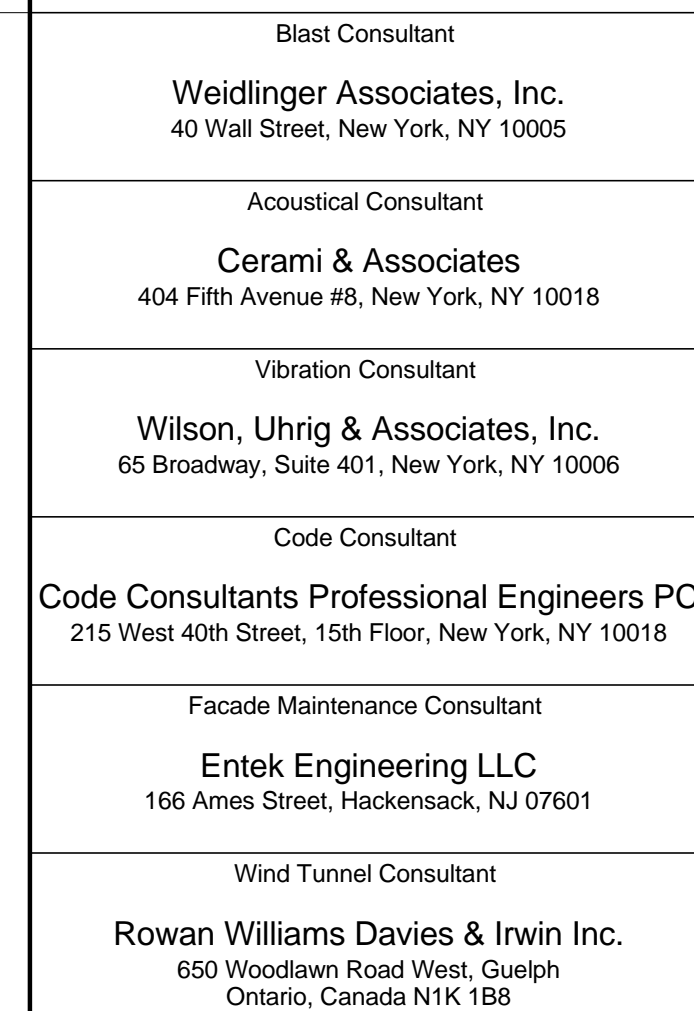
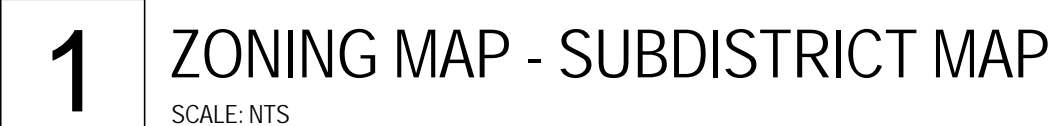
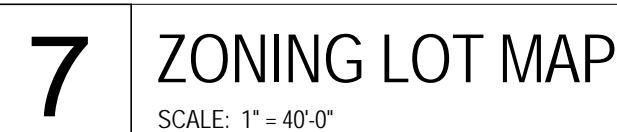
2 12 SEPT 2014 ISSUED FOR FOUNDATION PERMIT
1 18 NOV 2013 ISSUED FOR 03 PROGRESS PRICING

No. Date Description

Sheet Name:

**CURTAIN WALL
DETAILS**

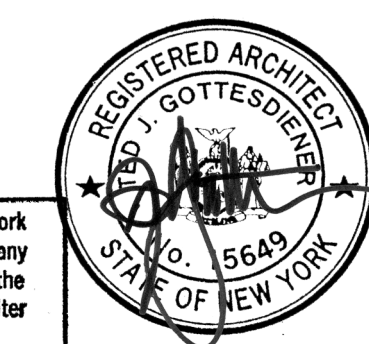Project No.: 207120 B-SCAN Sheet No.:
Date: 12 SEPT 2014 **A-575.00**
Scale: 3" = 1'-0" Sheet No.: A-575
File No.: A-575 Page No.: 0 OF 30





3	12 SEPT 2014	ISSUED FOR FOUNDATION PERMIT
2	20 JUN 2014	ISSUED FOR FOUNDATION PERMIT
1	20 DEC 2013	ISSUED FOR FOUNDATION PERMIT
No.	Date	Description

ZONING MAP &
TAX LOT MAP

Project No.: 207120	B-SCAN Sheet No.: Z-001.00
Date: 12 SEPT 2014	
Scale: As indicated	
File No.: Z-001	Sheet No.: Z-001
	Page No.: 1 OF 30

SECTION	ITEM	COMPLIANCE	SECTION	ITEM	COMPLIANCE
93-00 93-01 93-02 93-03 93-04	GENERAL PURPOSES Definitions General provisions District plan and maps Sub districts and subareas within Farley Corridor subdistrict western blocks subarea B1, central blocks subarea B2	General Note (G.N.) G.N. G.N. G.N. G.N.	93-52	Special height and setback regulations in the Farley Corridor subdistrict B 450 West 33rd Street Ninth Avenue rail yard Pennsylvania Station subarea B4 Special permit for modification of height and setback regulations	COMPLIES COMPLIES G.N. G.N.
93-05 93-051 93-052 93-053 93-054 93-055	Applicability of district regulations Applicability of Article I, Chapter 1 Applicability of Article I, Chapter 3 Applicability of Chapter 3 of Article VII Applicability of Article VII, Chapter 4 Modification of use and bulk regulations for zoning lots bounding Hudson Boulevard Park	G.N. G.N. G.N. G.N. G.N. G.N.	93-60 93-61 93-62 93-523 93-57	MANDATORY IMPROVEMENTS Sidewalk widening Street tree planting Pedestrian circulation space Major building entrances Transit facilities Open area requirements in the large scale plan subdistrict A Public access requirements for special sites Public access areas in the eastern rail yard subarea A1 Public access areas at 450 West 33rd Street Public access areas on Ninth Avenue rail yards Design and maintenance requirements for public access areas on Ninth Avenue rail yard Certification for public access areas on the Ninth Avenue rail yard Certification to modify general requirements for public access areas for ventilation demands Certification to temporarily modify public access areas for construction staging	COMPLIES COMPLIES COMPLIES COMPLIES G.N. G.N. G.N. COMPLIES COMPLIES G.N. G.N. G.N.
93-10 93-11 93-12 93-13 93-131 93-132 93-14 93-15 93-16 93-17 93-18 93-19	USE REGULATIONS Air space over a rail road or transit right-of-way or yard Special residential use regulations Special office use regulations Certification for office use Authorization for office use Ground floor level requirements Security gates Public parking facilities Modification of sign regulations Non-conforming uses in large-scale plan sub district A Authorization for electrical utility substation	G.N. G.N. G.N. G.N. G.N. G.N. G.N. G.N. G.N. G.N. G.N. G.N.	93-70 93-71 93-72 93-73 93-731 93-732 93-733 93-734	OFF STREET PARKING REGULATIONS Definitions Permitted parking Use and location of parking facilities Curb cut restrictions Curb cut restriction in Farley Corridor subdistrict B No curb cut shall be permitted on Ninth Ave. between West 31st and West 33rd street. Max. aggregate width of curb cuts on West 33rd street: 90'	COMPLIES COMPLIES G.N. G.N. COMPLIES COMPLIES G.N. G.N.
93-20 93-21	FLOOR AREA REGULATIONS Floor area regulations in the large-scale plan subdistrict A	G.N.	93-80 93-81	OFF STREET PARKING REGULATIONS Definitions Permitted parking Use and location of parking facilities Curb cut restrictions Curb cut restriction in Farley Corridor subdistrict B No curb cut shall be permitted on Ninth Ave. between West 31st and West 33rd street. Max. aggregate width of curb cuts on West 33rd street: 90'	COMPLIES COMPLIES
93-22 93-221	Floor area regulations in subdistrict B,C,D,E, and F Maximum floor area ratio in the Farley Corridor subdistrict B	COMPLIES COMPLIES	93-82 93-83 93-84 93-842	OFF STREET PARKING REGULATIONS Definitions Permitted parking Use and location of parking facilities Curb cut restrictions Curb cut restriction in Farley Corridor subdistrict B No curb cut shall be permitted on Ninth Ave. between West 31st and West 33rd street. Max. aggregate width of curb cuts on West 33rd street: 90'	COMPLIES COMPLIES G.N. G.N. COMPLIES
93-222	Maximum floor area ratio in the 34th Street Corridor subdistrict C	G.N.	93-90	HARASSMENT Required accessory off-street loading berths Required bicycle parking spaces Steps Permitted obstructions Hours of access Seatings Planting and trees Public space signage system	COMPLIES COMPLIES COMPLIES COMPLIES G.N.
93-223 93-224	Maximum floor area ratio in Hell's Kitchen subdistrict D Maximum floor area ratio in the south of Port Authority subdistrict E	G.N. G.N.	93-90 36-62 36-71 37-725 37-726 37-727 37-741 37-742 37-751	HARASSMENT Required accessory off-street loading berths Required bicycle parking spaces Steps Permitted obstructions Hours of access Seatings Planting and trees Public space signage system	COMPLIES COMPLIES COMPLIES COMPLIES G.N.
93-225 93-23 93-30 93-31 93-32	Floor area regulations in subdistrict F Modification of inclusionary housing program Special floor area regulations District improvement found bonus Floor area regulation in the phase 2 Hudson Boulevard and park	G.N. G.N. G.N. G.N. G.N.	93-90 36-62 36-71 37-725 37-726 37-727 37-741 37-742 37-751	HARASSMENT Required accessory off-street loading berths Required bicycle parking spaces Steps Permitted obstructions Hours of access Seatings Planting and trees Public space signage system	COMPLIES COMPLIES COMPLIES COMPLIES G.N.
93-33 93-34	Special regulations for residual portions of zoning lots partially within the phase 2 Hudson Boulevard and park Distribution of floor area in the large-scale plan subdistrict A	G.N. G.N.	93-90 36-62 36-71 37-725 37-726 37-727 37-741 37-742 37-751	HARASSMENT Required accessory off-street loading berths Required bicycle parking spaces Steps Permitted obstructions Hours of access Seatings Planting and trees Public space signage system	COMPLIES COMPLIES COMPLIES COMPLIES G.N.
93-35	Special permit for transit bonus in Pennsylvania Station subarea B4 plan subdistrict A	G.N.	93-90 36-62 36-71 37-725 37-726 37-727 37-741 37-742 37-751	HARASSMENT Required accessory off-street loading berths Required bicycle parking spaces Steps Permitted obstructions Hours of access Seatings Planting and trees Public space signage system	COMPLIES COMPLIES COMPLIES COMPLIES G.N.
93-40 93-41 93-42	HEIGHT AND SETBACK REGULATIONS Rooftop regulations Height and setback in subdistrict A,B,C,D,E and F	G.N. COMPLIES	93-90 36-62 36-71 37-725 37-726 37-727 37-741 37-742 37-751	HARASSMENT Required accessory off-street loading berths Required bicycle parking spaces Steps Permitted obstructions Hours of access Seatings Planting and trees Public space signage system	COMPLIES COMPLIES COMPLIES COMPLIES G.N.
93-50 93-51	SPECIAL HEIGHT AND SETBACKS REGULATIONS Special height and setback regulations in the large-scale plan subdistrict A	COMPLIES	93-90 36-62 36-71 37-725 37-726 37-727 37-741 37-742 37-751	HARASSMENT Required accessory off-street loading berths Required bicycle parking spaces Steps Permitted obstructions Hours of access Seatings Planting and trees Public space signage system	COMPLIES COMPLIES COMPLIES COMPLIES G.N.

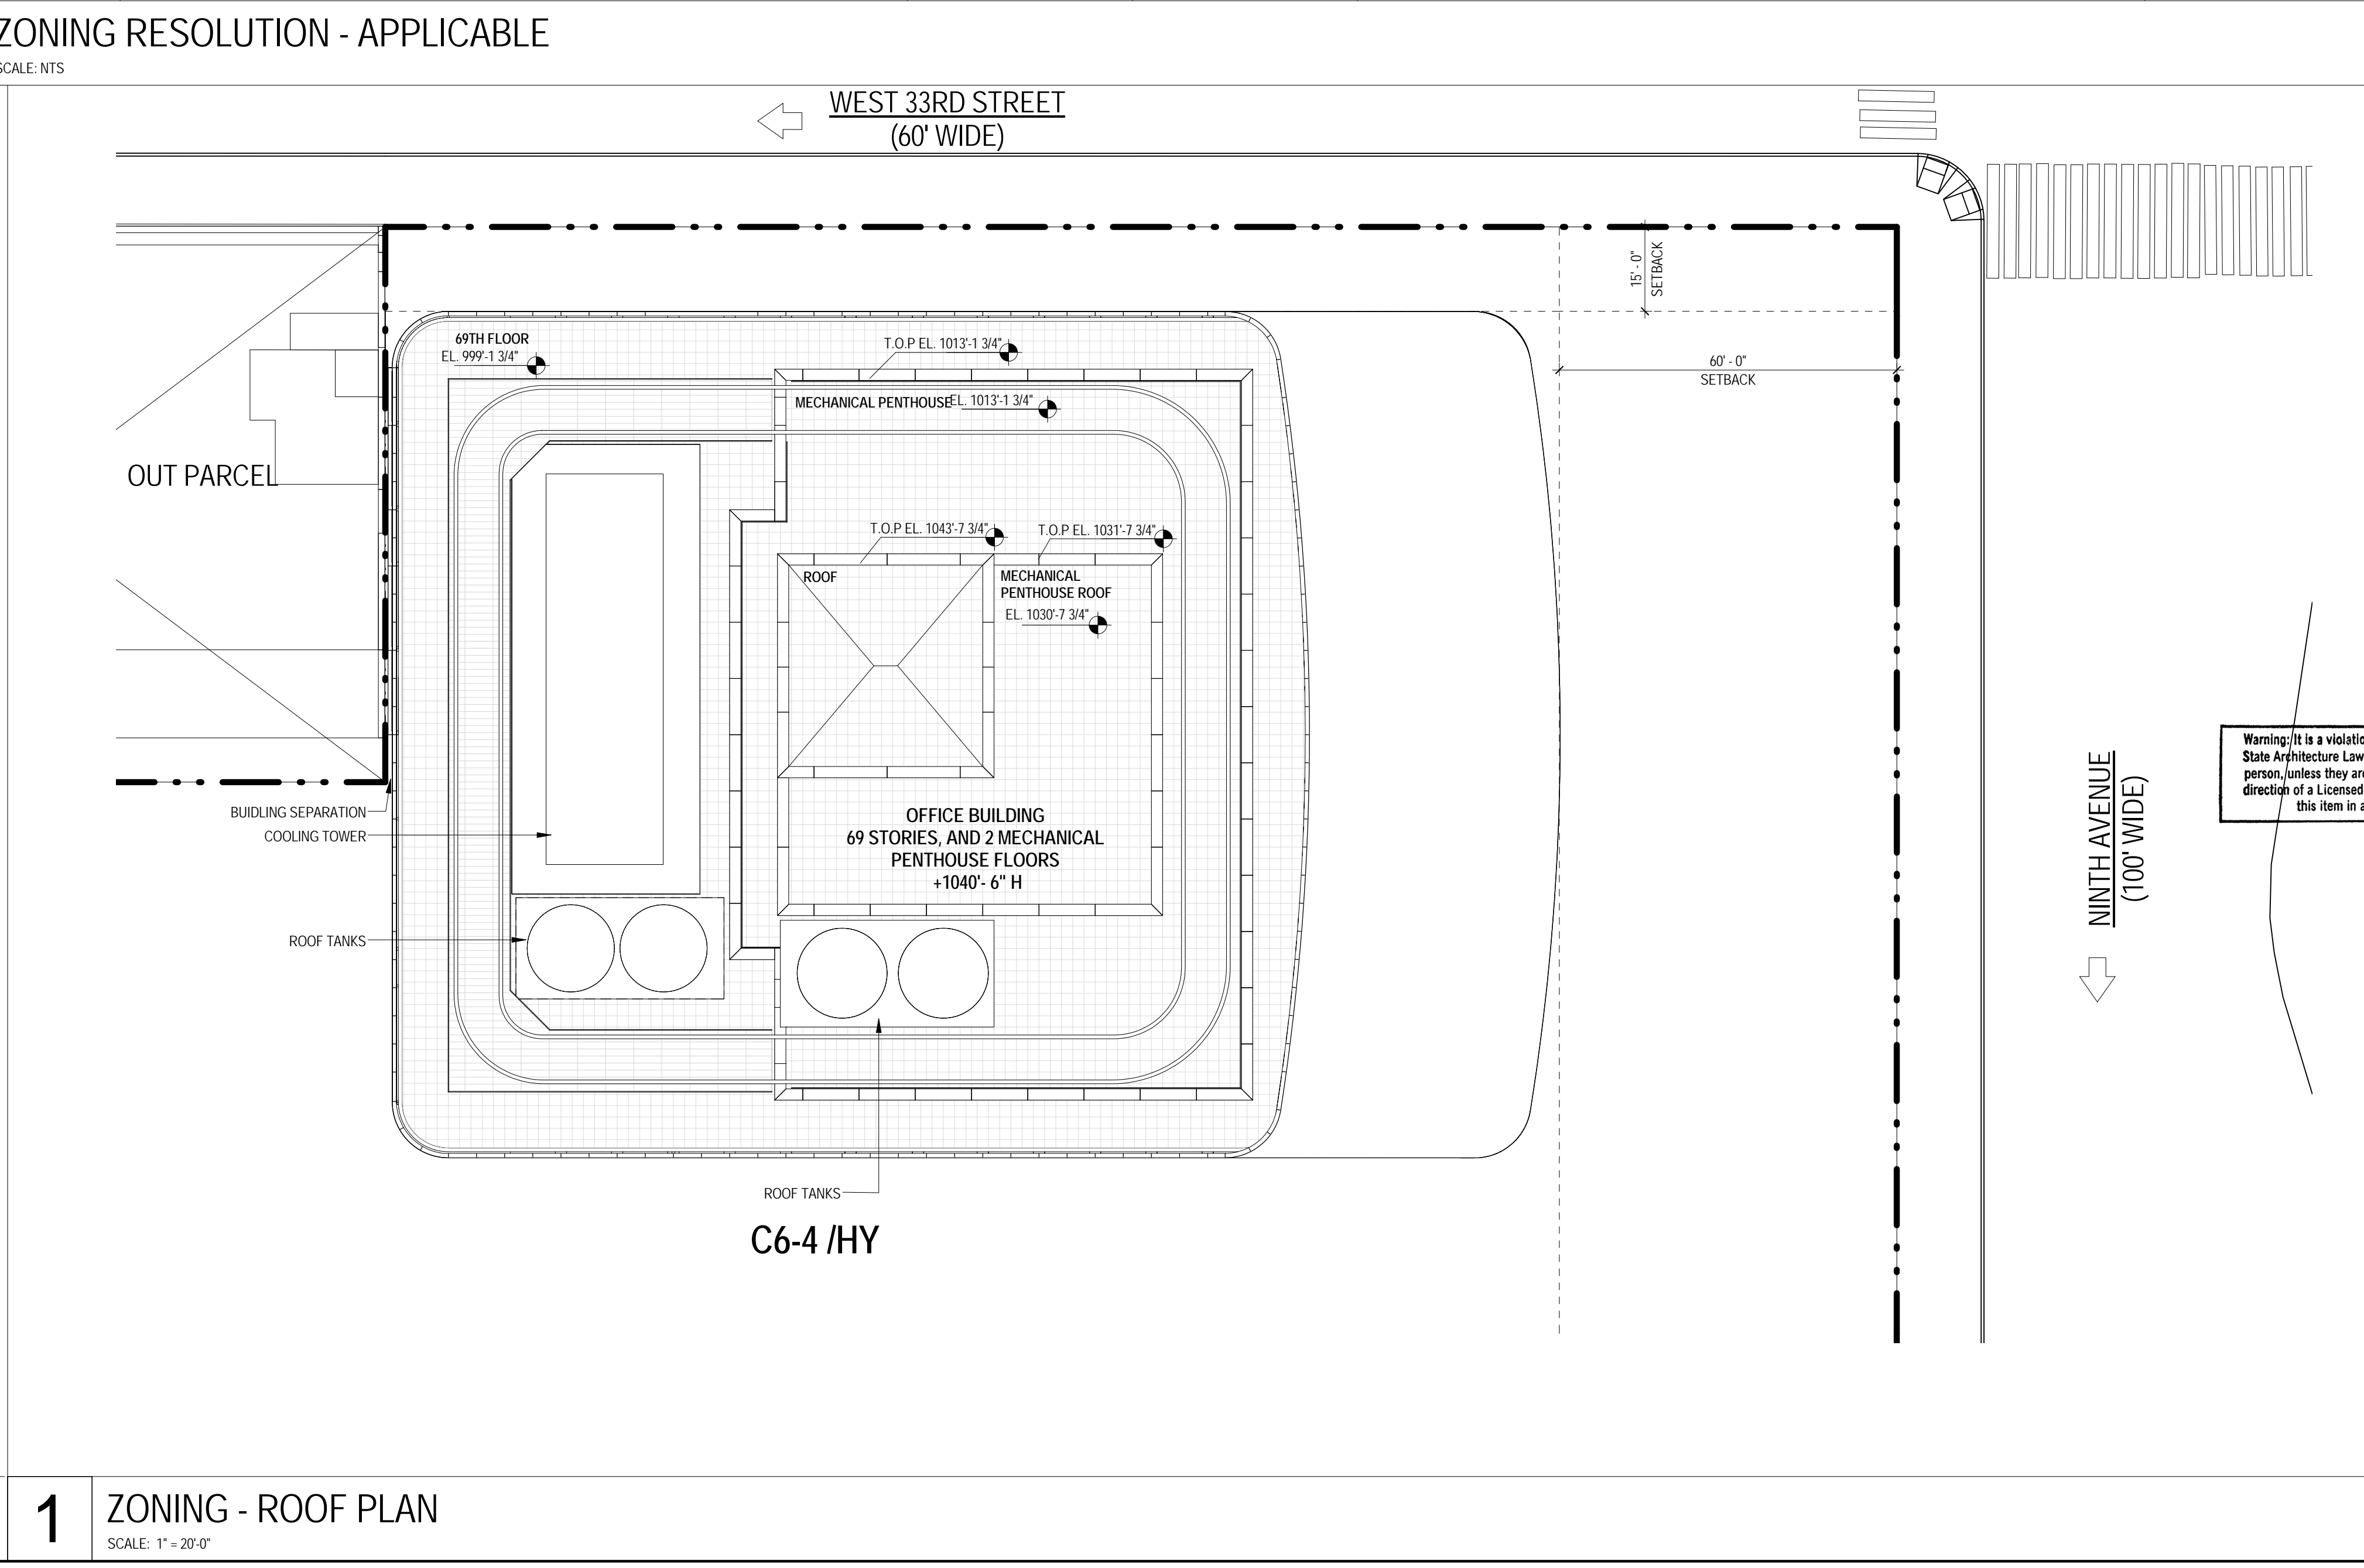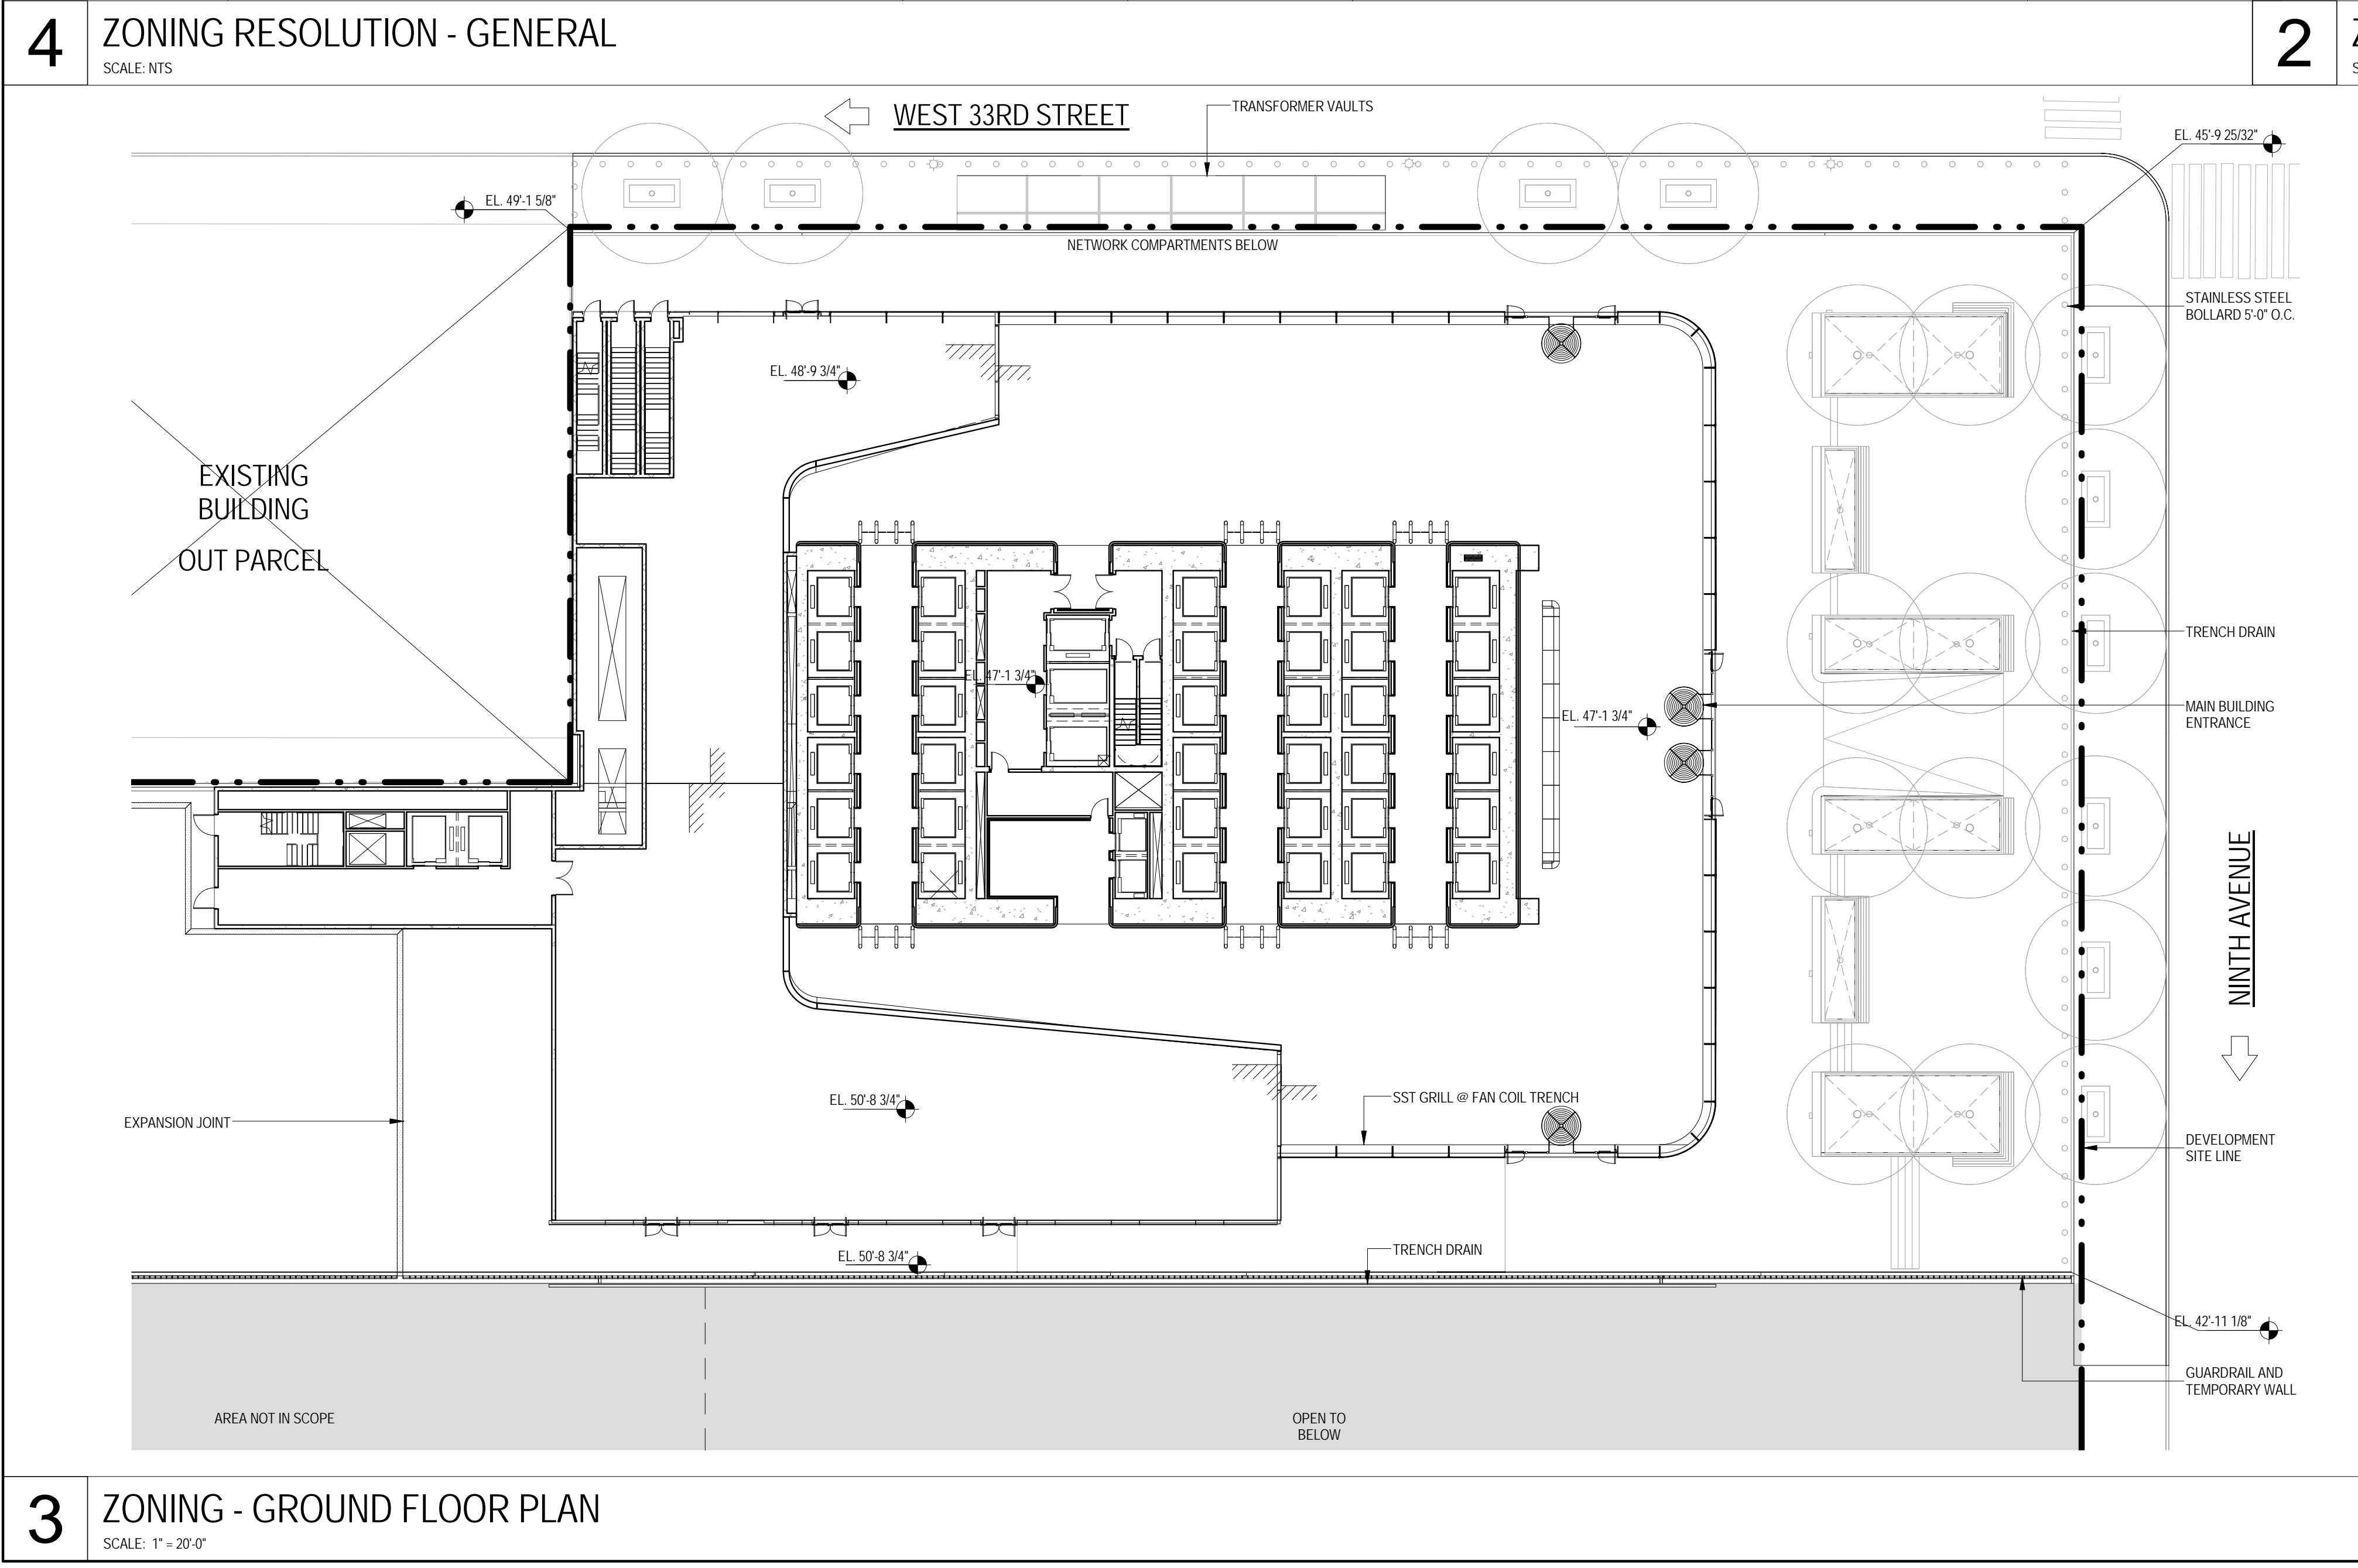

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Wind Tunnel Consultant
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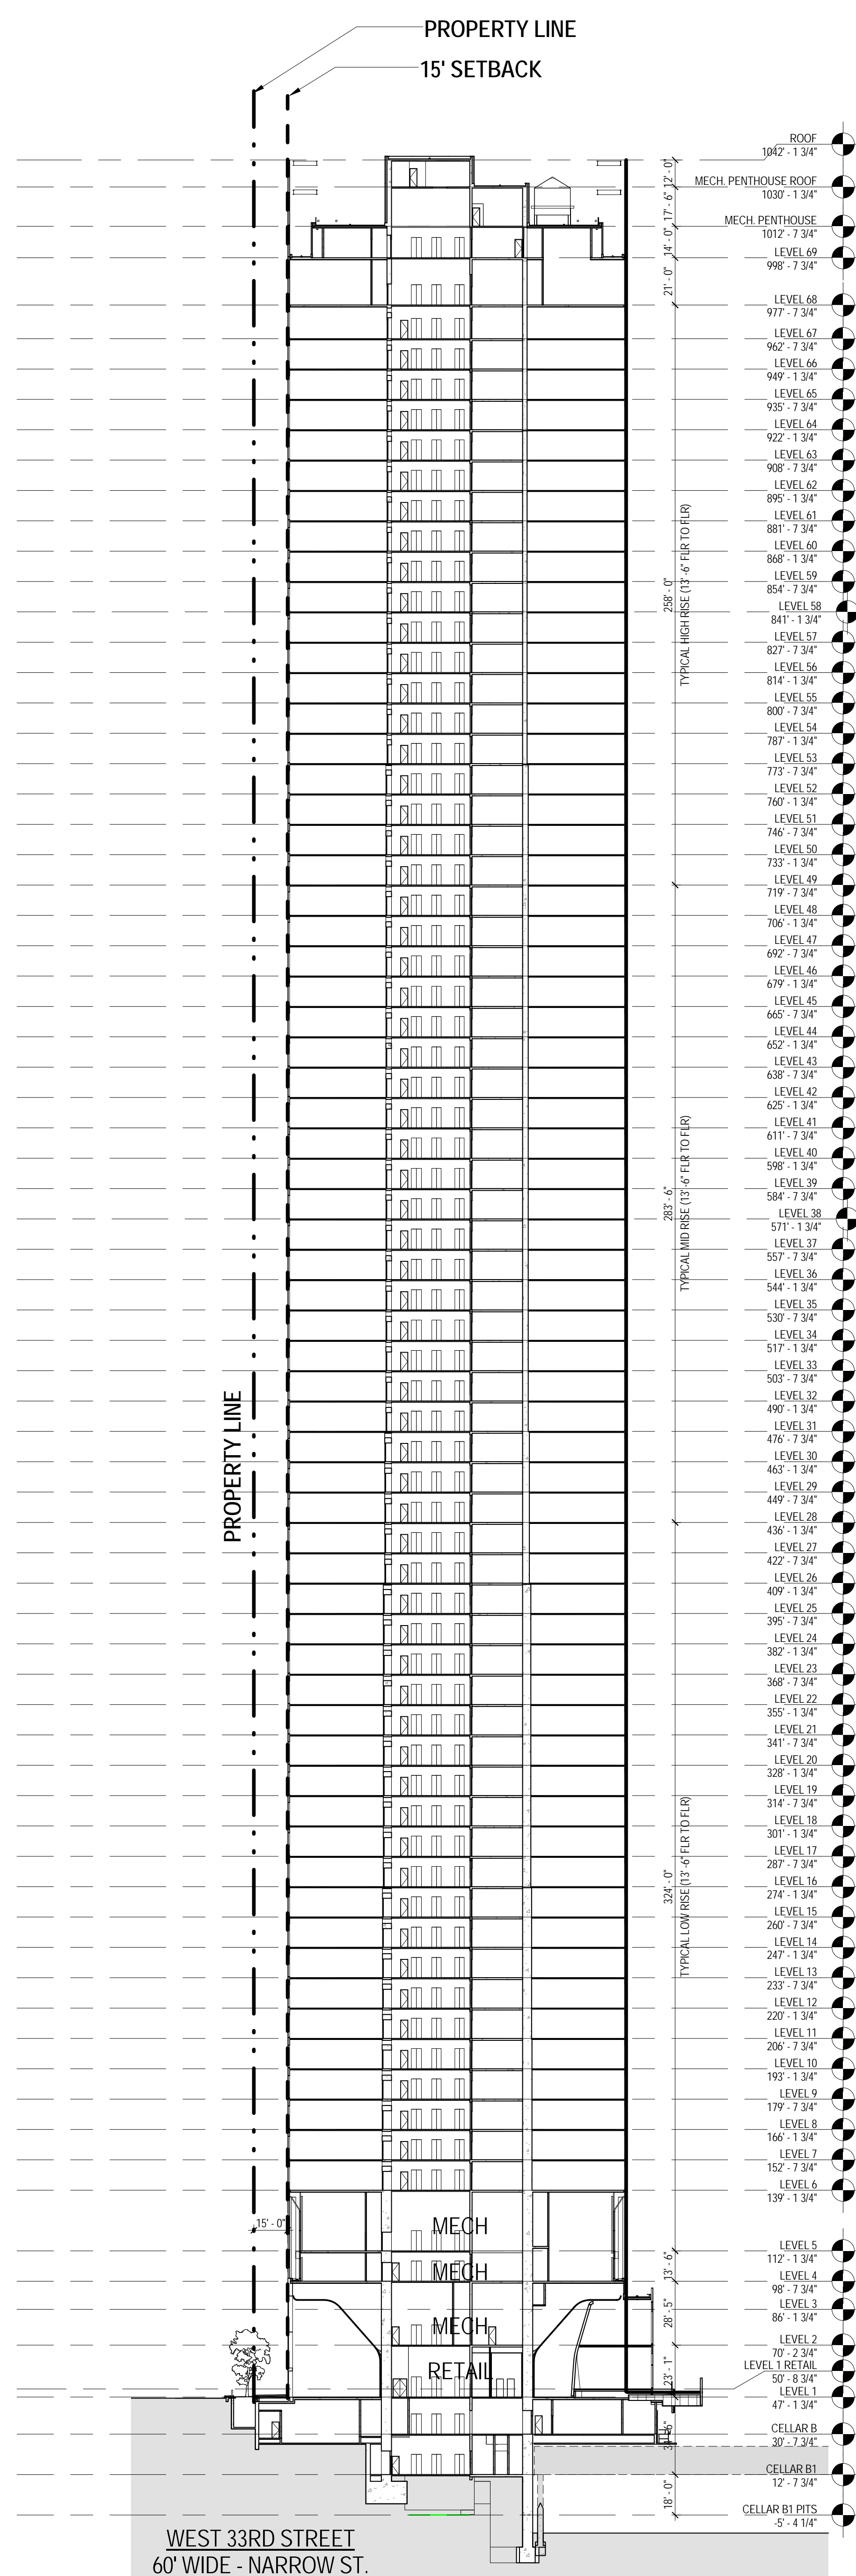
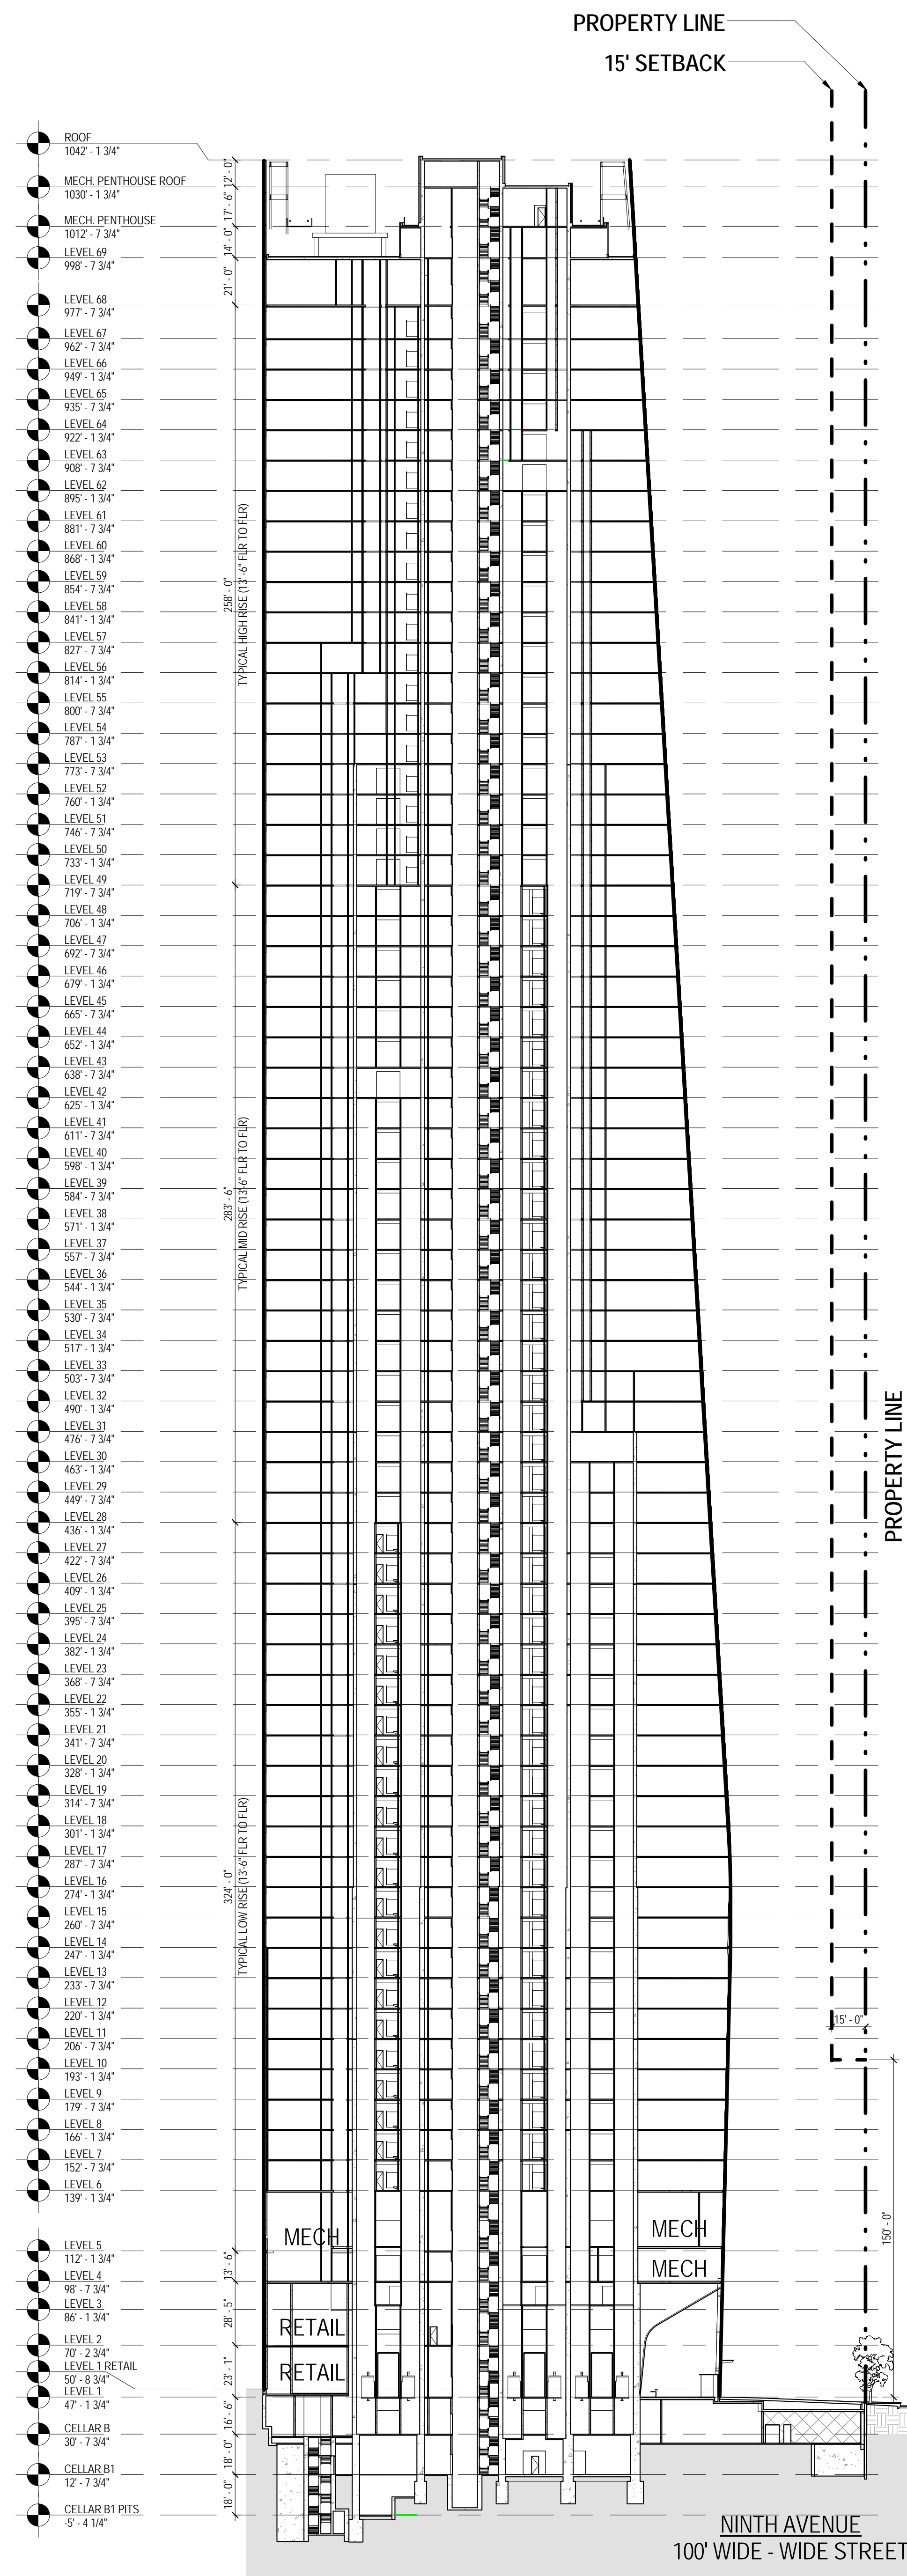
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2 20 JUN 2014 ISSUED FOR FOUNDATION PERMIT
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ZONING CALCULATIONS & ROOF PLAN

Project No.: 207150
Date: 20 JUN 2014
Scale: As indicated
File No.: Z-002

B-SCAN Sheet No.:
Z-002.00
Sheet No.:
Z-002
Page No.: 2 OF 28




HEIGHT AND SETBACK REGULATIONS (ZR 93-42)	
Max. base height on a wide street:	150 ft
Max. base height on a narrow street:	
-Within 100' of its intersection with wide street:	150 ft
-Beyond 100' of its intersection with wide street:	150 ft
-Weighted avg. base height on a narrow street:	120 ft (Approx.)

SPECIAL HEIGHT AND SETBACK REGULATIONS (ZR 93-522)
 Required setback on a wide street: 15 ft
 Required setback on a narrow street: 20 ft*
 *Exception: A building may rise without setback when no part of building is within 15' of street line.

2 ZONING RESOLUTION - HEIGHT & SETBACK REGULATIONS

FLOOR	FLOOR AREA SCHEDULE		RETAIL AREA	ZONING DEDUCTIONS	ZONING FLOOR AREA
	USE	GROSS FLOOR AREA (SF)			
CELLAR B1 PITS	Mechanical / Storage	2,742 R²	-	2,742 R²	-
CELLAR B1	Mechanical / Storage	7,782 R²	-	7,782 R²	-
CELLAR B	Mechanical / Storage	57,777 R²	-	57,777 R²	-
LEVEL 1	Office / Retail	33,862 R²	-	1,784 R²	-
LEVEL 2	Retail	14,162 R²	10,008 R²	1,250 R²	32,078 R²
LEVEL 3	Mechanical / Mezzanine	32,775 R²	10,115 R²	627 R²	12,912 R²
LEVEL 4	Mechanical	32,237 R²	-	32,237 R²	7,648 R²
LEVEL 5	Mechanical	20,296 R²	-	20,296 R²	-
LEVEL 6	Office	30,620 R²	-	2,631 R²	-
LEVEL 7	Office	30,646 R²	-	2,631 R²	27,989 R²
LEVEL 8	Office	30,673 R²	-	2,631 R²	28,015 R²
LEVEL 9	Office	30,699 R²	-	2,631 R²	28,042 R²
LEVEL 10	Office	30,726 R²	-	2,631 R²	28,068 R²
LEVEL 11	Office	30,753 R²	-	2,615 R²	28,095 R²
LEVEL 12	Office	30,780 R²	-	2,615 R²	28,137 R²
LEVEL 13	Office	30,807 R²	-	2,615 R²	28,164 R²
LEVEL 14	Office	30,812 R²	-	2,615 R²	28,191 R²
LEVEL 15	Office	30,831 R²	-	2,616 R²	28,196 R²
LEVEL 16	Office	30,832 R²	-	2,552 R²	28,215 R²
LEVEL 17	Office	30,807 R²	-	2,552 R²	28,280 R²
LEVEL 18	Office	30,756 R²	-	2,552 R²	28,255 R²
LEVEL 19	Office	30,637 R²	-	3,235 R²	28,204 R²
LEVEL 20	Office	30,517 R²	-	3,235 R²	27,402 R²
LEVEL 21	Office	30,396 R²	-	2,598 R²	27,262 R²
LEVEL 22	Office	30,276 R²	-	2,598 R²	27,198 R²
LEVEL 23	Office	30,155 R²	-	2,598 R²	27,678 R²
LEVEL 24	Office	30,035 R²	-	2,598 R²	27,557 R²
LEVEL 25	Office	29,915 R²	-	2,598 R²	27,437 R²
LEVEL 26	Office	29,794 R²	-	2,537 R²	27,317 R²
LEVEL 27	Office	29,674 R²	-	2,537 R²	27,257 R²
LEVEL 28	Office	29,553 R²	-	2,700 R²	27,137 R²
LEVEL 29	Office	29,433 R²	-	2,700 R²	26,853 R²
LEVEL 30	Office	29,313 R²	-	3,692 R²	26,733 R²
LEVEL 31	Office	29,192 R²	-	3,074 R²	25,622 R²
LEVEL 32	Office	29,072 R²	-	3,489 R²	26,118 R²
LEVEL 33	Office	28,951 R²	-	2,646 R²	25,882 R²
LEVEL 34	Office	28,831 R²	-	2,646 R²	26,305 R²
LEVEL 35	Office	28,711 R²	-	2,646 R²	26,185 R²
LEVEL 36	Office	28,590 R²	-	2,646 R²	26,065 R²
LEVEL 37	Office	28,470 R²	-	2,646 R²	25,944 R²
LEVEL 38	Office	28,349 R²	-	2,646 R²	25,823 R²
LEVEL 39	Office	28,229 R²	-	2,646 R²	25,703 R²
LEVEL 40	Office	28,109 R²	-	2,646 R²	25,583 R²
LEVEL 41	Office	27,989 R²	-	2,646 R²	25,463 R²
LEVEL 42	Office	27,868 R²	-	3,557 R²	25,342 R²
LEVEL 43	Office	27,747 R²	-	2,674 R²	24,311 R²
LEVEL 44	Office	27,627 R²	-	2,674 R²	25,073 R²
LEVEL 45	Office	27,507 R²	-	2,674 R²	24,953 R²
LEVEL 46	Office	27,386 R²	-	2,674 R²	24,833 R²
LEVEL 47	Office	27,266 R²	-	2,674 R²	24,712 R²
LEVEL 48	Office	27,145 R²	-	2,674 R²	24,592 R²
LEVEL 49	Office	27,025 R²	-	2,700 R²	24,471 R²
LEVEL 50	Office	26,905 R²	-	2,700 R²	24,325 R²
LEVEL 51	Office	26,784 R²	-	2,700 R²	24,205 R²
LEVEL 52	Office	26,664 R²	-	3,653 R²	24,084 R²
LEVEL 53	Office	26,543 R²	-	3,199 R²	23,011 R²
LEVEL 54	Office	26,423 R²	-	3,577 R²	23,344 R²
LEVEL 55	Office	26,303 R²	-	3,175 R²	22,846 R²
LEVEL 56	Office	26,182 R²	-	3,575 R²	23,128 R²
LEVEL 57	Office	26,062 R²	-	2,723 R²	22,807 R²
LEVEL 58	Office	25,941 R²	-	2,723 R²	23,338 R²
LEVEL 59	Office	25,821 R²	-	2,723 R²	23,218 R²
LEVEL 60	Office	25,701 R²	-	2,723 R²	23,098 R²
LEVEL 61	Office	25,580 R²	-	2,723 R²	22,978 R²
LEVEL 62	Office	25,460 R²	-	3,658 R²	22,857 R²
LEVEL 63	Office	25,339 R²	-	3,241 R²	21,801 R²
LEVEL 64	Office	25,219 R²	-	2,673 R²	22,099 R²
LEVEL 65	Office	25,099 R²	-	2,673 R²	22,546 R²
LEVEL 66	Office	24,978 R²	-	2,673 R²	22,426 R²
LEVEL 67	Office	24,858 R²	-	2,673 R²	22,305 R²
LEVEL 68	Mechanical	24,724 R²	-	24,724 R²	22,185 R²
LEVEL 69	Mechanical	9,843 R²	-	3,208 R²	-
MECH. PENTHOUSE	Mechanical Penthouse	4,003 R²	-	4,003 R²	-
MECH. PENTHOUSE ROOF	Mechanical Penthouse	1,534 R²	-	1,534 R²	6,635 R²
Grand total		1,976,602 R²	20,123 R²	331,941 R²	1,644,660 R²

FAR: 1,644,660 SF/ 213,629 SF = 7.7

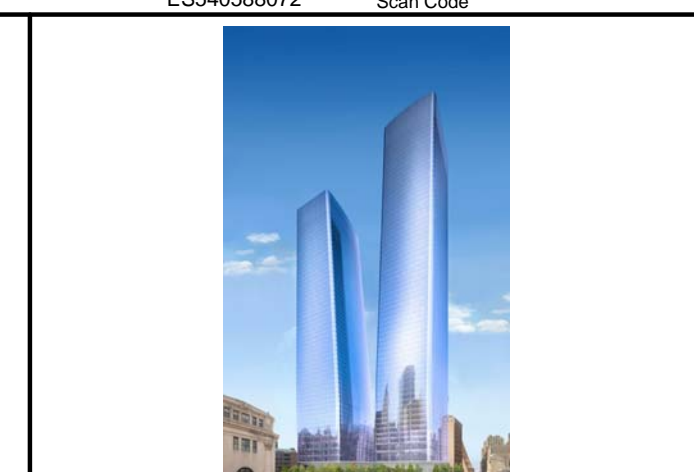

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PRELIMINARY
CONSTRUCTION

NOT FOR



33RD STREET

PARK AVENUE

B

A

MAIN AVENUE

24th Street



Seal & Signature:



NY 564

3	12 SEPT 2014	ISSUED FOR FOUNDATION PERMIT

No.	Date	Description
Sheet Name:		


HEIGHT & SETBACK

SECTIONS /
FLOOR AREA
COVERED

SCHEDULE

Project No.: 207120	B-SCAN SHEET NO.: Z-003.00
Date: 12 SEPT 2014	Sheet No.:

As indicated	Z-003
File No.: Z-003	Page No.: 3 OF 30

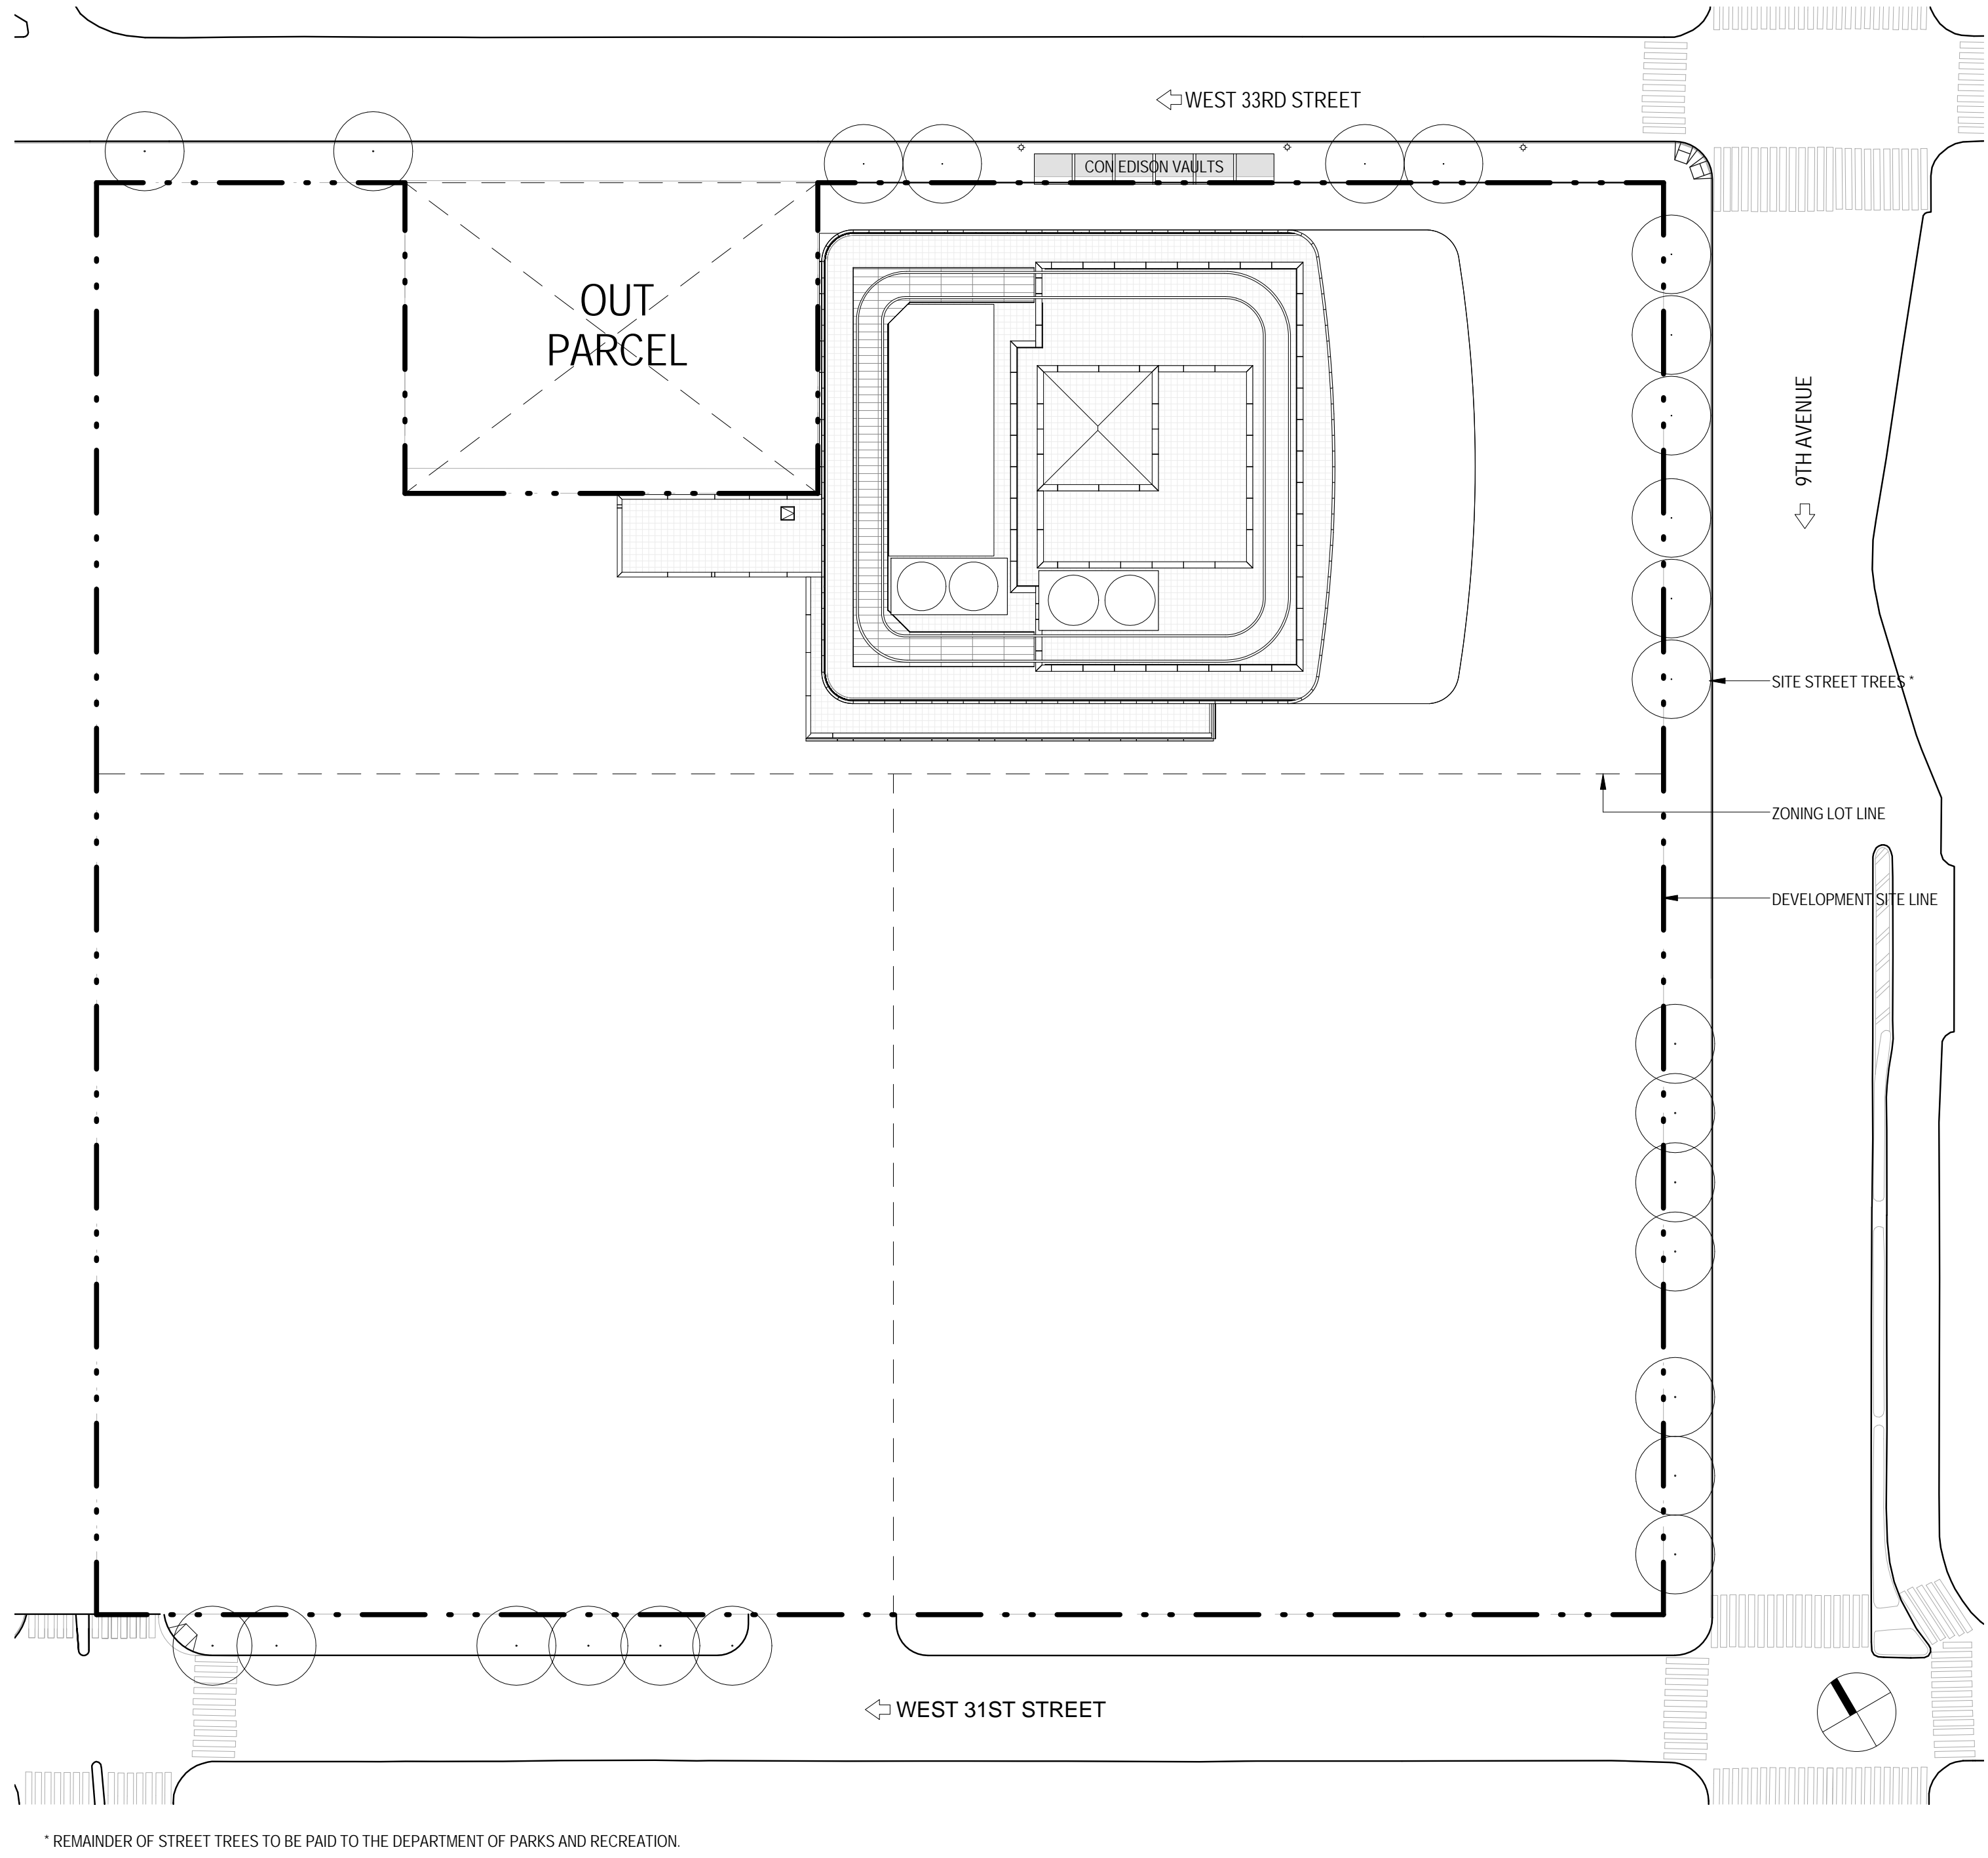

1 STREET TREES PLANTING

SCALE: 1" = 40'-0"


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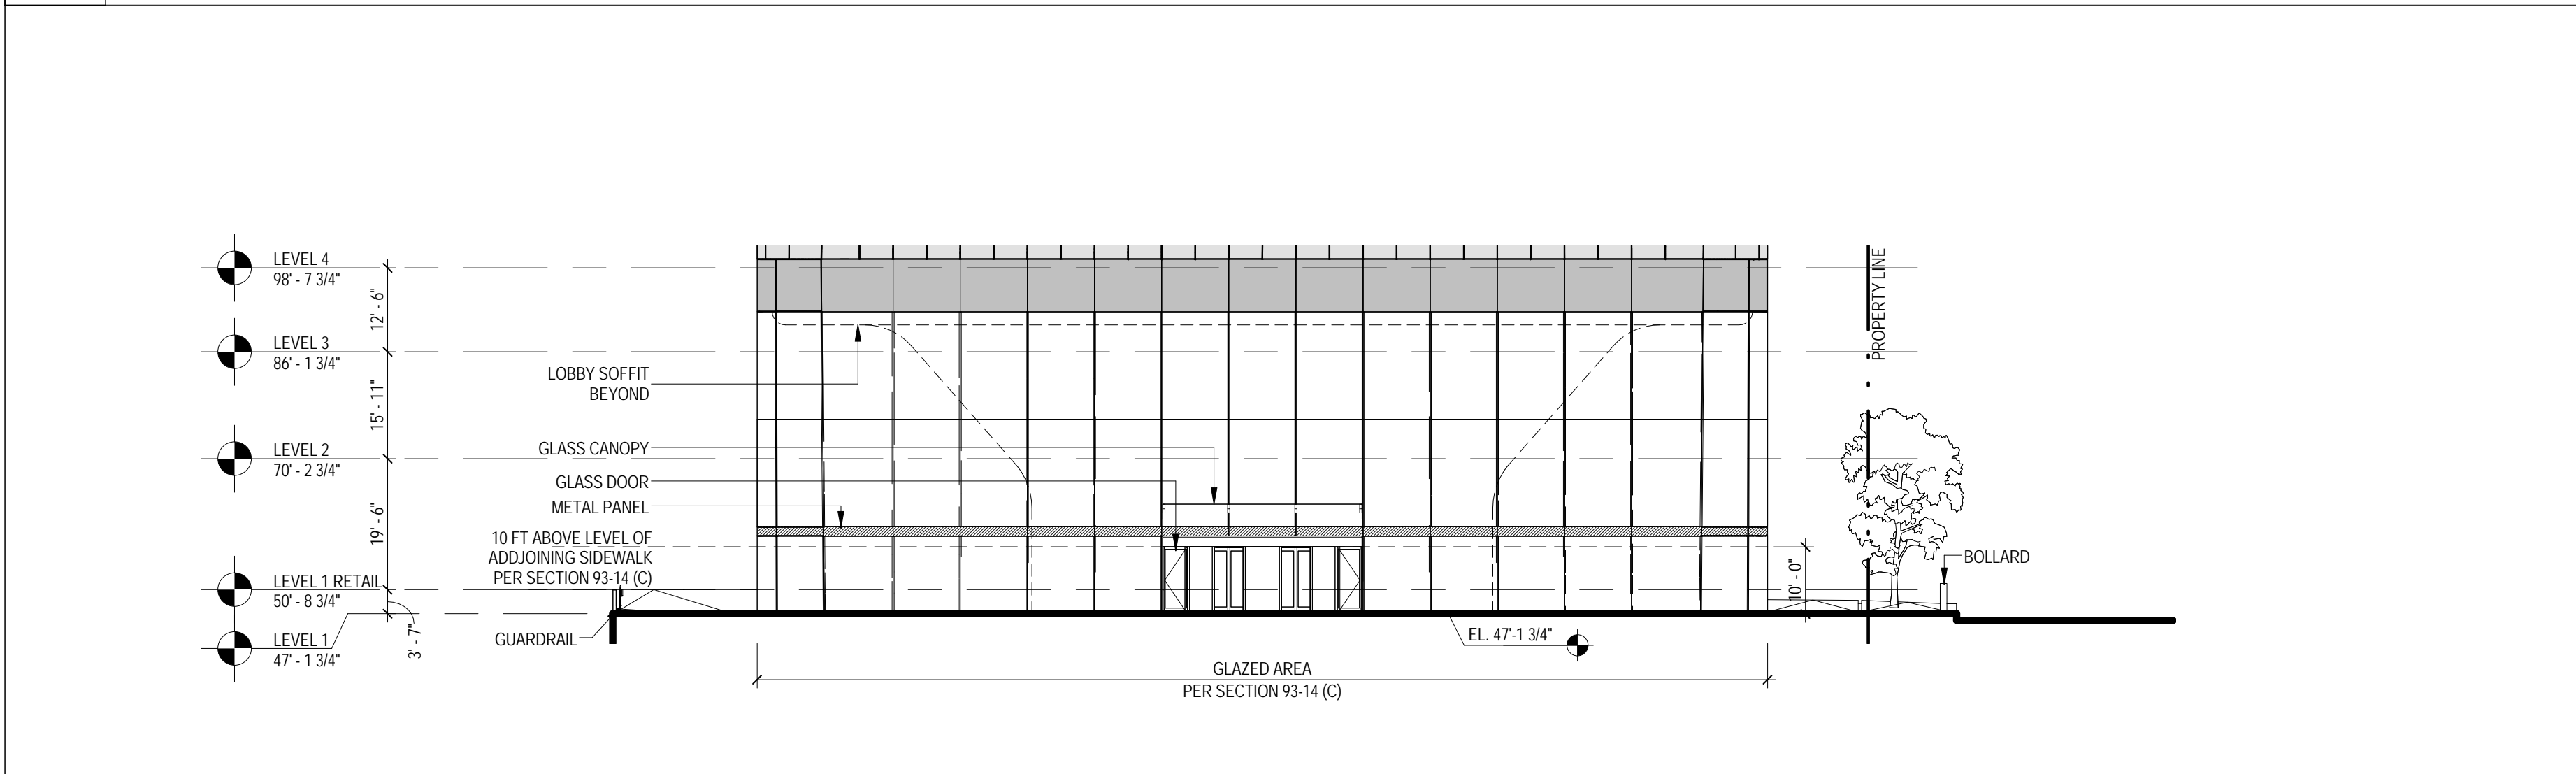
STREET TREES PLANTING

Project No.: 207150	B-SCAN Sheet No.: Z-004.00
Date: 20 JUN 2014	Sheet No.: Z-004
Scale: 1" = 40'-0"	Page No.: 4 OF 28
File No.: Z-004	


SECTION	ITEM	COMPLIANCE
93-73	PUBLIC ACCESS AREAS ON NINTH AVENUE RAIL YARD	
93-61	SIDEWALK WIDENING 5'-0" on 33rd Street and 9th Avenue	COMPLIES
93-732	CERTIFICATION FOR PUBLIC ACCESS AREAS ON THE NINTH AVENUE RAIL YARD Certification required as per section above.	
93-73(a)(2)(iv)	GROUND FLOOR TRANSPARENCY In accordance with Section 93-14, shall apply to at least 70% of the length of all building walls facing entry plaza.	COMPLIES (See 21Z-005.00)
4	ZONING RESOLUTION - PUBLIC ACCESS AREA REQUIREMENTS SCALE: NTS	



3 PUBLIC ACCESS AREAS - ENTRY PLAZA
SCALE: 1/16" = 1'-0"

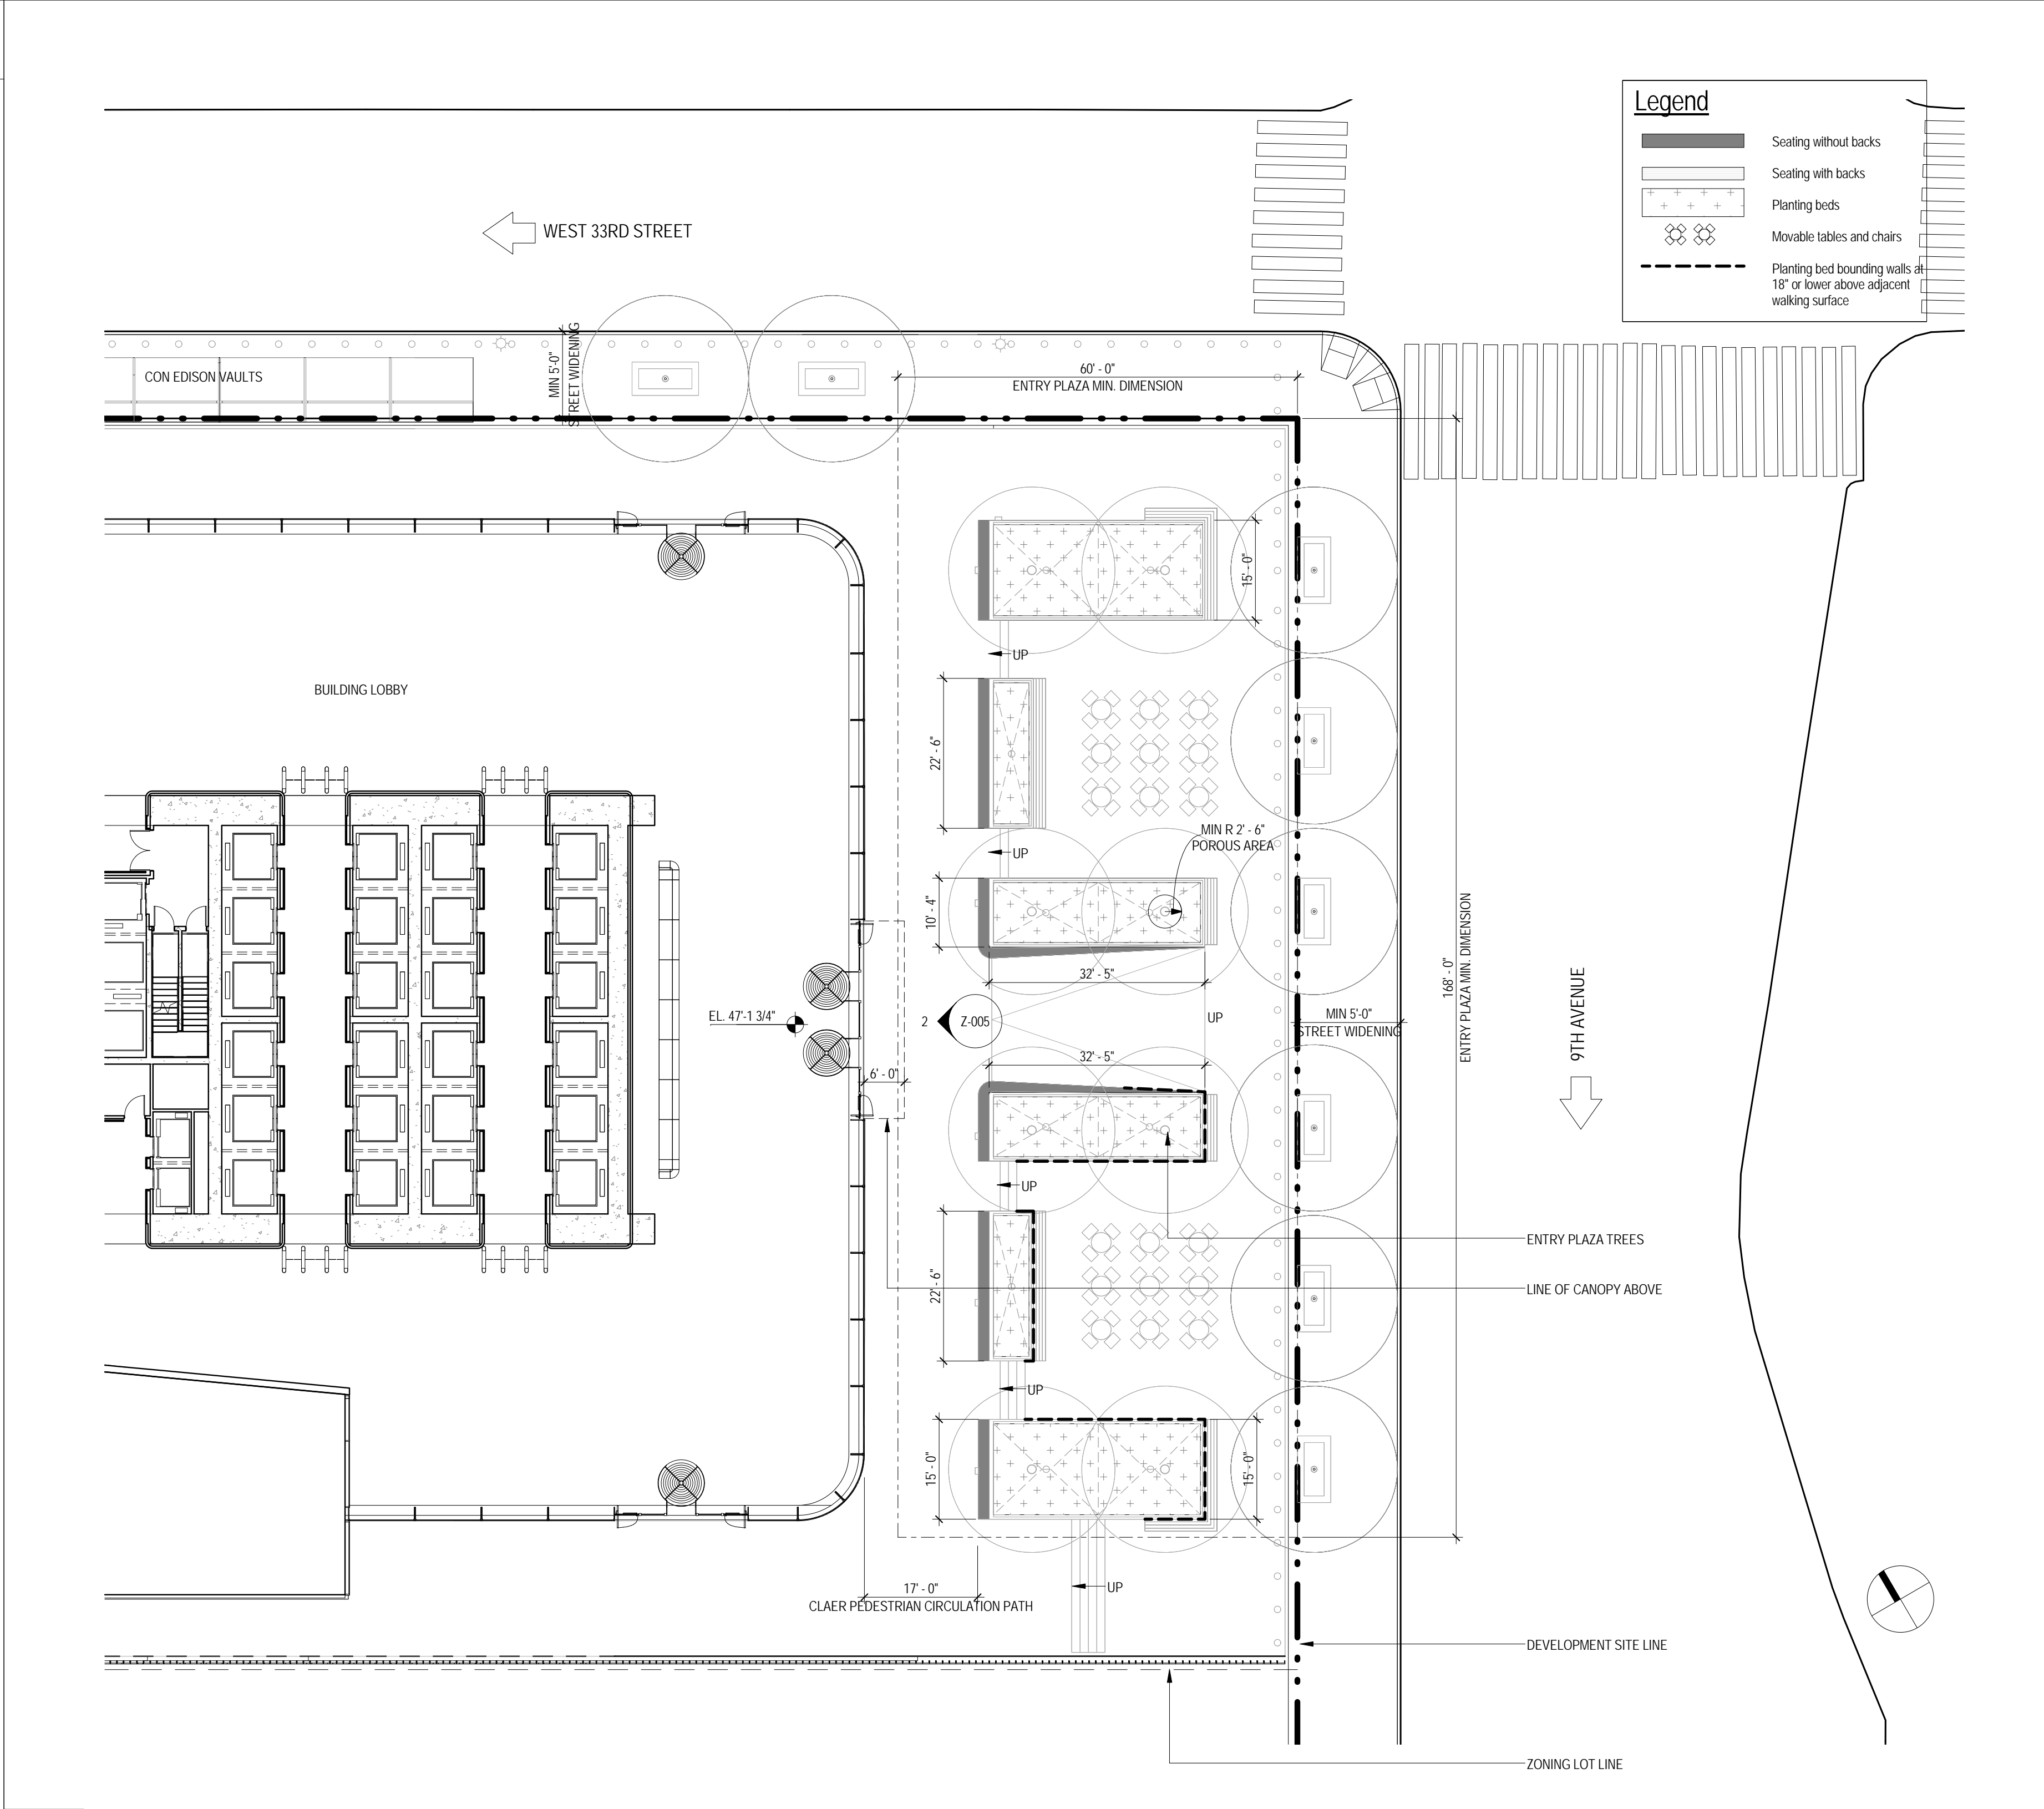

2 ENLARGED BUILDING ELEVATION FACING ENTRY PLAZA
SCALE: 1" = 20'-0"

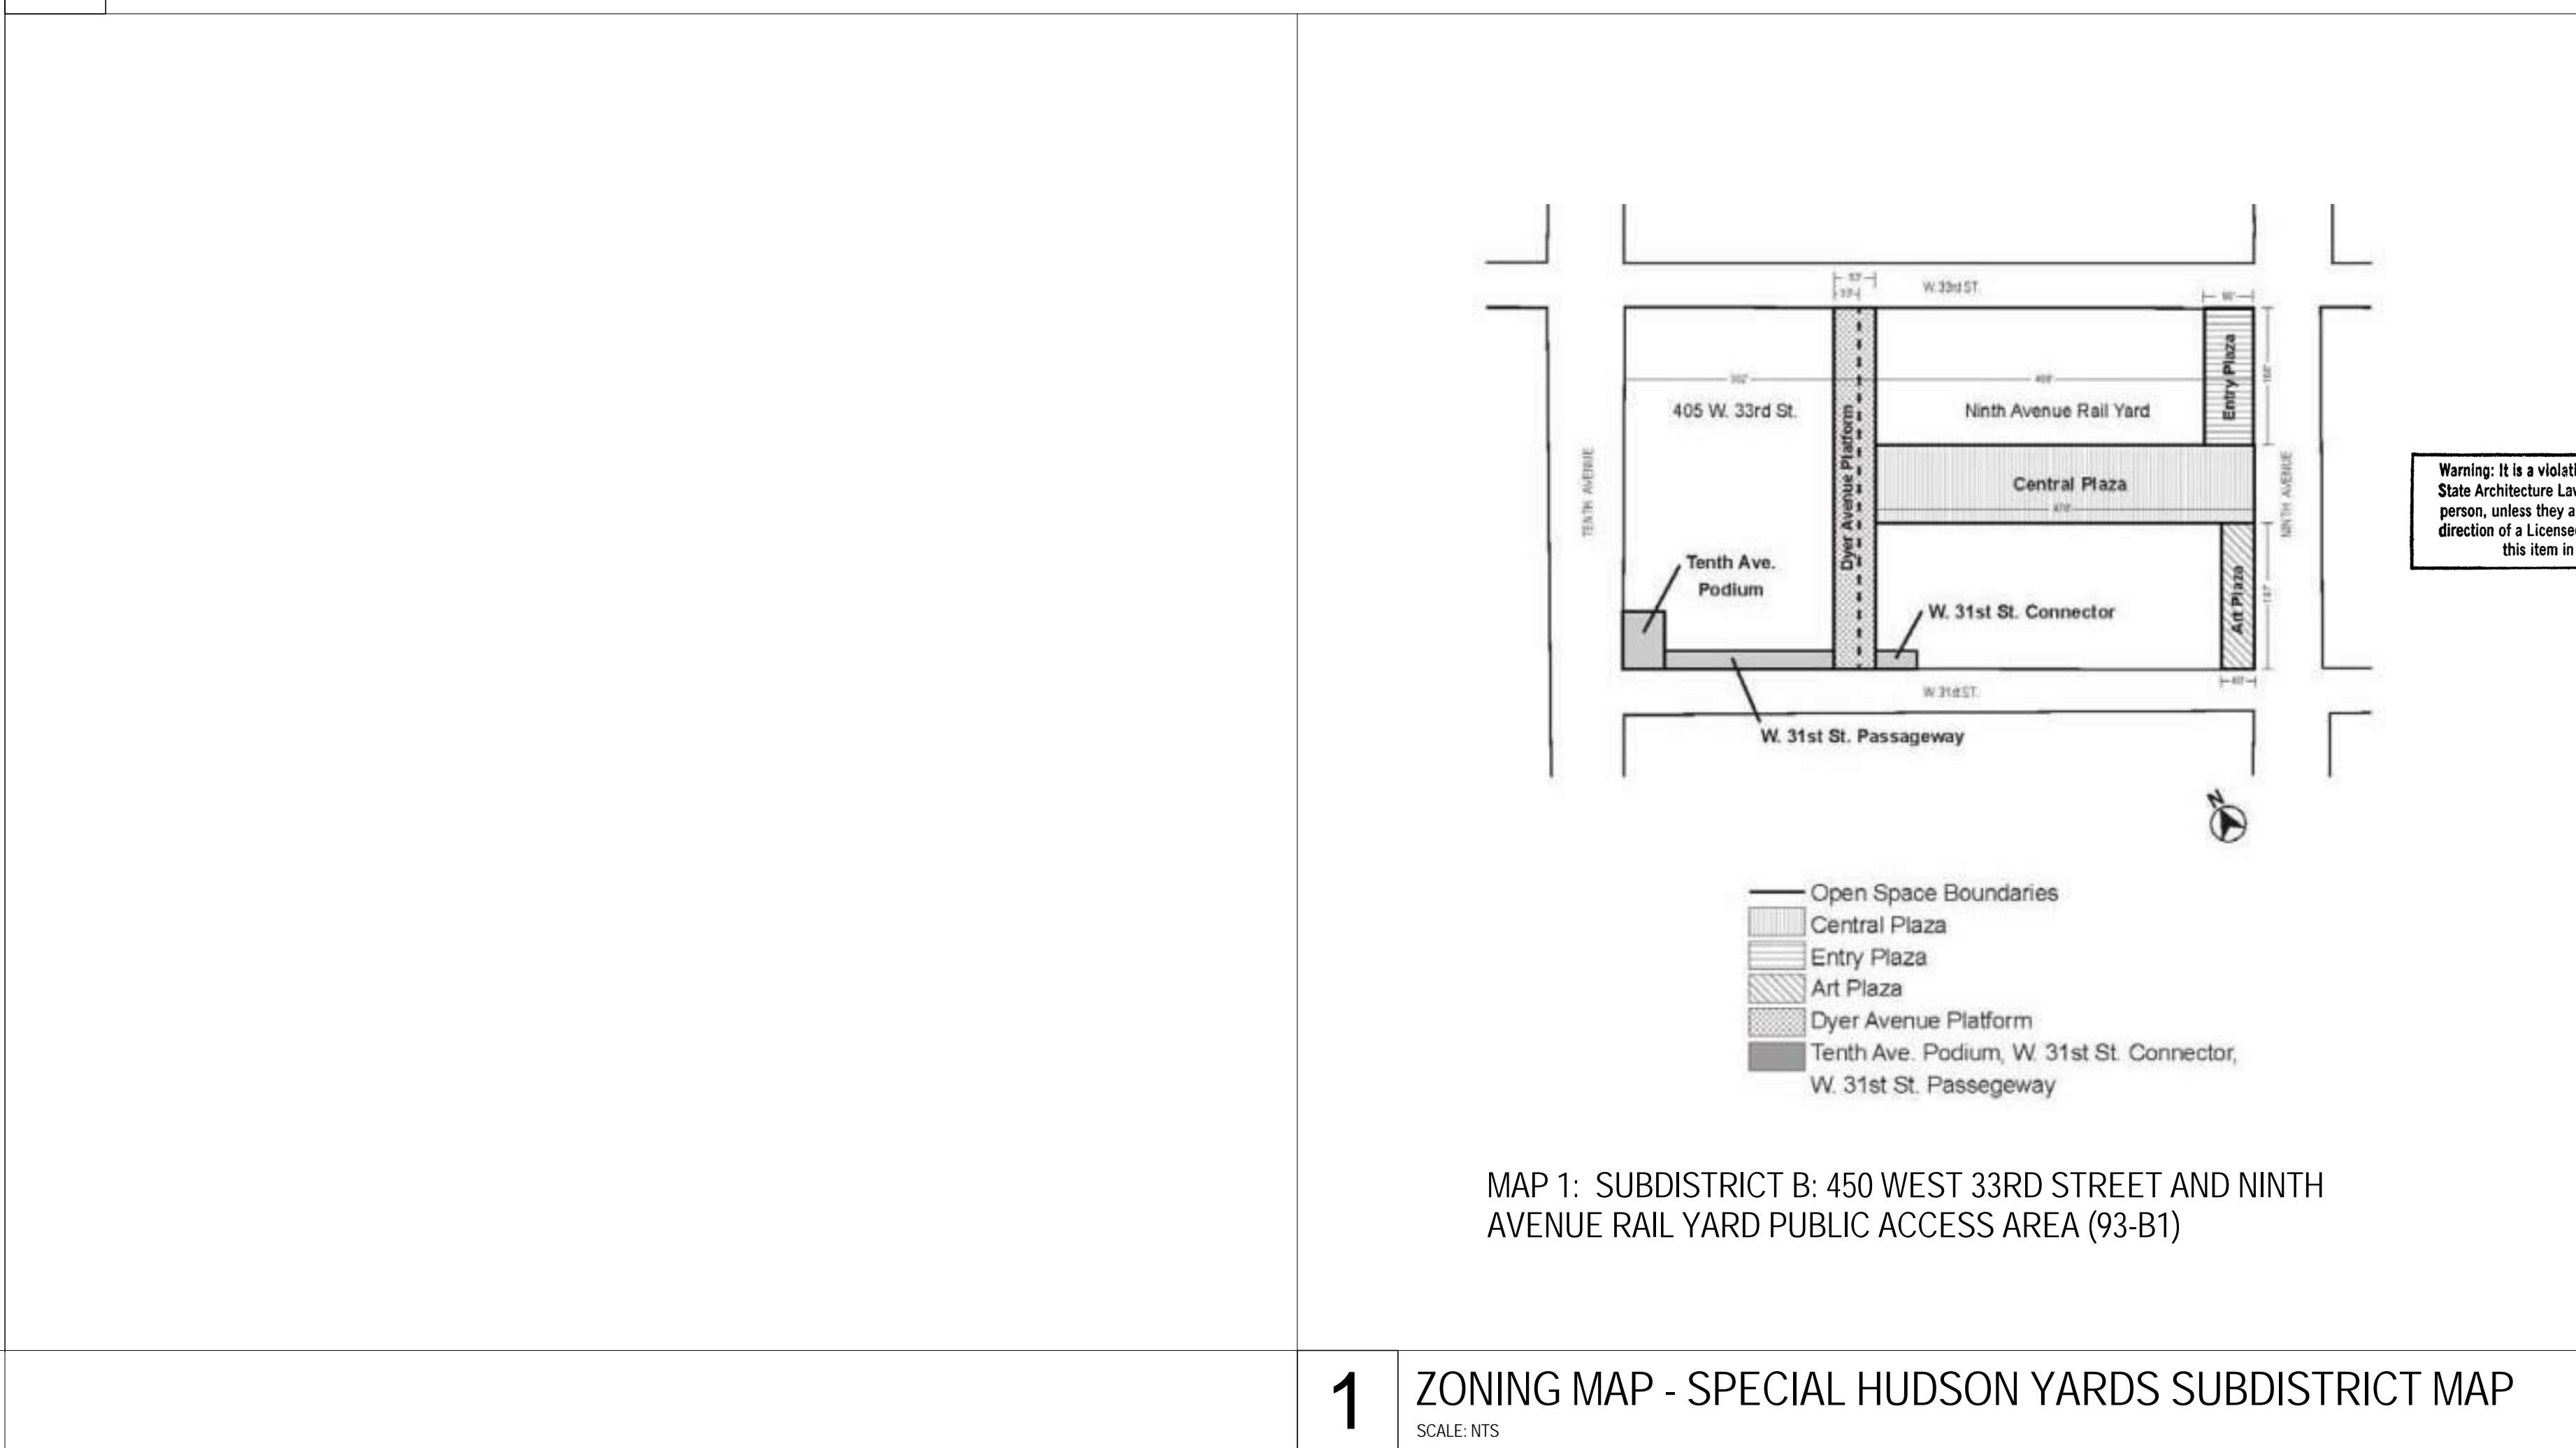

1 ZONING MAP - SPECIAL HUDSON YARDS SUBDISTRICT MAP
SCALE: NTS

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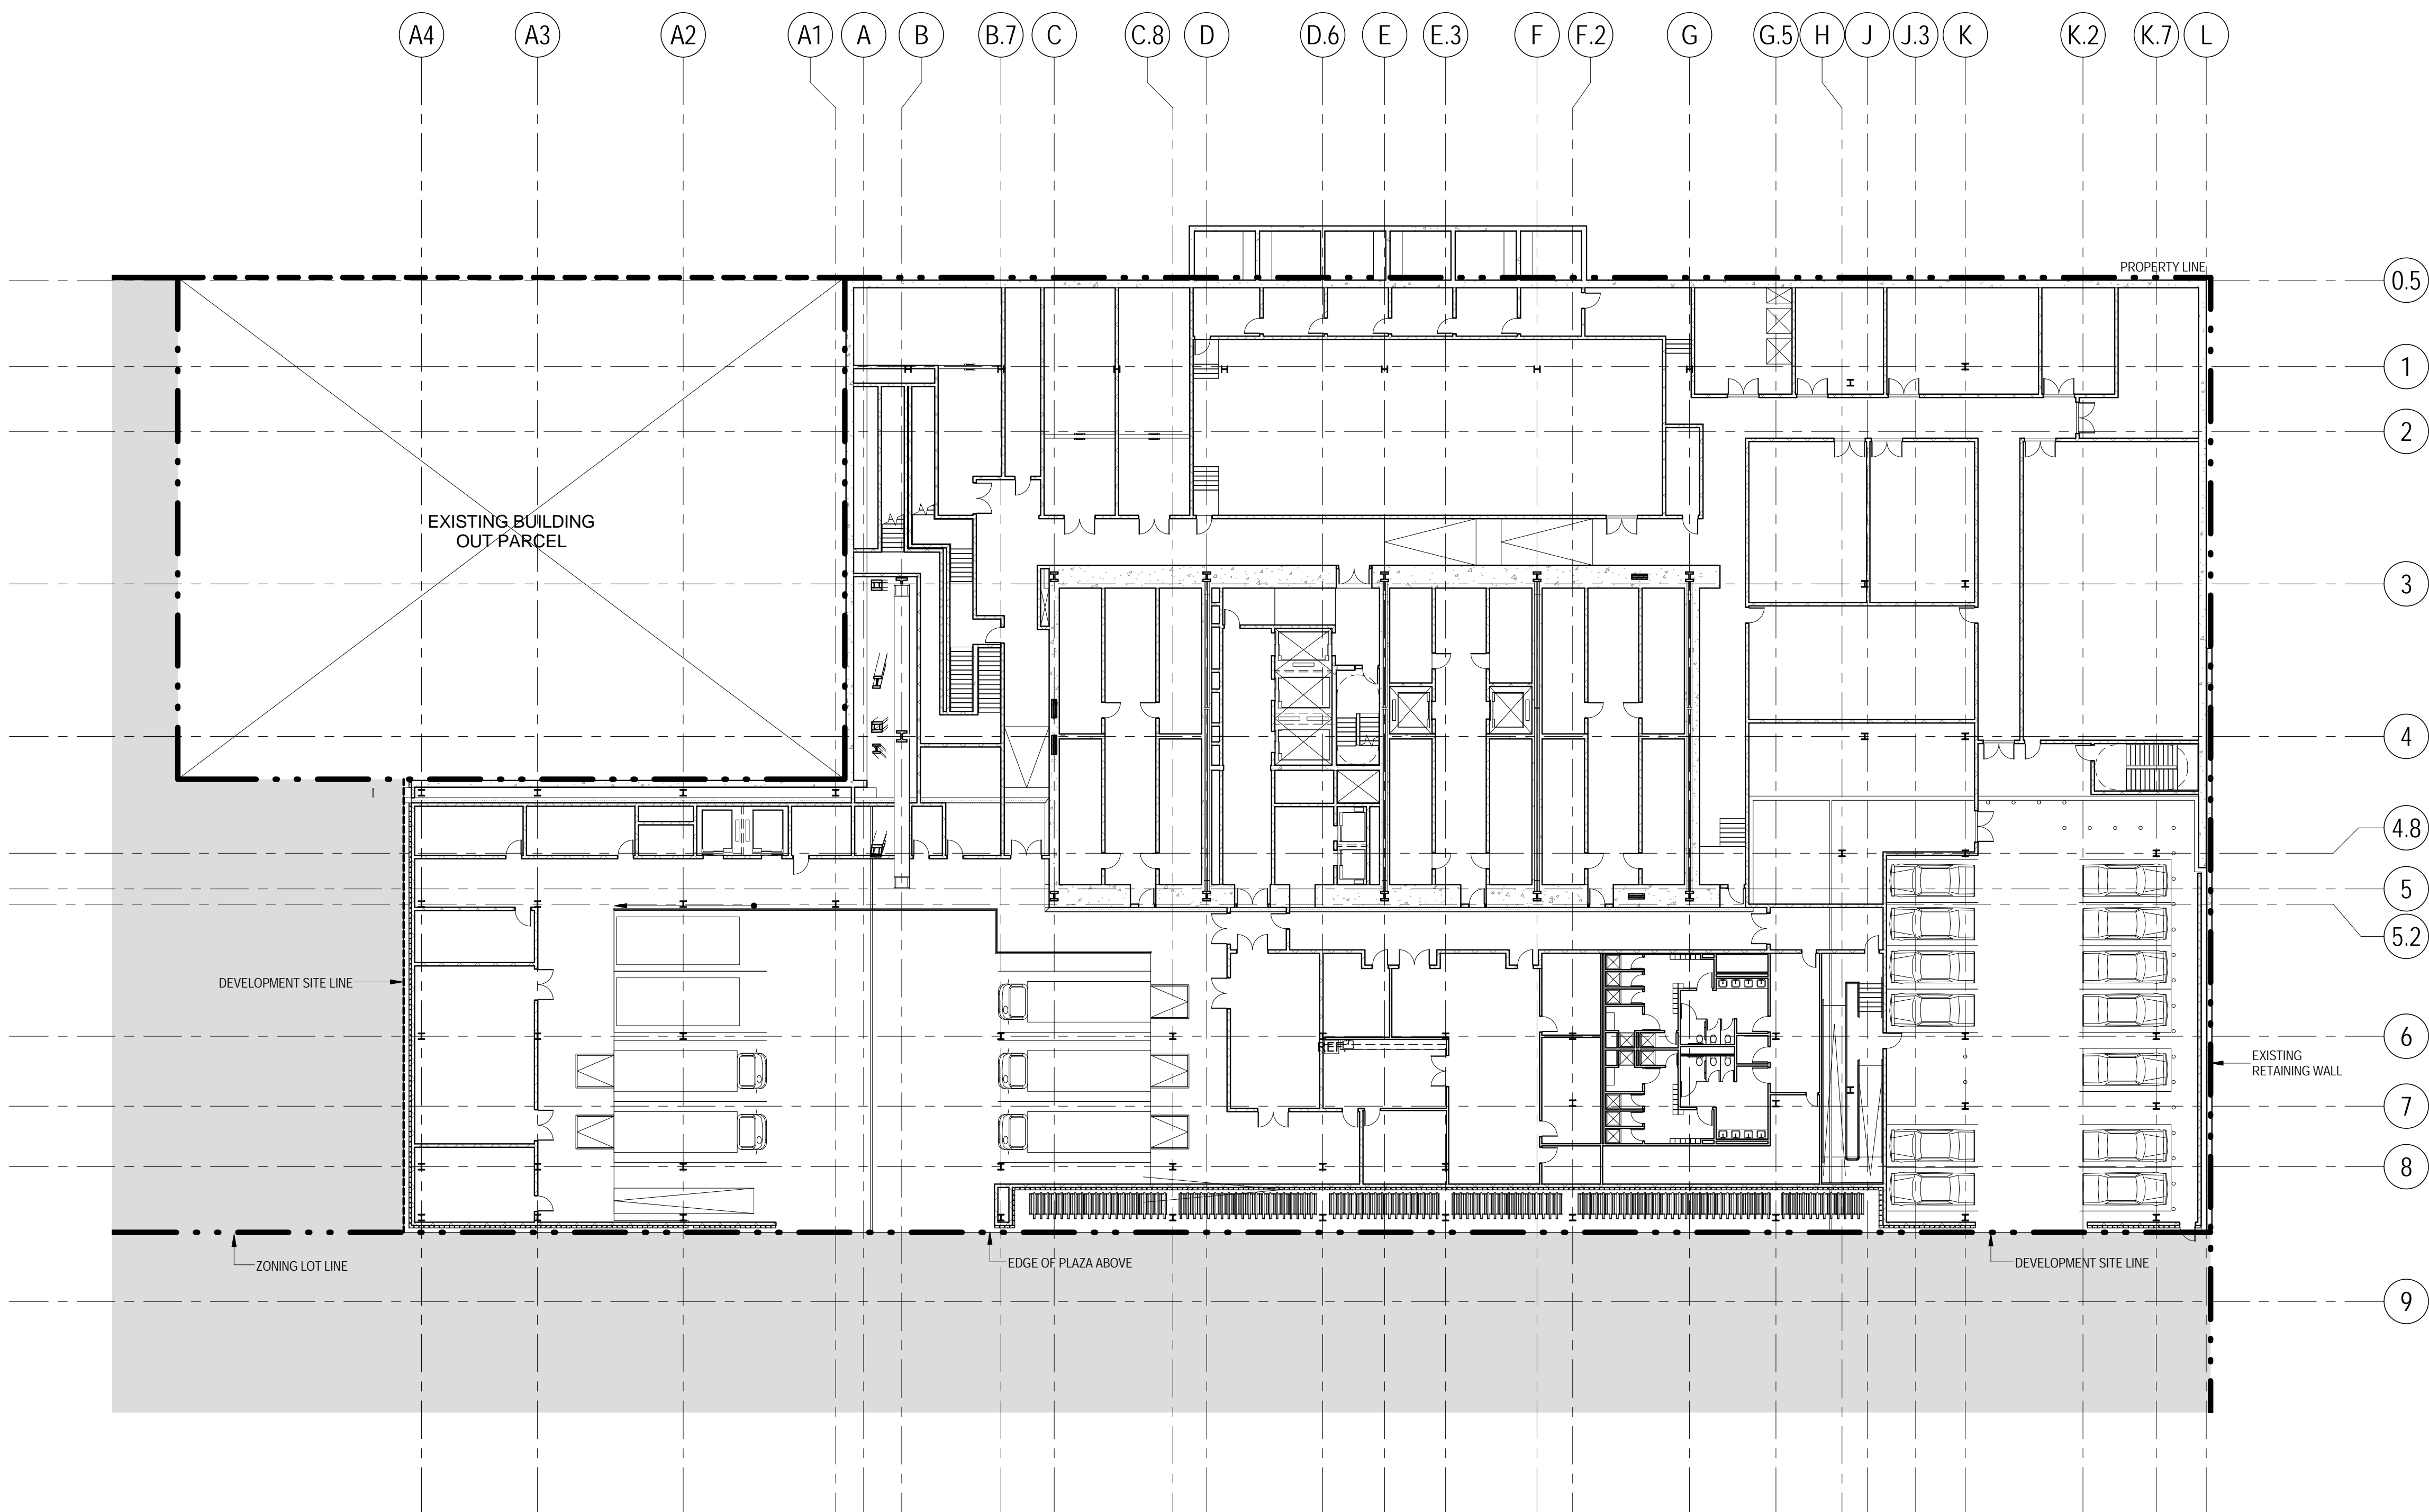
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2	20 JUN 2014	ISSUED FOR FOUNDATION PERMIT
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PUBLIC ACCESS AREAS - ENTRY PLAZA

Project No.: 207150	B-SCAN Sheet No.: Z-005.00
Date: 20 JUN 2014	Sheet No.: Z-005
Scale: As indicated	Page No.: 5 OF 28
File No: Z-005	



ACCESSORY OFF-STREET LOADING BERTHS (ZR 36-62)

Berths required for office use

First 100,000 ft²:	0 berths
Next 200,000 ft²:	1 berth
Each additional 300,000 ft²:	1 berth
Total:	5.4 berths
(1,624,537 ft² - 300,000 ft²) / 300,000 ft²	


Berths required for retail use

First 25,000 ft²:	0 berths
Next 15,000 ft²:	1 berth
Next 60,000 ft²:	1 berth
Each additional 150,000 ft²:	1 berth
Total:	0 berths
(20,123 ft² - 100,000 ft²) / 150,000 ft²	

Provided: 7 accessory off-street loading berths (COMPLIES)


OFF STREET PARKING REGULATIONS (ZR 93-81)

Provided: 13 parking spaces*
*Chairperson certification required

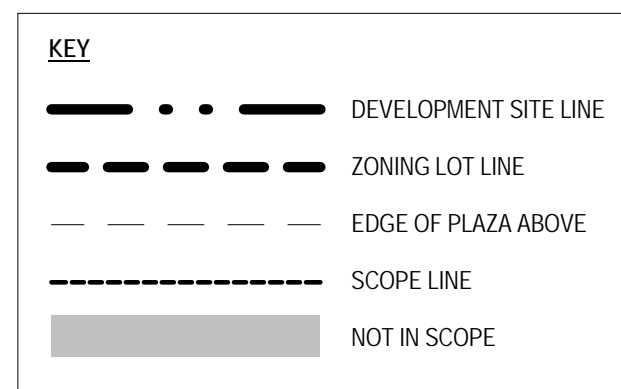

4 CELLAR B PLAN - LOADING DOCK

SCALE: 1" = 20'-0"

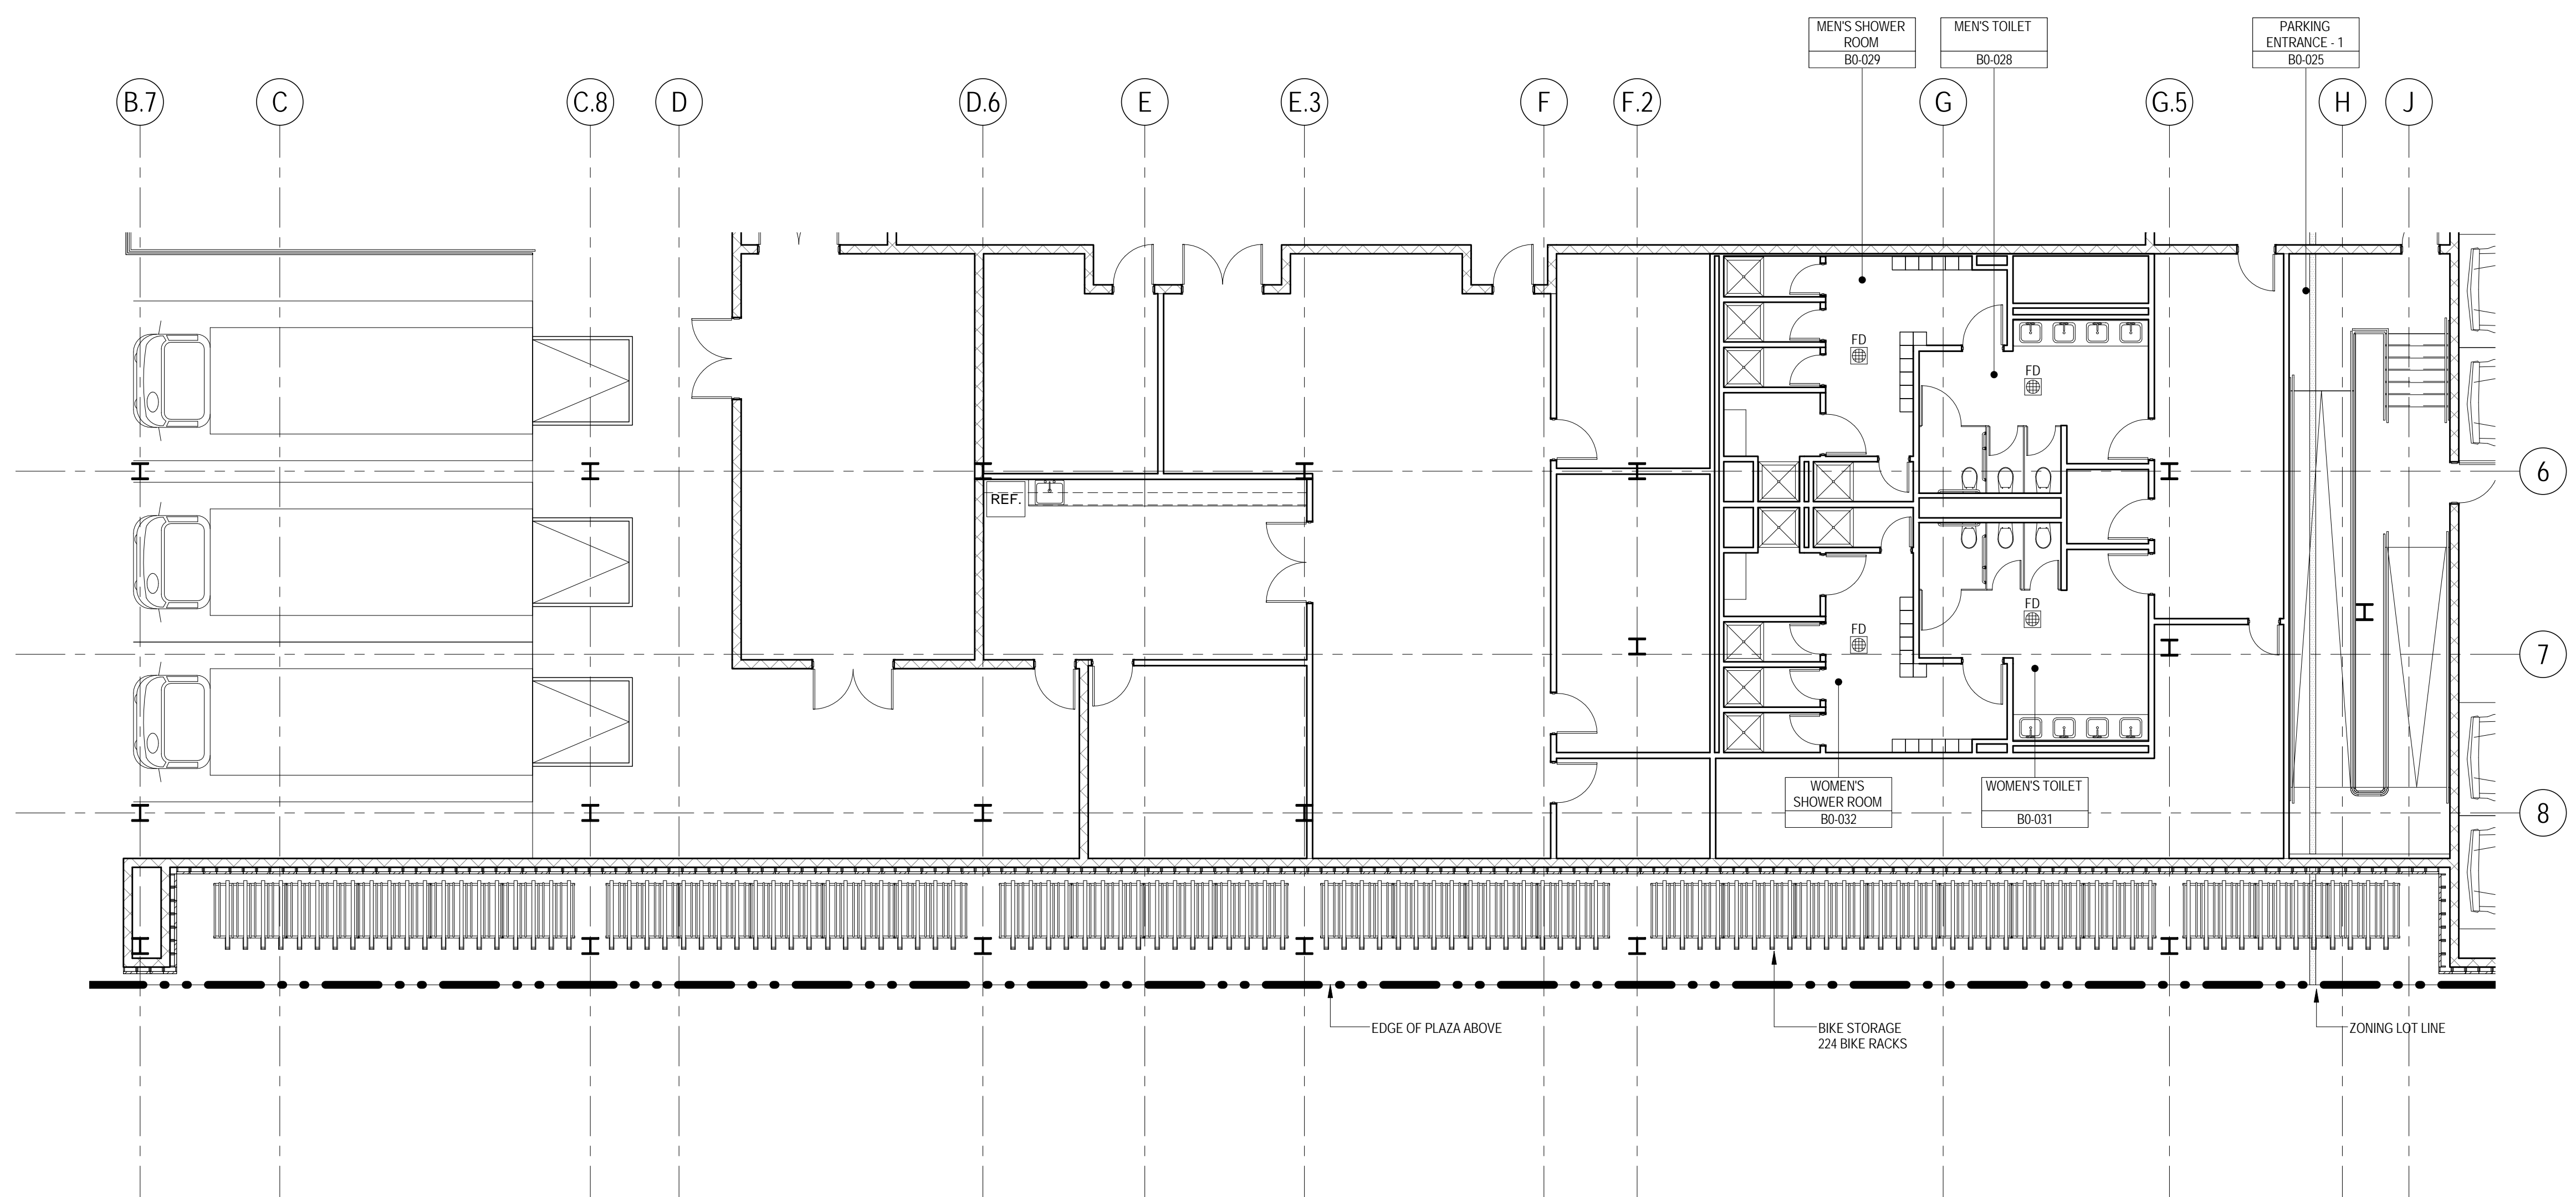

3 ENLARGED BICYCLE STORAGE PLAN

SCALE: 1/8" = 1'-0"

REQUIRED BICYCLE PARKING SPACES (ZR 36-71)

Spaces required for office use

1 per 7,500 ft² of floor area	
Total (1,624,537 / 7,500):	217 spaces


Spaces required for retail use

1 per 10,000 ft² of floor area	
Total (20,123 / 7,500):	3 spaces

Provided: 224 bike racks (COMPLIES)

2 ZONING RESOLUTION - BICYCLE PARKING RERQUIREMENTS

SCALE: NTS

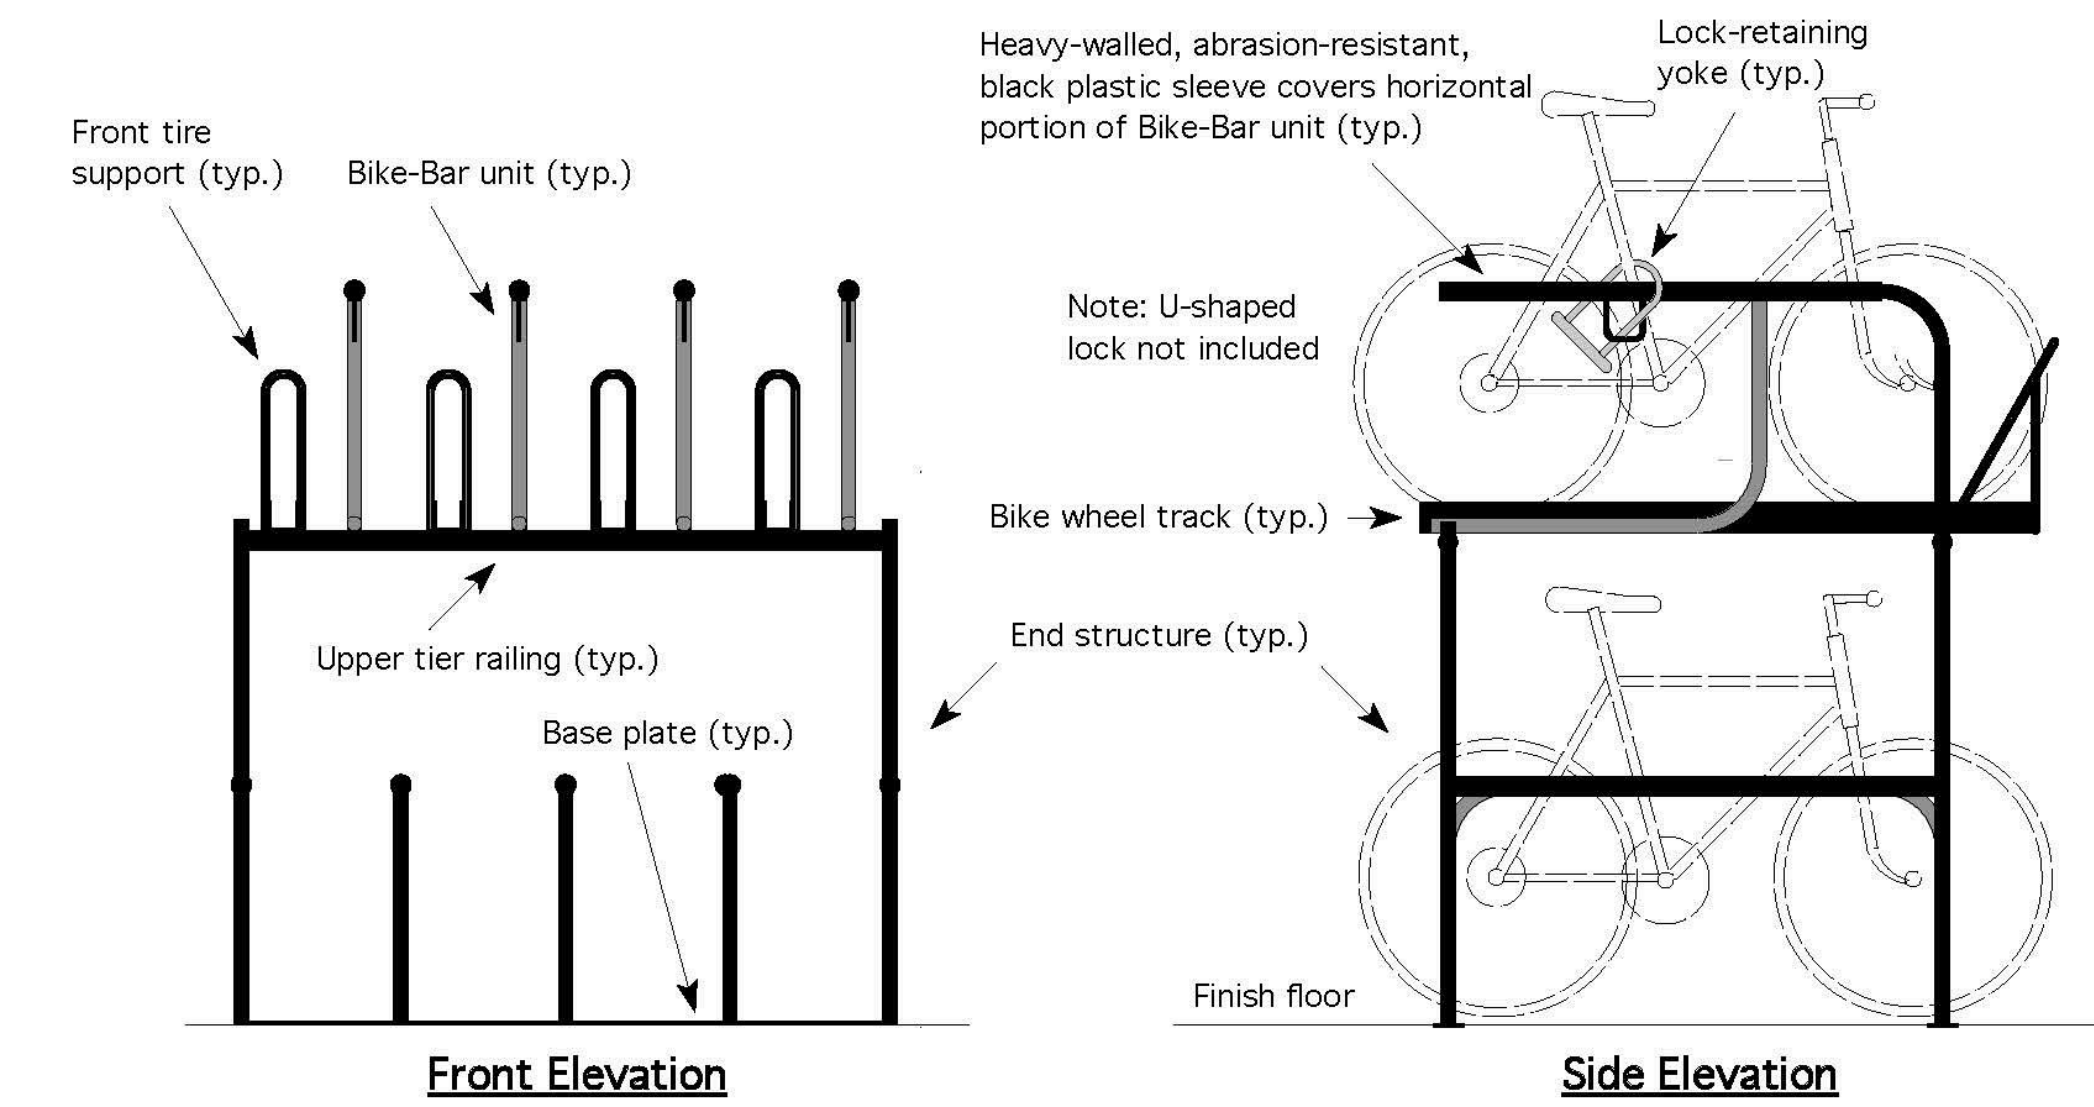

Specifications

Model#:	• BDDF-8.16 Bike-Double-Decker-Framework™: Two-Tier, Moderate Security Bike Rack
Capacity:	• (8) bikes on 16" centers (4 on the top and 4 on the bottom)
Materials:	• 1" nom., Sched. 40 ASTM A500 welded, seamless-steel pipe for Bike-Bar units and end structures • 1.5" nom., Sched. 40 ASTM A500 welded, seamless-steel pipe for upper-tier railings • 1" nom., heavy-walled, abrasion-resistant, black plastic sleeve covers entire horizontal portion of Bike-Bar units • 3" x 3" x 18 gauge H.R. steel channel for bike wheel tracks • 1/4" x 3" H.R. steel flat-bar for base plates • 1/2" dia. H.R. steel round-bar for lock-retaining yokes and front tire supports
Finishes:	• Hot-dipped galvanizing • Black, abrasion-resistant thermoplastic powder coating 8 to 10 mils thick • Standard-colored, abrasion-resistant thermoplastic powder coating 8 to 10 mils thick (extra) • Hot-dipped galvanized substrate plus thermoplastic powder coating 8 to 10 mils thick (extra) • Satin-finished #304 stainless-steel construction (extra)
Fabrication:	• All metallurgical joints are MIG welds

©Feb. 2013 Bike Security Racks Co., Inc. All Rights Reserved

1 BICYCLE PARKING SPECIFICATIONS

SCALE: NTS



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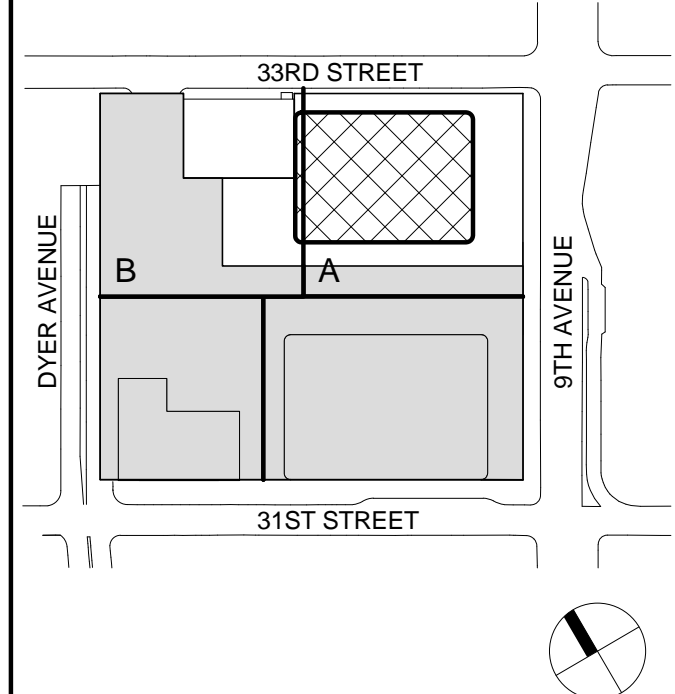
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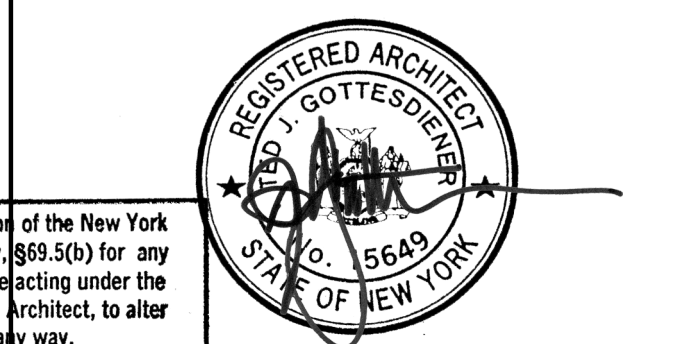
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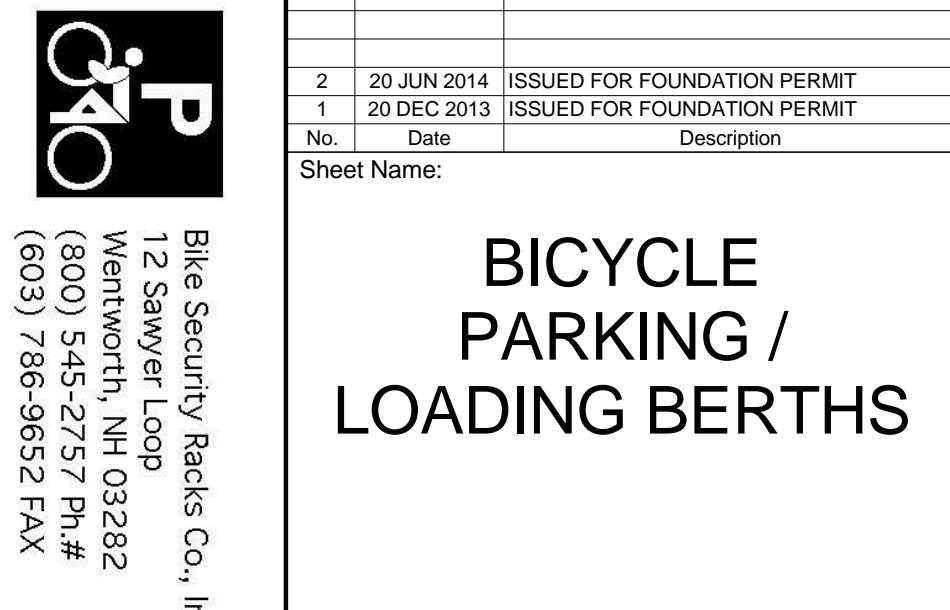
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BICYCLE PARKING / LOADING BERTHS

Project No.: 207150

Date: 20 JUN 2014

Scale: As indicated

File No: Z-007

B-SCAN Sheet No.: Z-007.00

Sheet No.: Z-007


Page No.: 7 OF 28

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SUB-CELLAR LEVEL B2 FLOOR PLAN

SCALE: 1/16" = 1'-0"



ZONING SCHEDULE - LEVEL B2	
ZONING DEDUCTIONS	2742 ft²
GROSS FLOOR AREA	2742 ft²

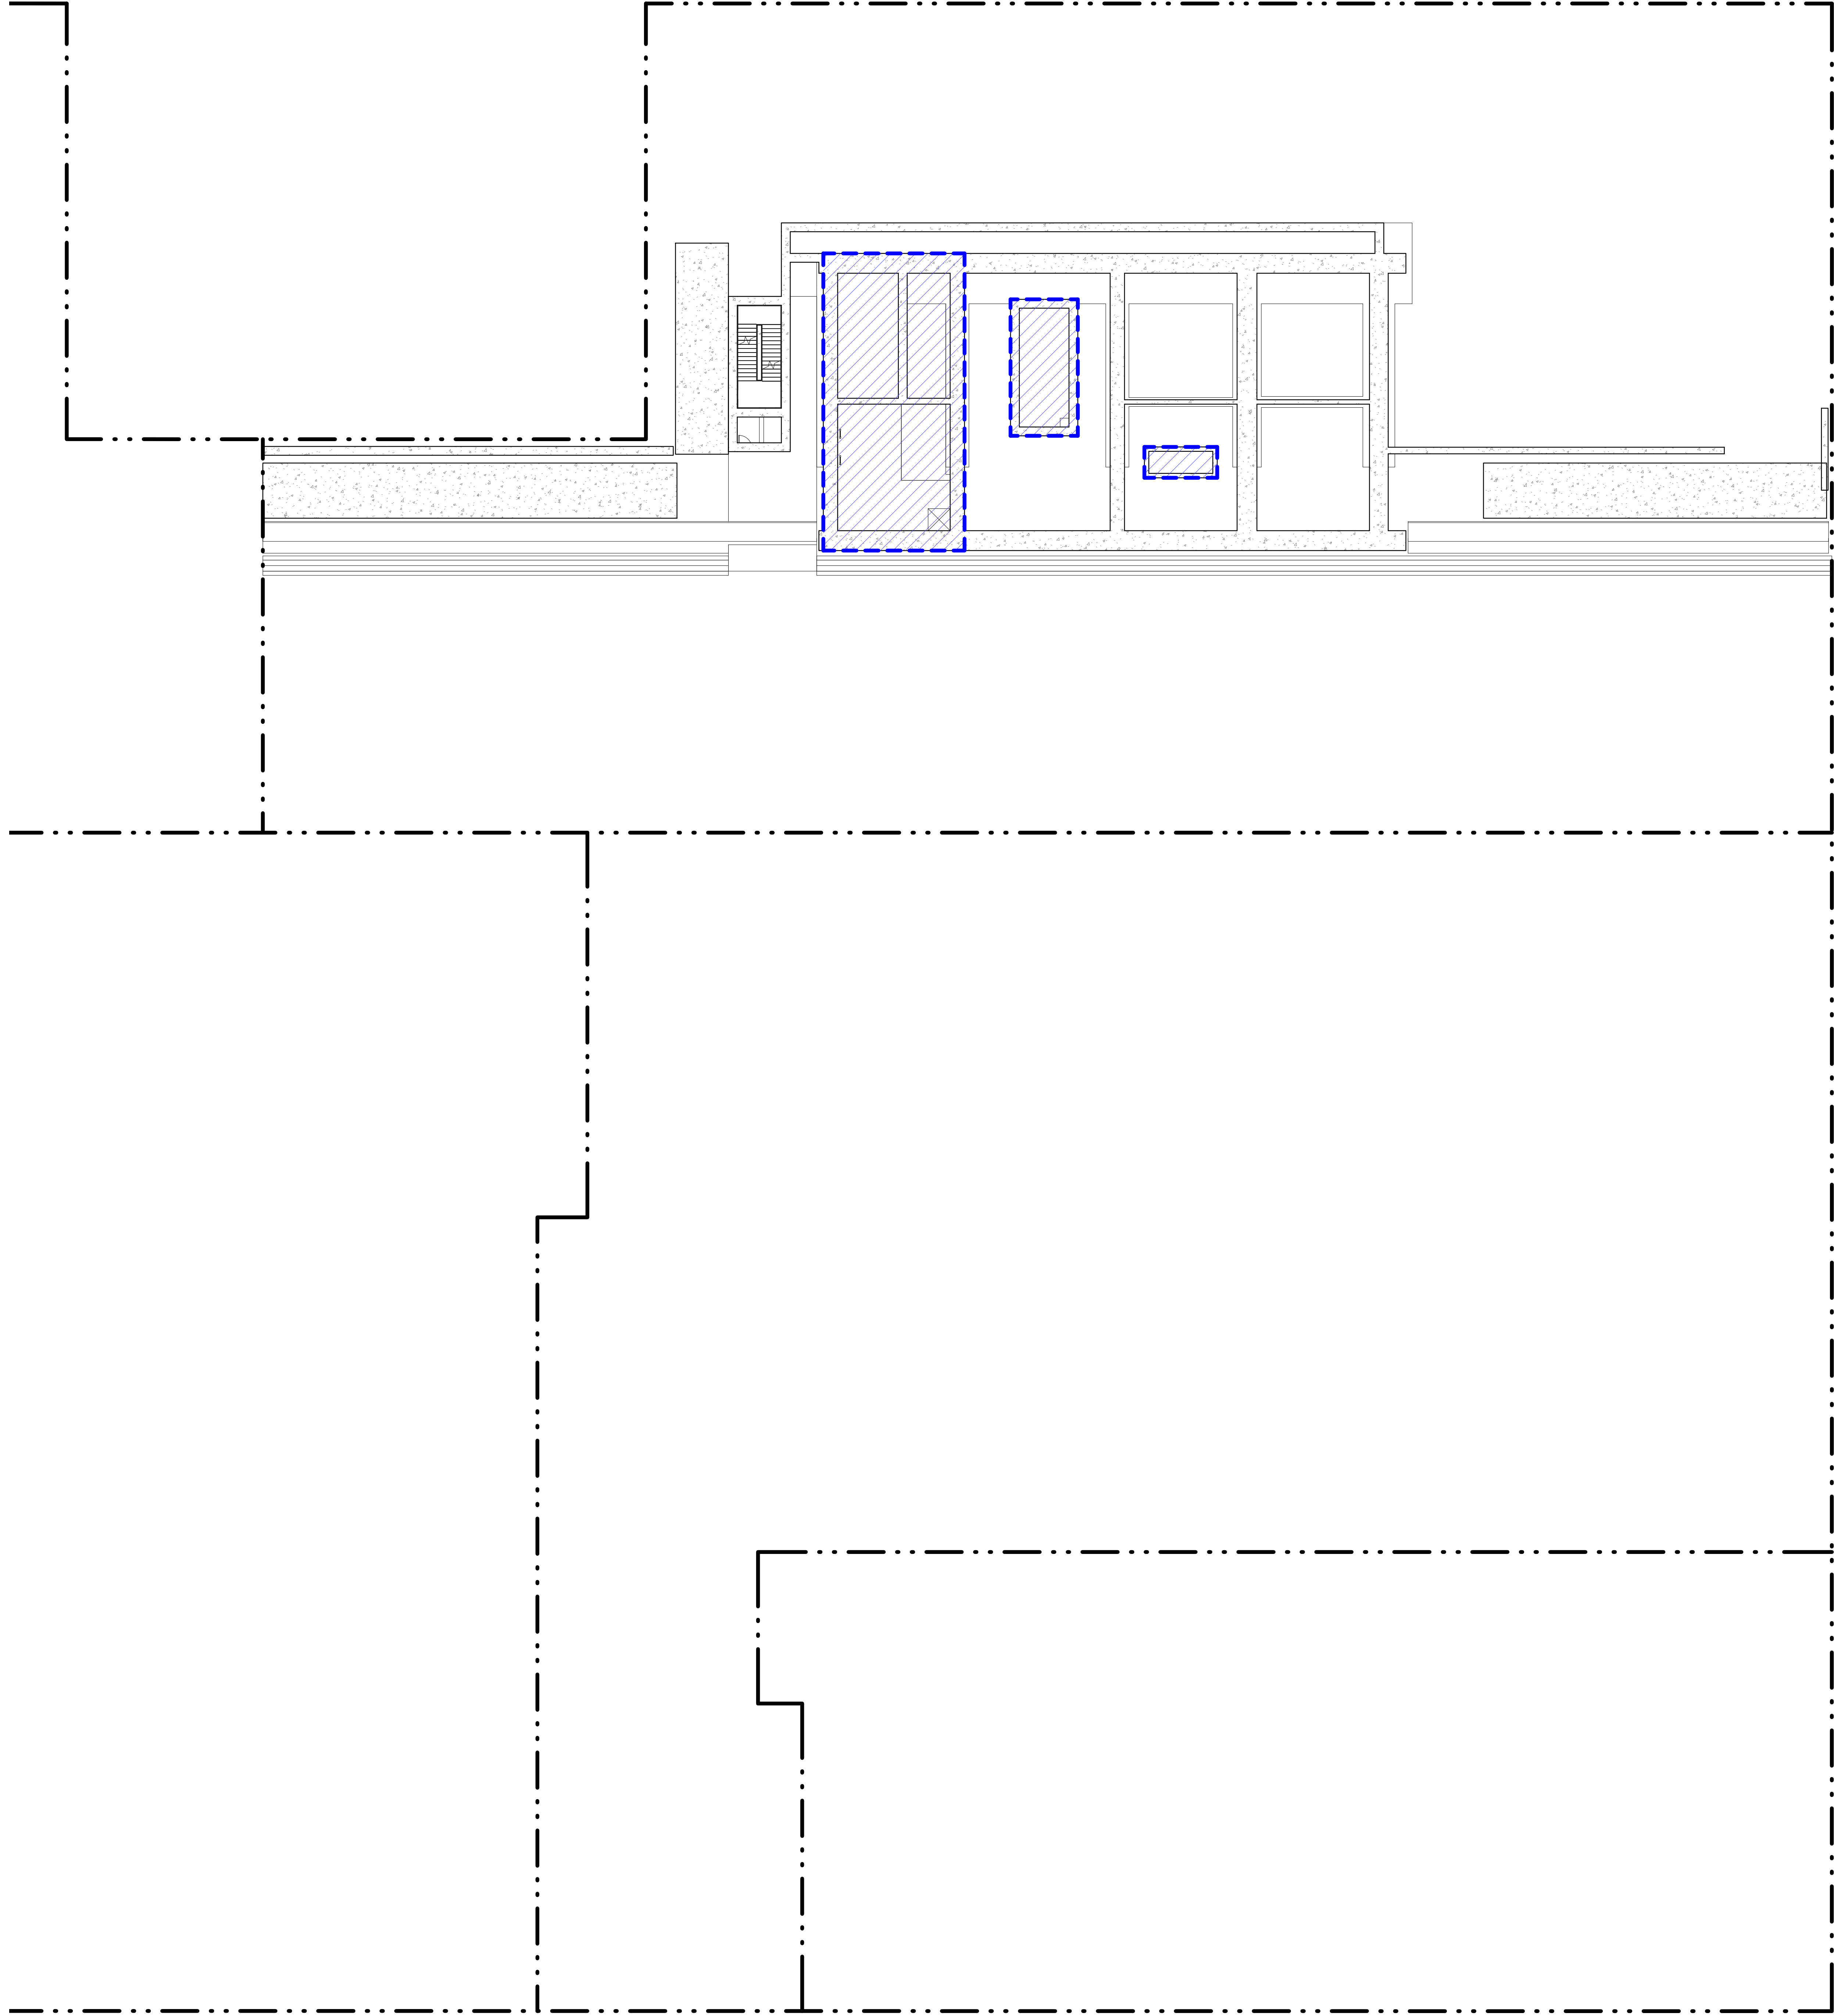ZONING LEGENDS

- GROSS BUILDING AREA
- ZONING AREA DEDUCTIONS
- ZONING FLOOR AREA
- RETAIL
- MR MECHANICAL ROOM
- M MECHANICAL
- E ELECTRICAL/TEL./IT
- P PLUMBING
- EM ELEVATOR MACHINE ROOM



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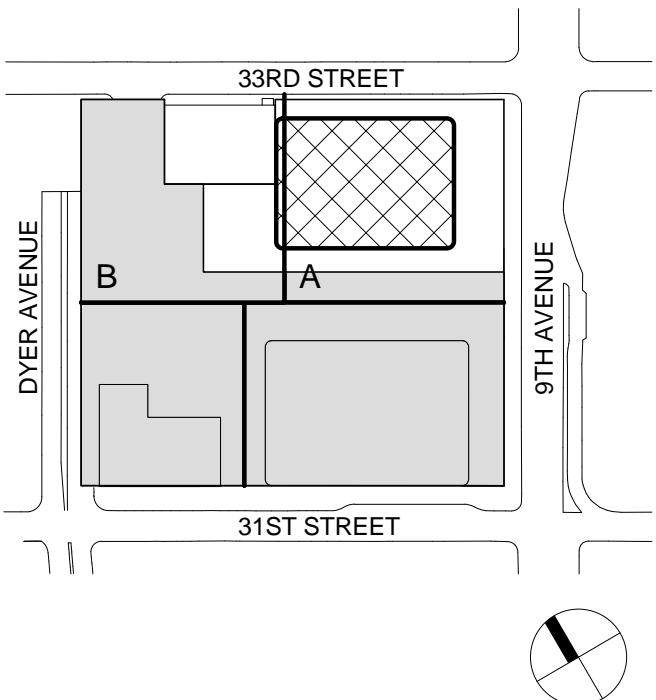
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DEDUCTIONS -
CELLAR B1 PITS


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Date: 20 JUN 2014
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File No: Z-101
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Sheet No.: Z-101
Page No.: 8 OF 28

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1

SUB-CELLAR LEVEL B1 FLOOR PLAN

SCALE: 1/16" = 1'-0"

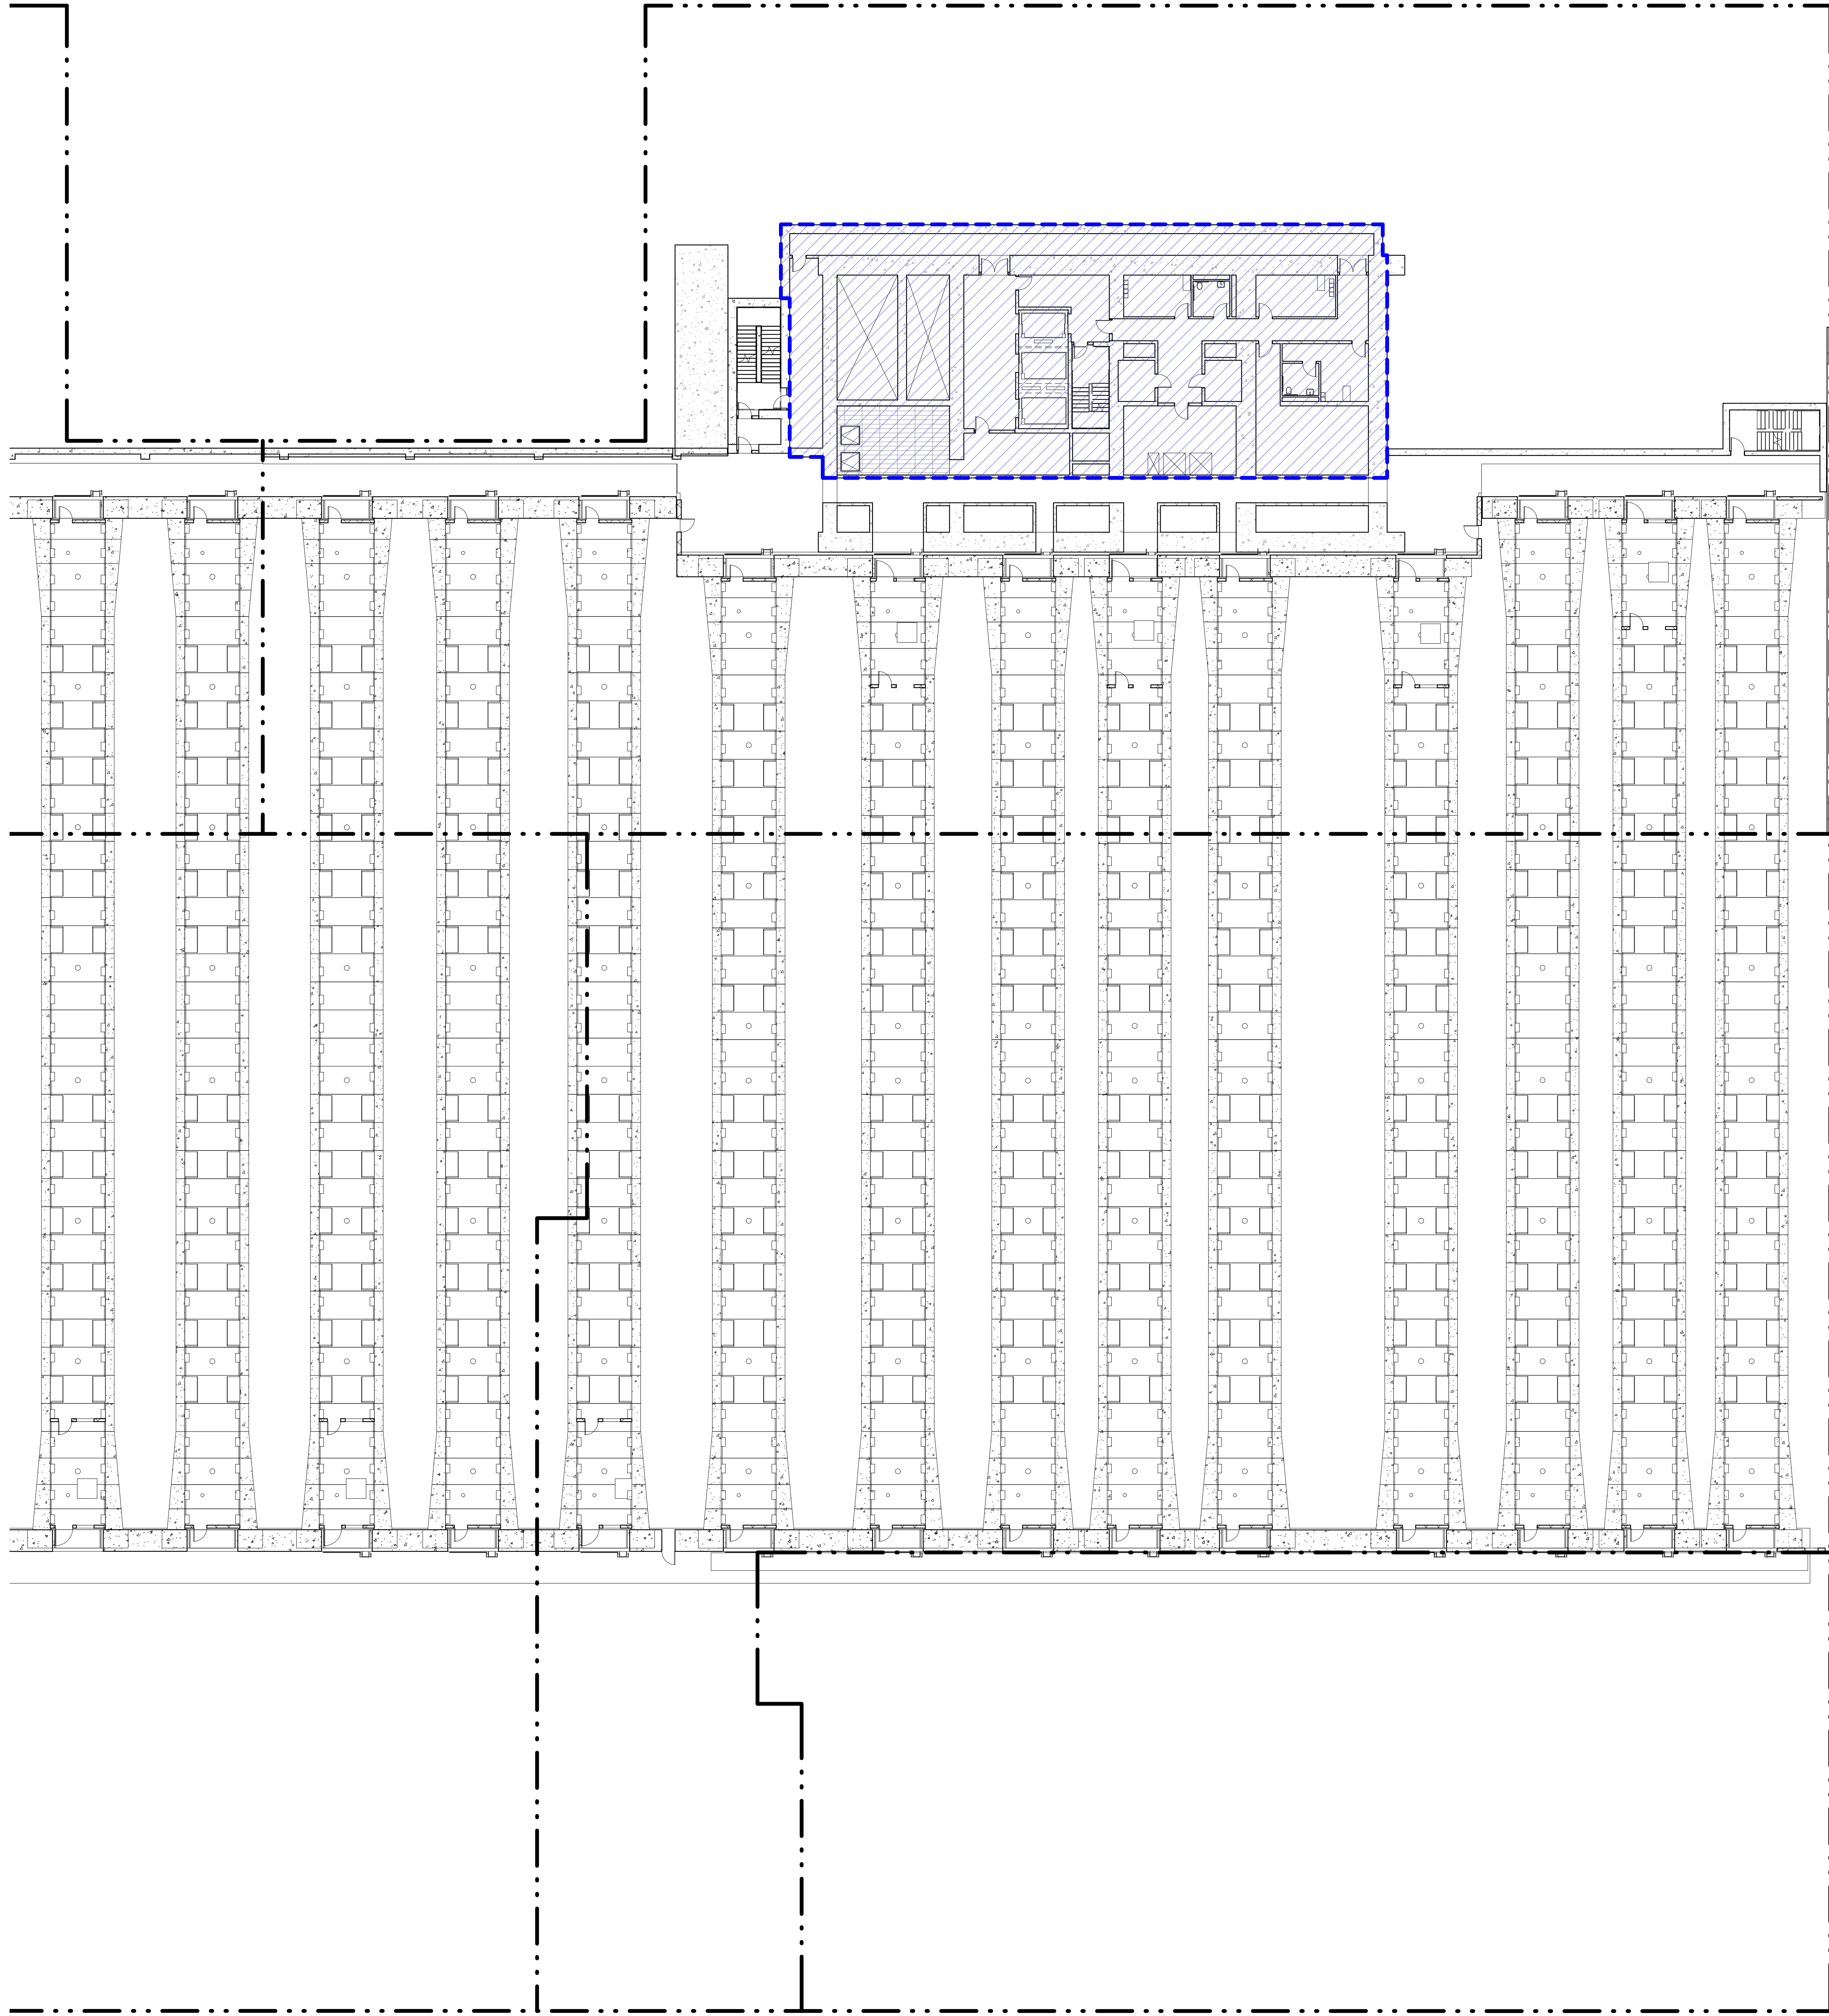

ZONING SCHEDULE - LEVEL B1	
ZONING DEDUCTIONS	7782 R ²
GROSS FLOOR AREA	7782 R ²

ZONING LEGENDS

- GROSS BUILDING AREA
- ZONING AREA DEDUCTIONS
- ZONING FLOOR AREA
- RETAIL
- MR MECHANICAL ROOM
- M MECHANICAL
- E ELECTRICAL/TEL./IT
- P PLUMBING
- EM ELEVATOR MACHINE ROOM



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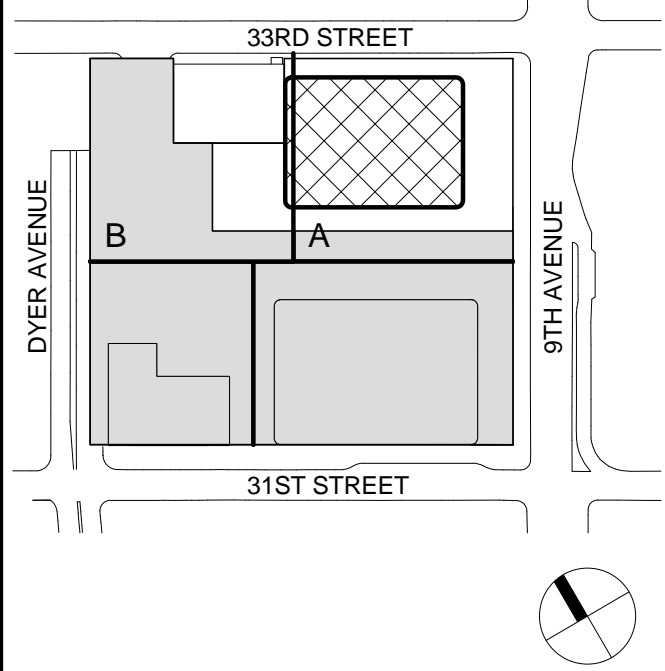
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ZONING FLOOR
AREA
DEDUCTIONS -
CELLAR B1

Project No.:

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Date:

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1/16" = 1'-0"

File No.:

Z-102

B-SCAN Sheet No.:

Z-102.00

Sheet No.:

Z-102

Page No.:

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Project No. 207150
Date: 20 JUN 2014
Scale: 1/16" = 1'-0"

ZONING LEGENDS

- GROSS BUILDING AREA
- ZONING AREA DEDUCTIONS
- ZONING FLOOR AREA
- RETAIL
- MR MECHANICAL ROOM
- M MECHANICAL
- E ELECTRICAL/TEL./IT
- P PLUMBING
- EM ELEVATOR MACHINE ROOM



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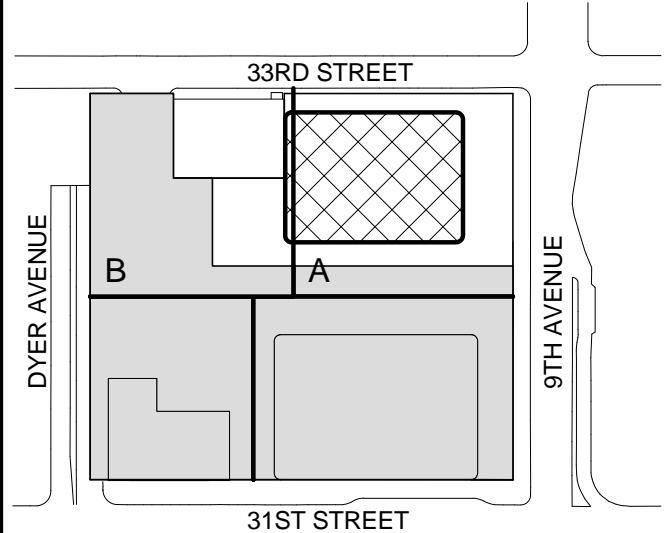
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ZONING FLOOR
AREA
DEDUCTIONS -
CELLAR B

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Z-103.00


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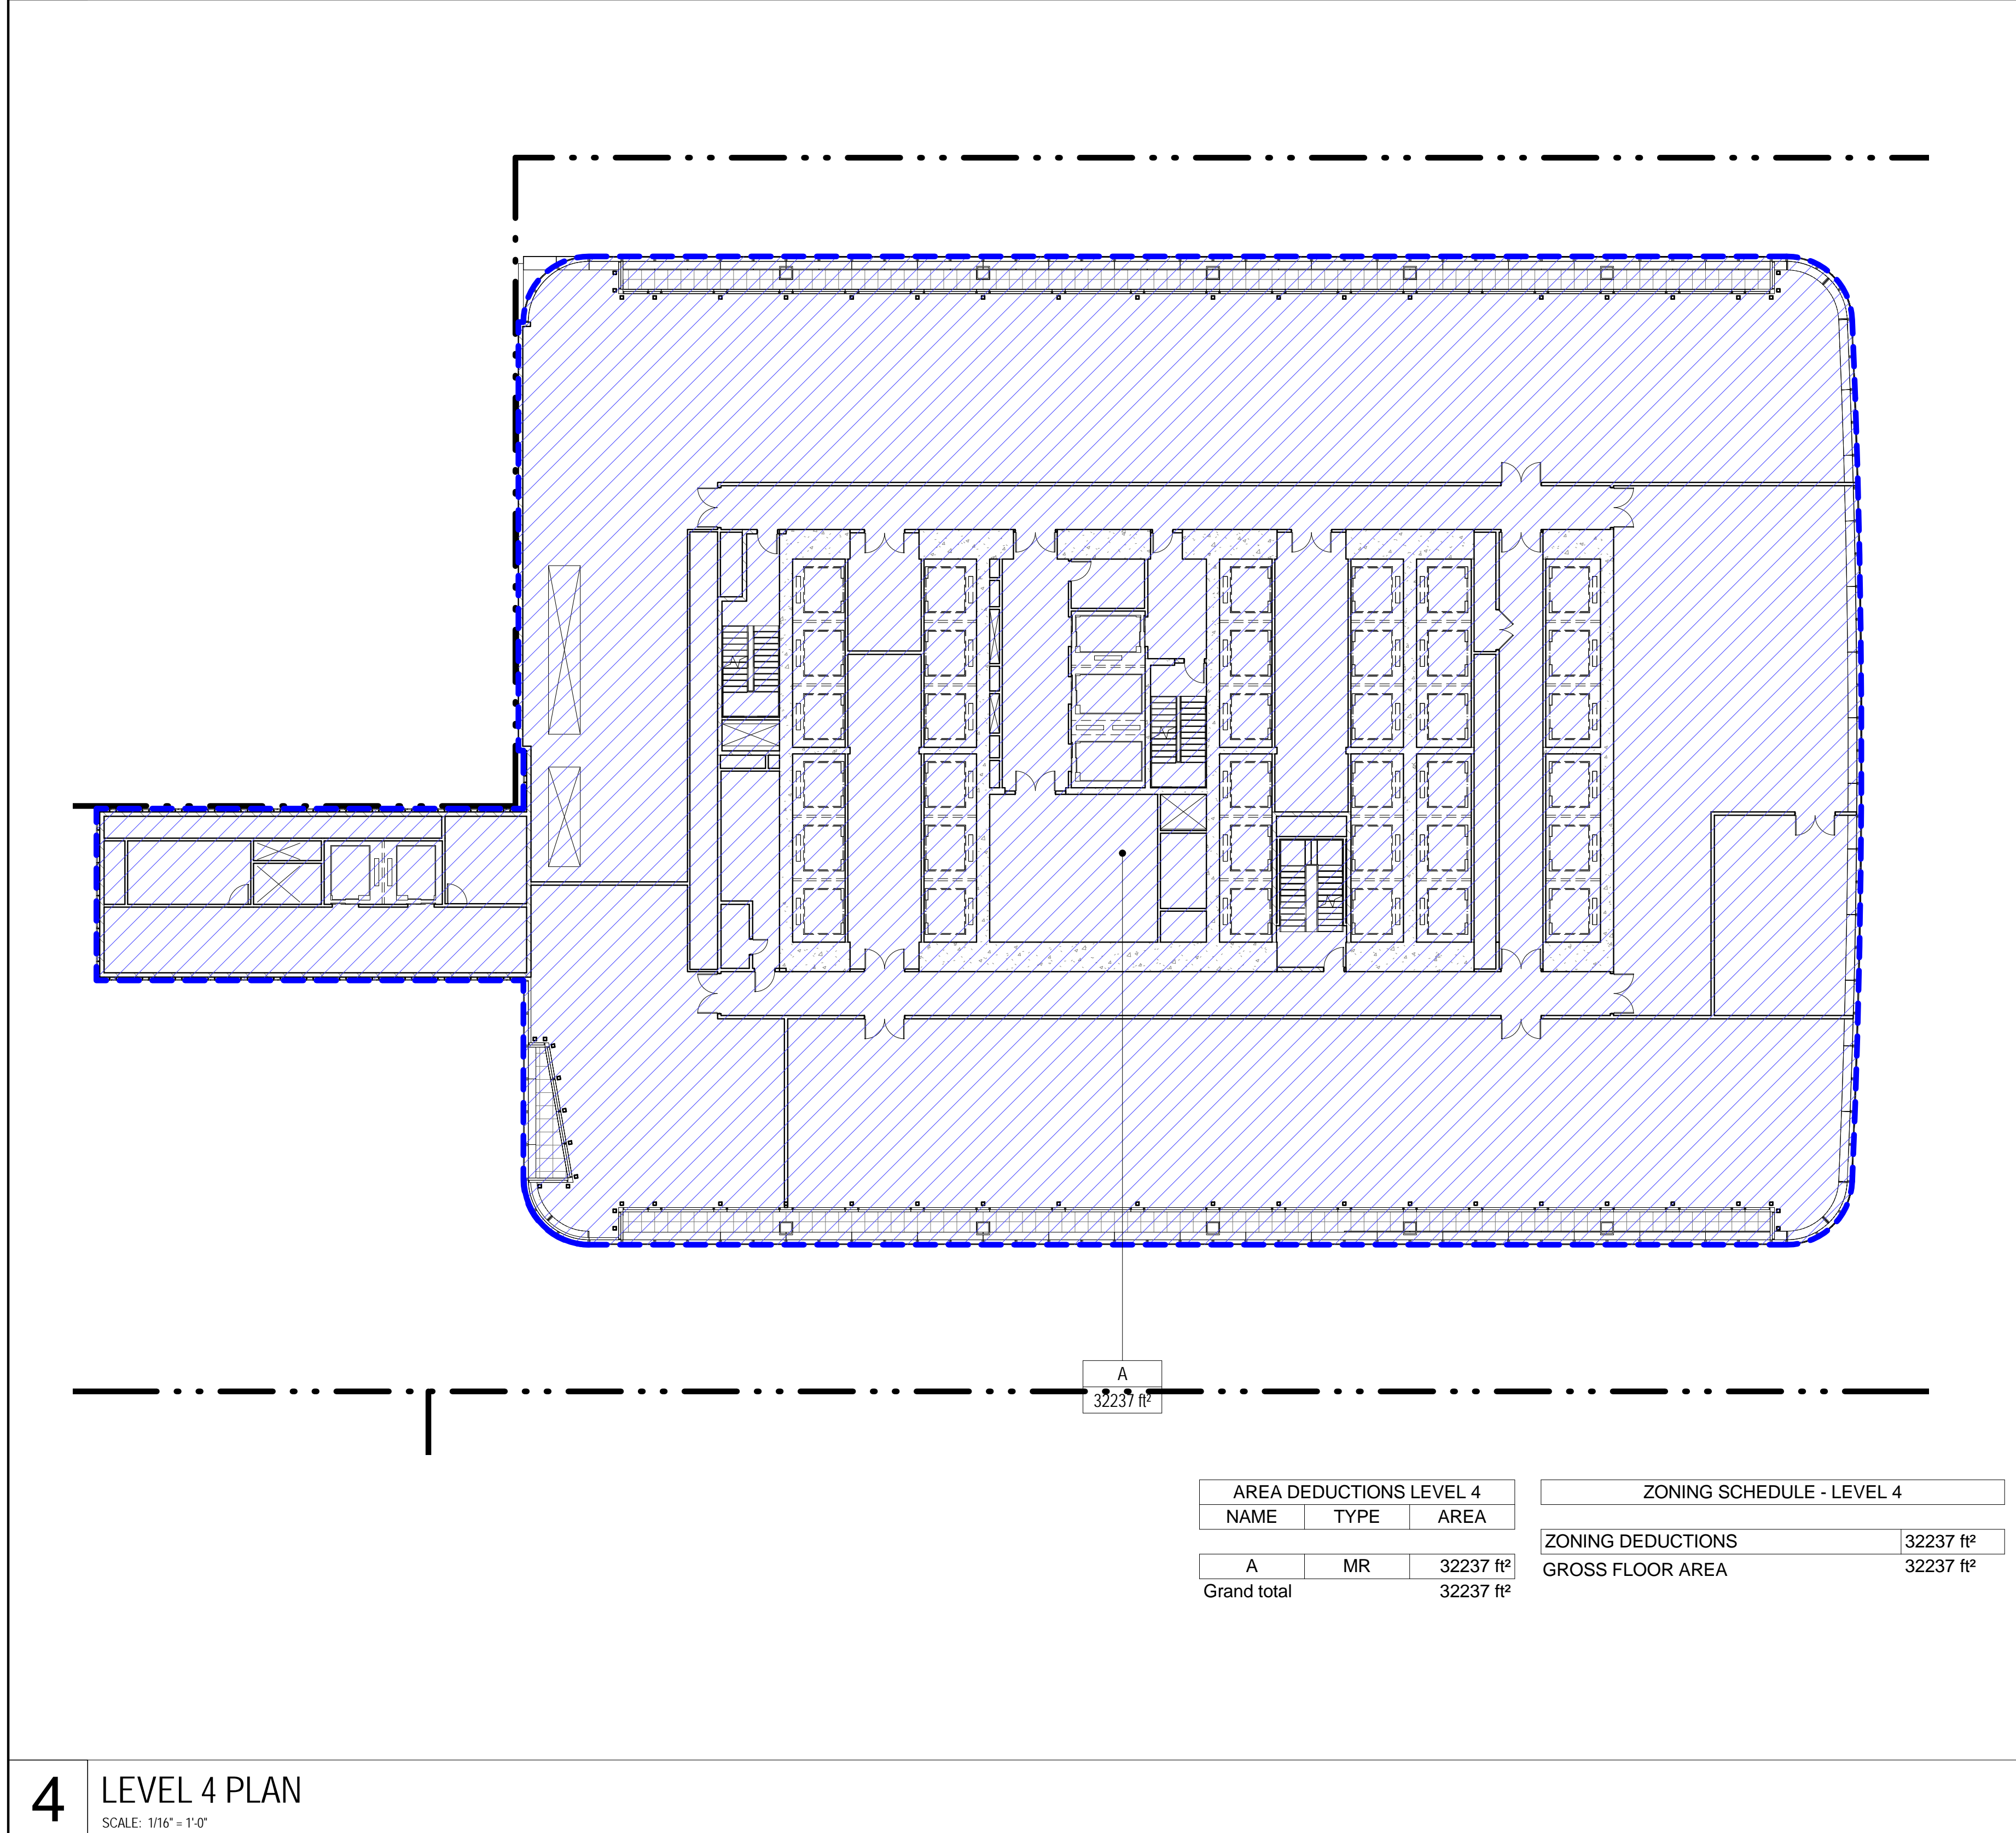
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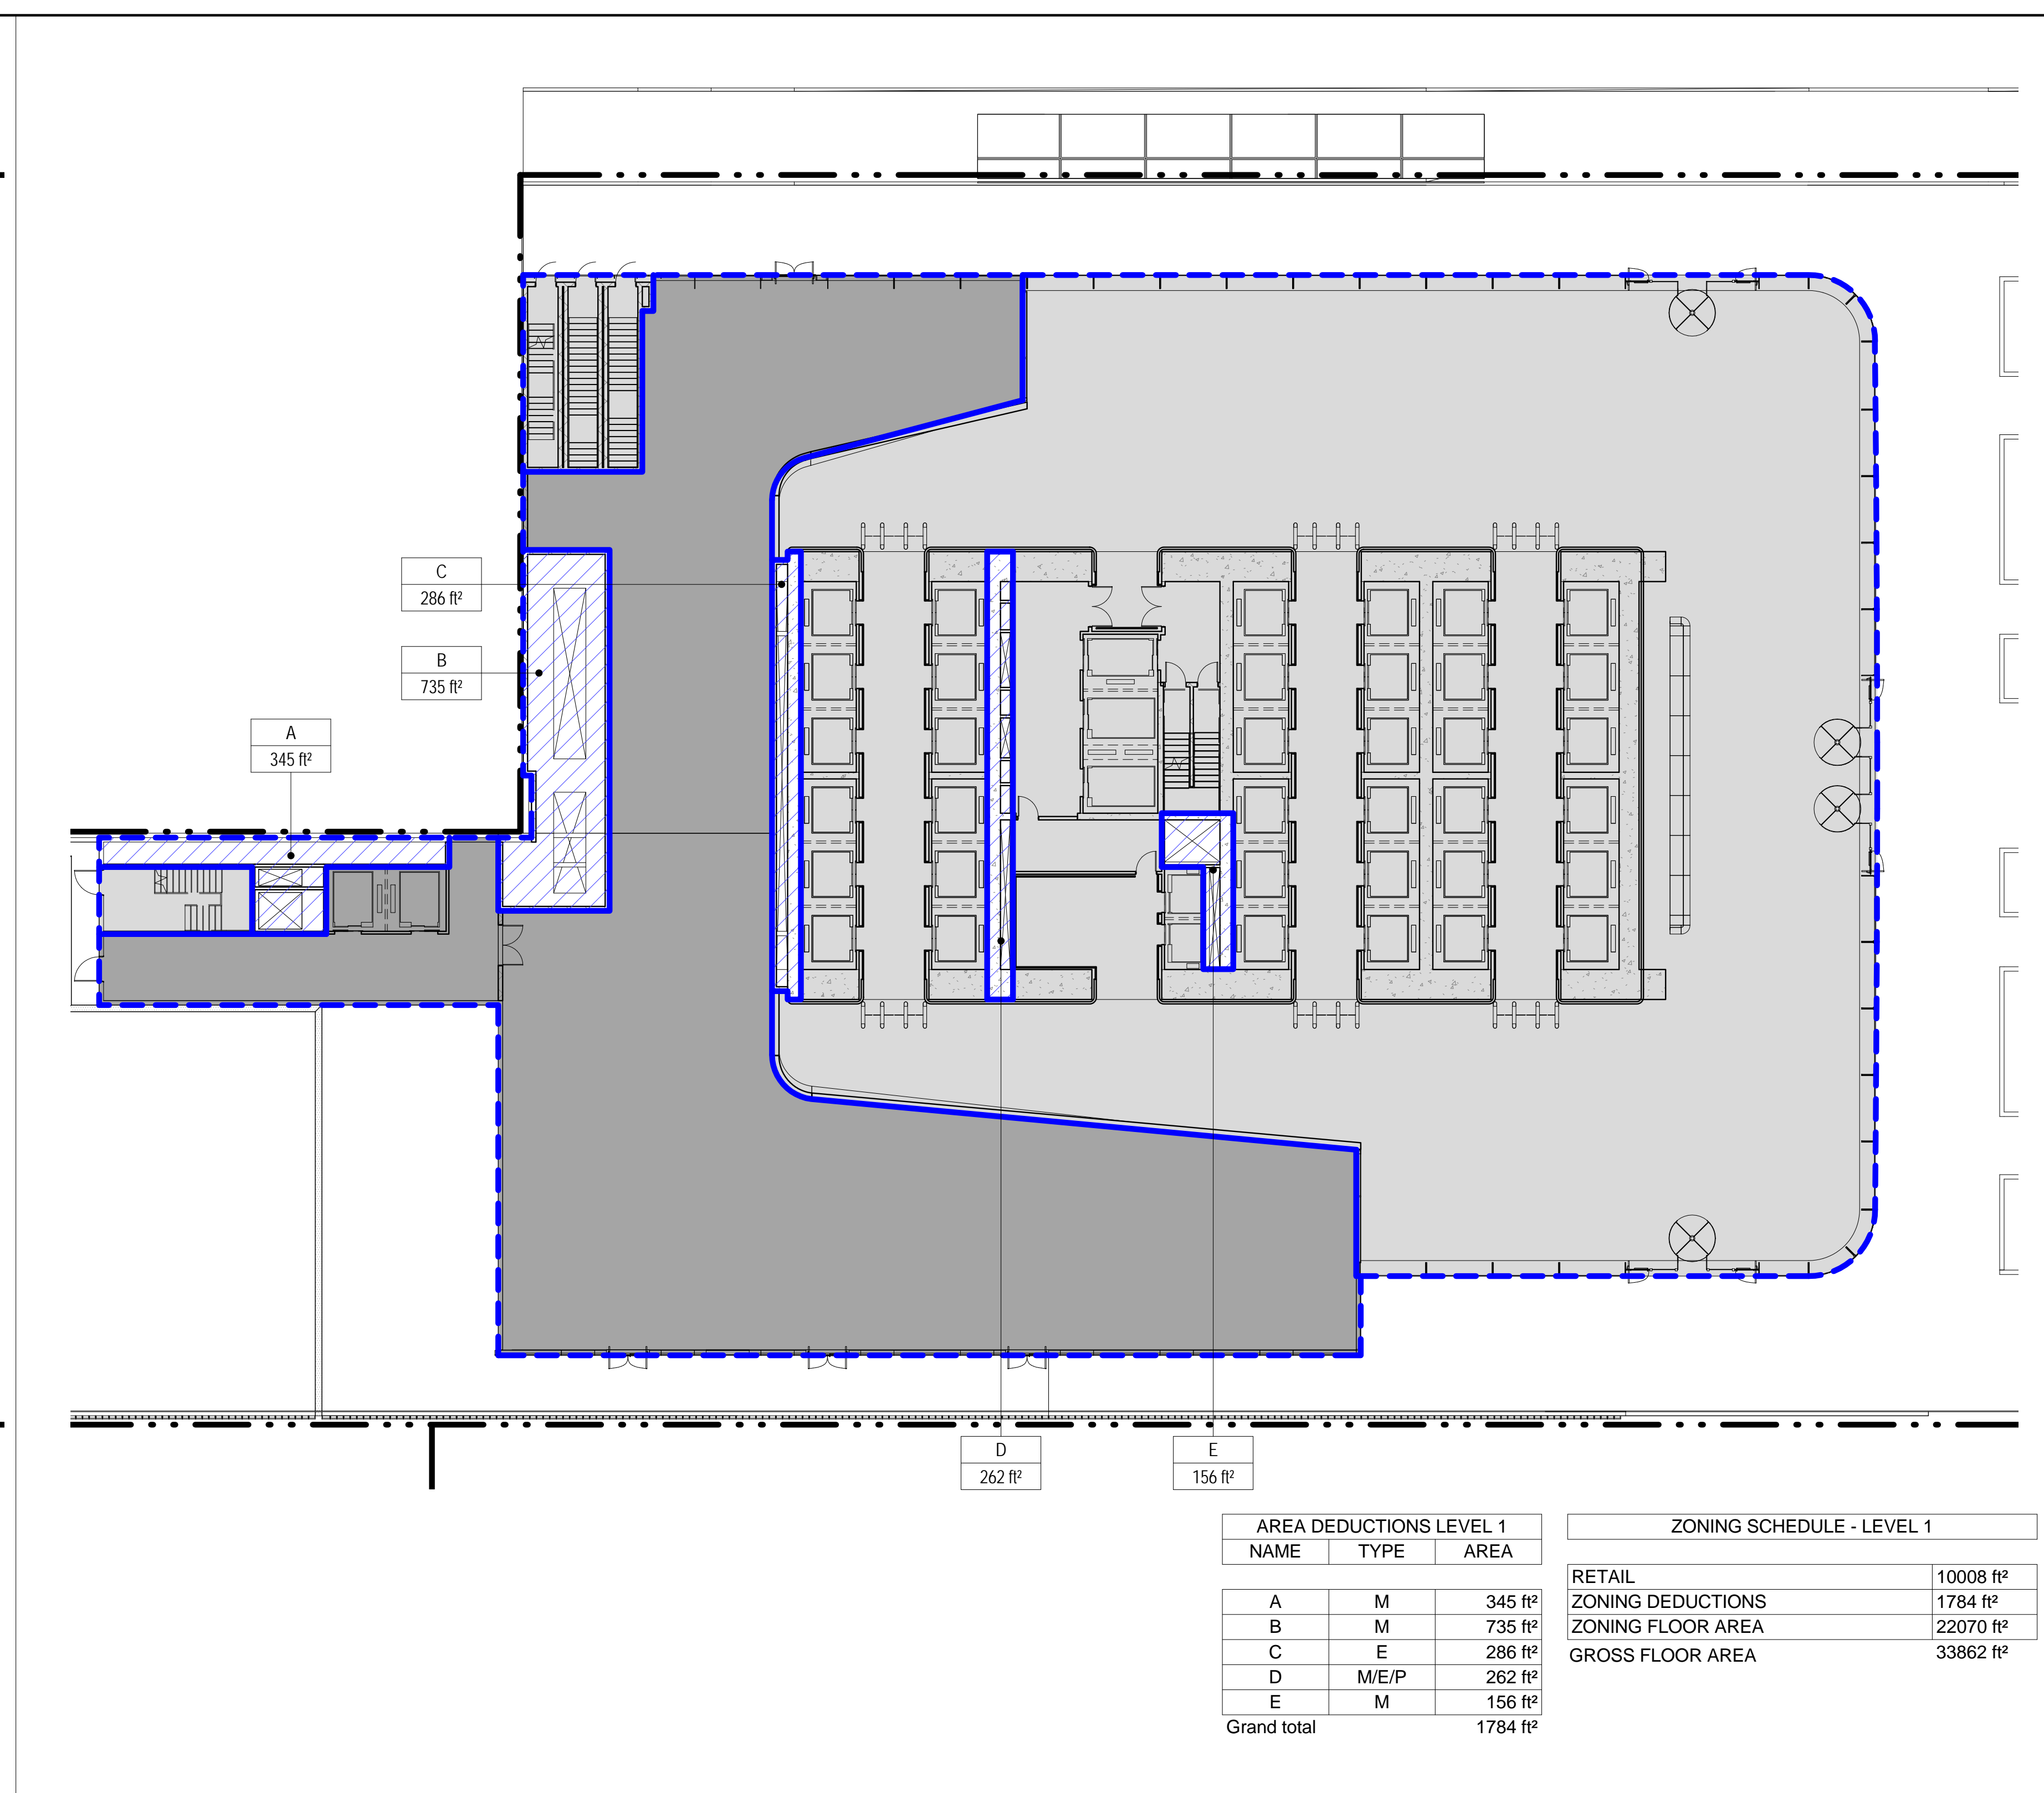
ZONING SCHEDULE - LEVEL B	
ZONING DEDUCTIONS	57777 R²
GROSS FLOOR AREA	57777 R²




3 LEVEL 3 PLAN
SCALE: 1/16" = 1'-0"



4 LEVEL 4 PLAN
SCALE: 1/16" = 1'-0"

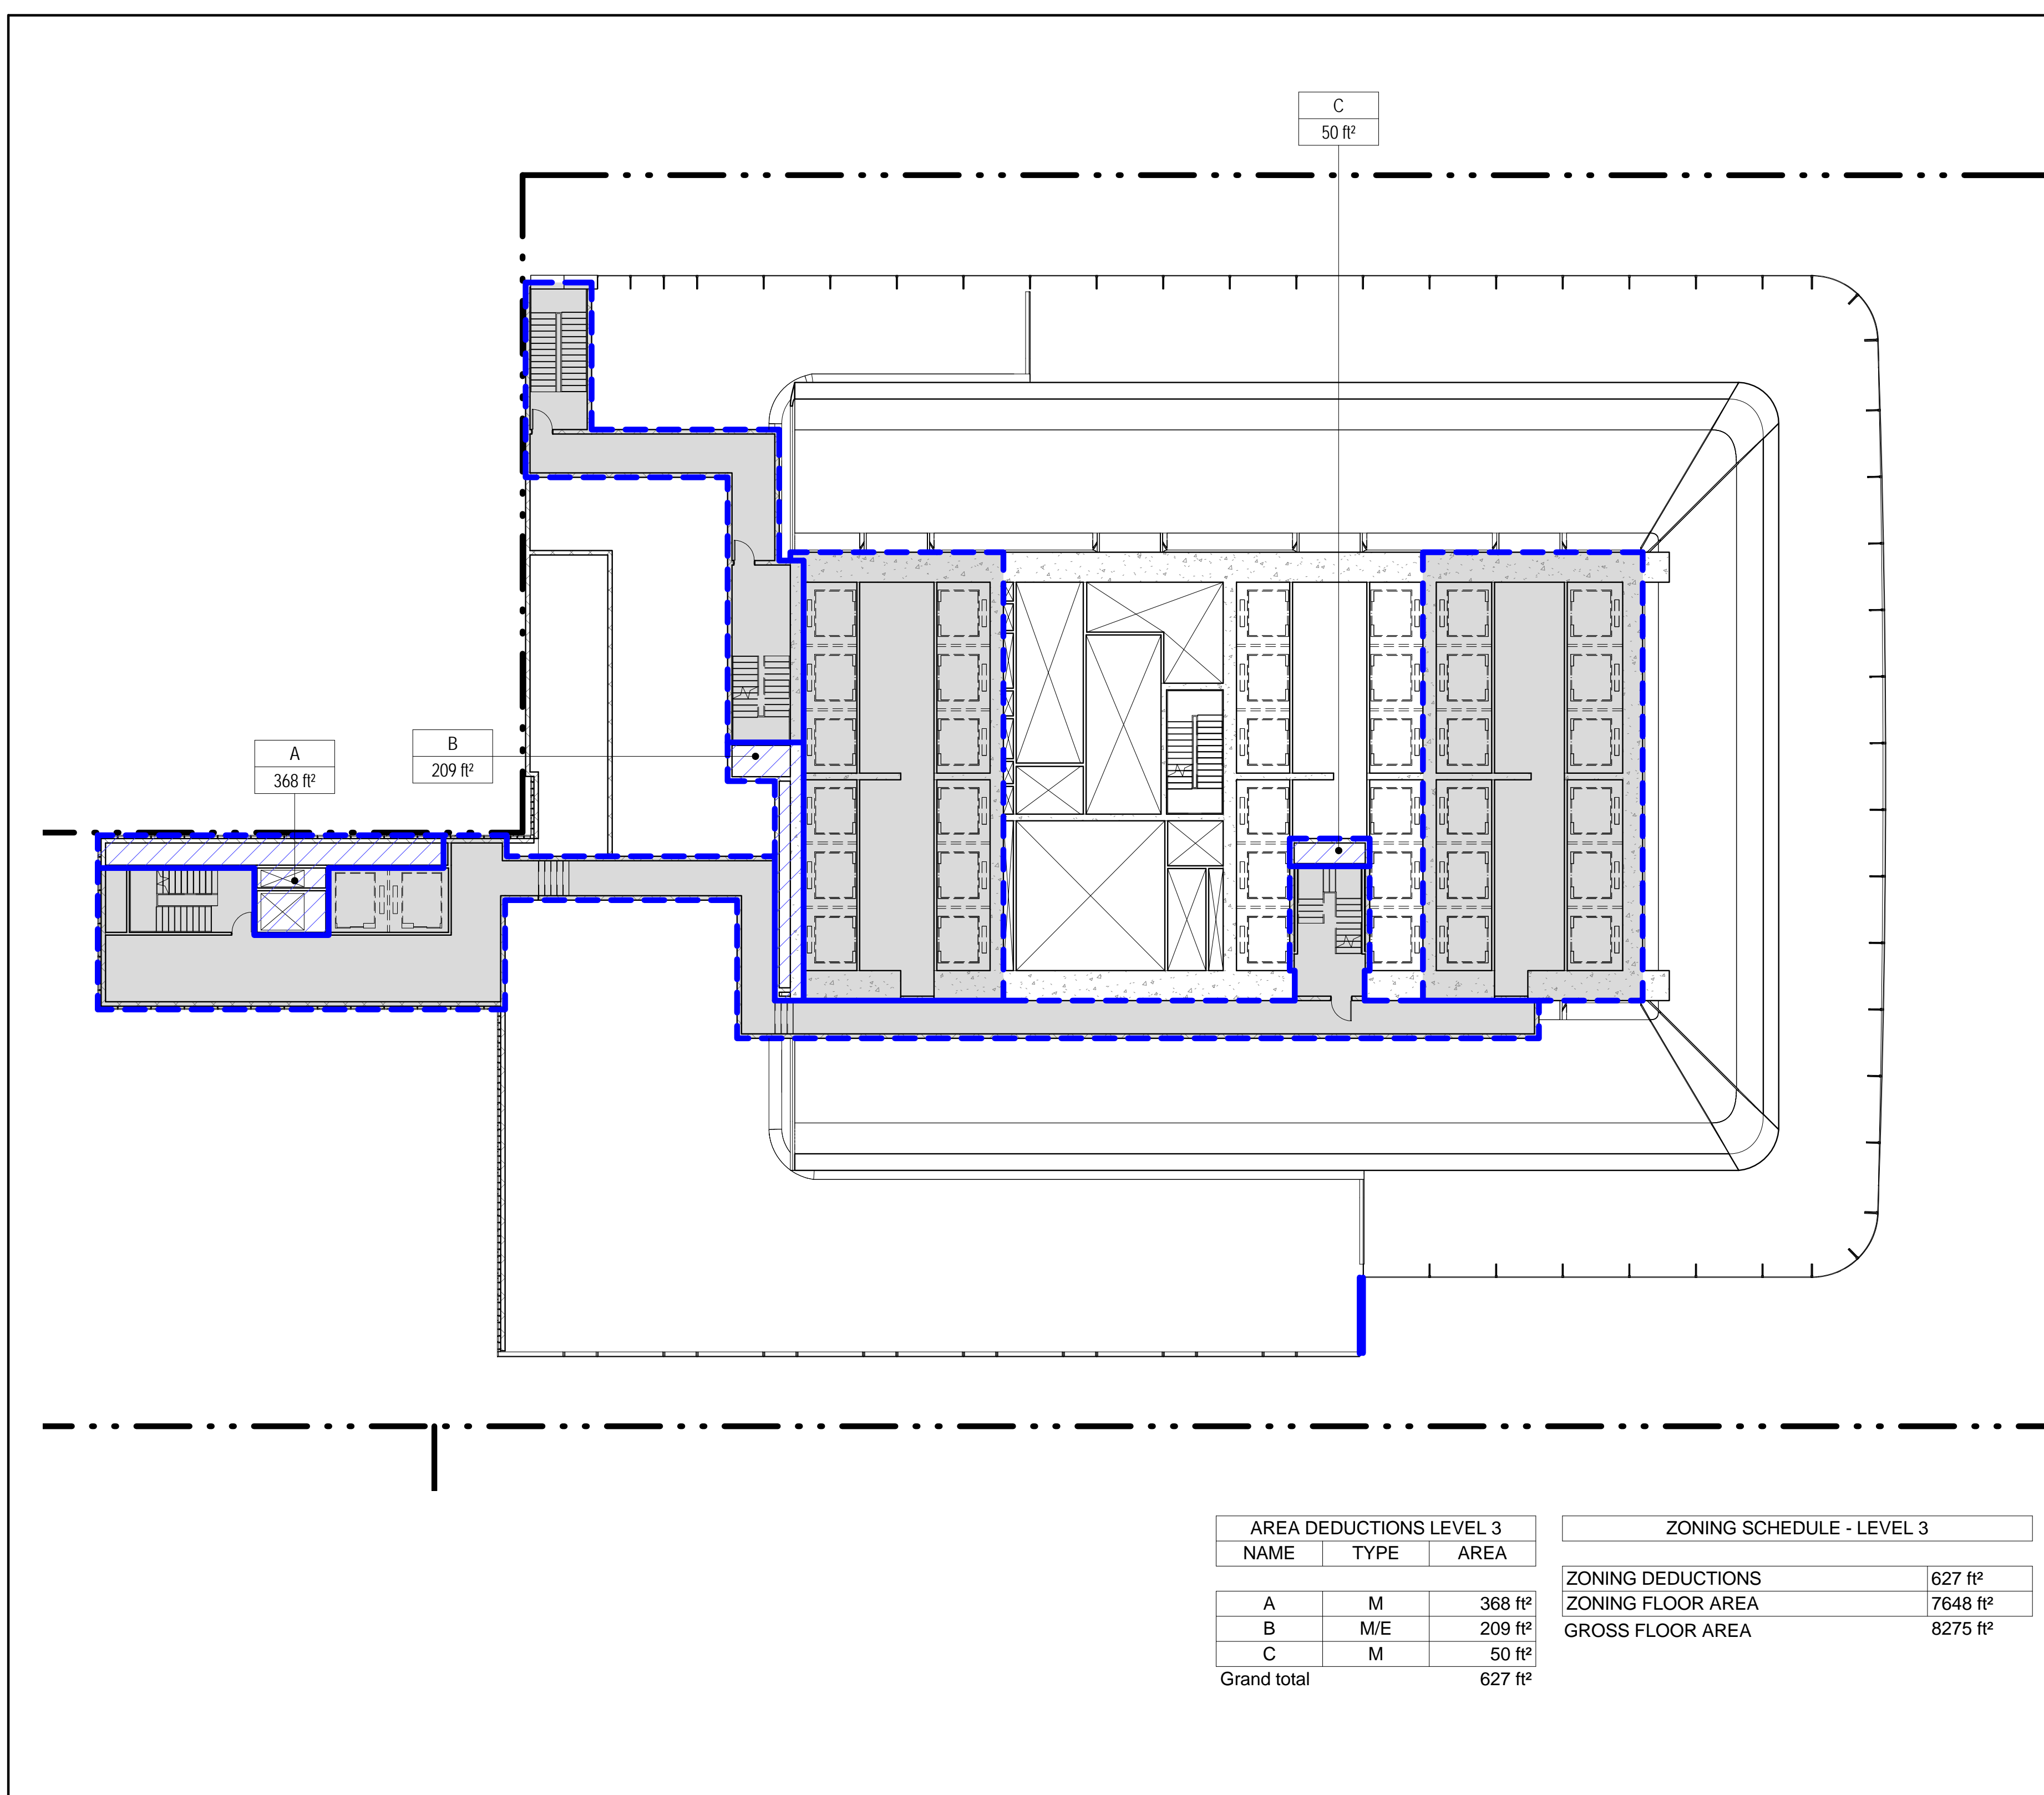

1 LEVEL 1 PLAN
SCALE: 1/16" = 1'-0"

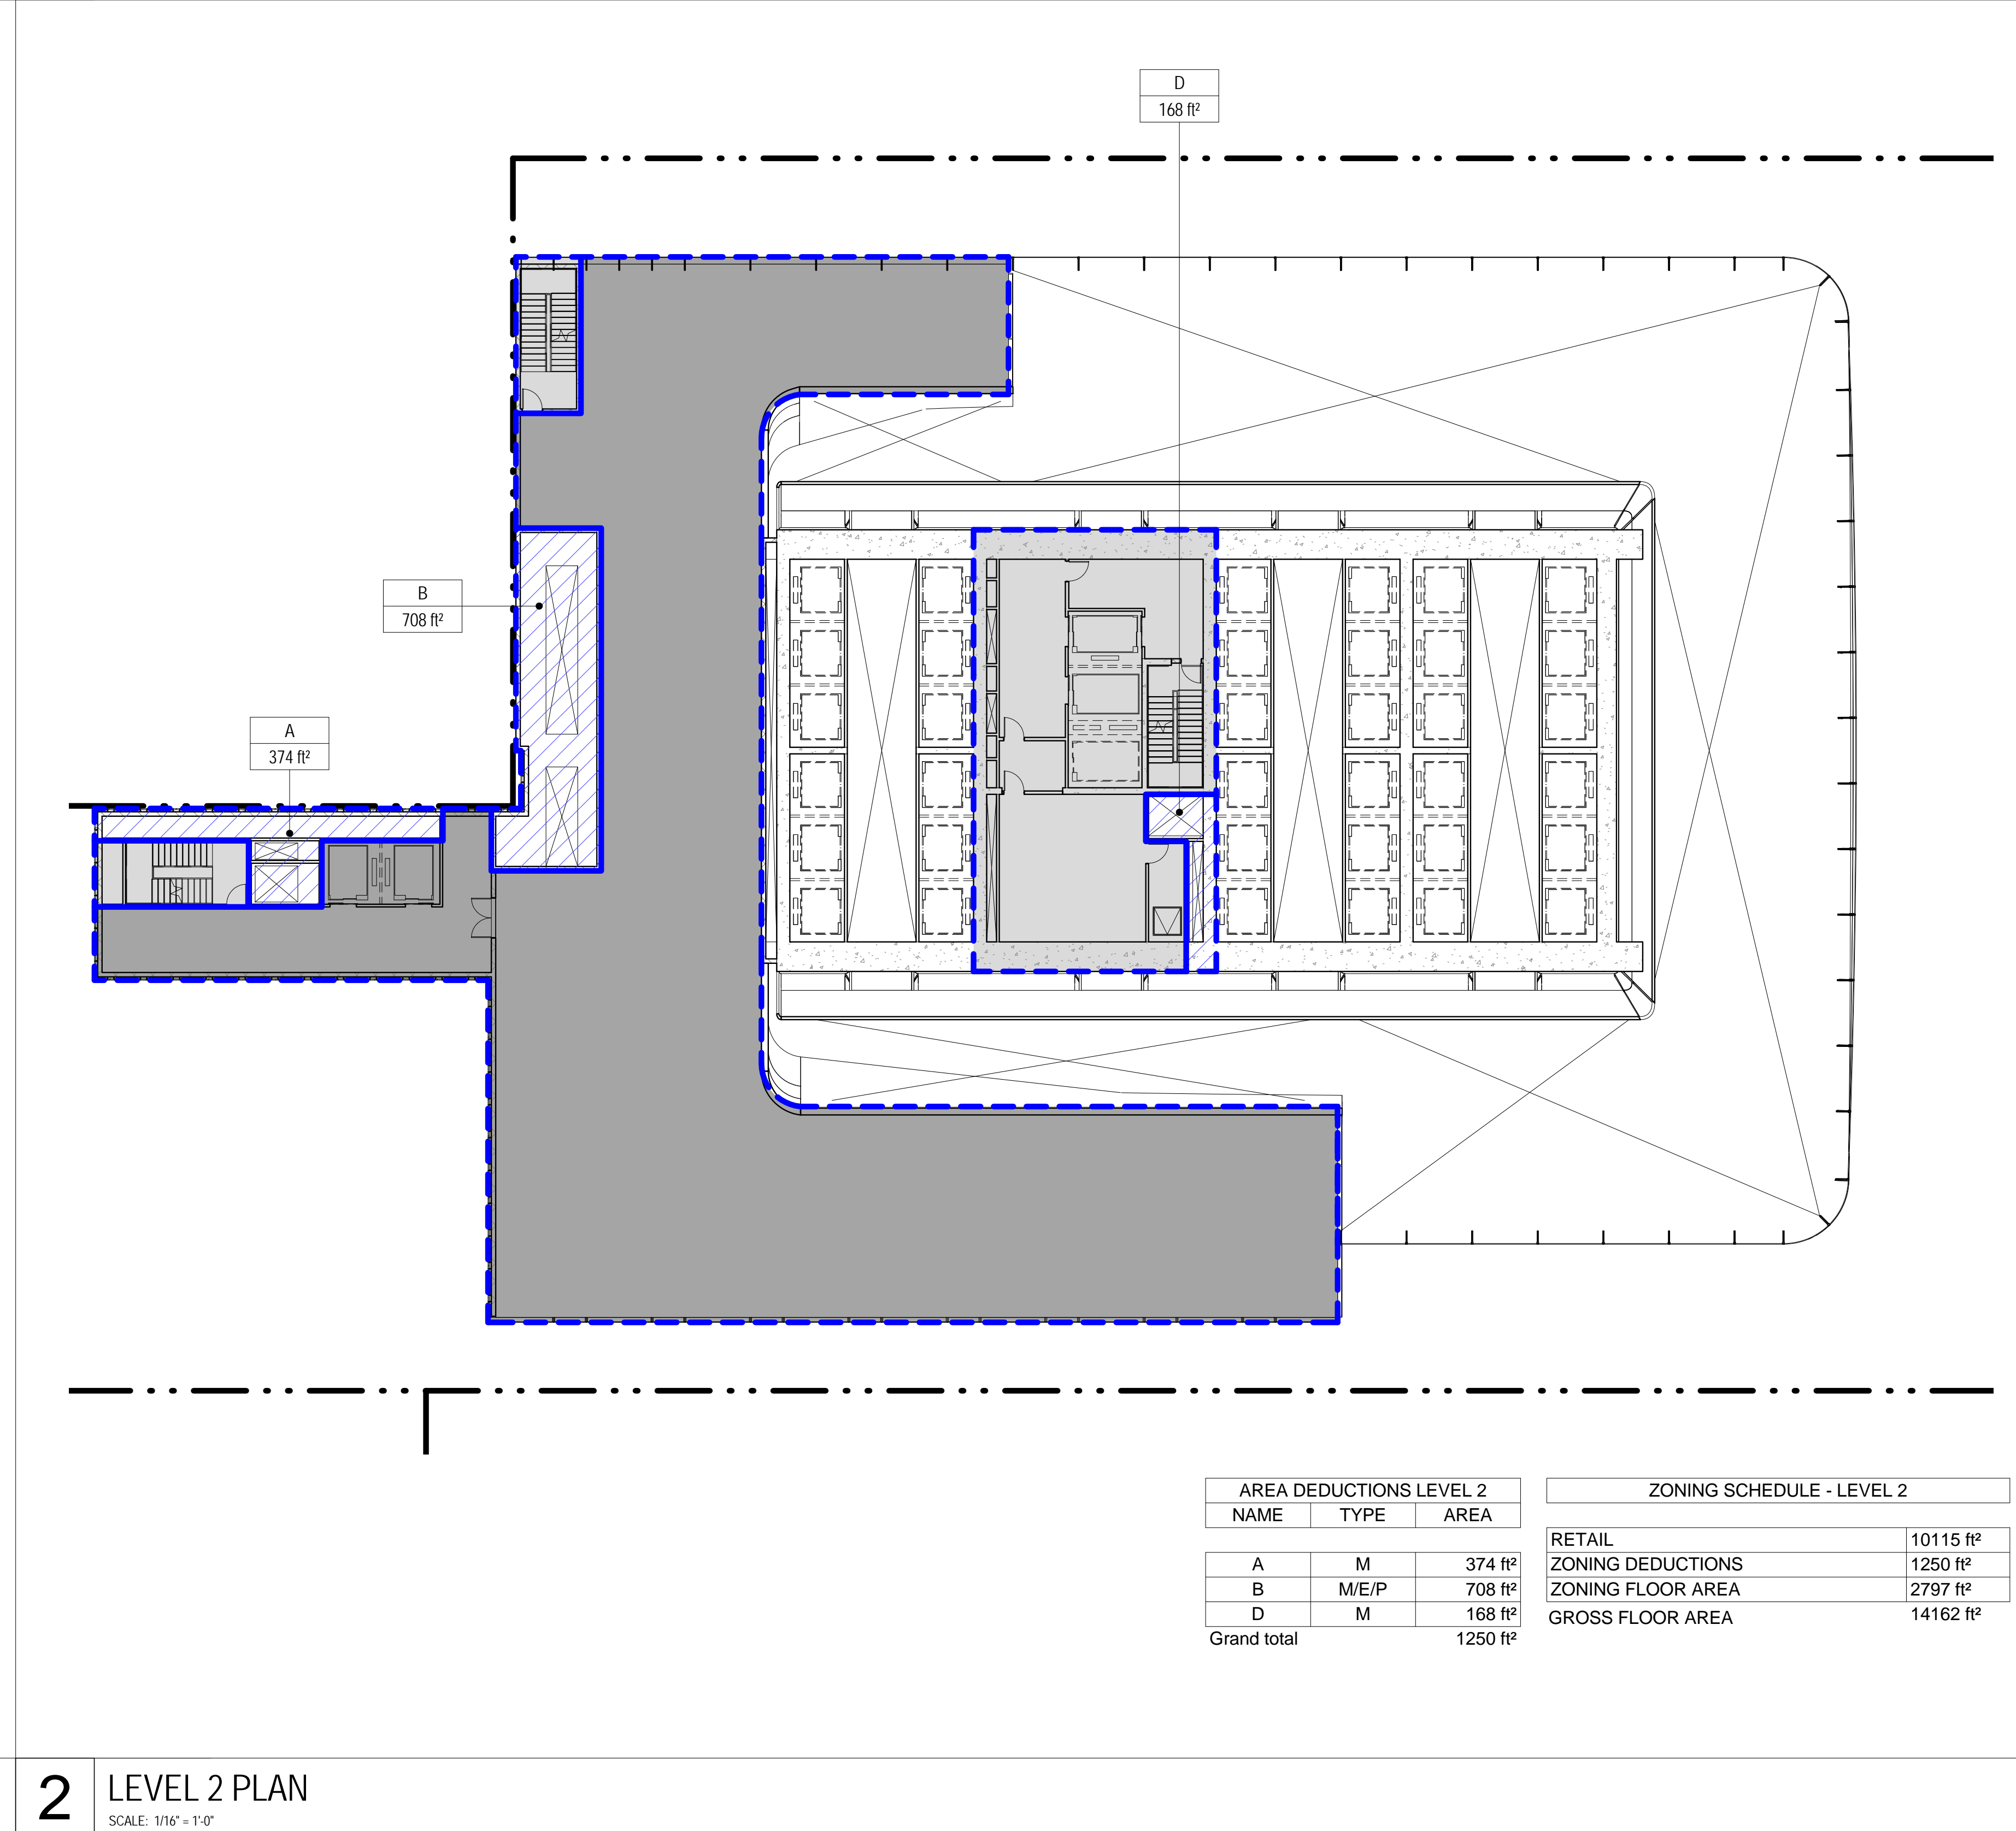

2 LEVEL 2 PLAN
SCALE: 1/16" = 1'-0"

ZONING LEGENDS

- GROSS BUILDING AREA
- ZONING AREA DEDUCTIONS
- ZONING FLOOR AREA
- RETAIL
- MR MECHANICAL ROOM
- M MECHANICAL
- E ELECTRICAL/TEL/IT
- P PLUMBING
- EM ELEVATOR MACHINE ROOM

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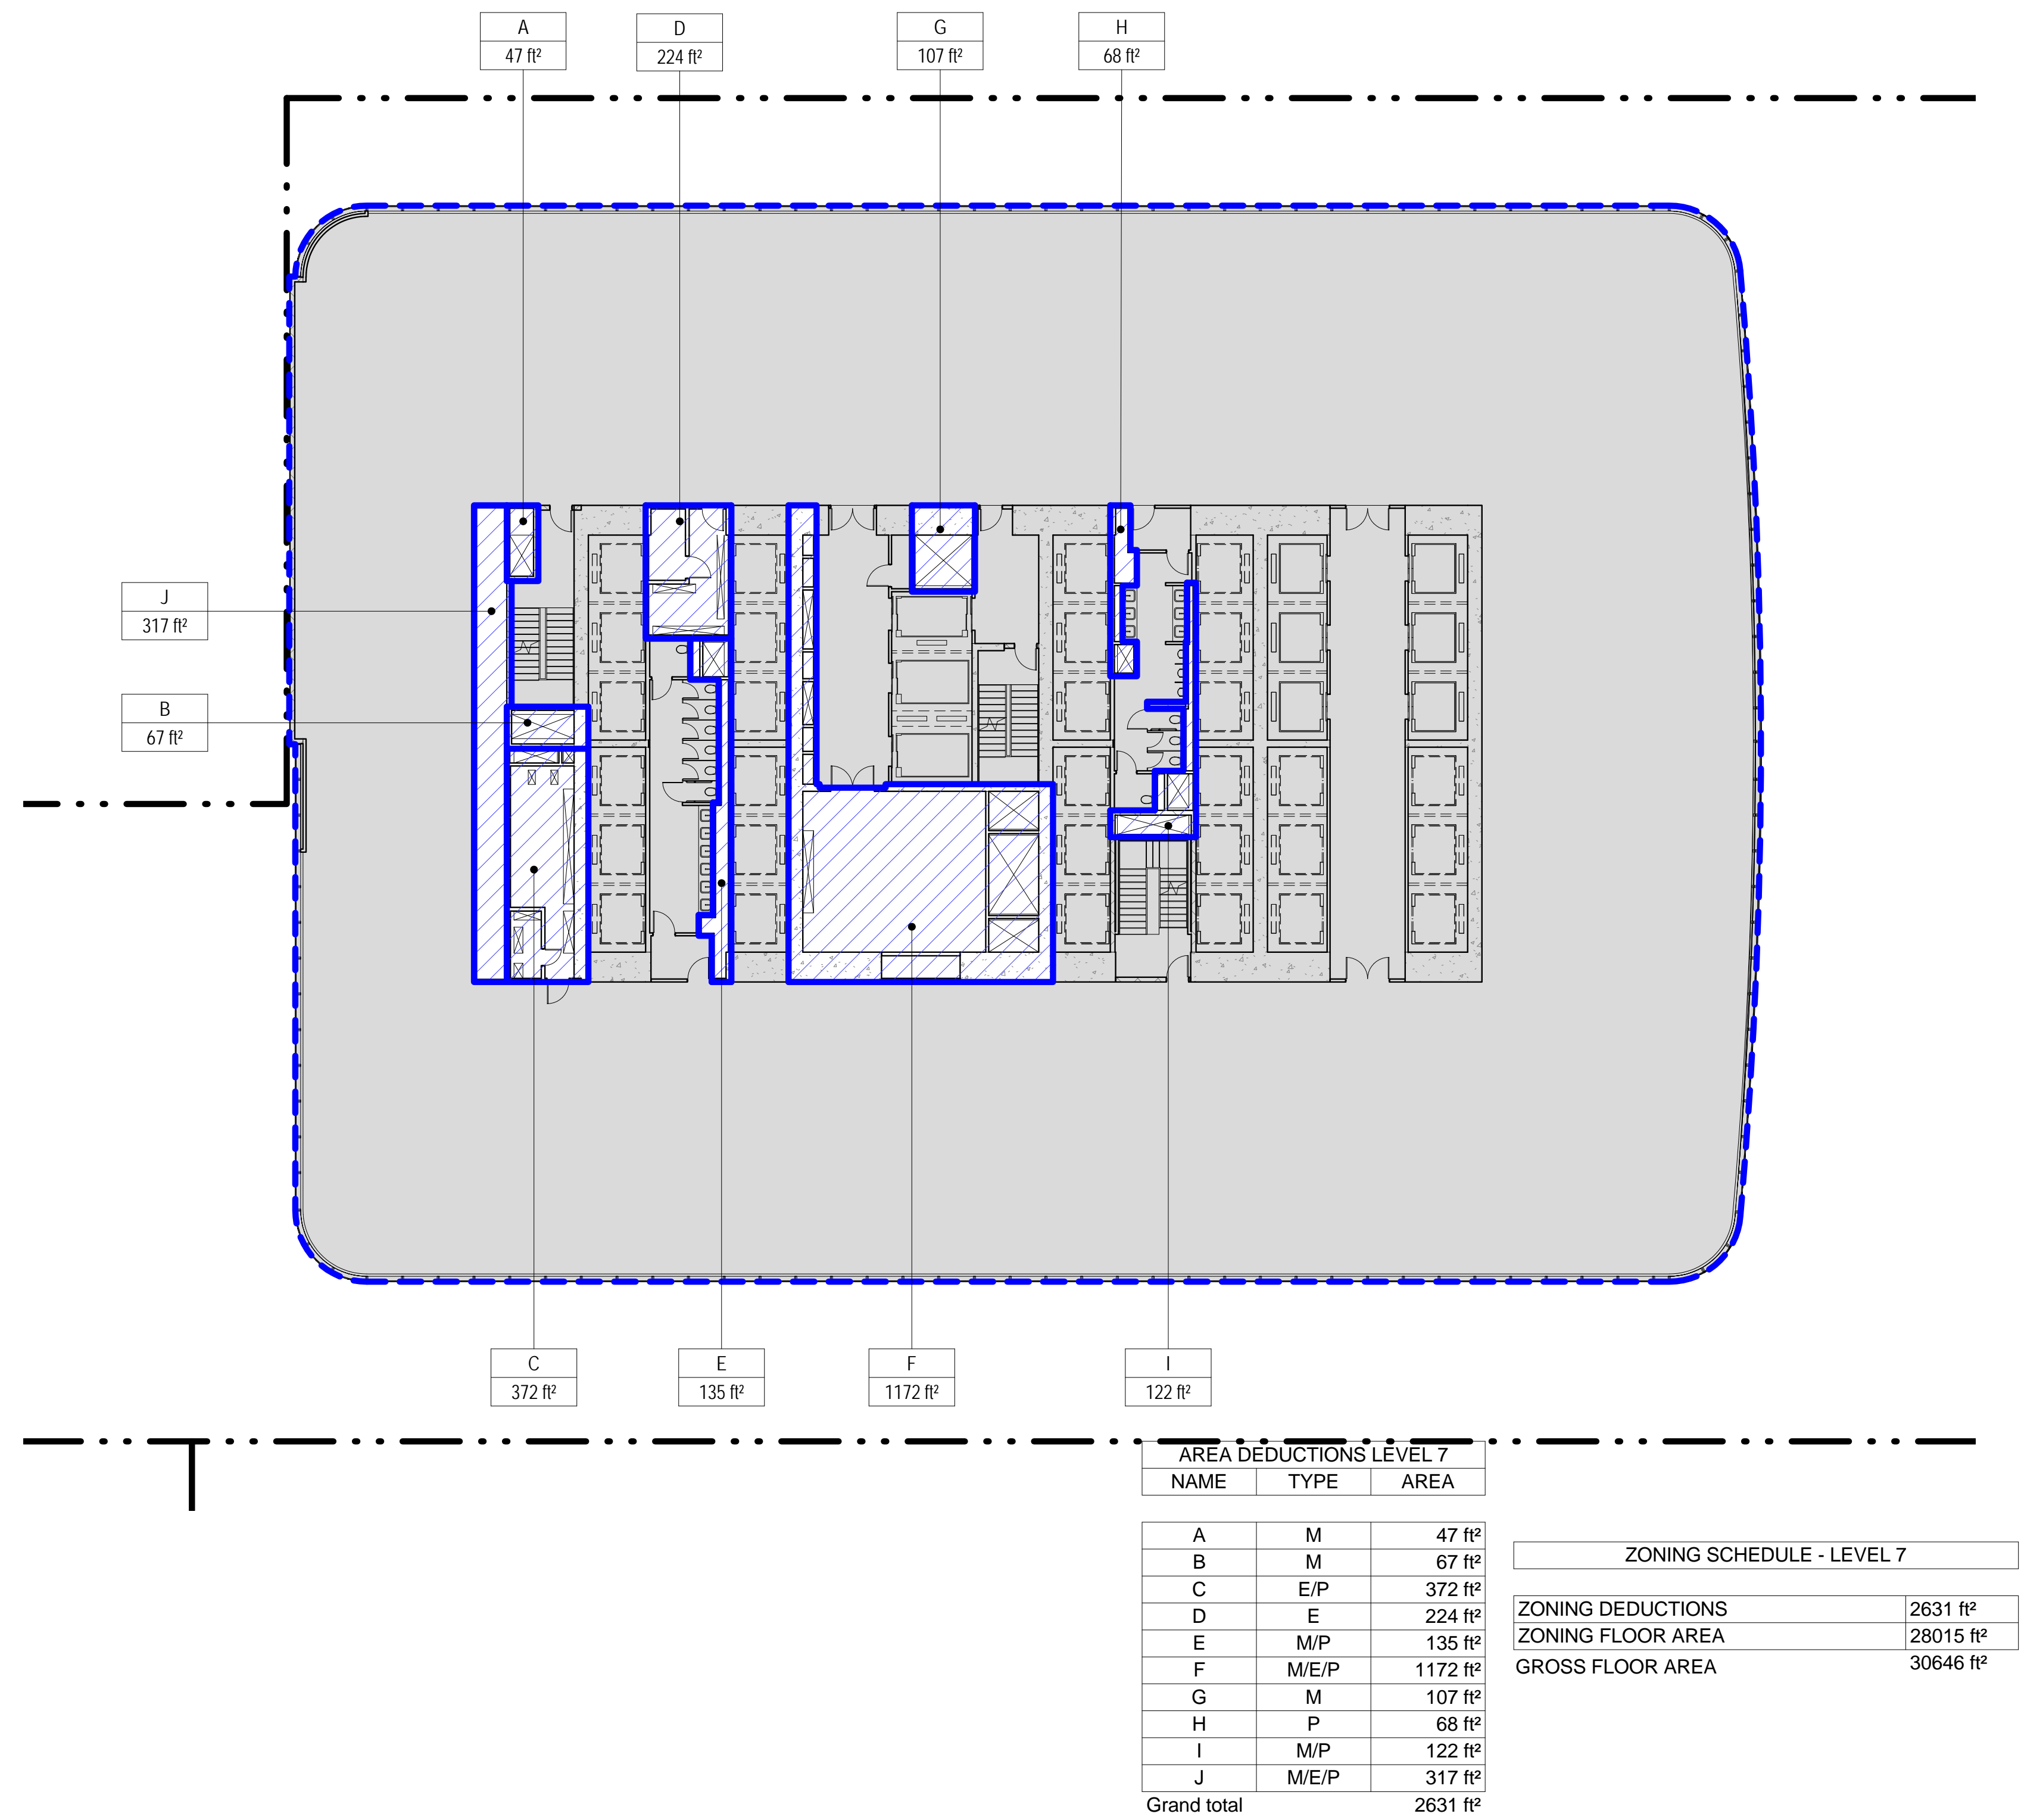
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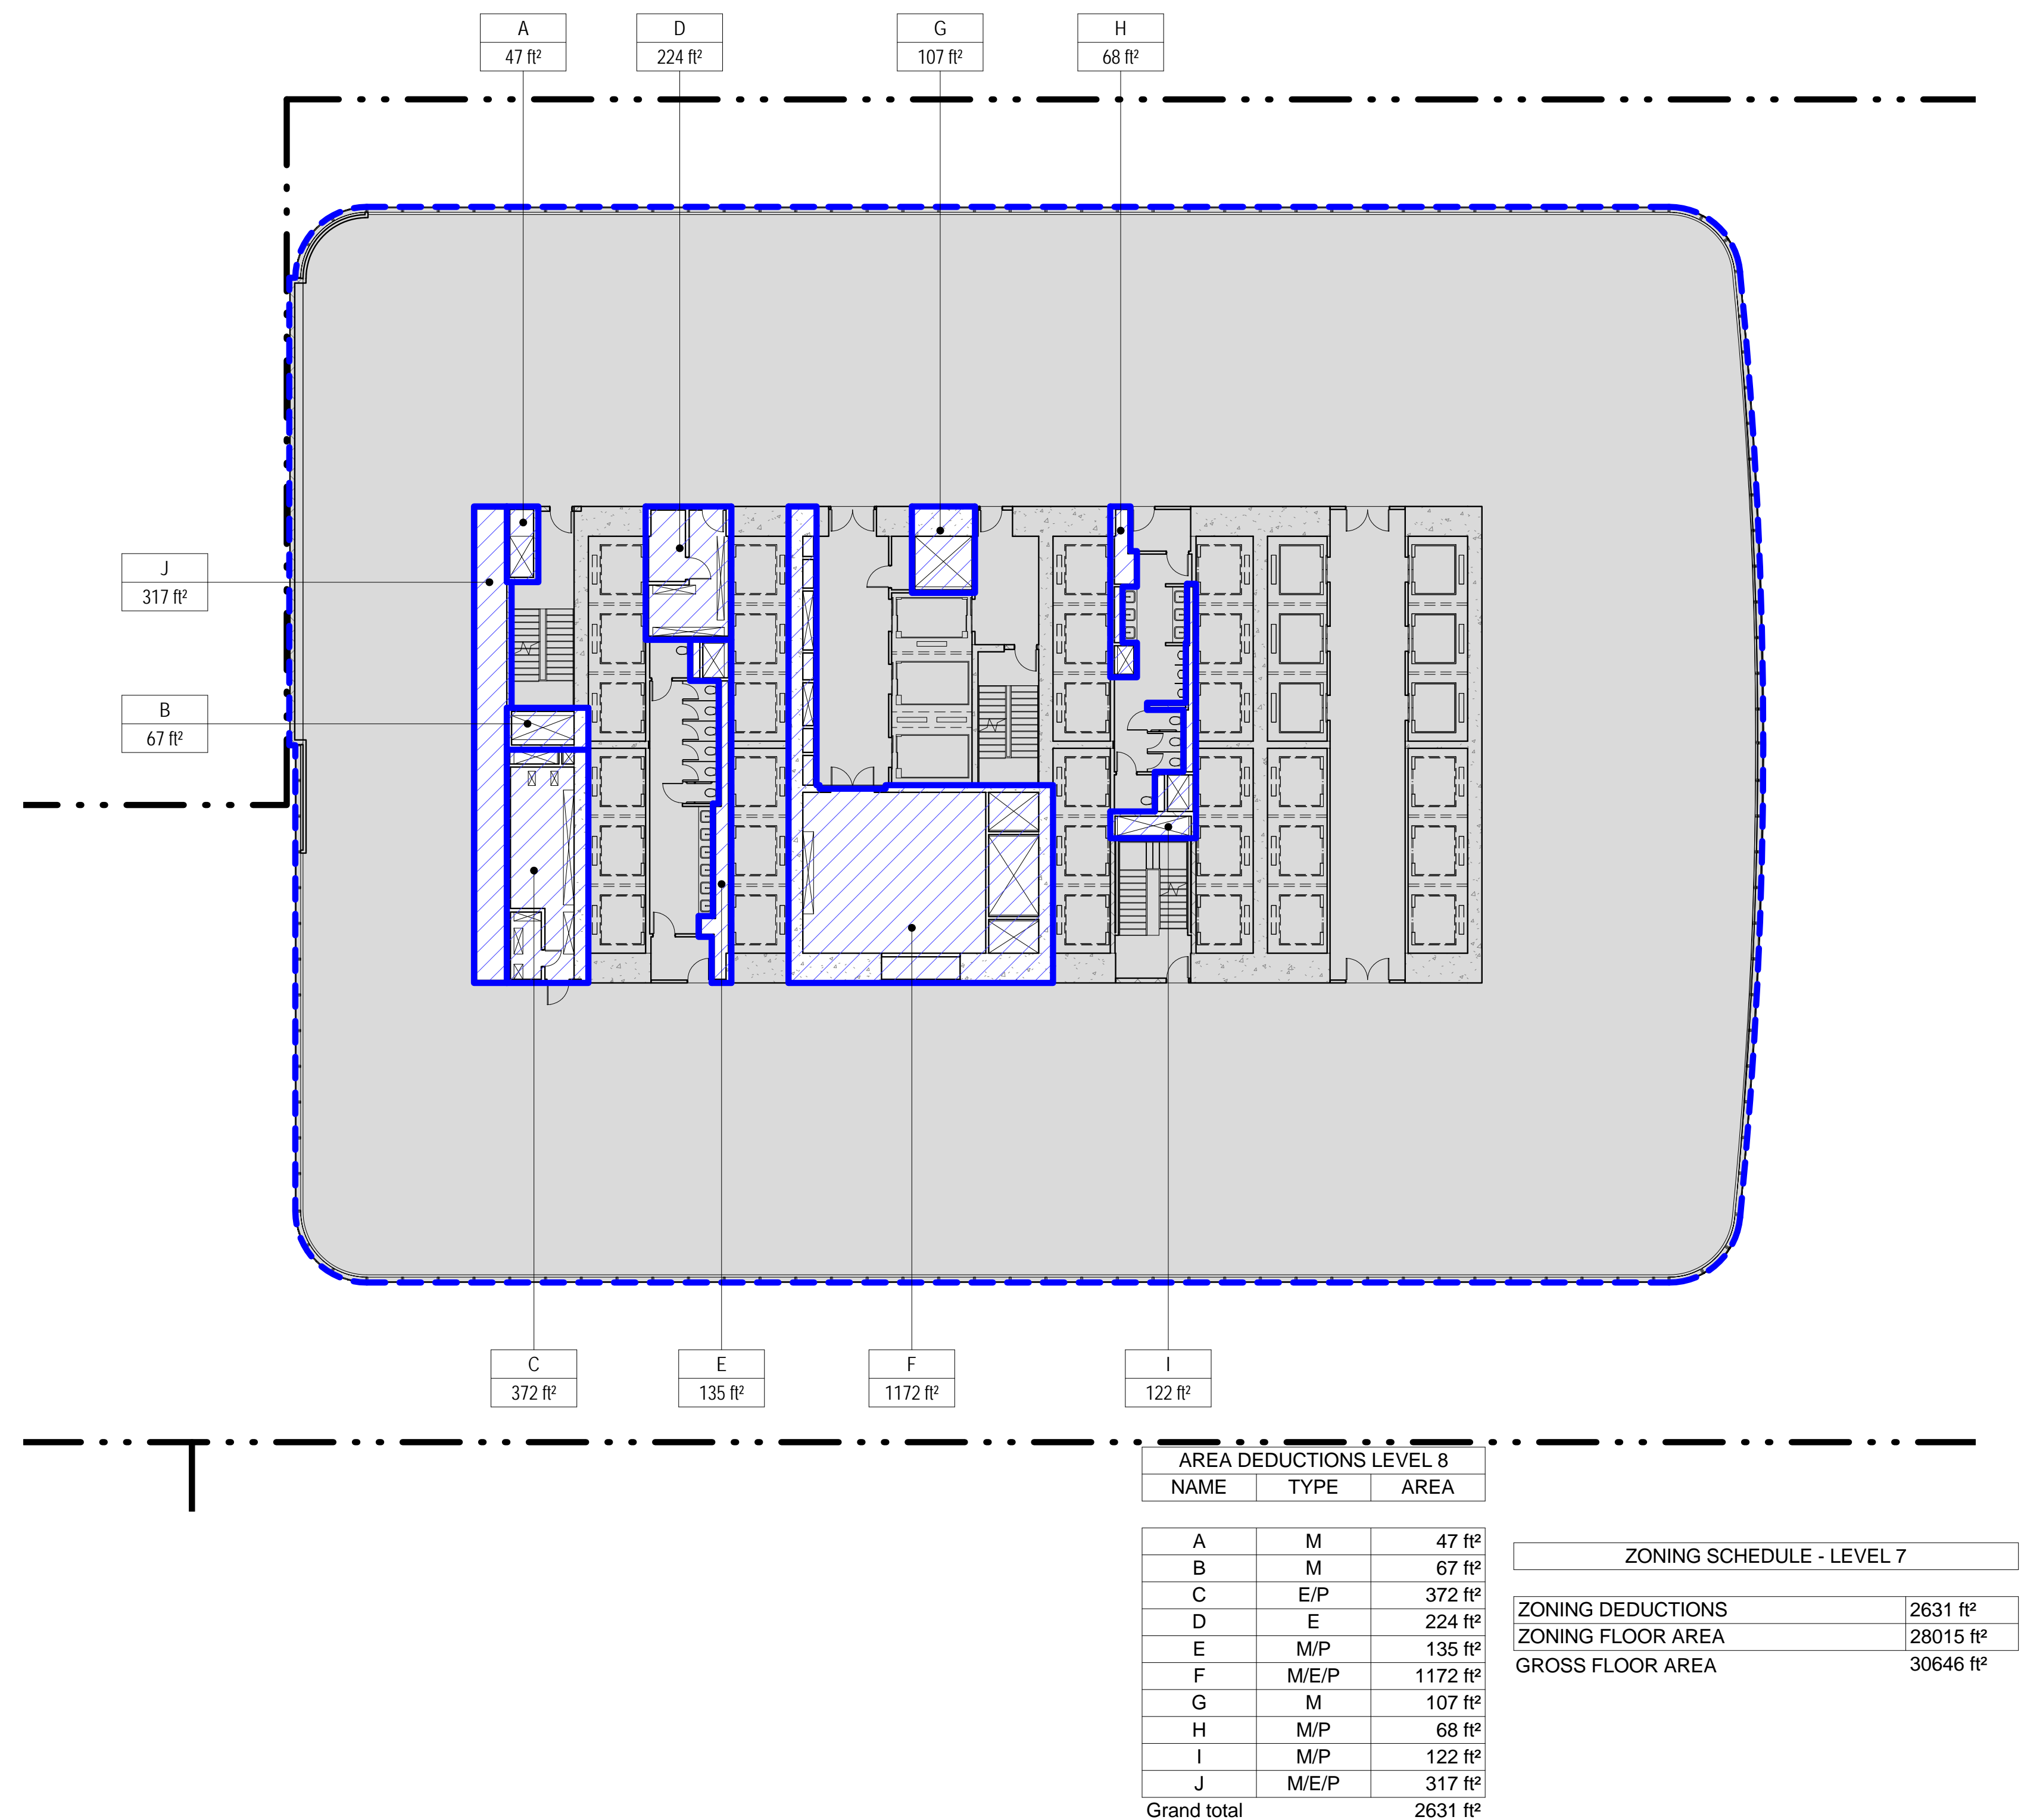
ZONING FLOOR AREA DEDUCTIONS - GROUND FLOOR & LEVEL 2-4

Project No.: 207150	B-SCAN Sheet No.: Z-104.00
Date: 20 JUN 2014	Sheet No.: Z-104
Scale: 1/16" = 1'-0"	Page No.: 11 OF 28
File No.: Z-104	


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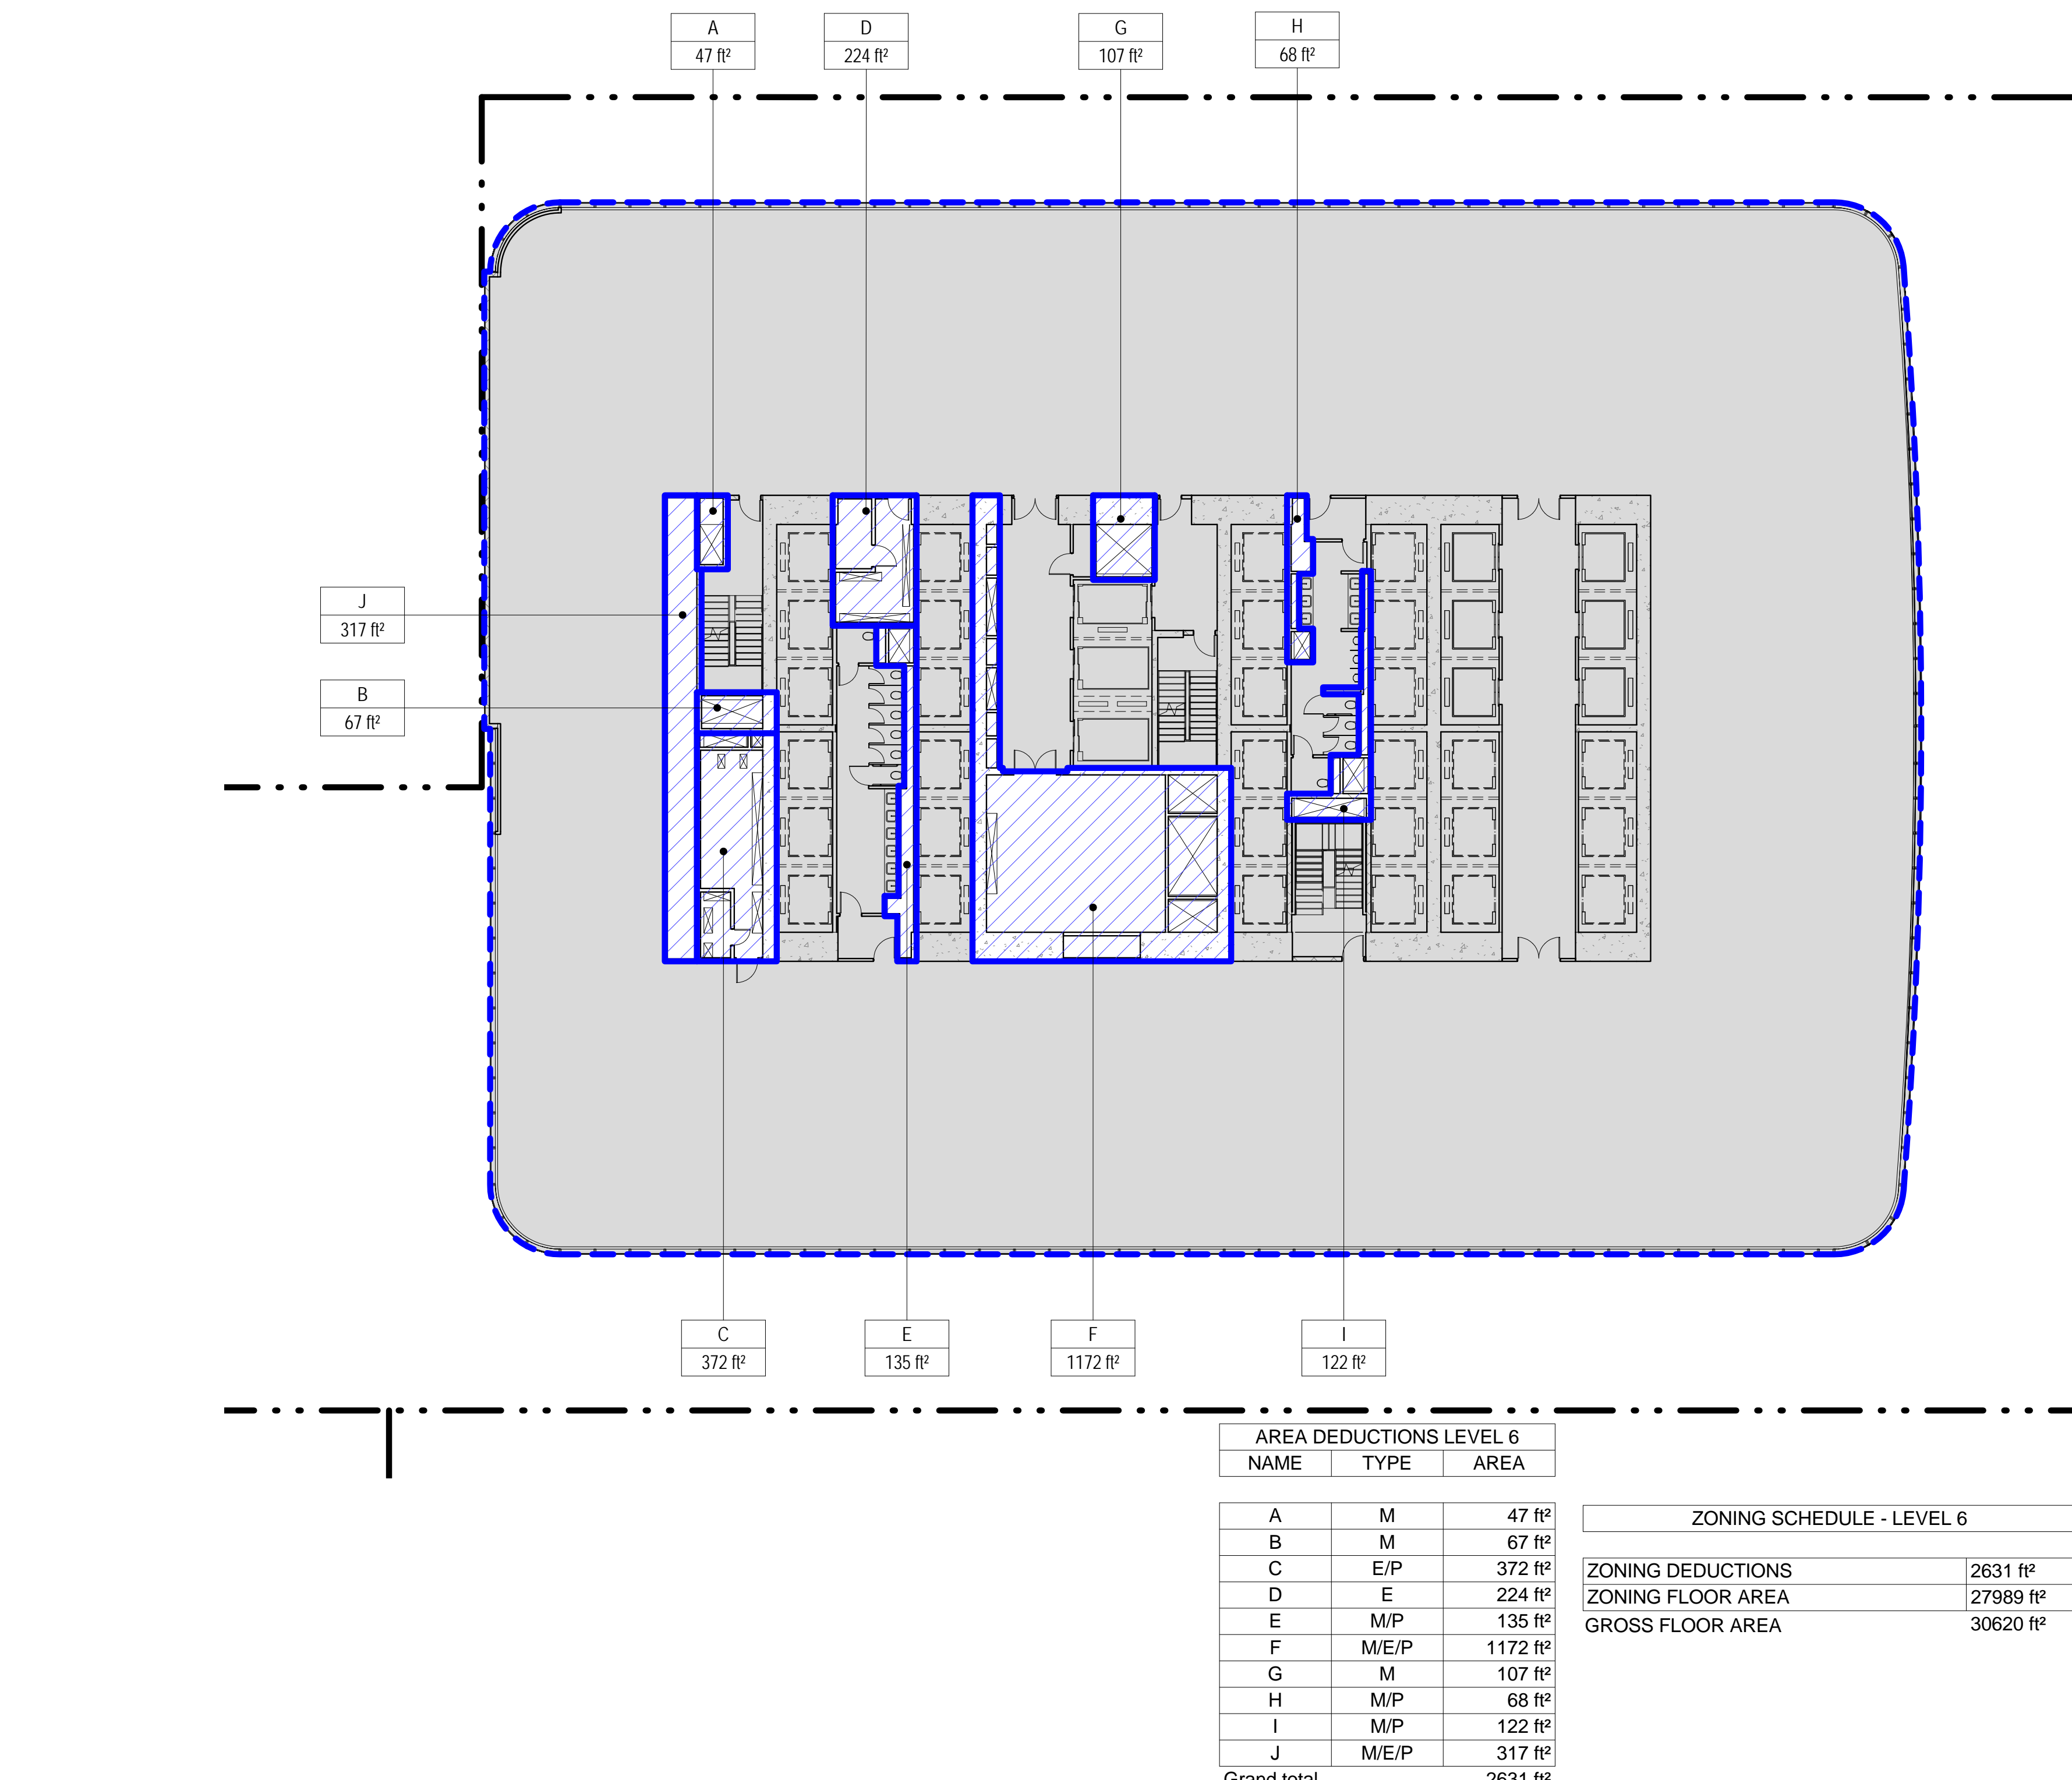
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1 LEVEL 5 PLAN
SCALE: 1/16" = 1'-0"



2 LEVEL 6 PLAN
SCALE: 1/16" = 1'-0"



- ZONING LEGENDS
- GROSS BUILDING AREA
 - ZONING AREA DEDUCTIONS
 - ZONING FLOOR AREA
 - RETAIL
 - MR MECHANICAL ROOM
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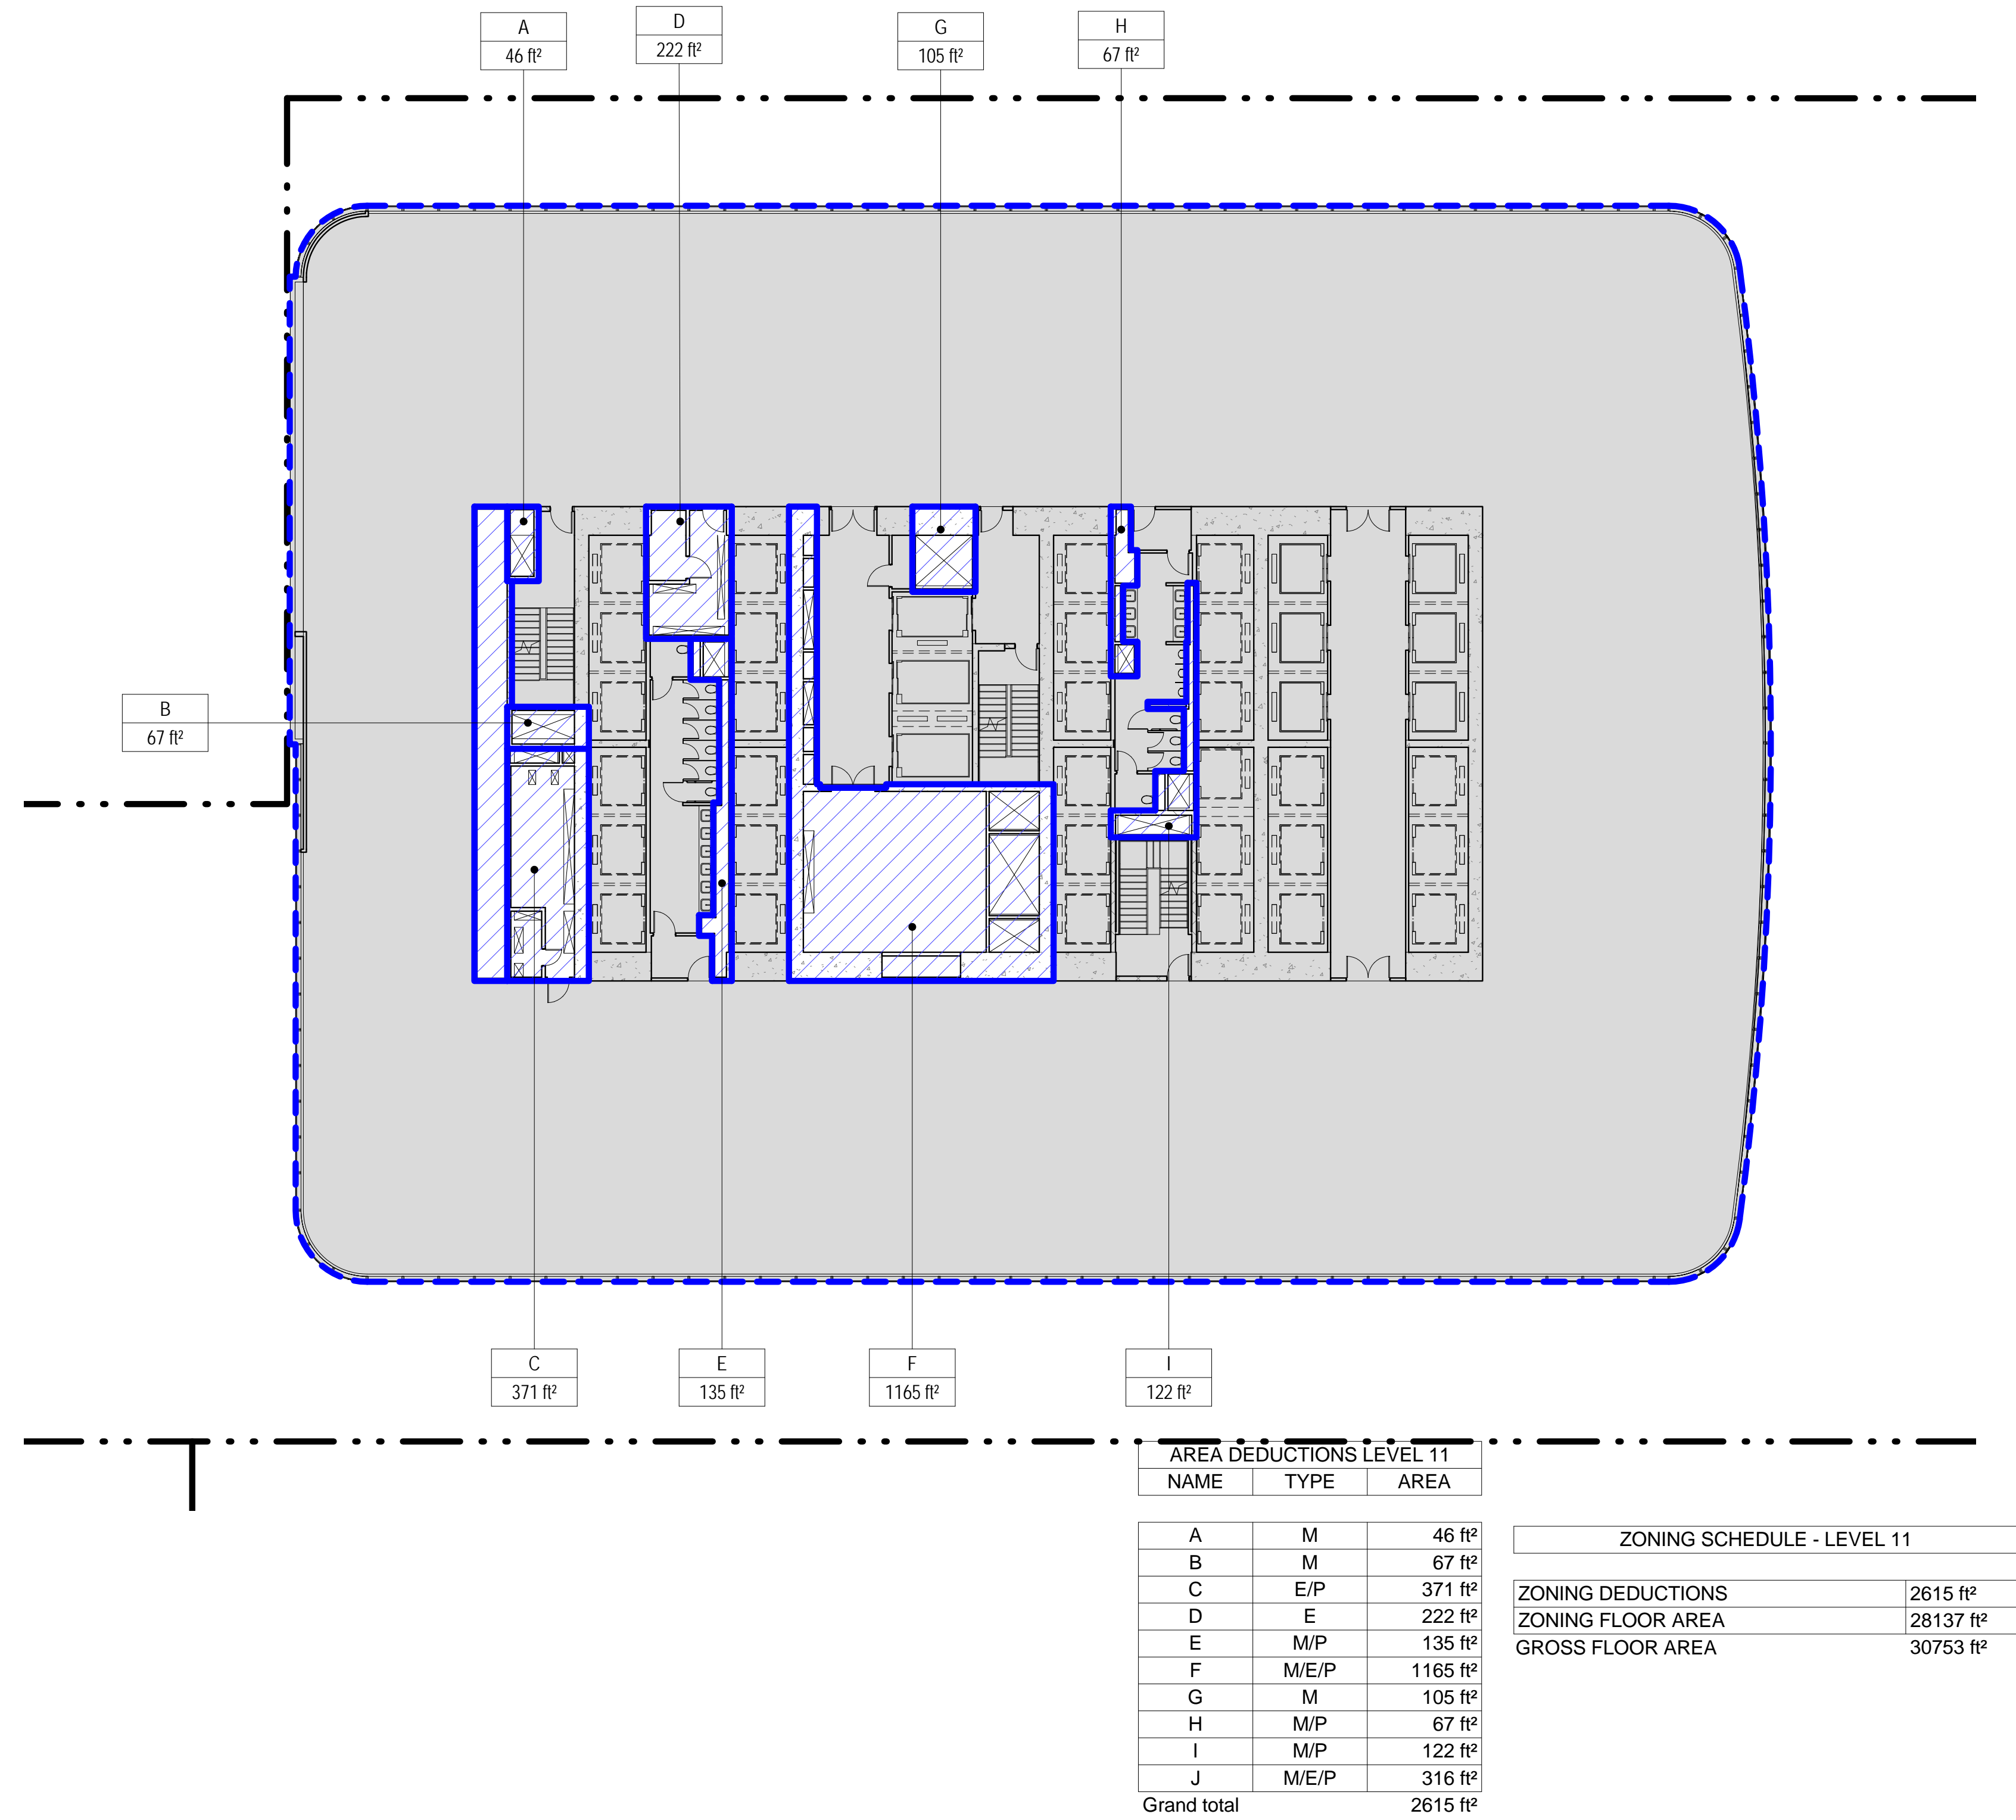

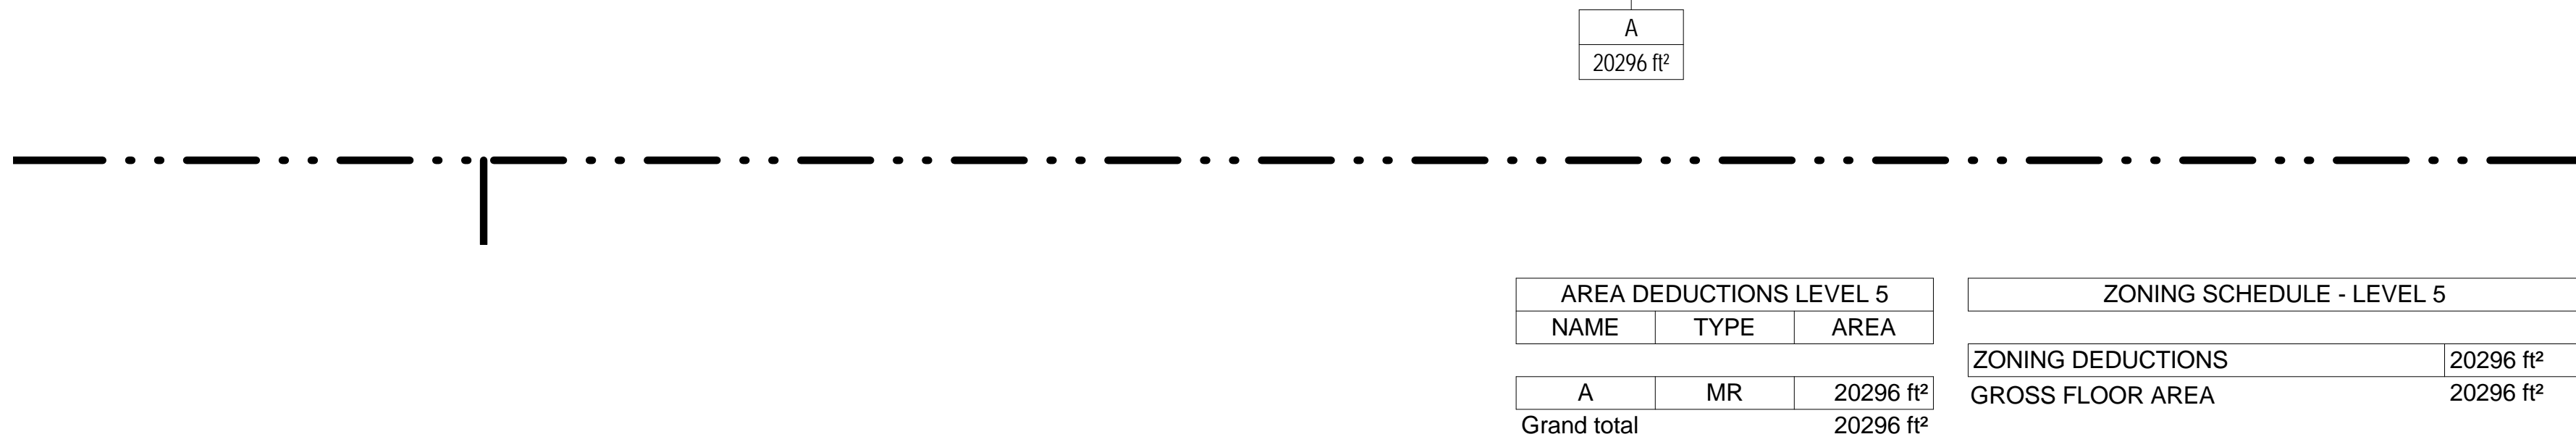
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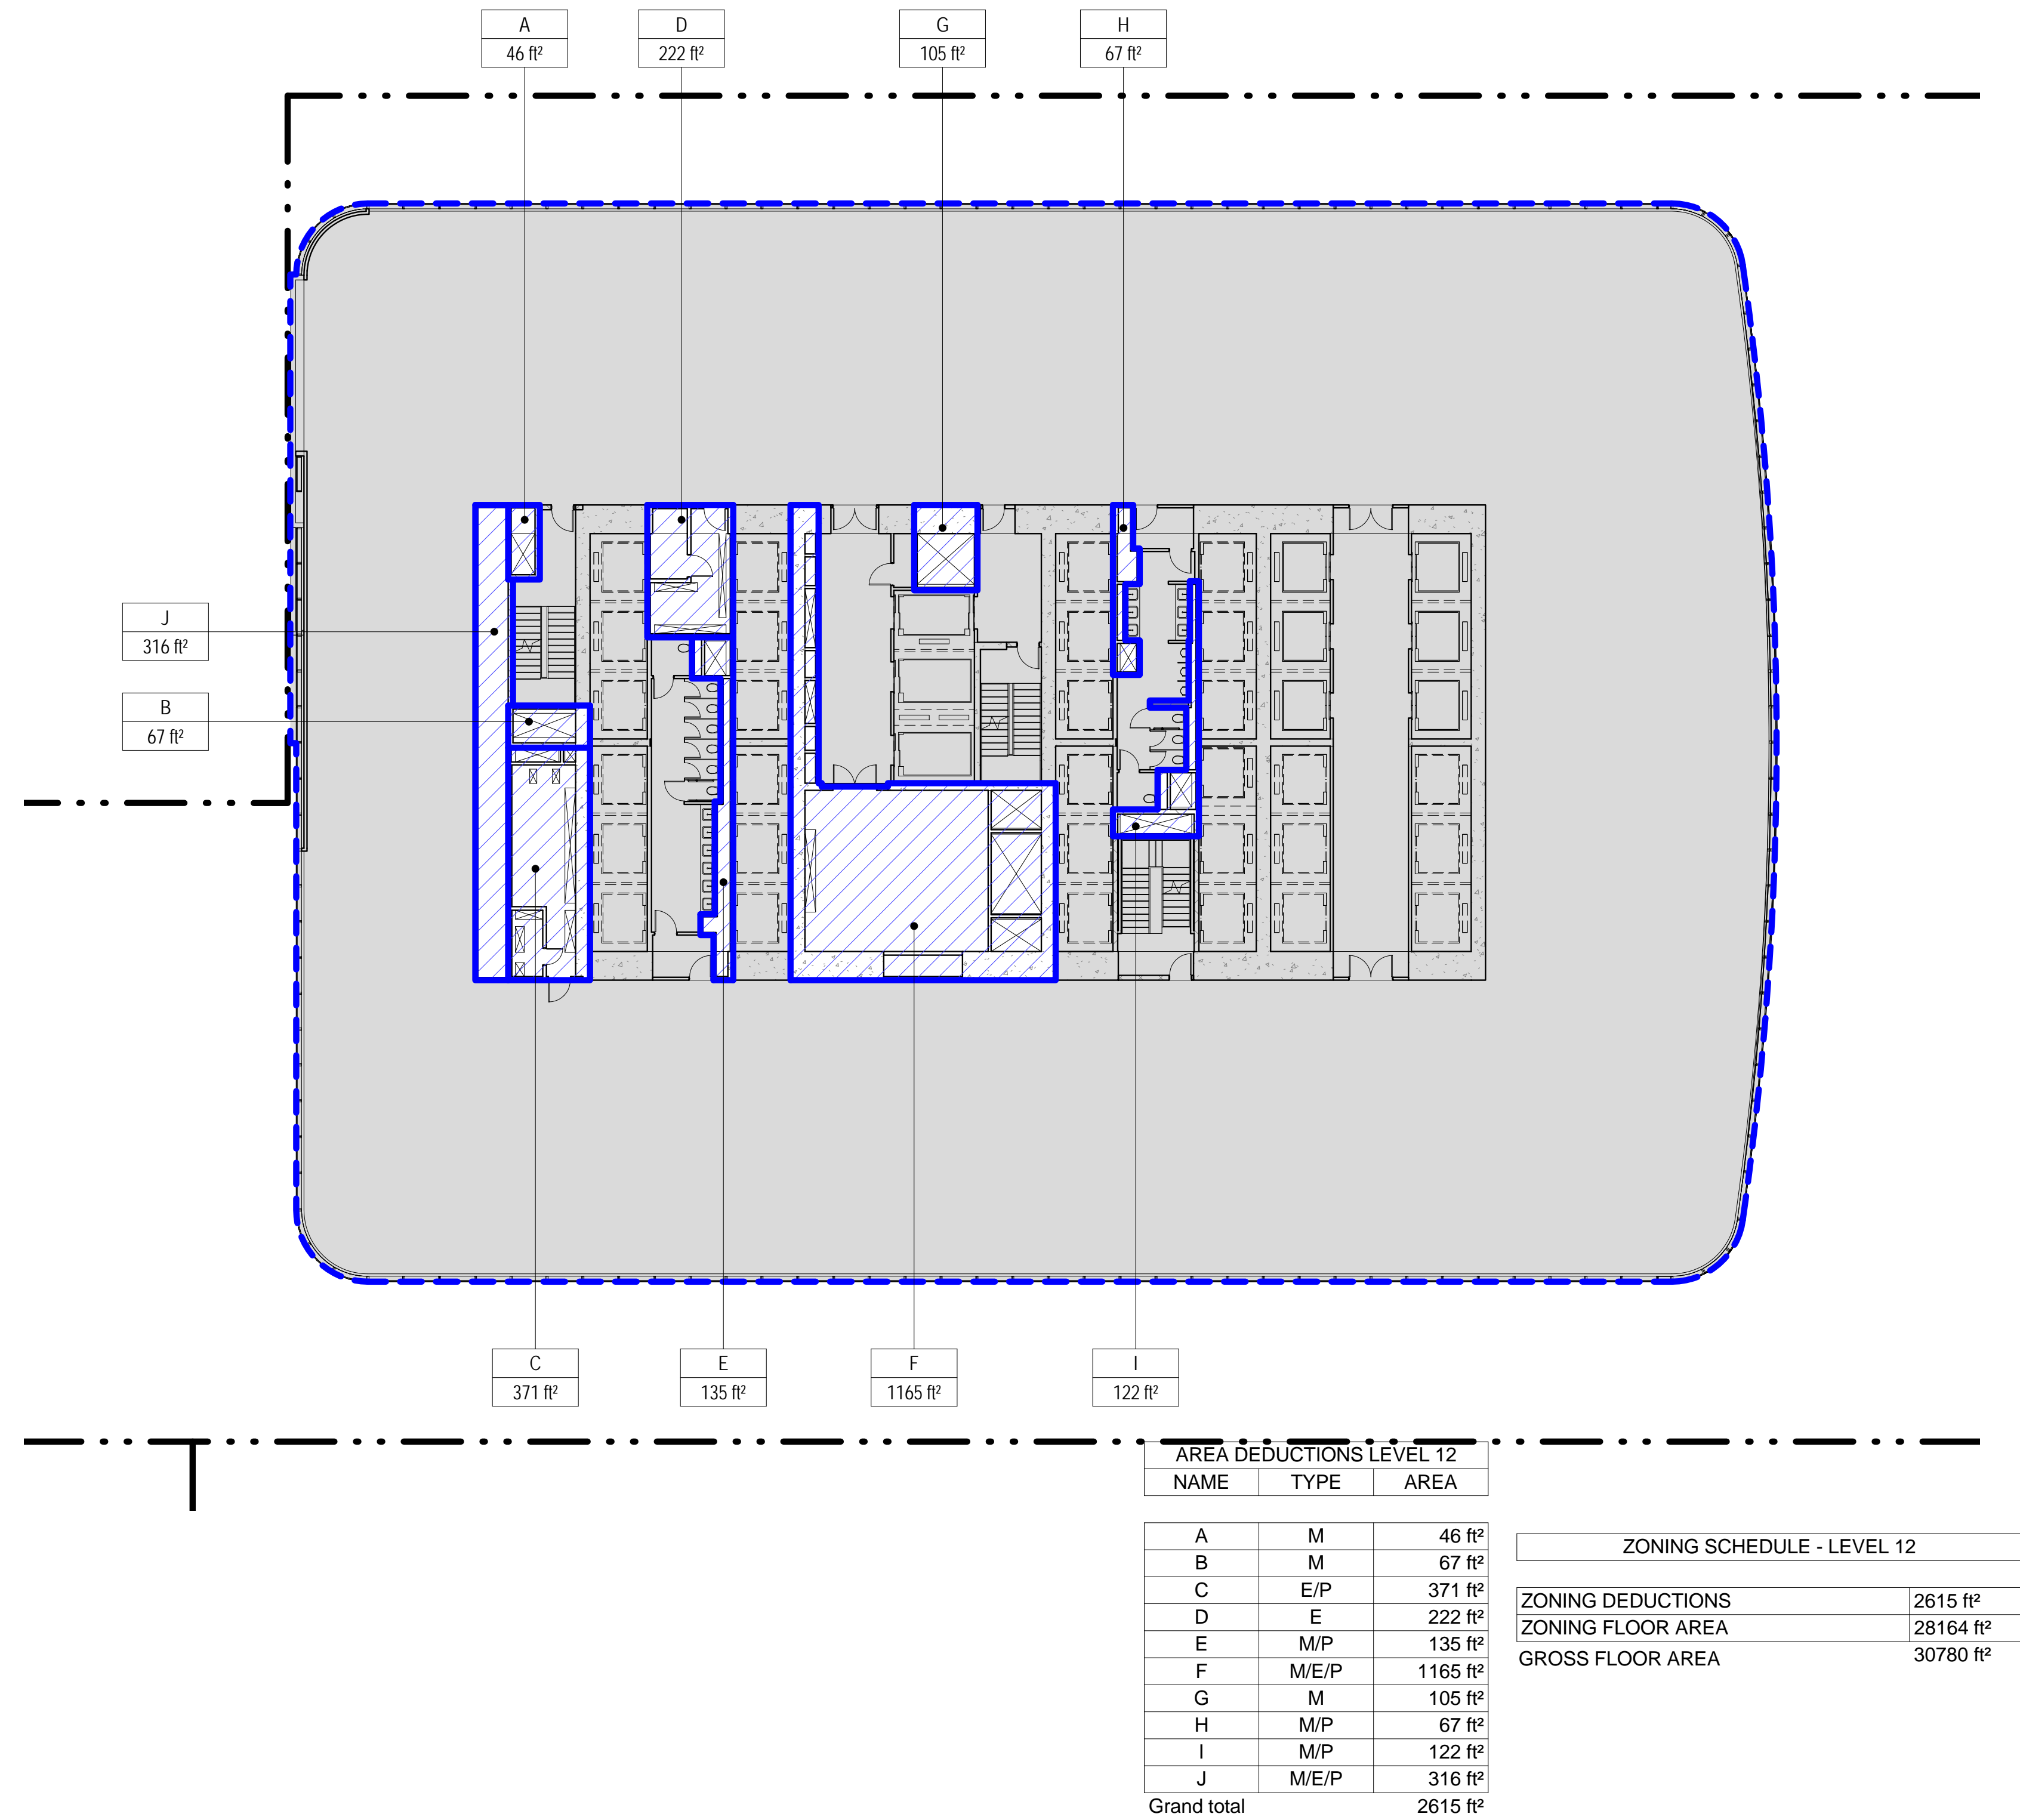
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ZONING FLOOR AREA DEDUCTIONS - LEVEL 5-8


3 LEVEL 11 PLAN
SCALE: 1/16" = 1'-0"




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SCALE: 1/16" = 1'-0"



1 LEVEL 9 PLAN
SCALE: 1/16" = 1'-0"

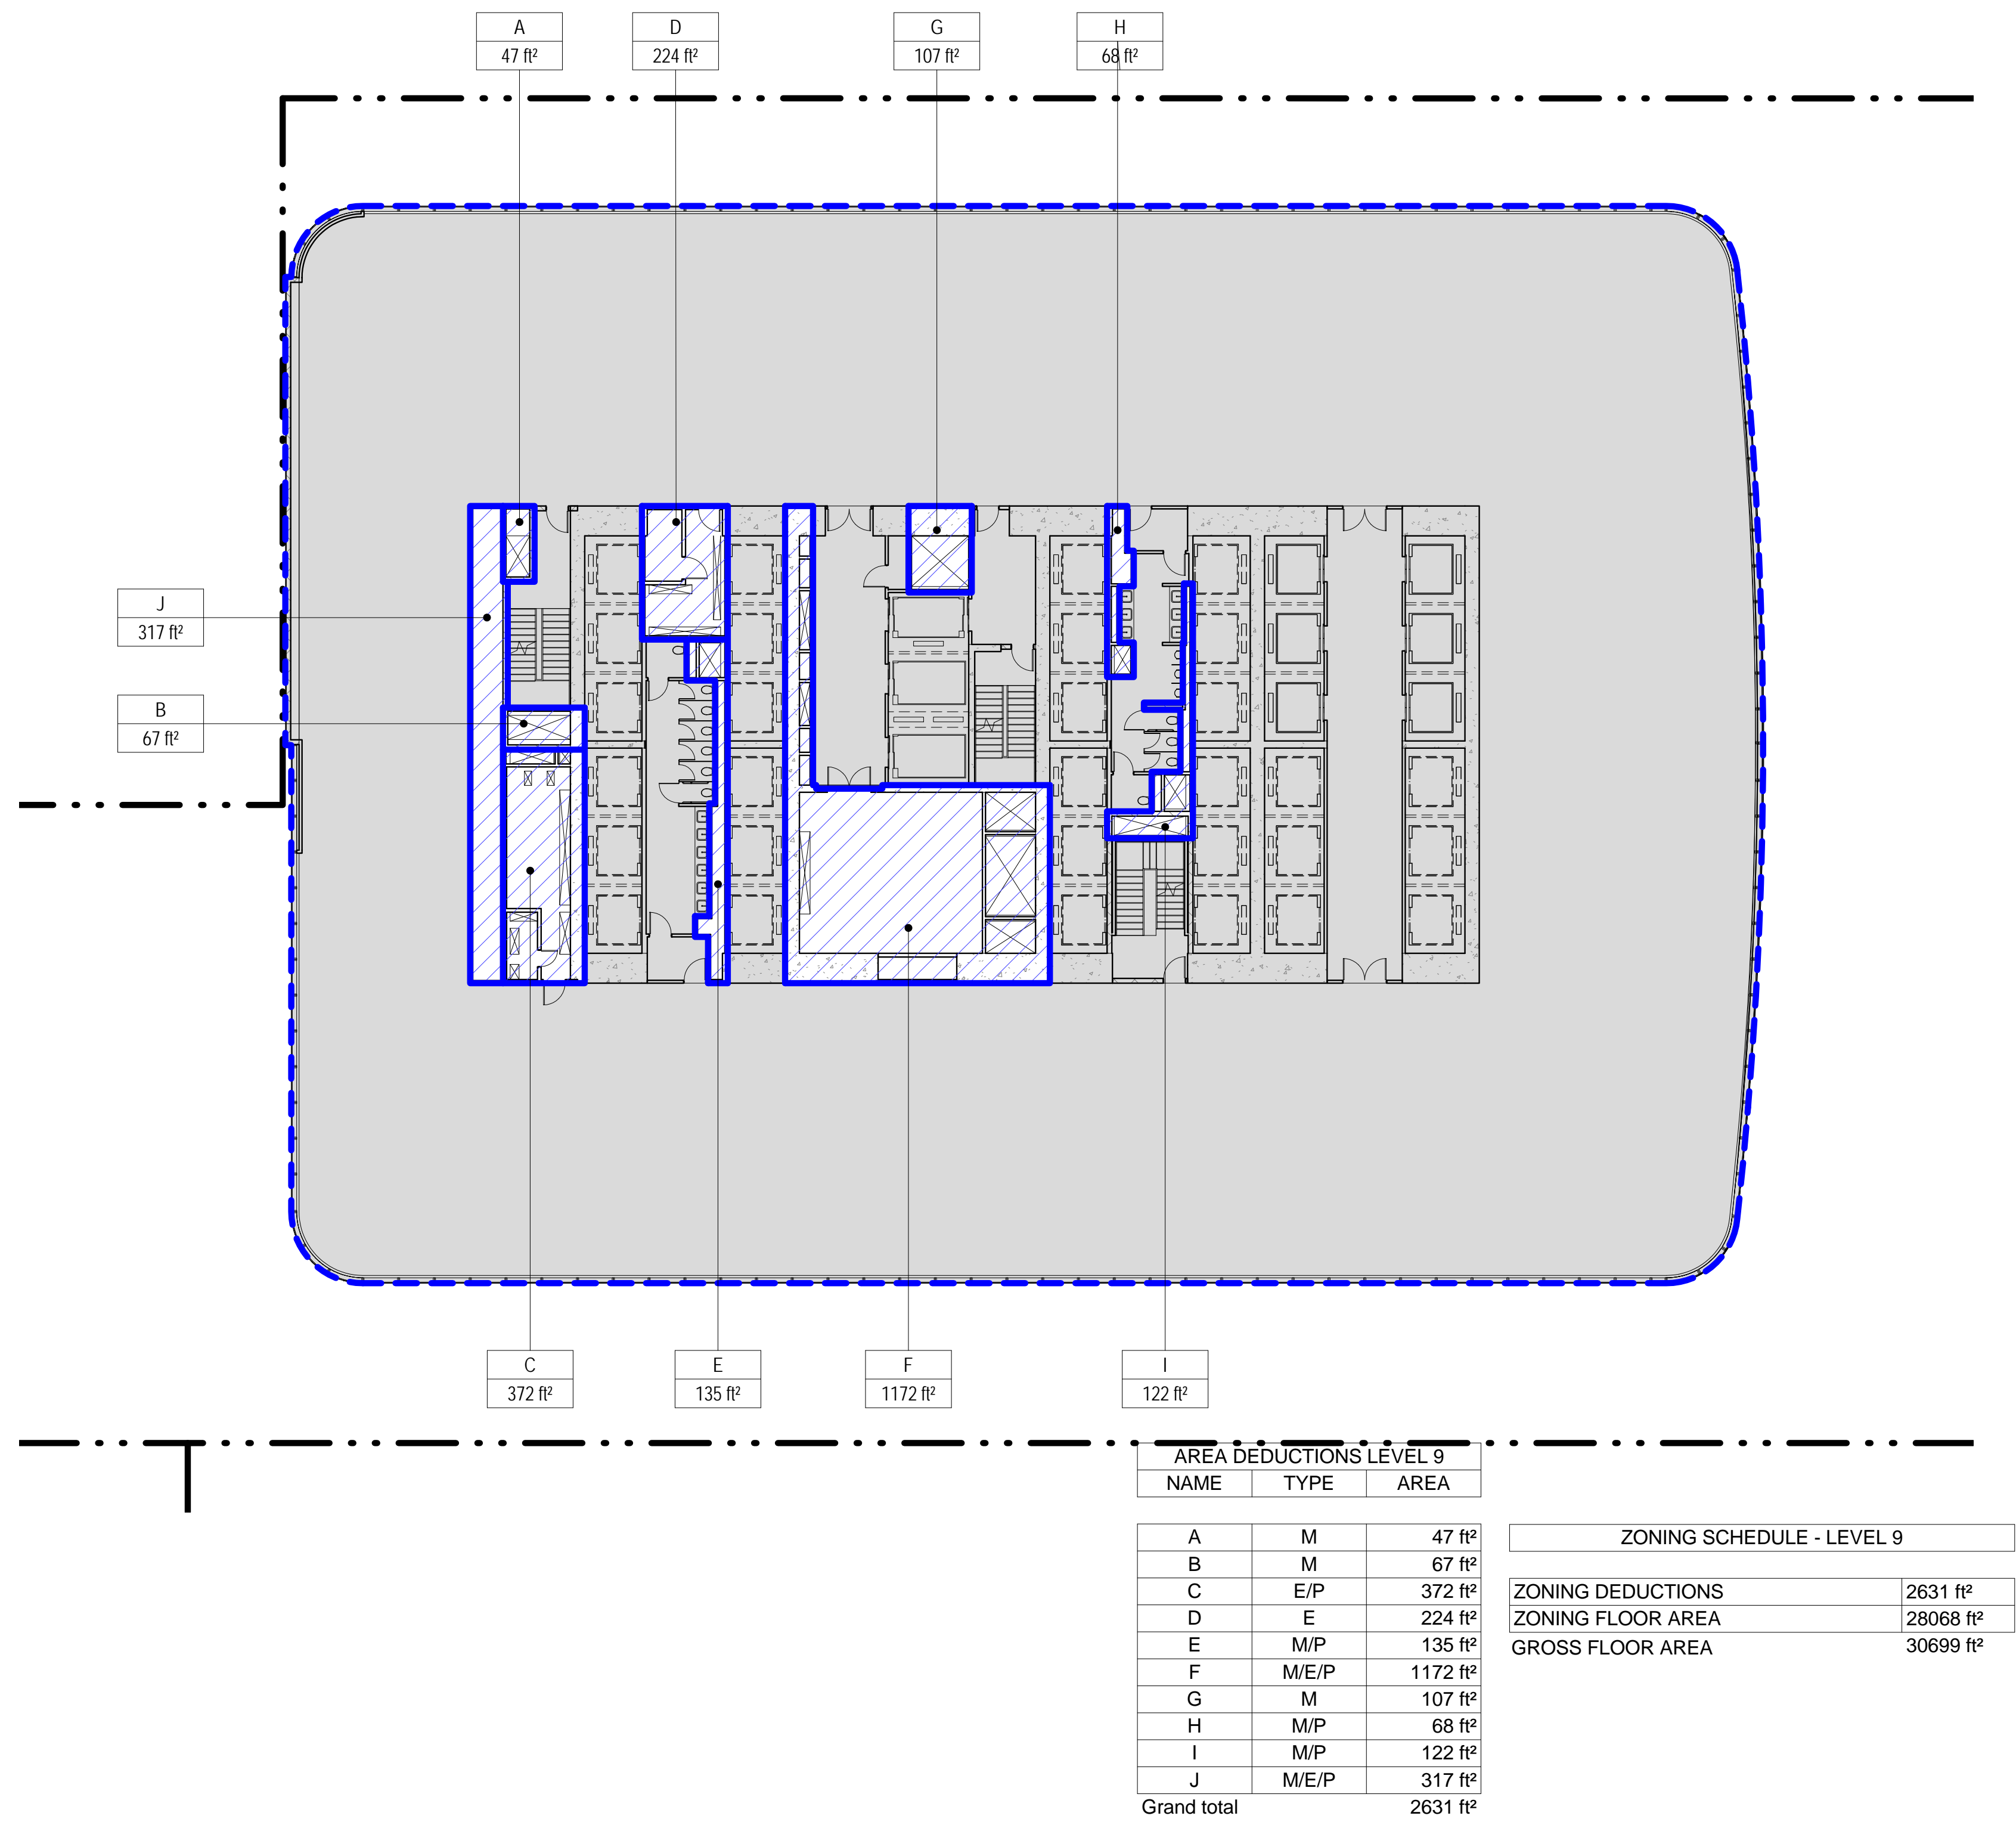

2 LEVEL 10 PLAN
SCALE: 1/16" = 1'-0"

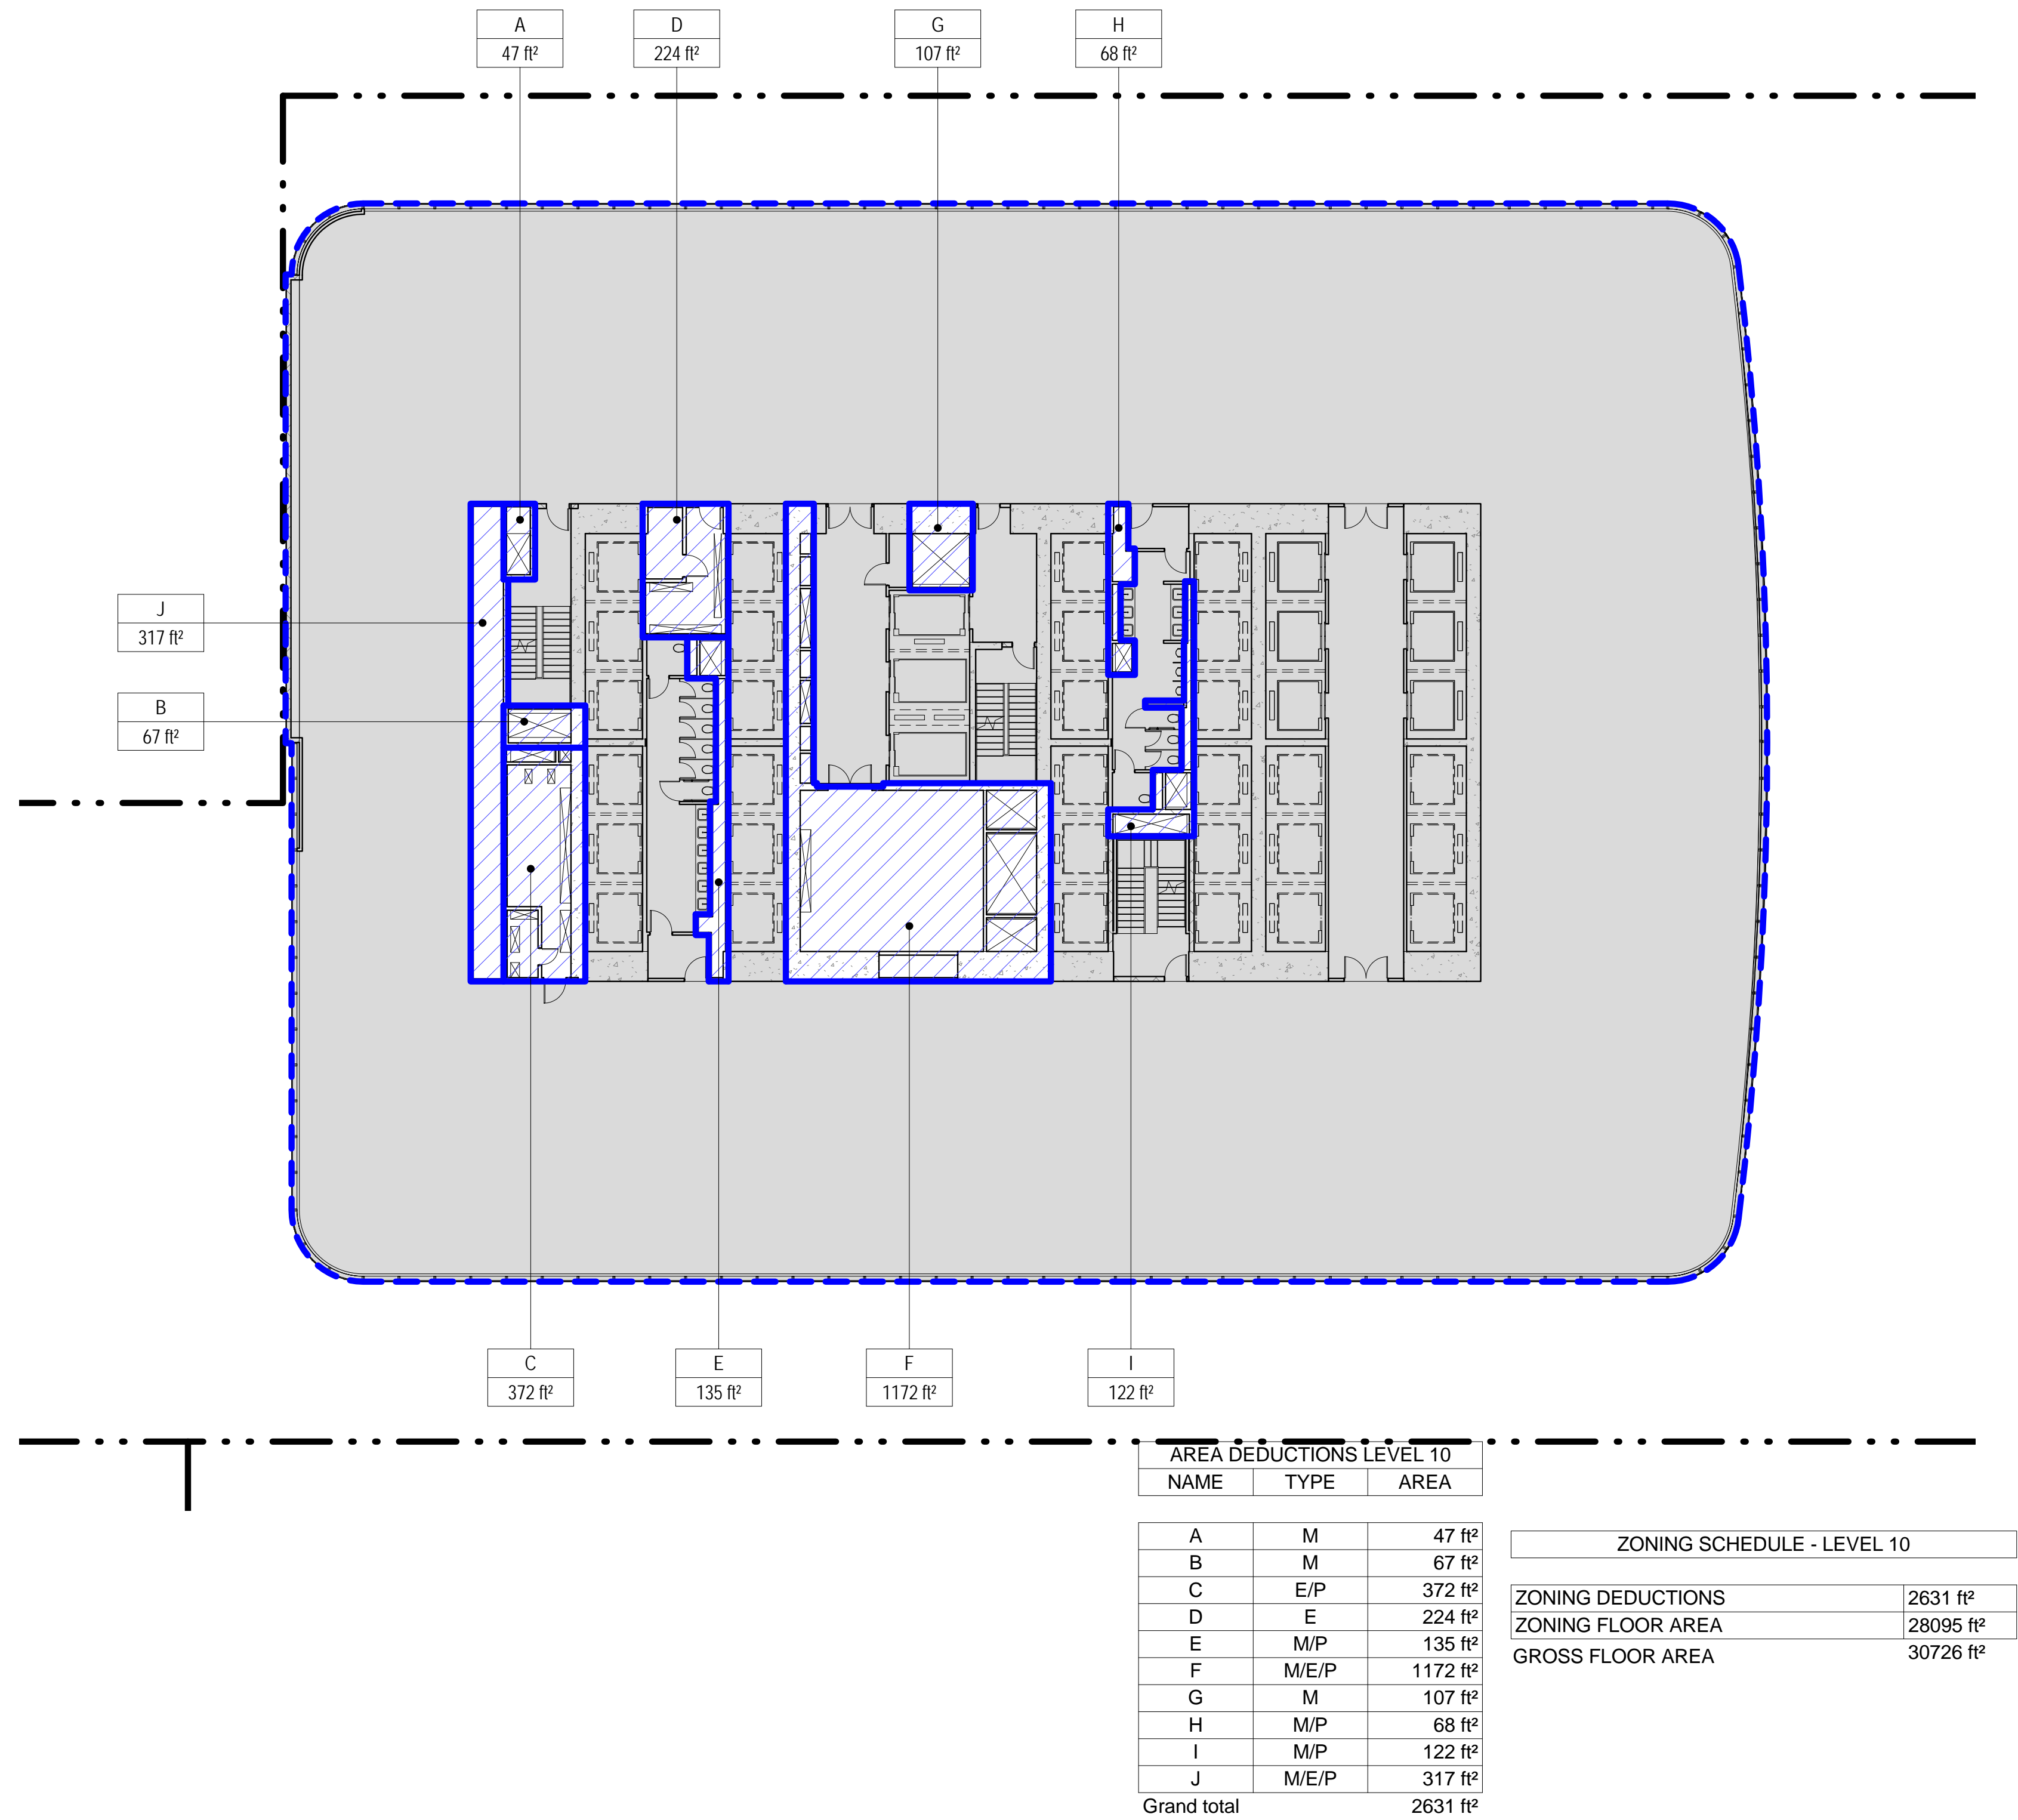

- ZONING LEGENDS**
- GROSS BUILDING AREA
 - ZONING AREA DEDUCTIONS
 - ZONING FLOOR AREA
 - RETAIL
 - MR MECHANICAL ROOM
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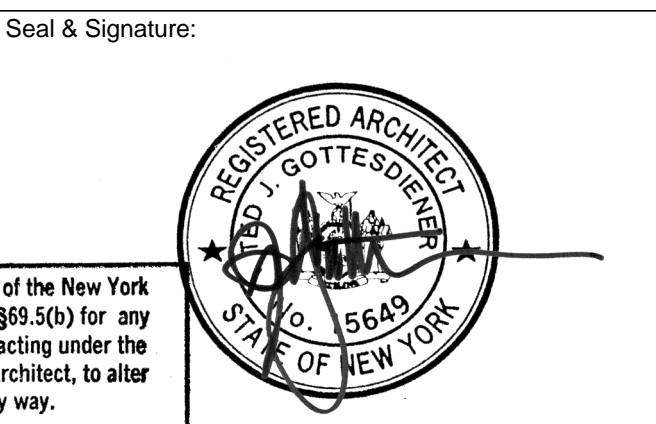
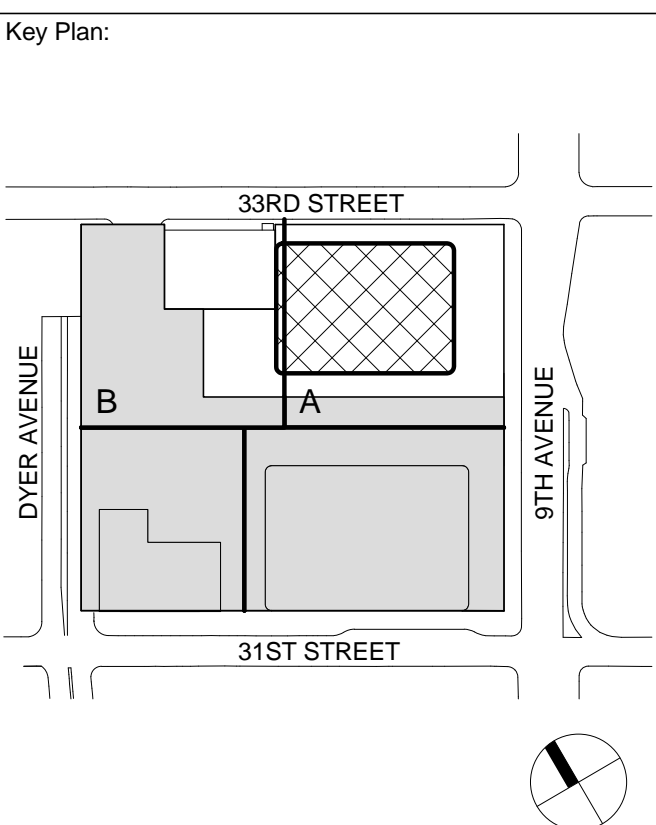
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Wind Tunnel Consultant
Rowan Williams Davies & Irwin Inc.
650 Woodlawn Road West, Guelph, Ontario, Canada N1K 1B6

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**ZONING FLOOR
AREA
DEDUCTIONS -
LEVEL 9-12**


Project No.: 207150
Date: 20 JUN 2014
Scale: 1/16" = 1'-0"
File No.: 2-106

B-SCAN Sheet No.: **Z-106.00**
Sheet No.: **Z-106**
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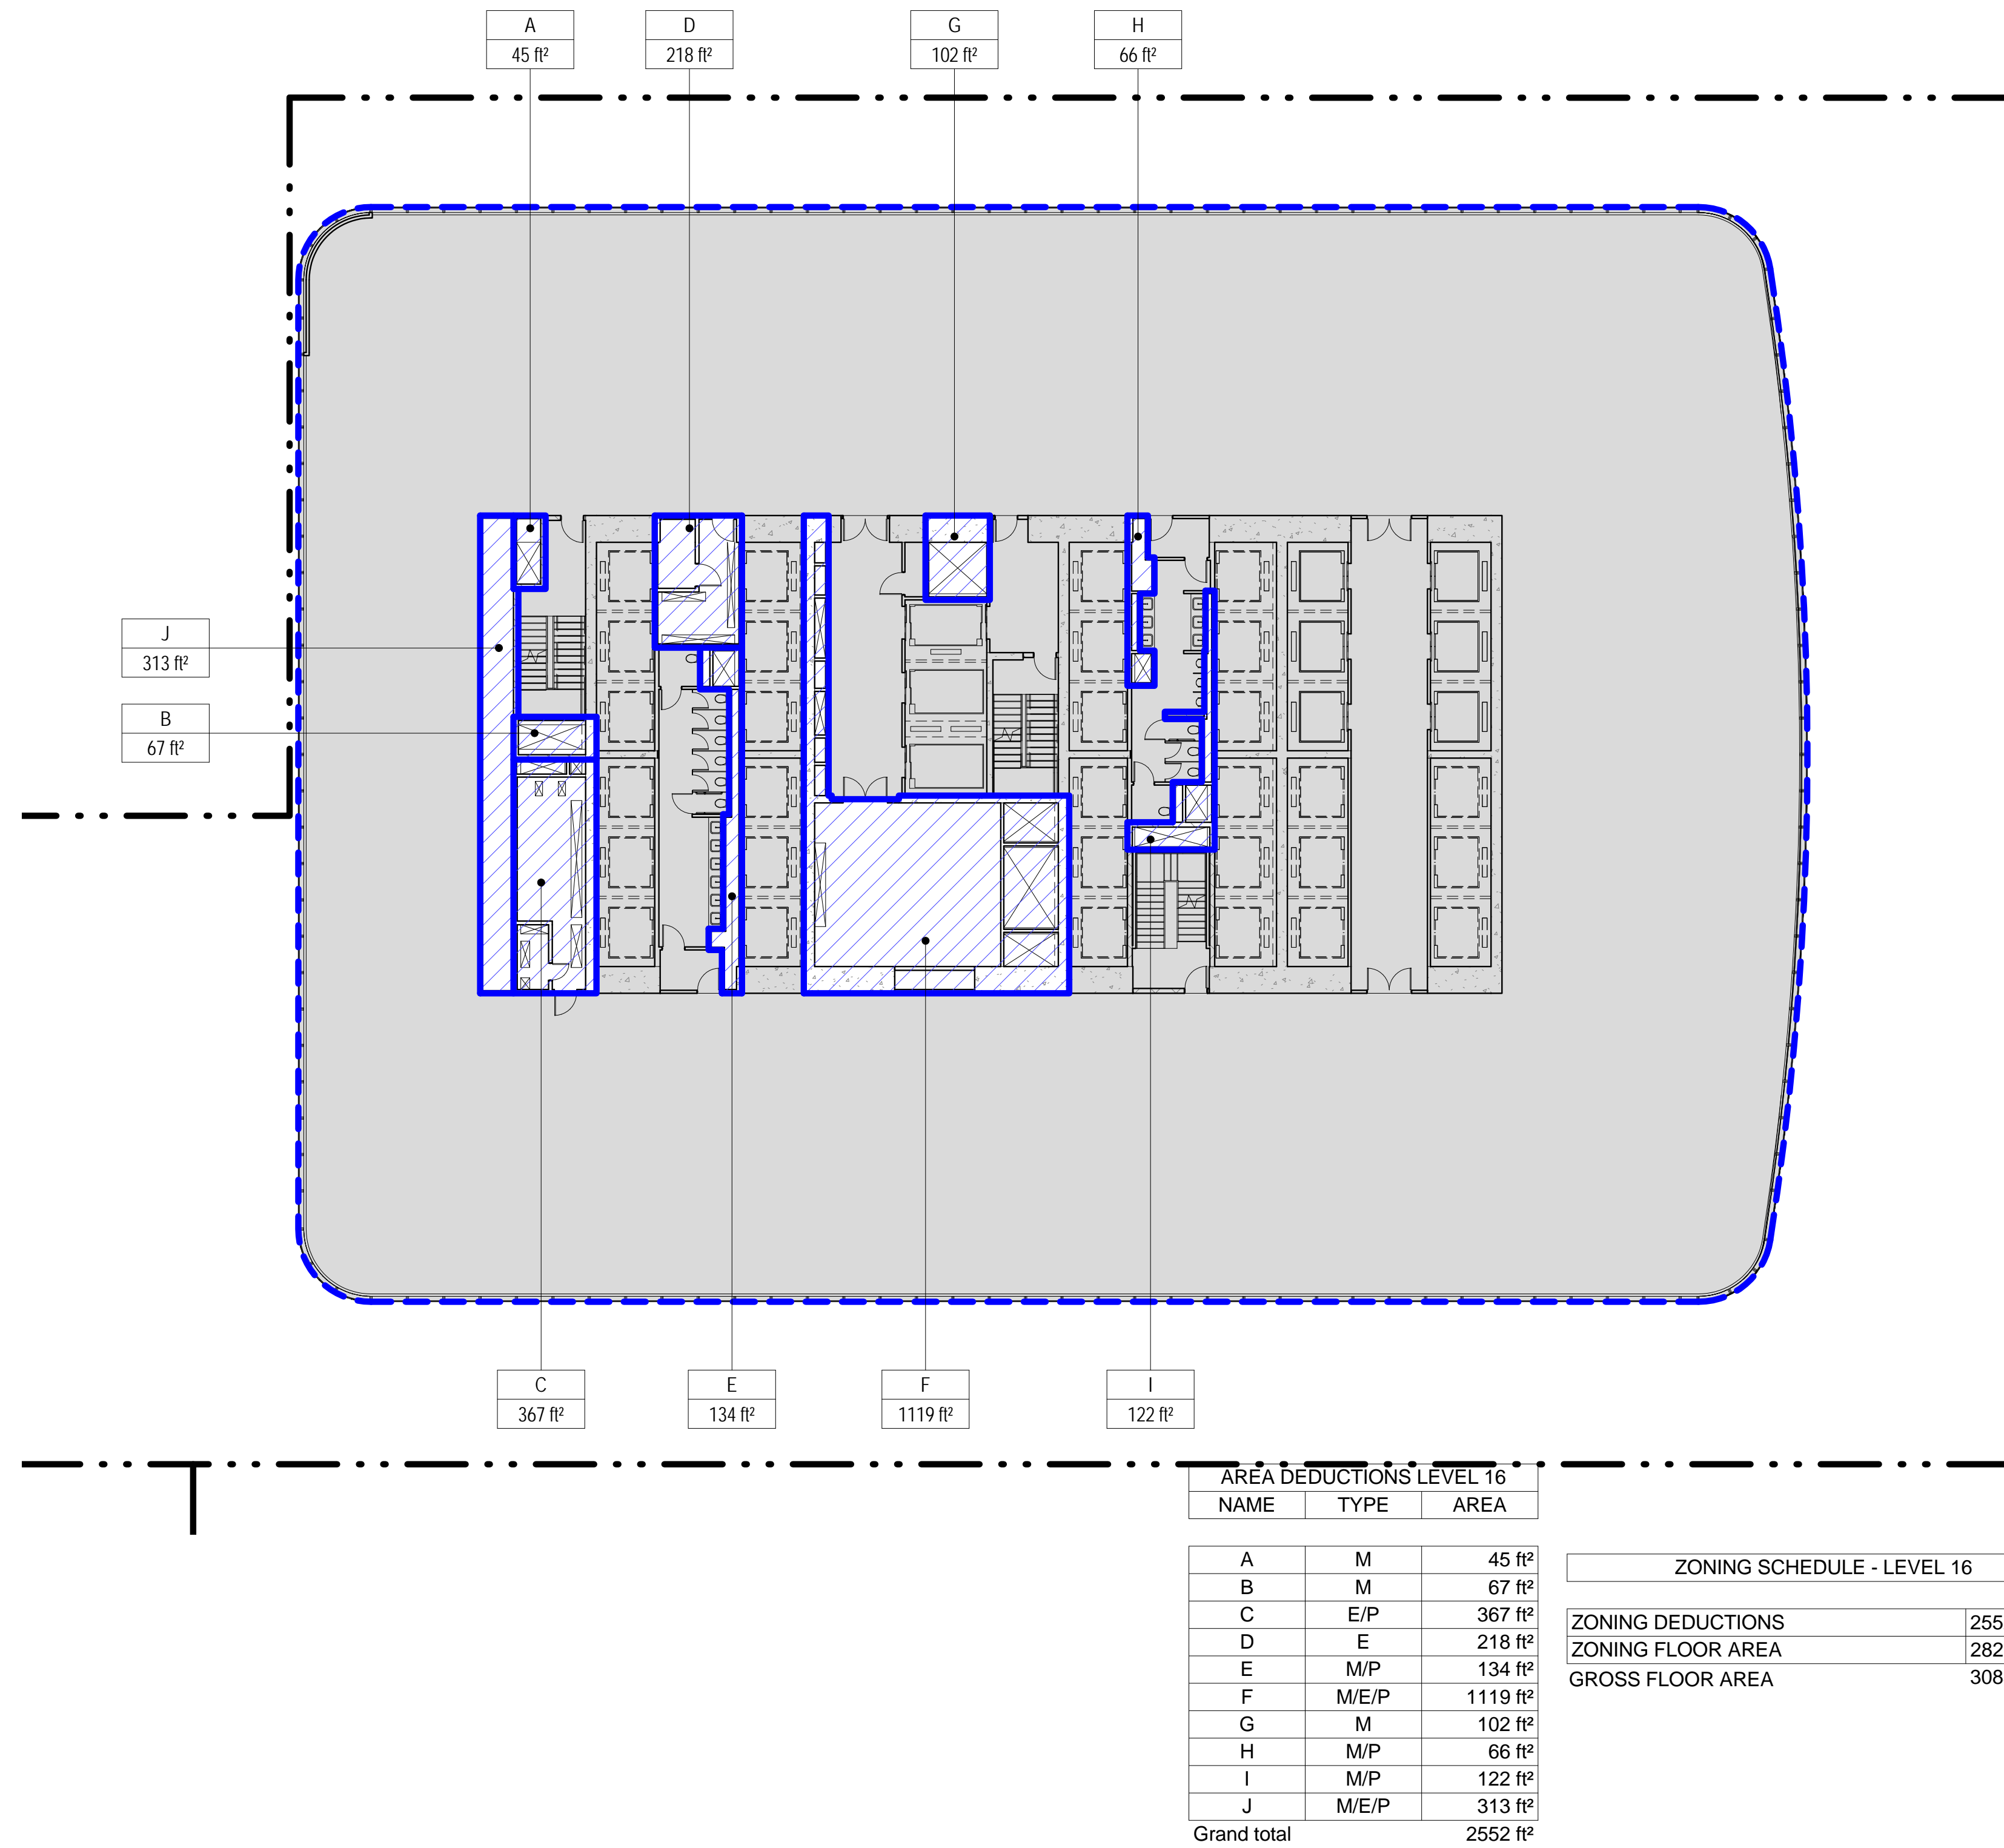
3 LEVEL 15 PLAN

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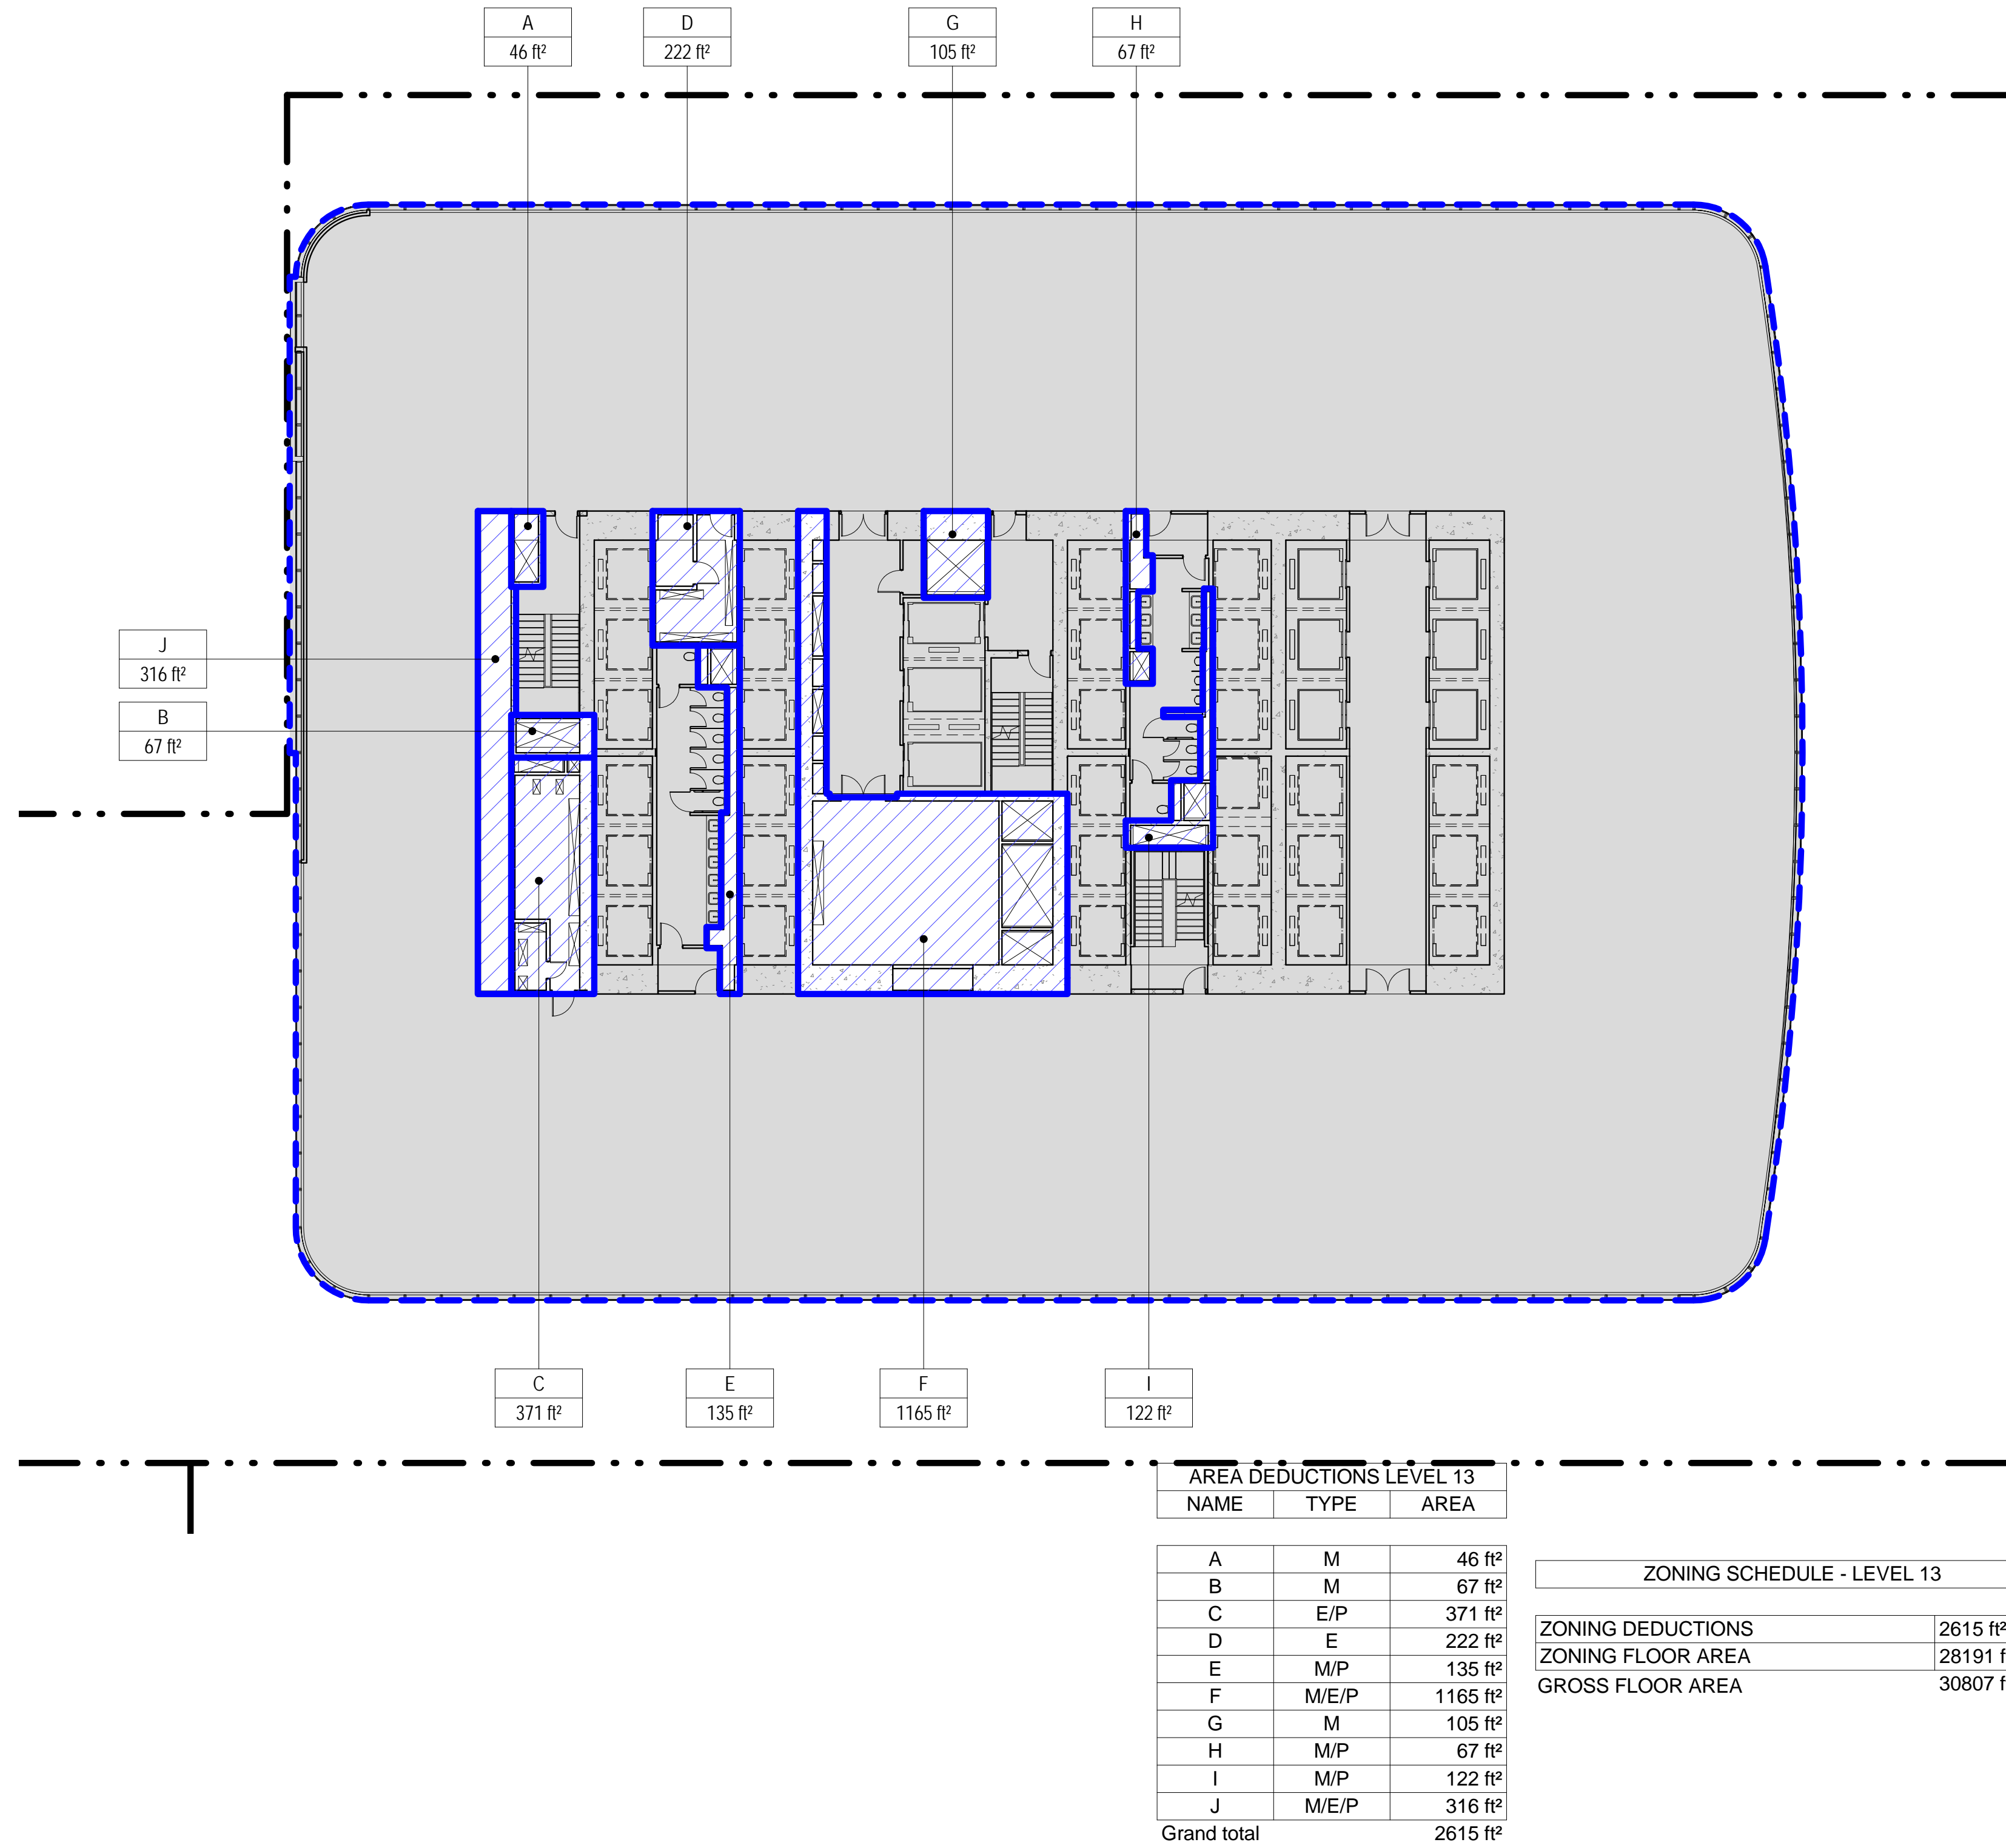
4 LEVEL 16

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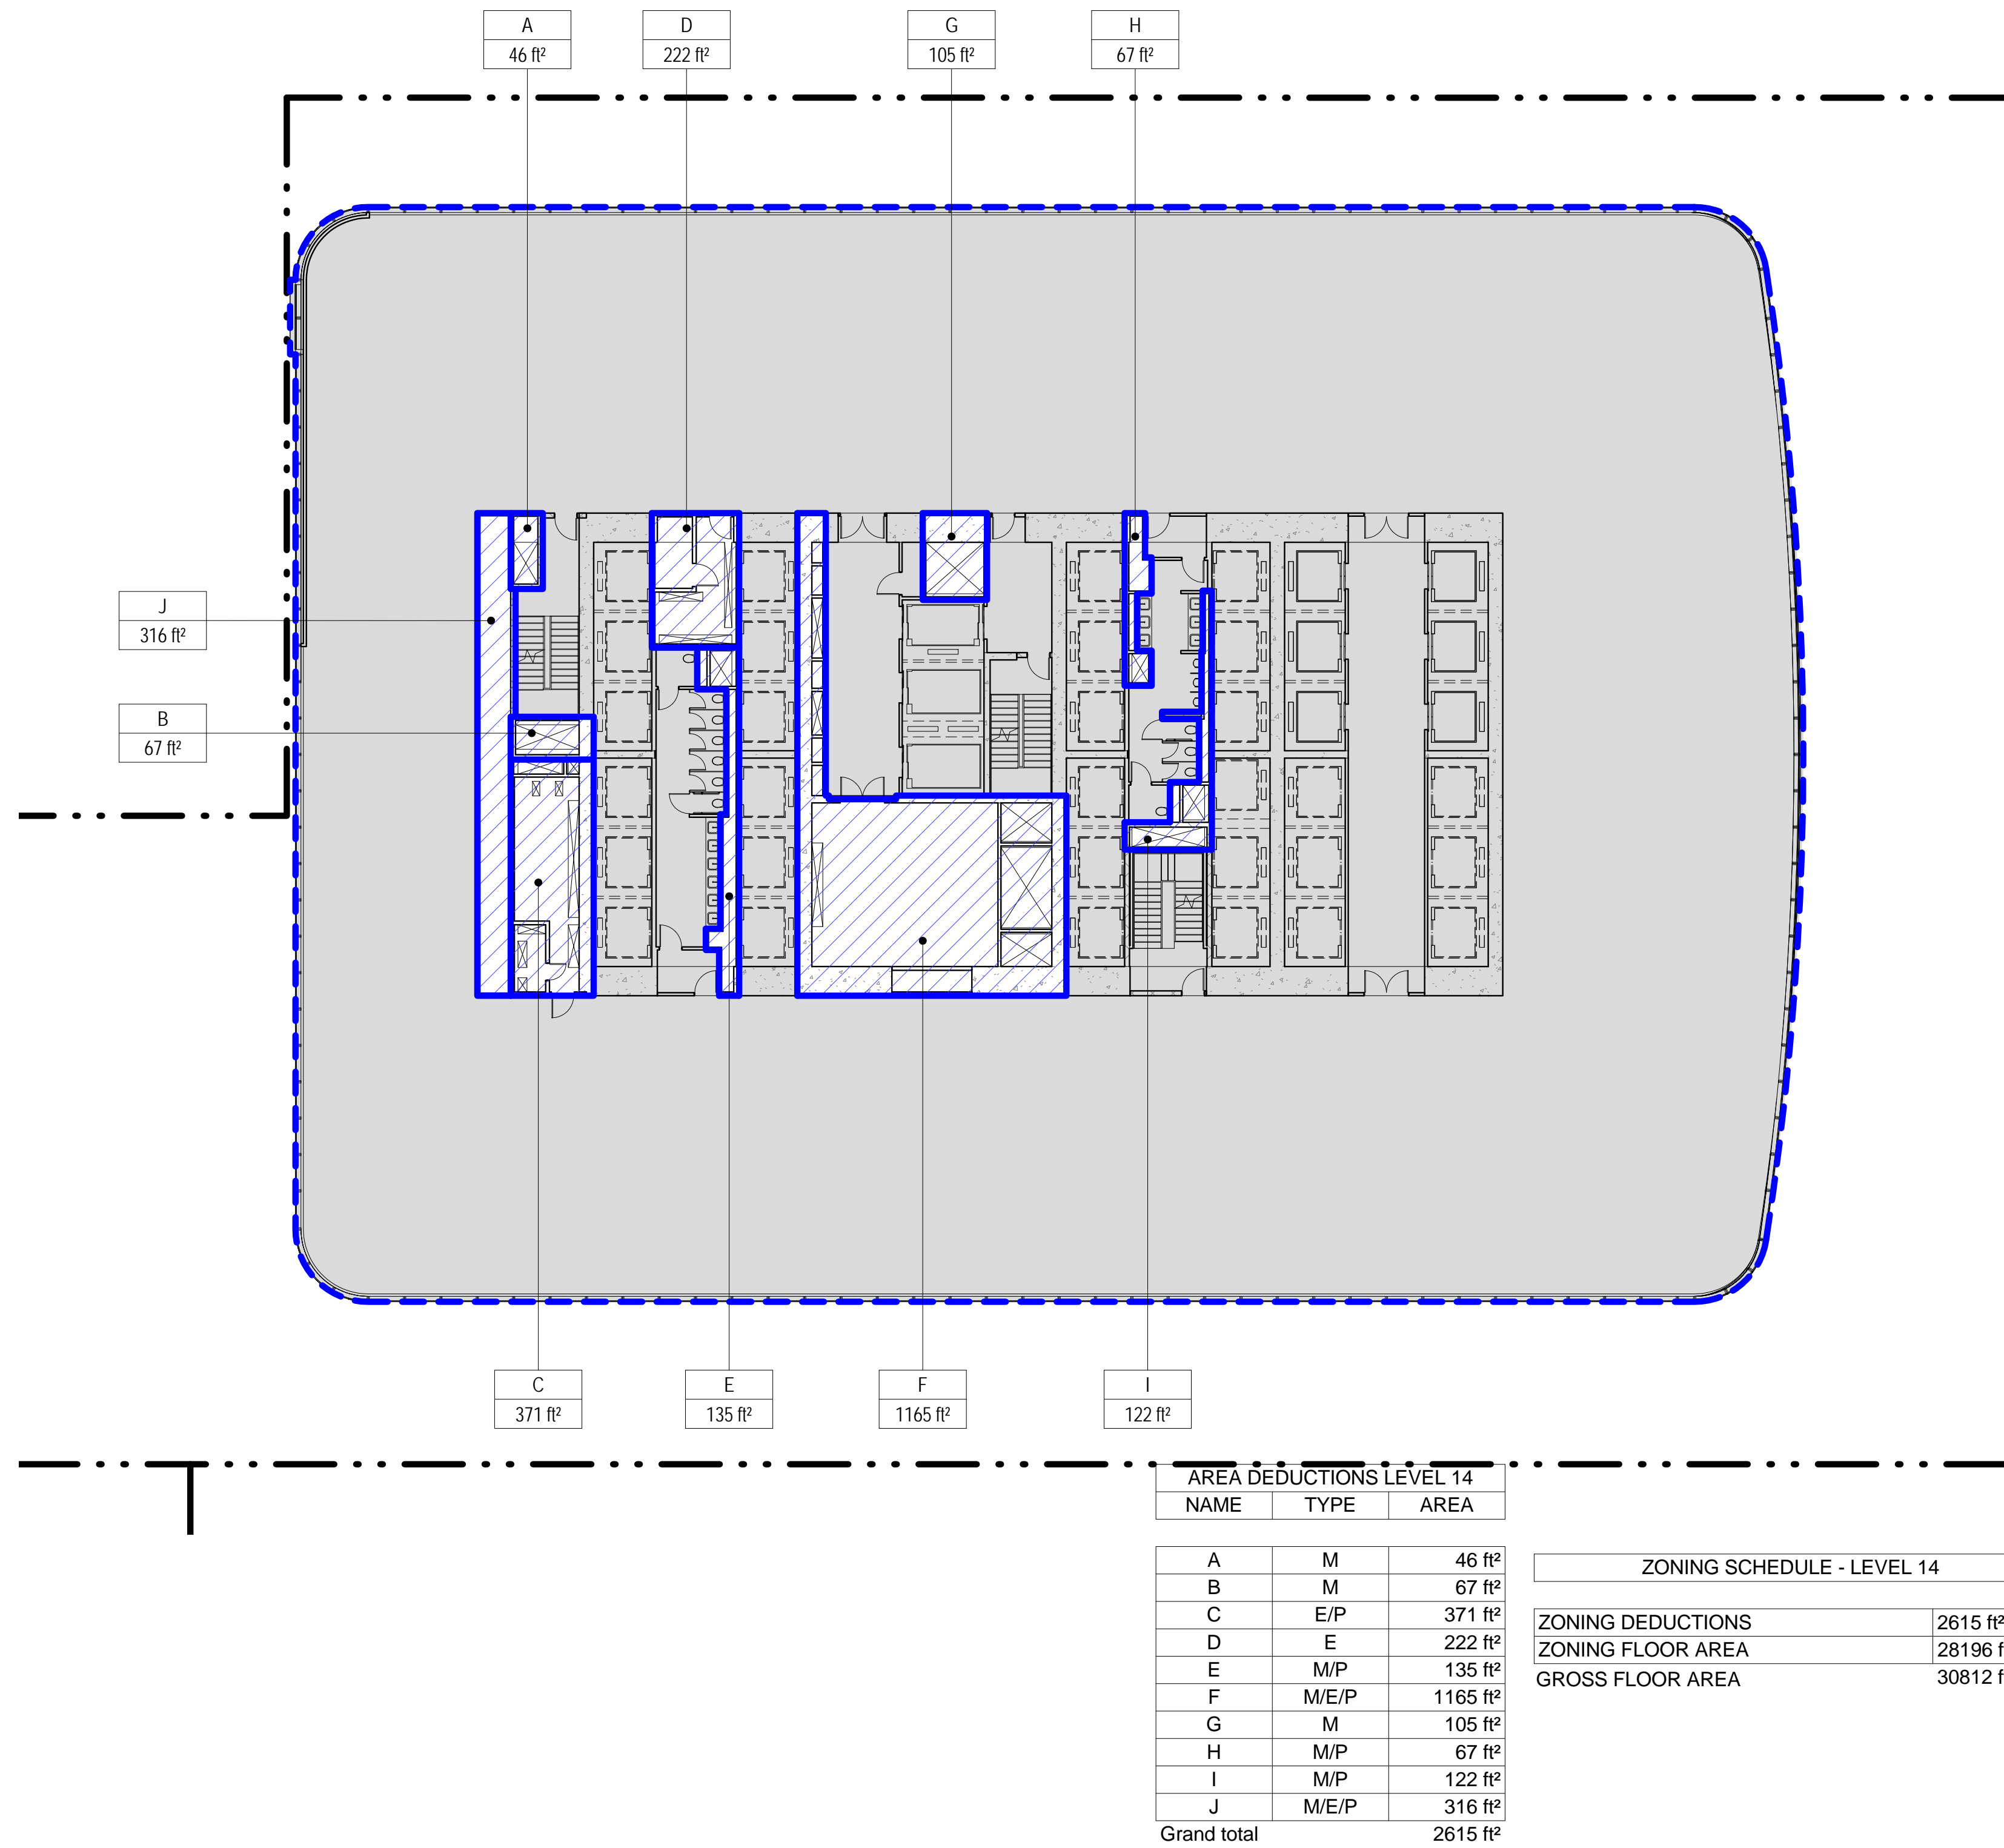
1 LEVEL 13 PLAN

SCALE: 1/16" = 1'-0"

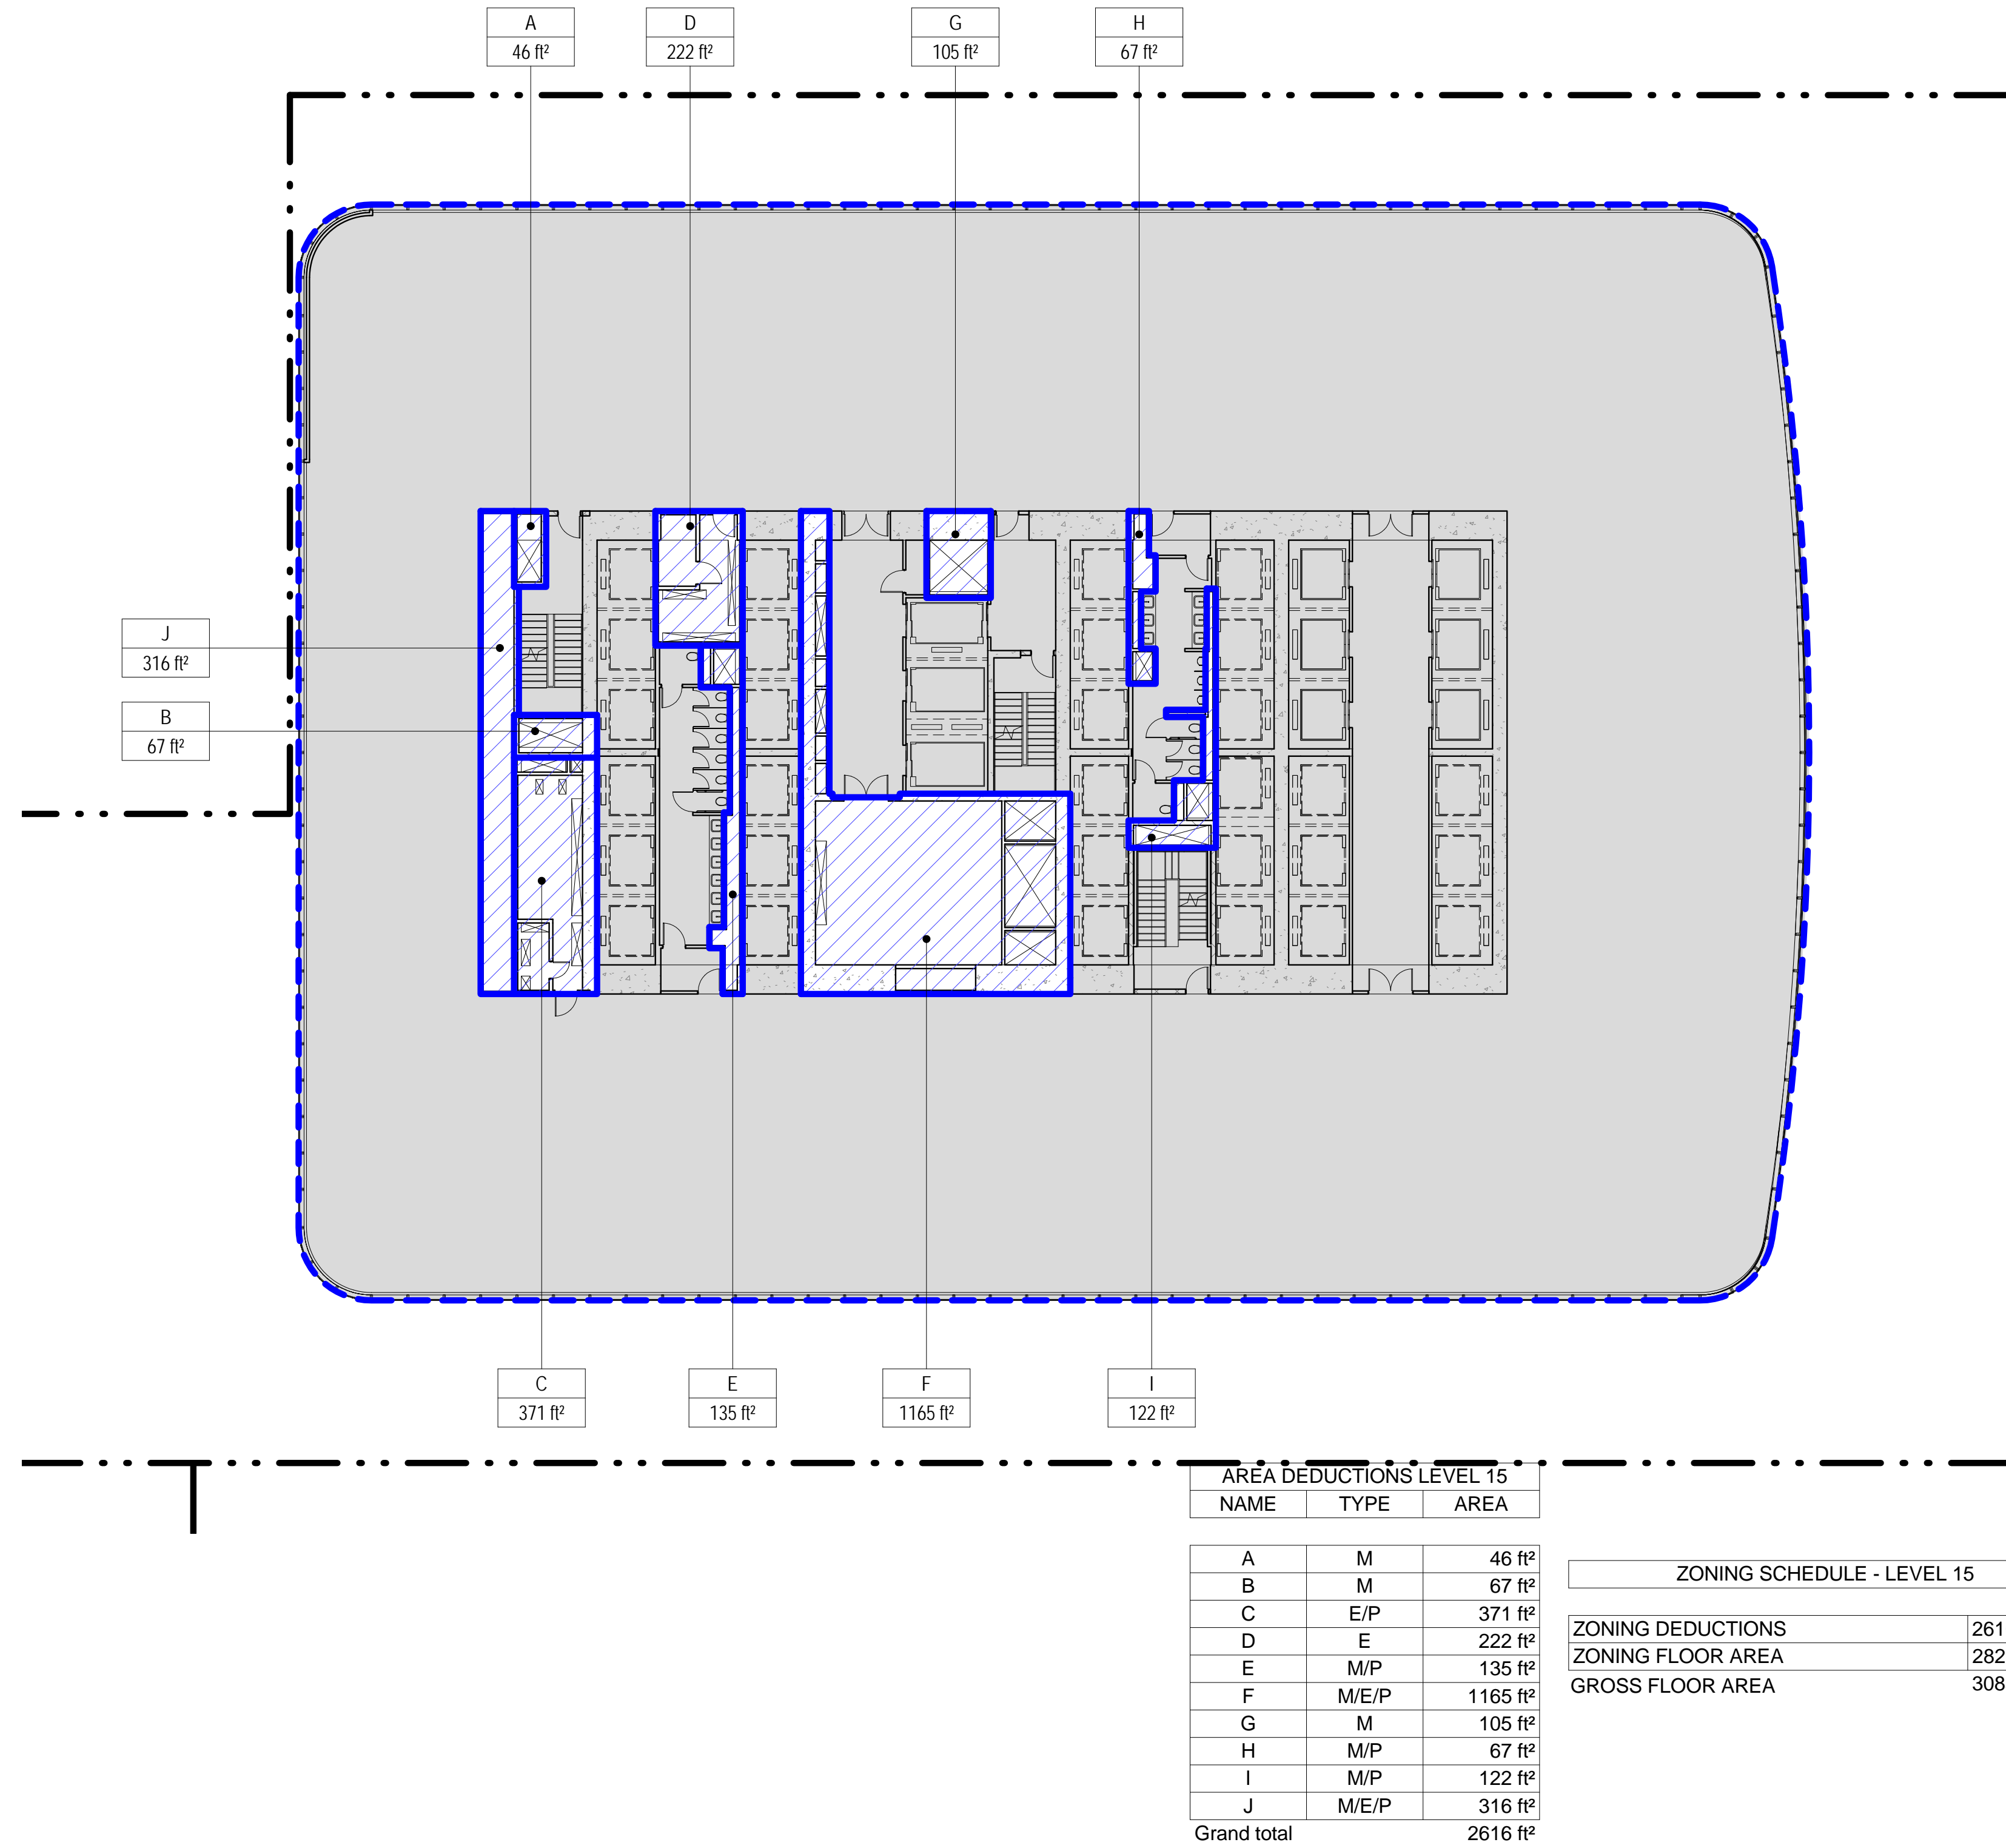

2 LEVEL 14 PLAN

SCALE: 1/16" = 1'-0"



ZONING LEGENDS

- GROSS BUILDING AREA
- ZONING AREA DEDUCTIONS
- ZONING FLOOR AREA
- RETAIL
- MR MECHANICAL ROOM
- M MECHANICAL
- E ELECTRICAL/TEL./IT
- P PLUMBING
- EM ELEVATOR MACHINE ROOM



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Code Consultants Professional Engineers PC
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Facade Maintenance Consultant


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ZONING FLOOR AREA DEDUCTIONS - LEVEL 13-16

Project No.:

207150

Date:

20 JUN 2014
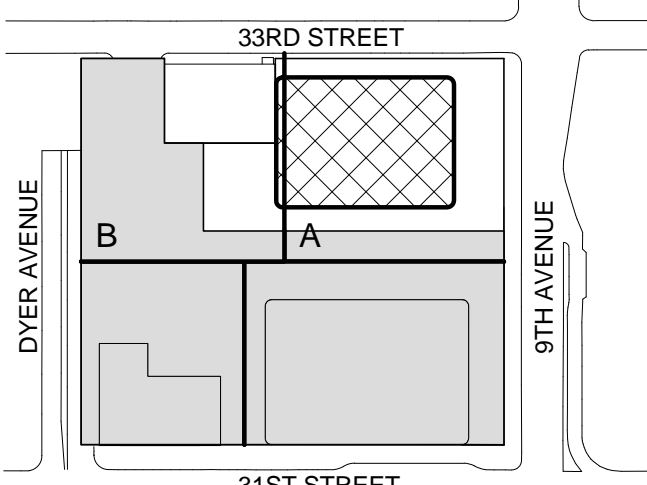
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1/16" = 1'-0"

File No.:

Z-107

B-SCAN Sheet No.:

Z-107.00


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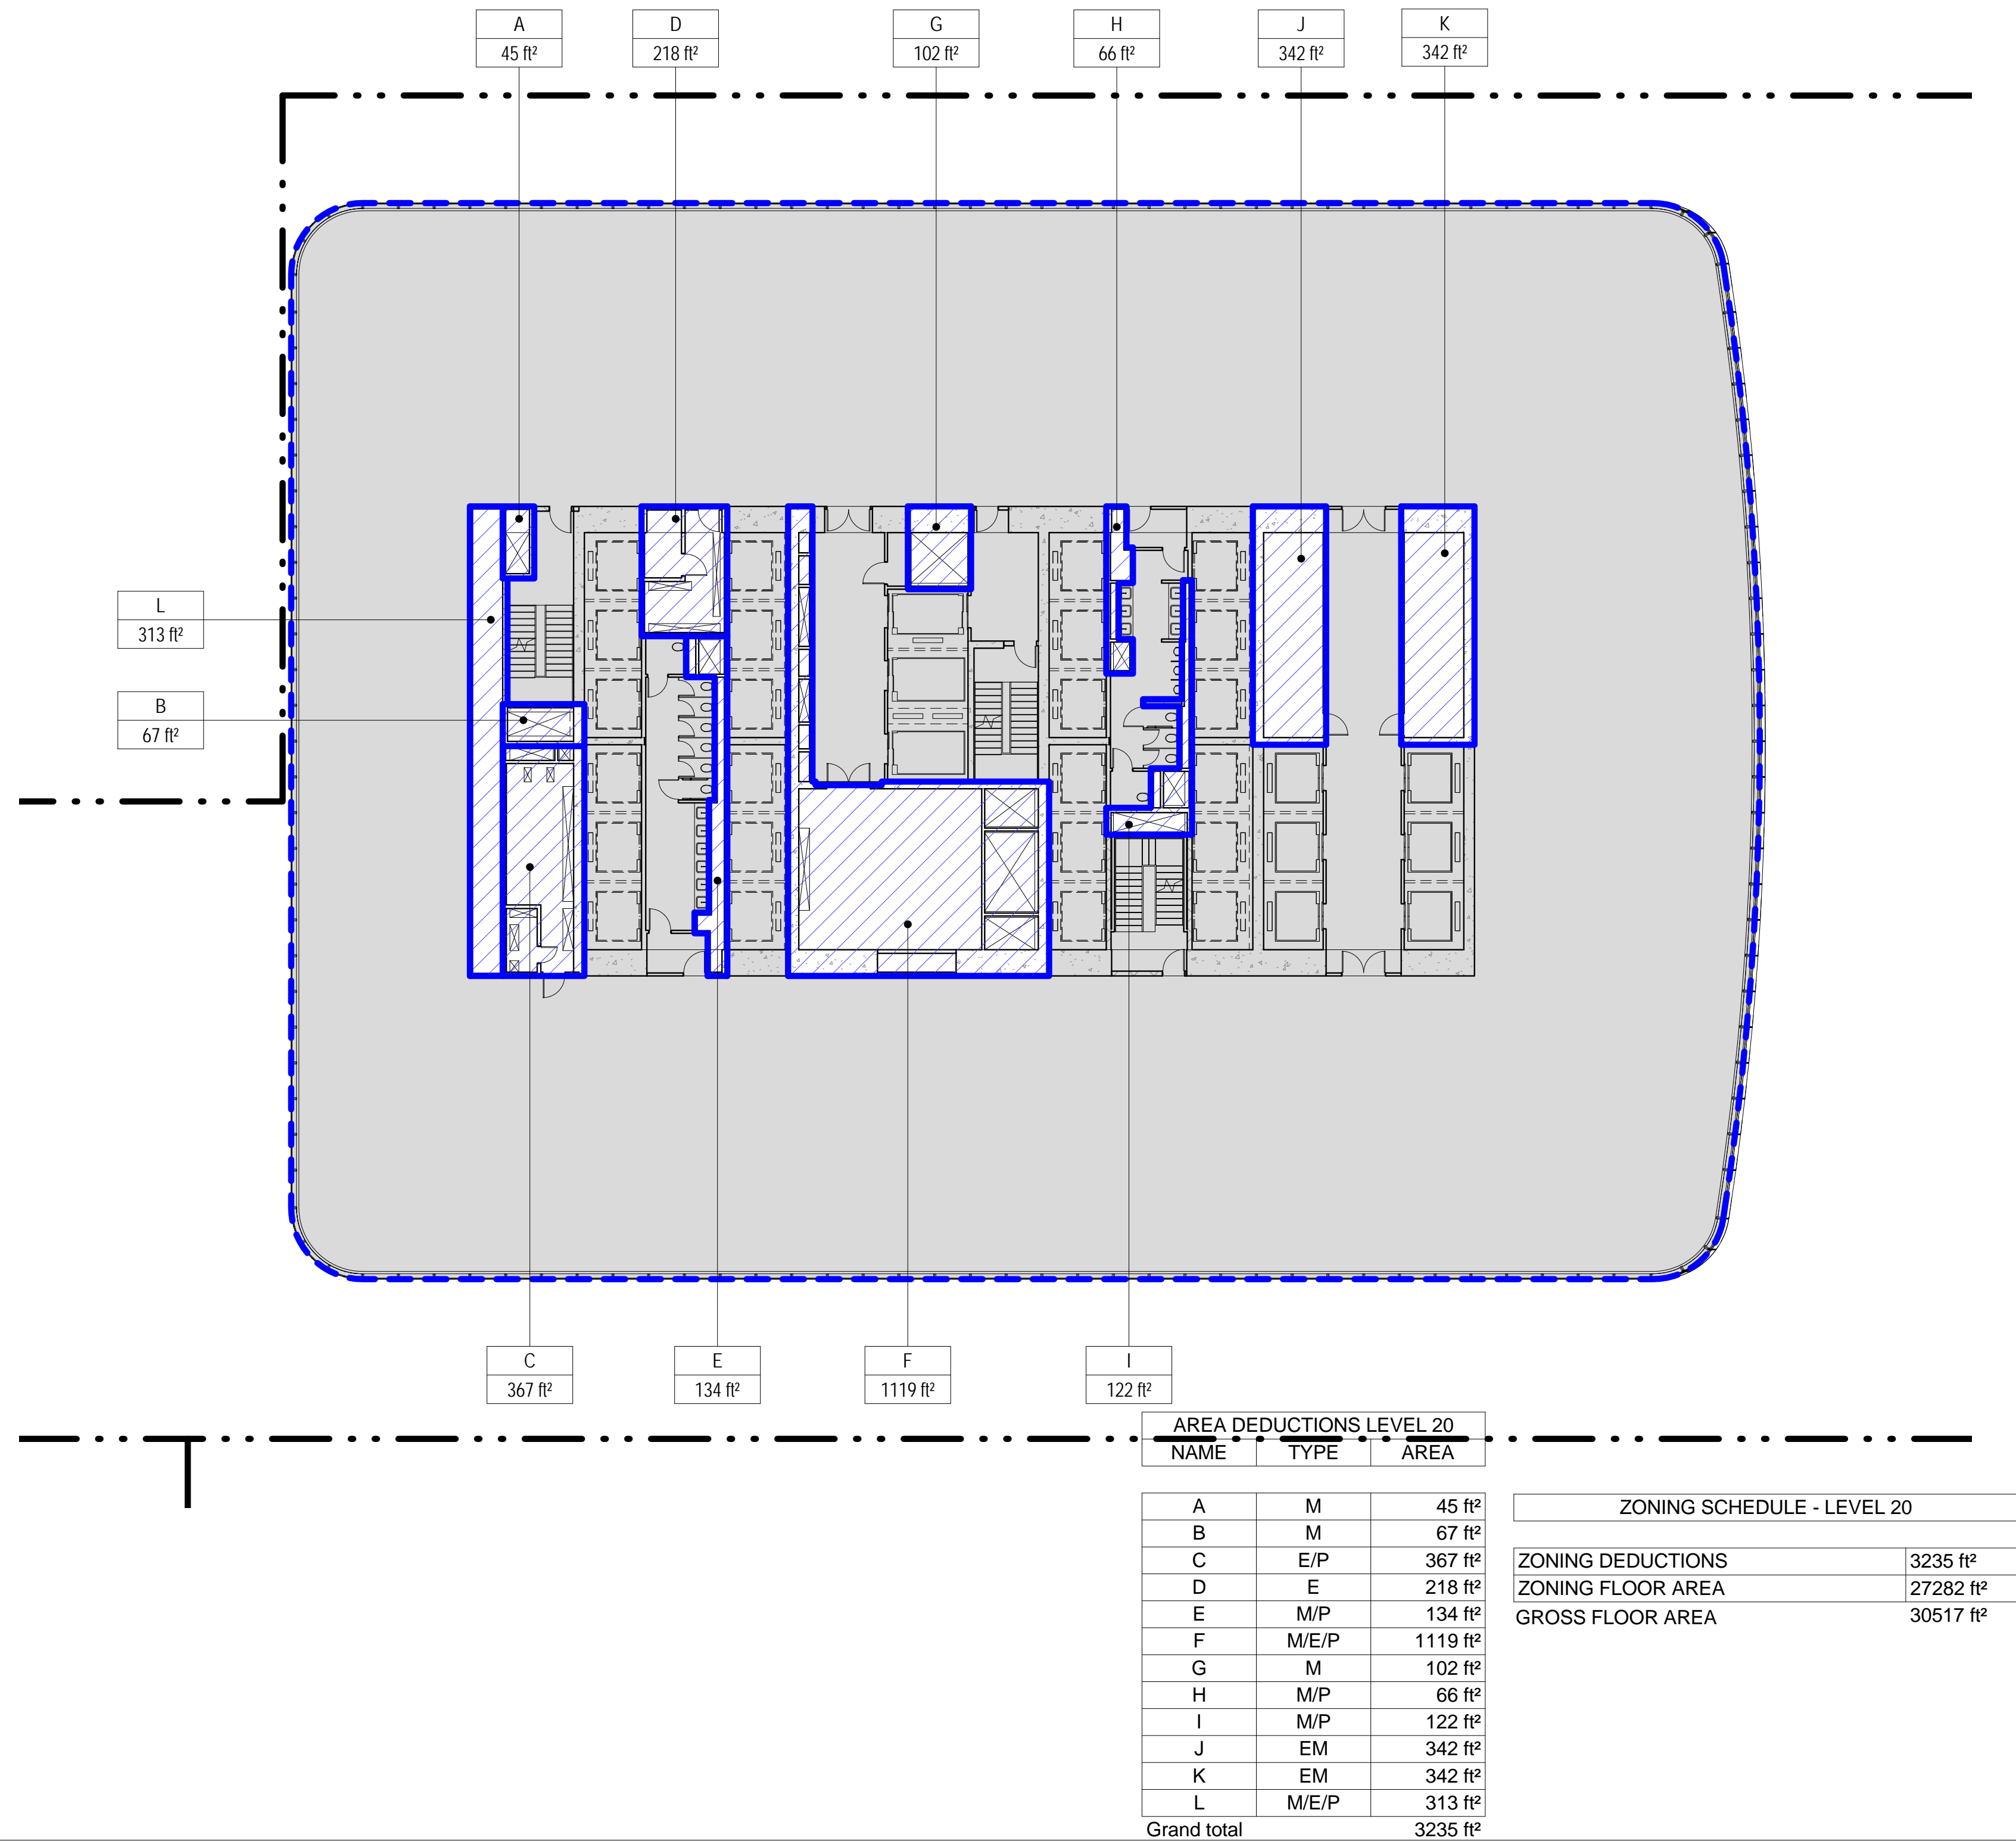
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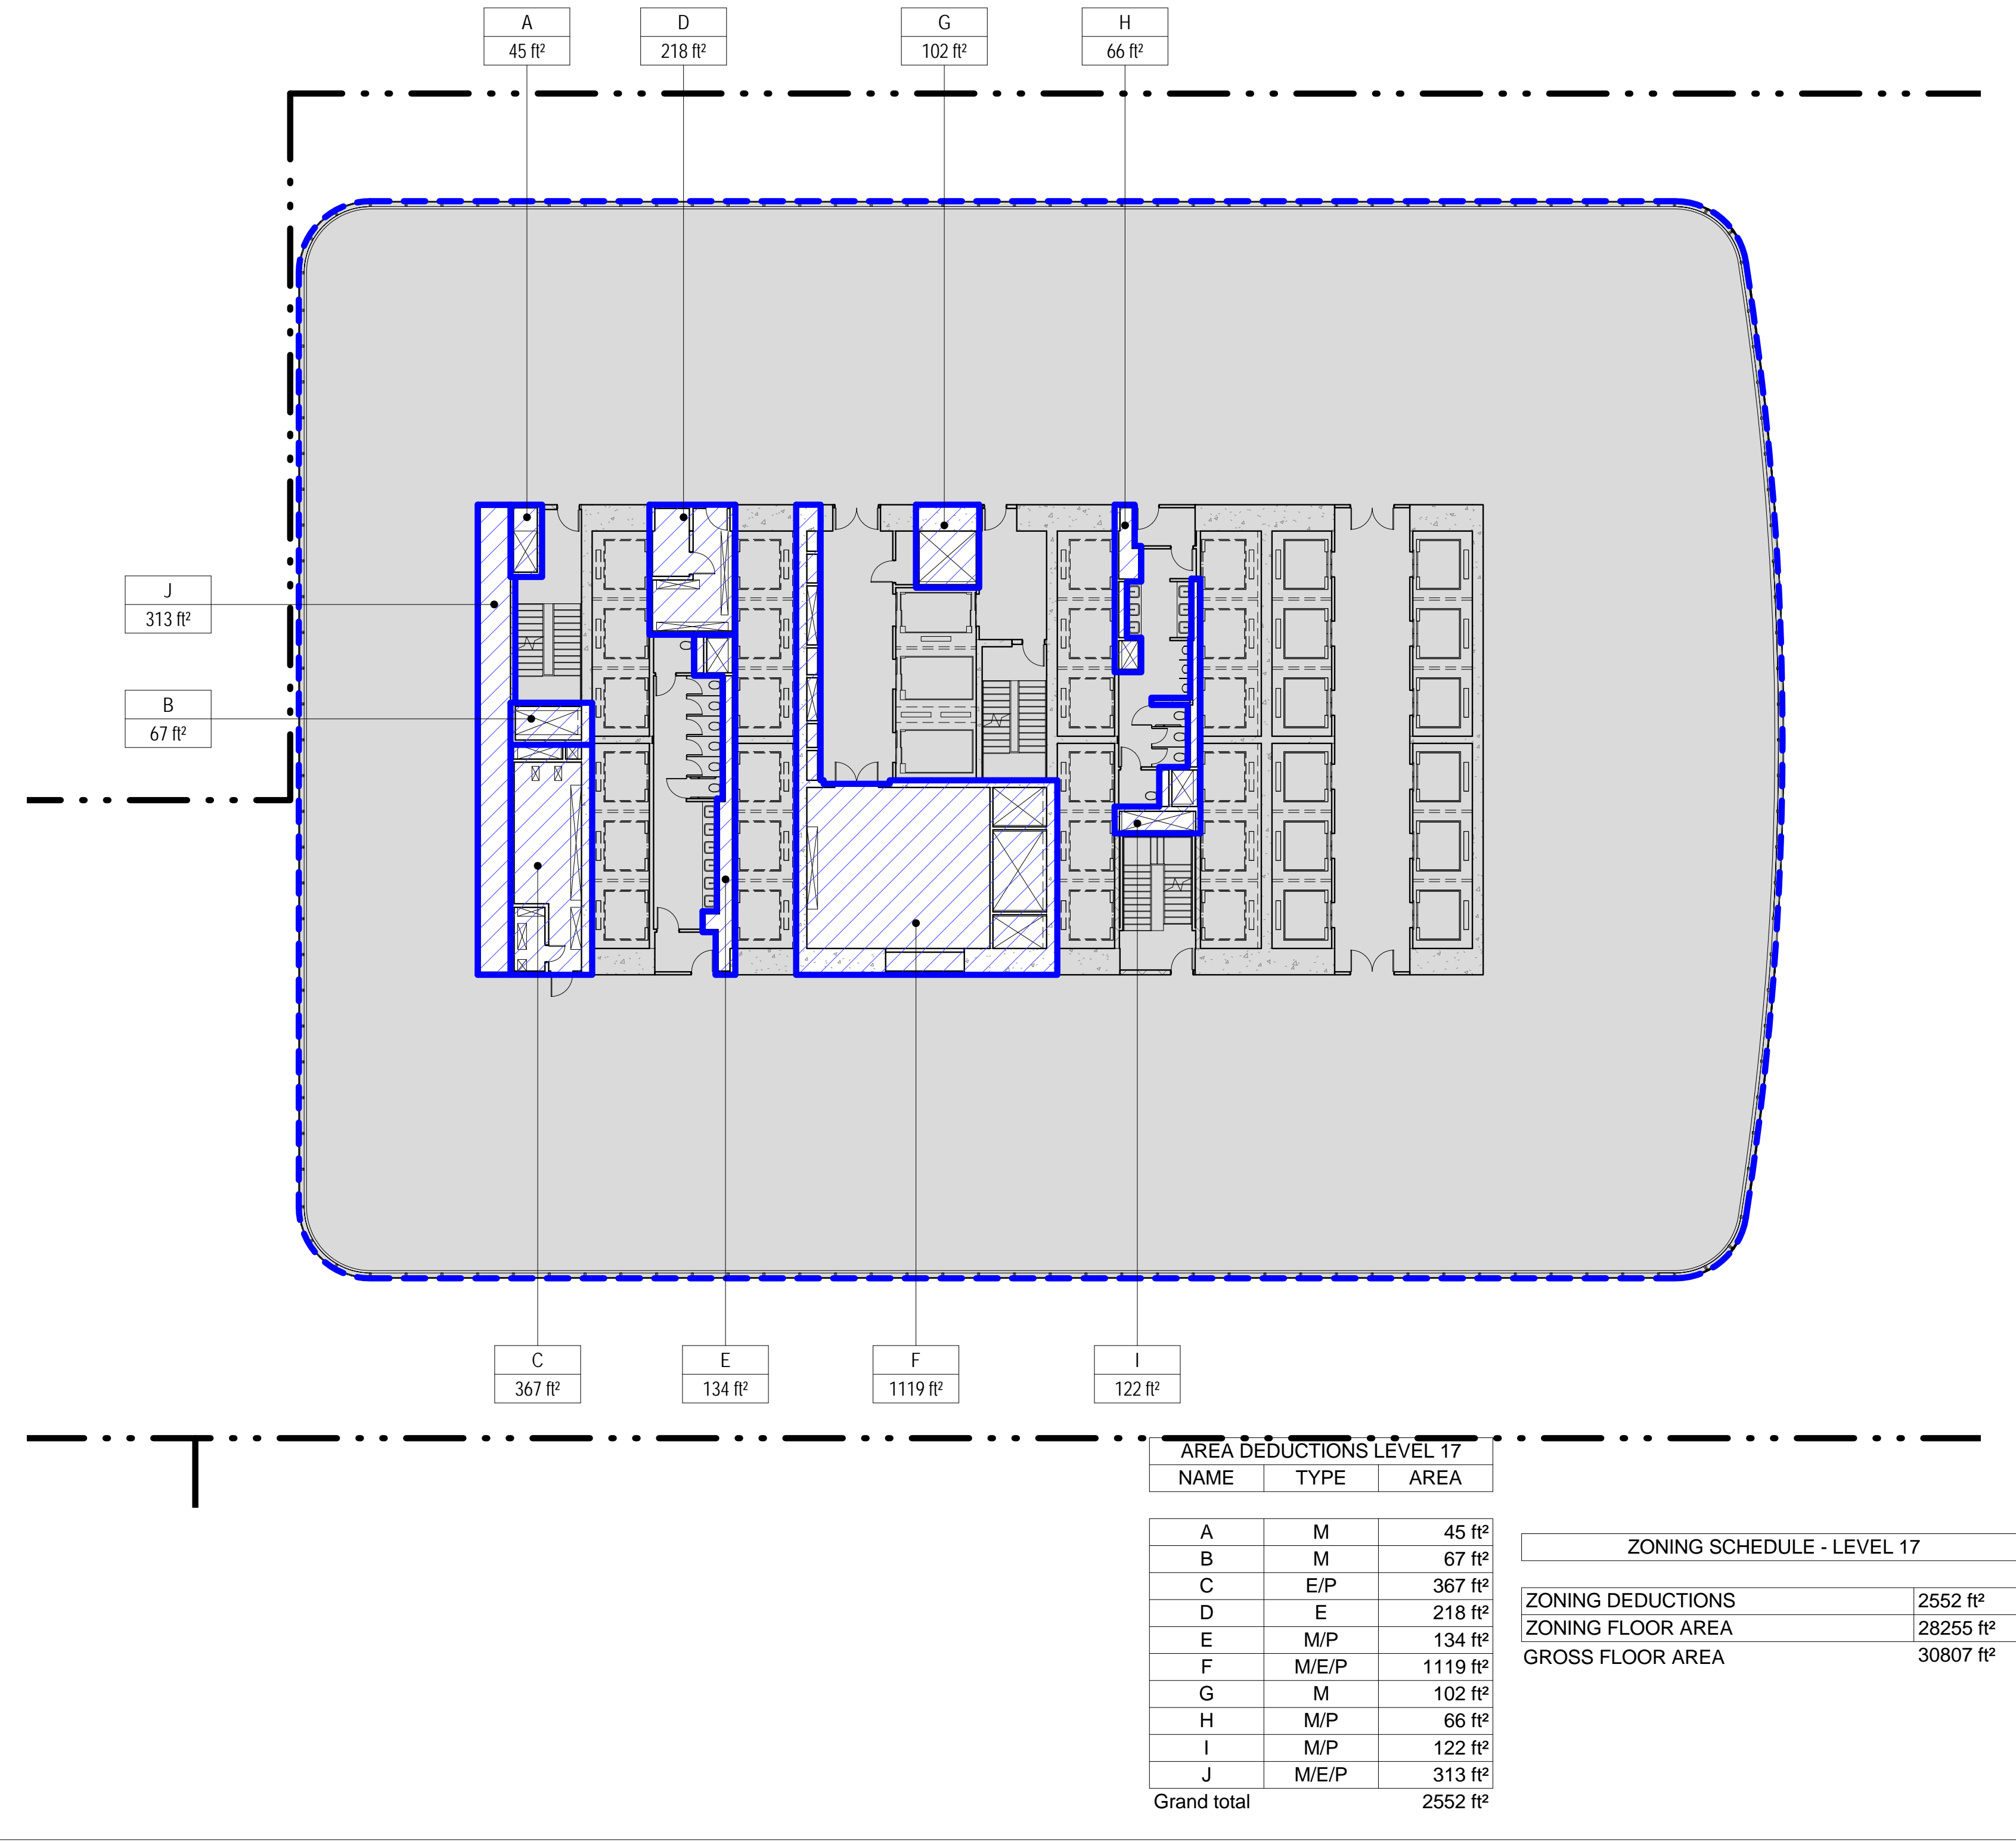
3 LEVEL 19 PLAN
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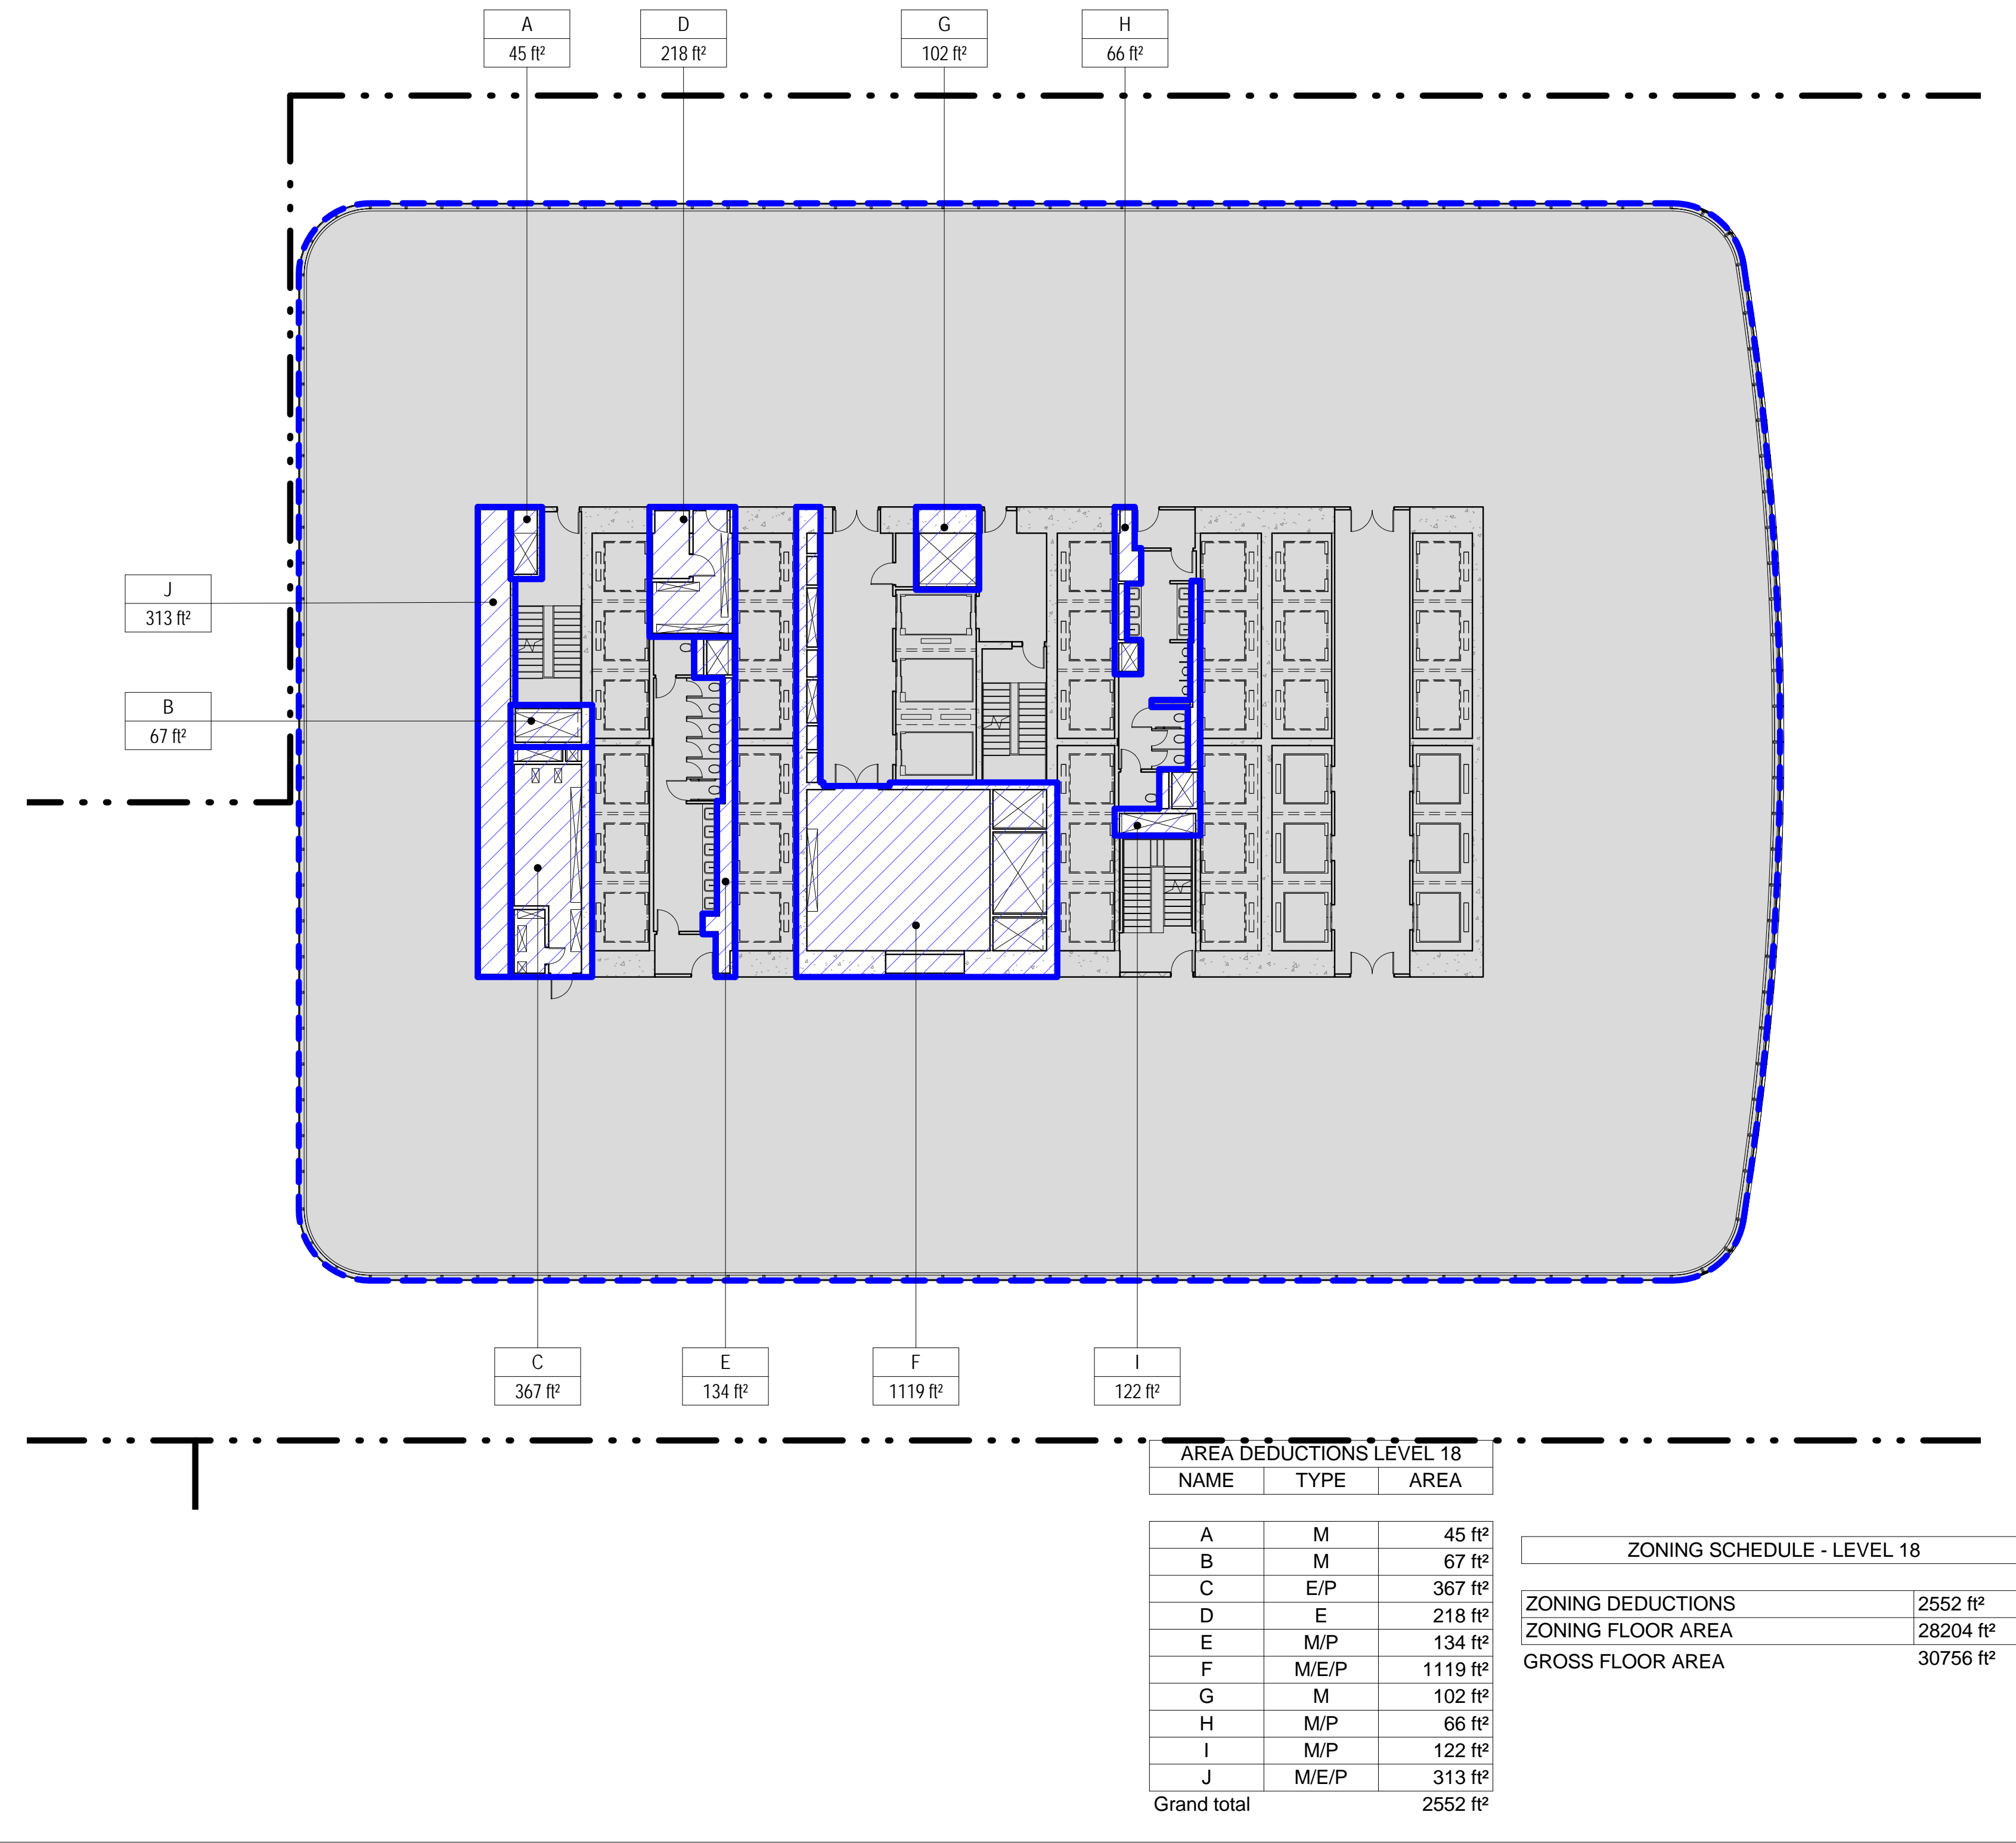
4 LEVEL 20 PLAN
SCALE: 1/16" = 1'-0"



1 LEVEL 17 PLAN
SCALE: 1/16" = 1'-0"



2 LEVEL 18 PLAN
SCALE: 1/16" = 1'-0"

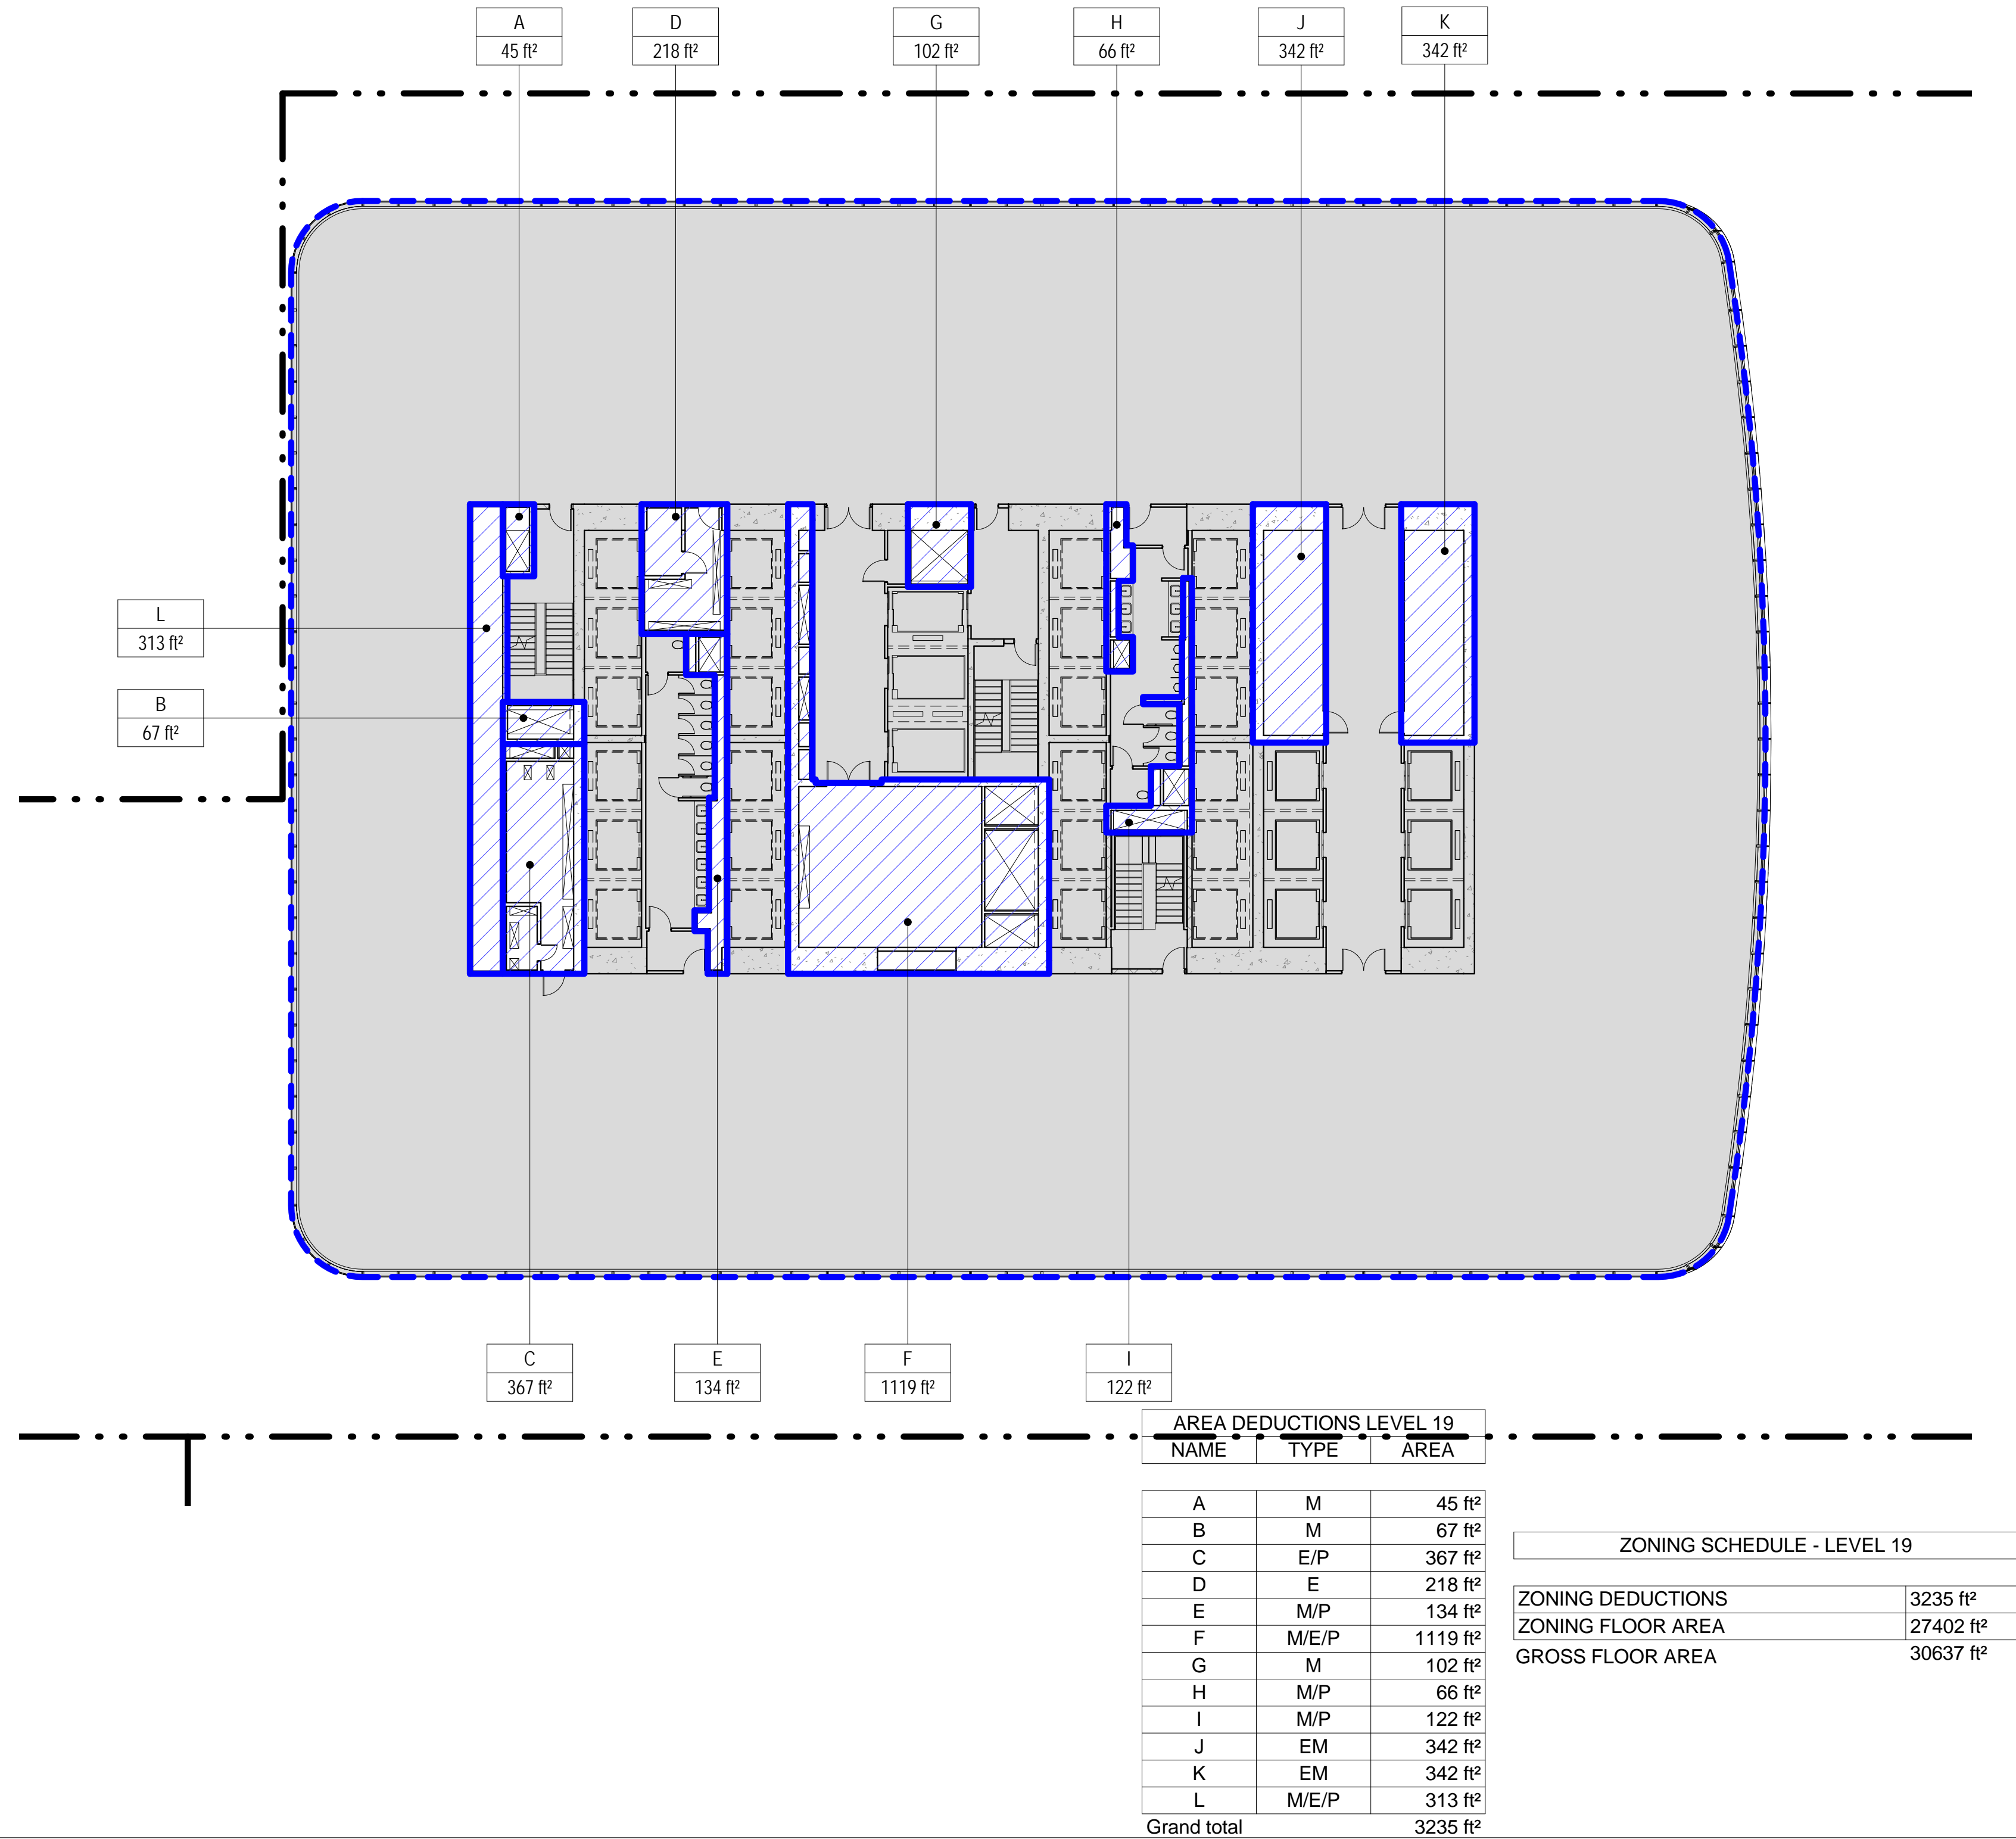

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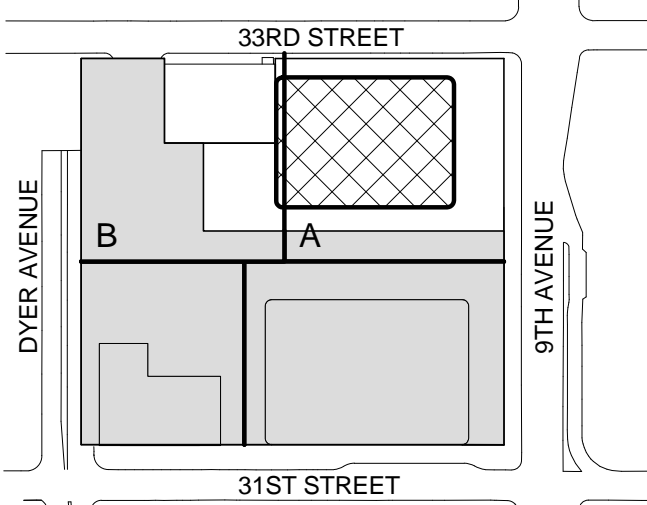
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Code Consultants Professional Engineers PC
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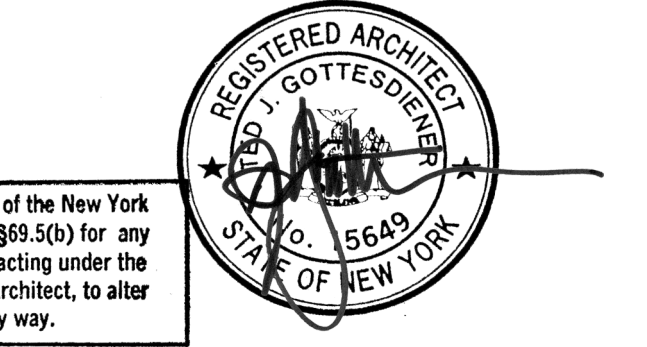
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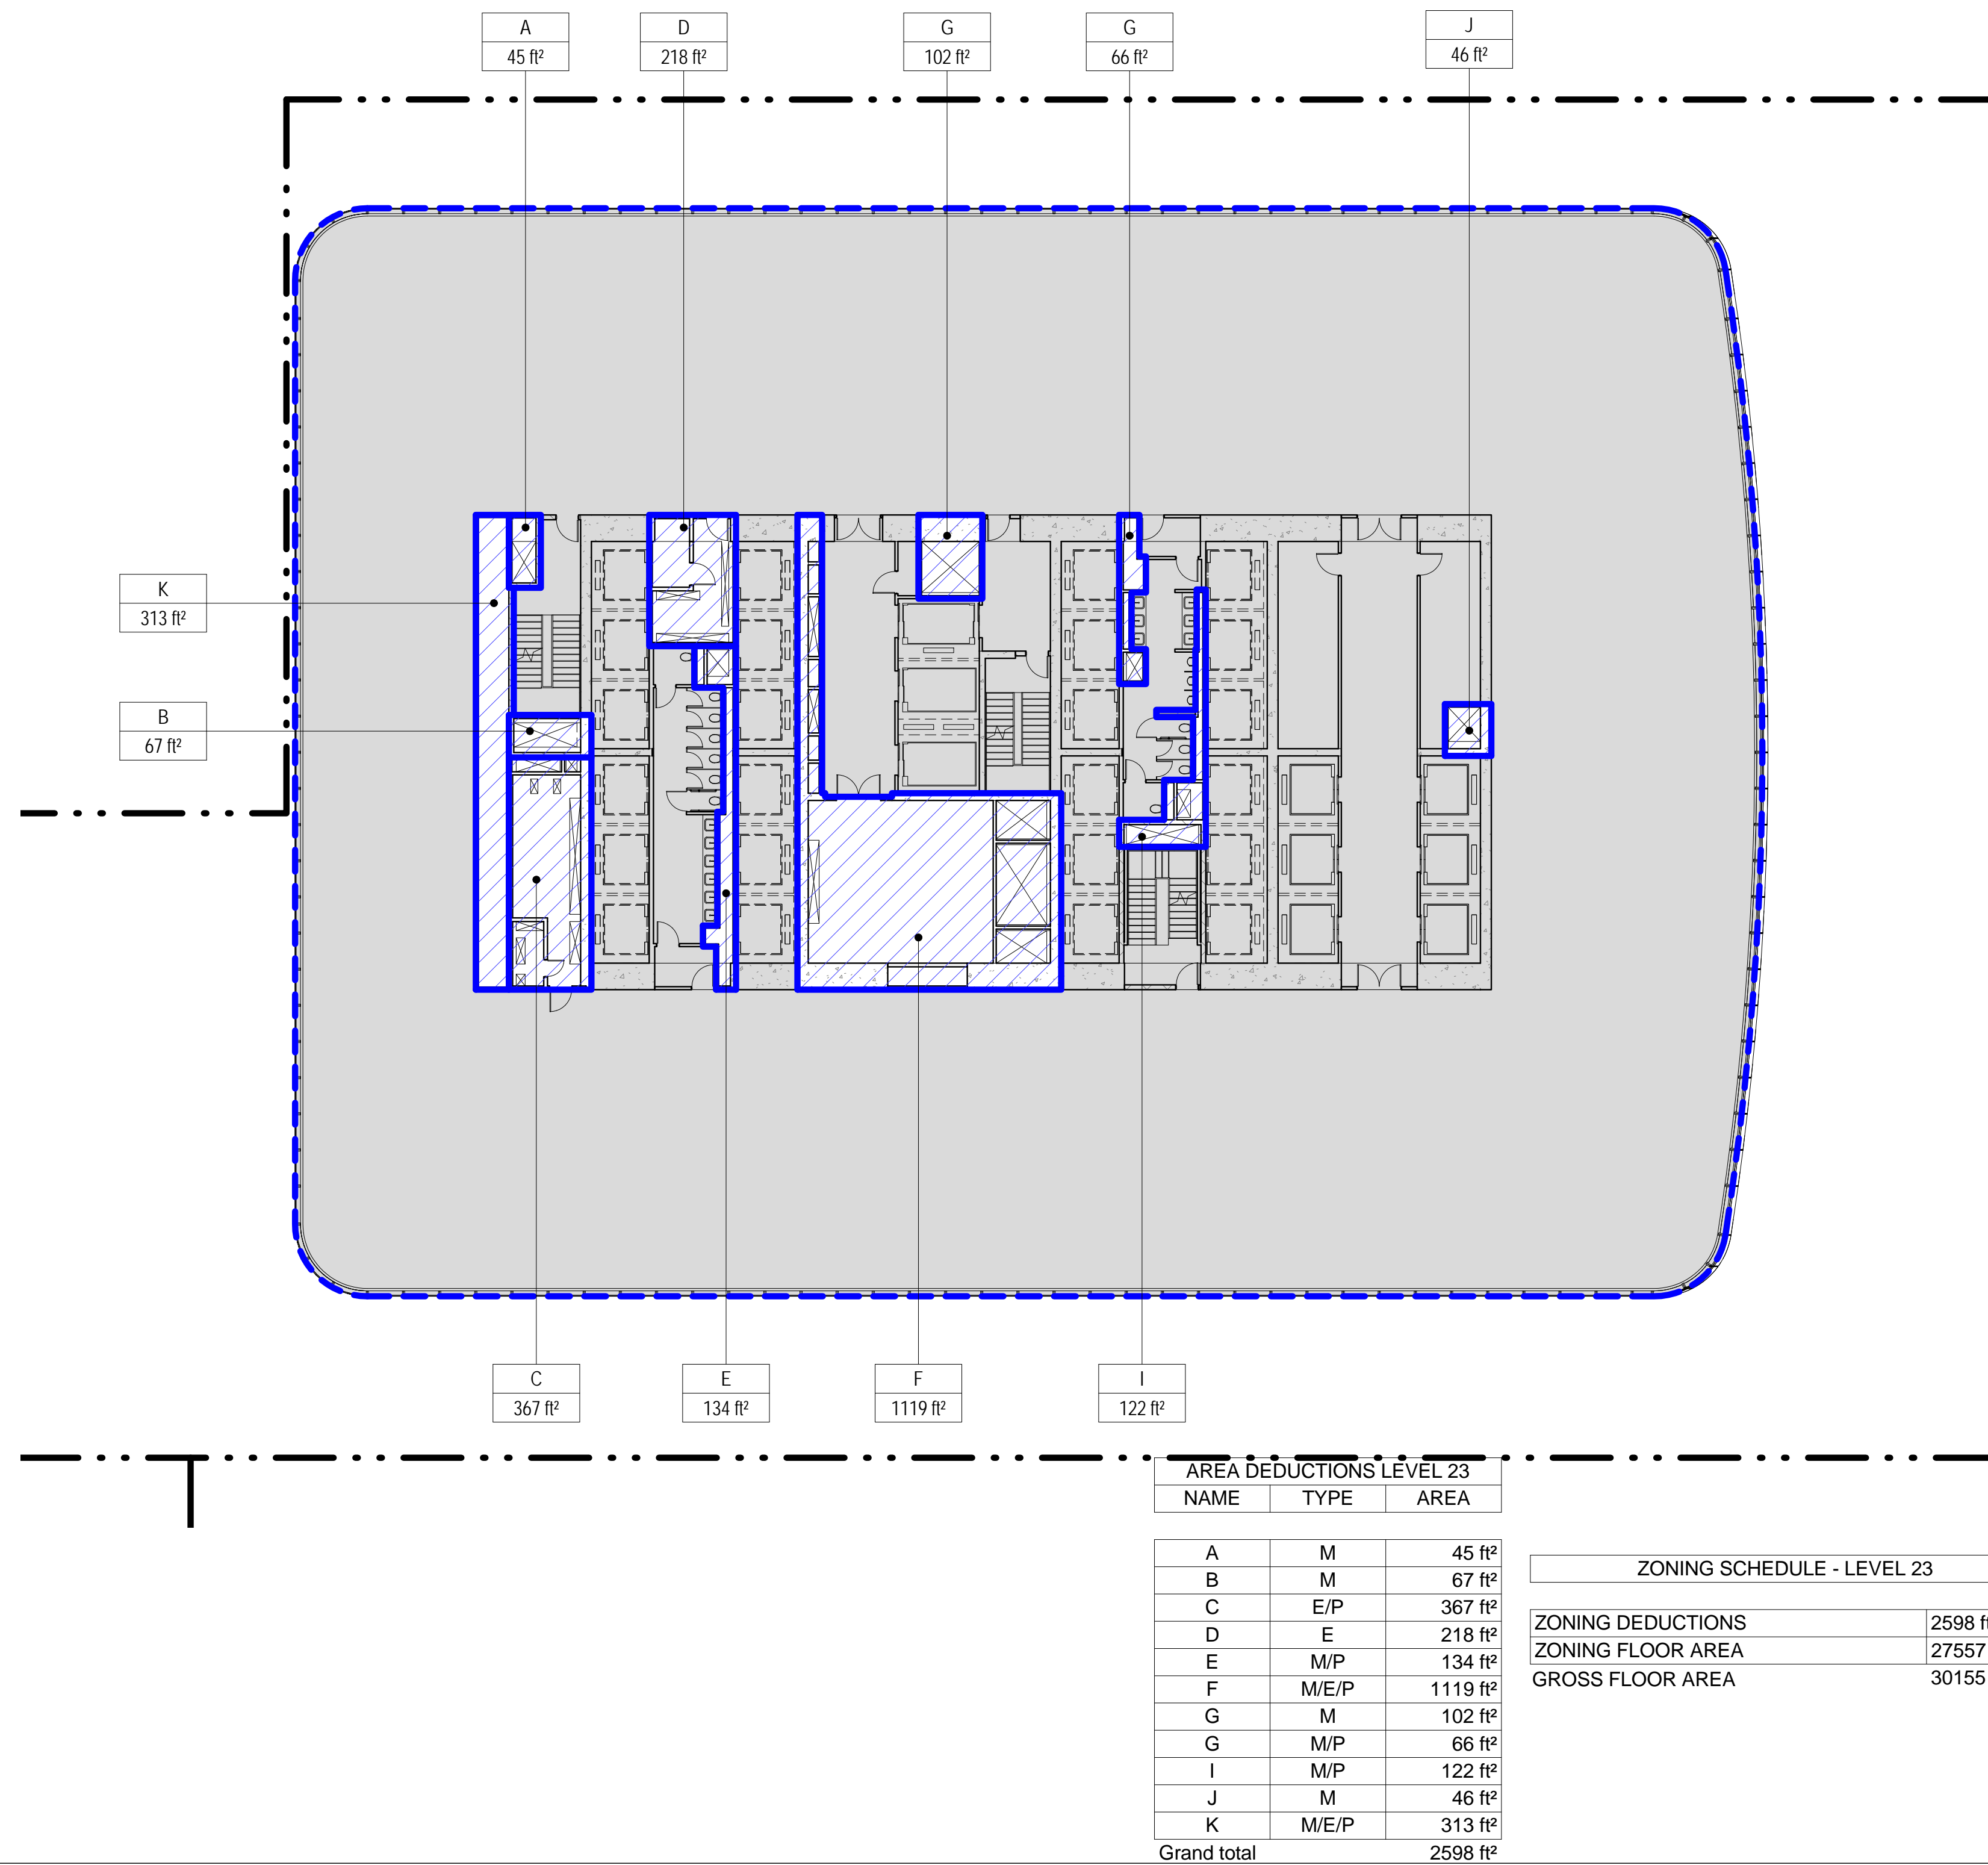
**ZONING FLOOR
AREA
DEDUCTIONS -
LEVEL 17-20**

Project No.: 207150
Date: 20 JUN 2014
Scale: 1/16" = 1'-0"
File No.: 2-108

B-SCAN Sheet No.: **Z-108.00**
Sheet No.: **Z-108**
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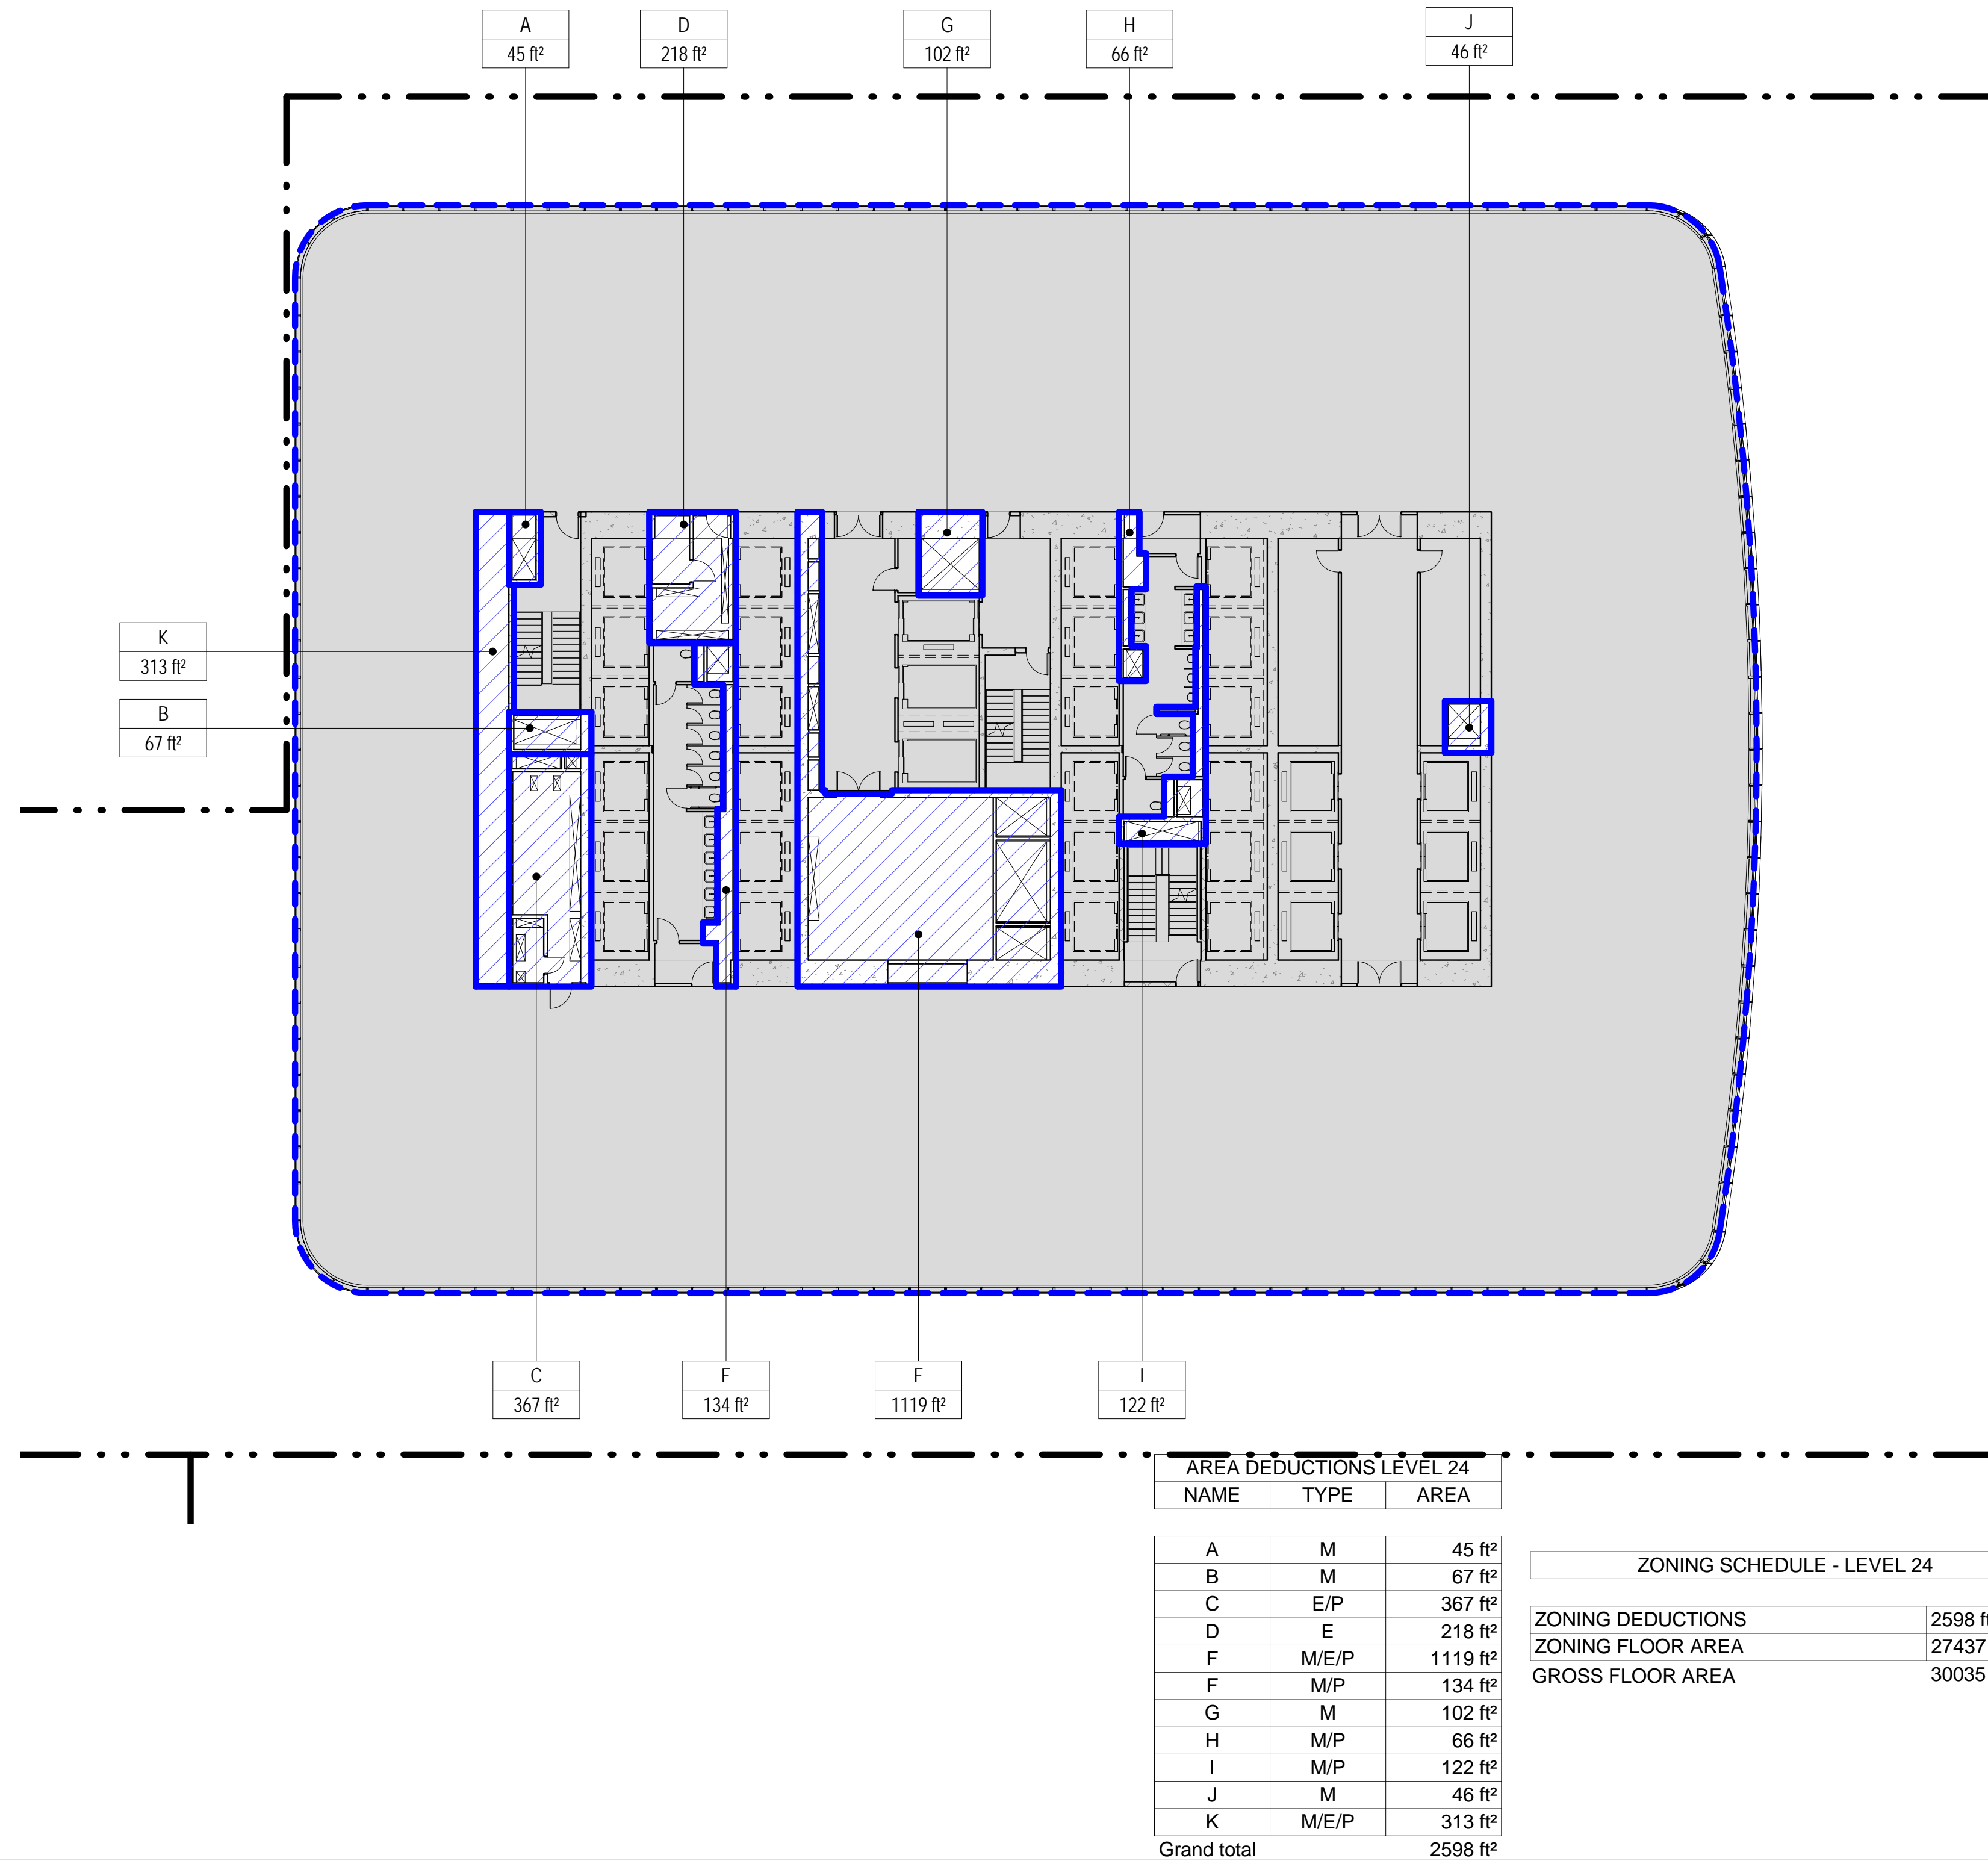
3 LEVEL 23 PLAN

SCALE: 1/16" = 1'-0"




4 LEVEL 24 PLAN

SCALE: 1/16" = 1'-0"




1 LEVEL 21 PLAN

SCALE: 1/16" = 1'-0"

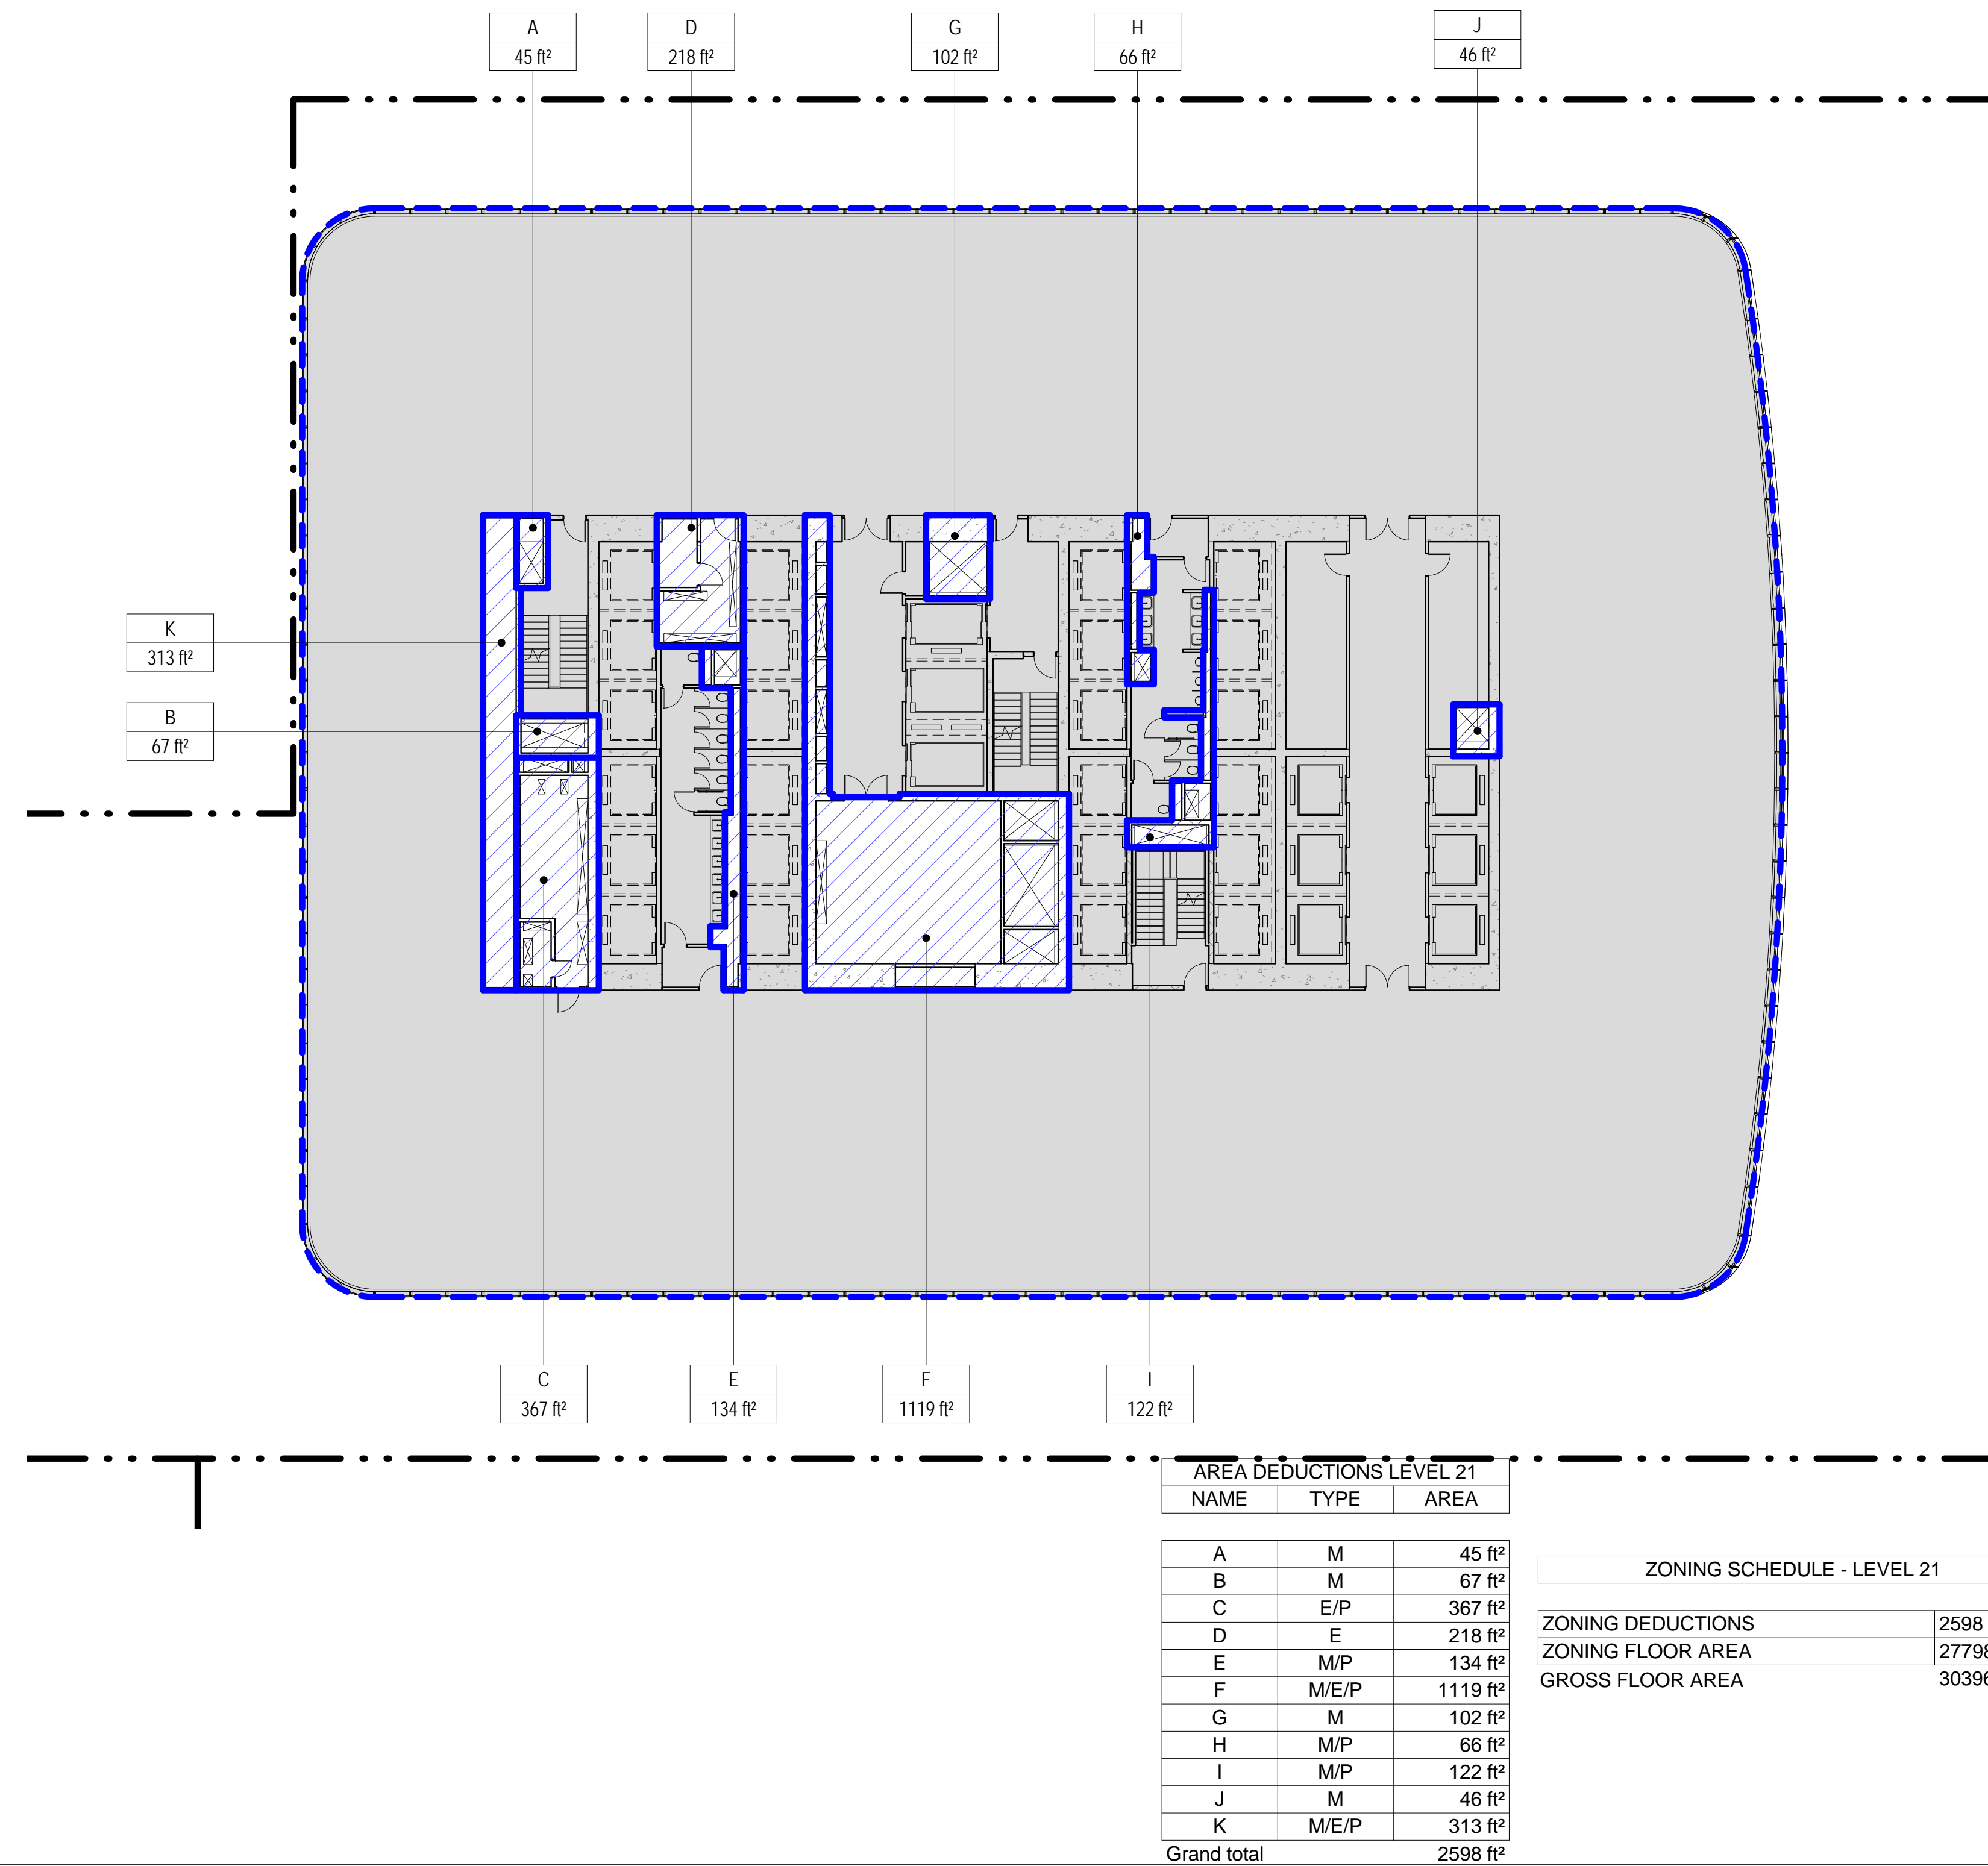

2 LEVEL 22 PLAN

SCALE: 1/16" = 1'-0"

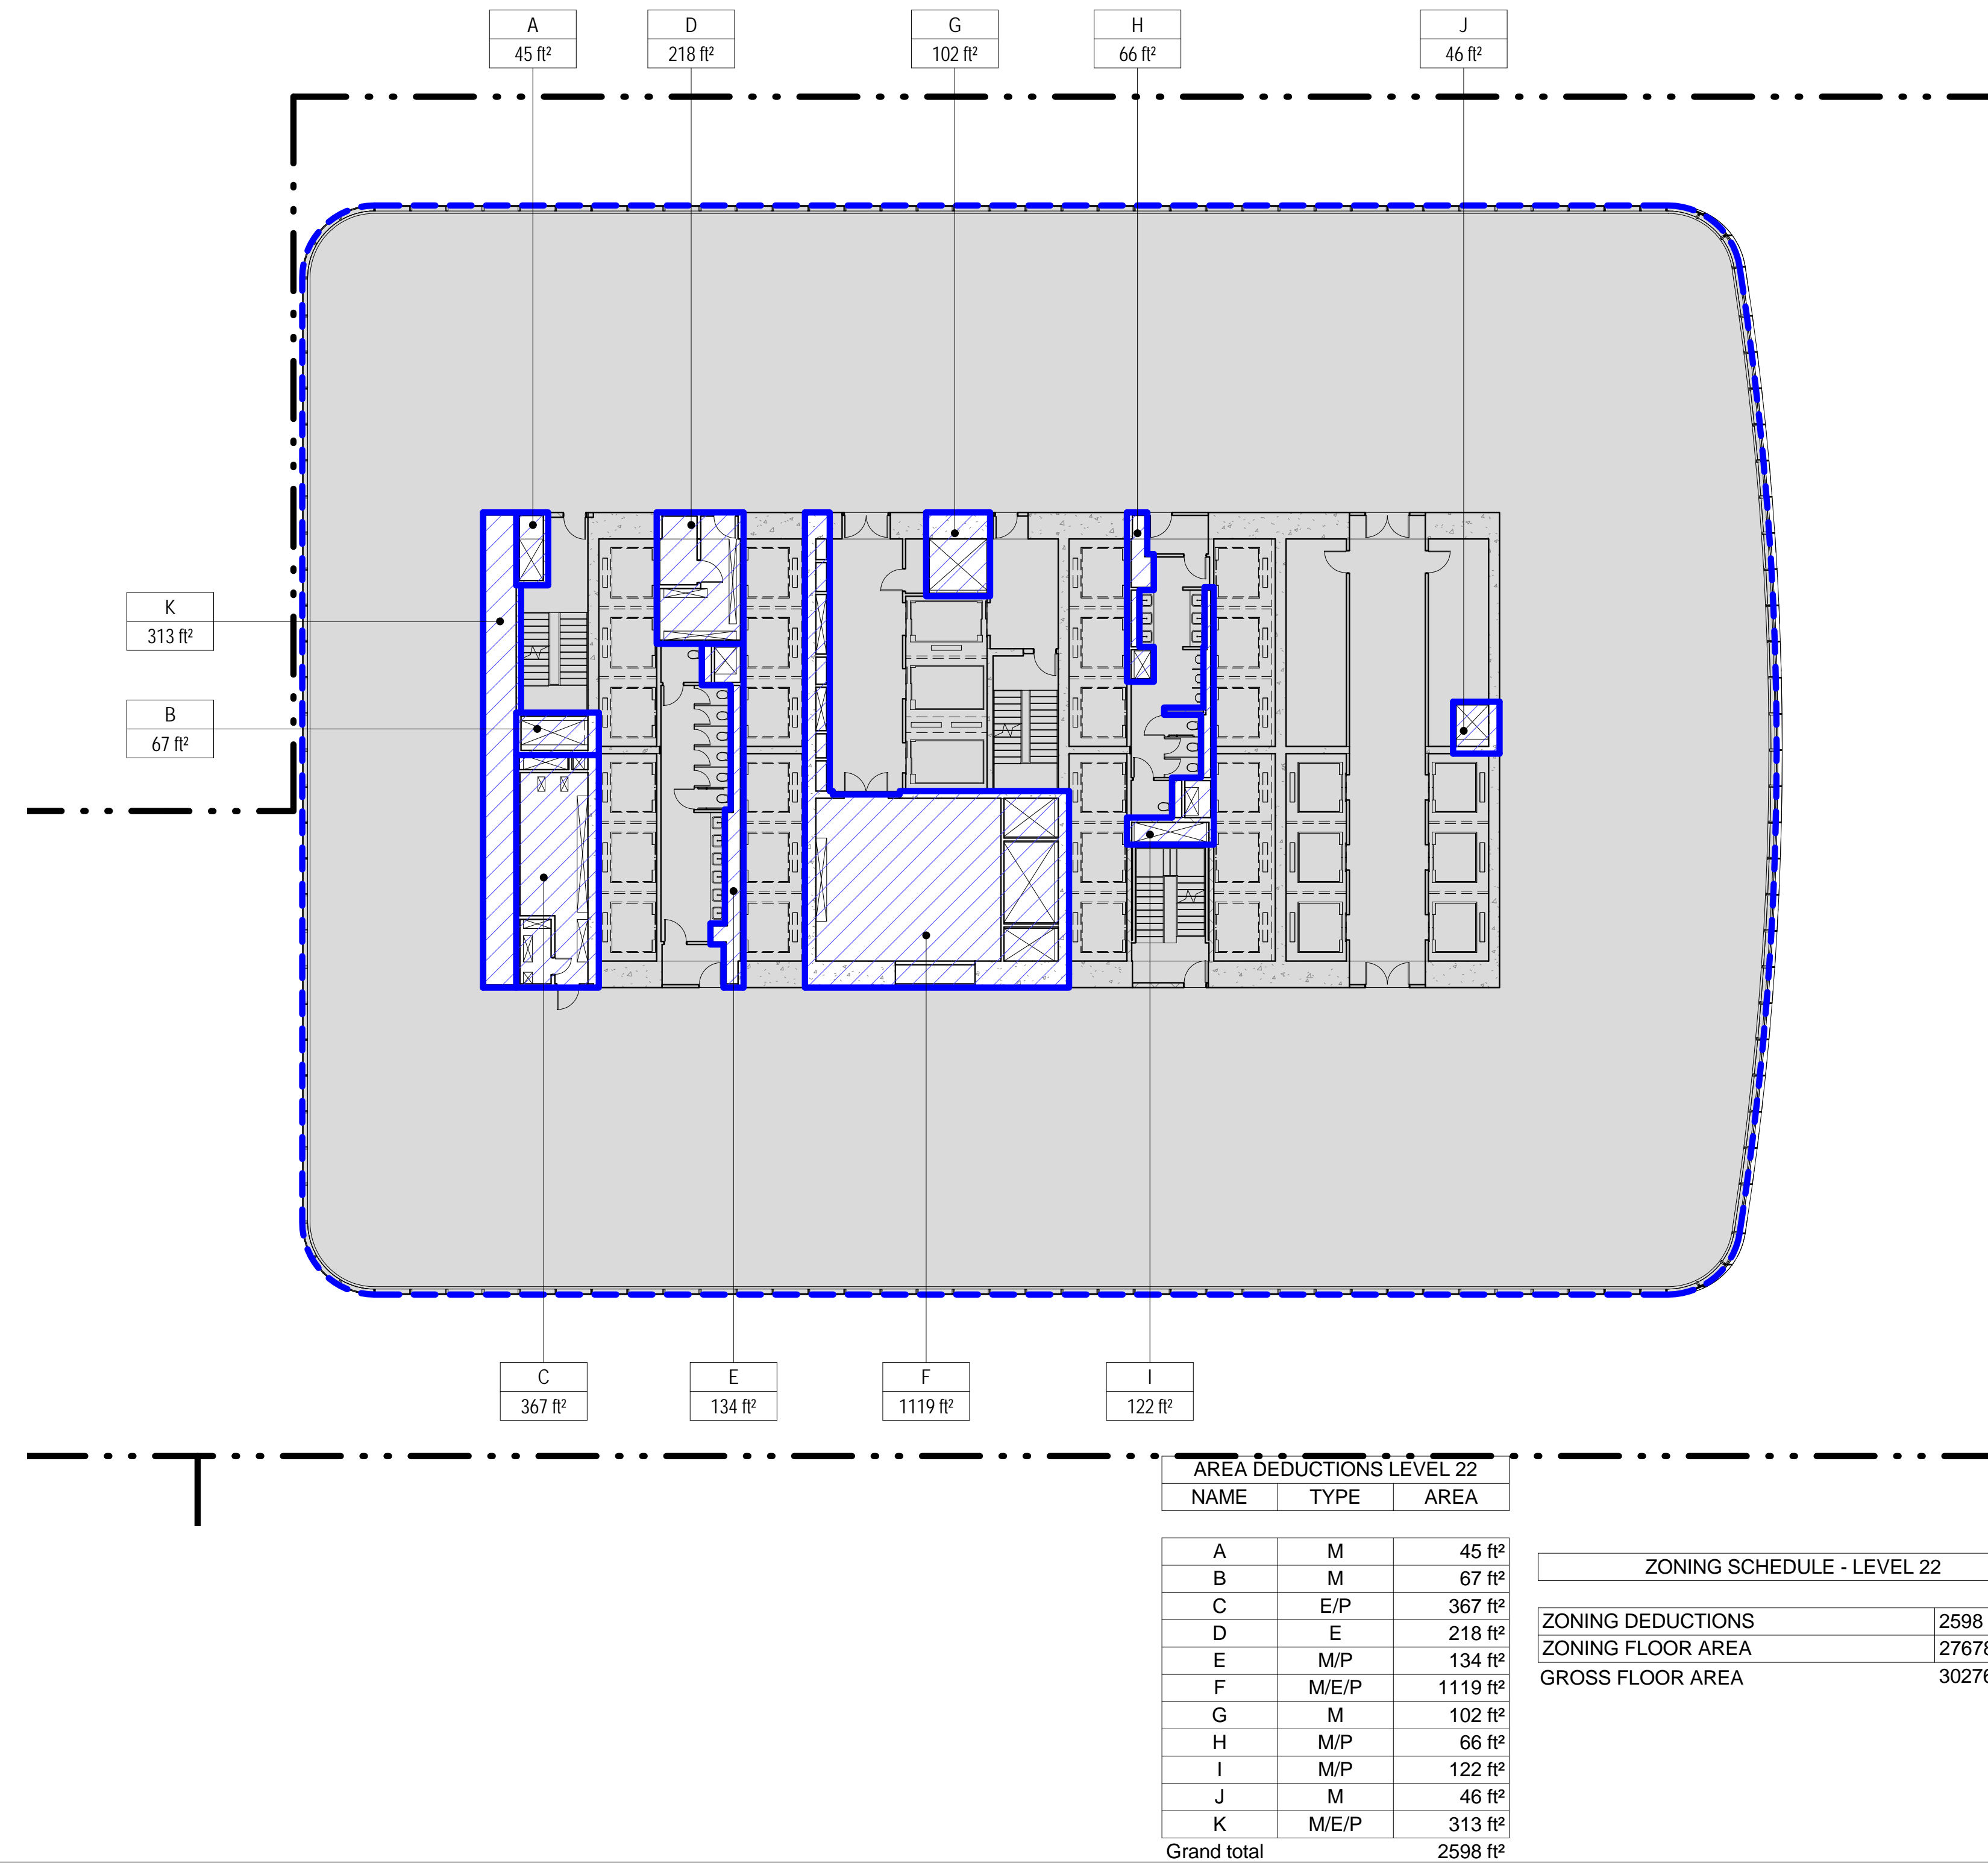

ZONING LEGENDS

- GROSS BUILDING AREA
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- ZONING FLOOR AREA
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- M MECHANICAL
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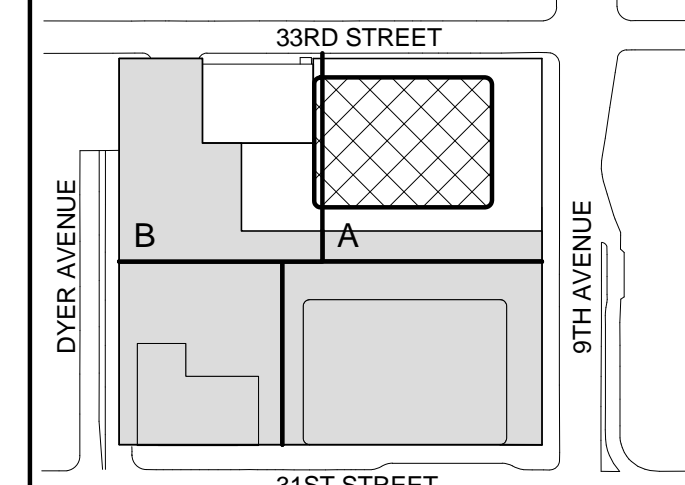
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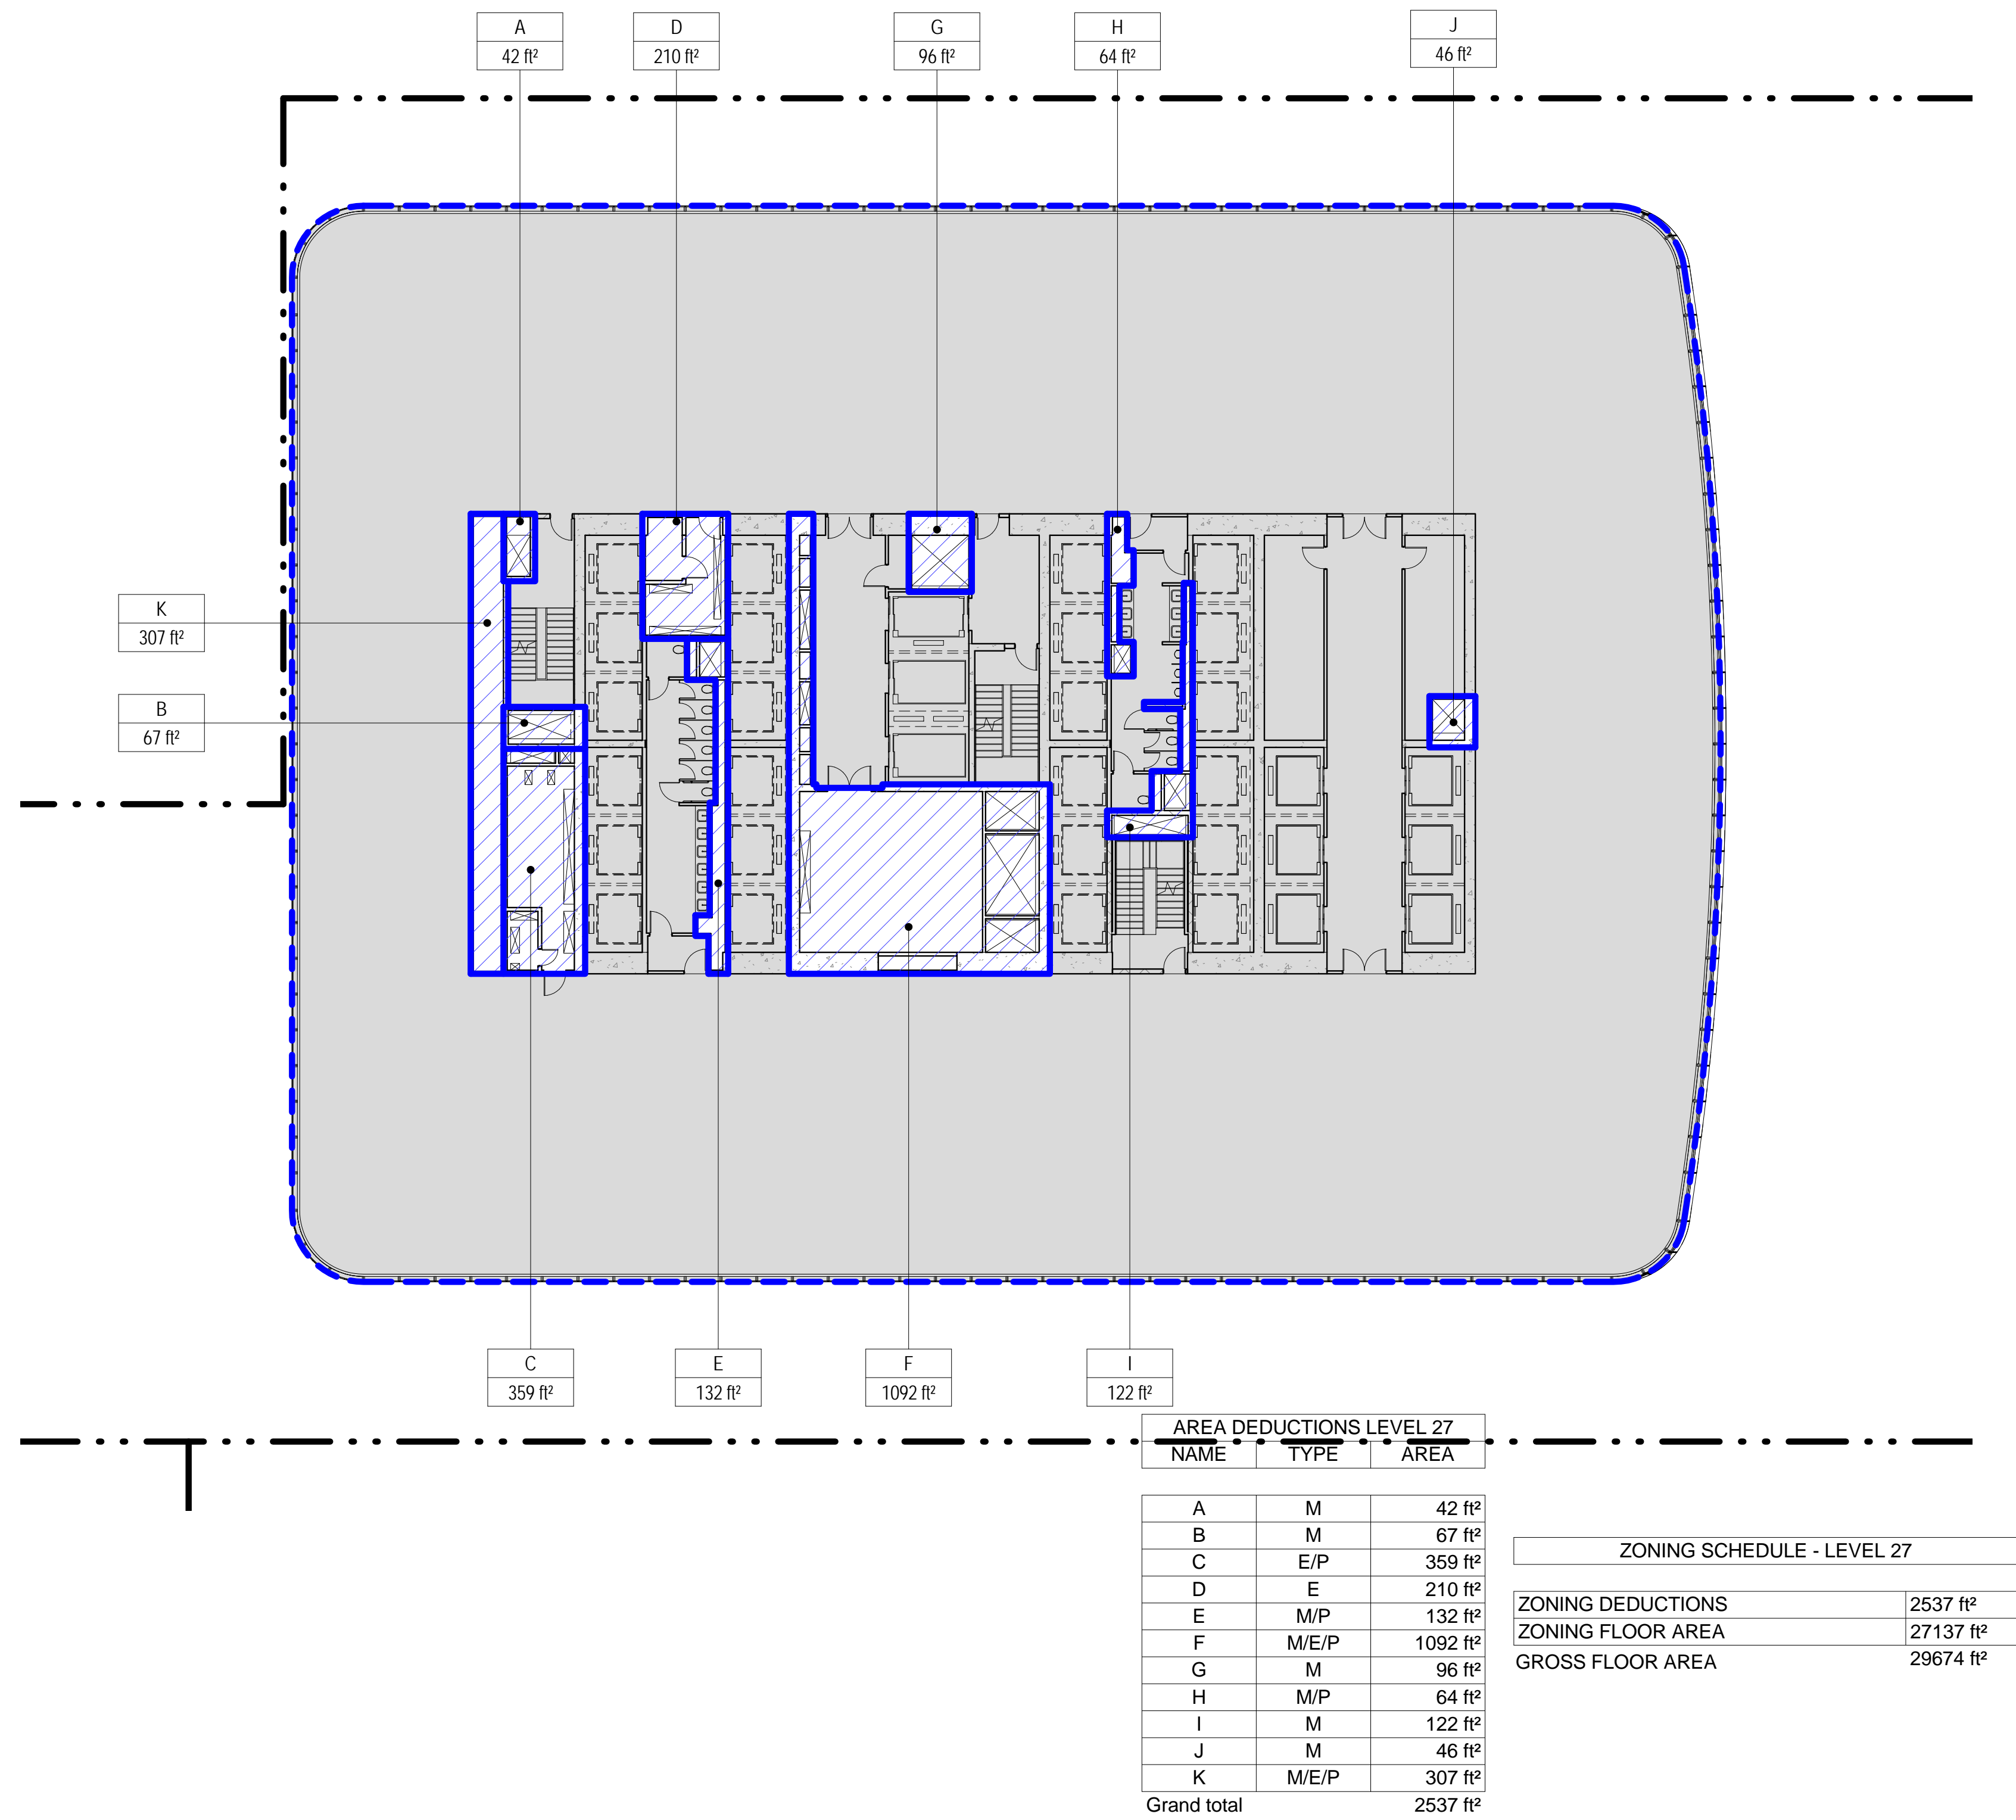
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ZONING FLOOR AREA DEDUCTIONS - LEVEL 21-24

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Date: 20 JUN 2014
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File No.: 2-109
B-SCAN Sheet No.: Z-109.00
Sheet No.: Z-109
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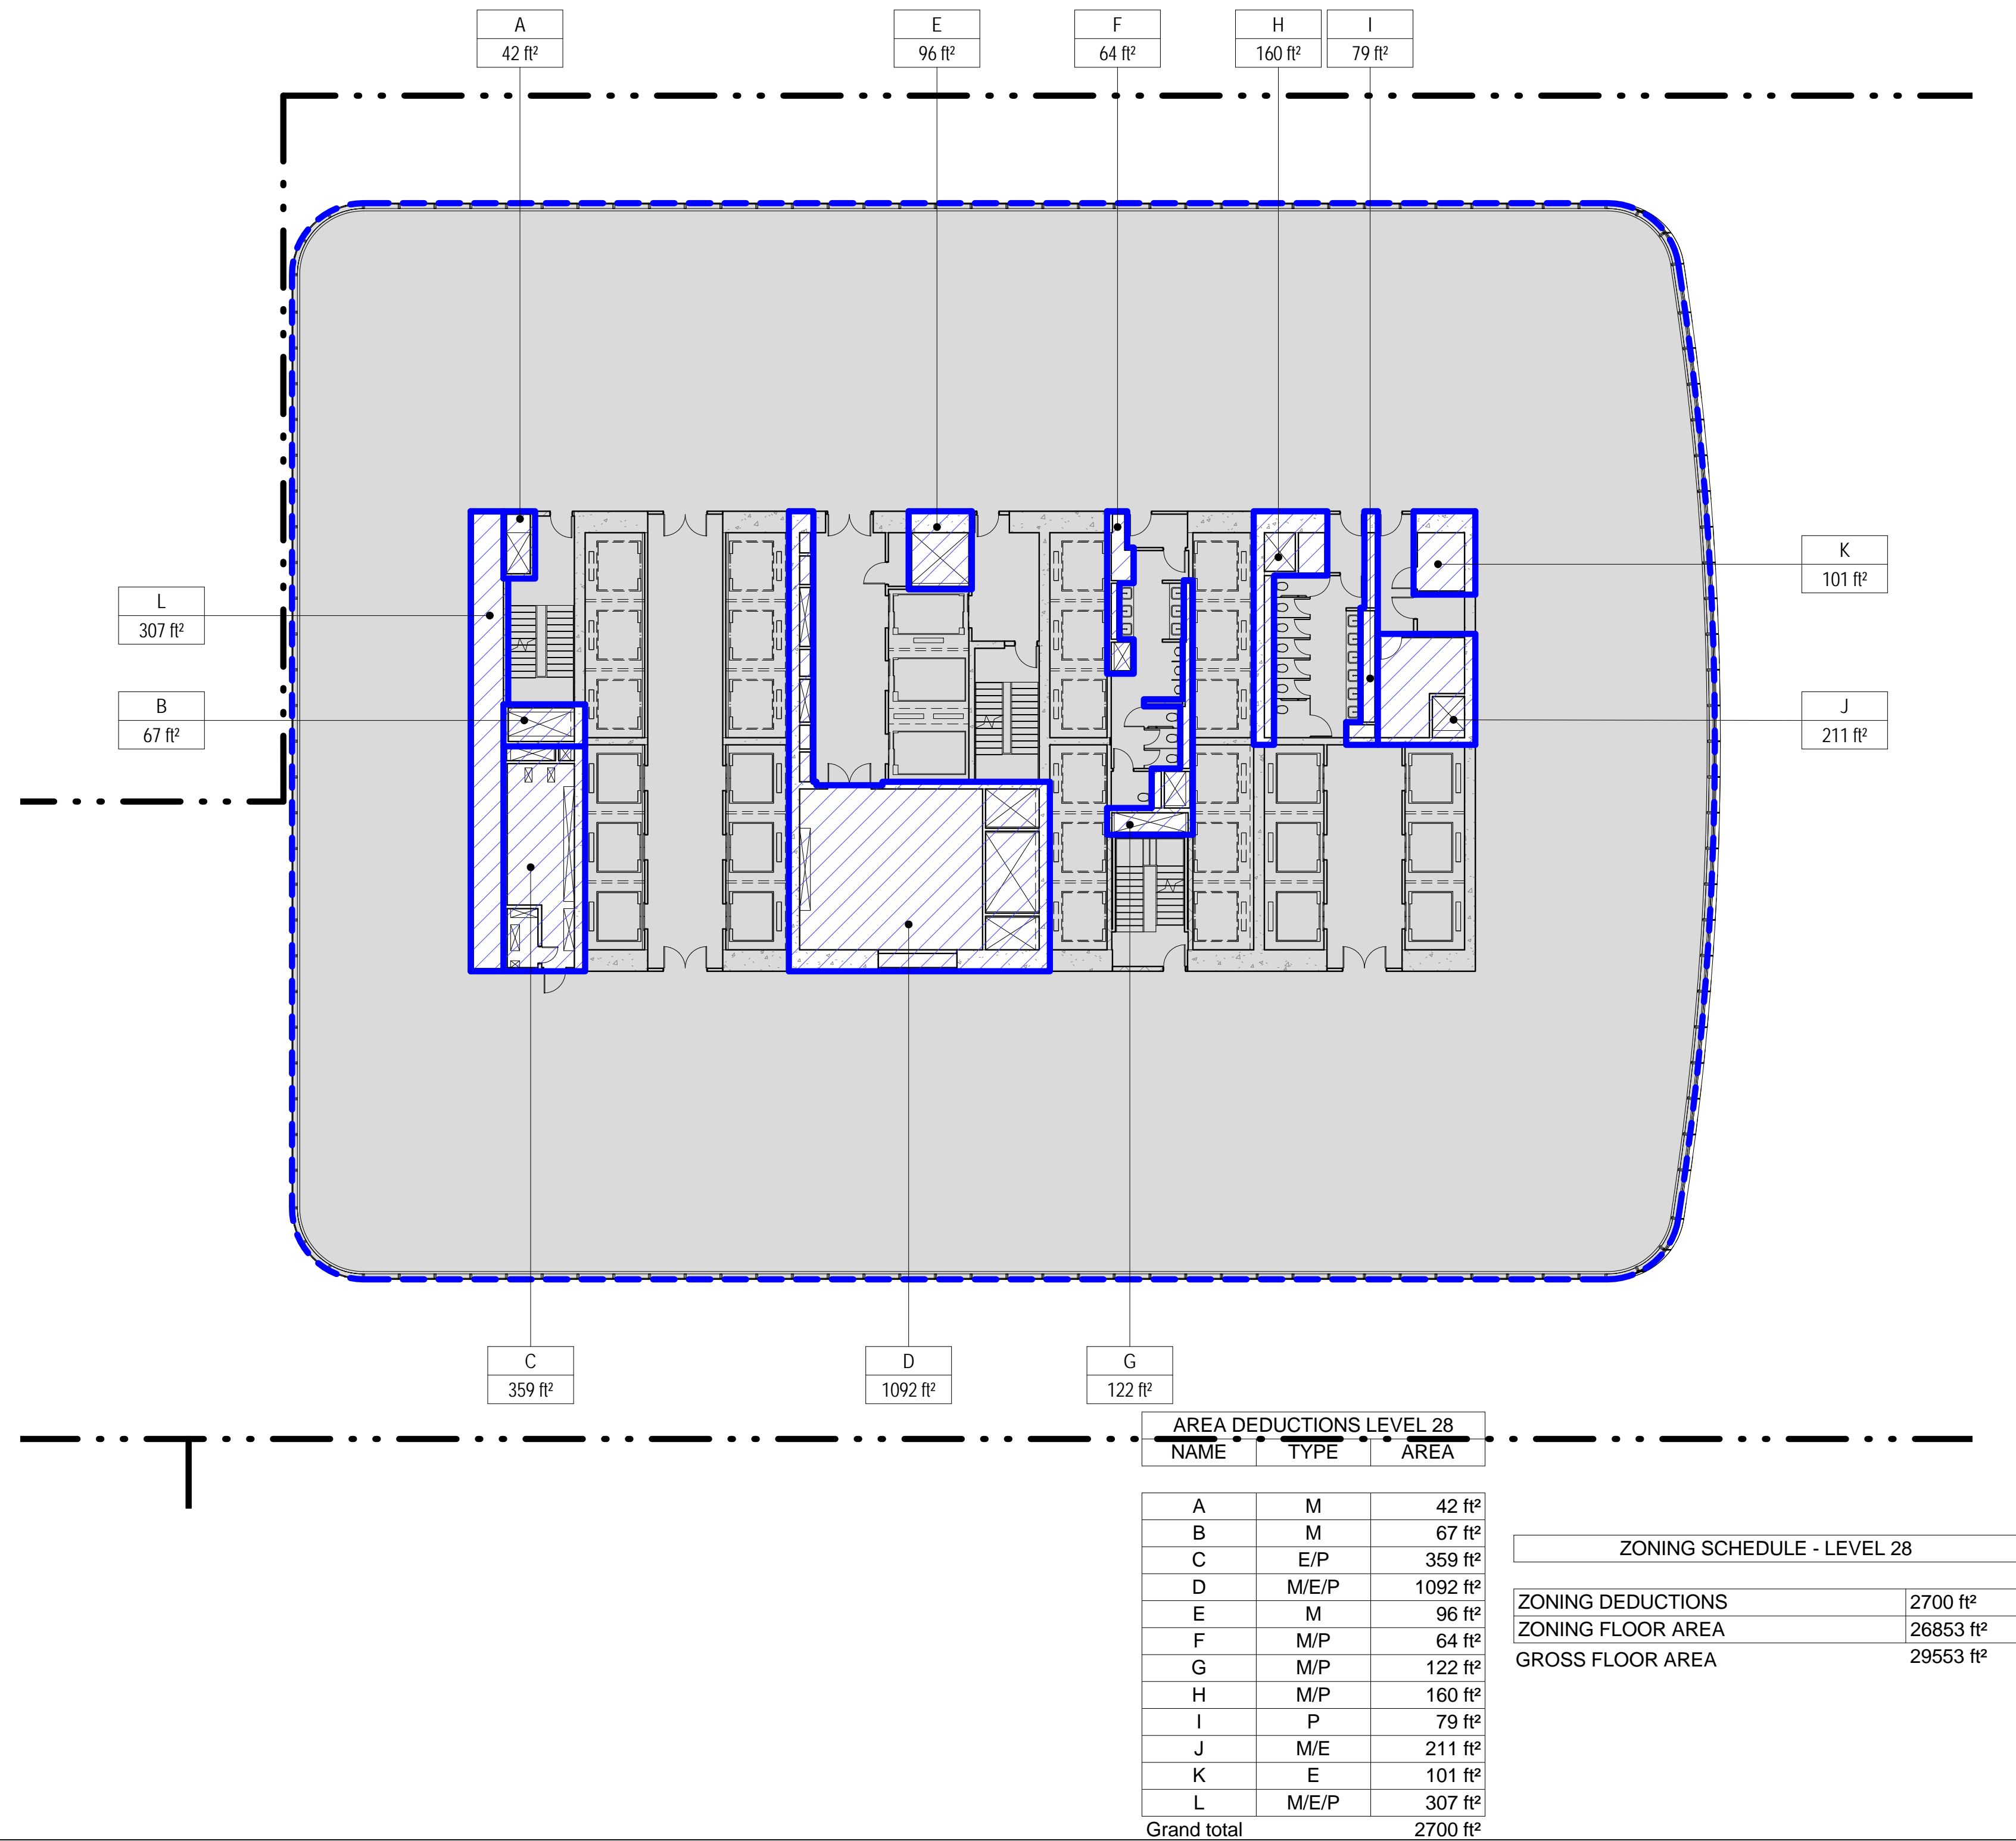
3 LEVEL 27 PLAN

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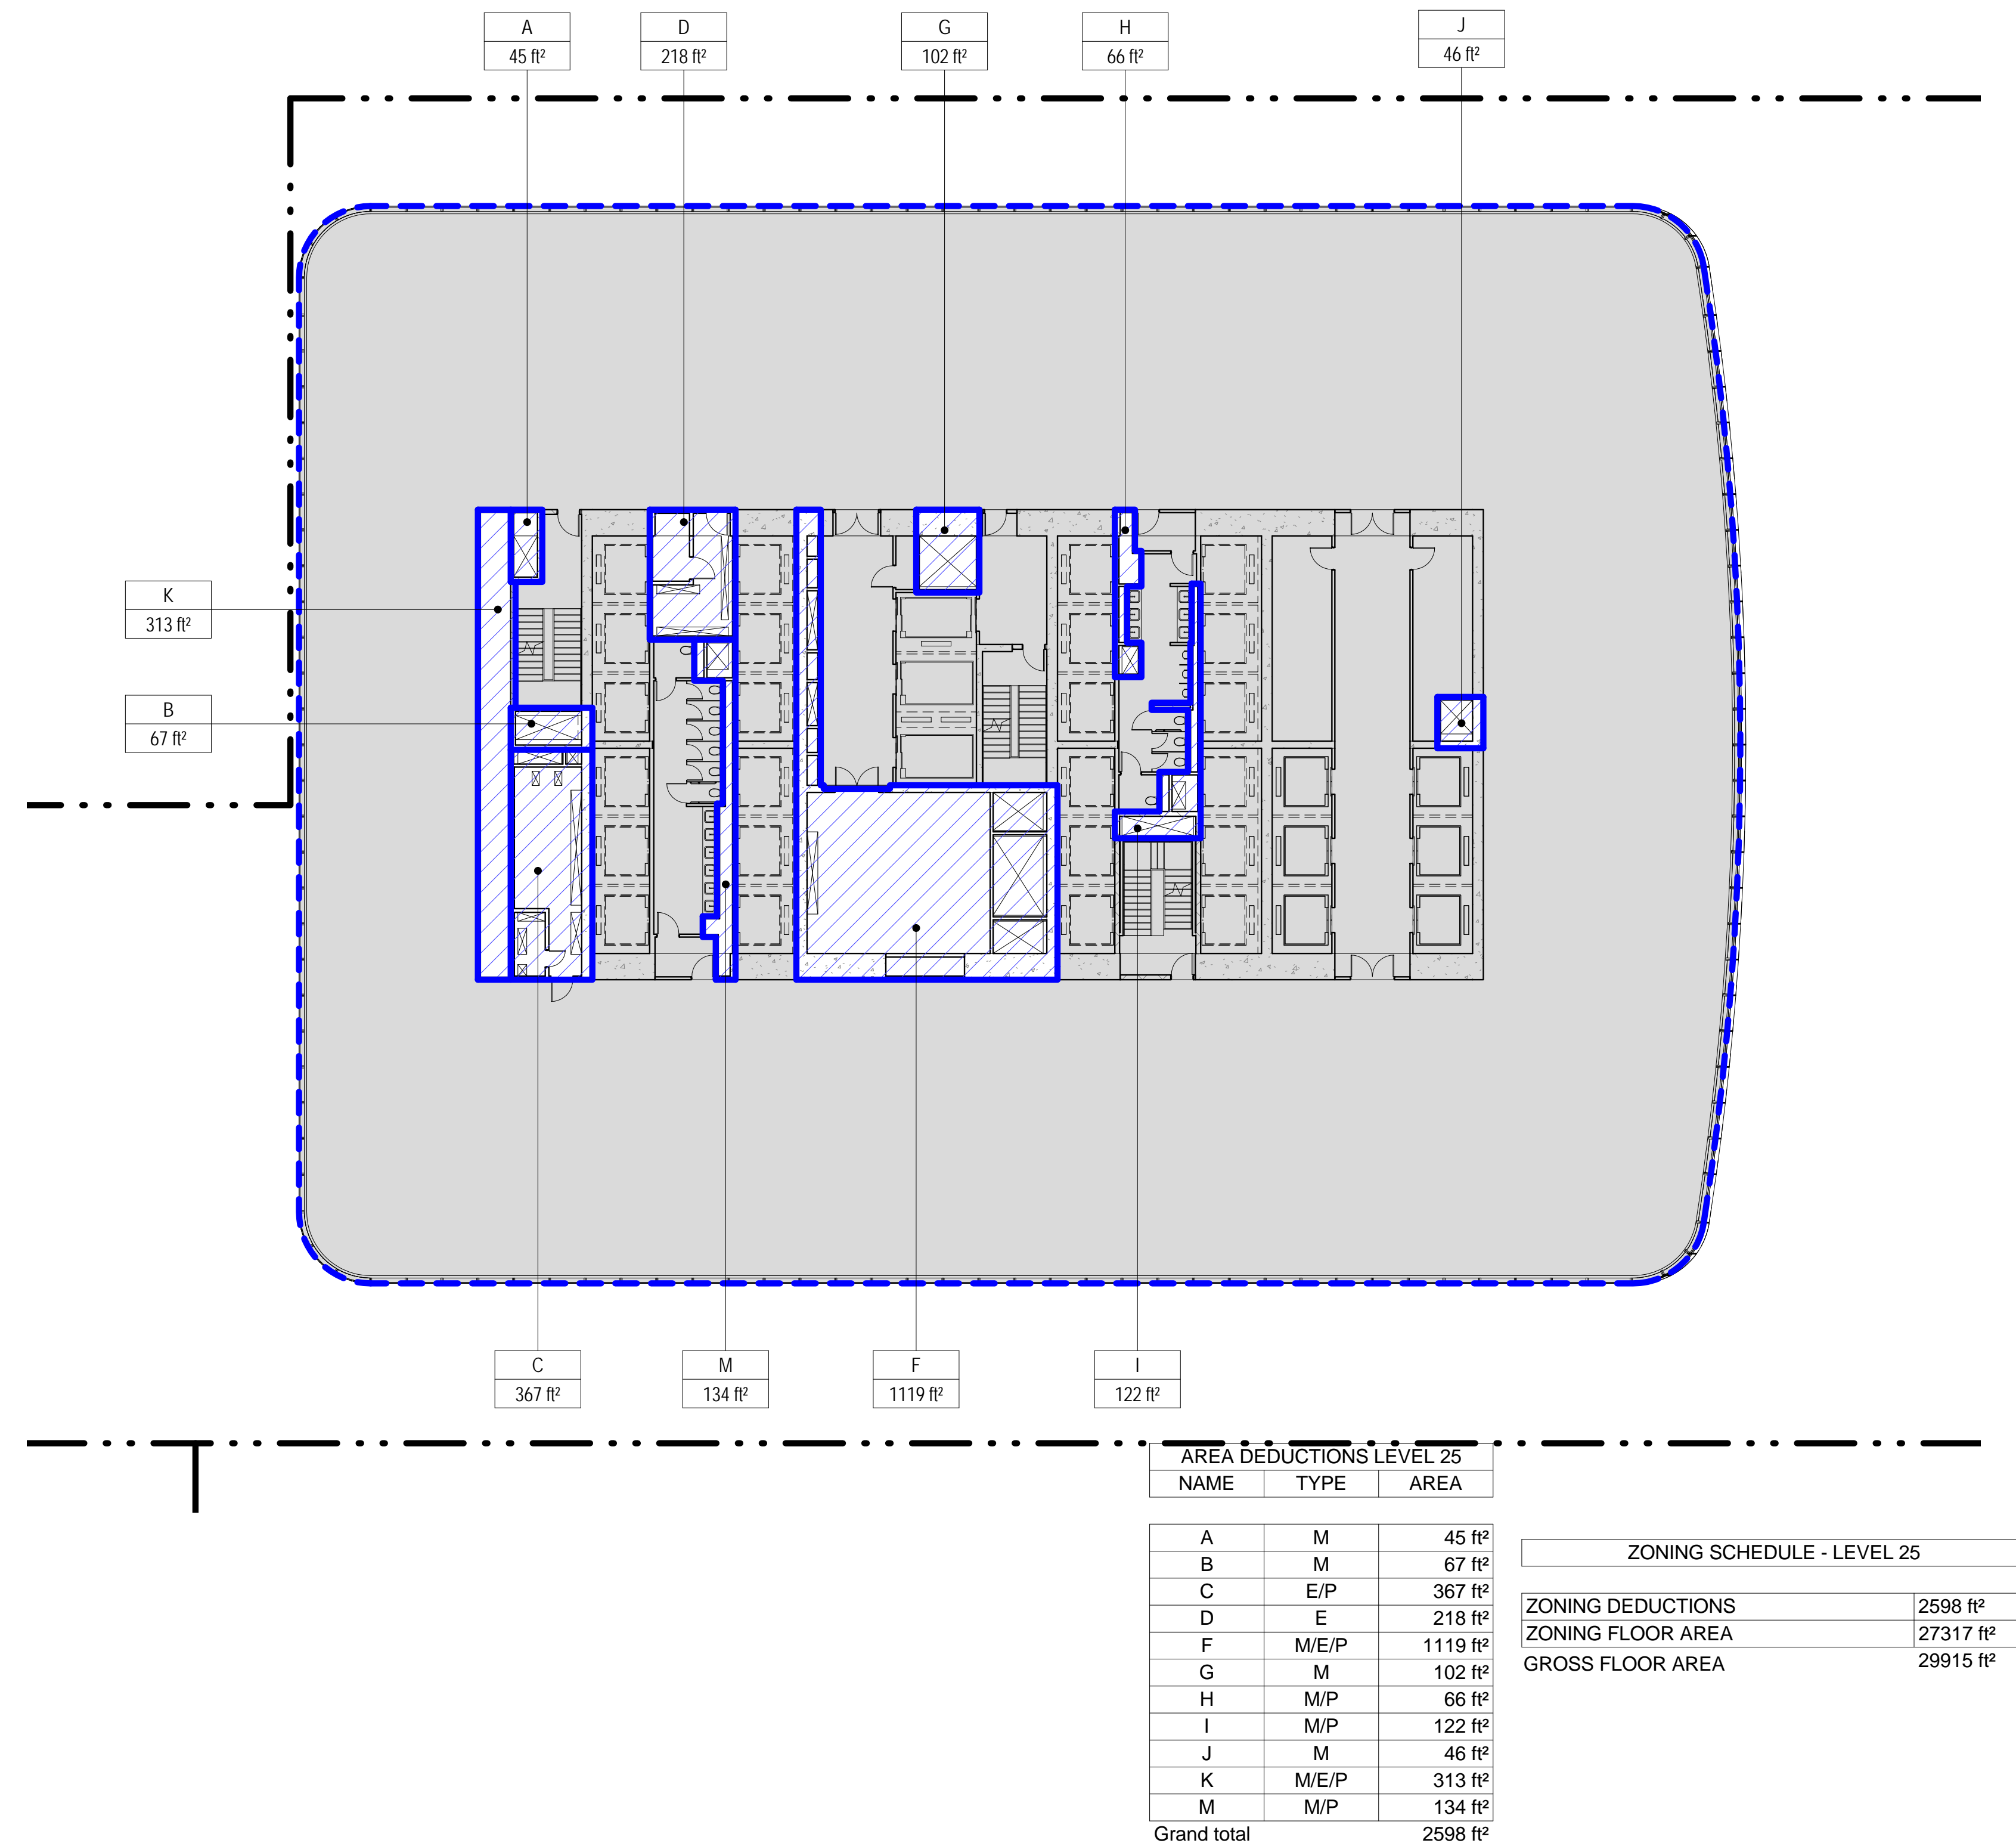
4 LEVEL 28 PLAN

SCALE: 1/16" = 1'-0"




1 LEVEL 25 PLAN

SCALE: 1/16" = 1'-0"



2 LEVEL 26 PLAN

SCALE: 1/16" = 1'-0"

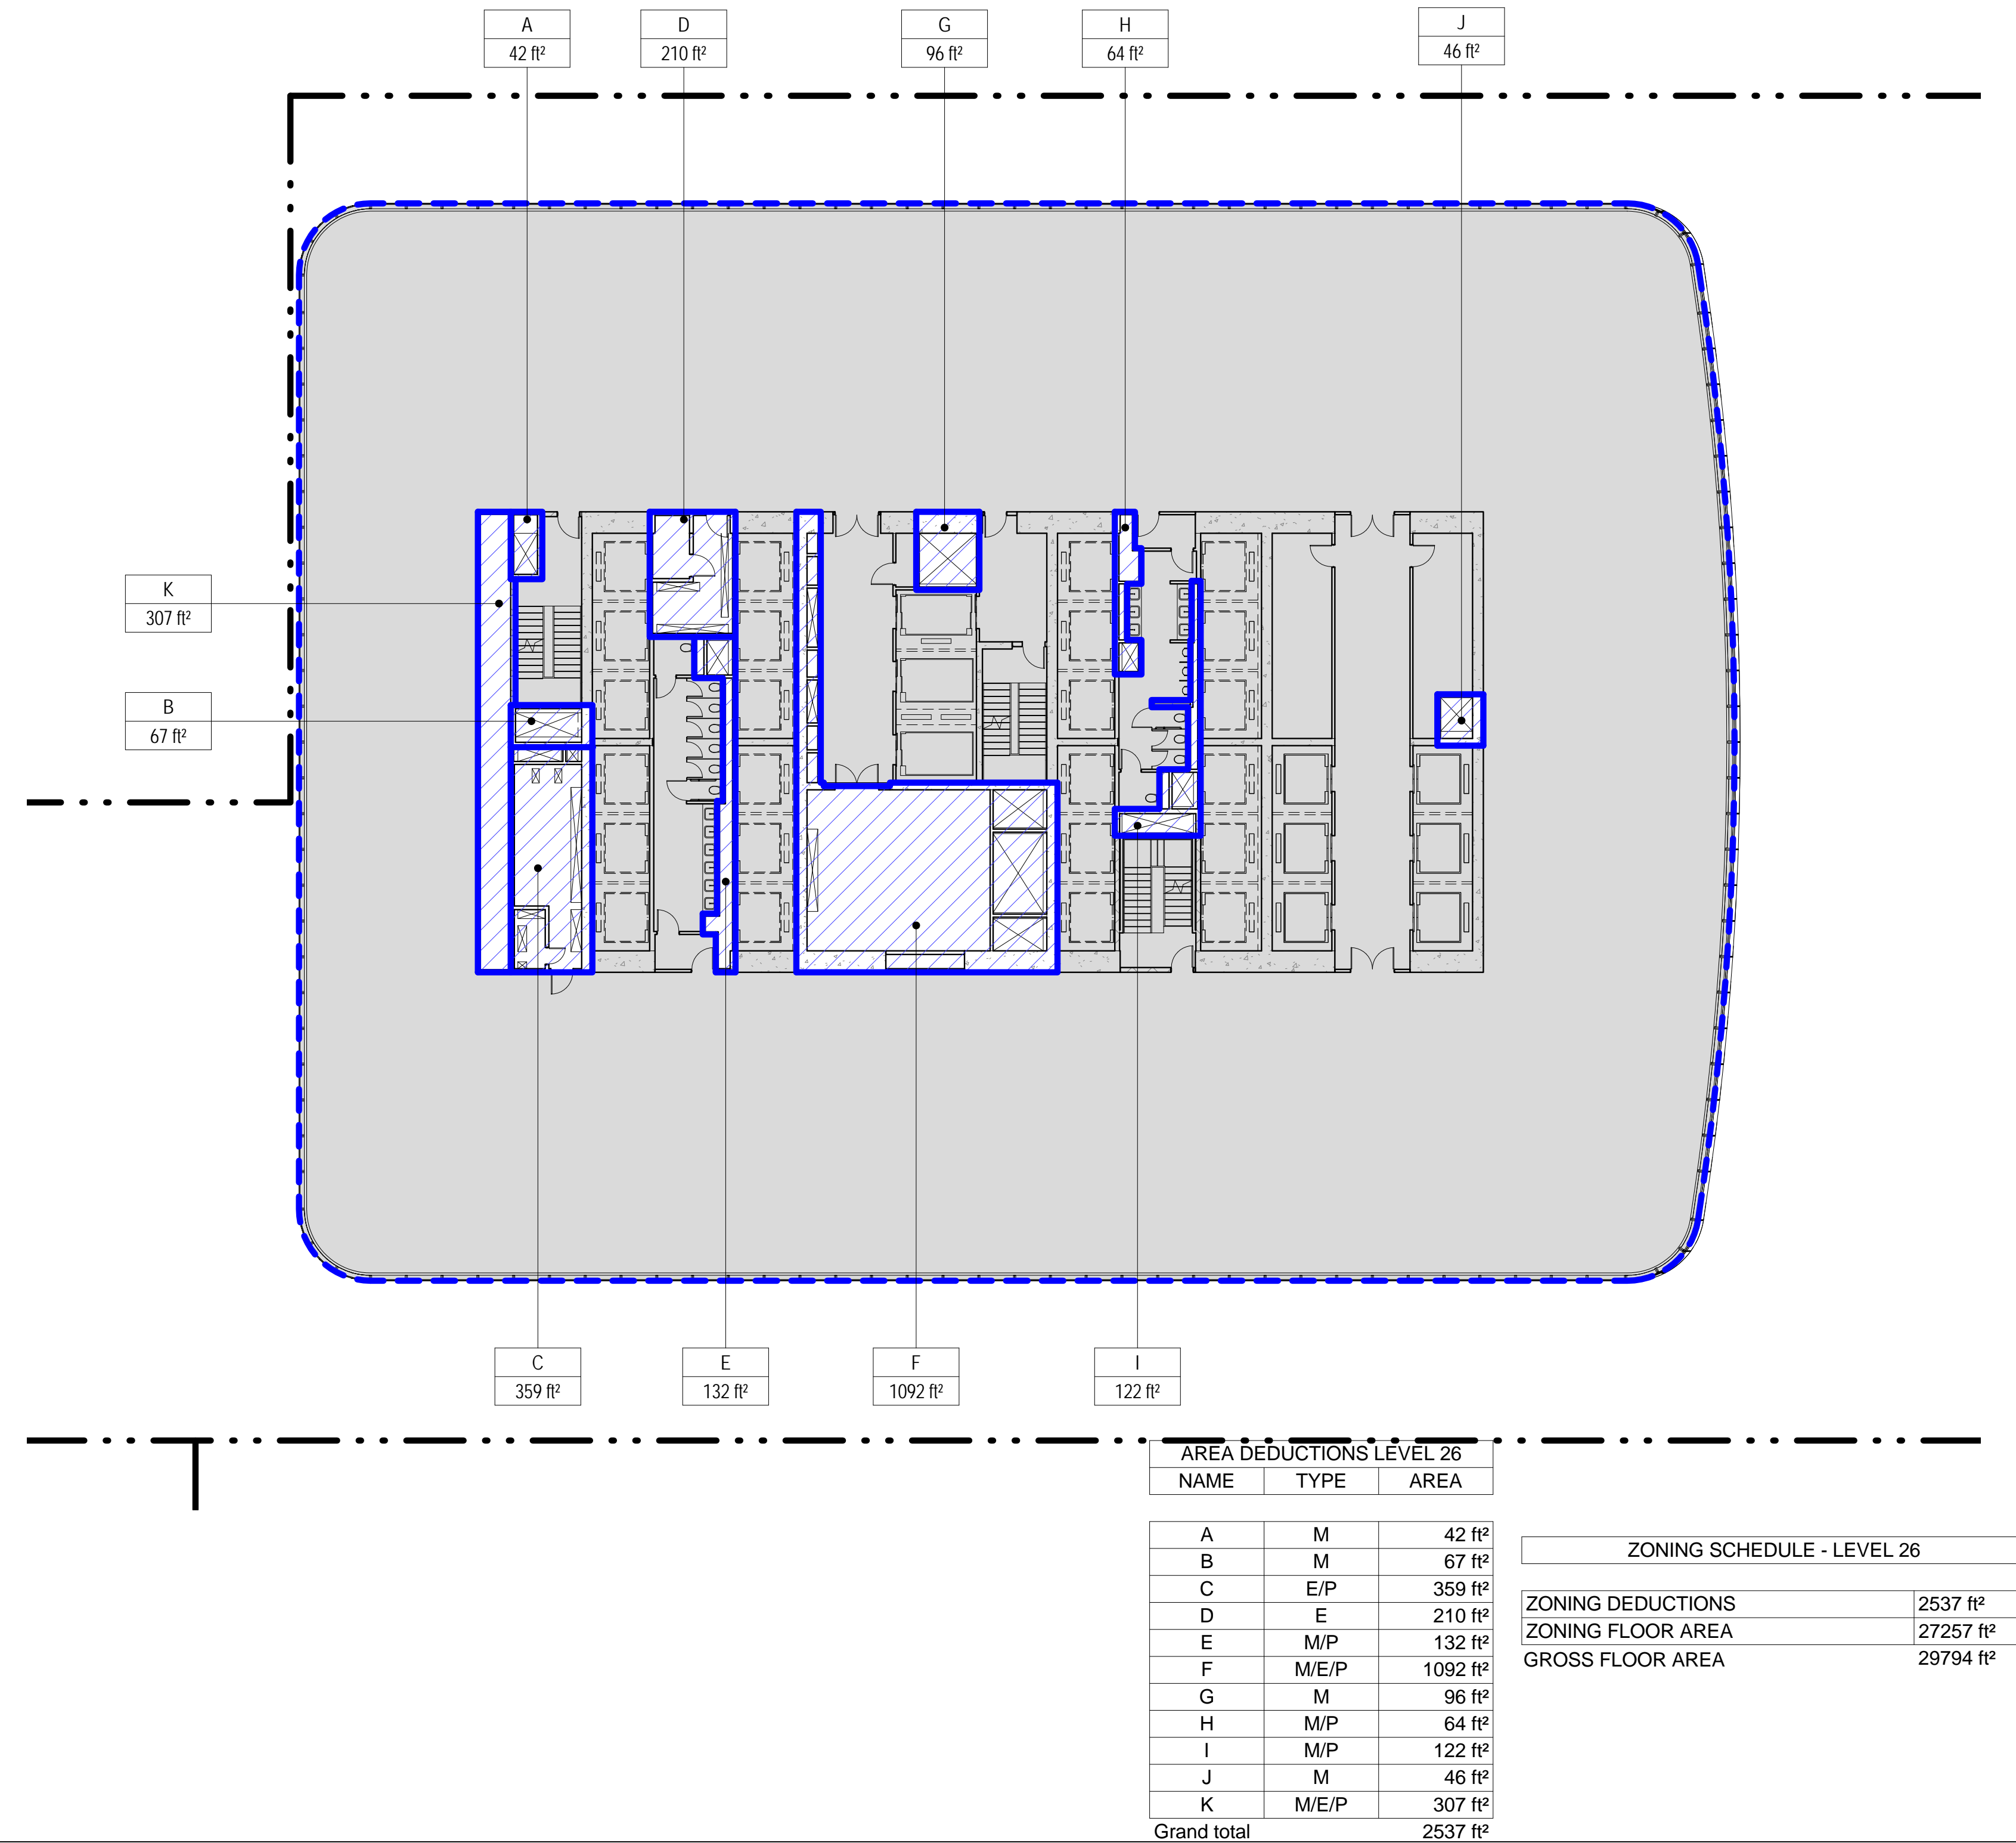

- ZONING LEGENDS**
- GROSS BUILDING AREA
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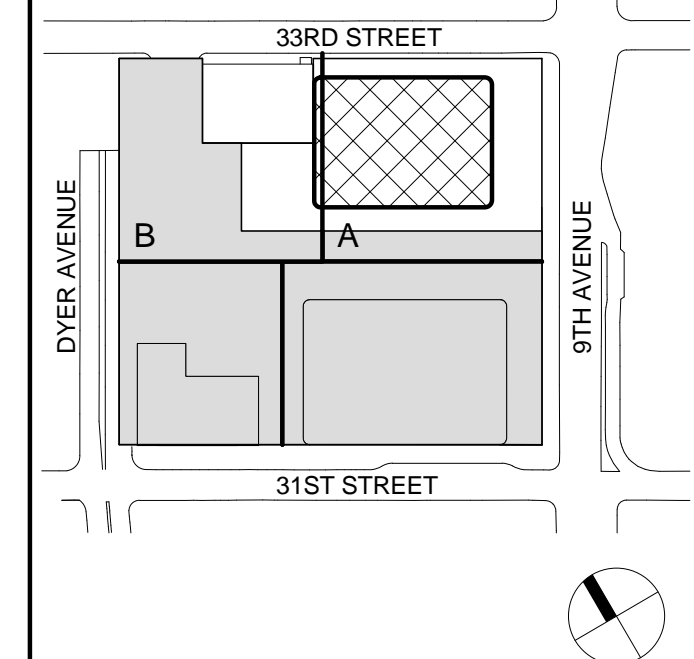
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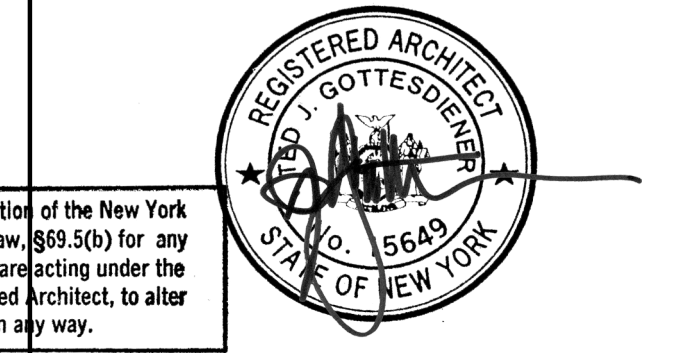
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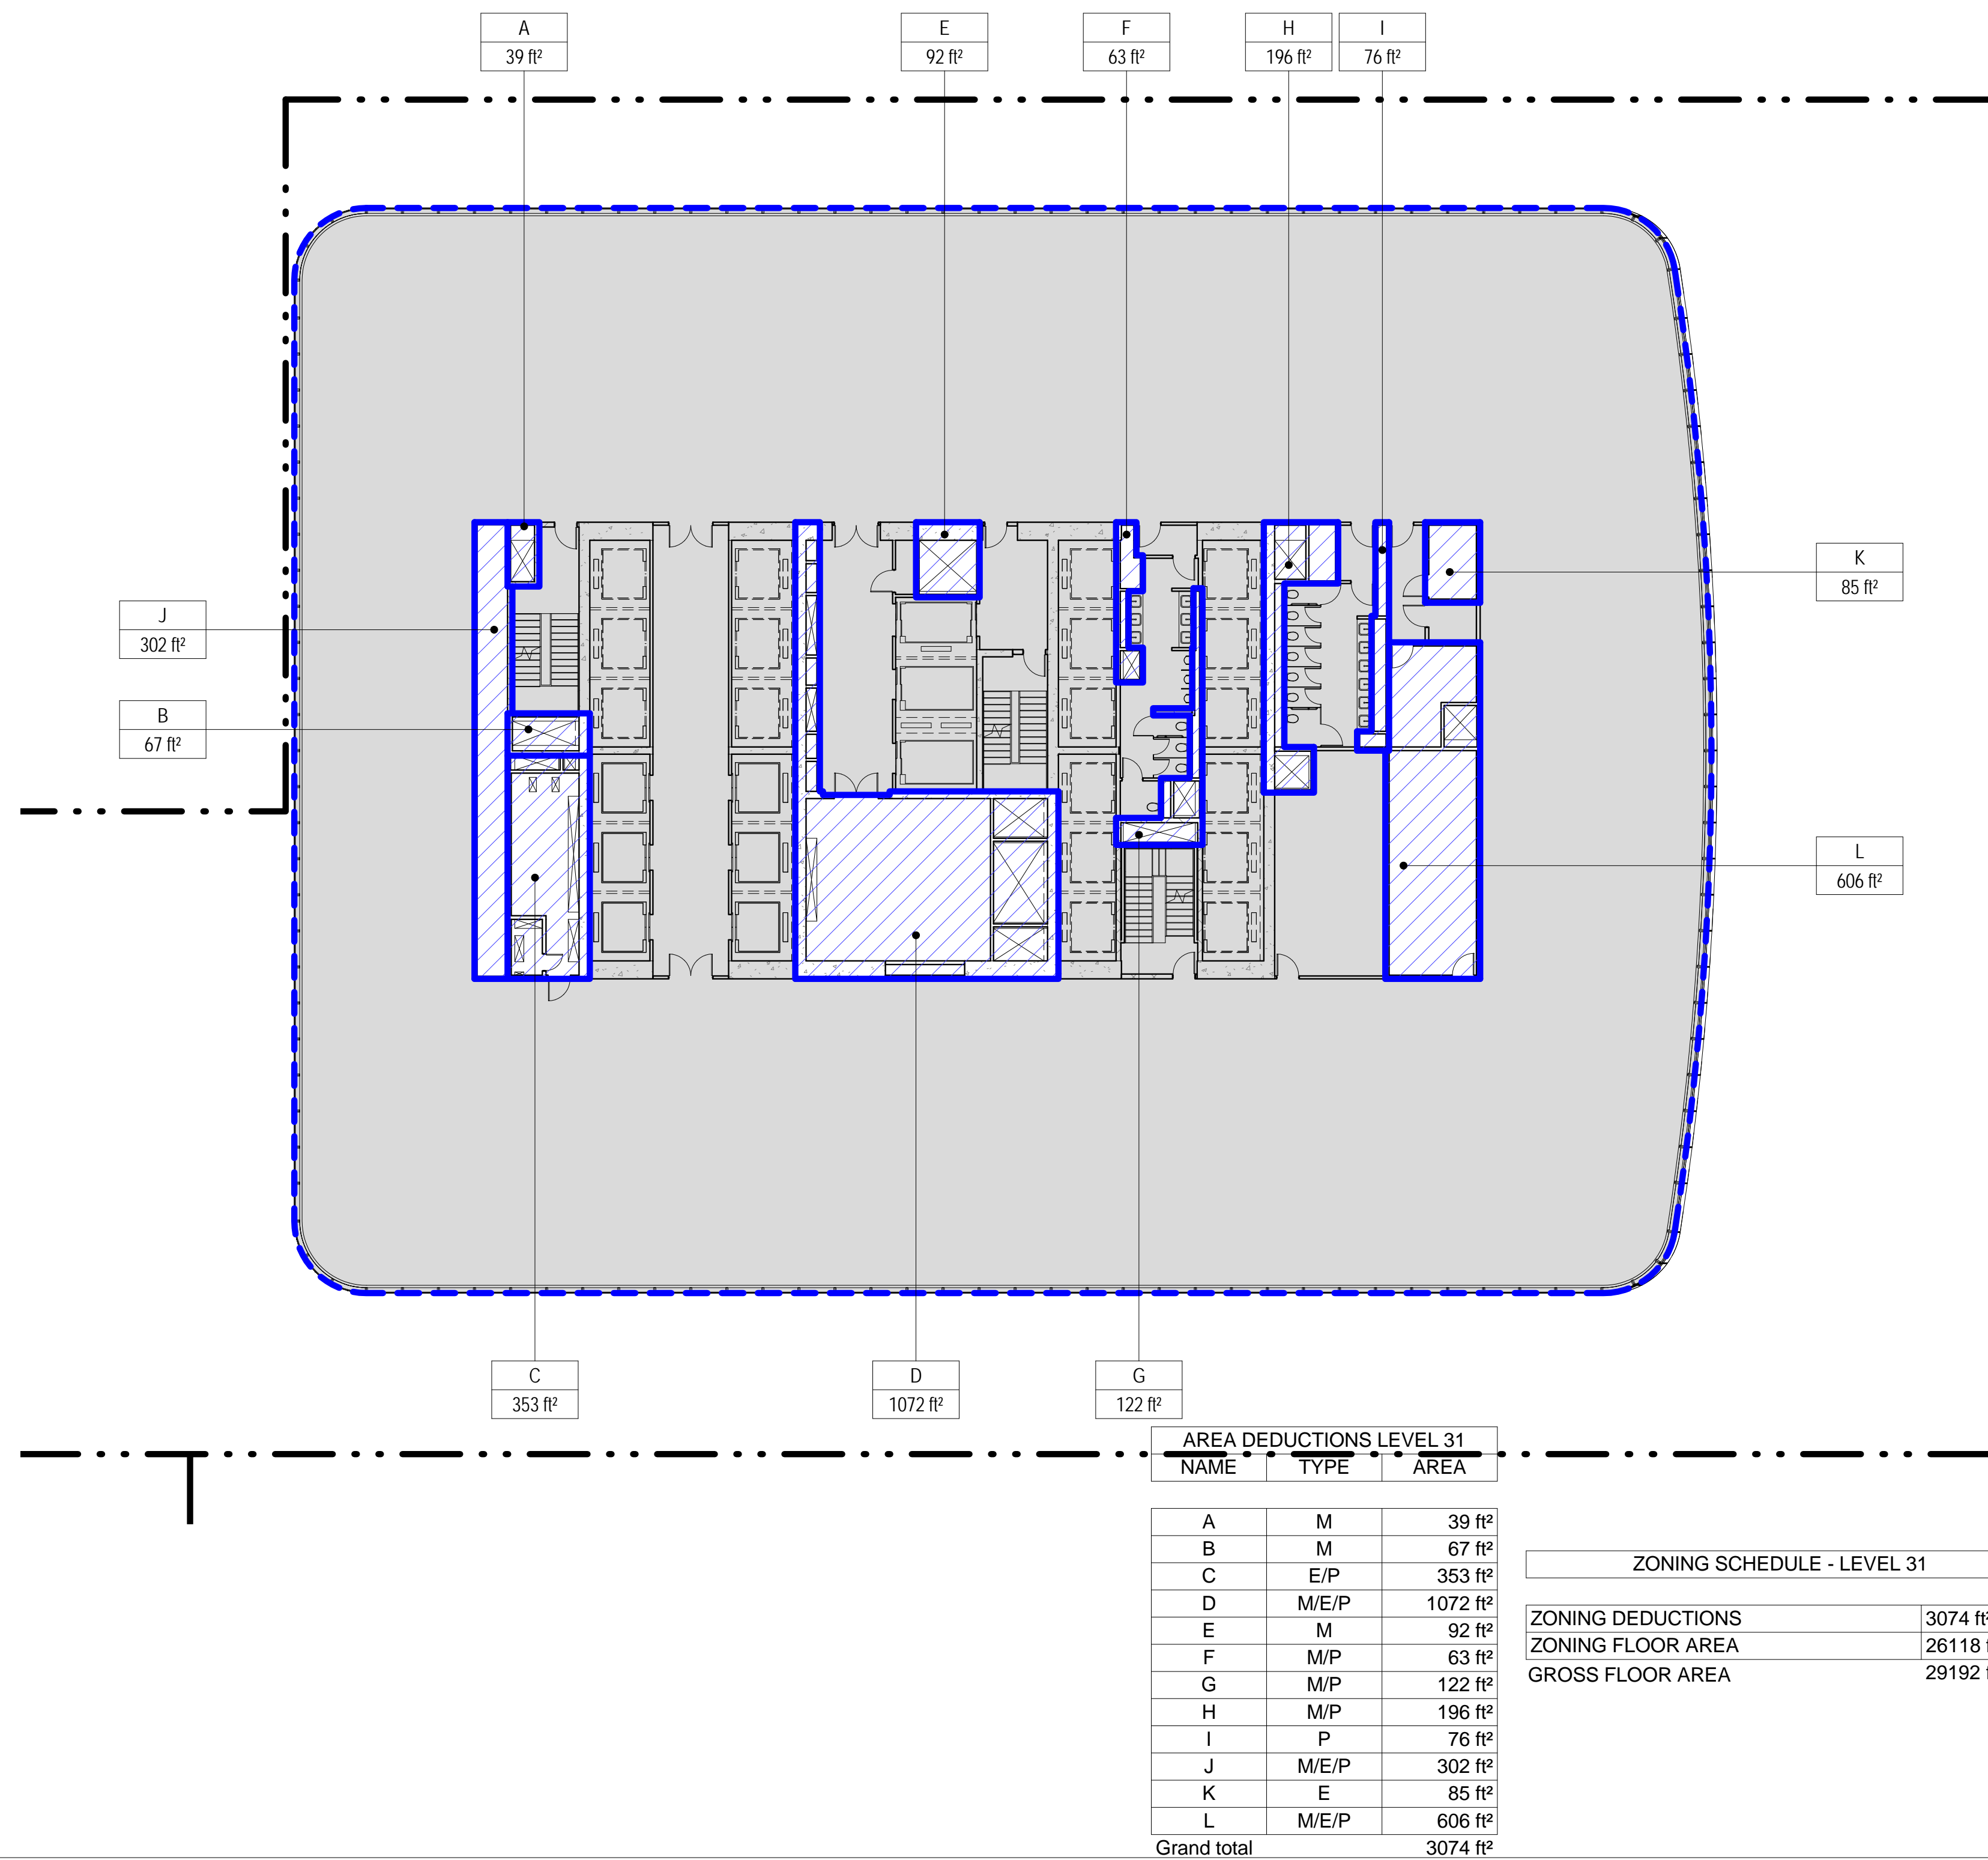
**ZONING FLOOR
AREA
DEDUCTIONS -
LEVEL 25-28**

Project No.: 207150
Date: 20 JUN 2014
Scale: 1/16" = 1'-0"
File No.: Z-110

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Z-110.00
Sheet No.:
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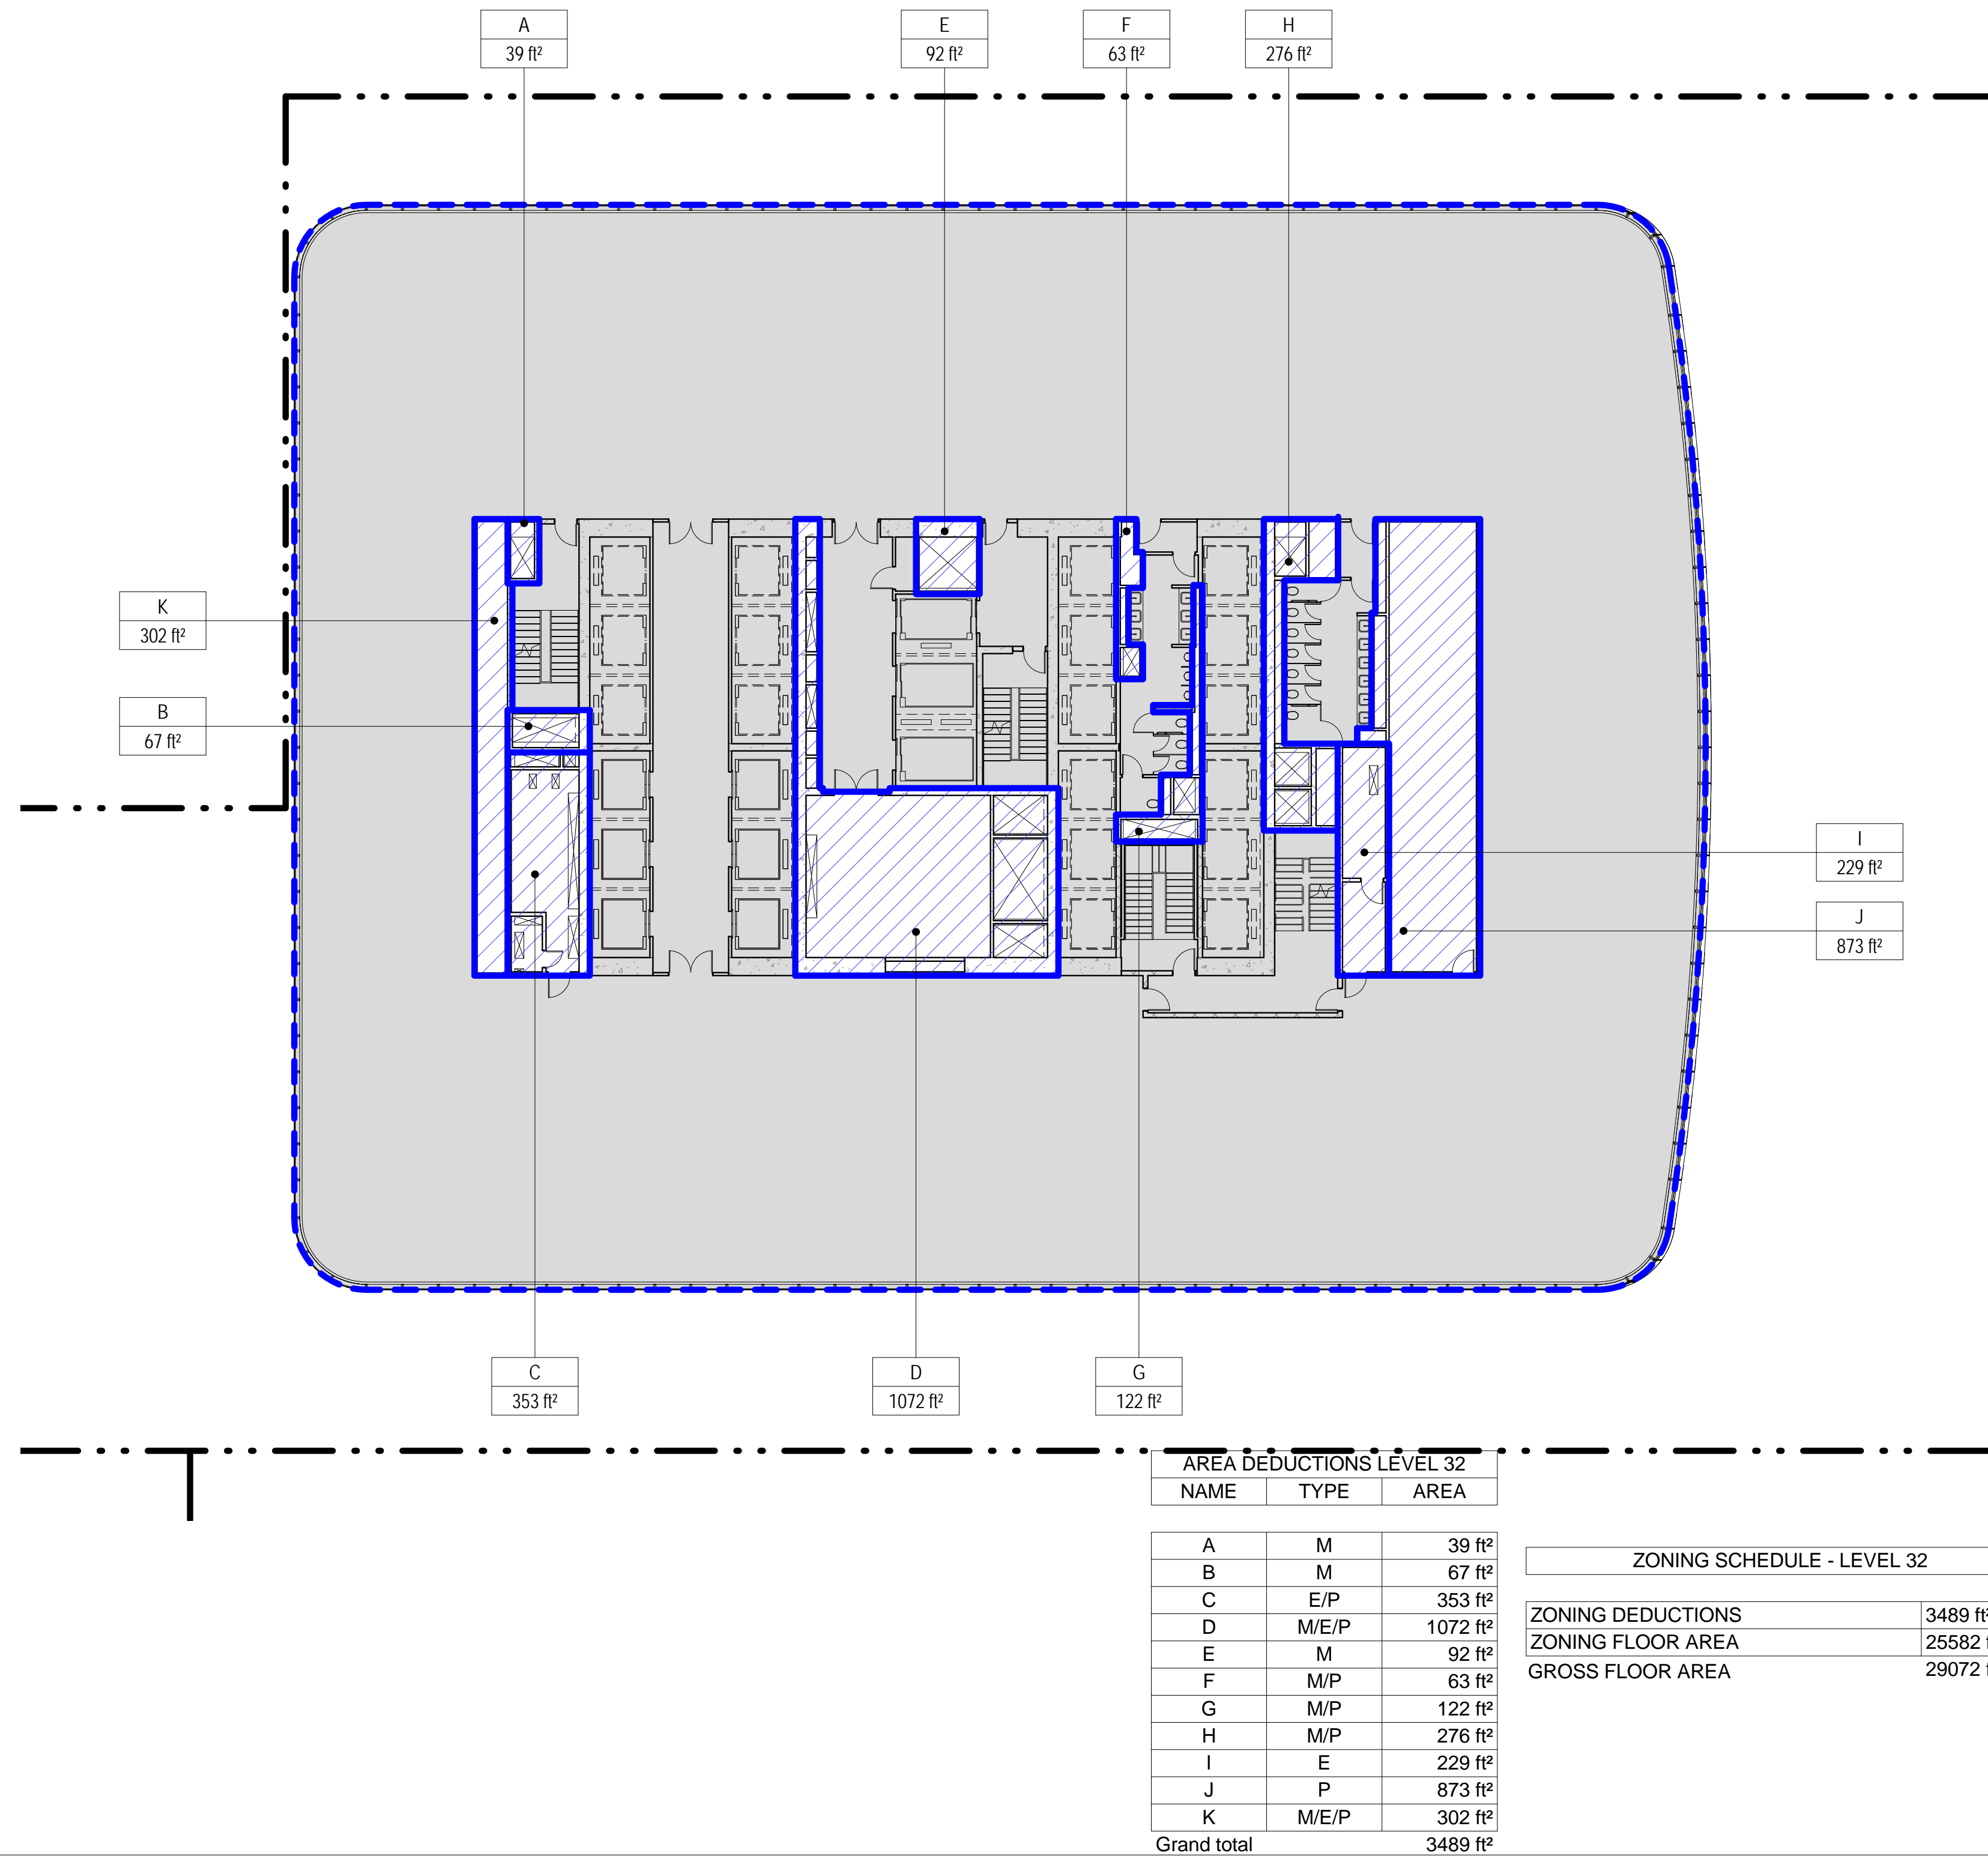
3 LEVEL 31 PLAN

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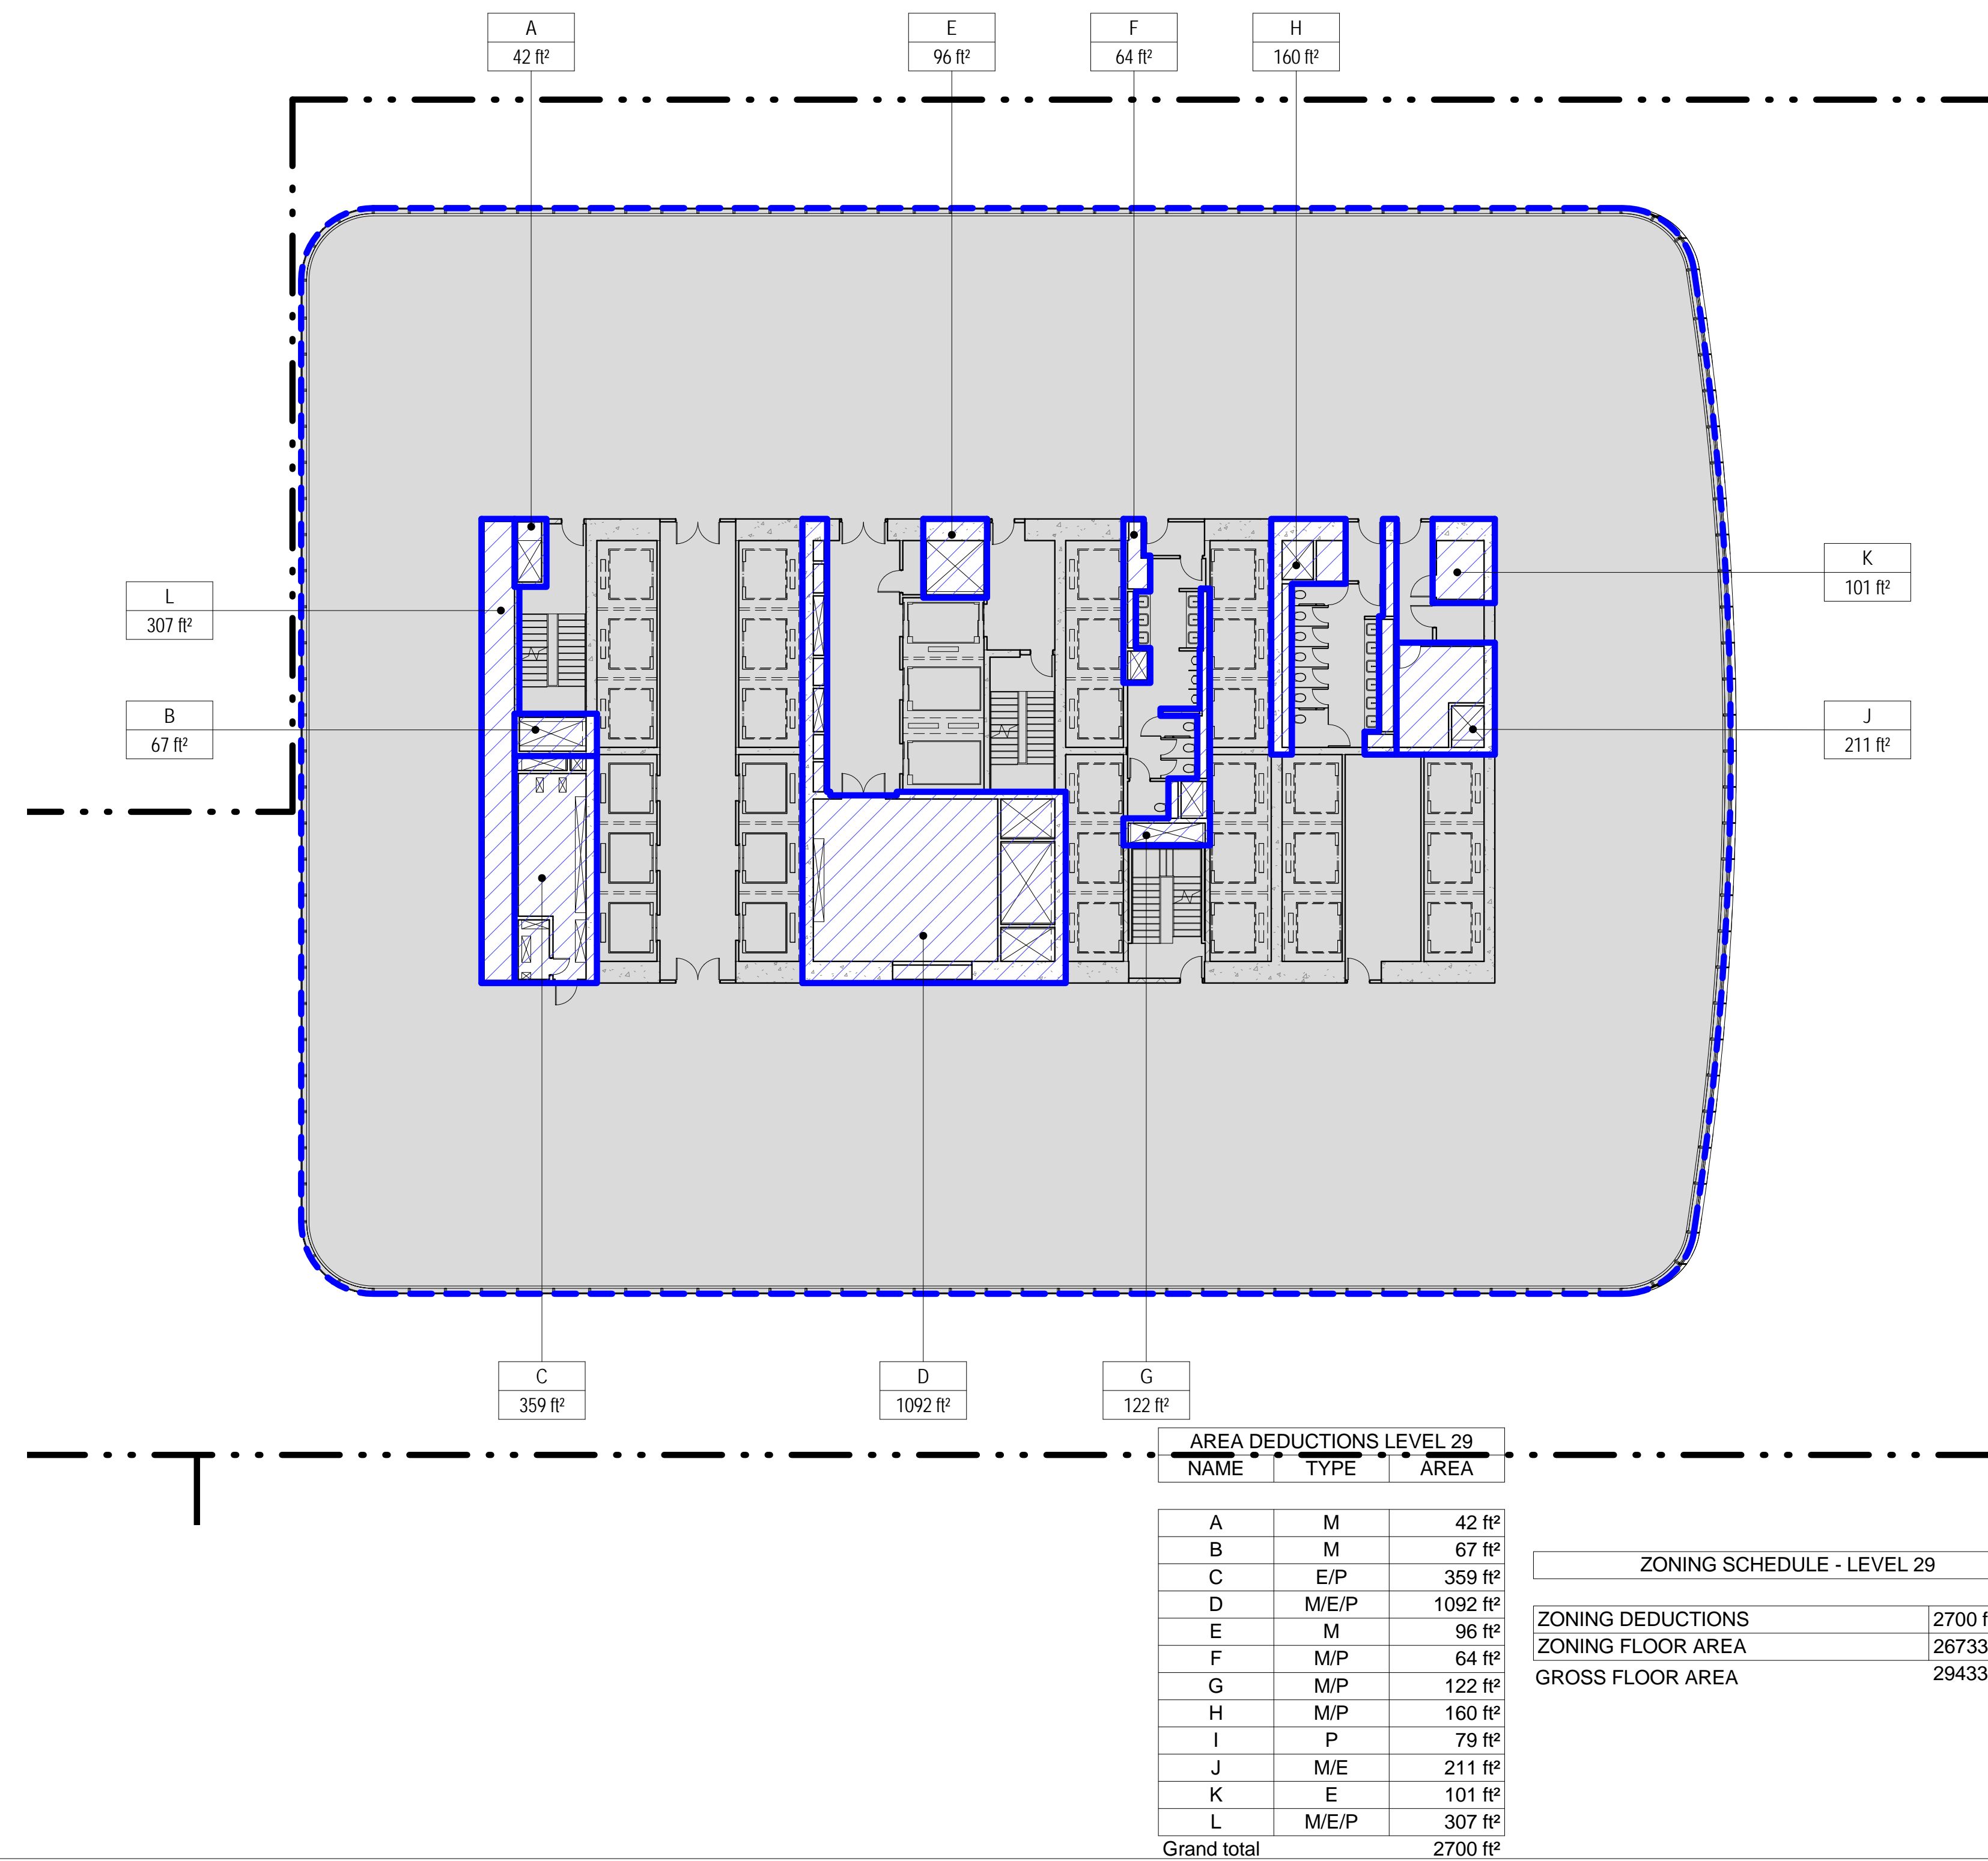
4 LEVEL 32 PLAN

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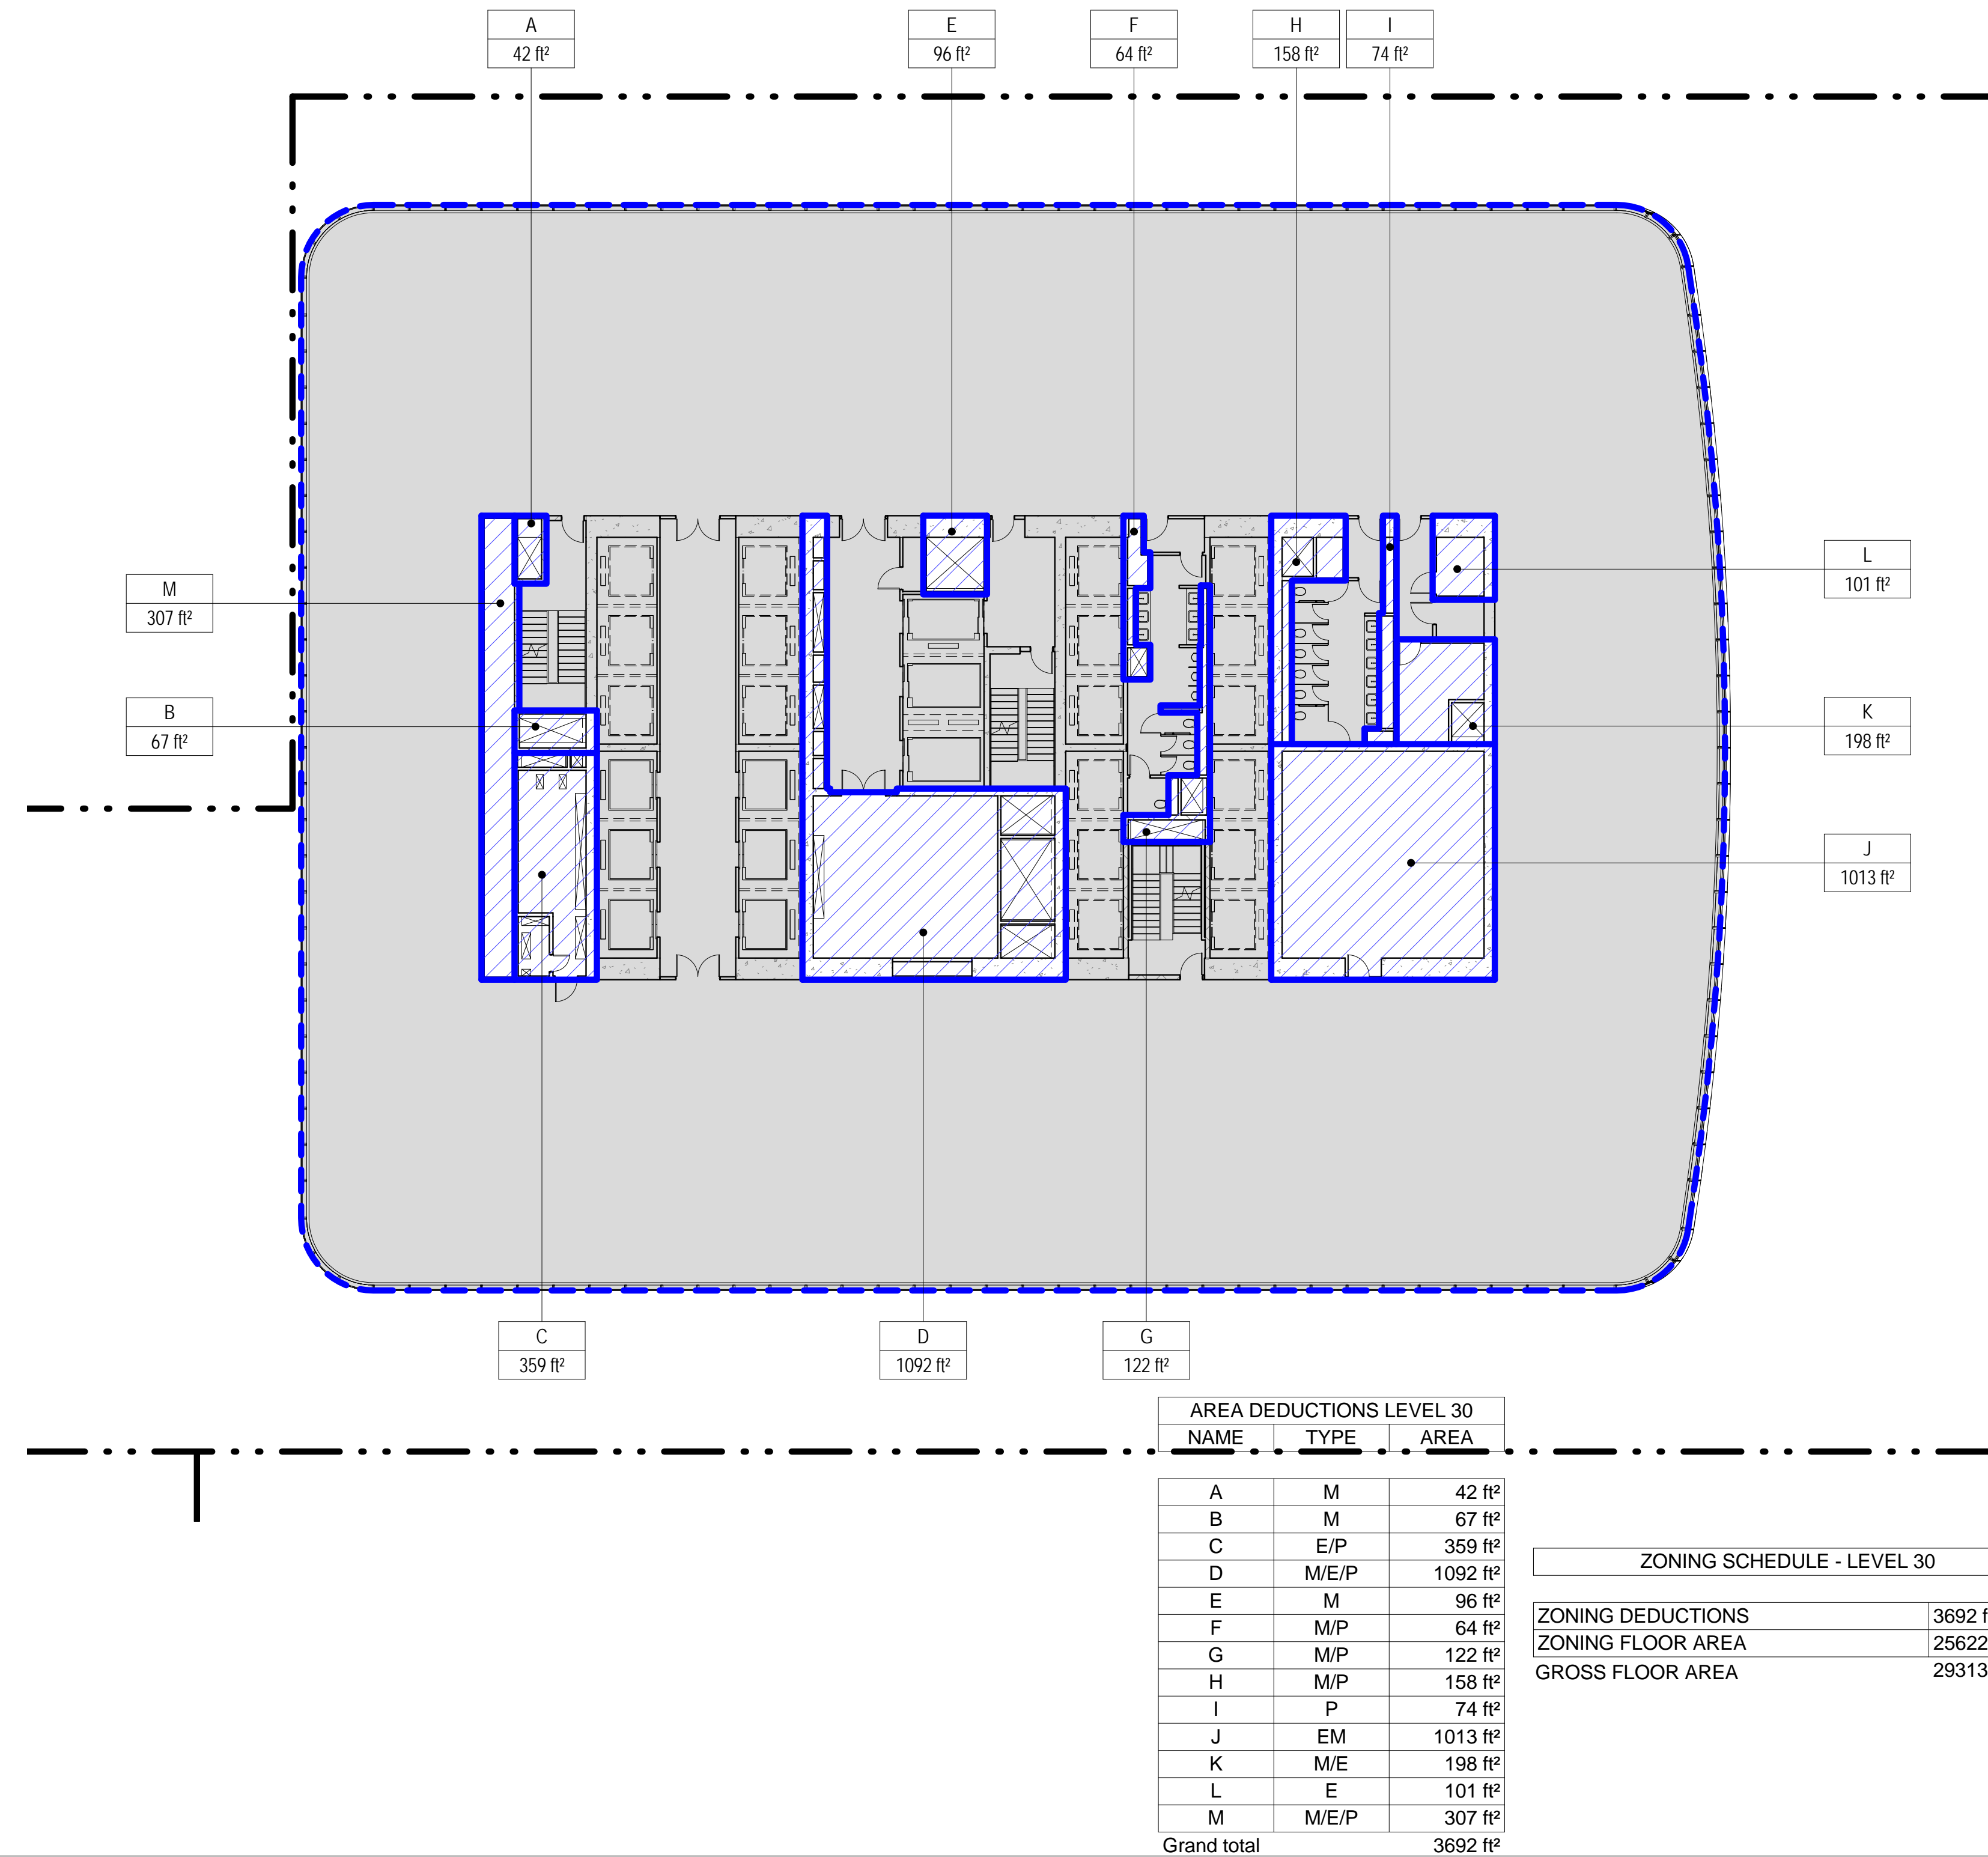
1 LEVEL 29 PLAN

SCALE: 1/16" = 1'-0"



2 LEVEL 30 PLAN

SCALE: 1/16" = 1'-0"



ZONING LEGENDS

- GROSS BUILDING AREA
- ZONING AREA DEDUCTIONS
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- RETAIL
- MR MECHANICAL ROOM
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MANHATTAN WEST: NORTH TOWER

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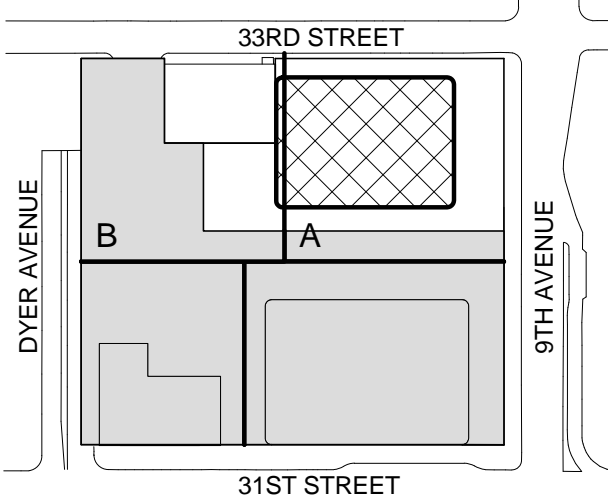
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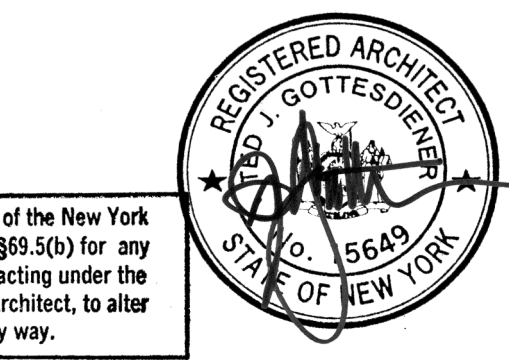
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ZONING FLOOR AREA DEDUCTIONS - LEVEL 29-32

Project No.:

207150

Date:

20 JUN 2014

Scale:

1/16" = 1'-0"

File No.:

Z-111

B-SCAN Sheet No.:

Z-111.00

Sheet No.:

Z-111


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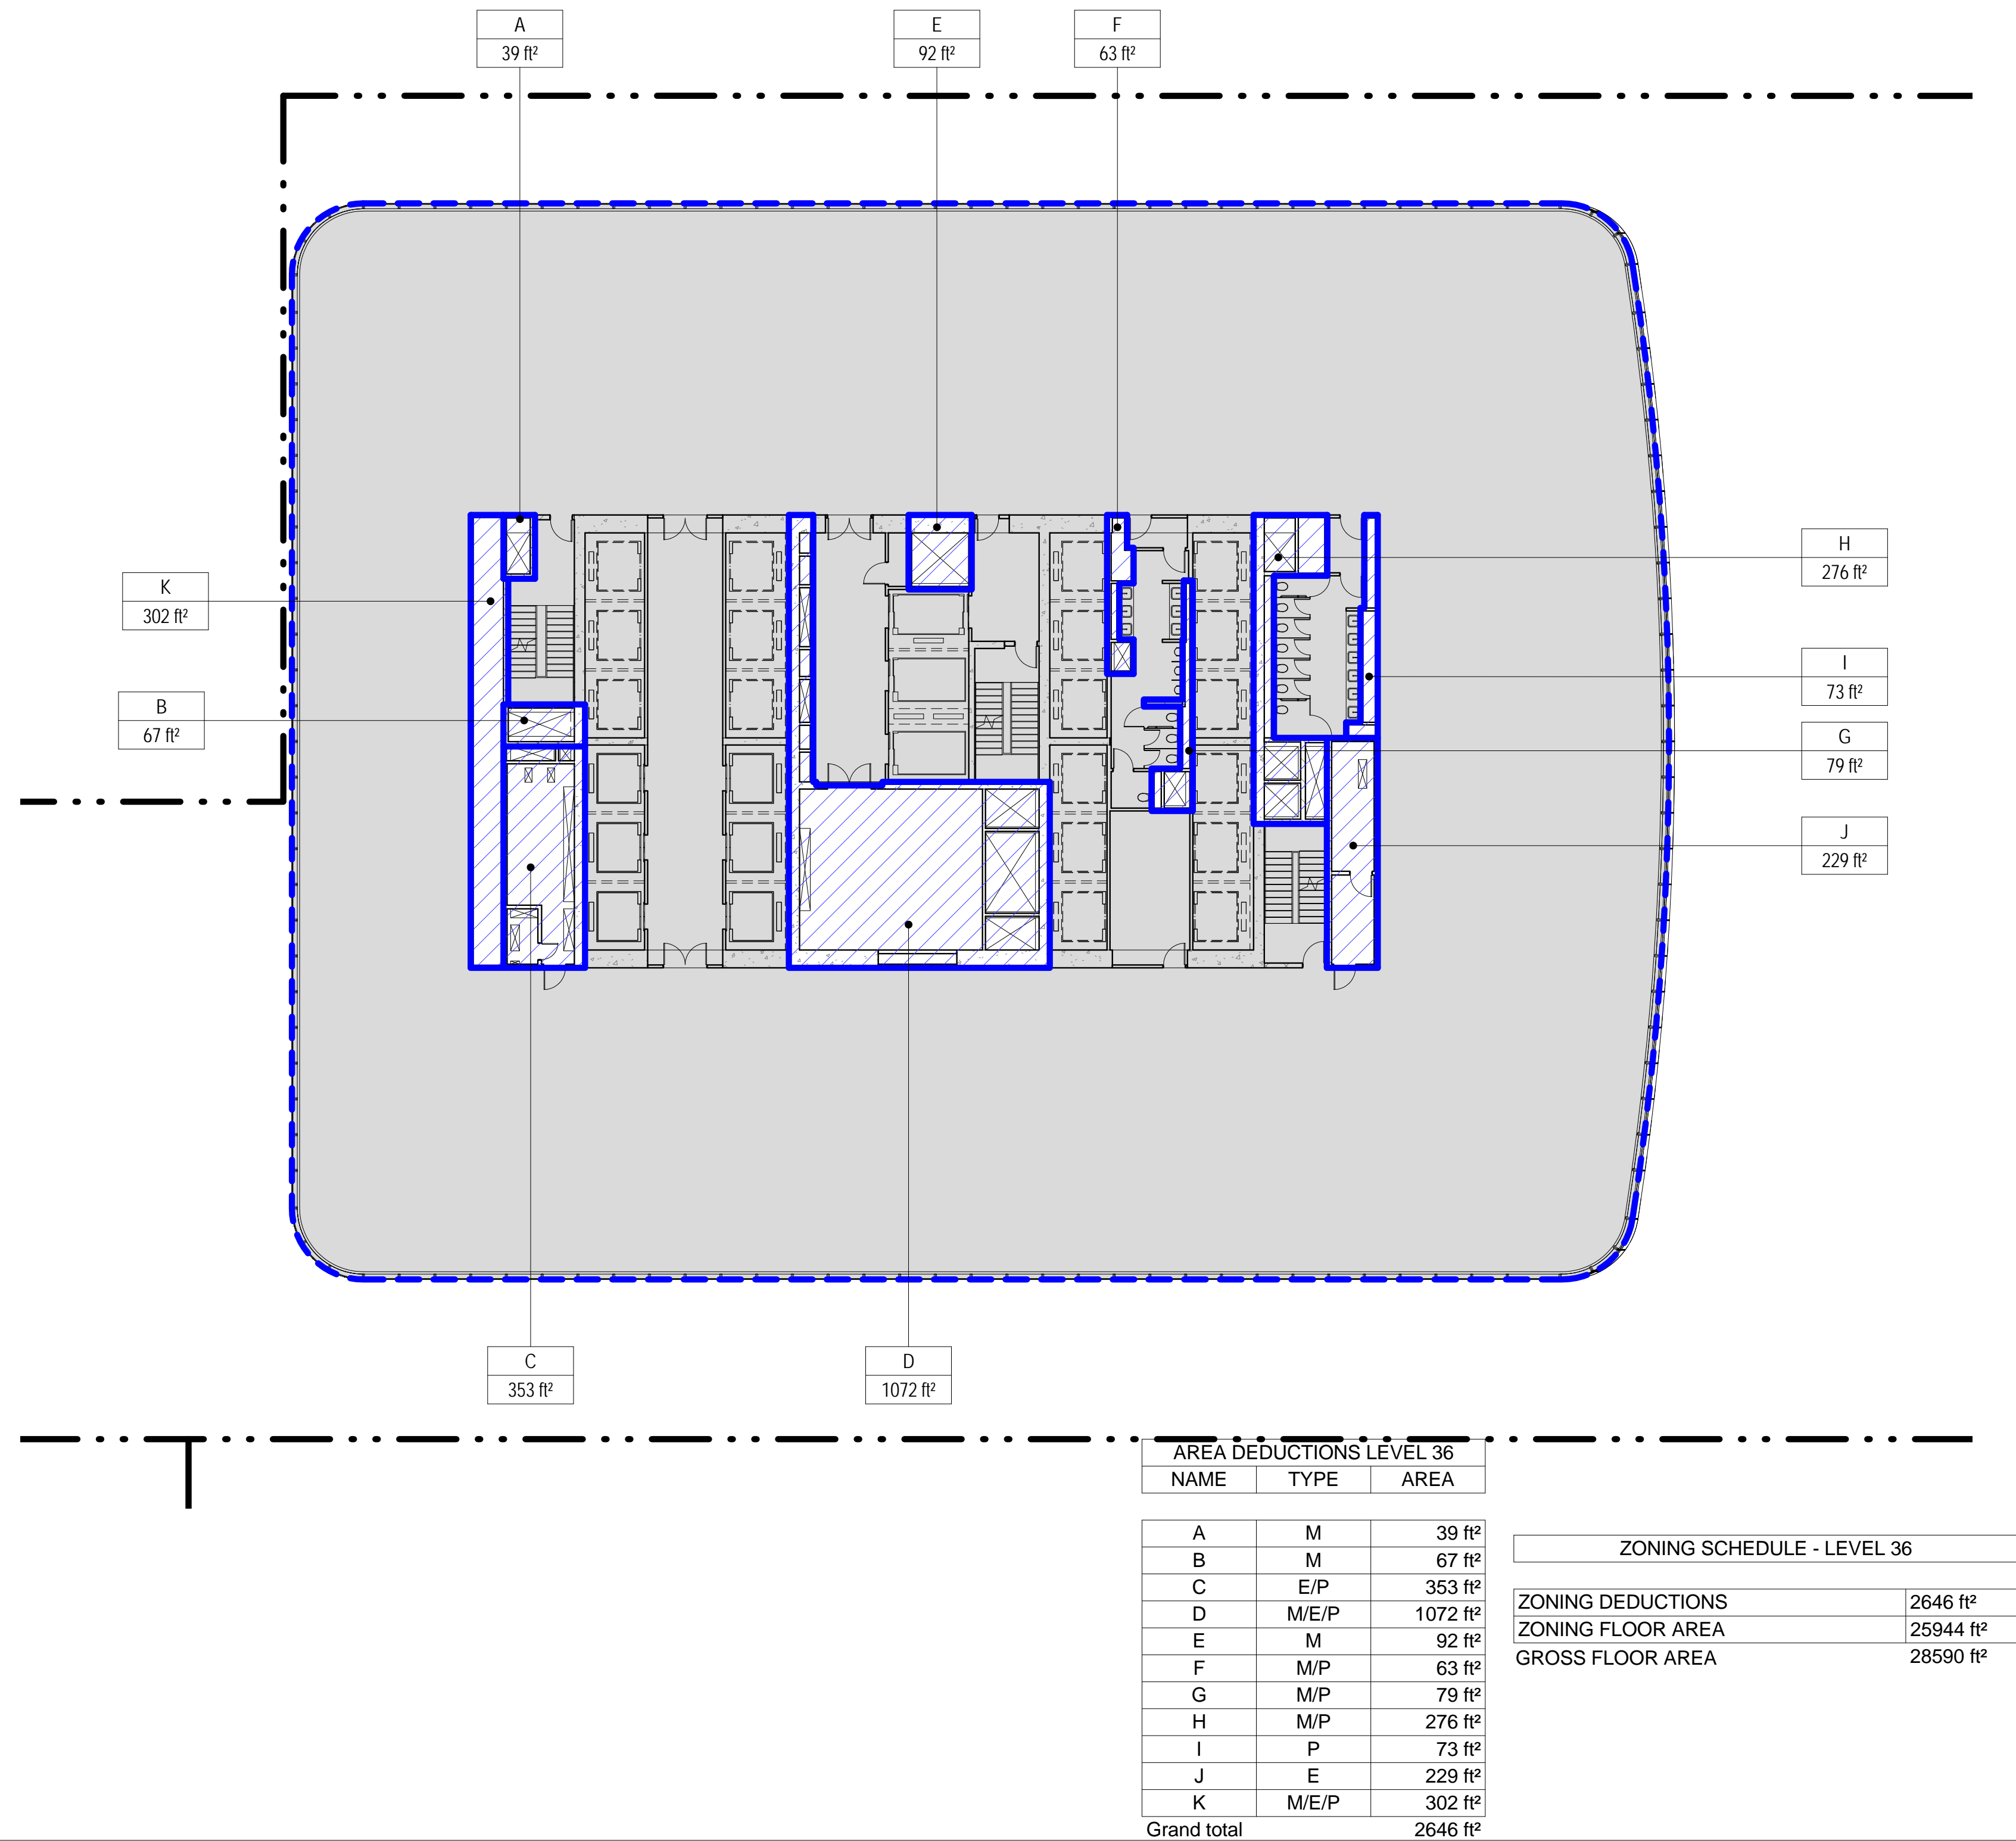
3 LEVEL 35 PLAN

SCALE: 1/16" = 1'-0"




4 LEVEL 36 PLAN

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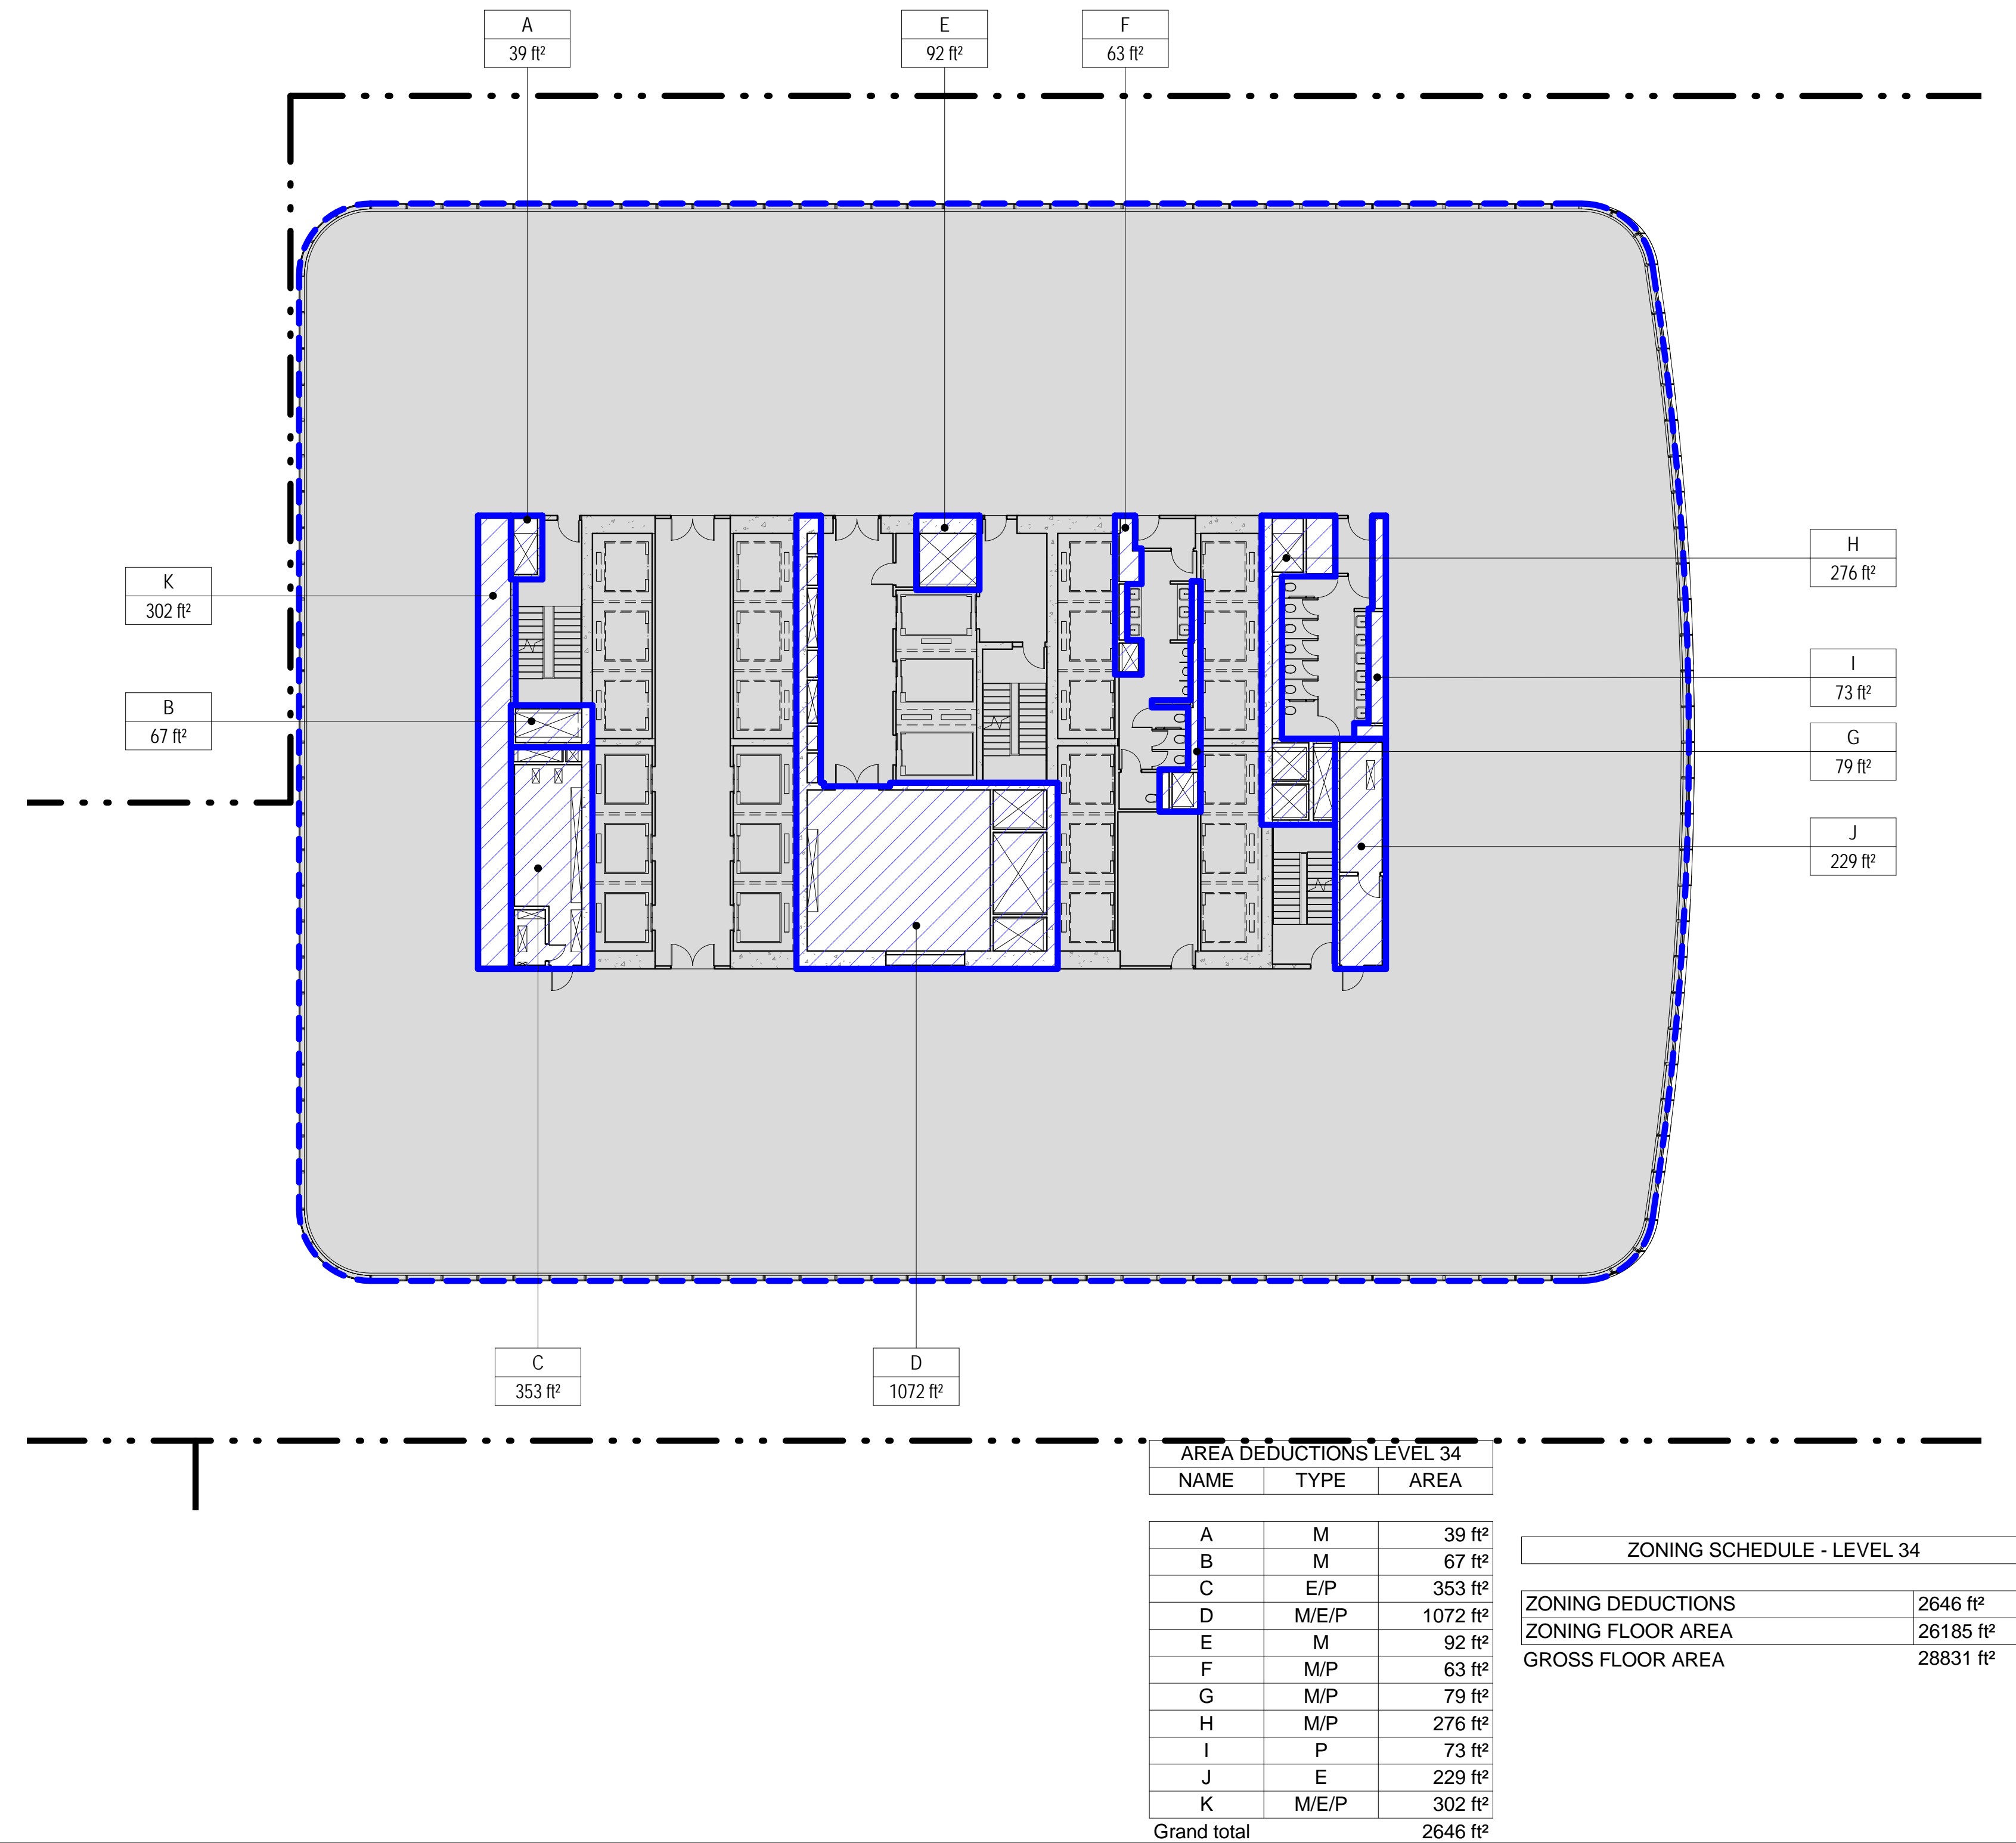
1 LEVEL 33 PLAN

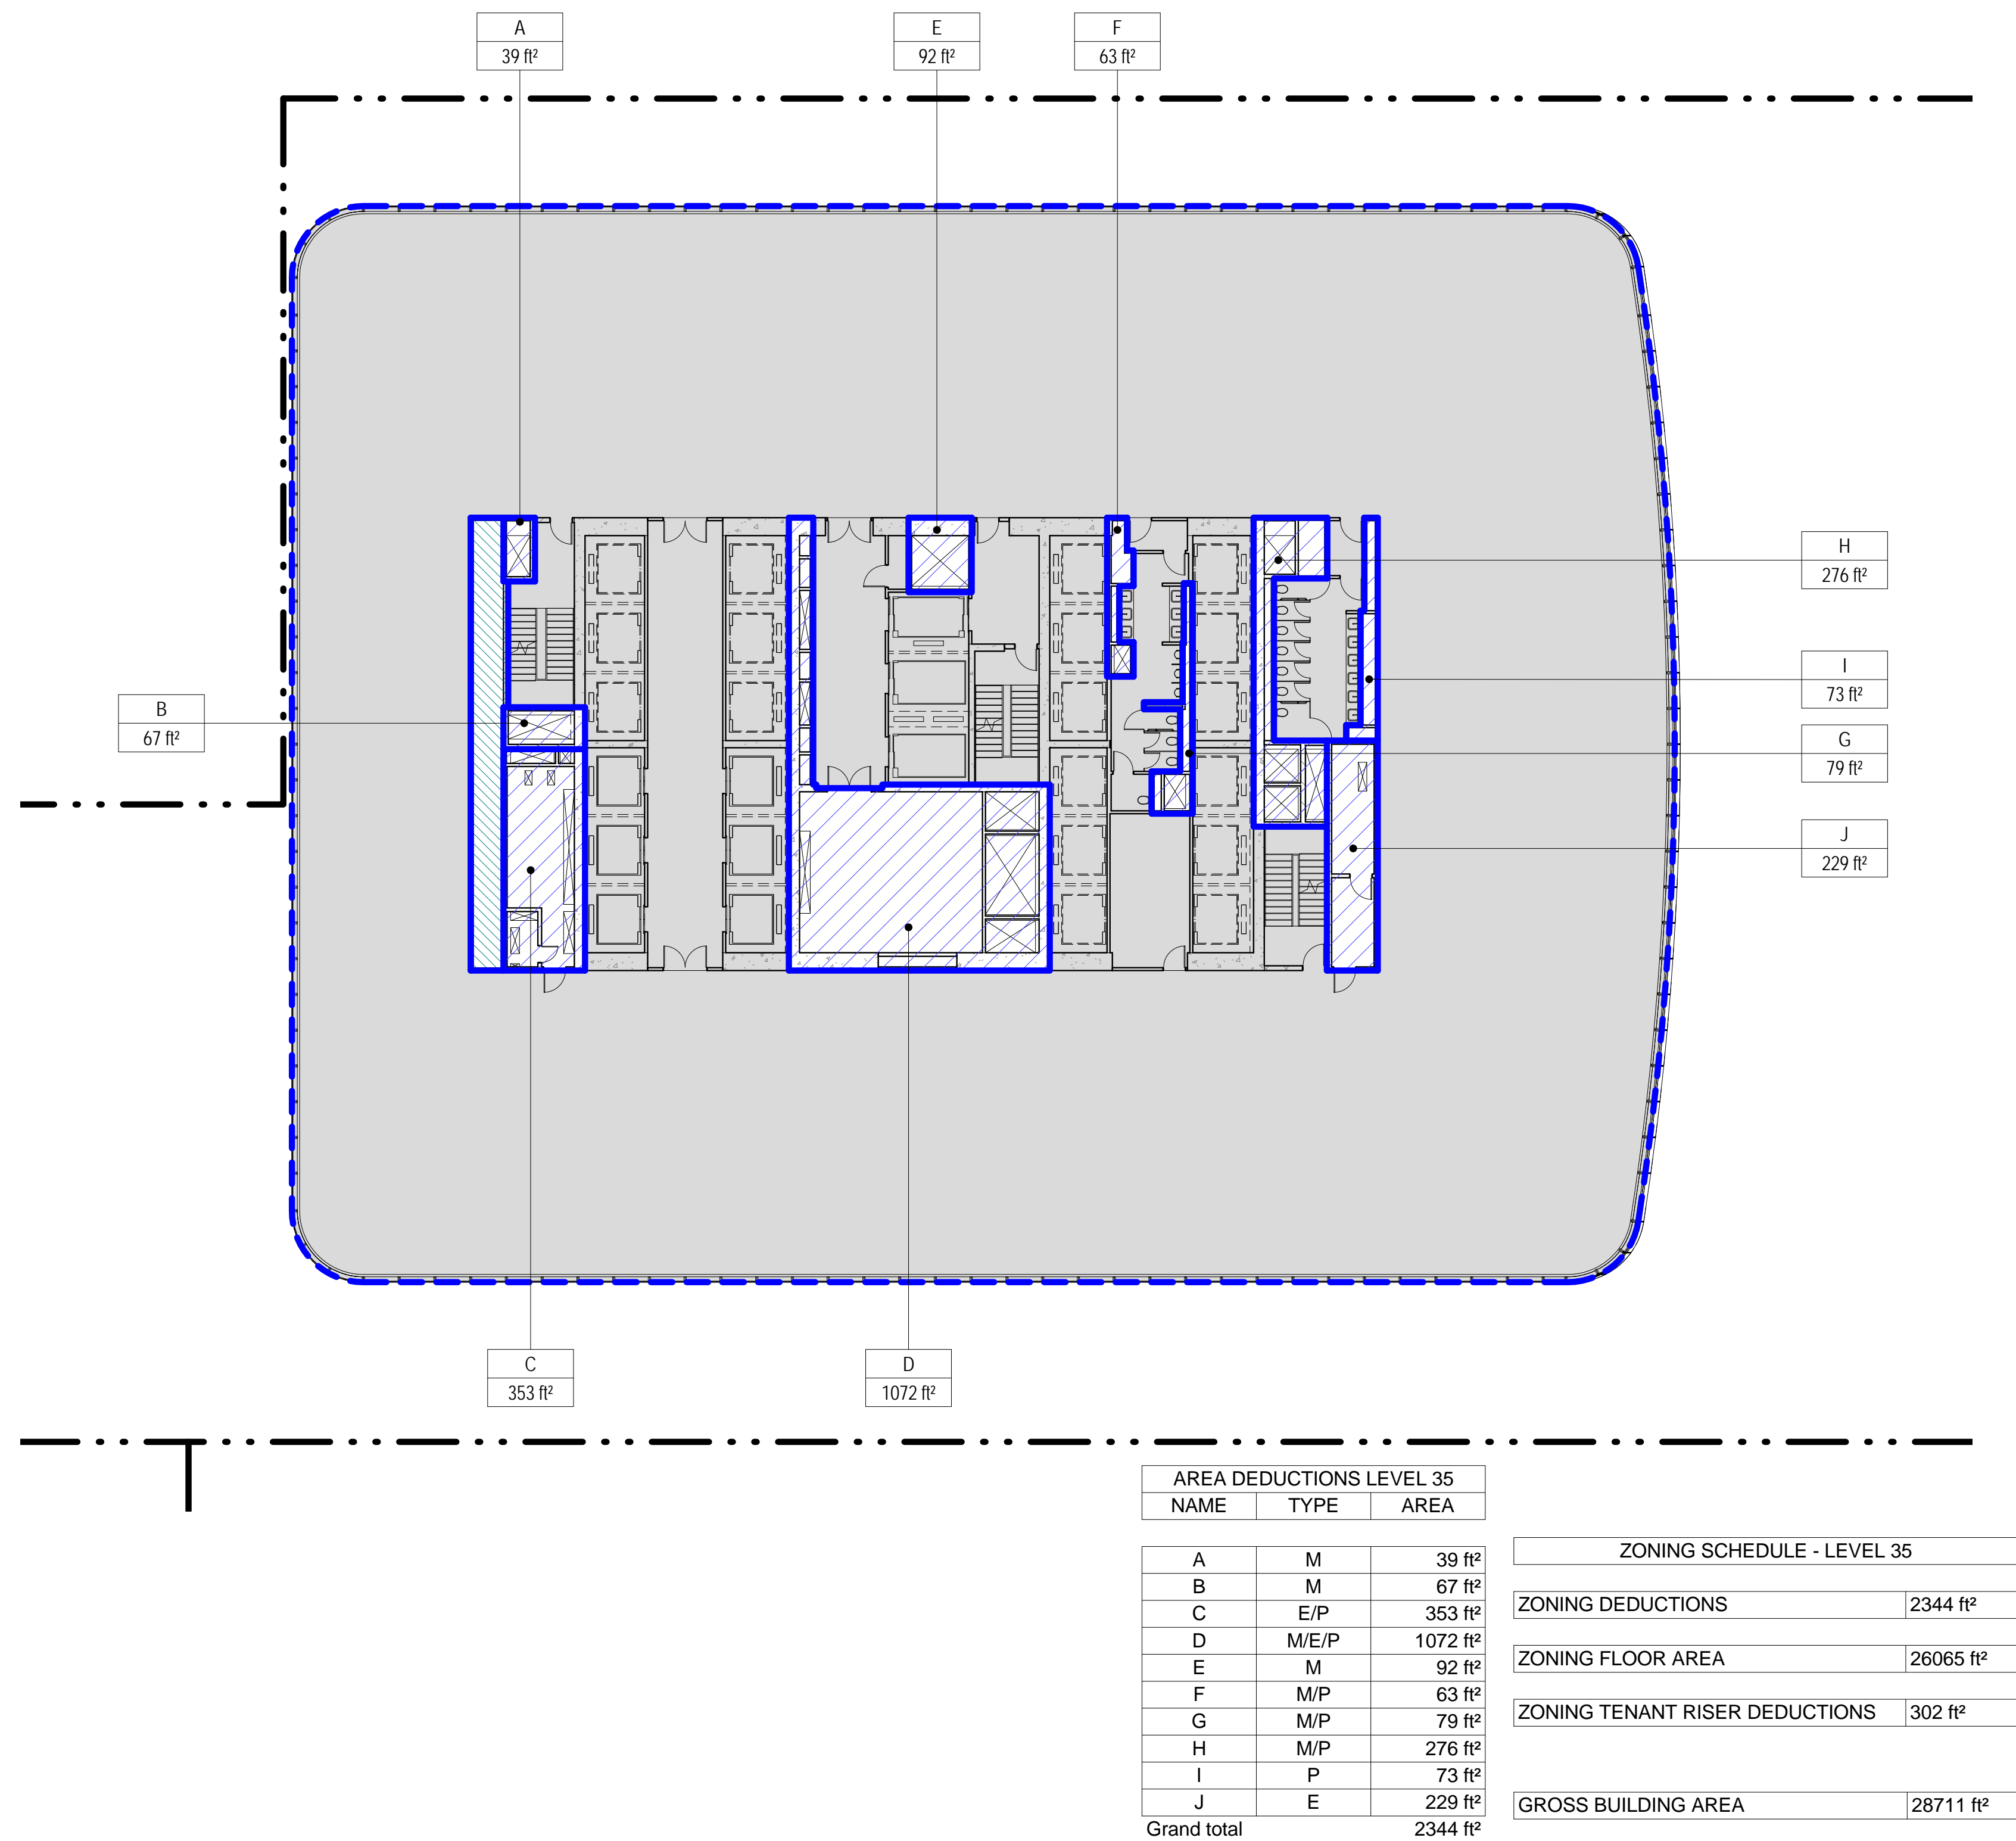SCALE: 1/16" = 1'-0"



2 LEVEL 34 PLAN

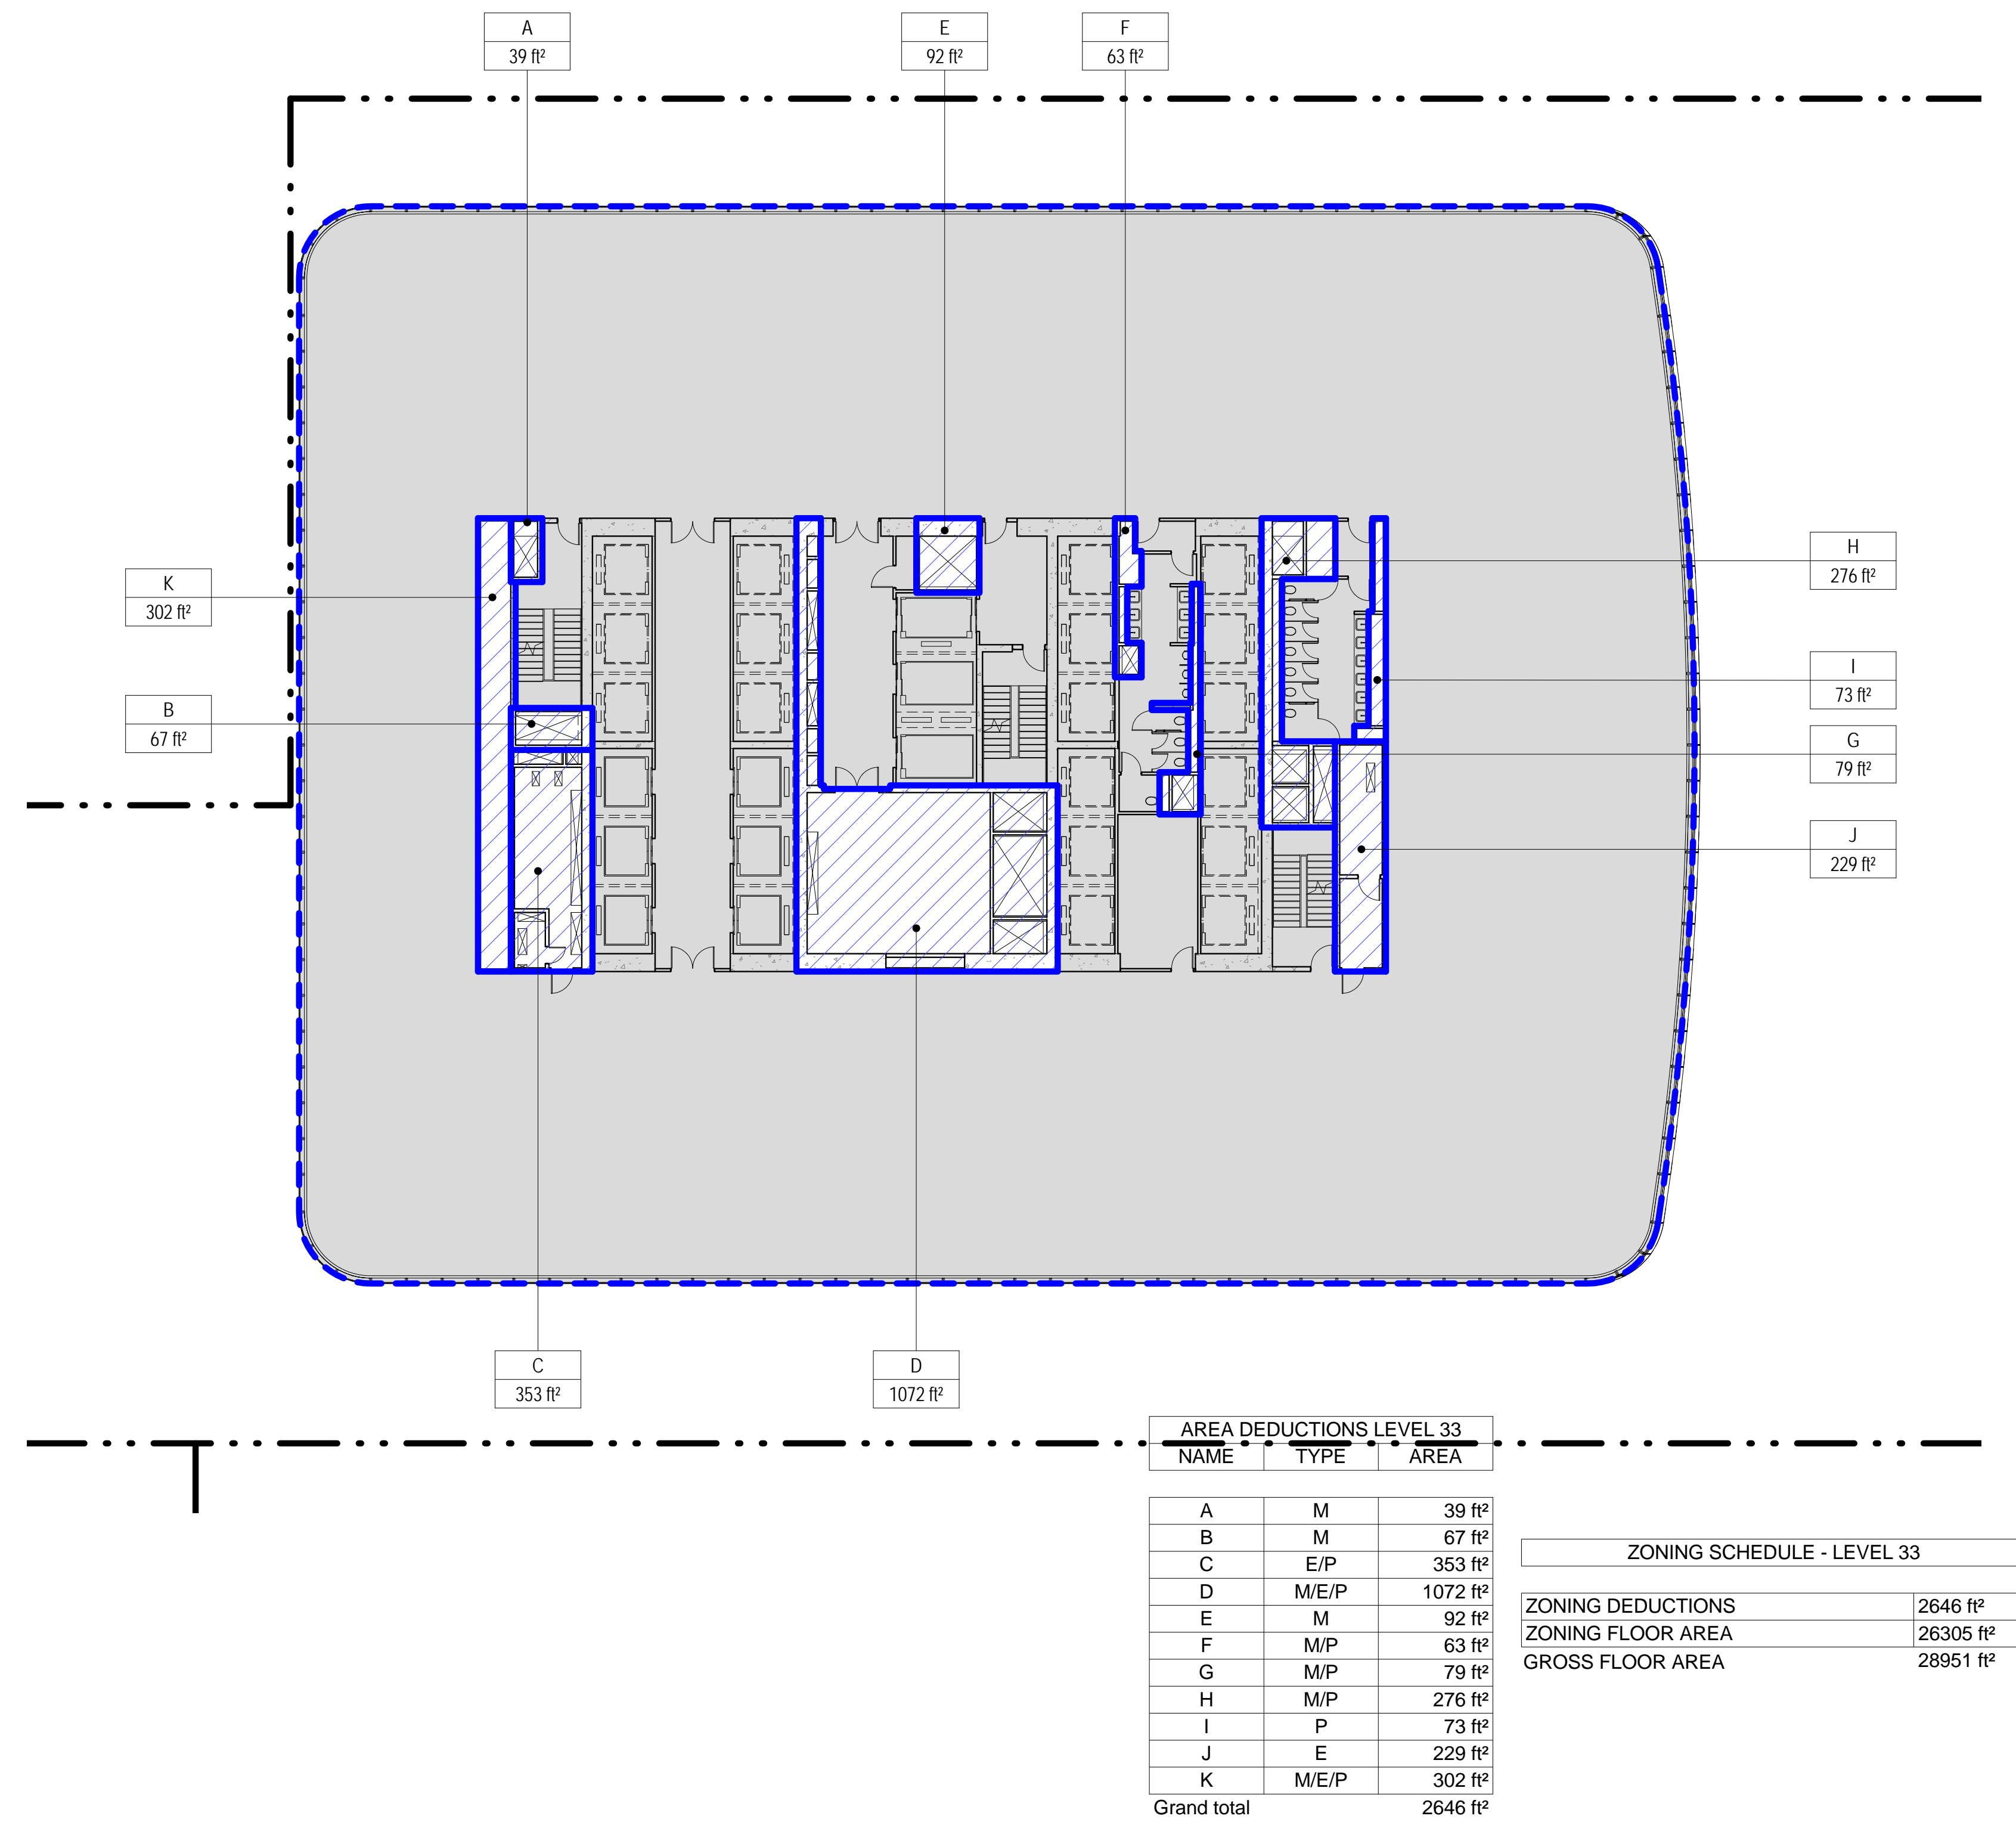SCALE: 1/16" = 1'-0"



ZONING LEGENDS

- GROSS BUILDING AREA
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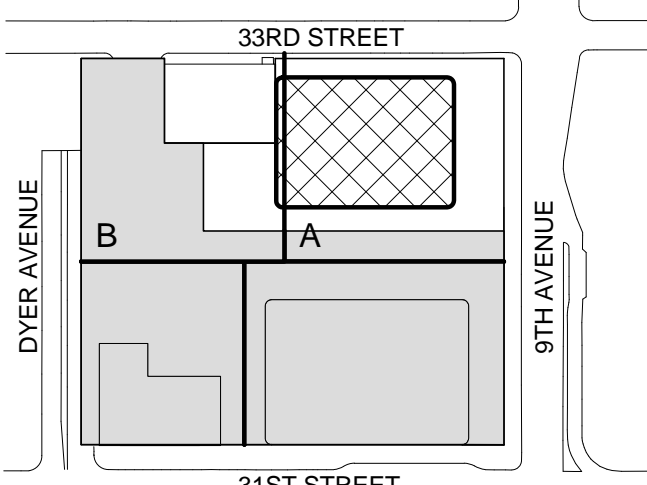
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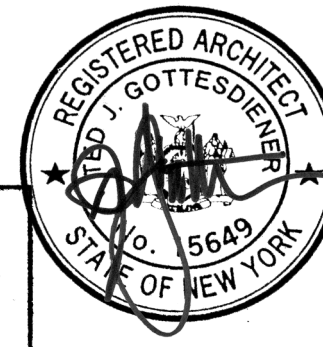
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ZONING FLOOR
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LEVEL 33-36

Project No.:

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Date:

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2-112

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Sheet No.:

Z-112


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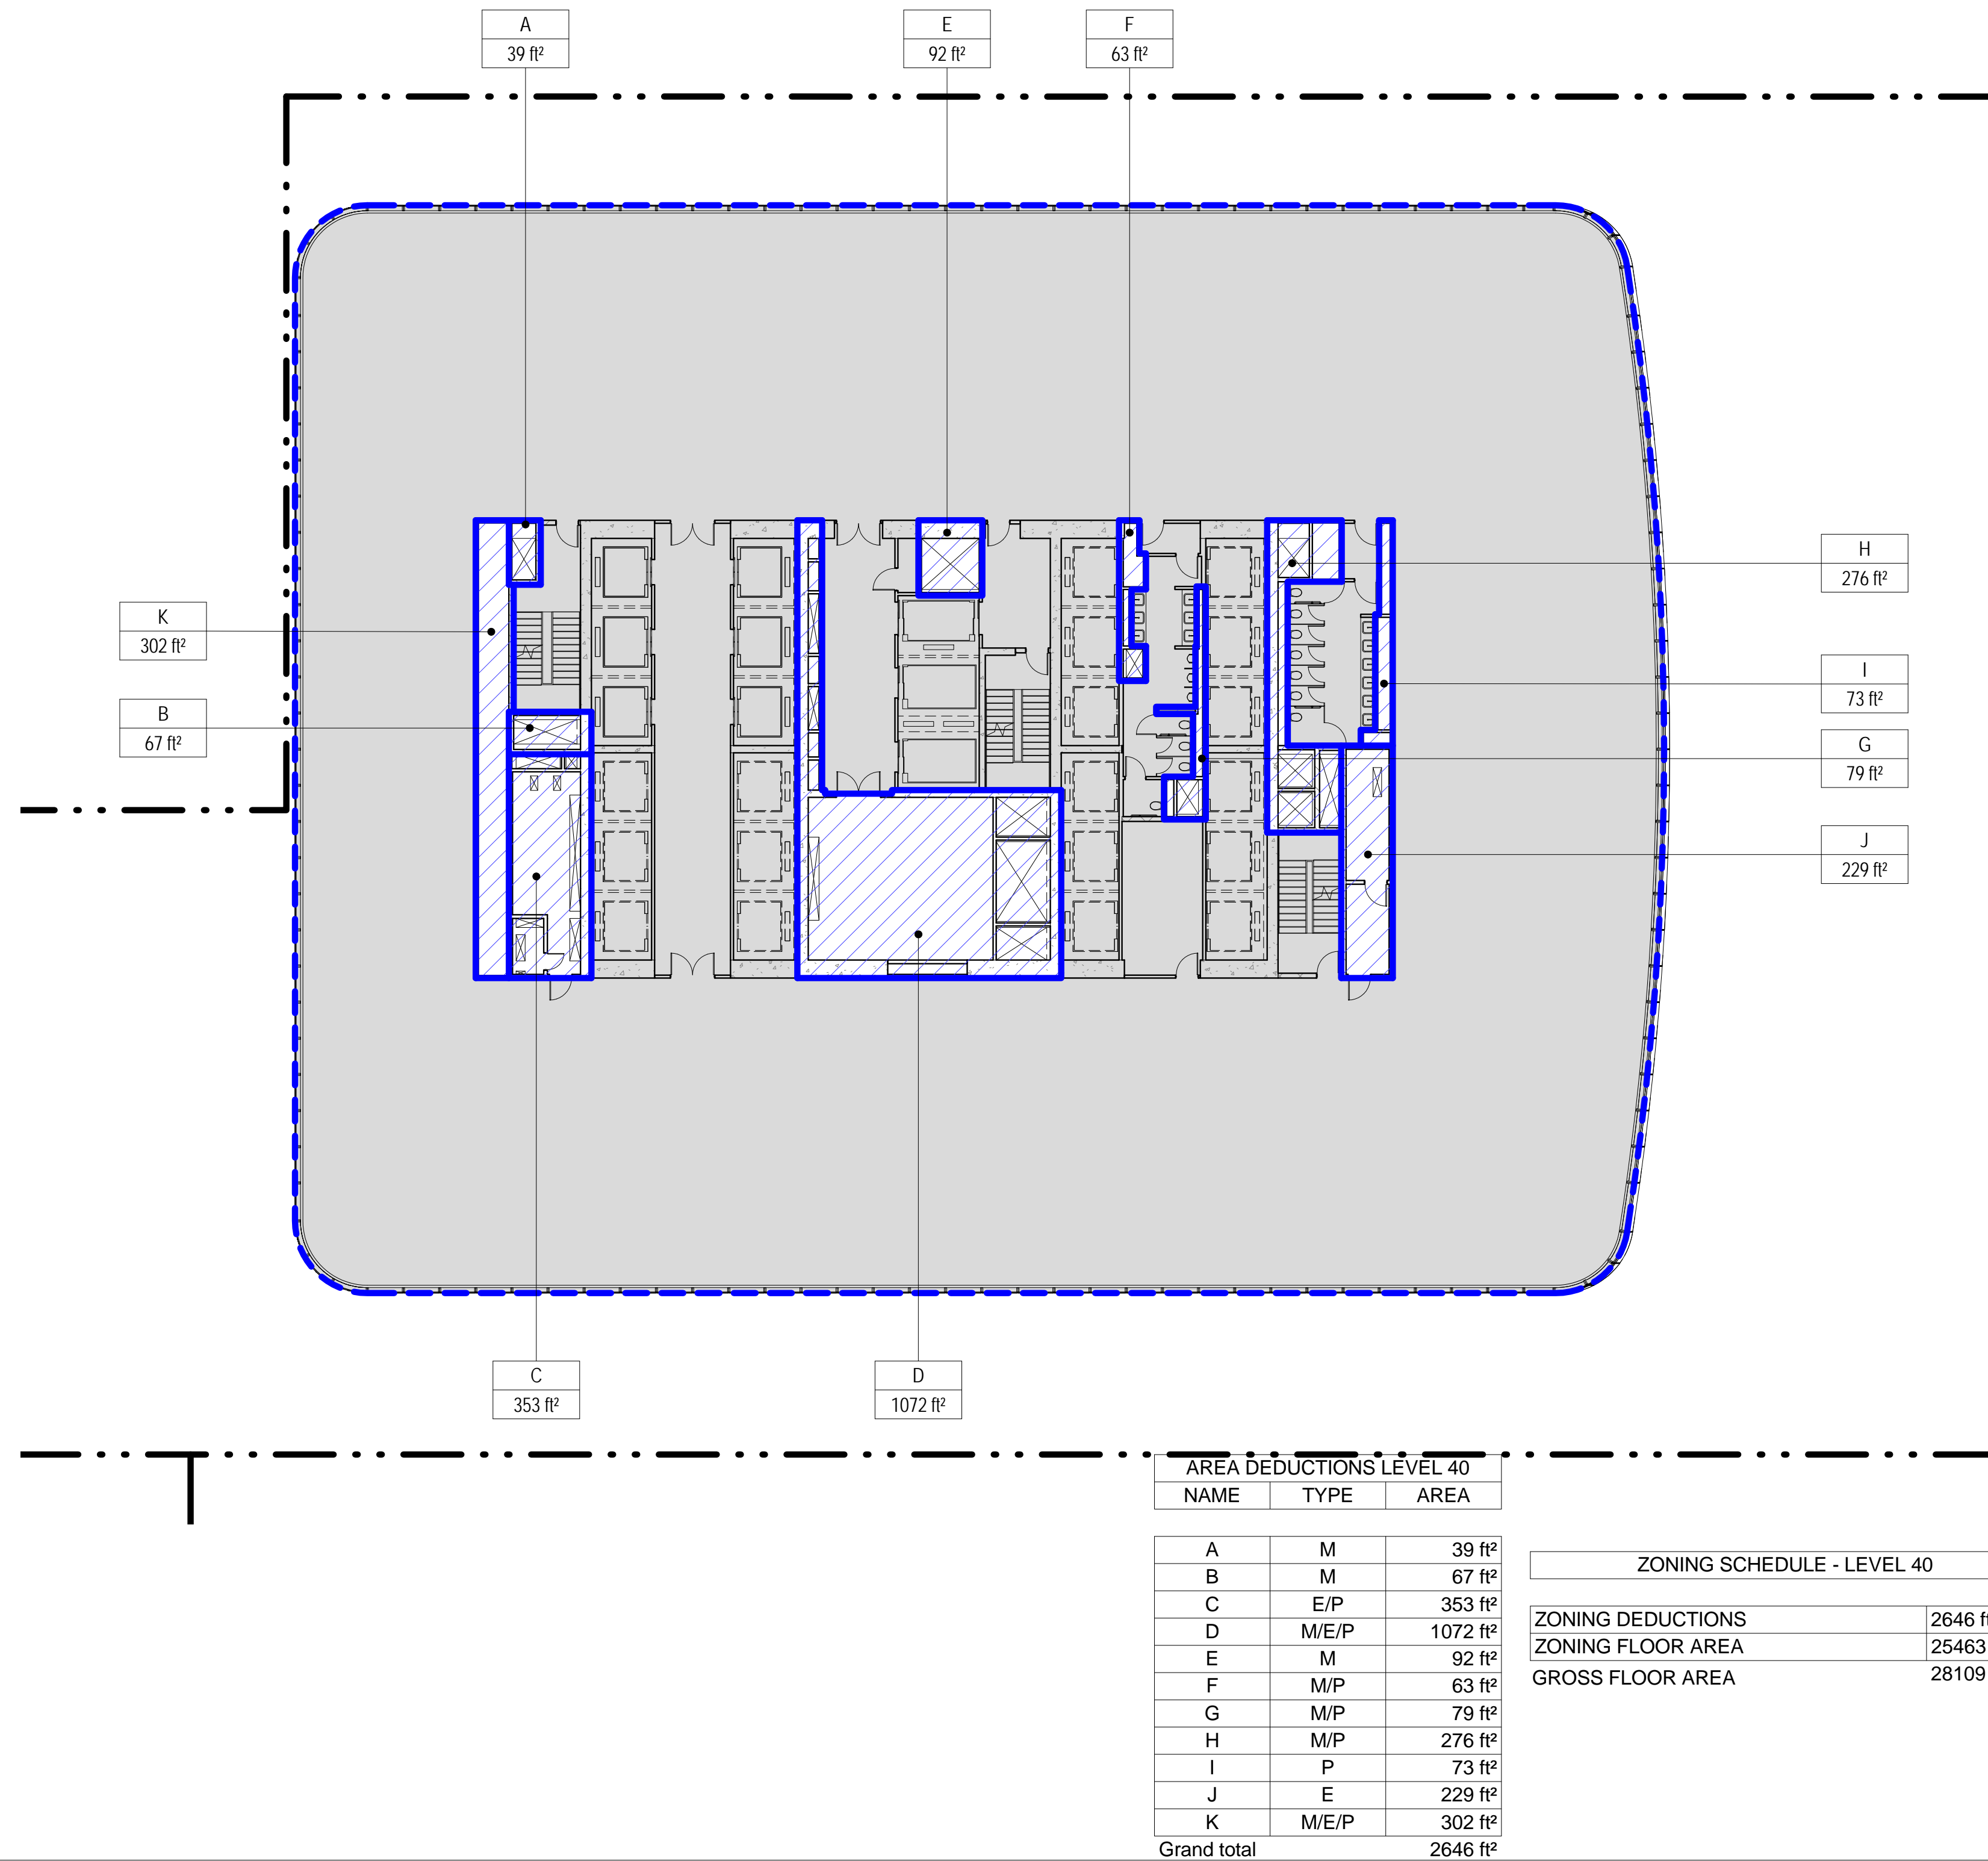
3 LEVEL 39 PLAN

SCALE: 1/16" = 1'-0"




4 LEVEL 40 PLAN

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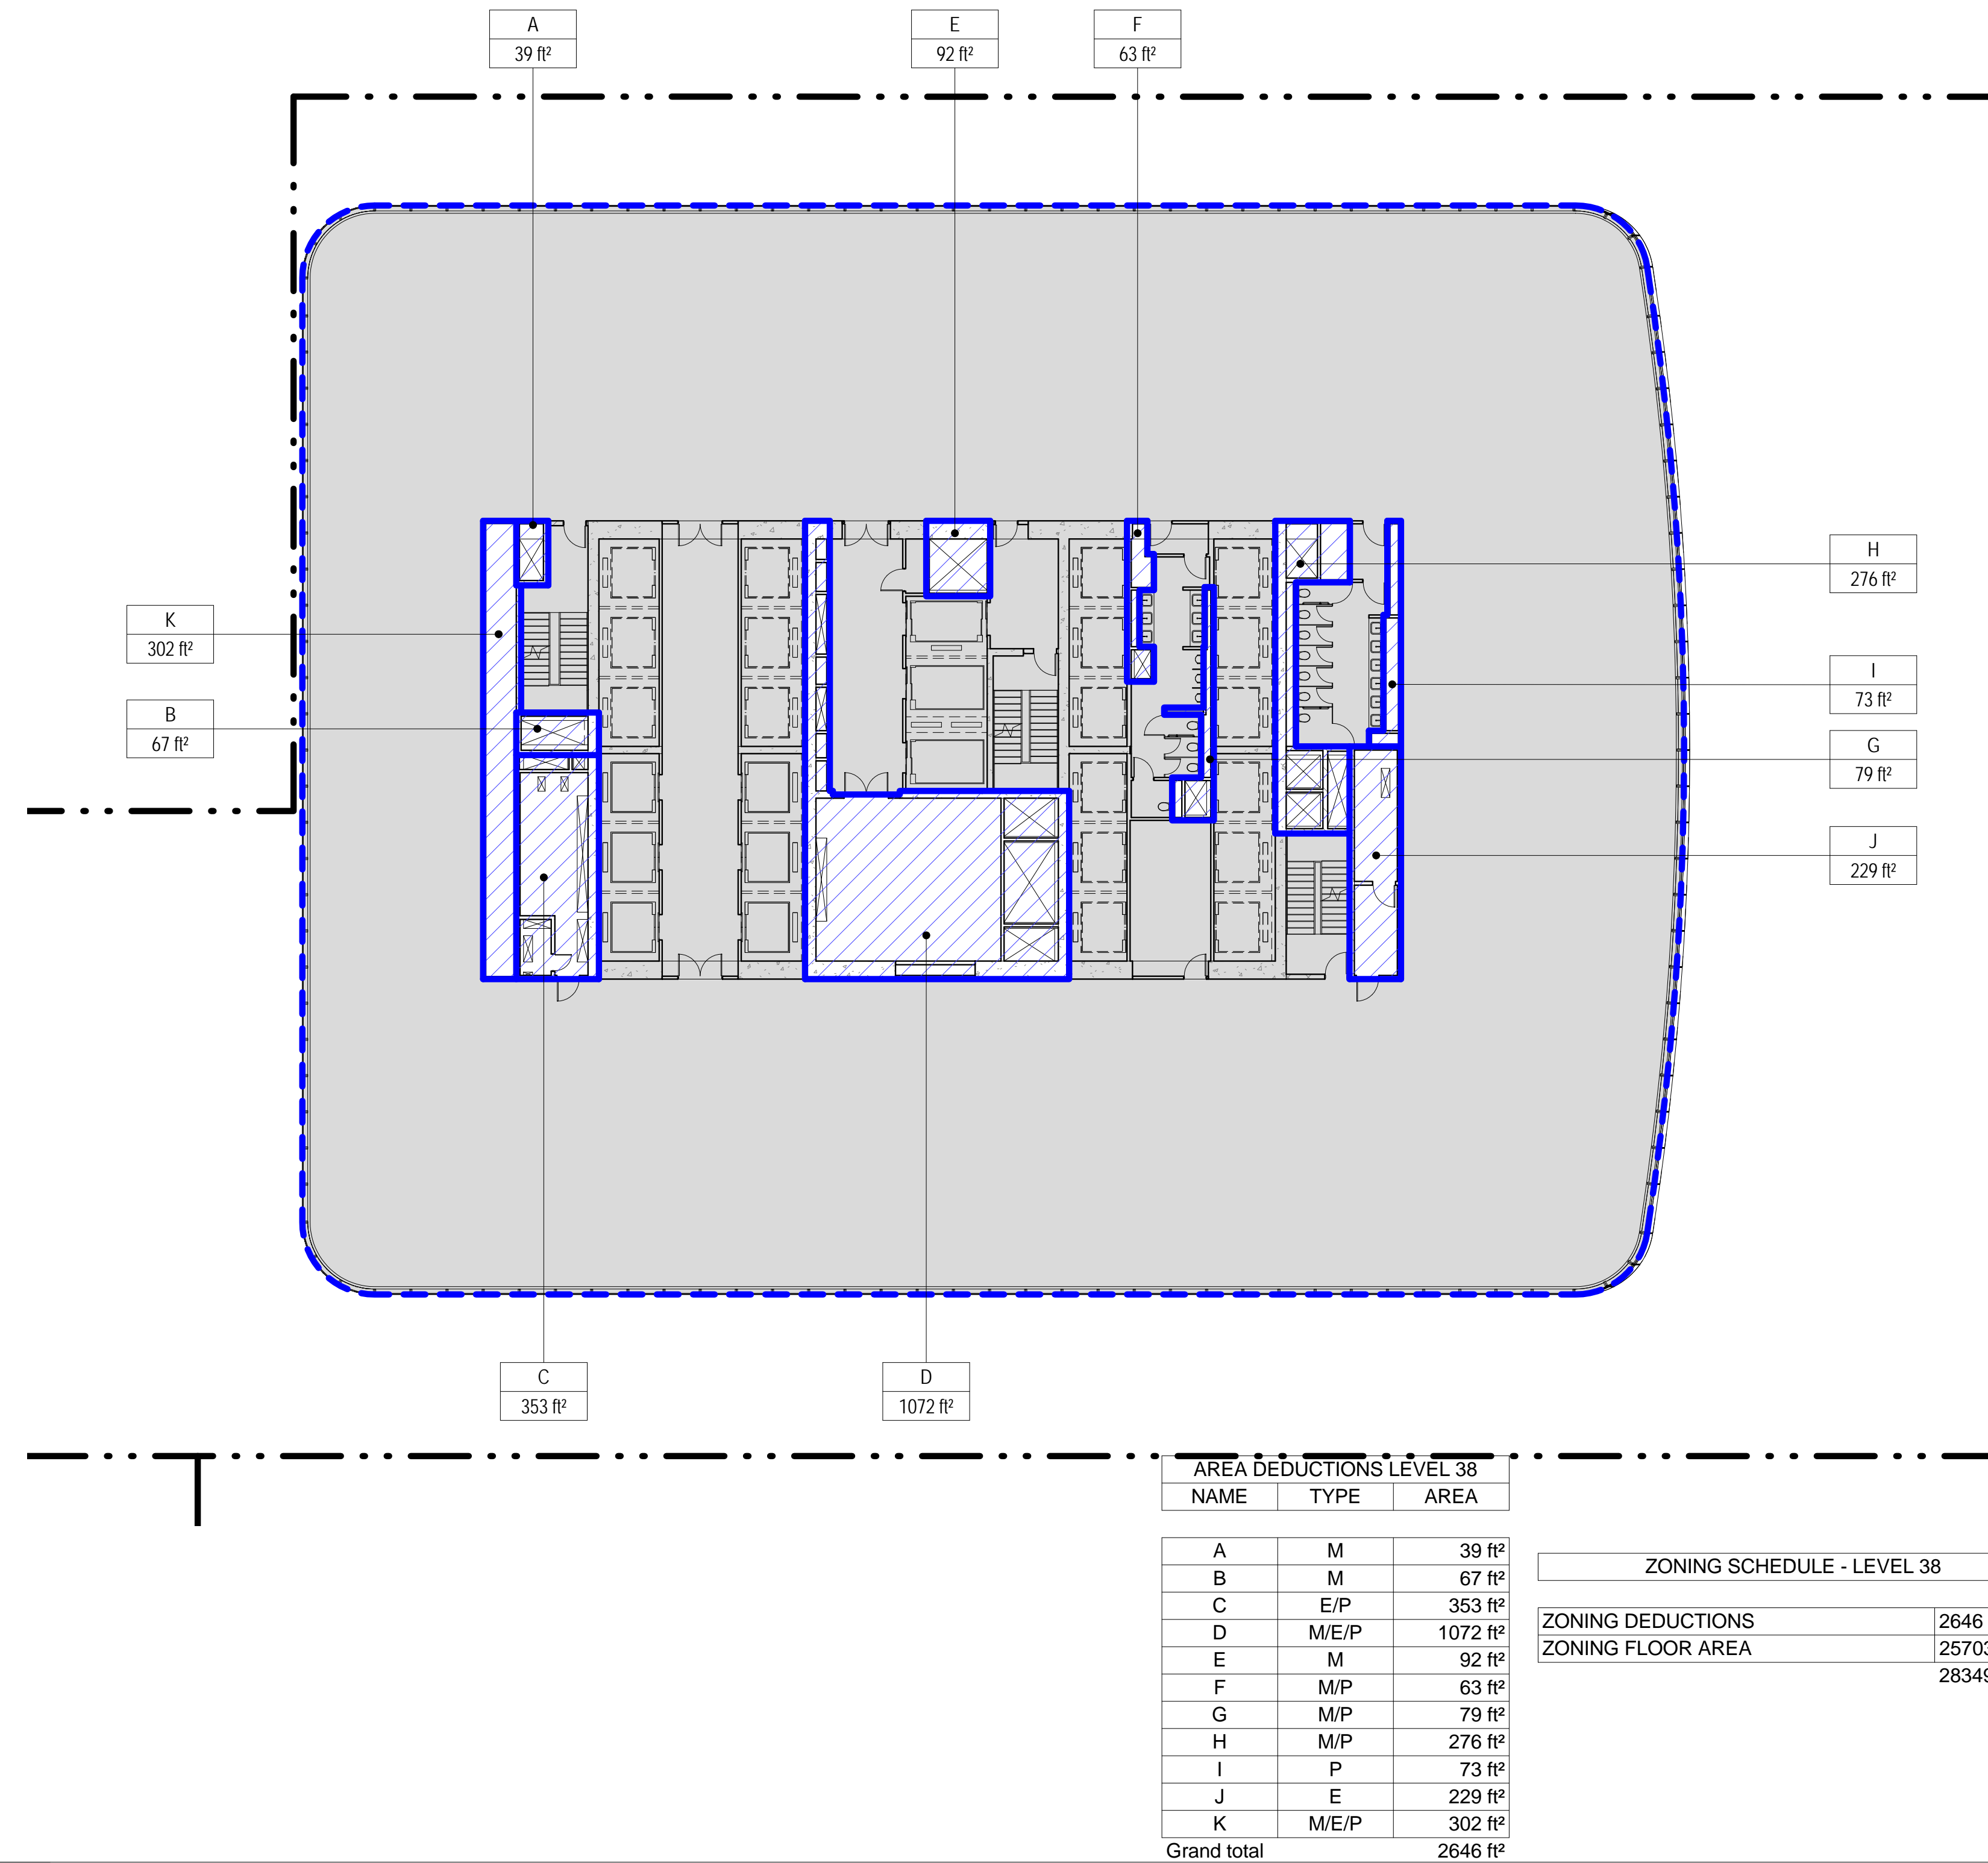
1 LEVEL 37 PLAN

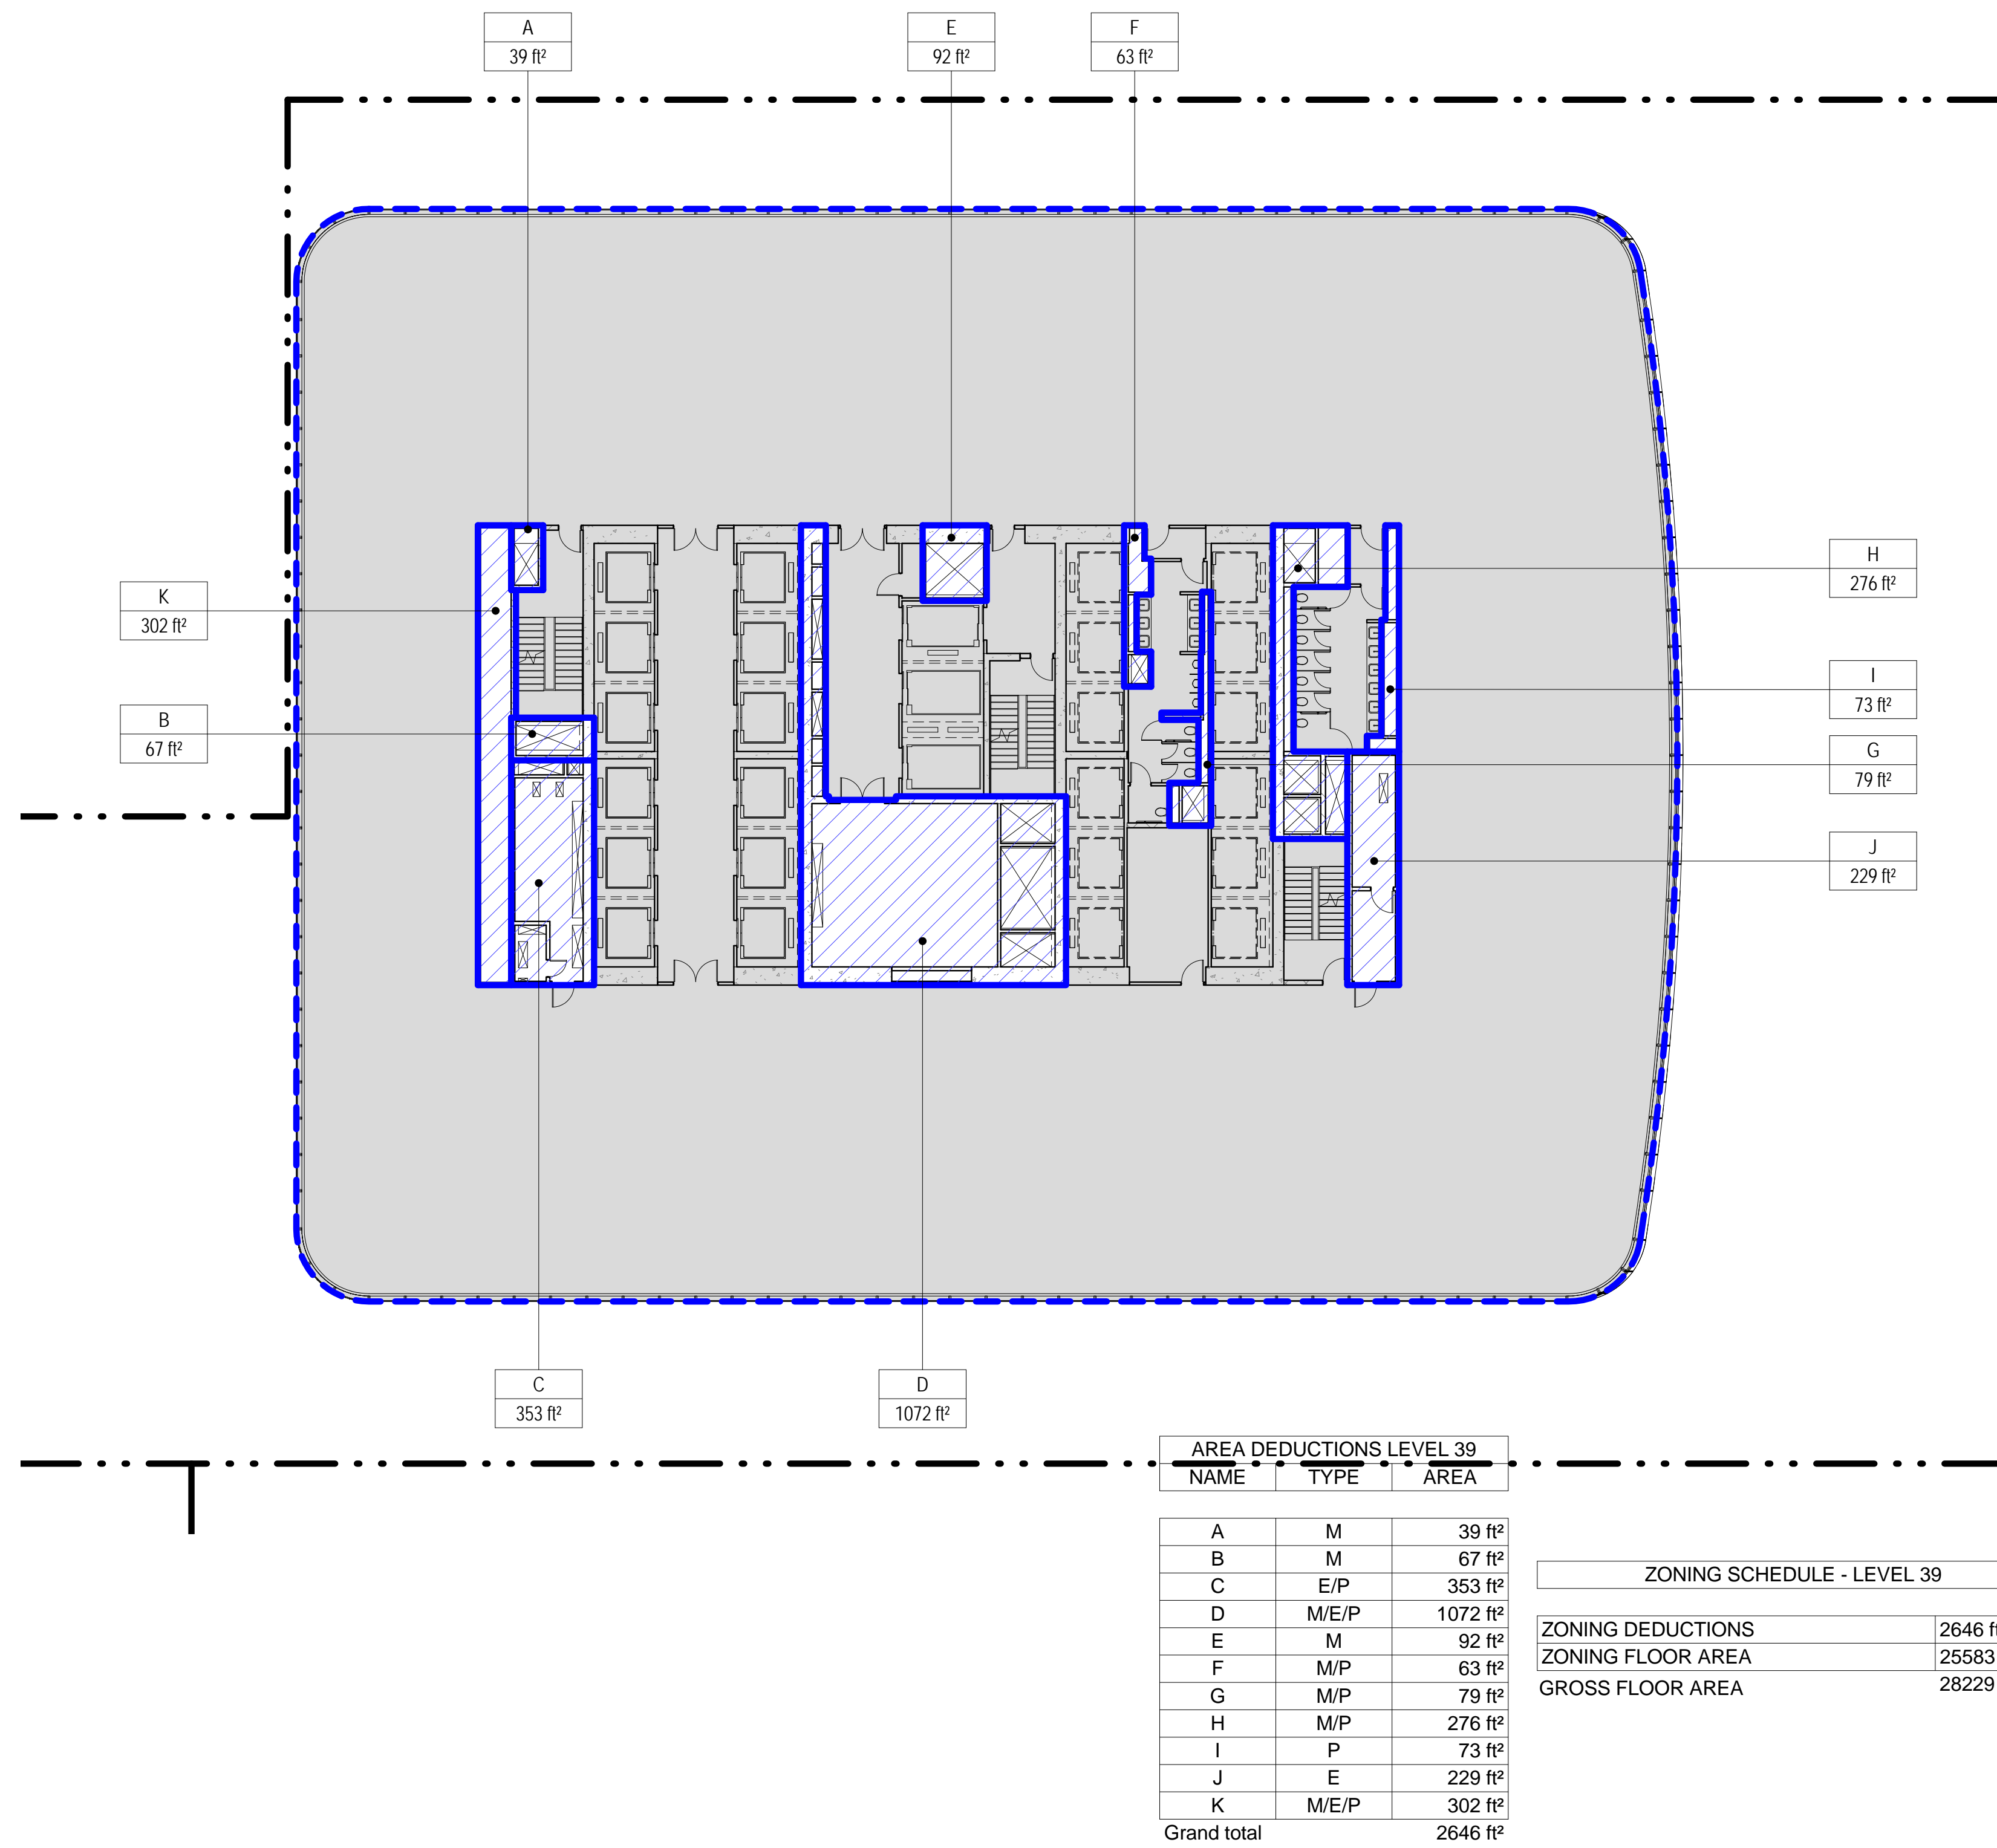SCALE: 1/16" = 1'-0"



2 LEVEL 38 PLAN

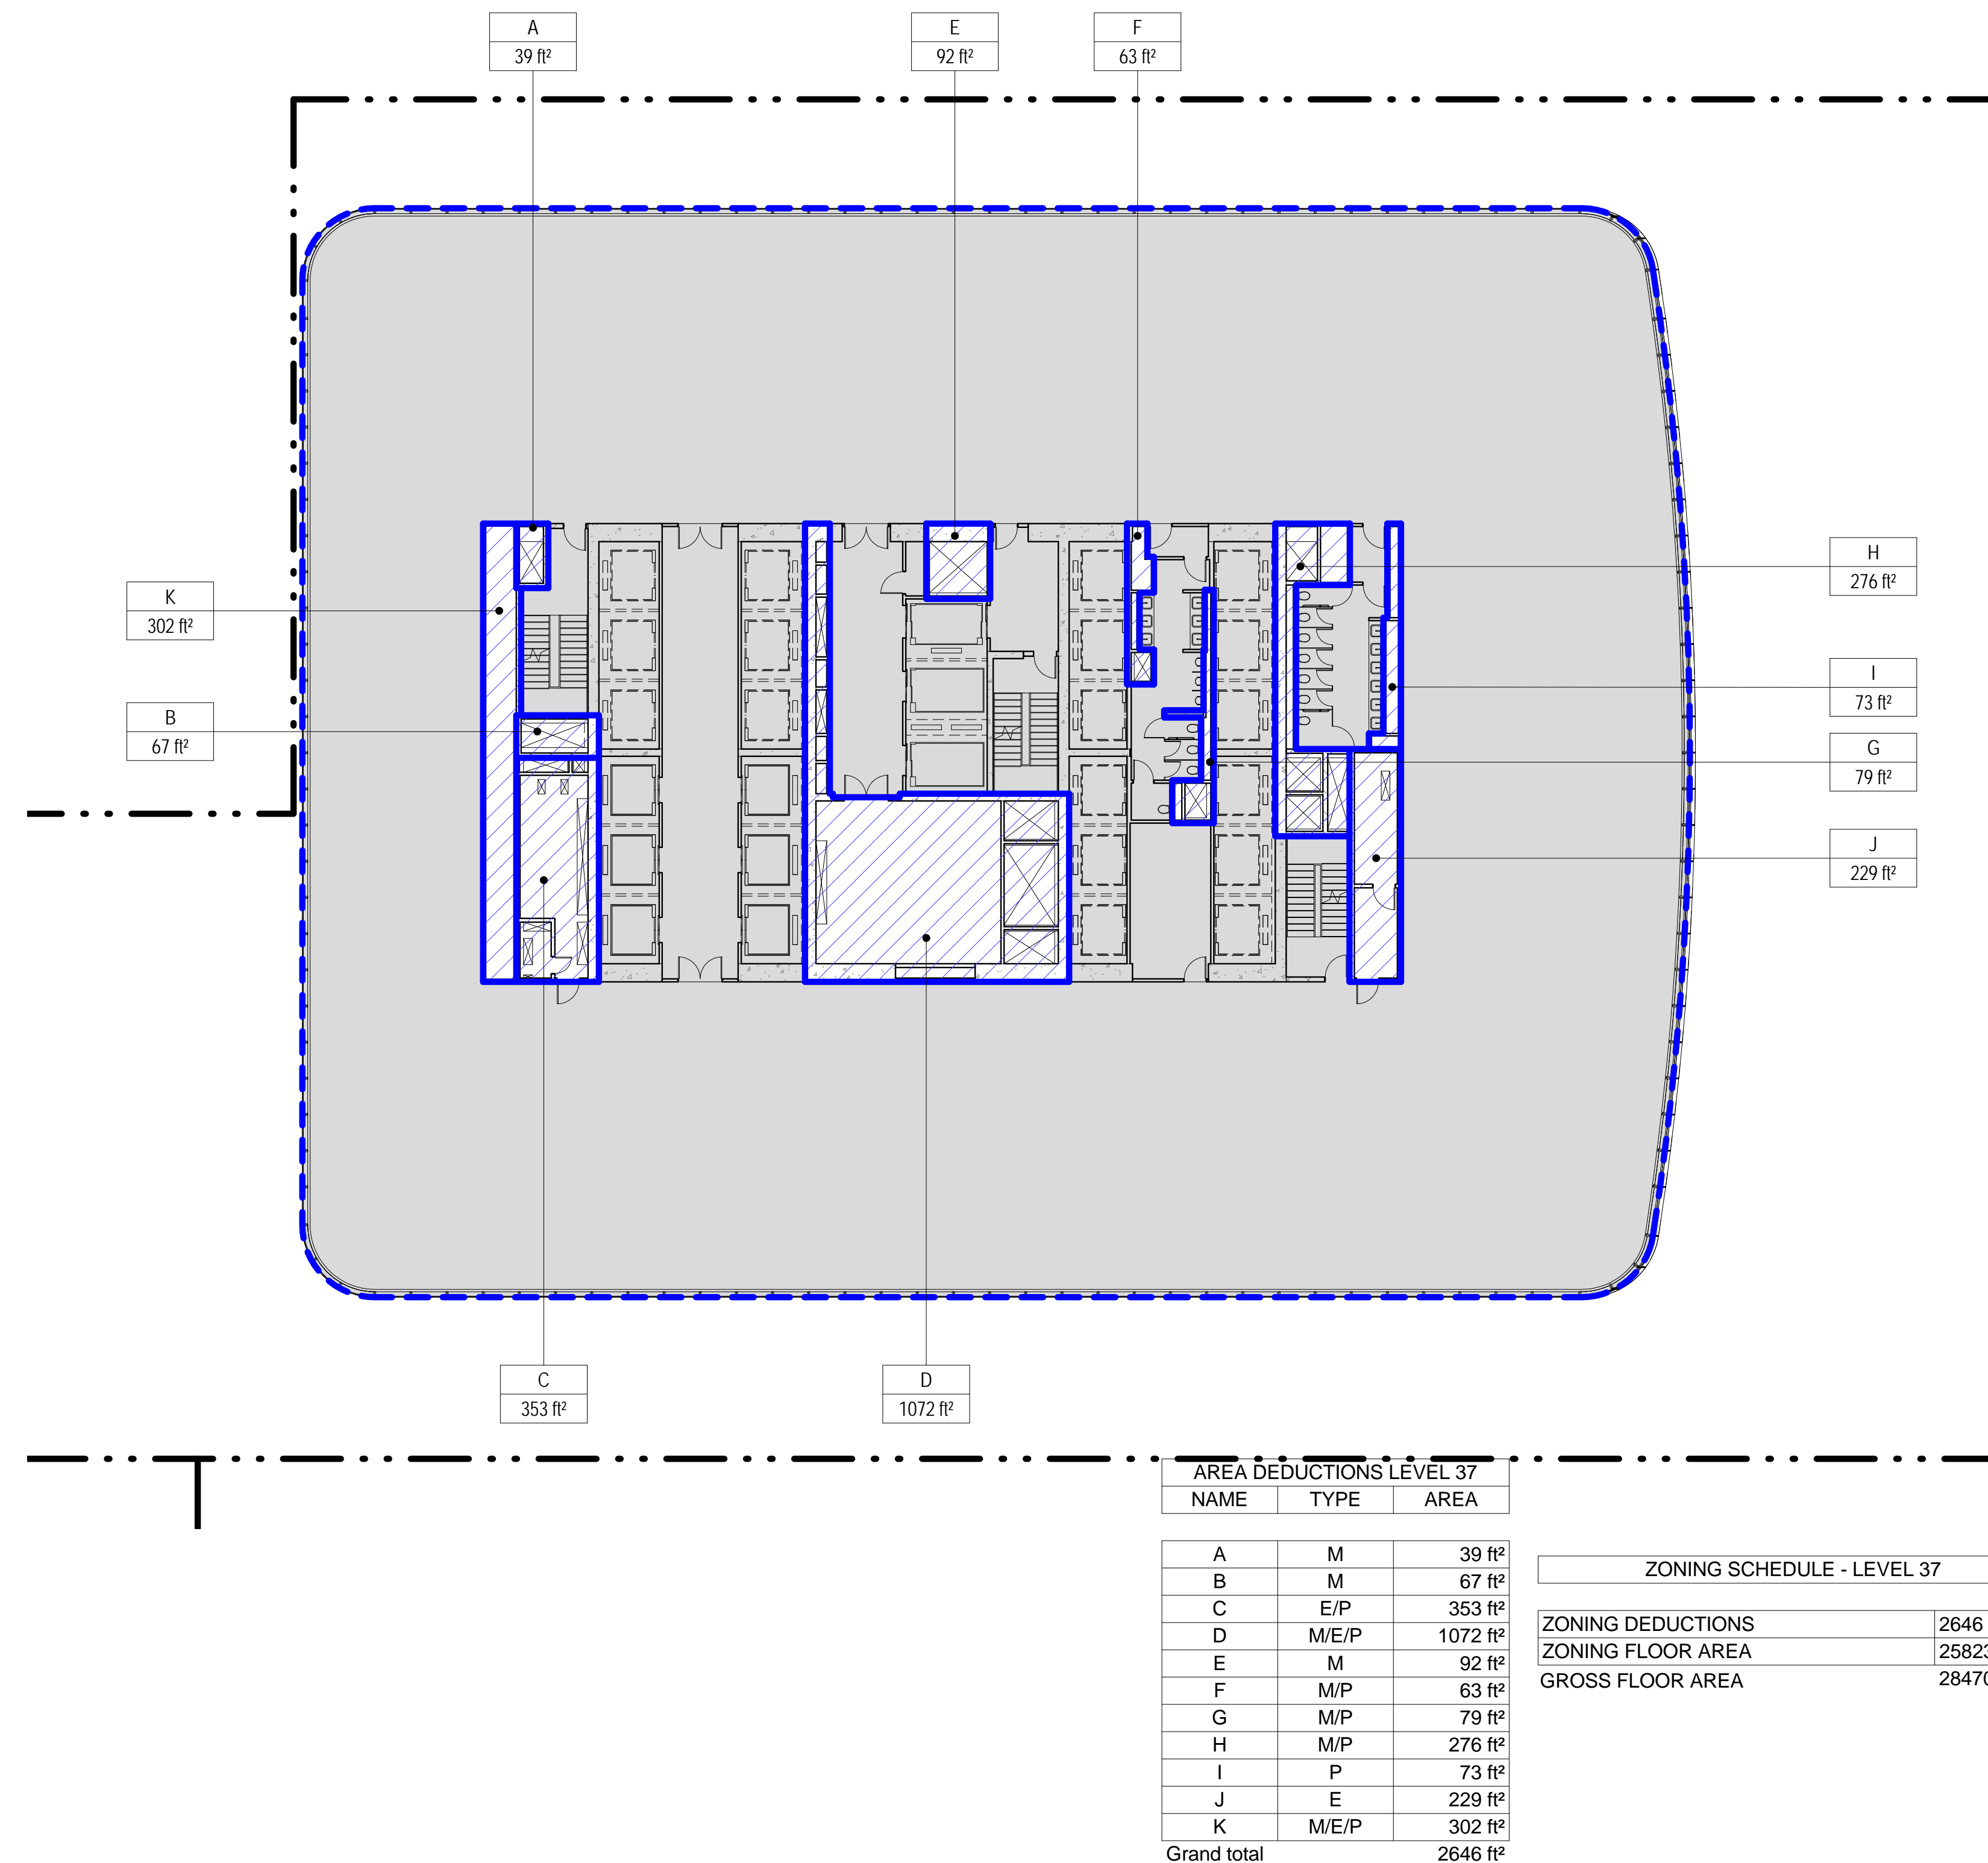SCALE: 1/16" = 1'-0"



ZONING LEGENDS

- GROSS BUILDING AREA
- ZONING AREA DEDUCTIONS
- ZONING FLOOR AREA
- RETAIL
- MR MECHANICAL ROOM
- M MECHANICAL
- E ELECTRICAL/TEL./IT
- P PLUMBING
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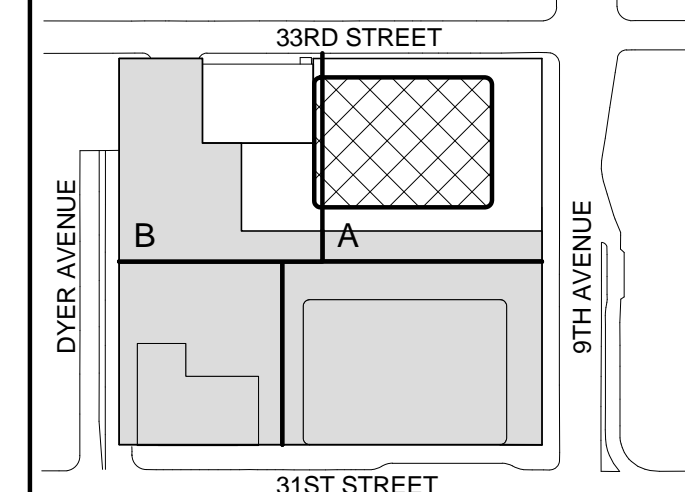
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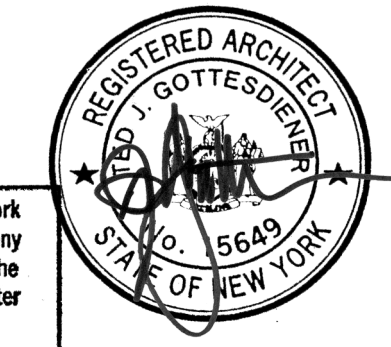
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**ZONING FLOOR
AREA
DEDUCTIONS -
LEVEL 37-40**

Project No.:

207150

Date:

20 JUN 2014

Scale:

1/16" = 1'-0"

File No.:

Z-113

B-SCAN Sheet No.:

Z-113.00

Sheet No.:

Z-113


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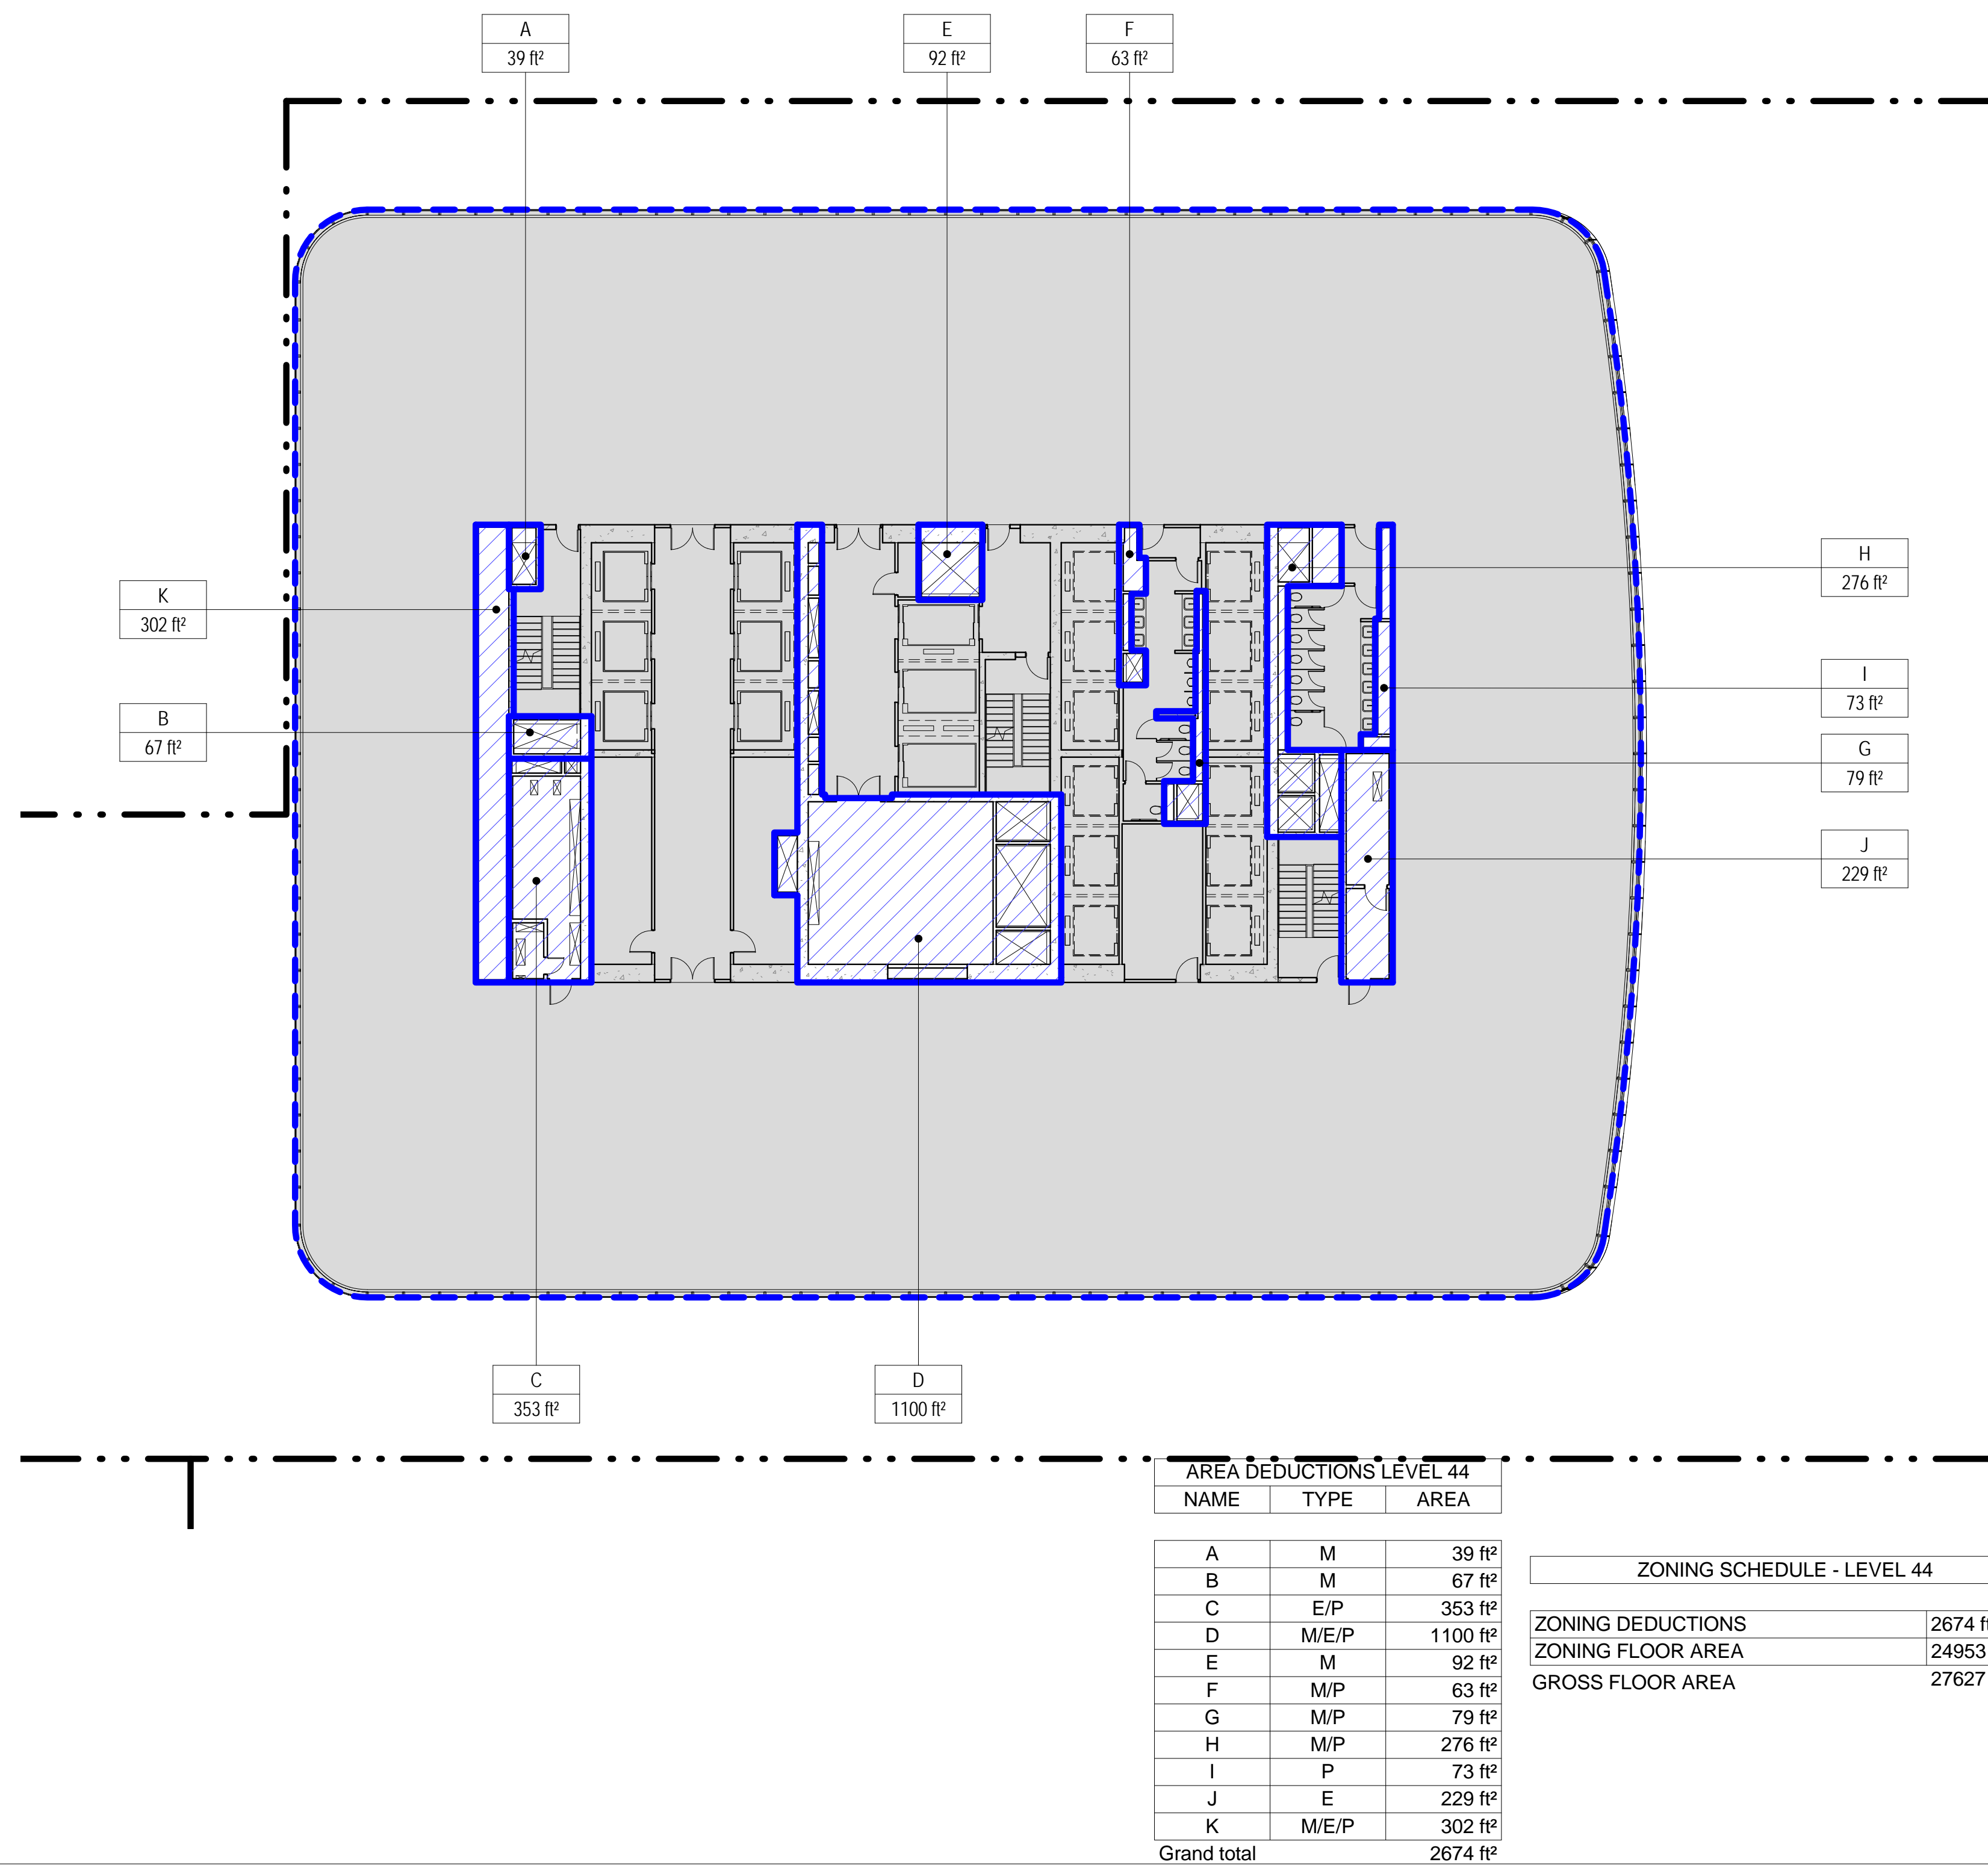
3 LEVEL 43 PLAN

SCALE: 1/16" = 1'-0"




4 LEVEL 44 PLAN

SCALE: 1/16" = 1'-0"

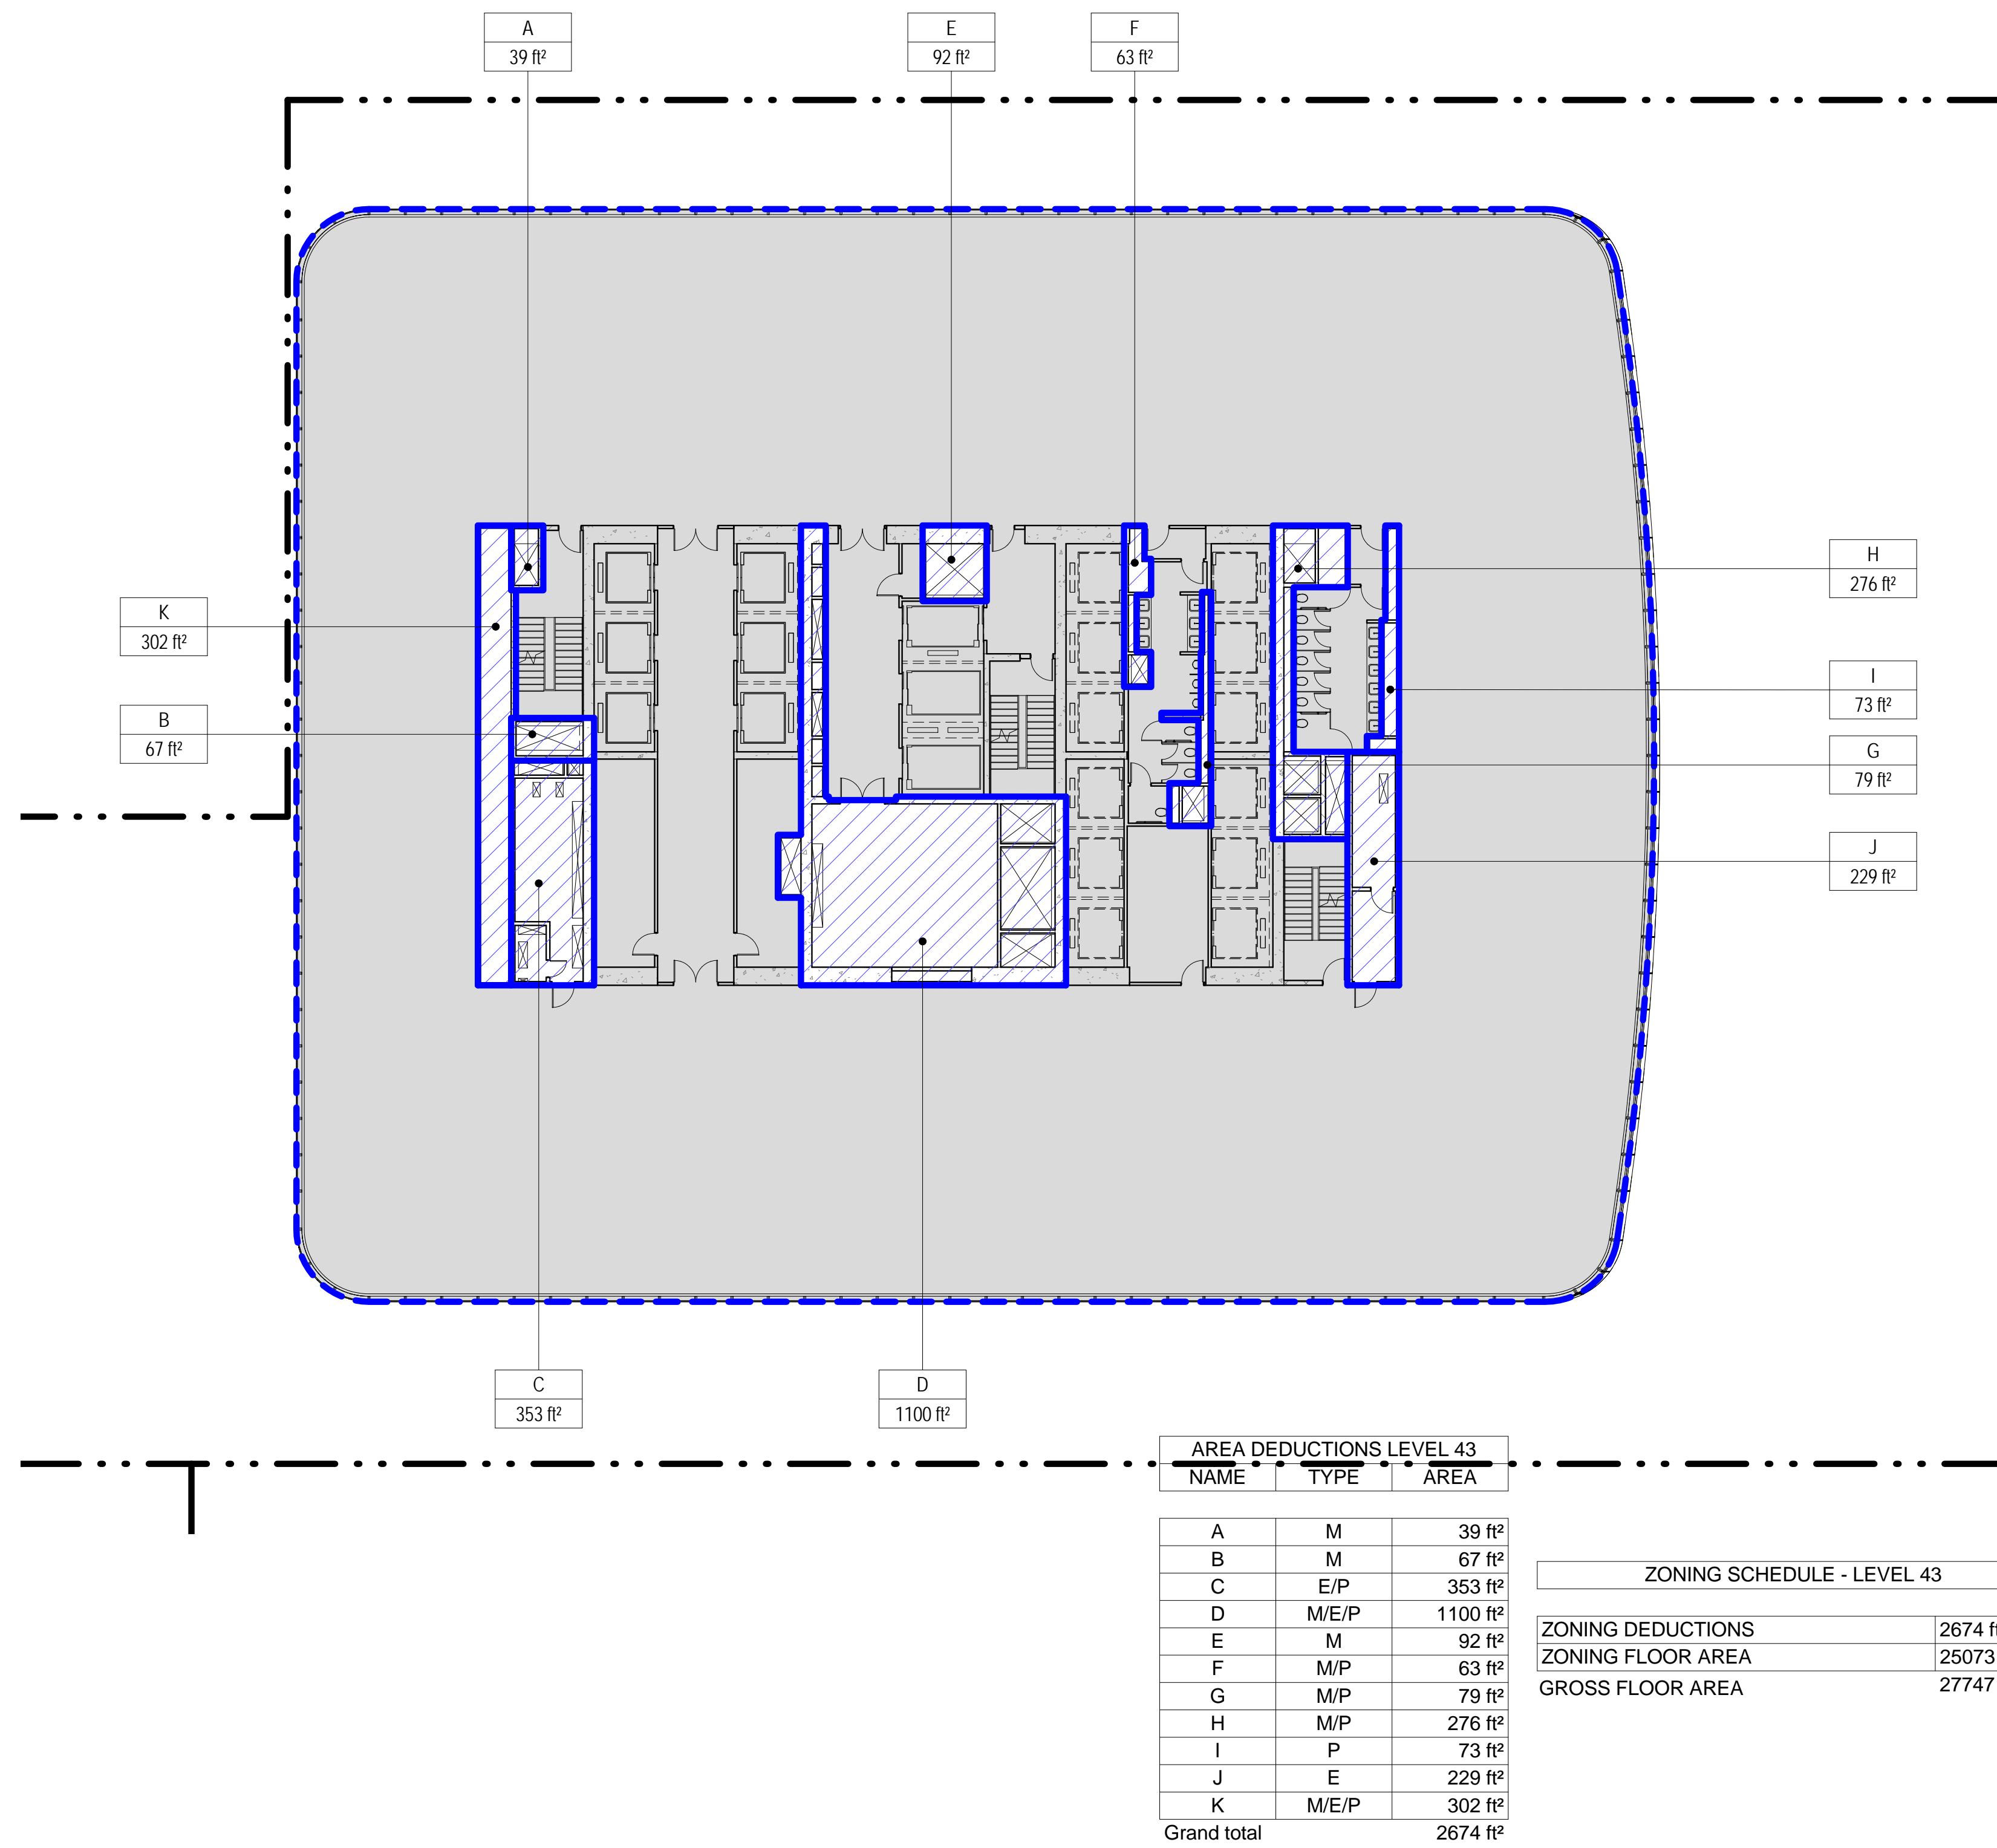


1 LEVEL 41 PLAN

SCALE: 1/16" = 1'-0"

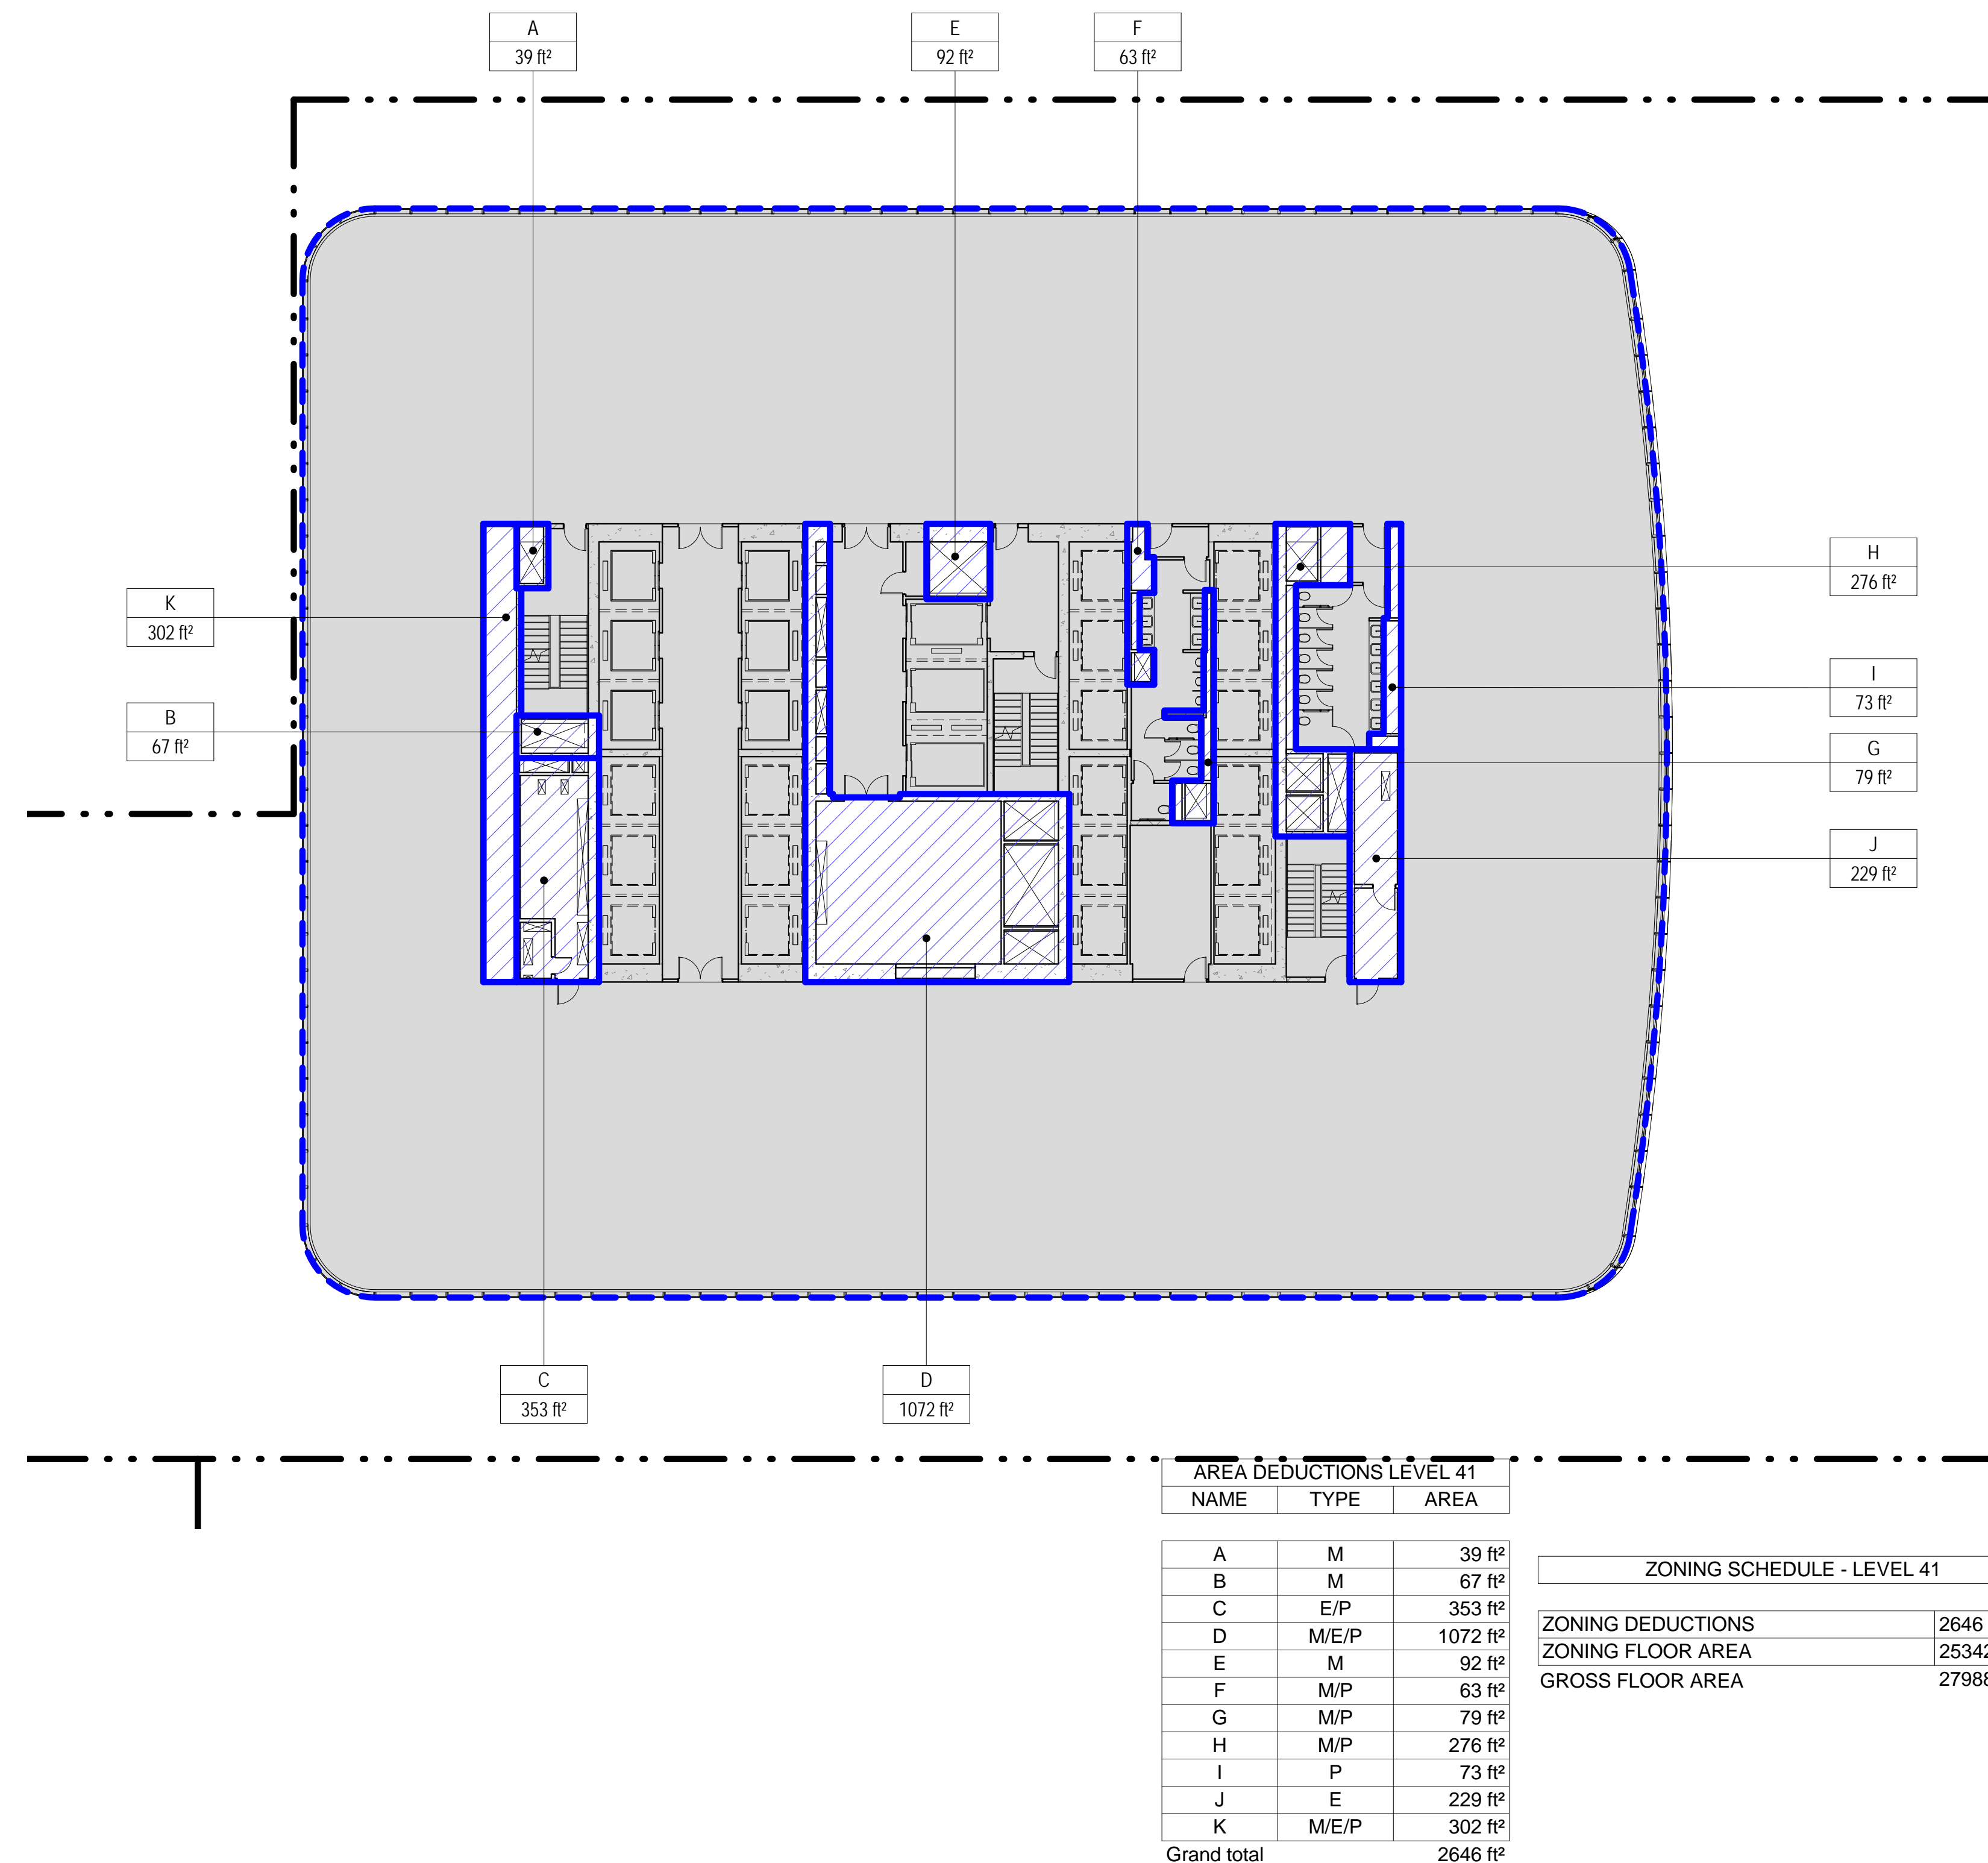

2 LEVEL 42 PLAN

SCALE: 1/16" = 1'-0"

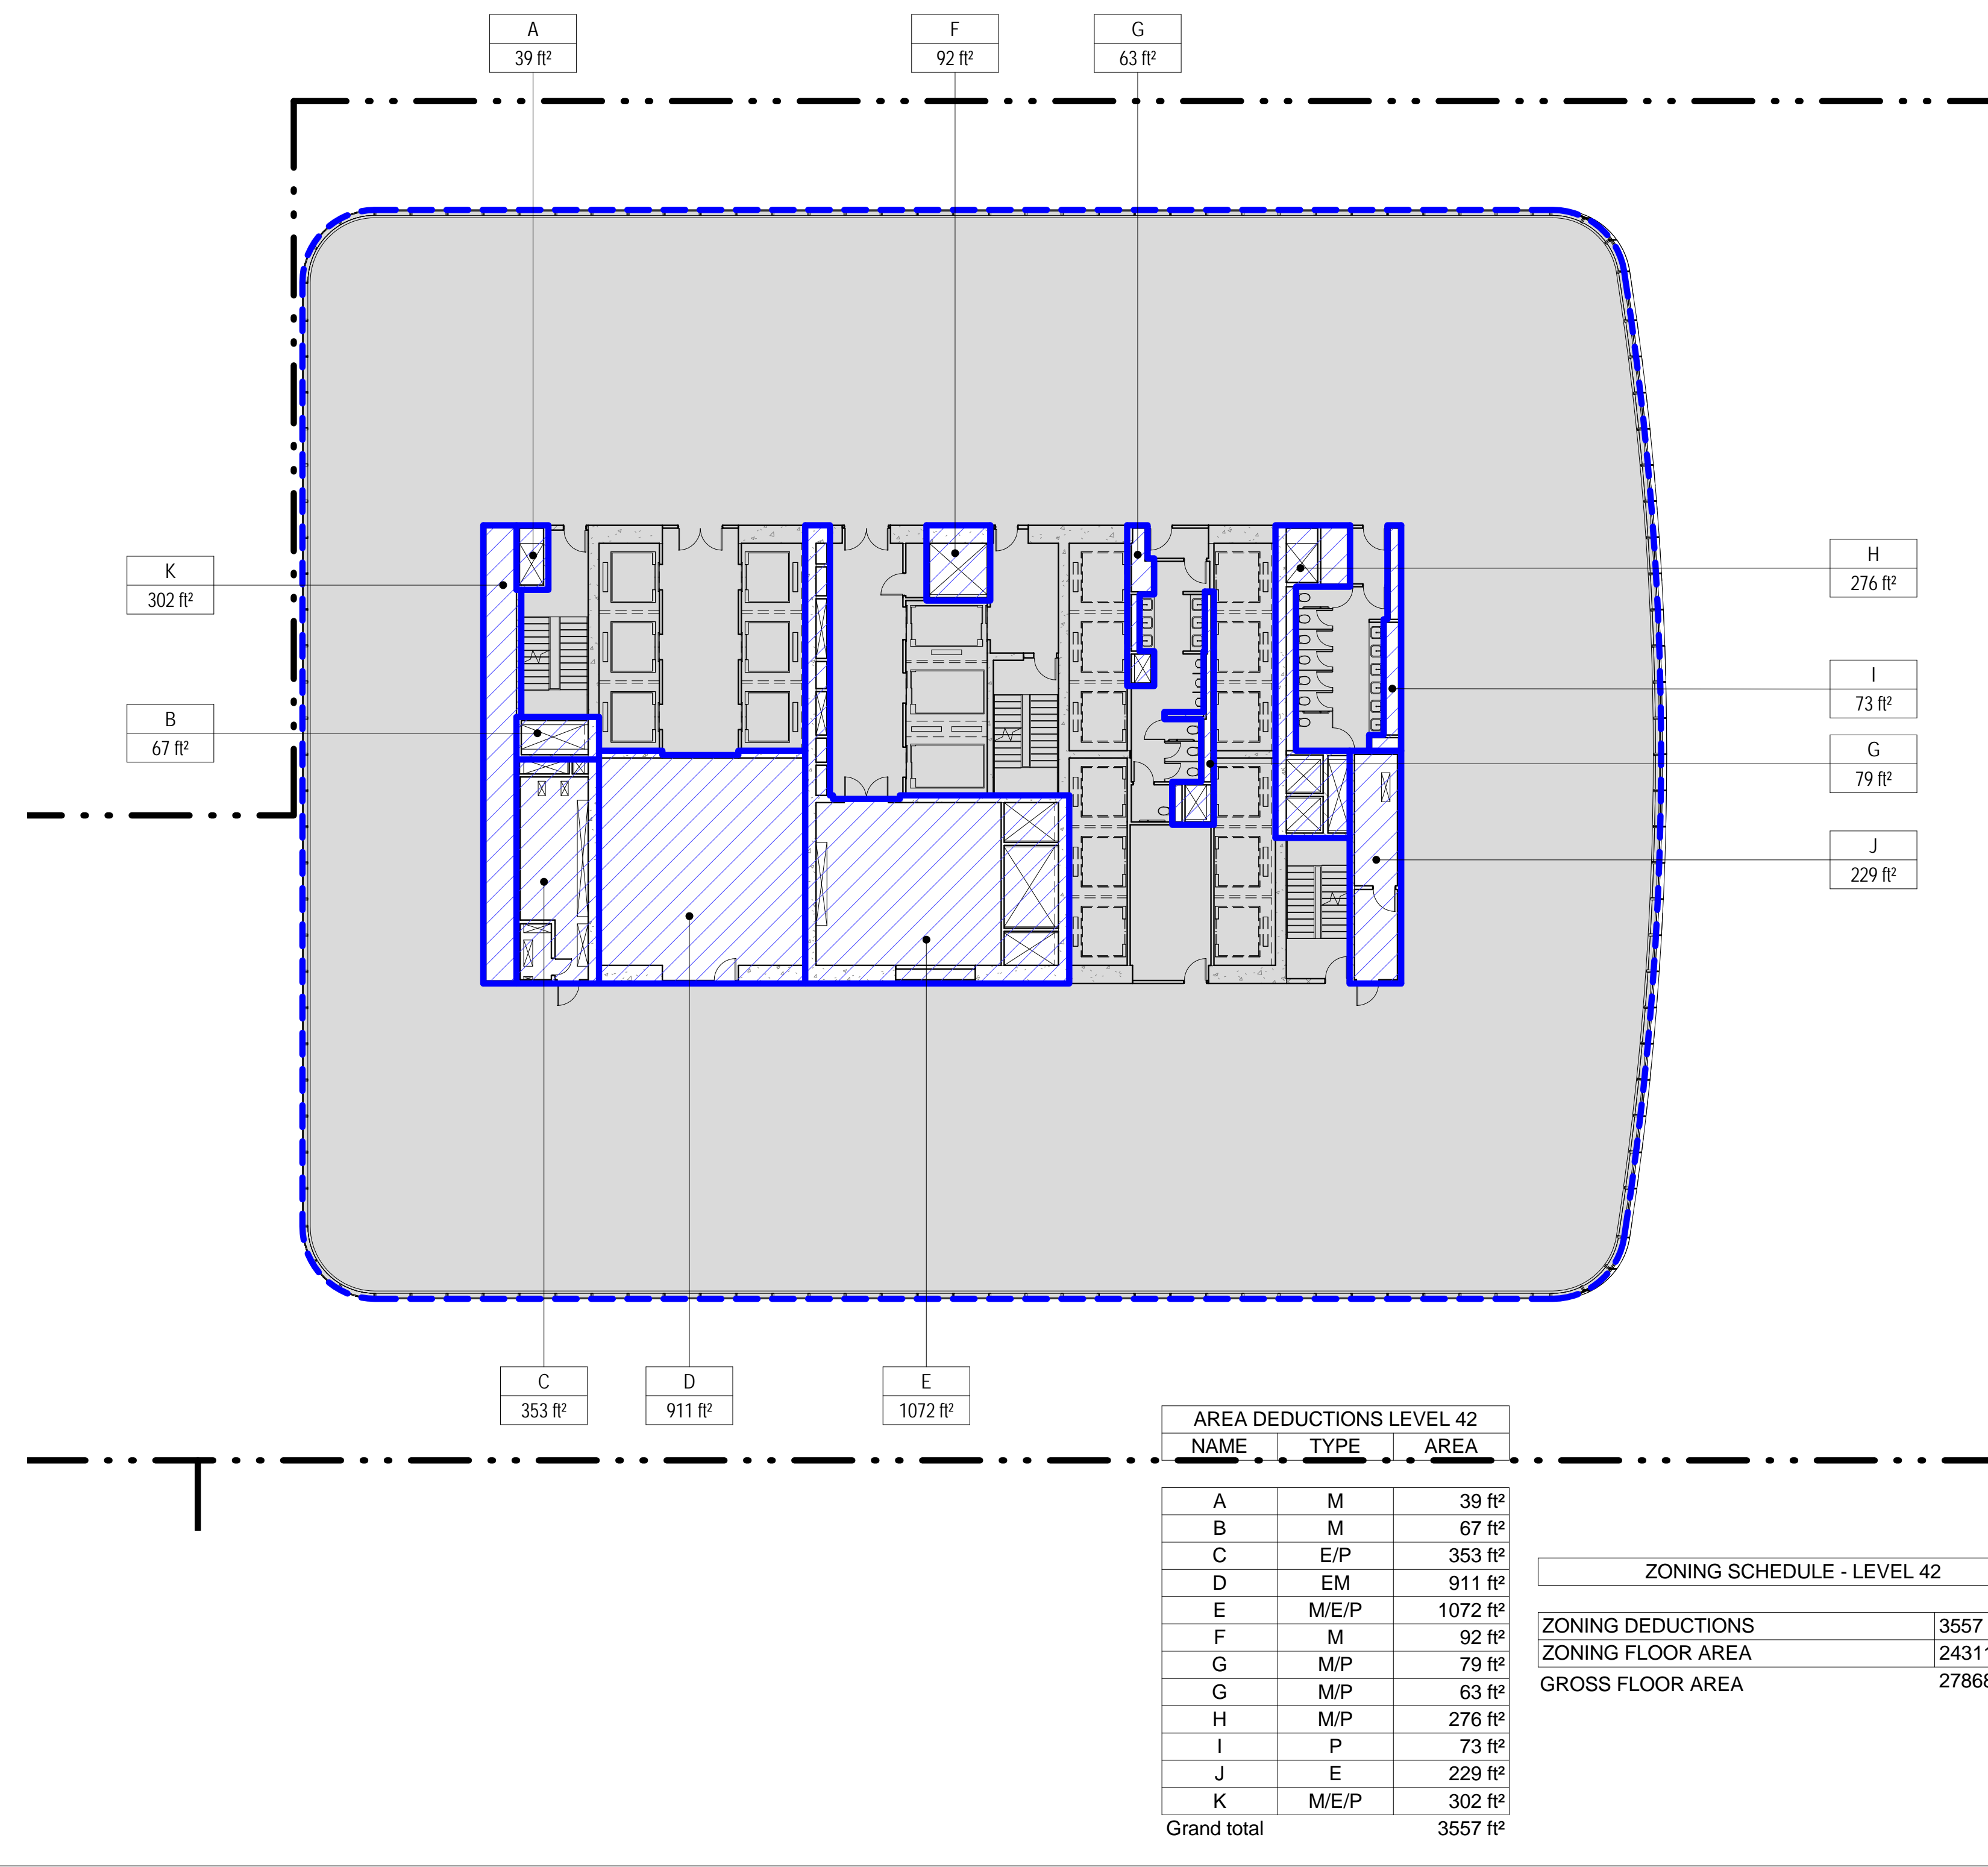

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- GROSS BUILDING AREA
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- ZONING FLOOR AREA
- RETAIL
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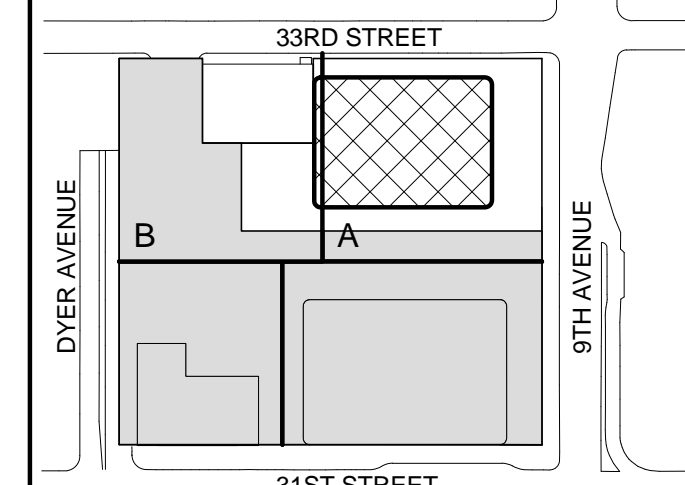
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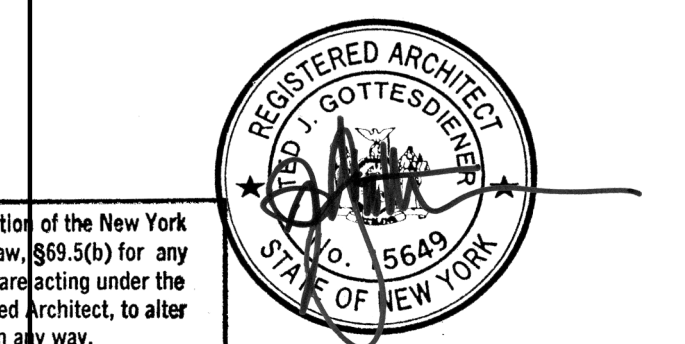
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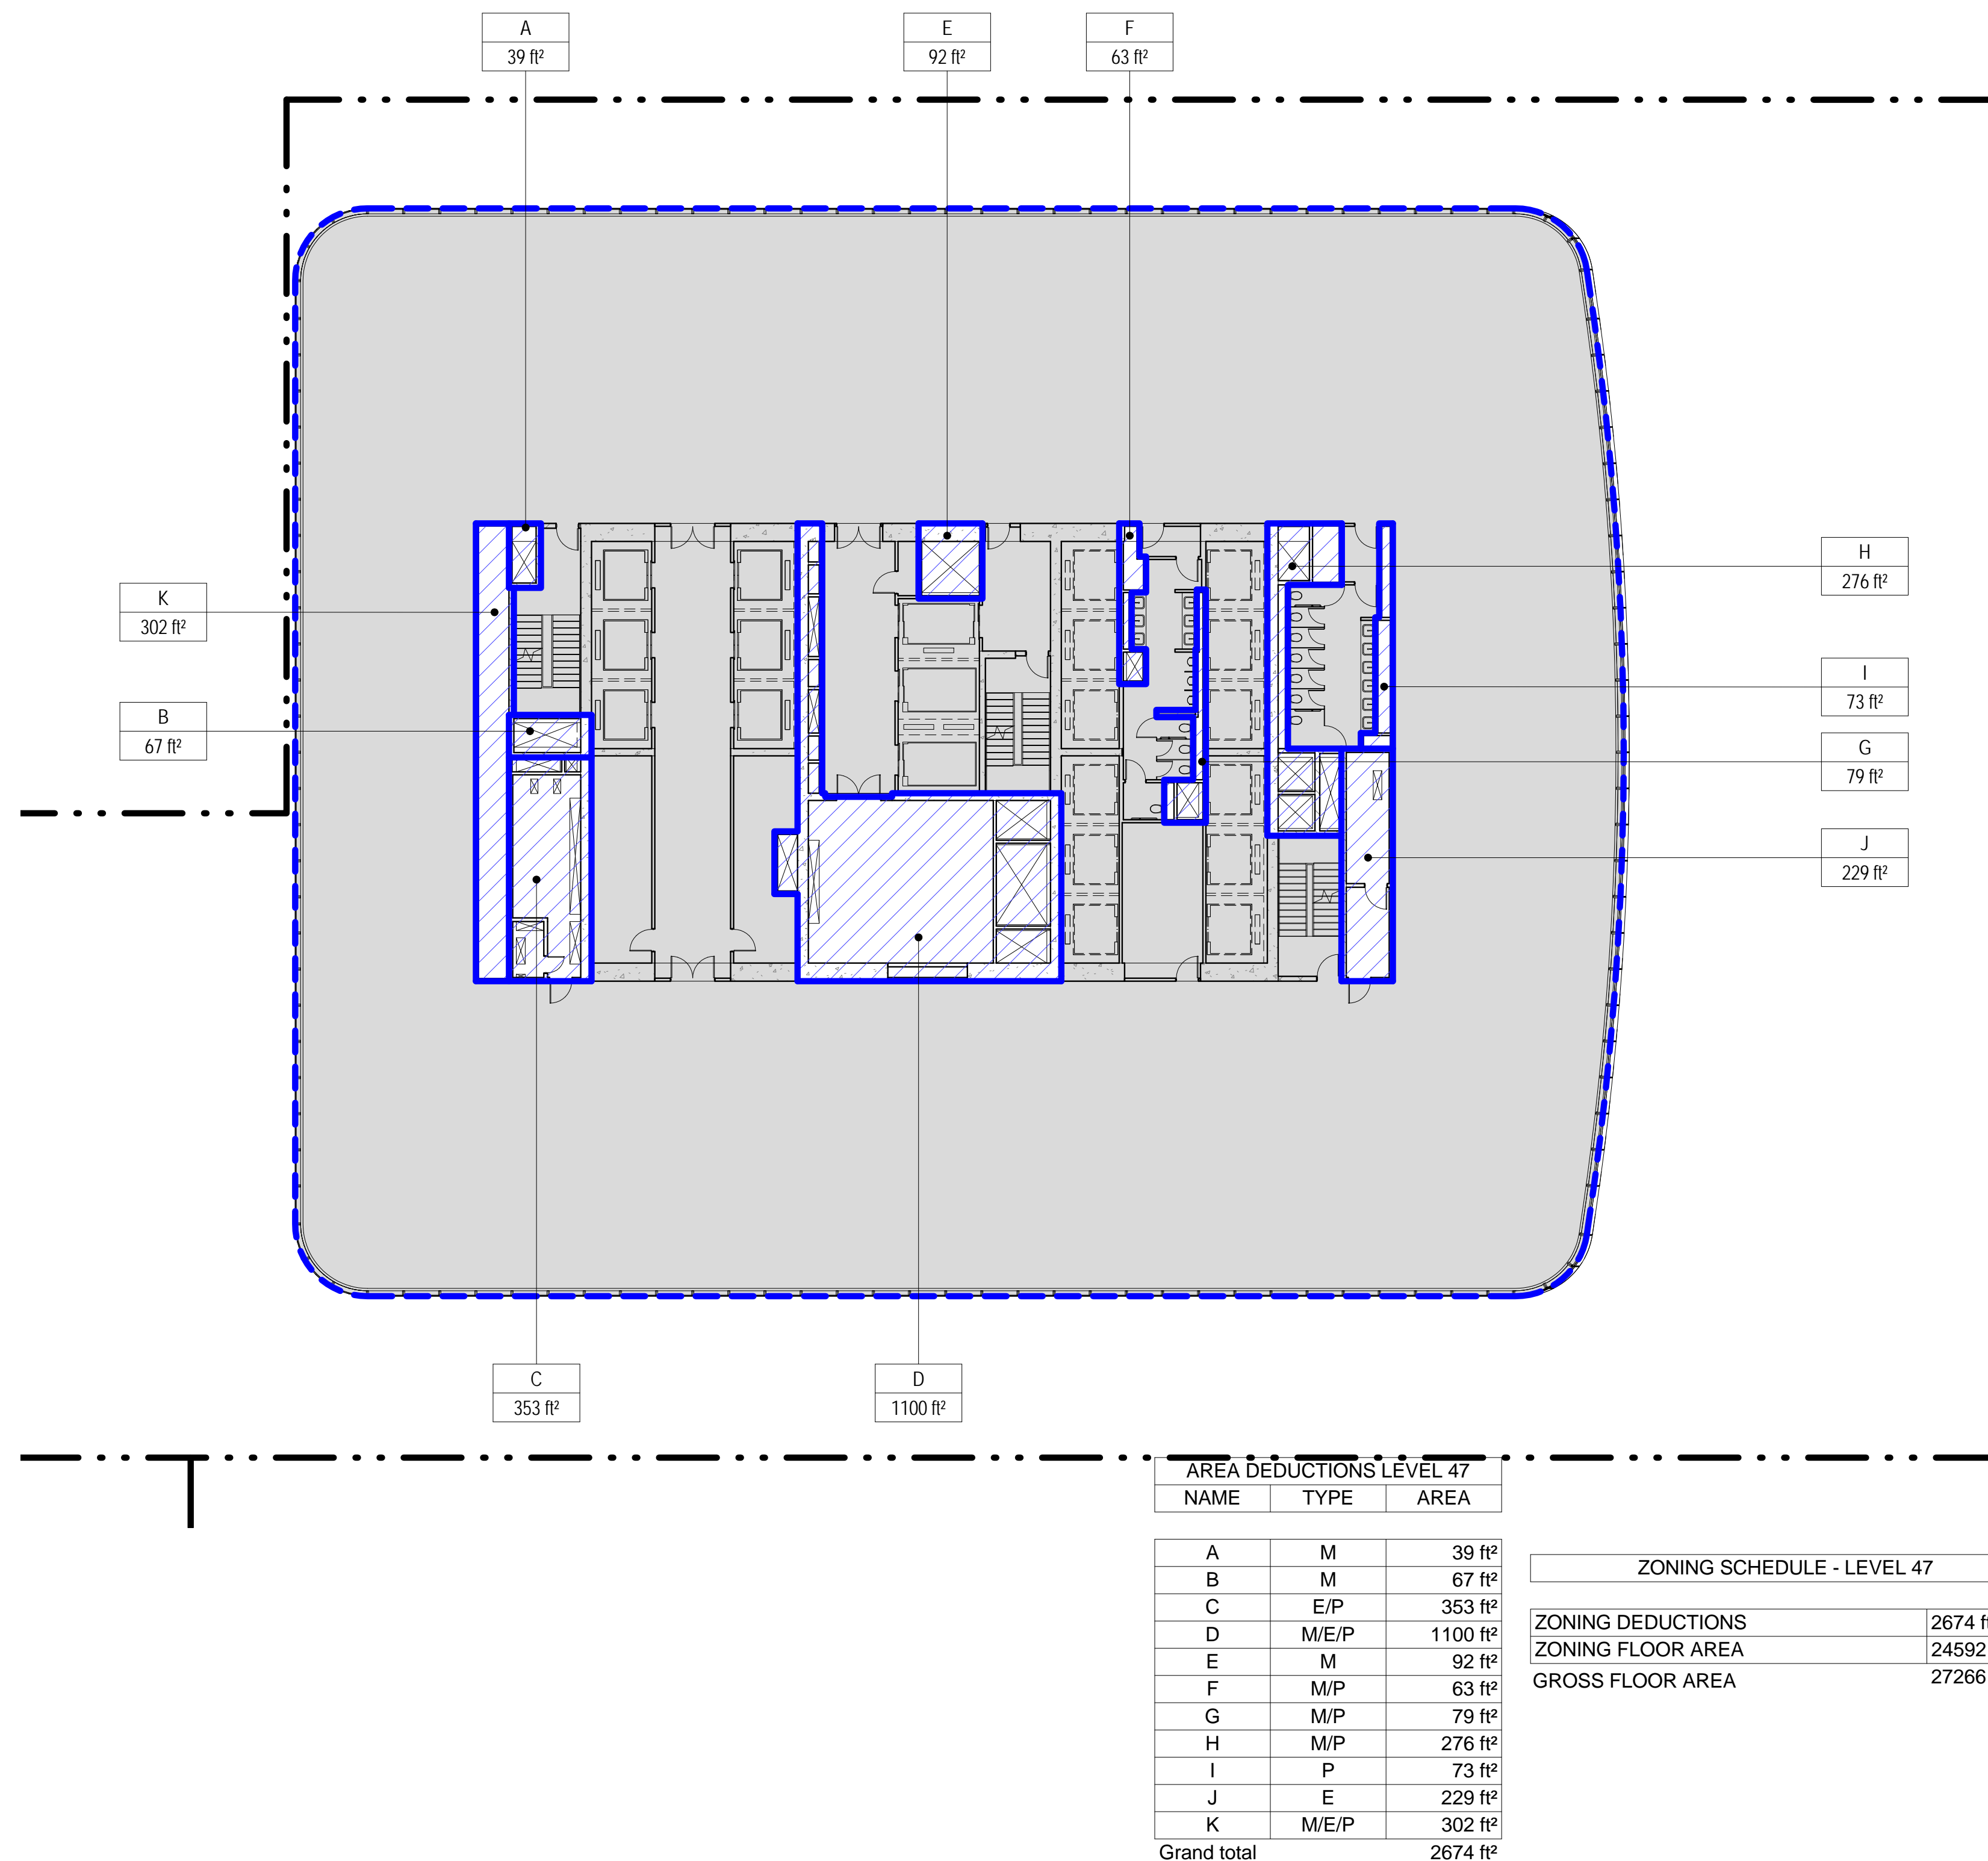
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ZONING FLOOR AREA DEDUCTIONS - LEVEL 41-44

Project No.:	B-SCAN Sheet No.:
207150	Z-114.00
Date:	20 JUN 2014
Scale:	1/16" = 1'-0"
File No.:	2-114
Sheet No.:	21 OF 28


3 LEVEL 47 PLAN

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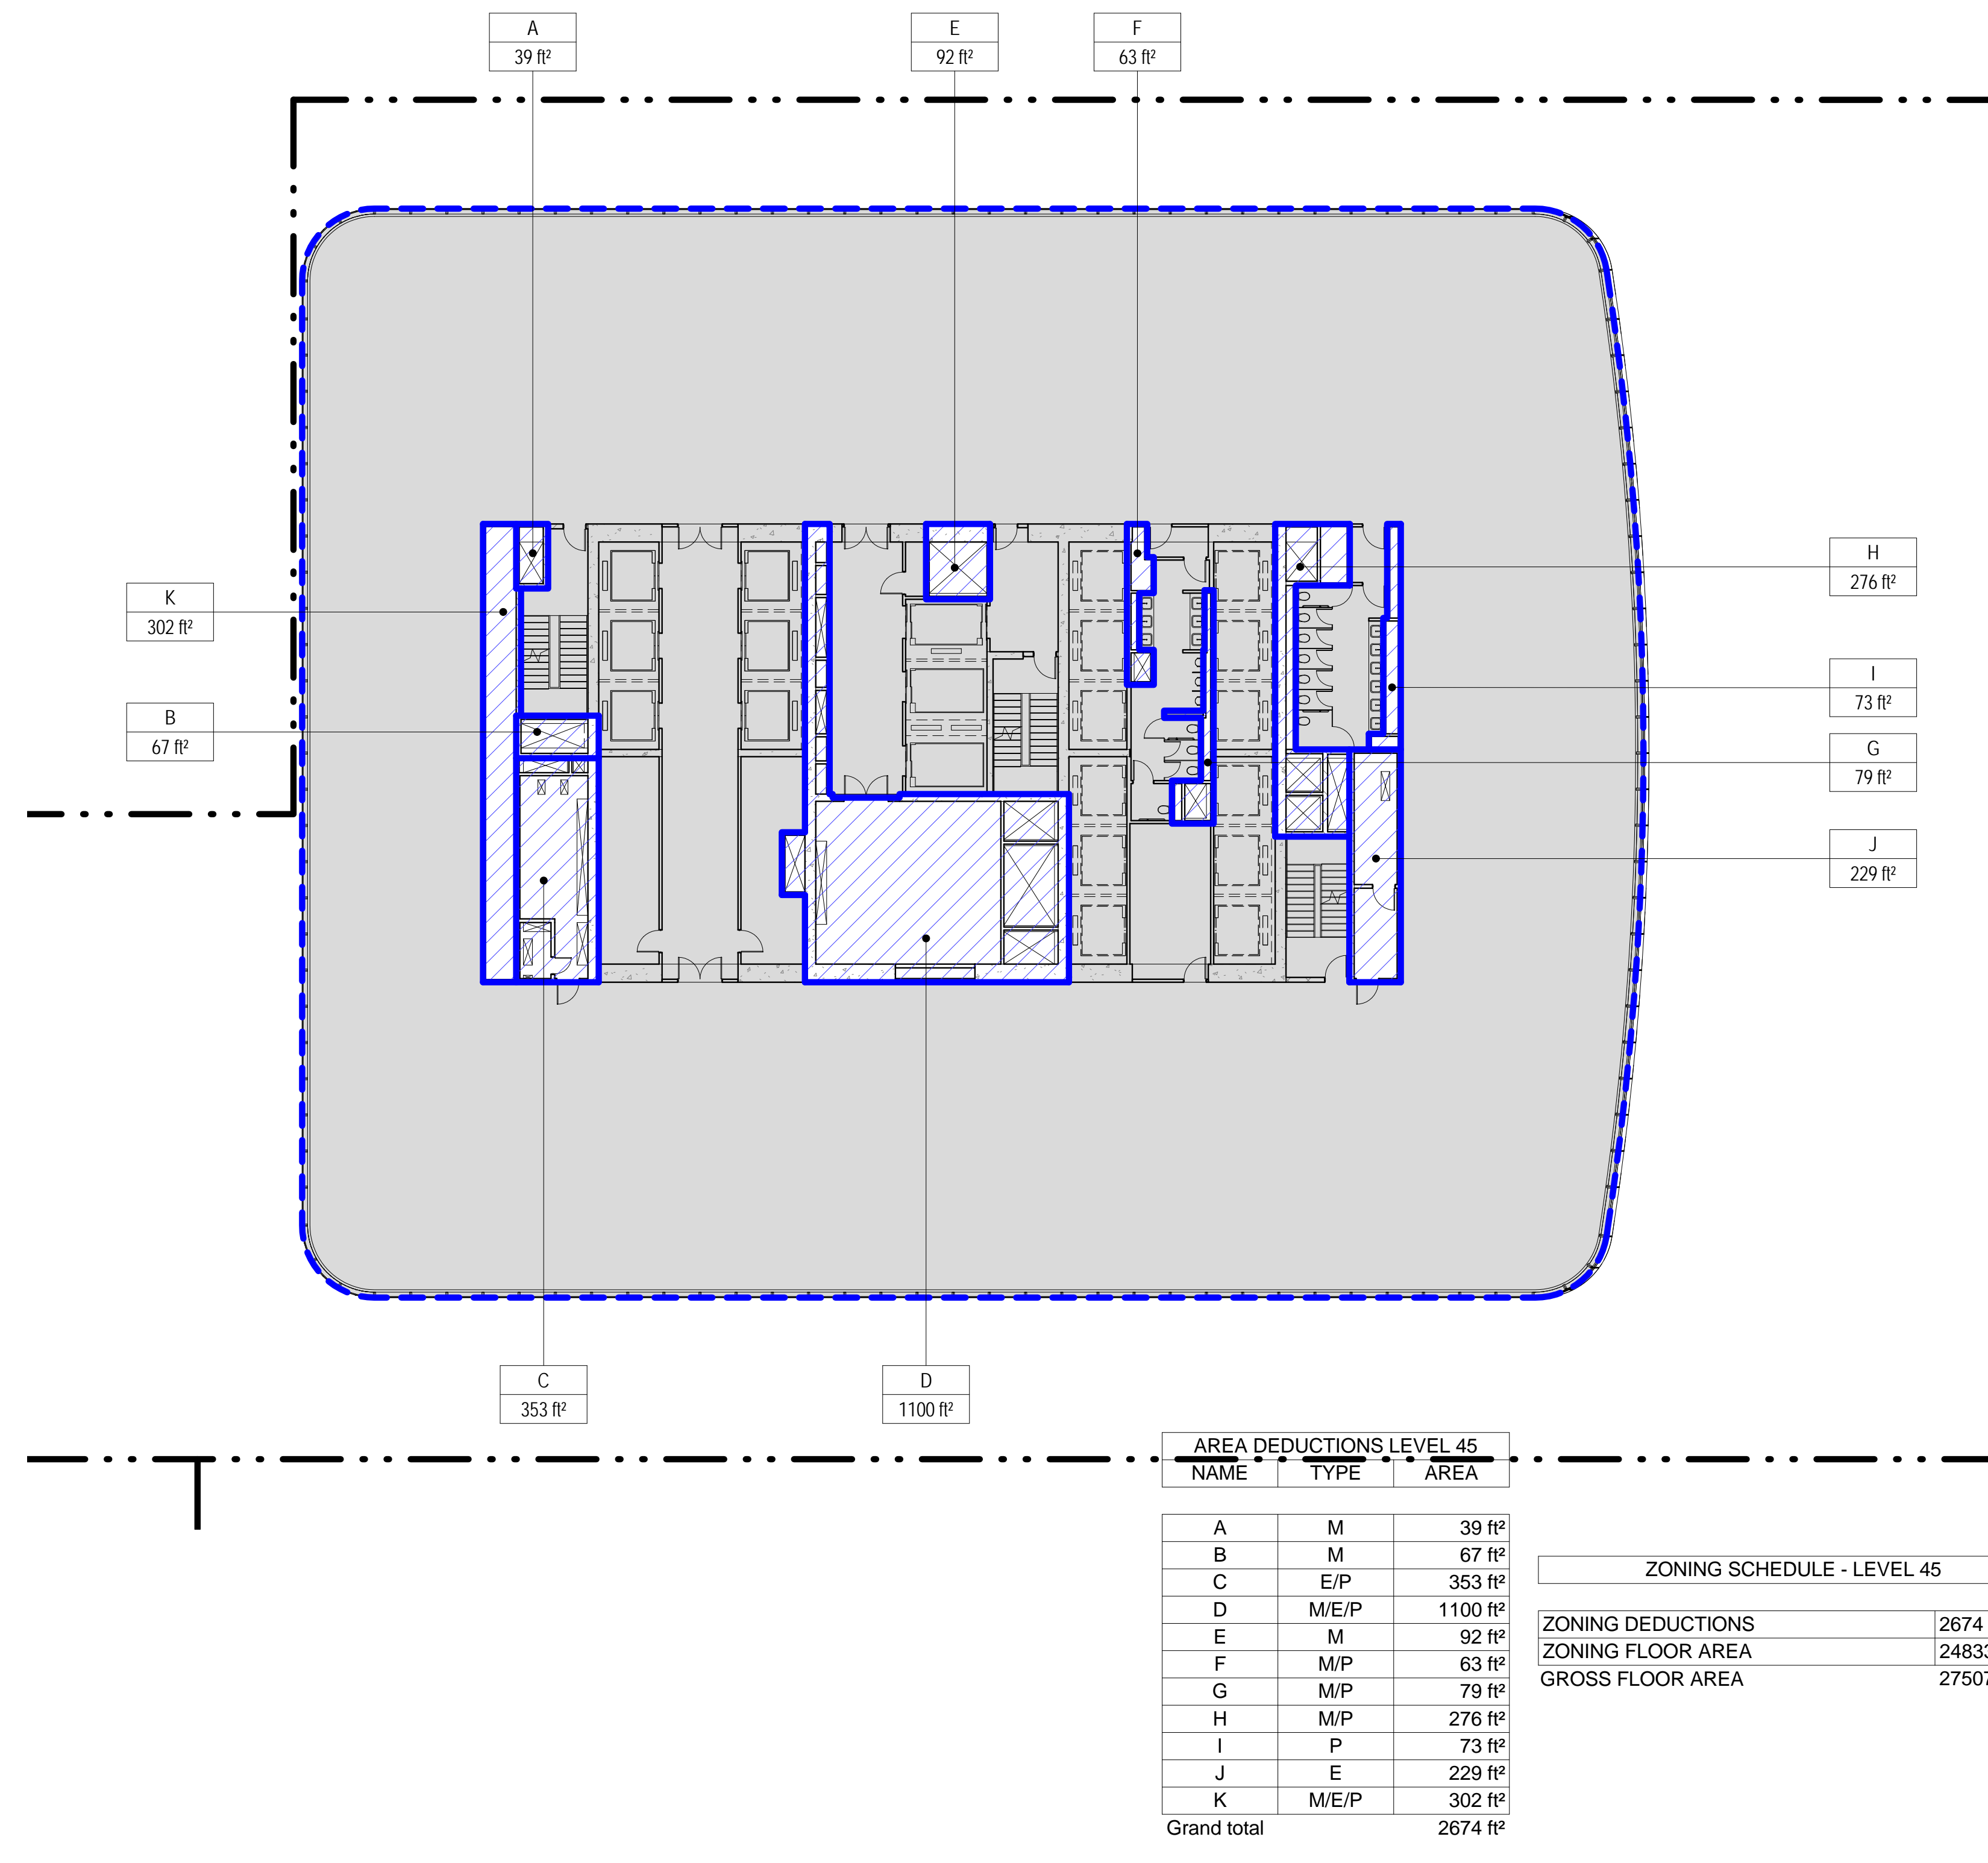
4 LEVEL 48 PLAN

SCALE: 1/16" = 1'-0"




1 LEVEL 45 PLAN

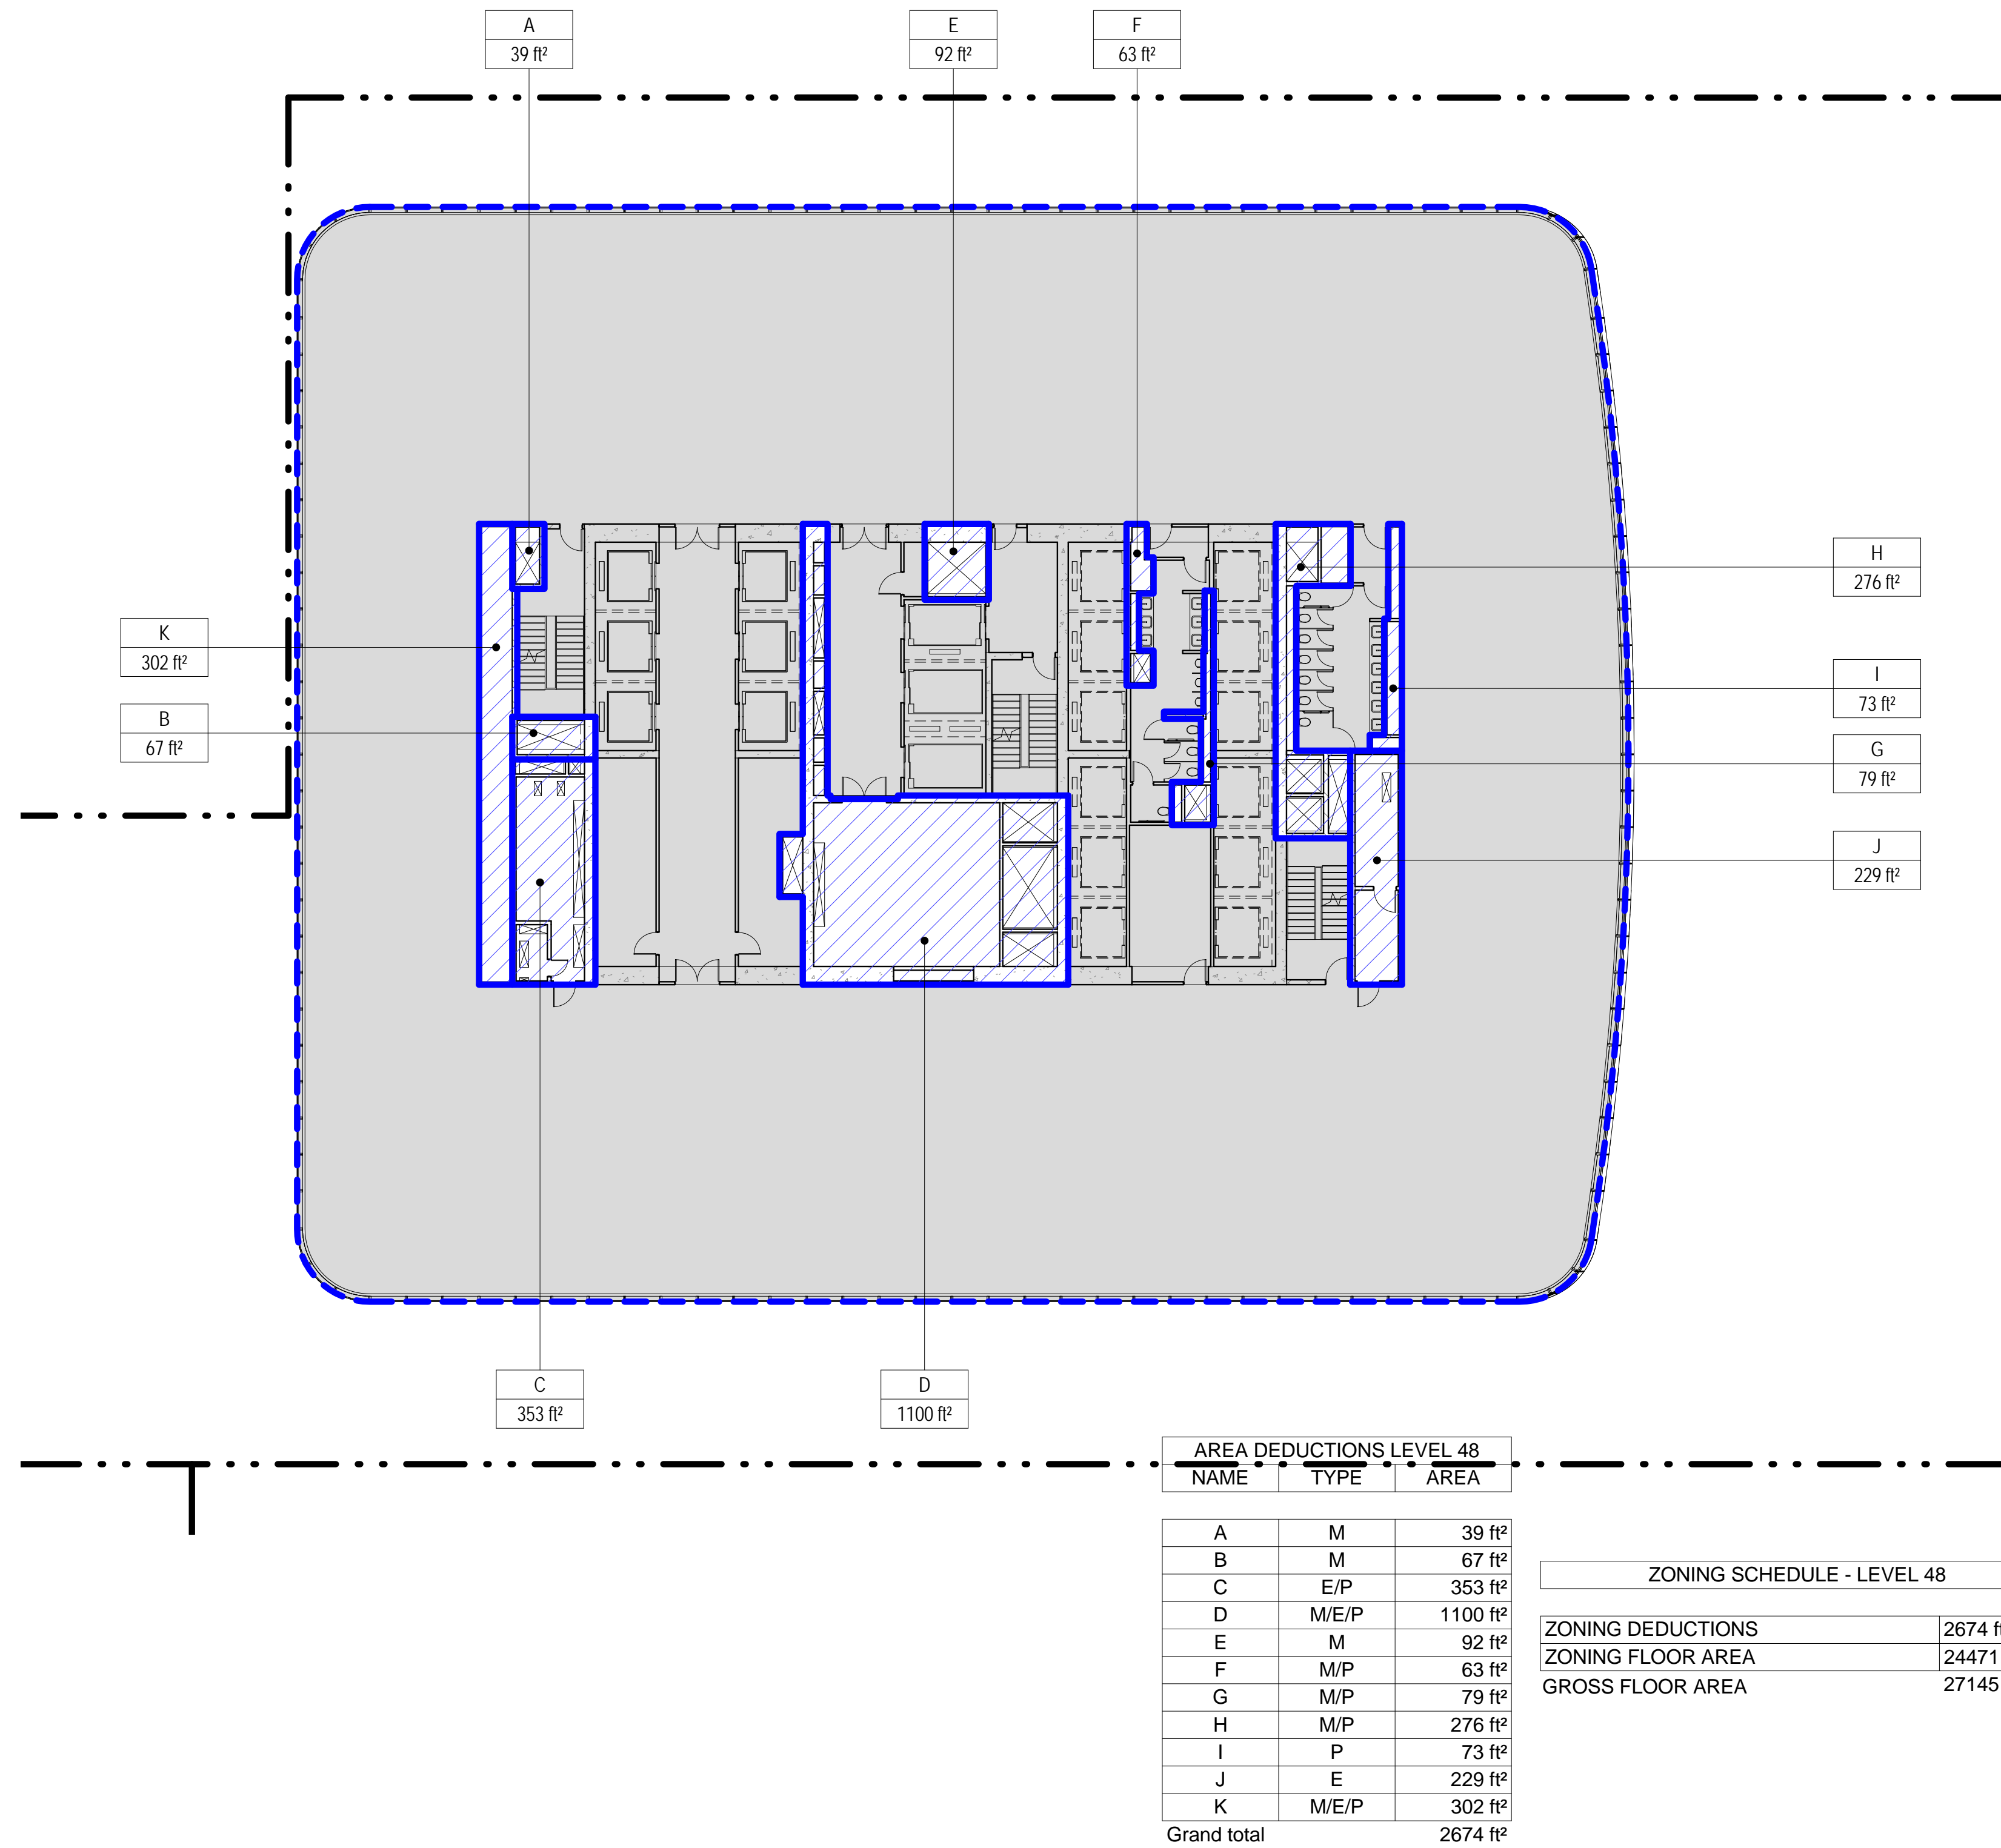SCALE: 1/16" = 1'-0"



2 LEVEL 46 PLAN

SCALE: 1/16" = 1'-0"

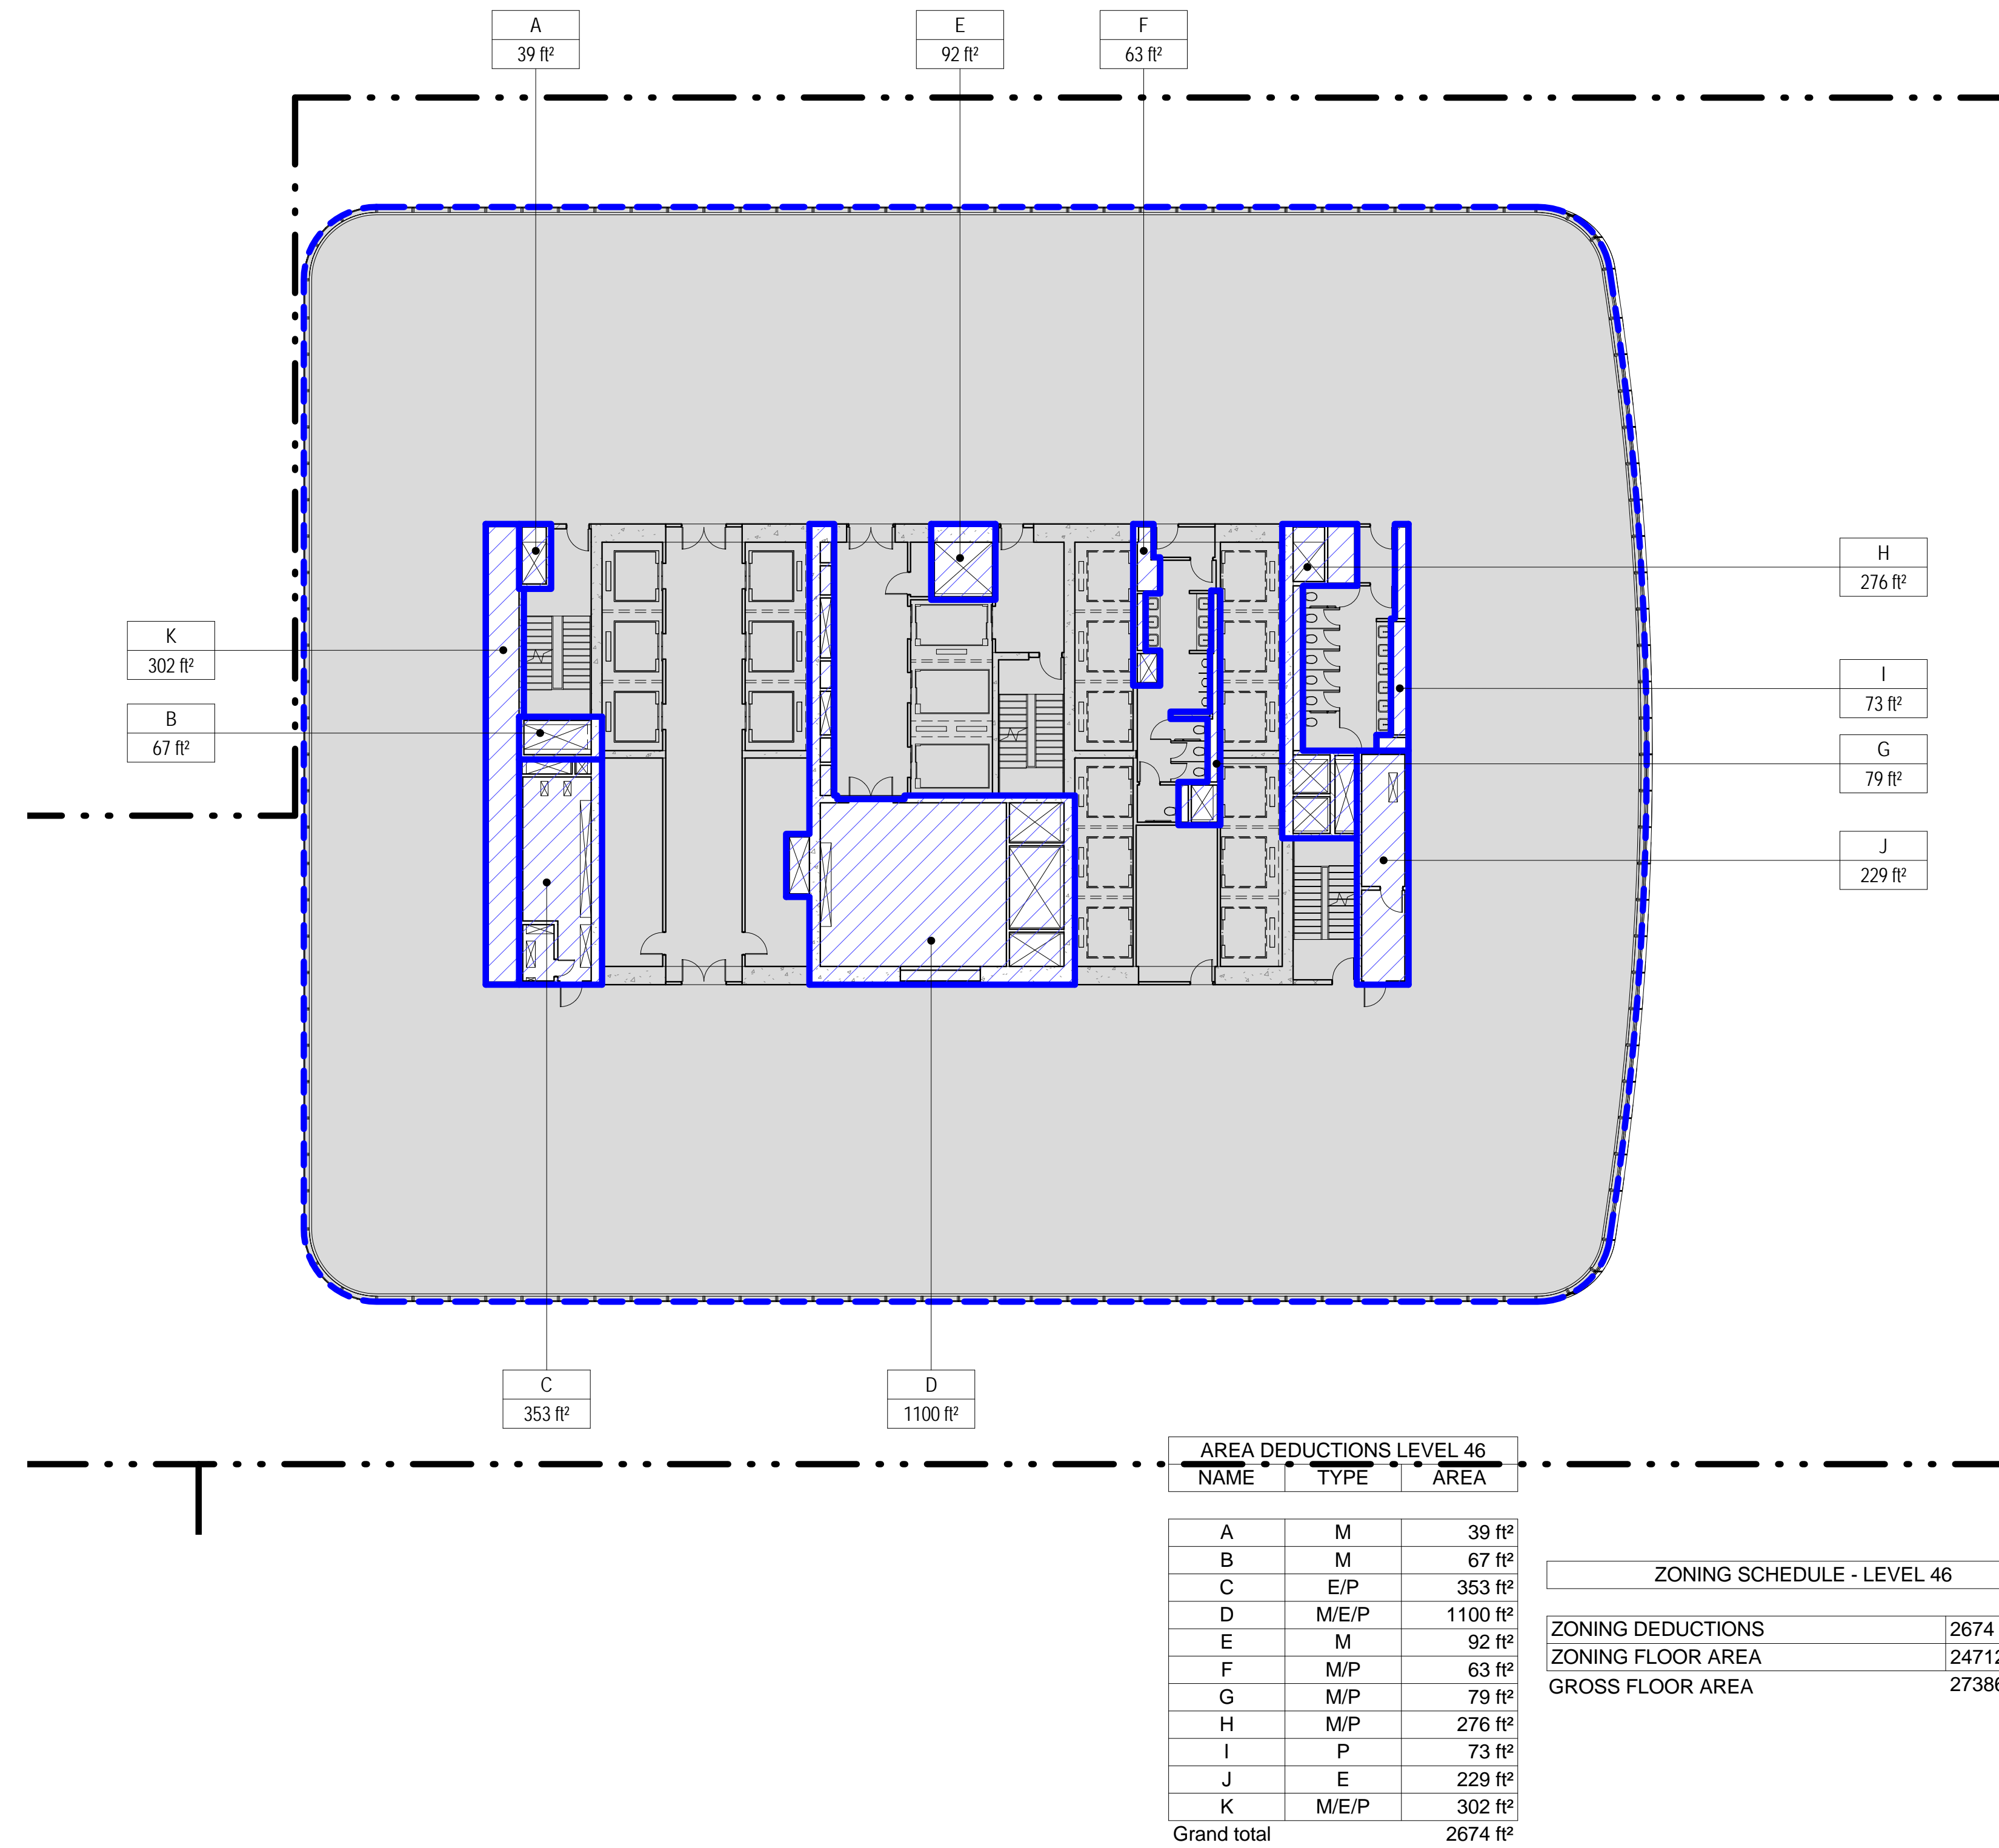

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- GROSS BUILDING AREA
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- ZONING FLOOR AREA
- RETAIL
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- E ELECTRICAL/TEL./IT
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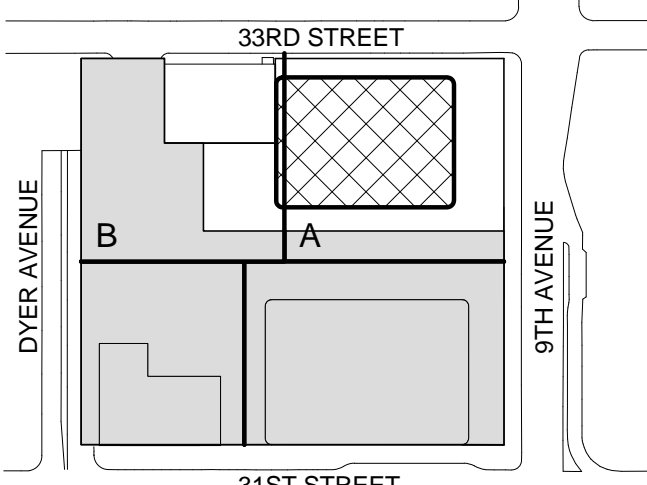
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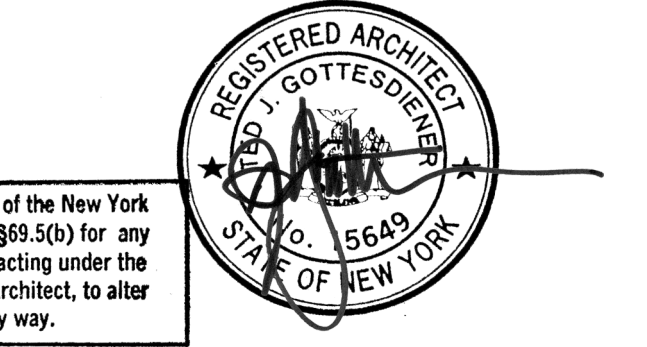
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ZONING FLOOR
AREA
DEDUCTIONS -
LEVEL 45-48


Project No.: 207150
Date: 20 JUN 2014
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File No.: Z-115

B-SCAN Sheet No.: Z-115.00
Sheet No.: Z-115
Page No.: 22 OF 28

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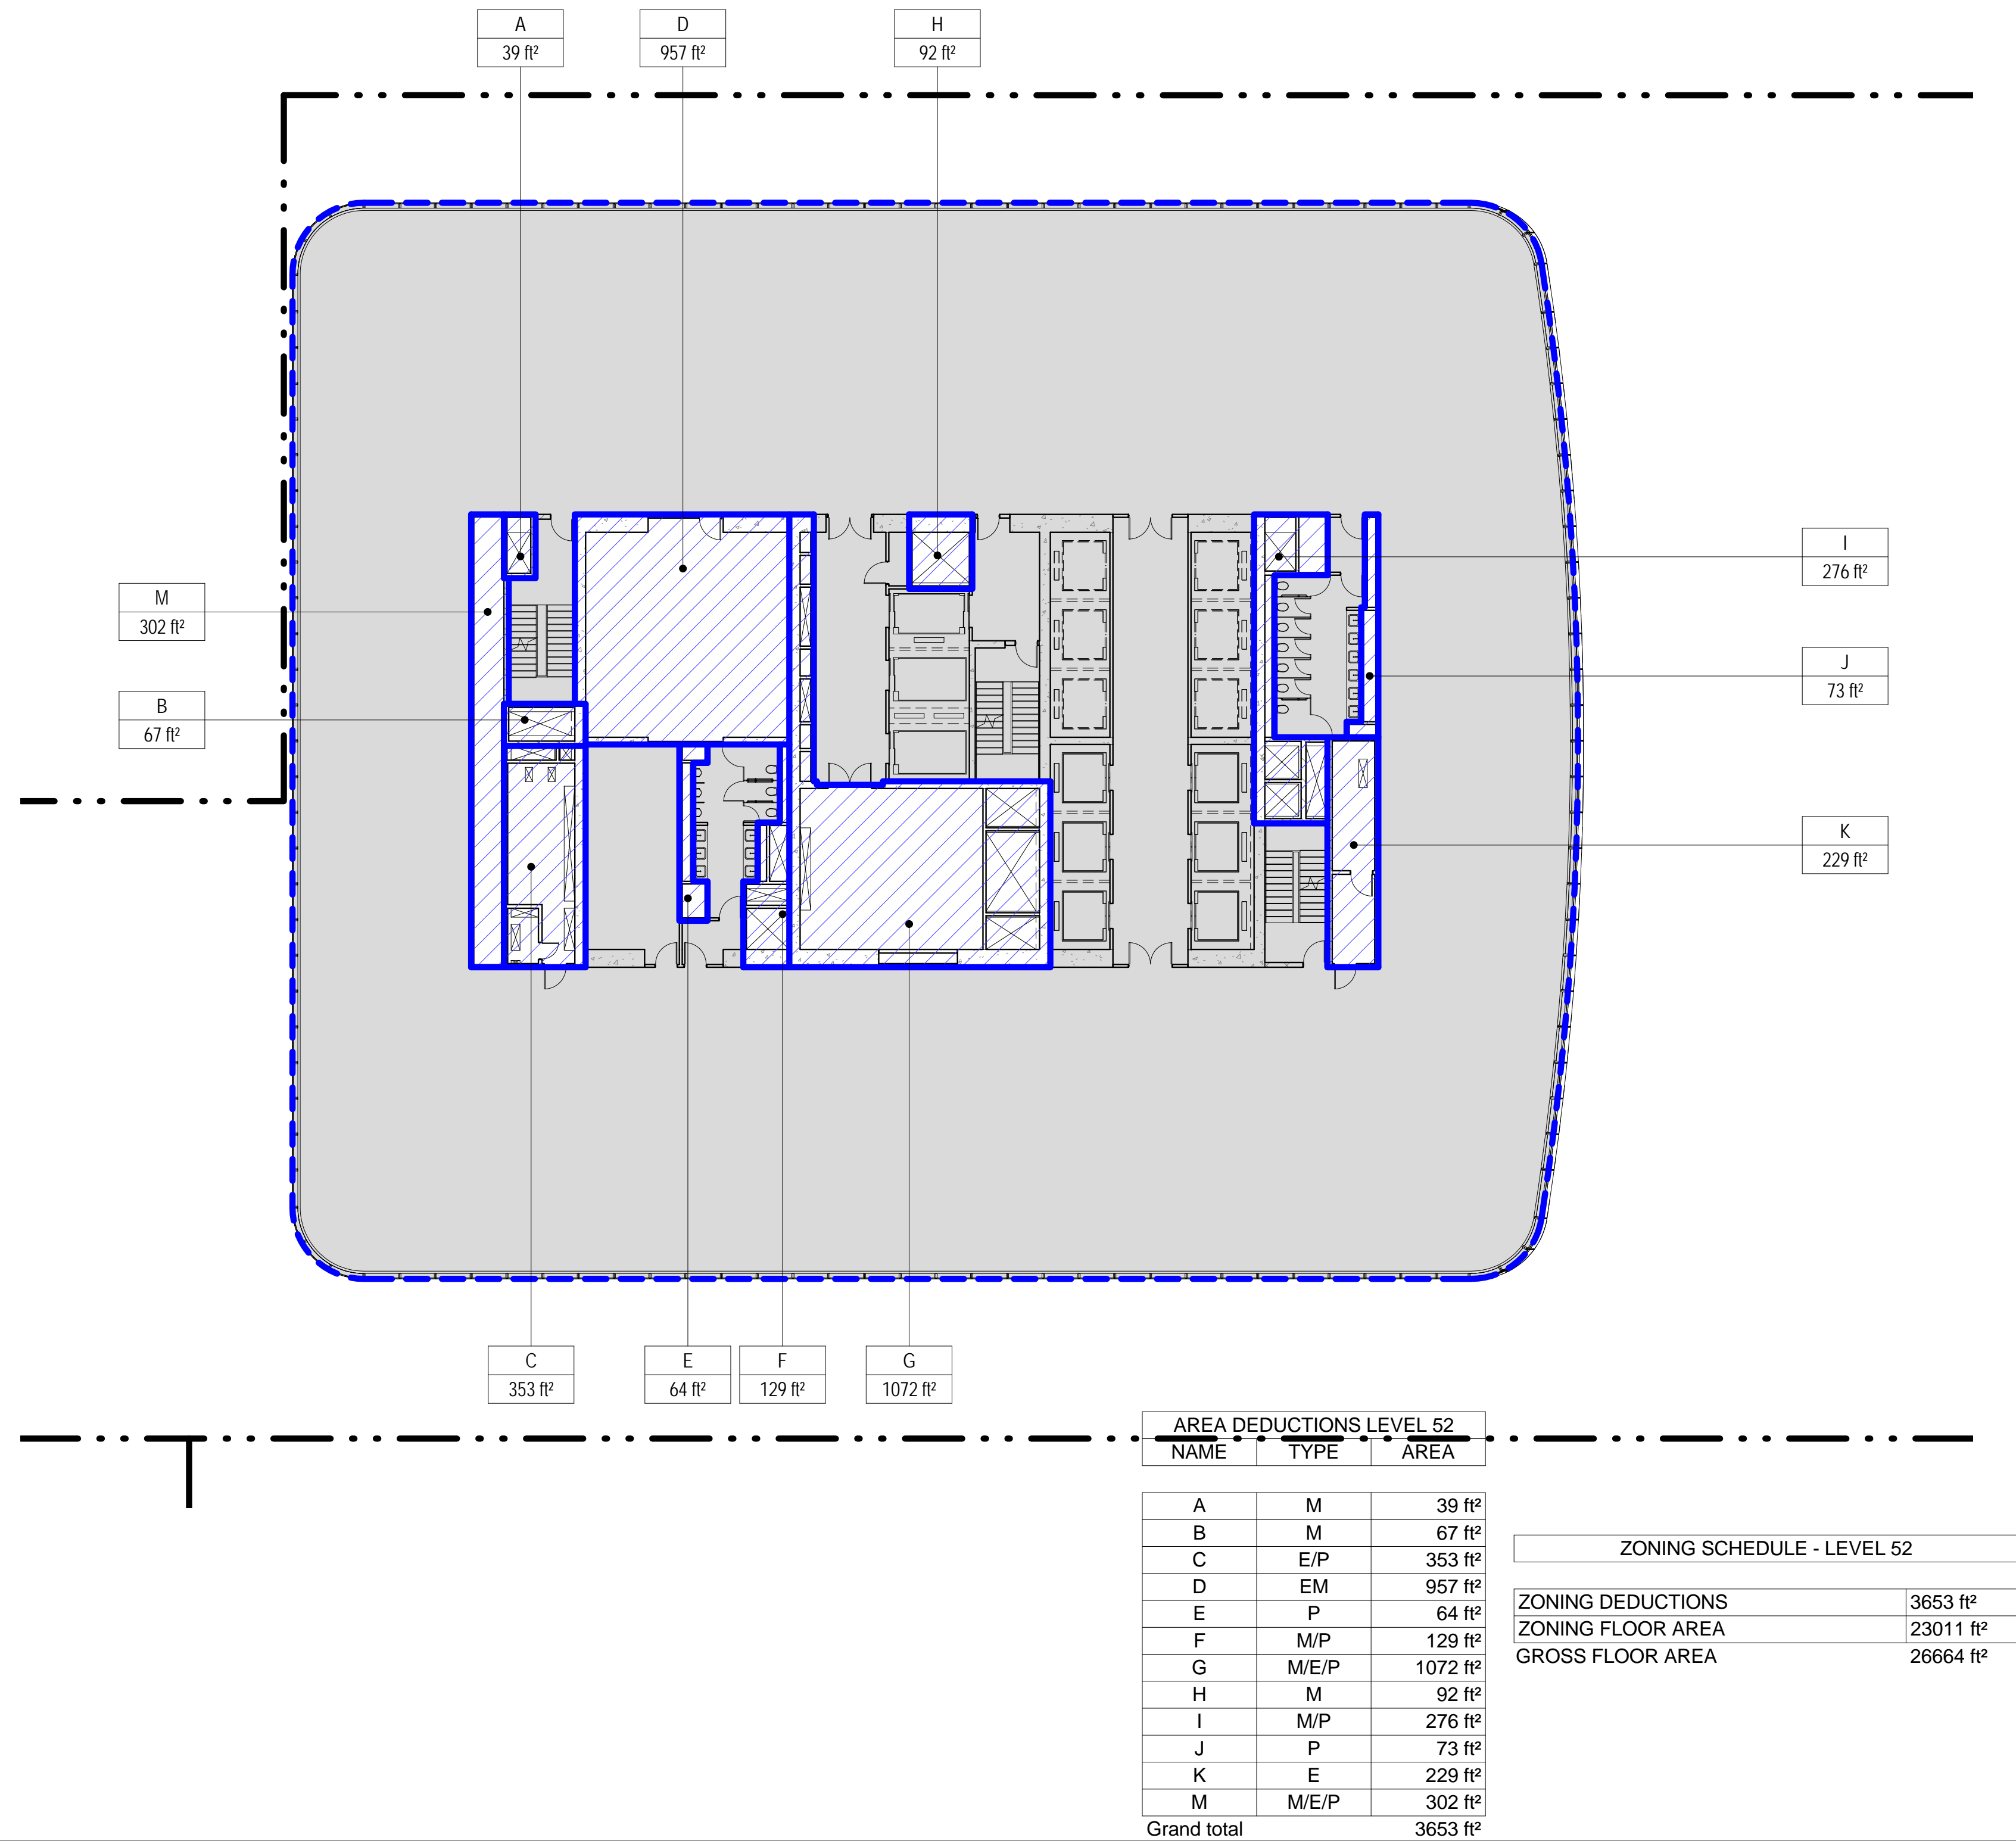
3 LEVEL 51 PLAN

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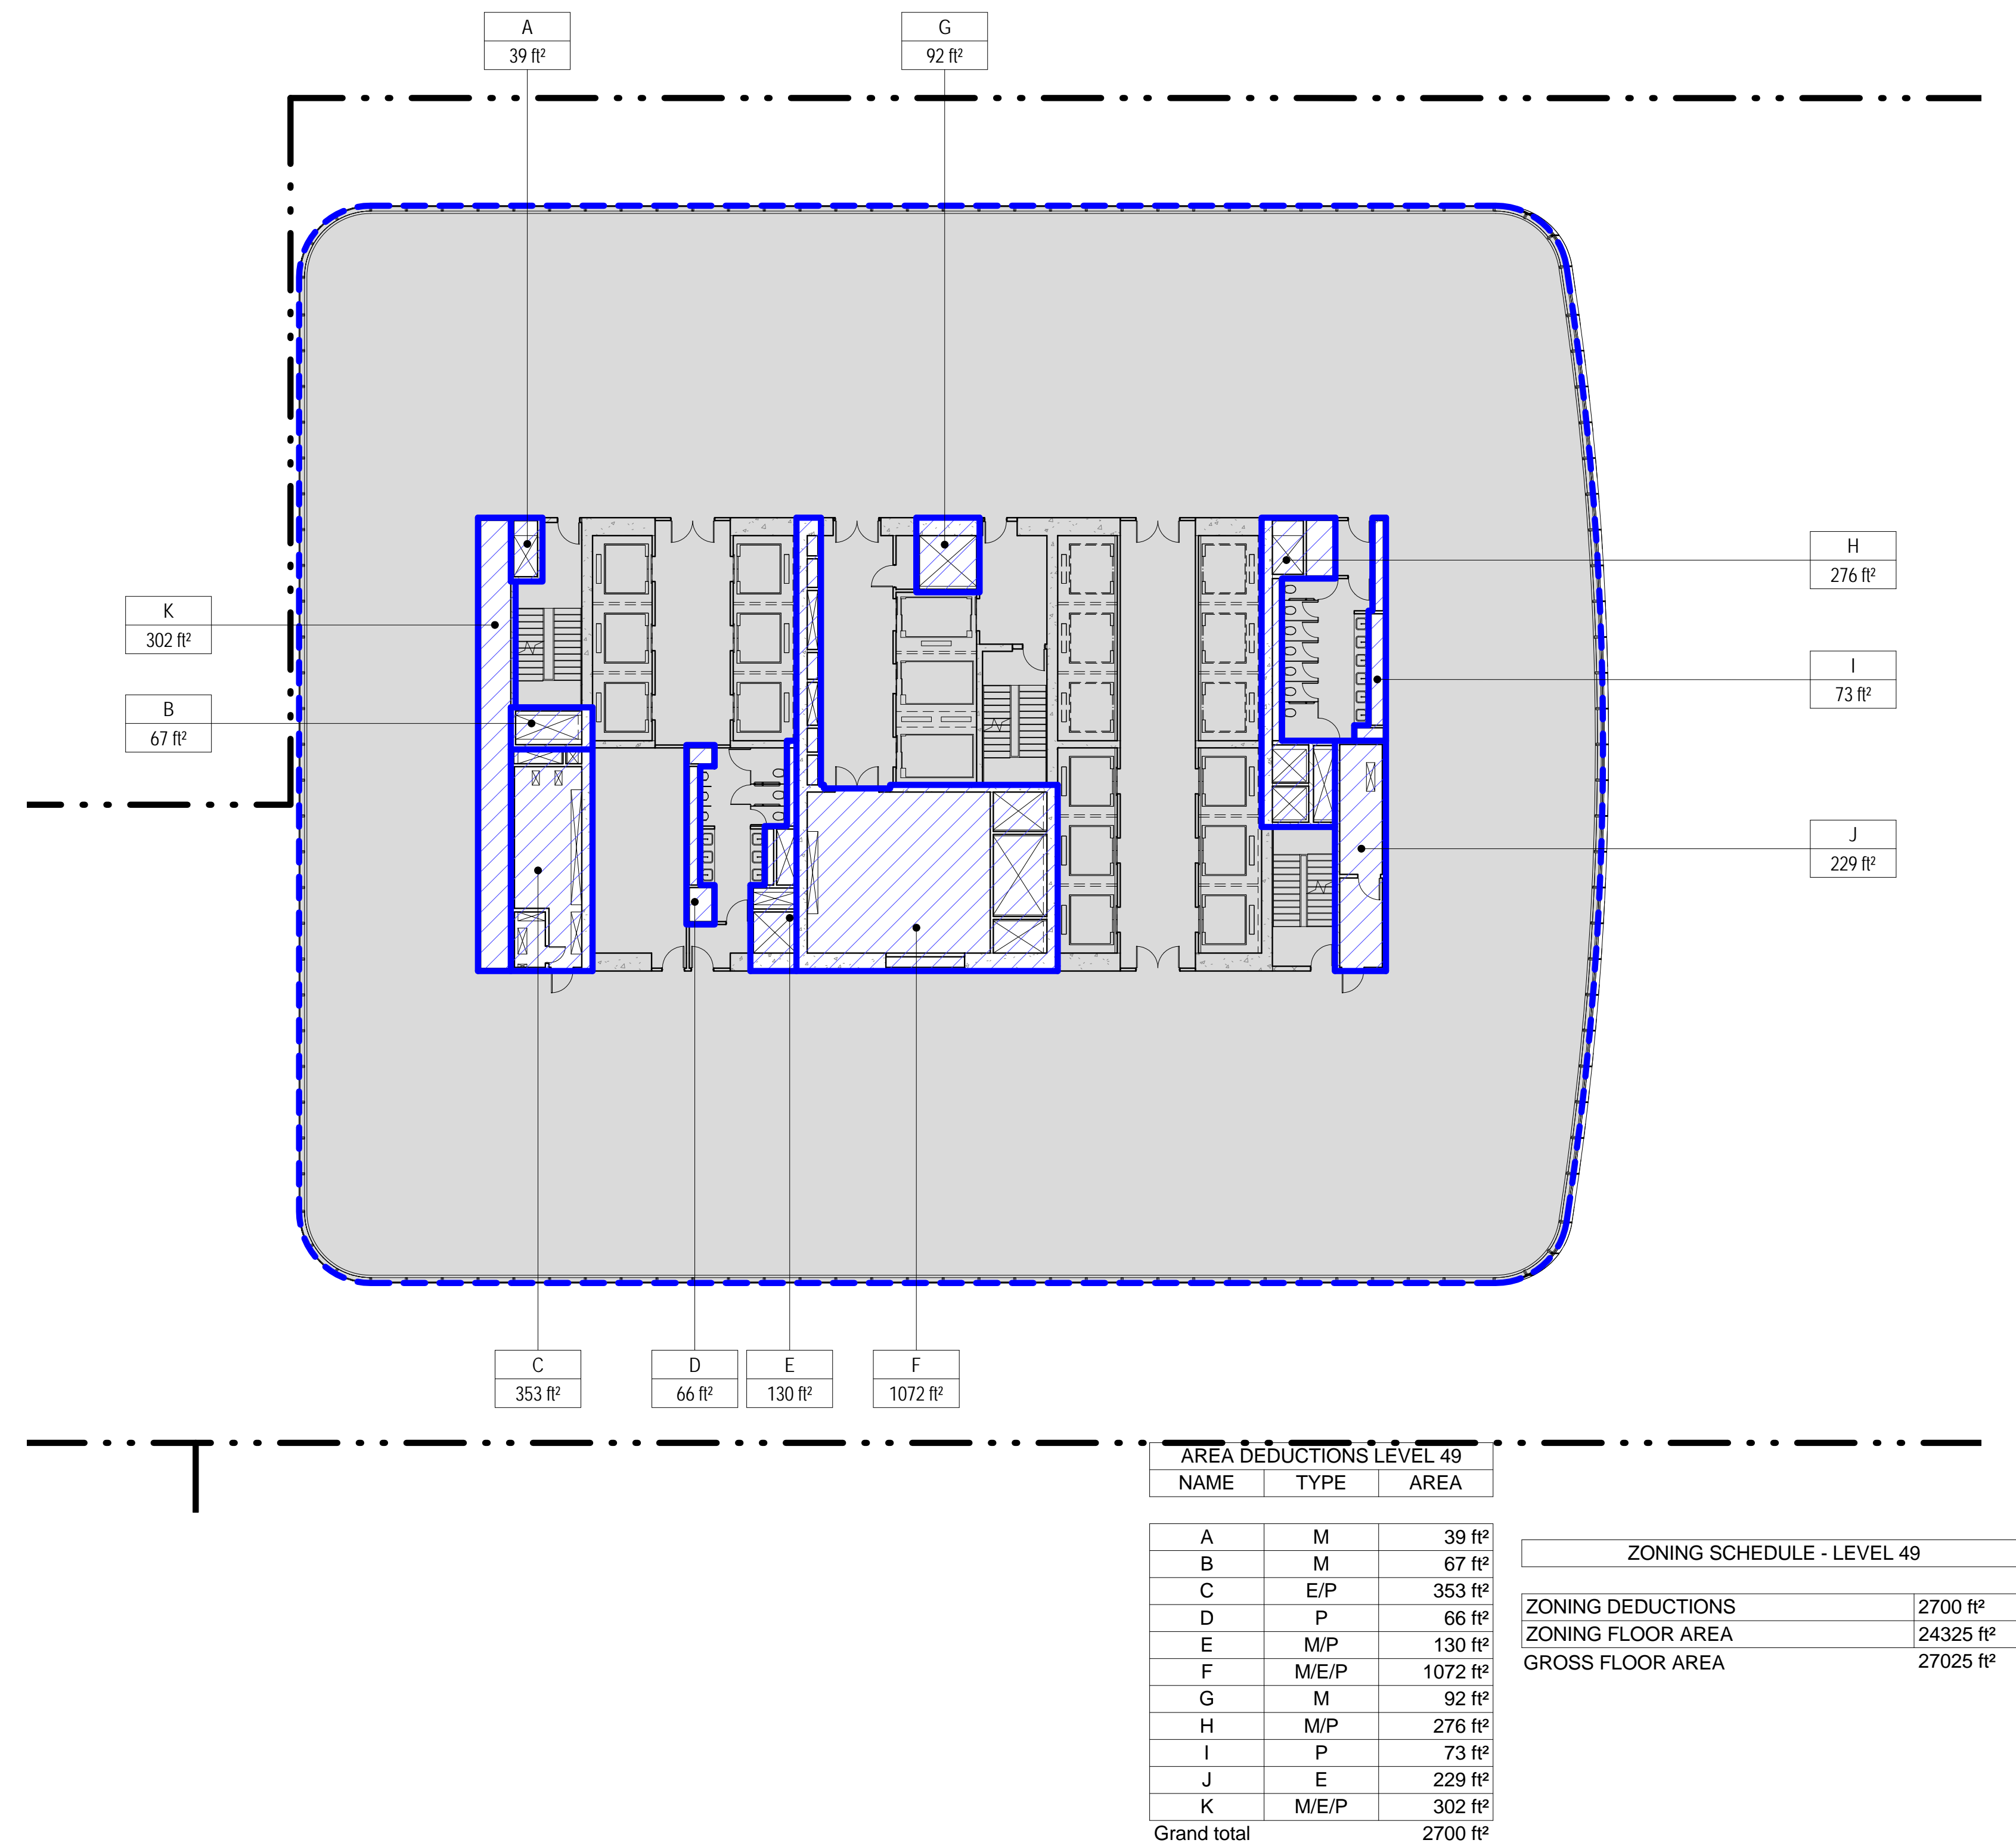
4 LEVEL 52 PLAN

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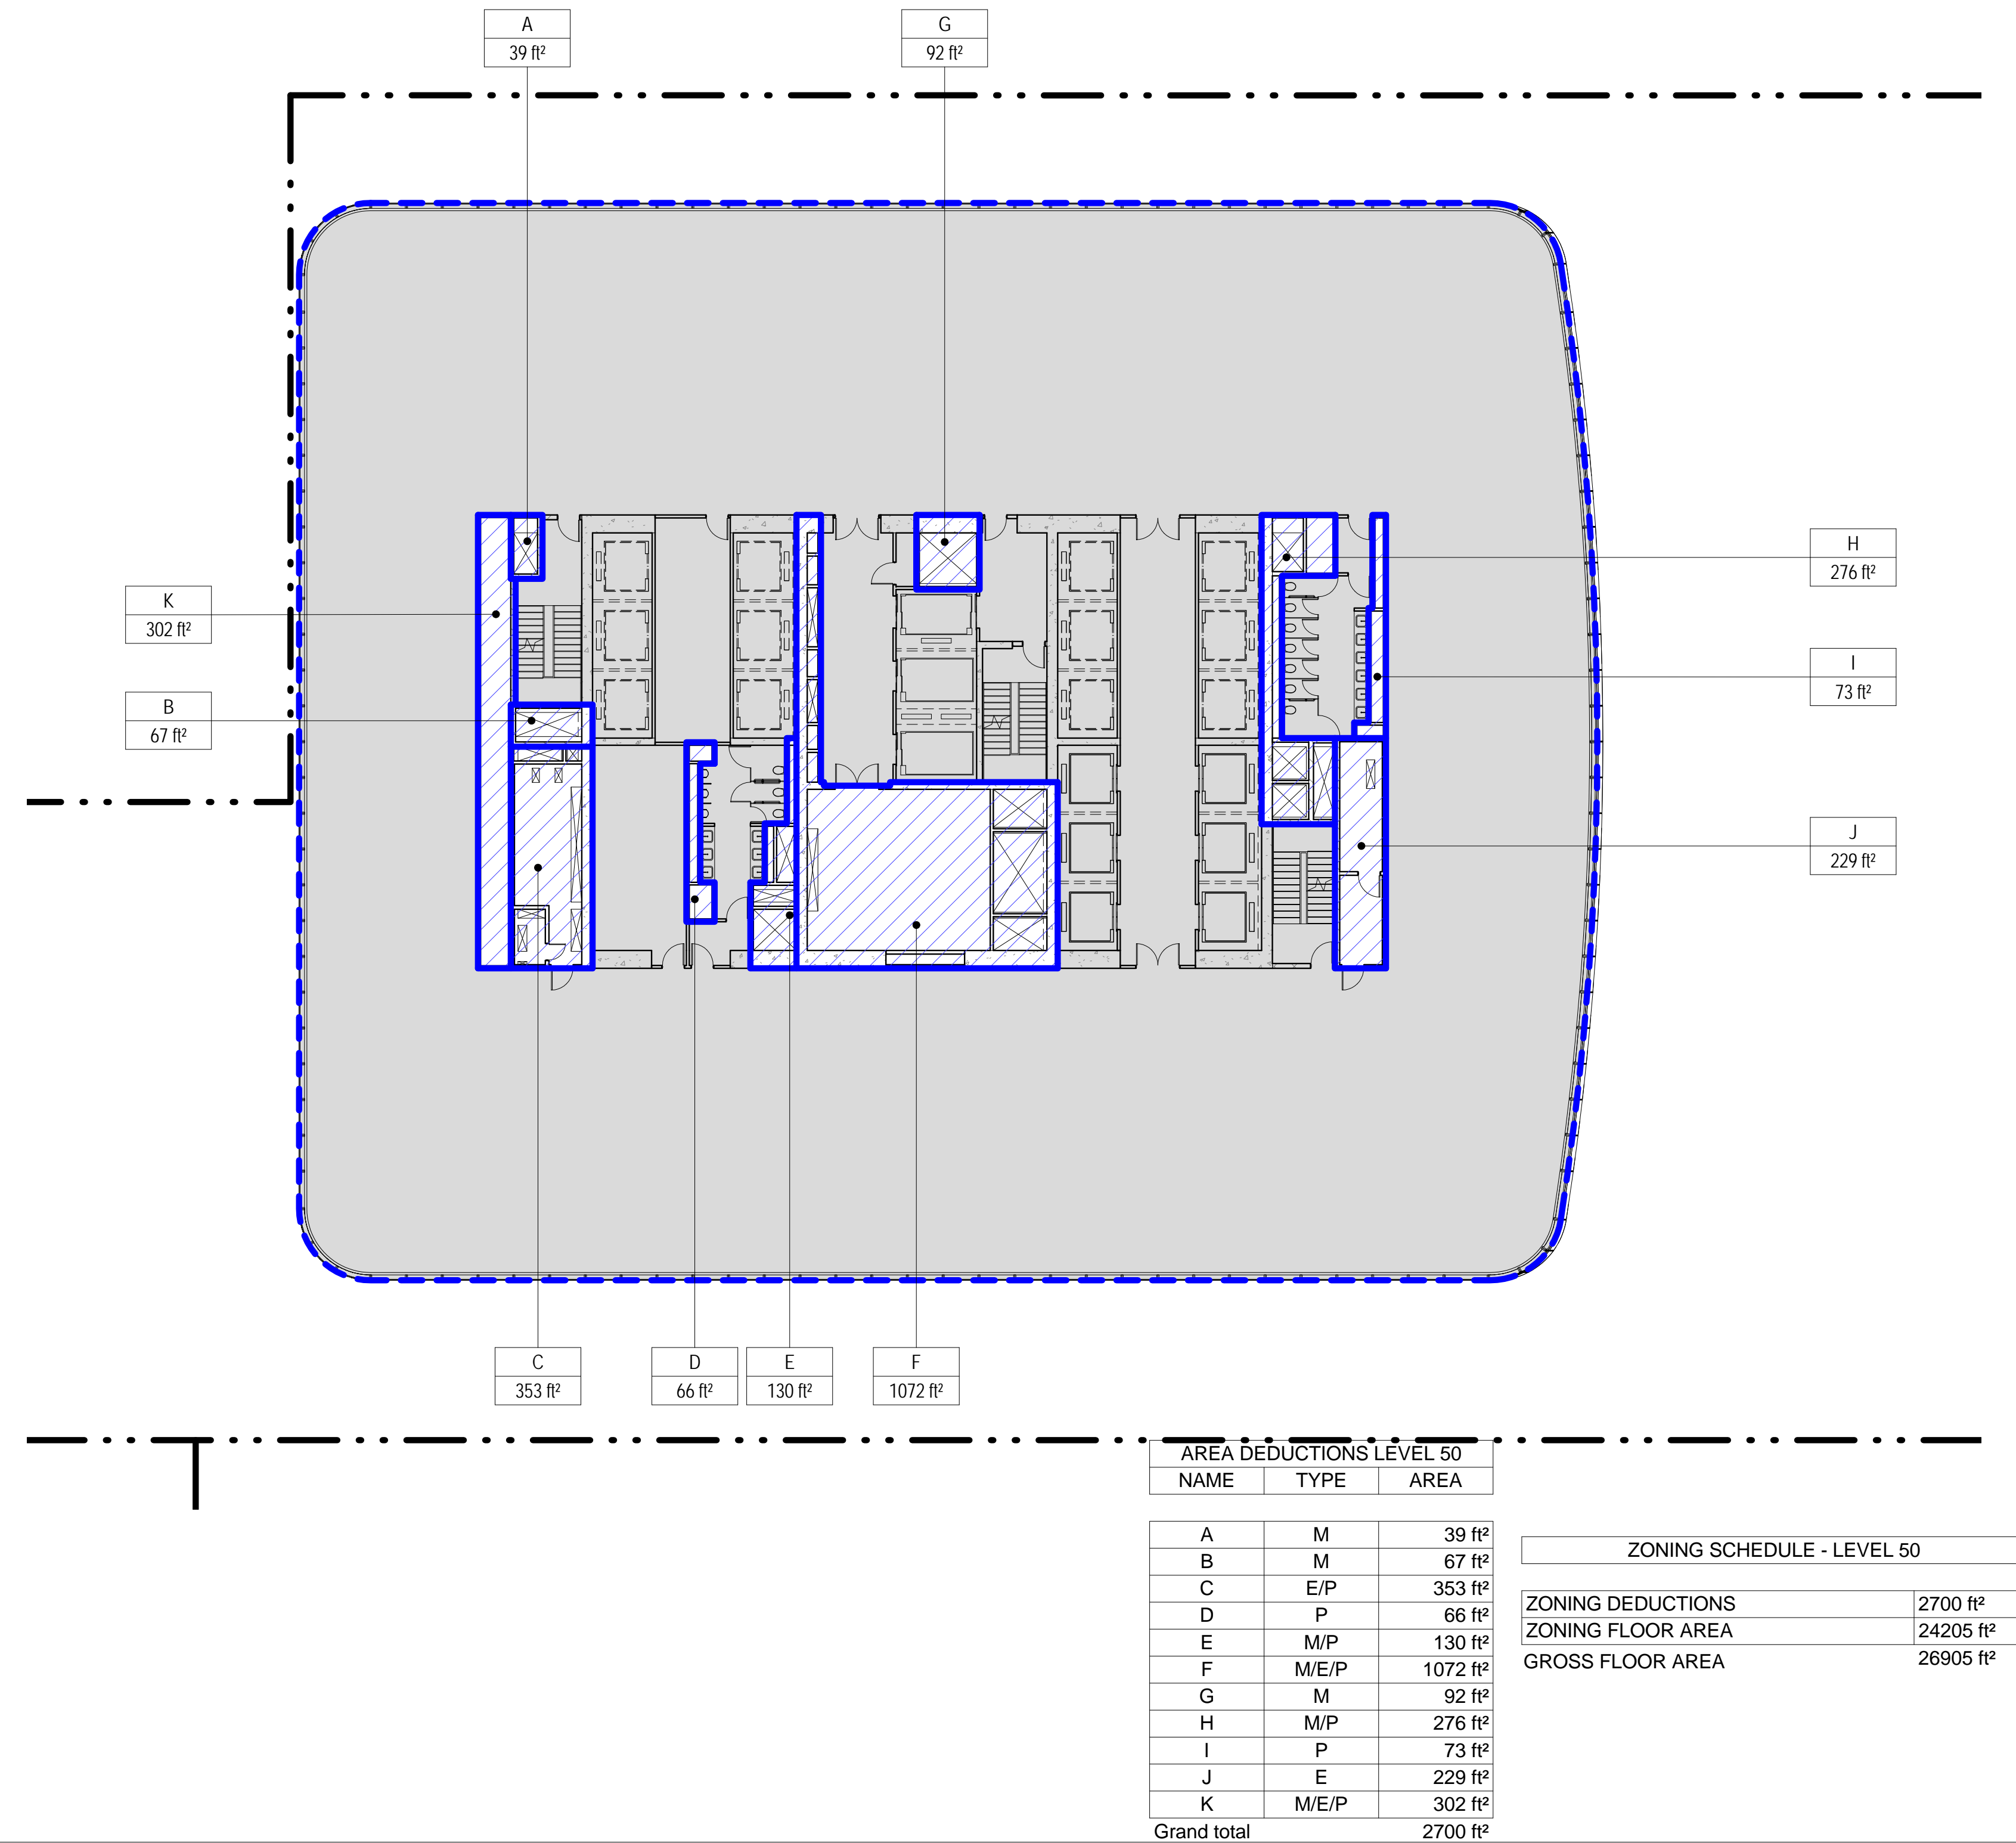
1 LEVEL 49 PLAN

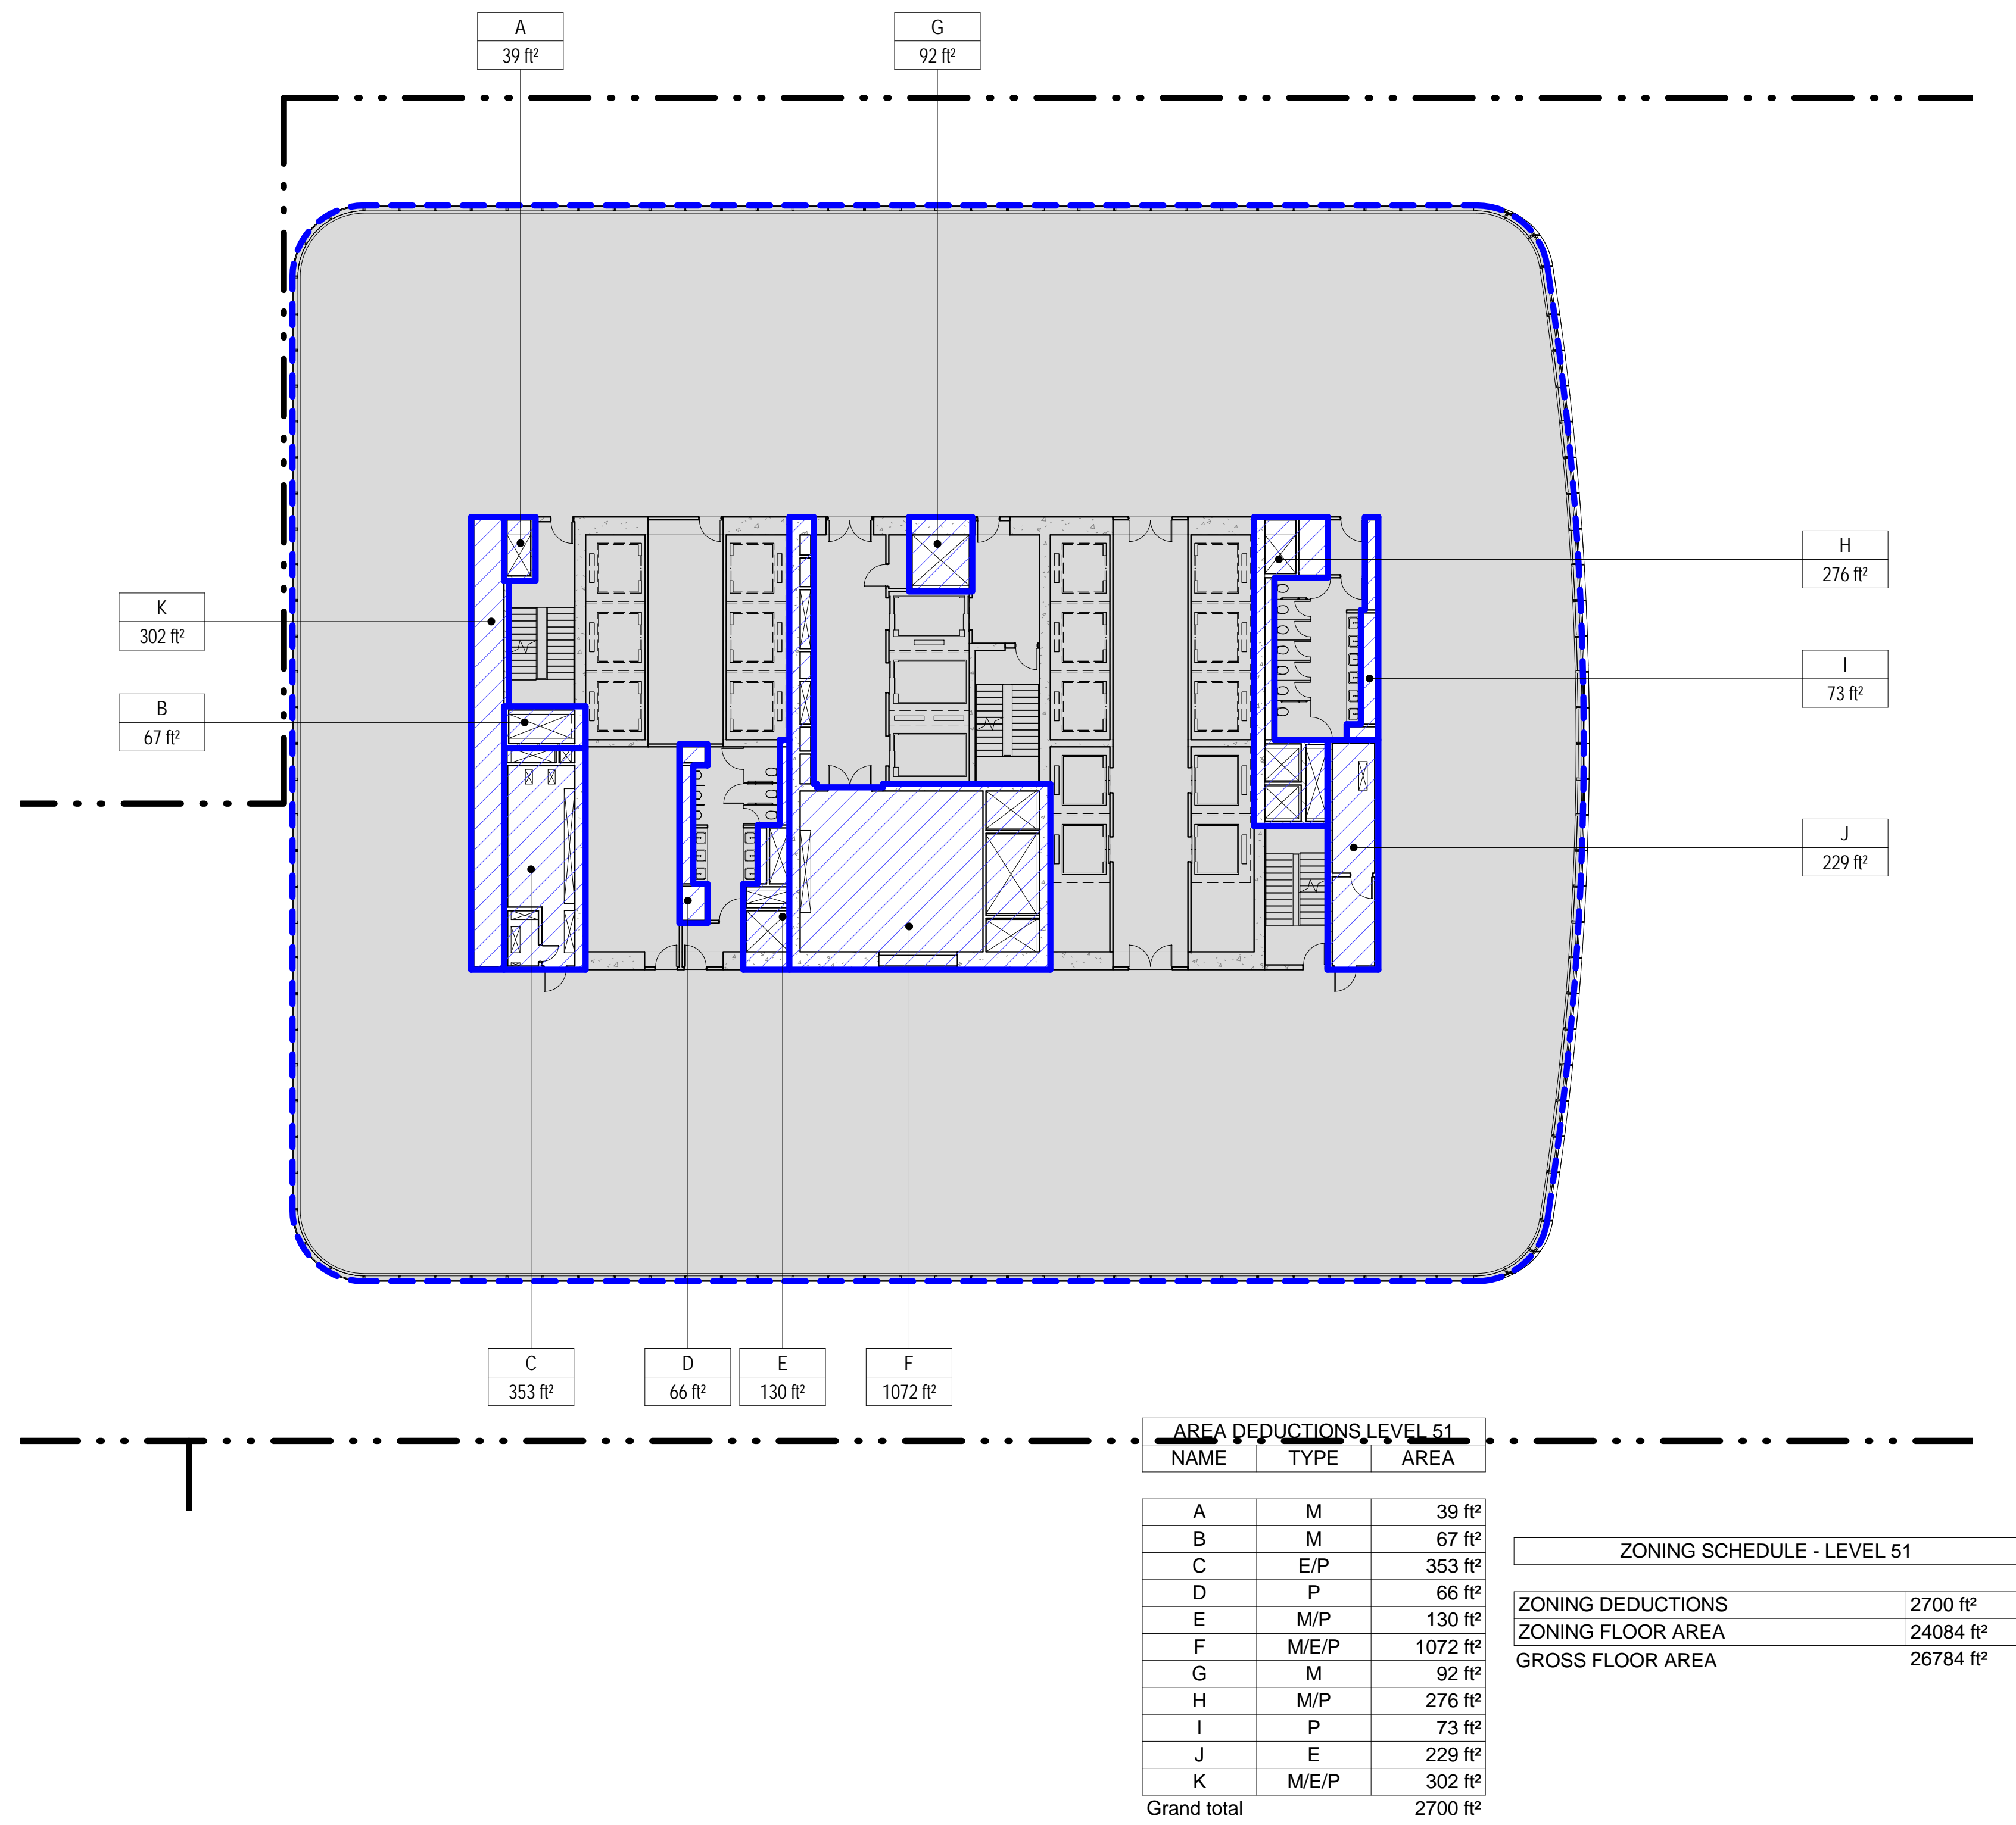SCALE: 1/16" = 1'-0"



2 LEVEL 50 PLAN

SCALE: 1/16" = 1'-0"



ZONING LEGENDS

- GROSS BUILDING AREA
- ZONING AREA DEDUCTIONS
- ZONING FLOOR AREA
- RETAIL
- MR MECHANICAL ROOM
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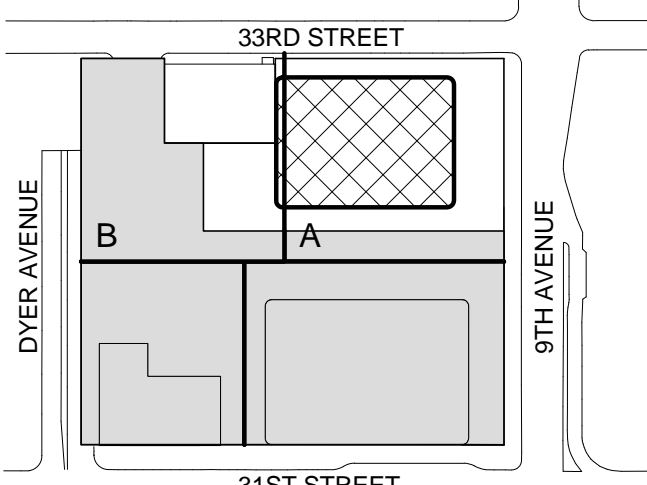
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ZONING FLOOR
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DEDUCTIONS -
LEVEL 49-52

Project No.:

207150

Date:

20 JUN 2014

Scale:

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File No.:

Z-116

B-SCAN Sheet No.:

Z-116.00

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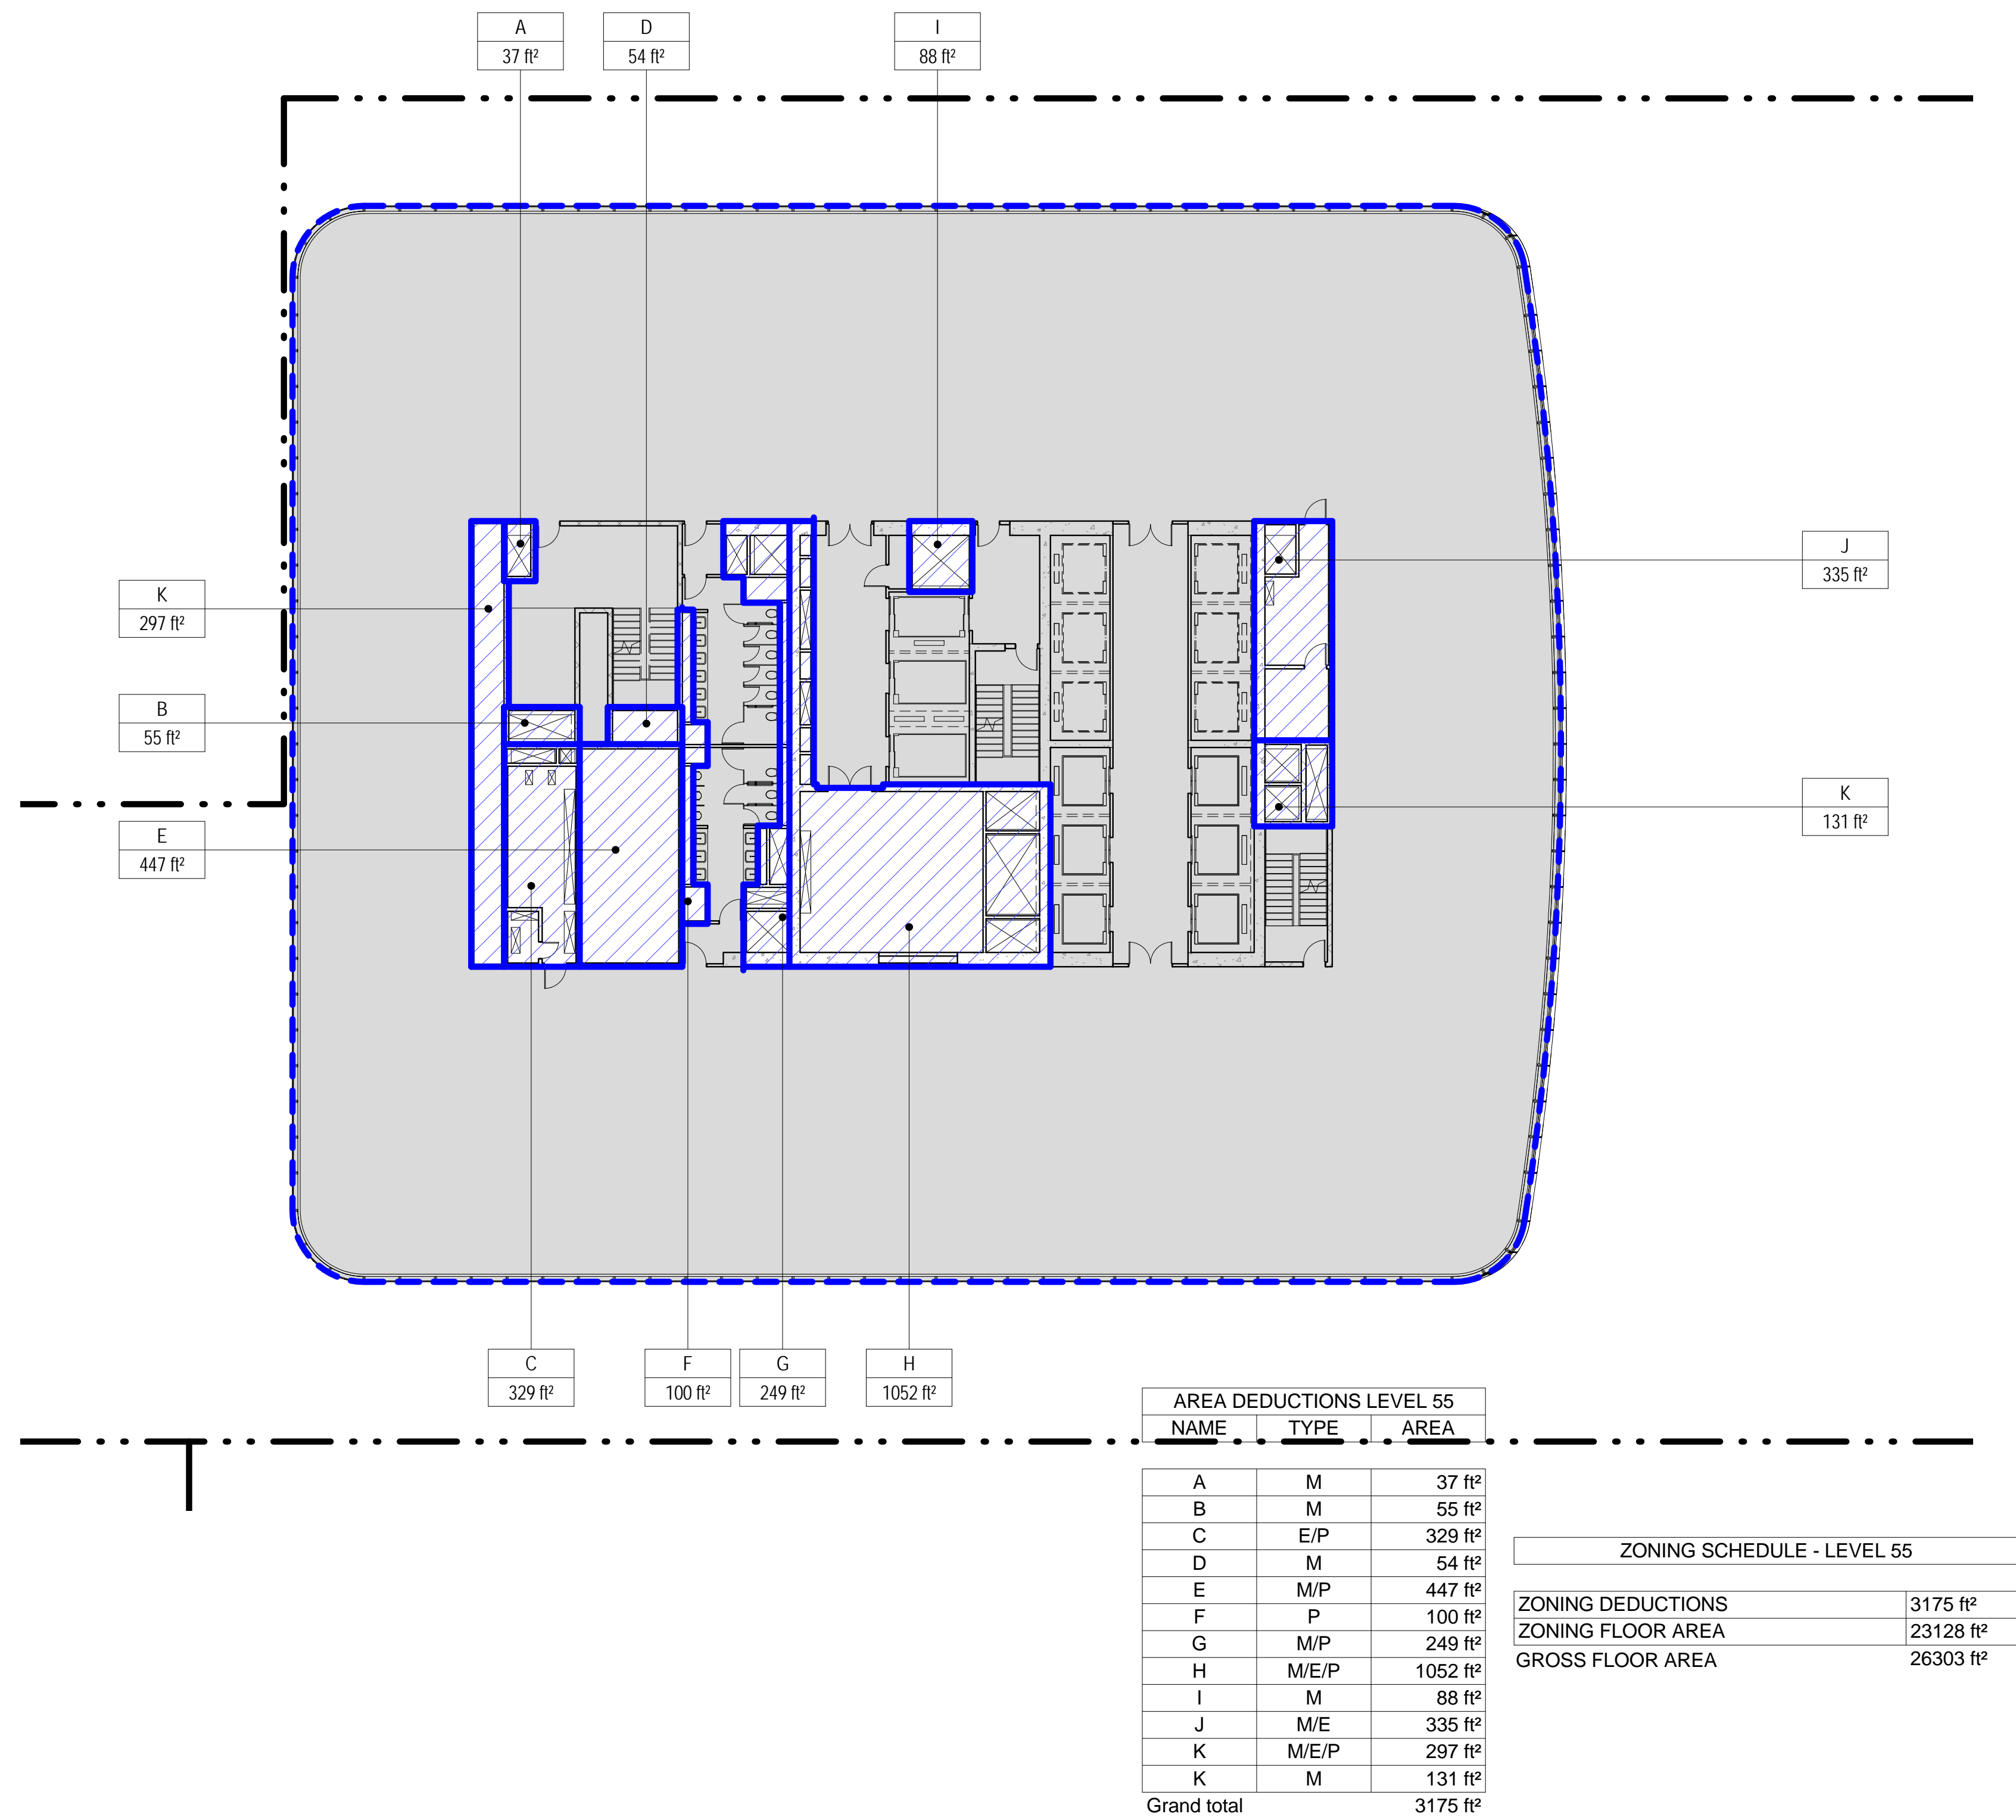
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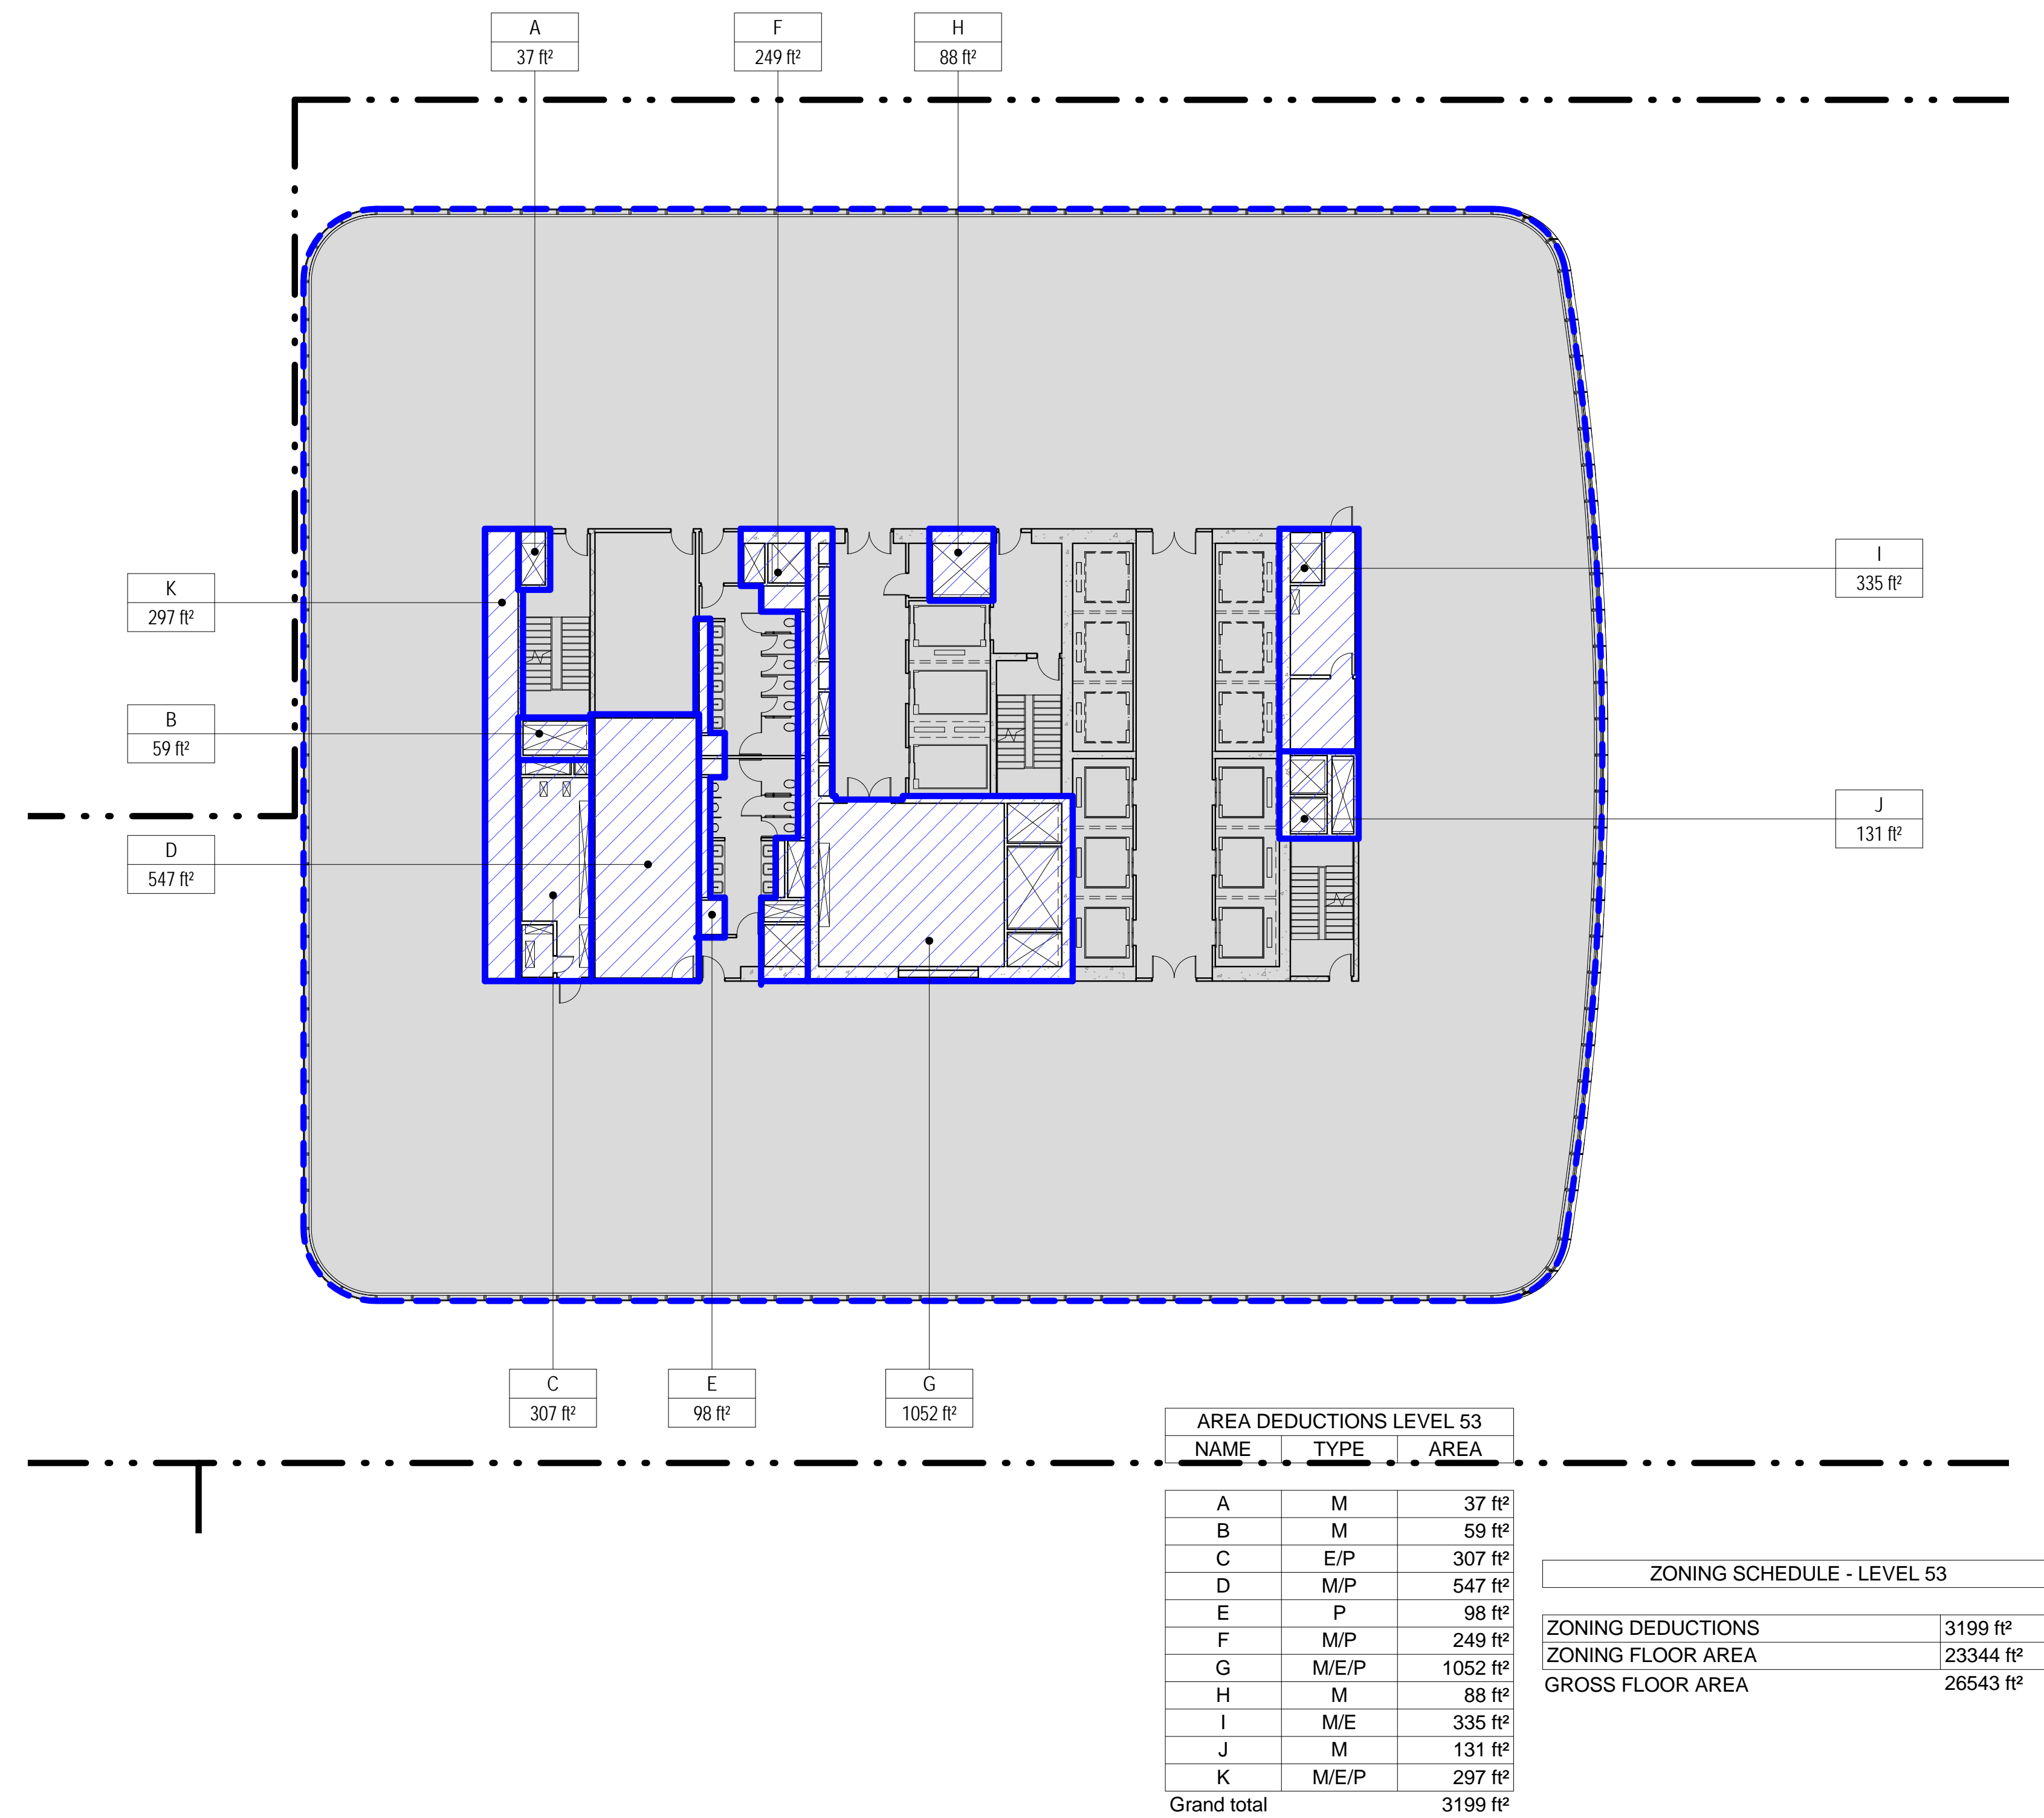
3 LEVEL 55 PLAN

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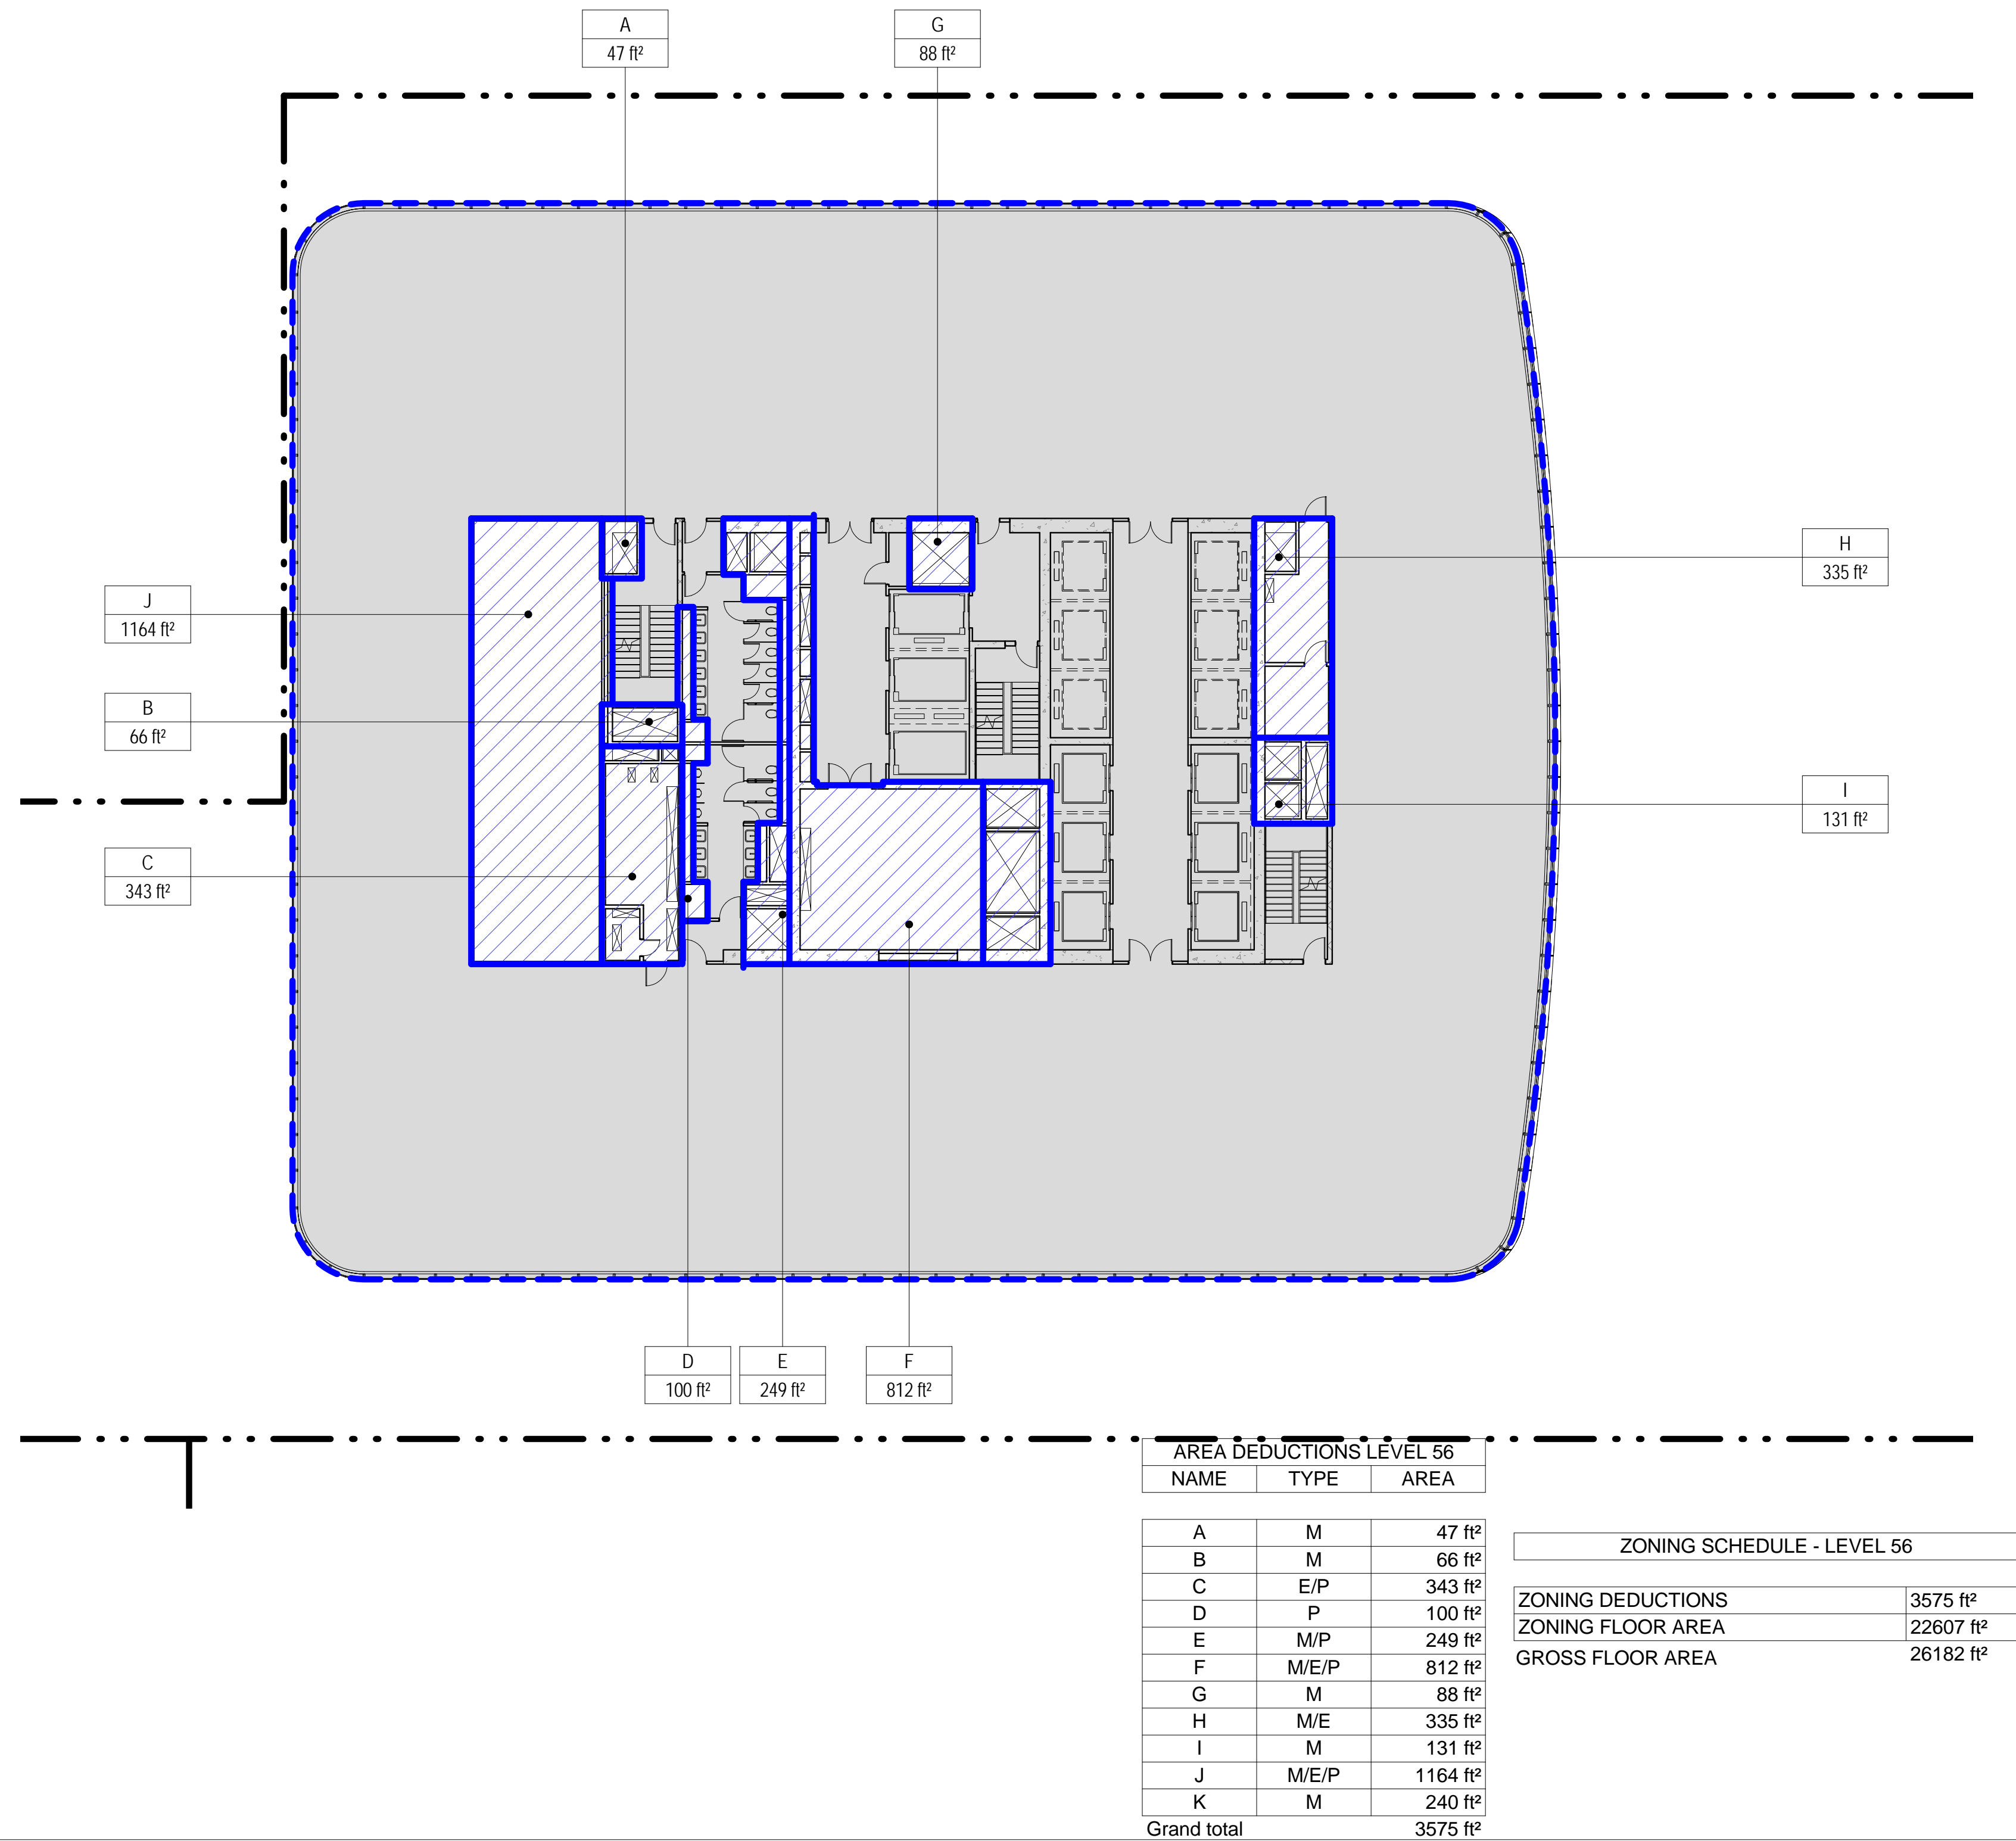
1 LEVEL 53 PLAN

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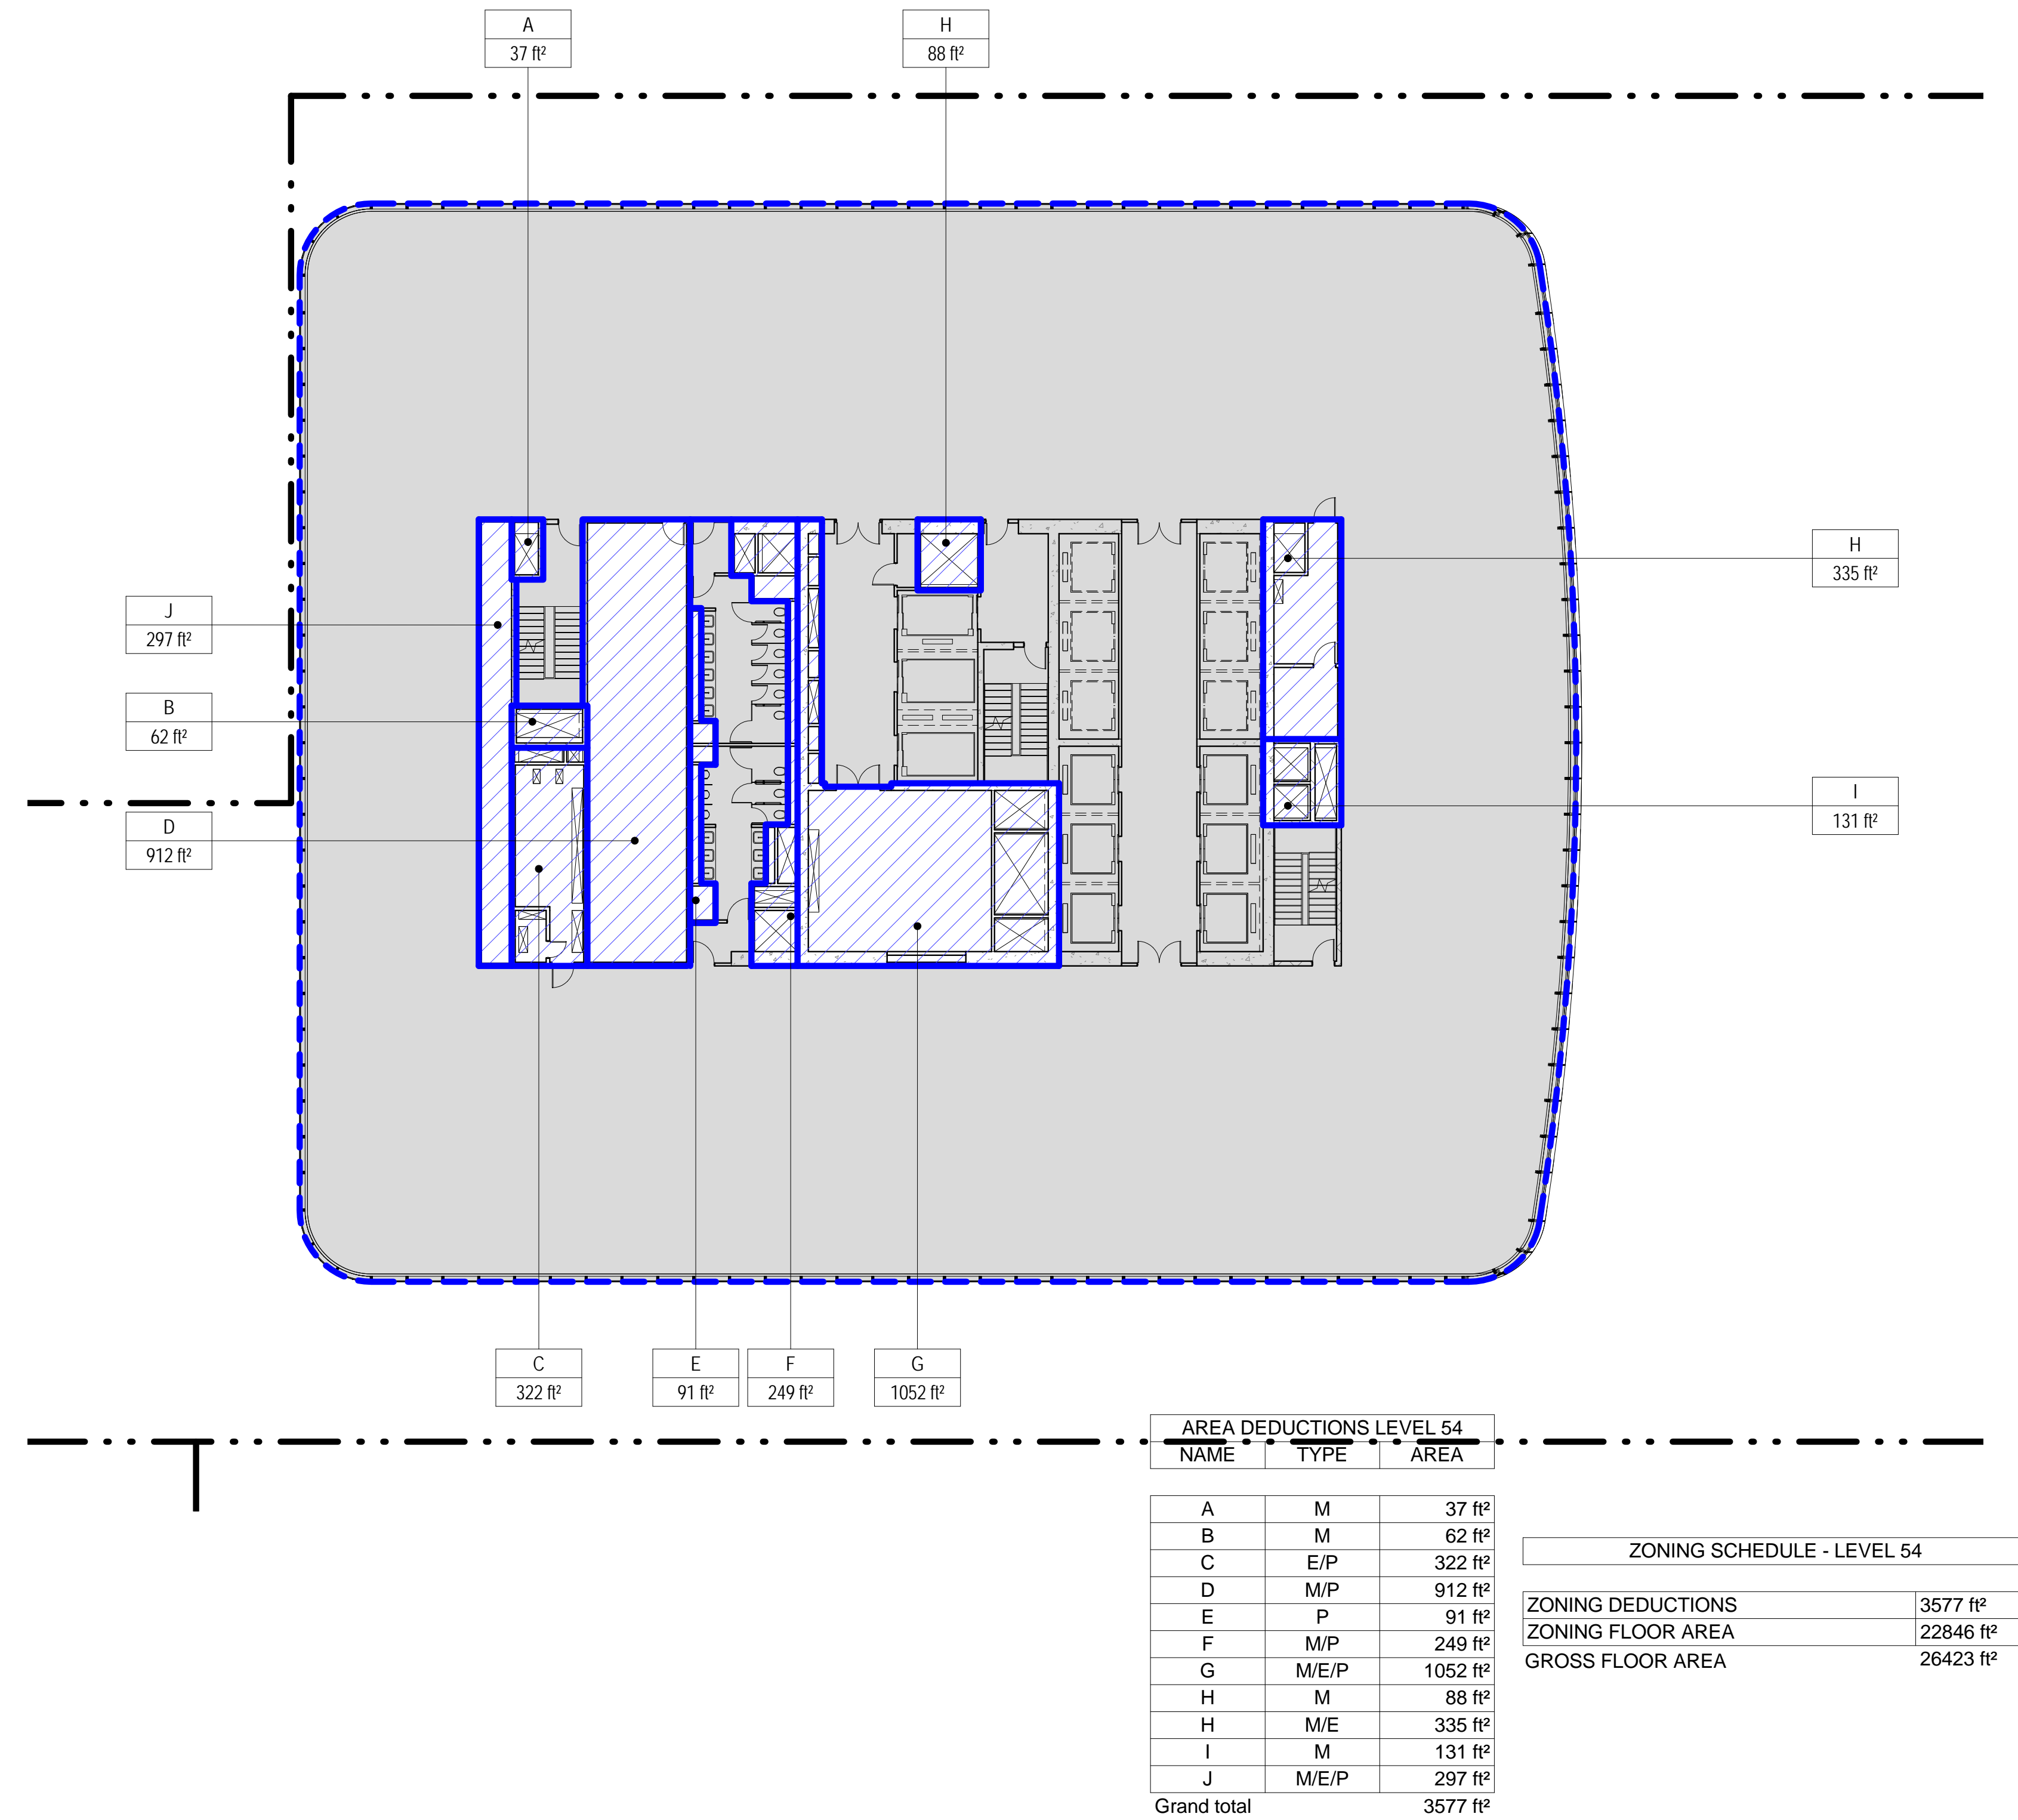
4 LEVEL 56 PLAN

SCALE: 1/16" = 1'-0"



2 LEVEL 54 PLAN

SCALE: 1/16" = 1'-0"



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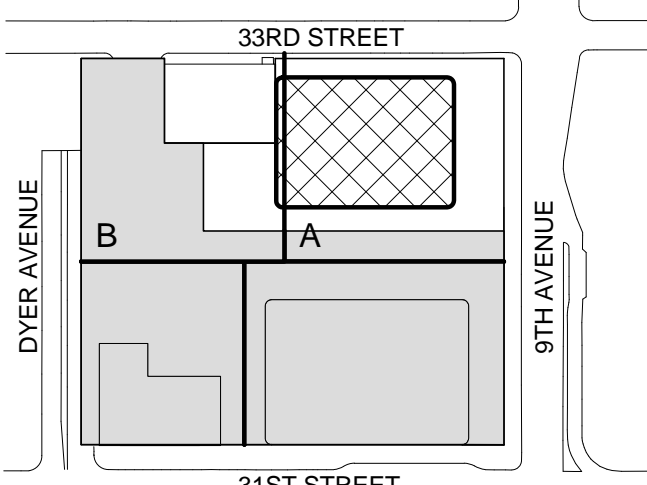
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LEVEL 53-56

Project No.:

207150

Date:

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File No.:

2-117

B-SCAN Sheet No.:

Z-117.00

Sheet No.:


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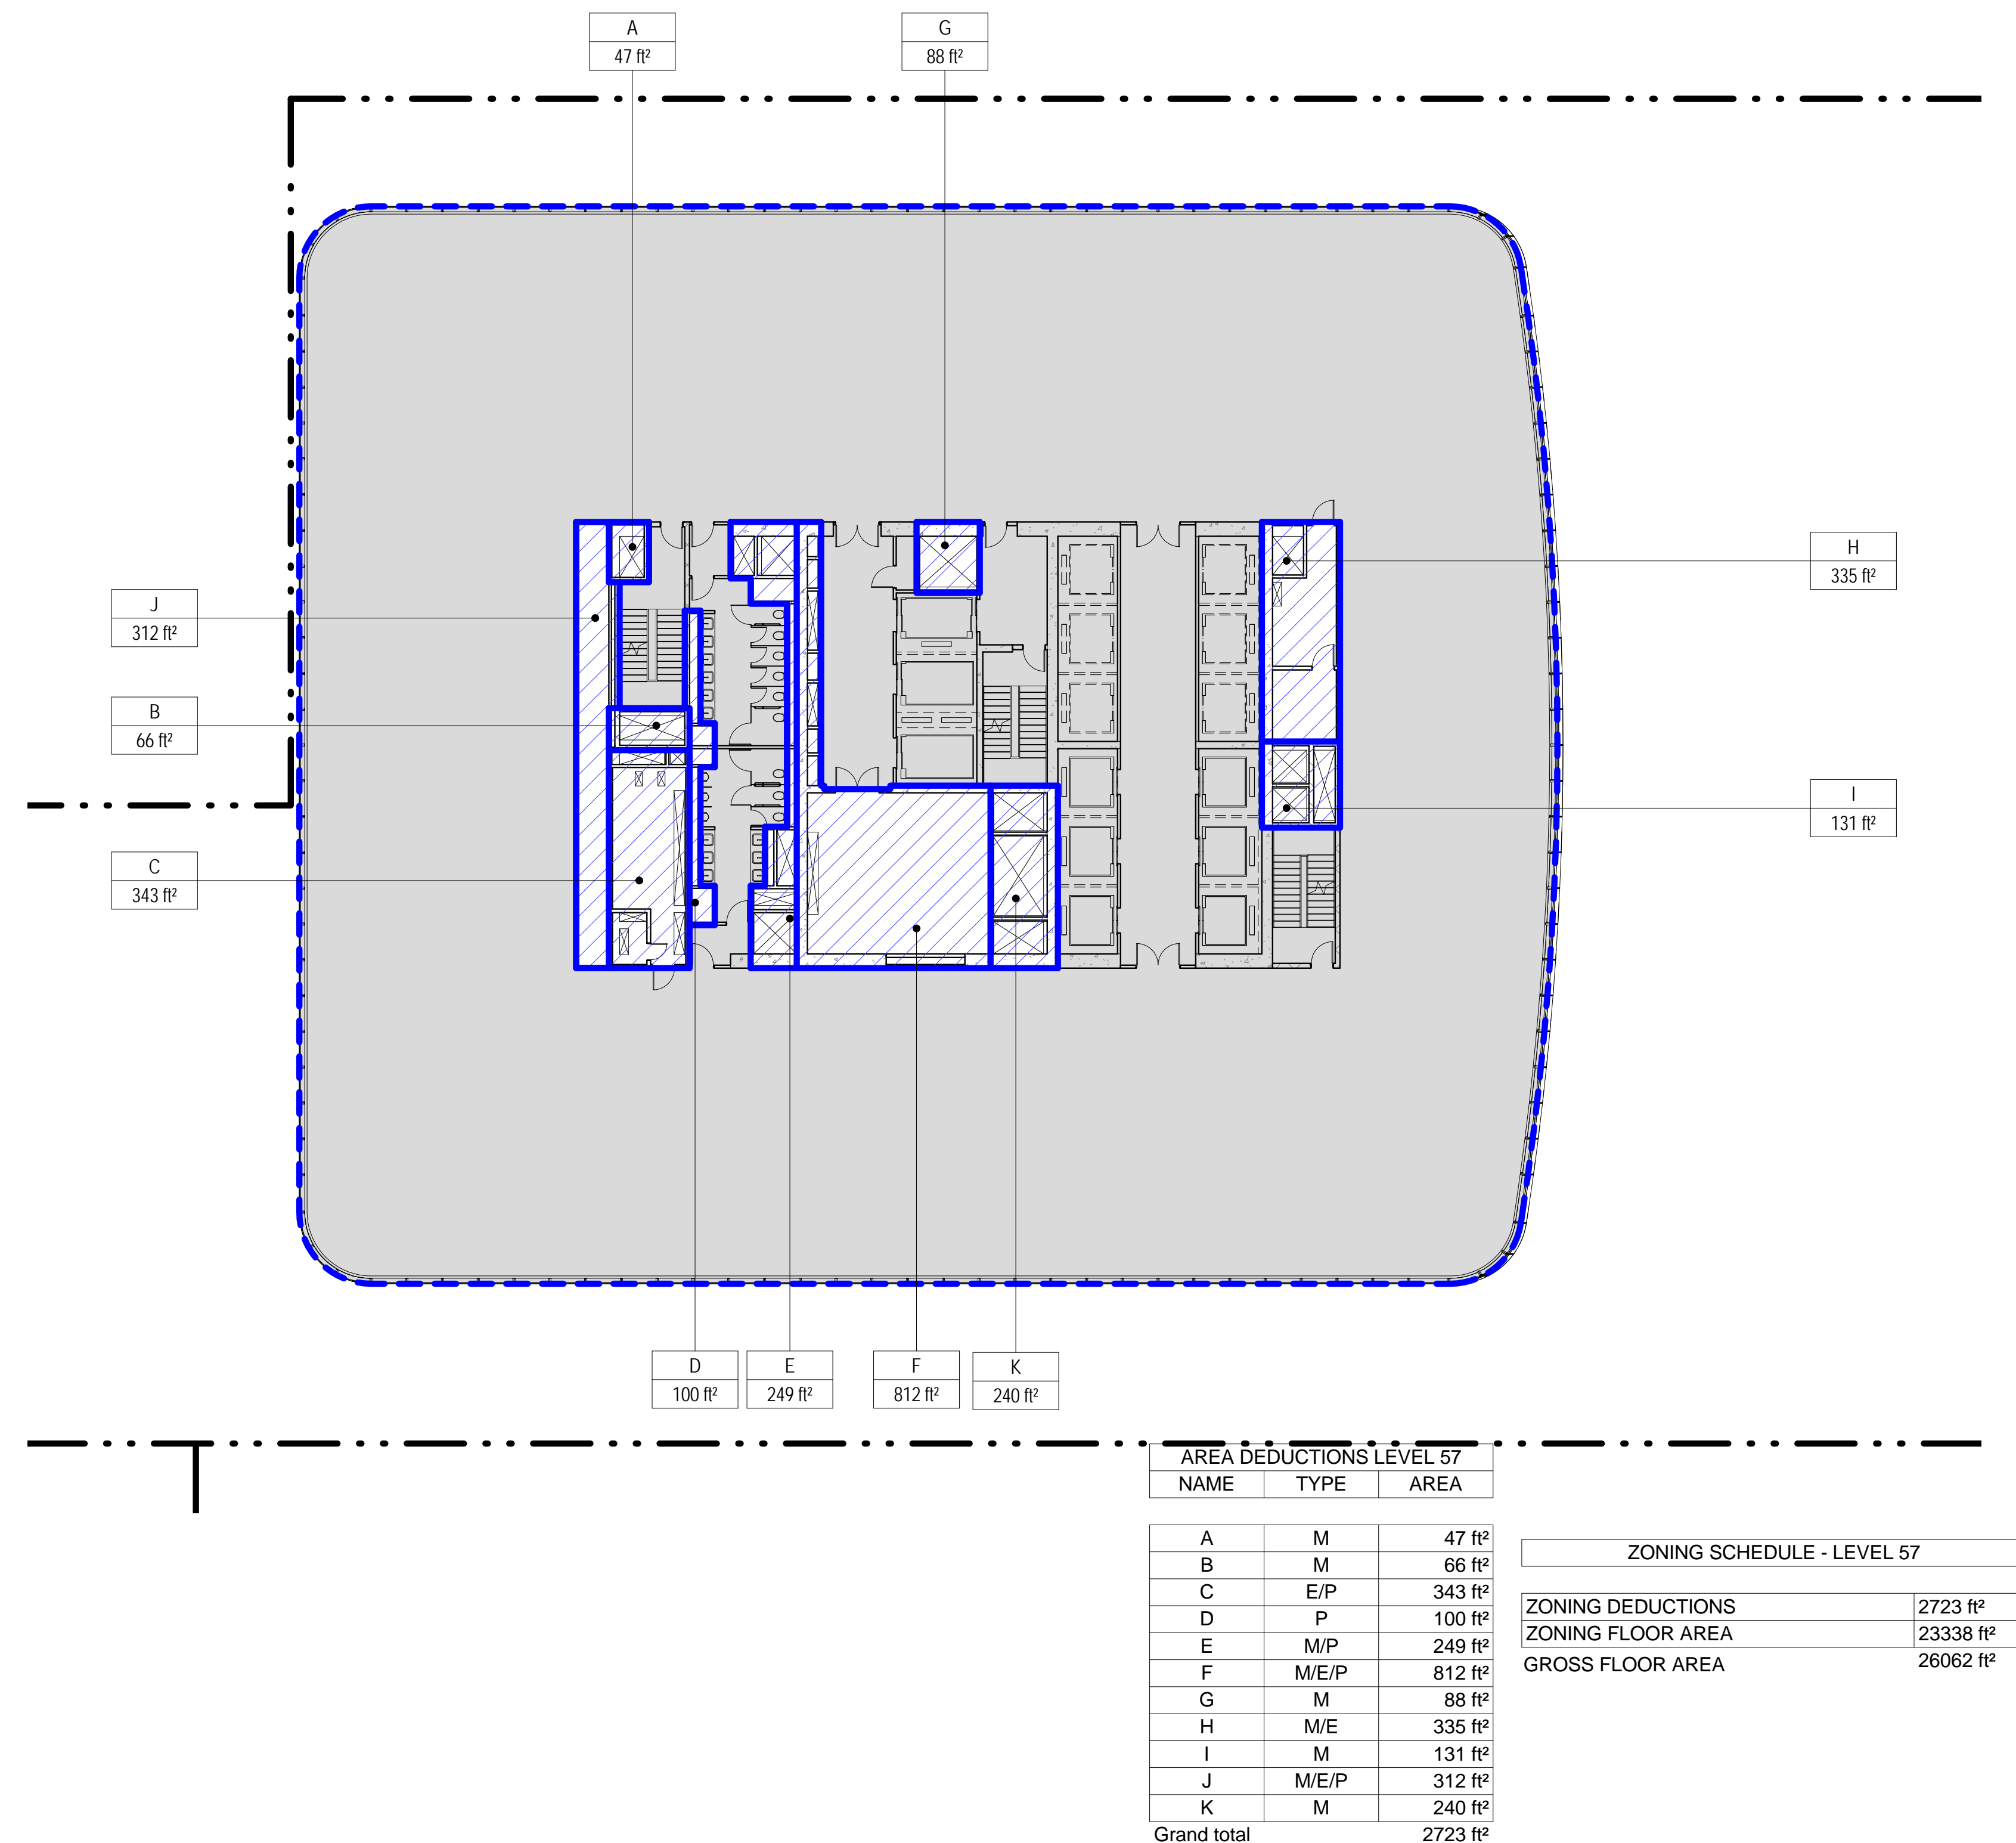
3 LEVEL 59 PLAN

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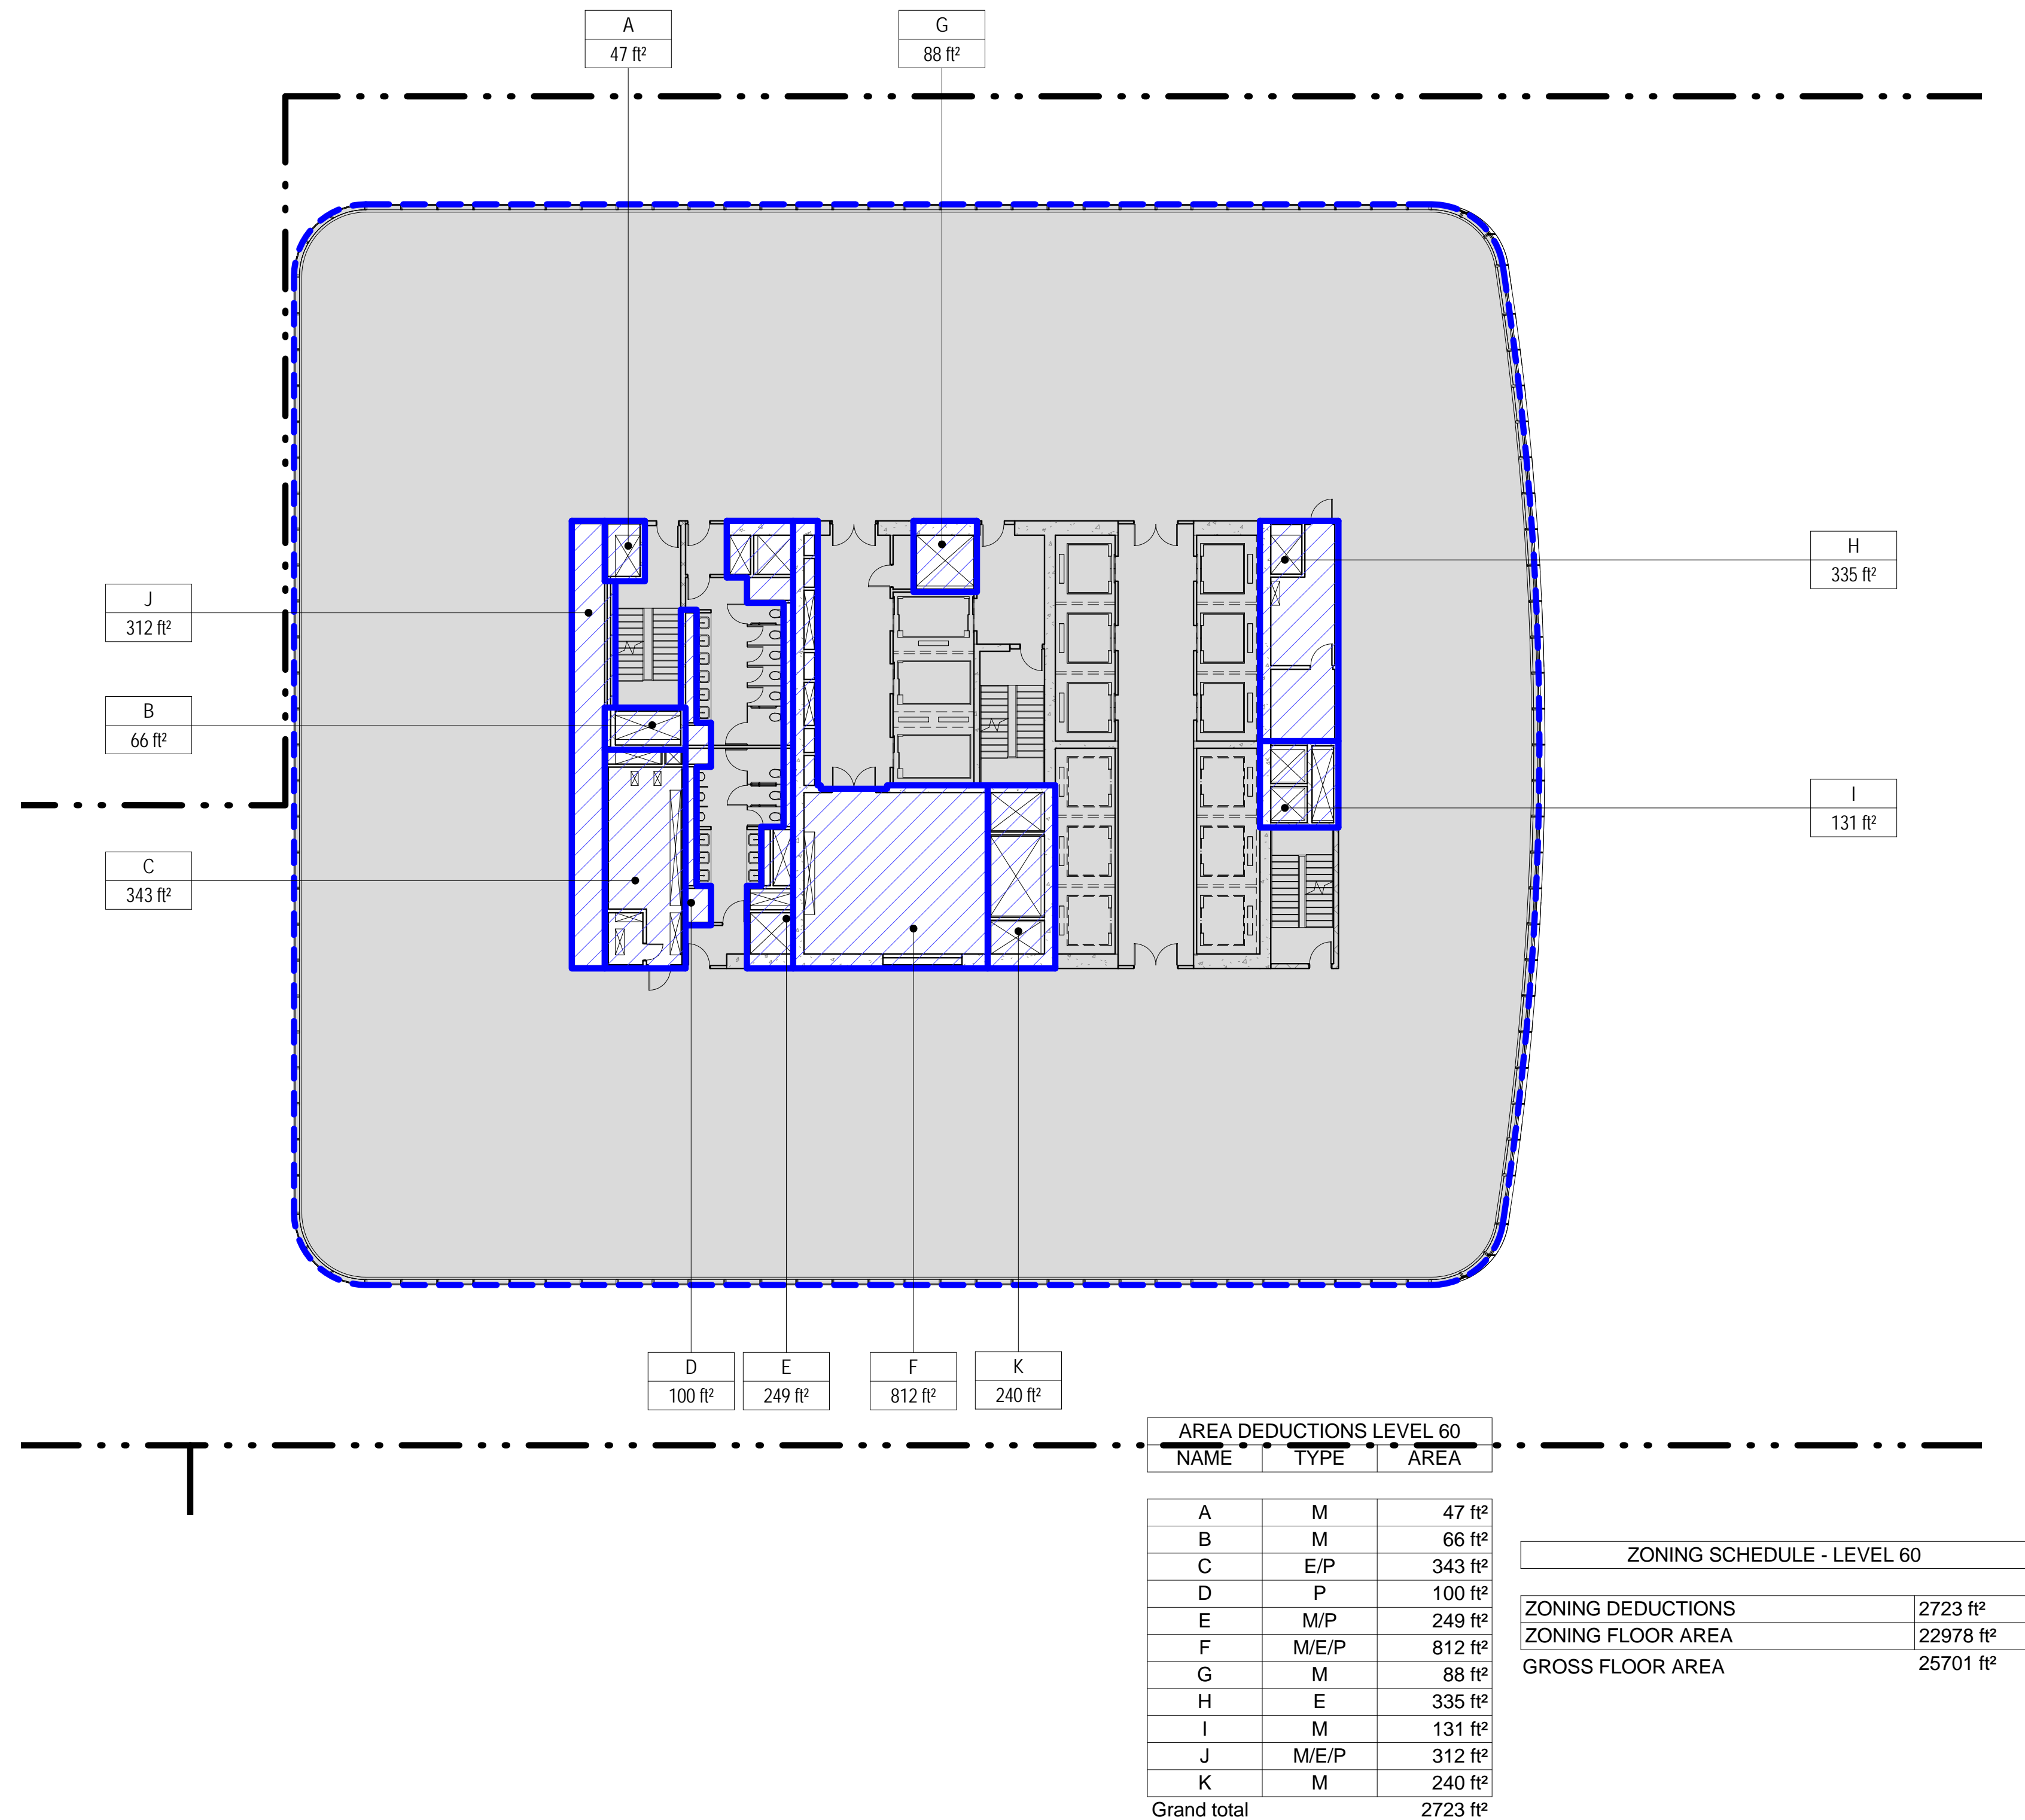
1 LEVEL 57 PLAN

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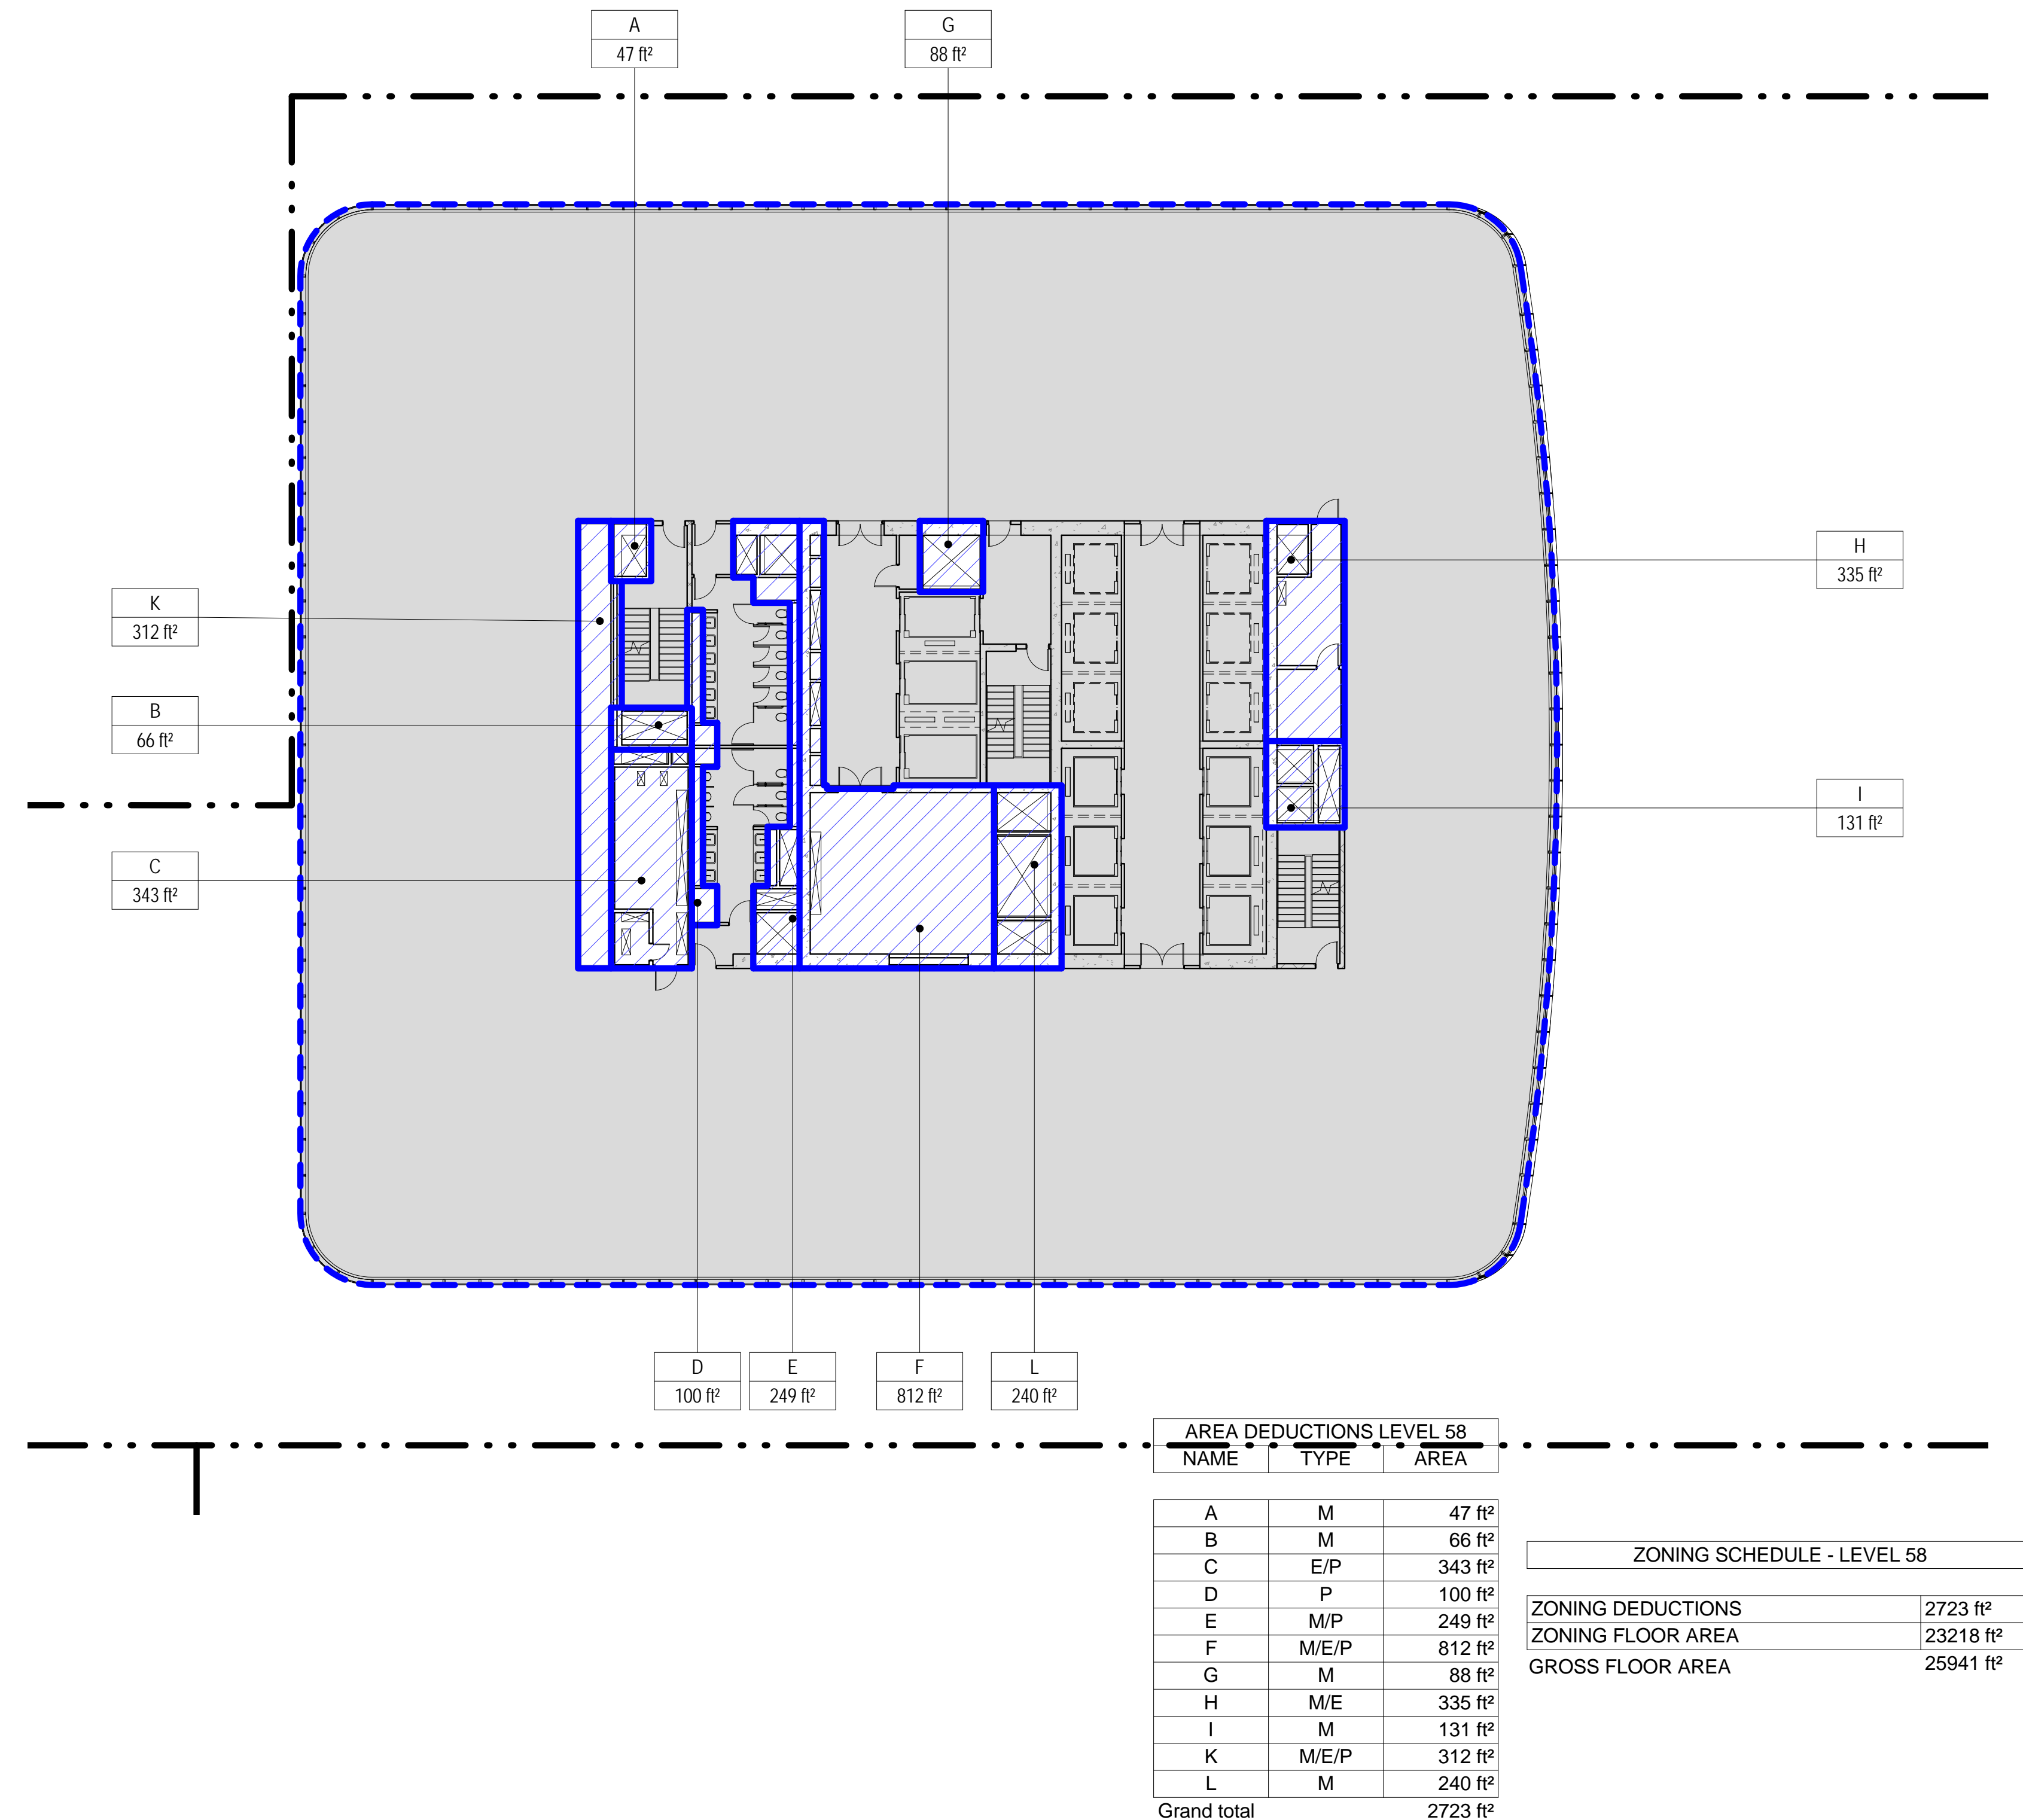
4 LEVEL 60 PLAN

SCALE: 1/16" = 1'-0"

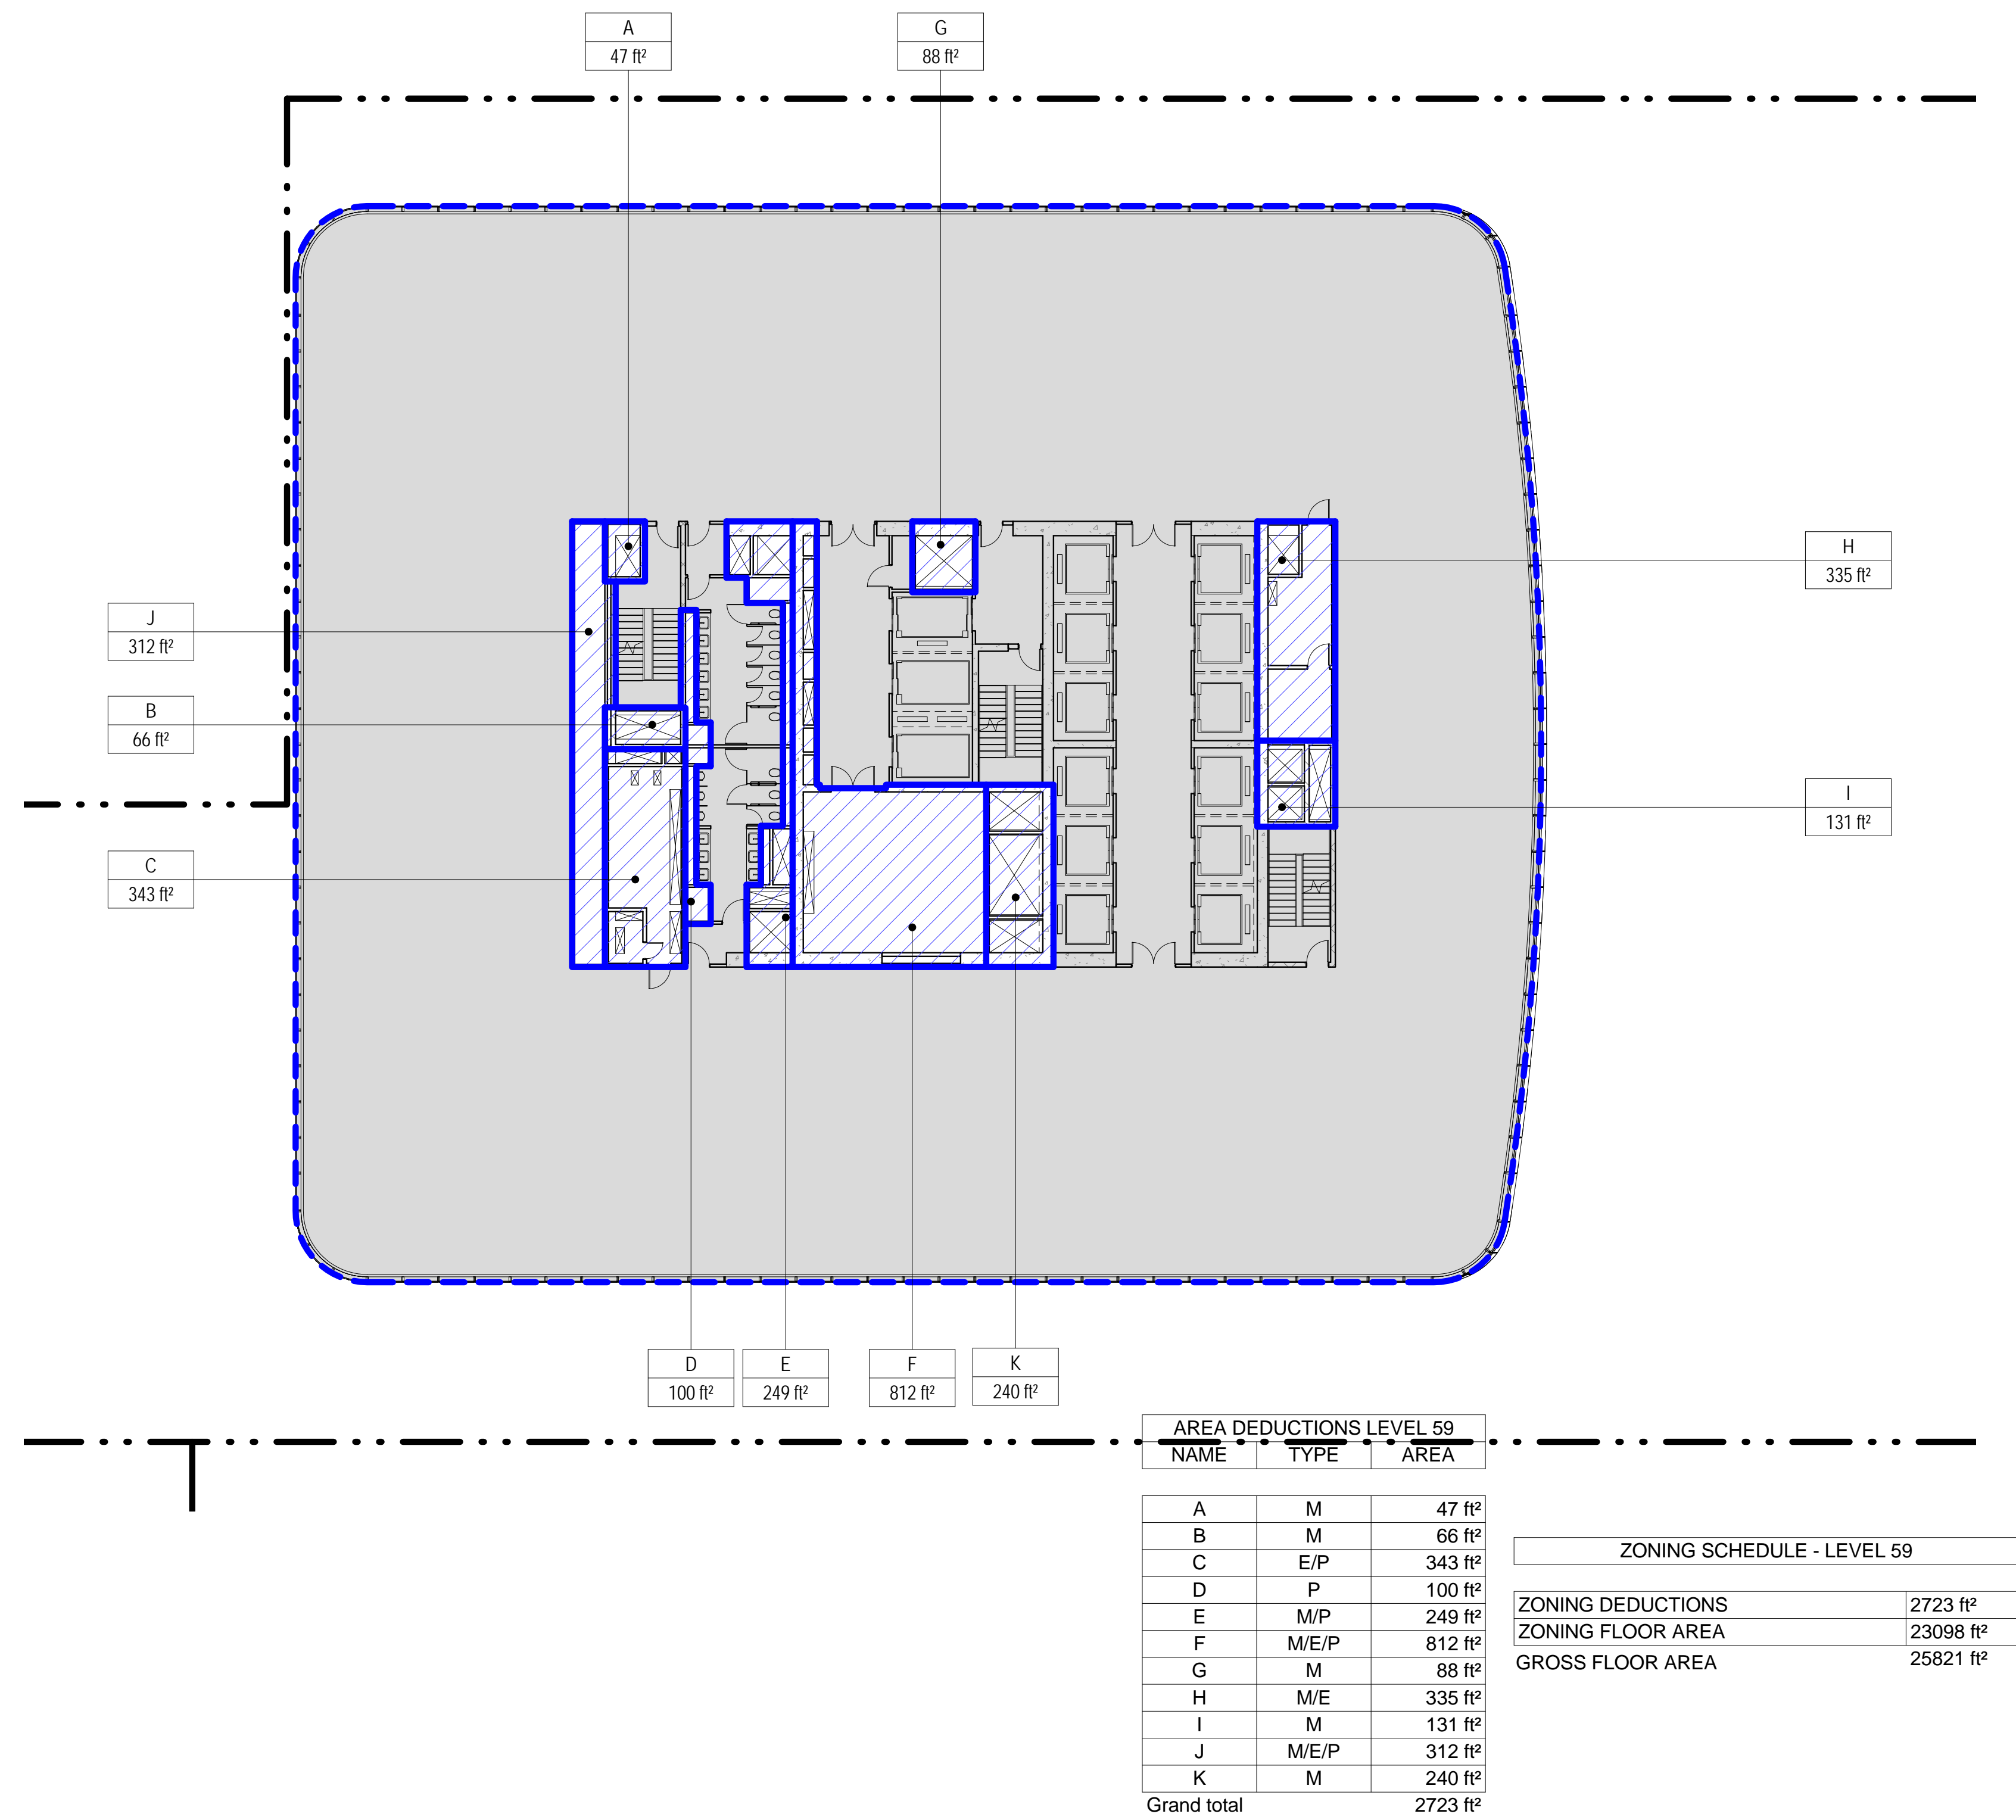

2 LEVEL 58 PLAN

SCALE: 1/16" = 1'-0"



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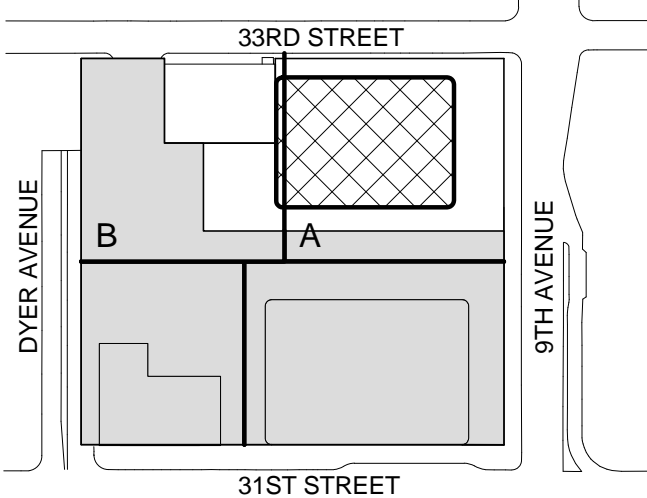
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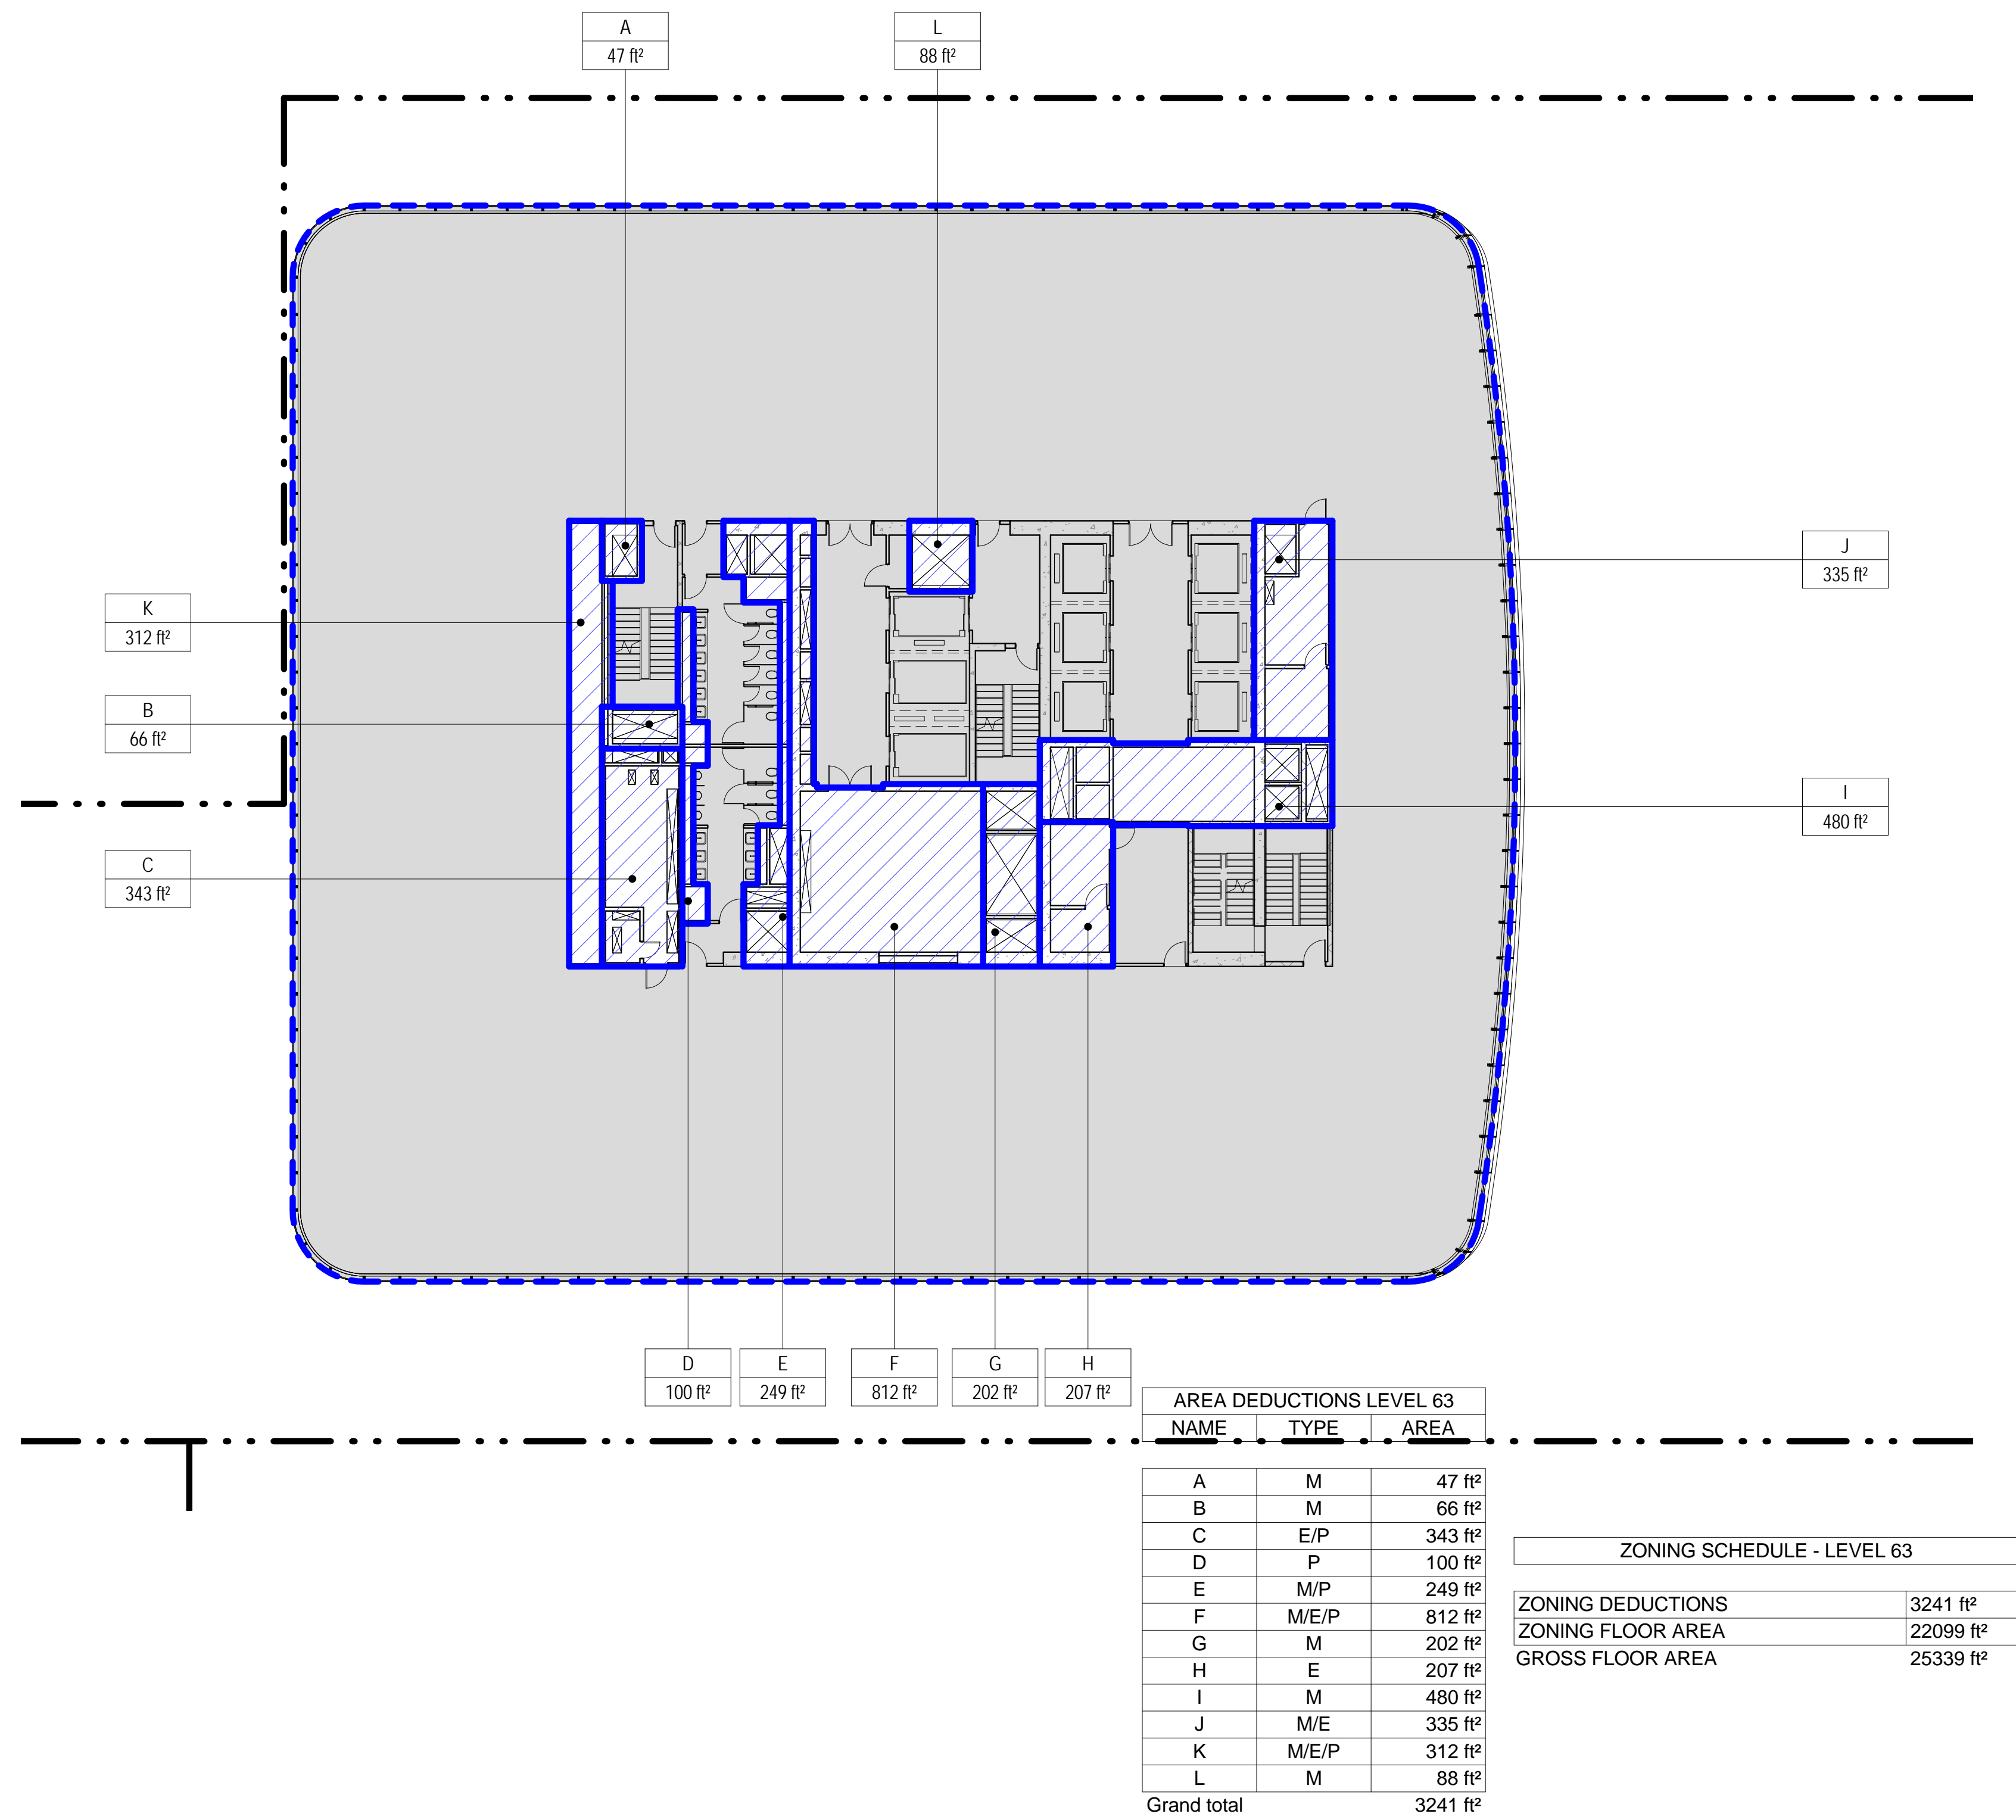
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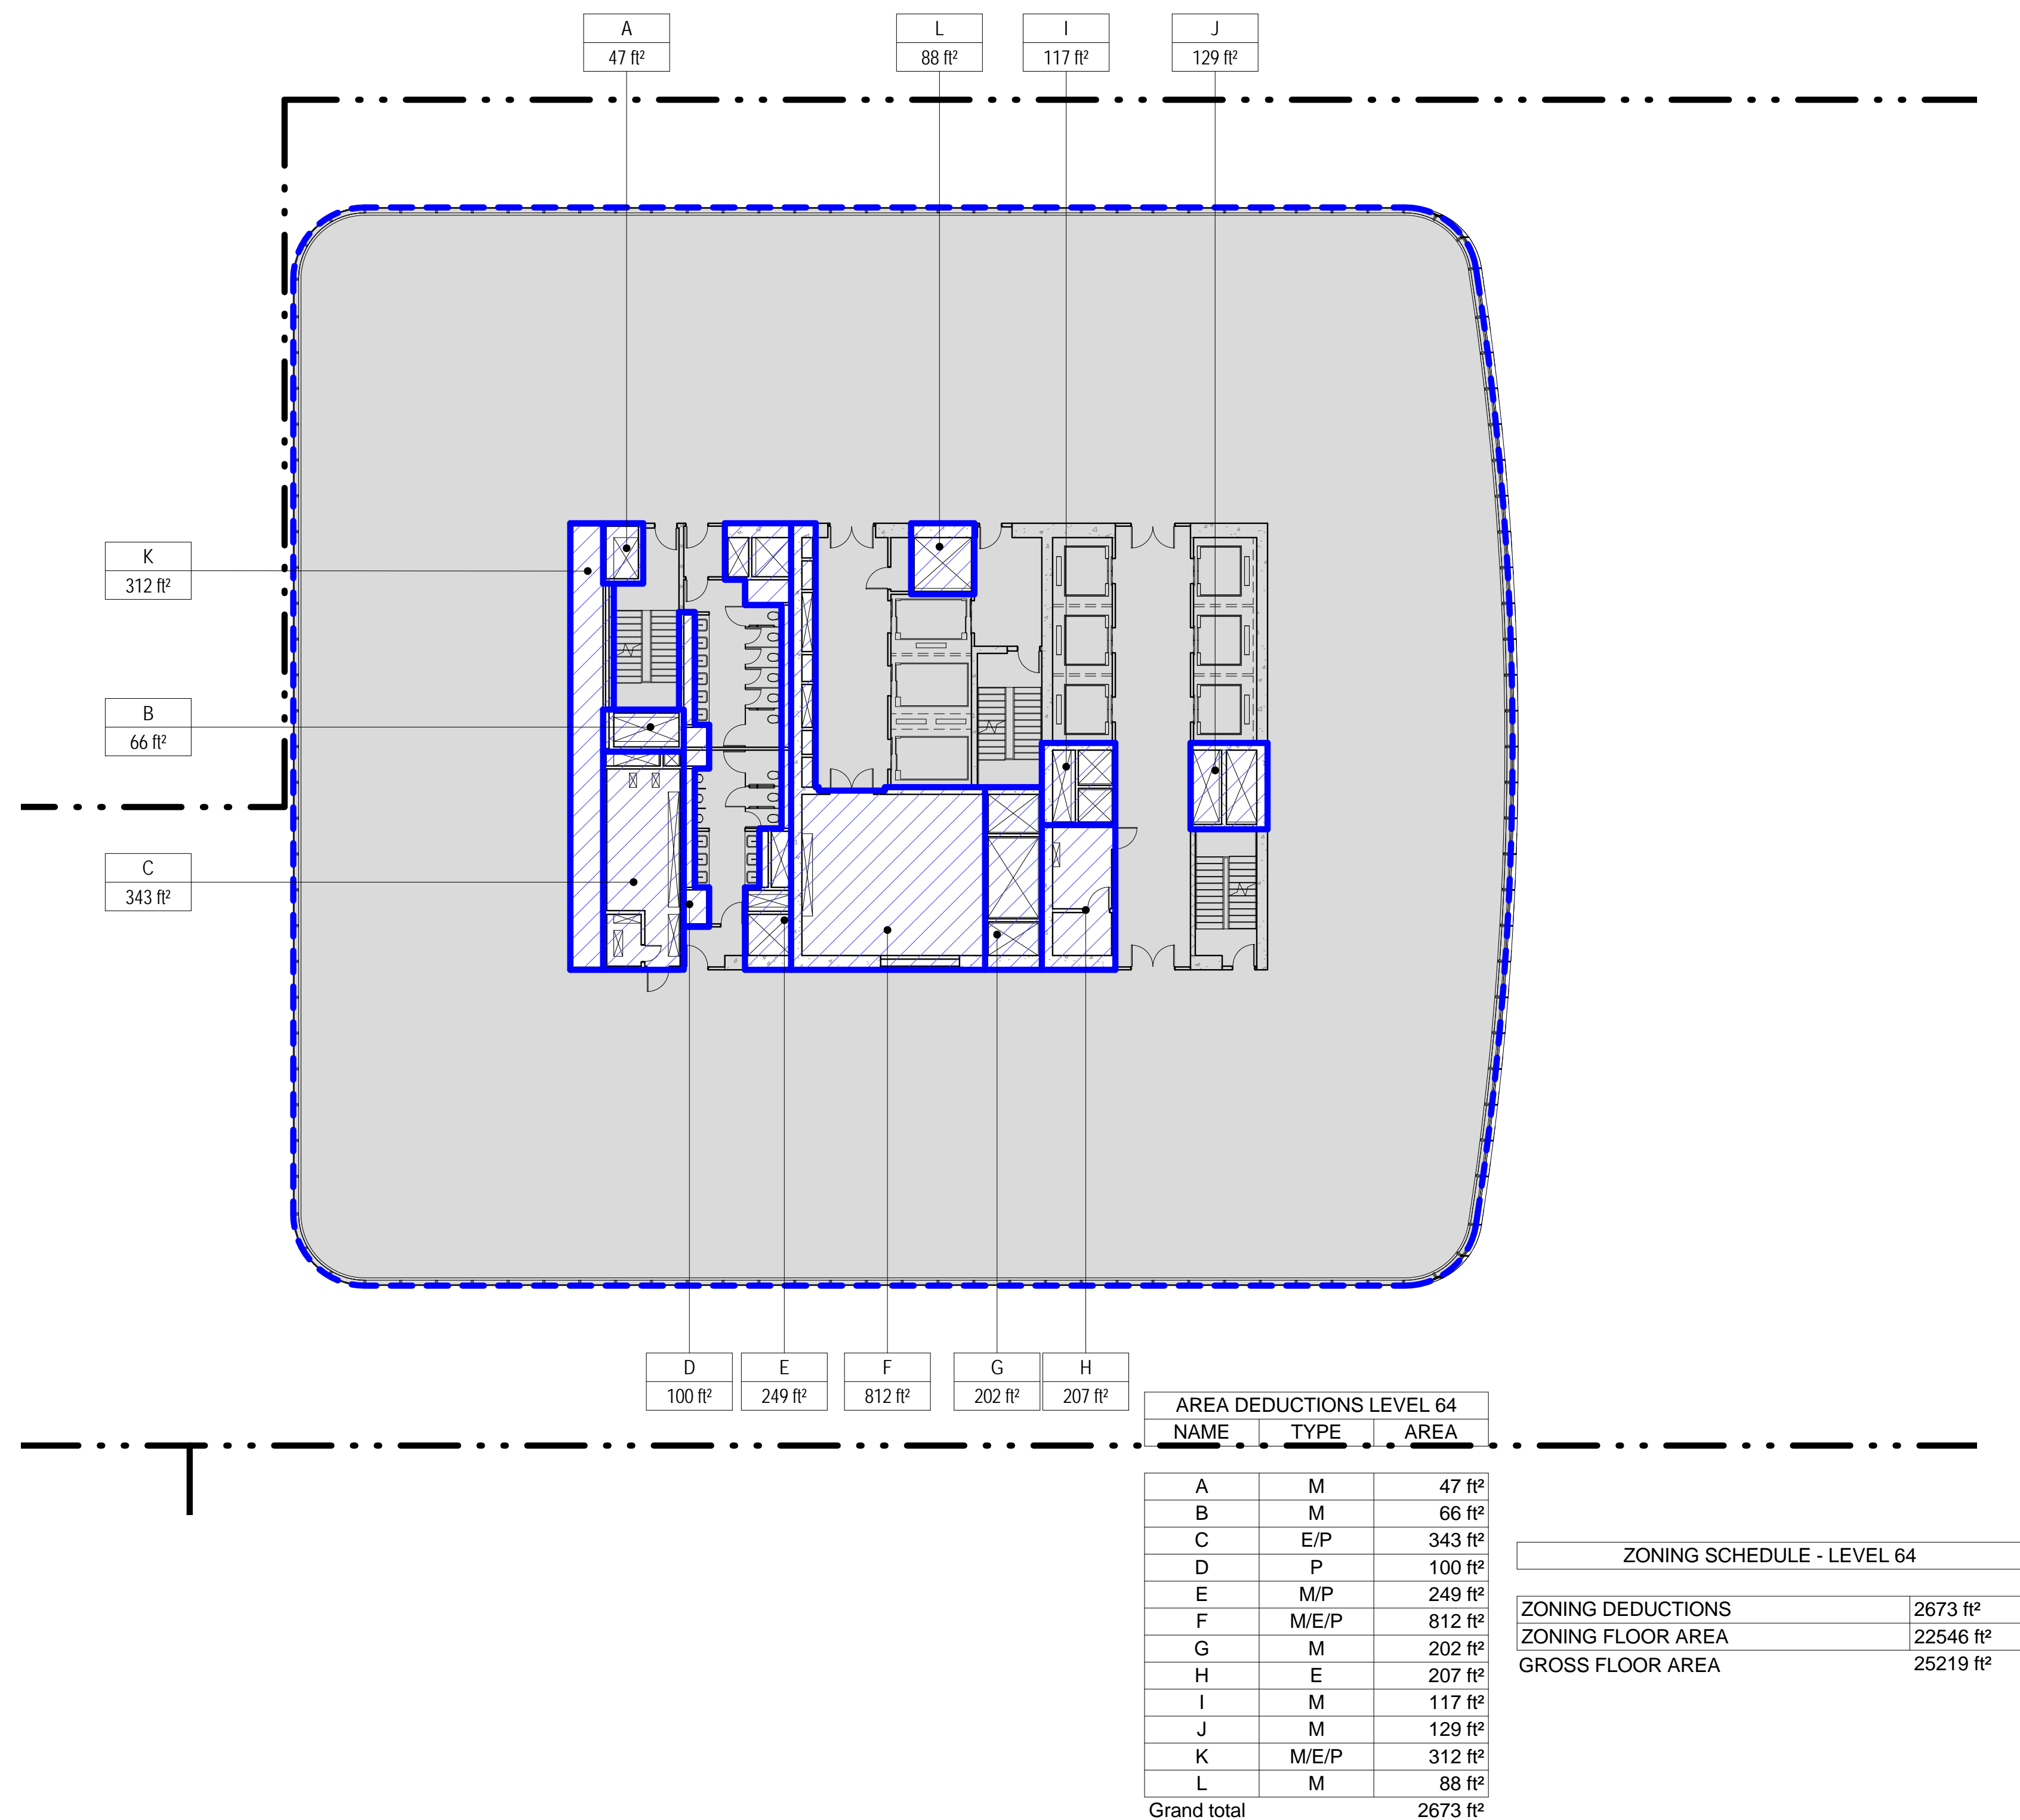
3 LEVEL 63 PLAN

SCALE: 1/16" = 1'-0"




4 LEVEL 64 PLAN

SCALE: 1/16" = 1'-0"




1 LEVEL 61 PLAN

SCALE: 1/16" = 1'-0"

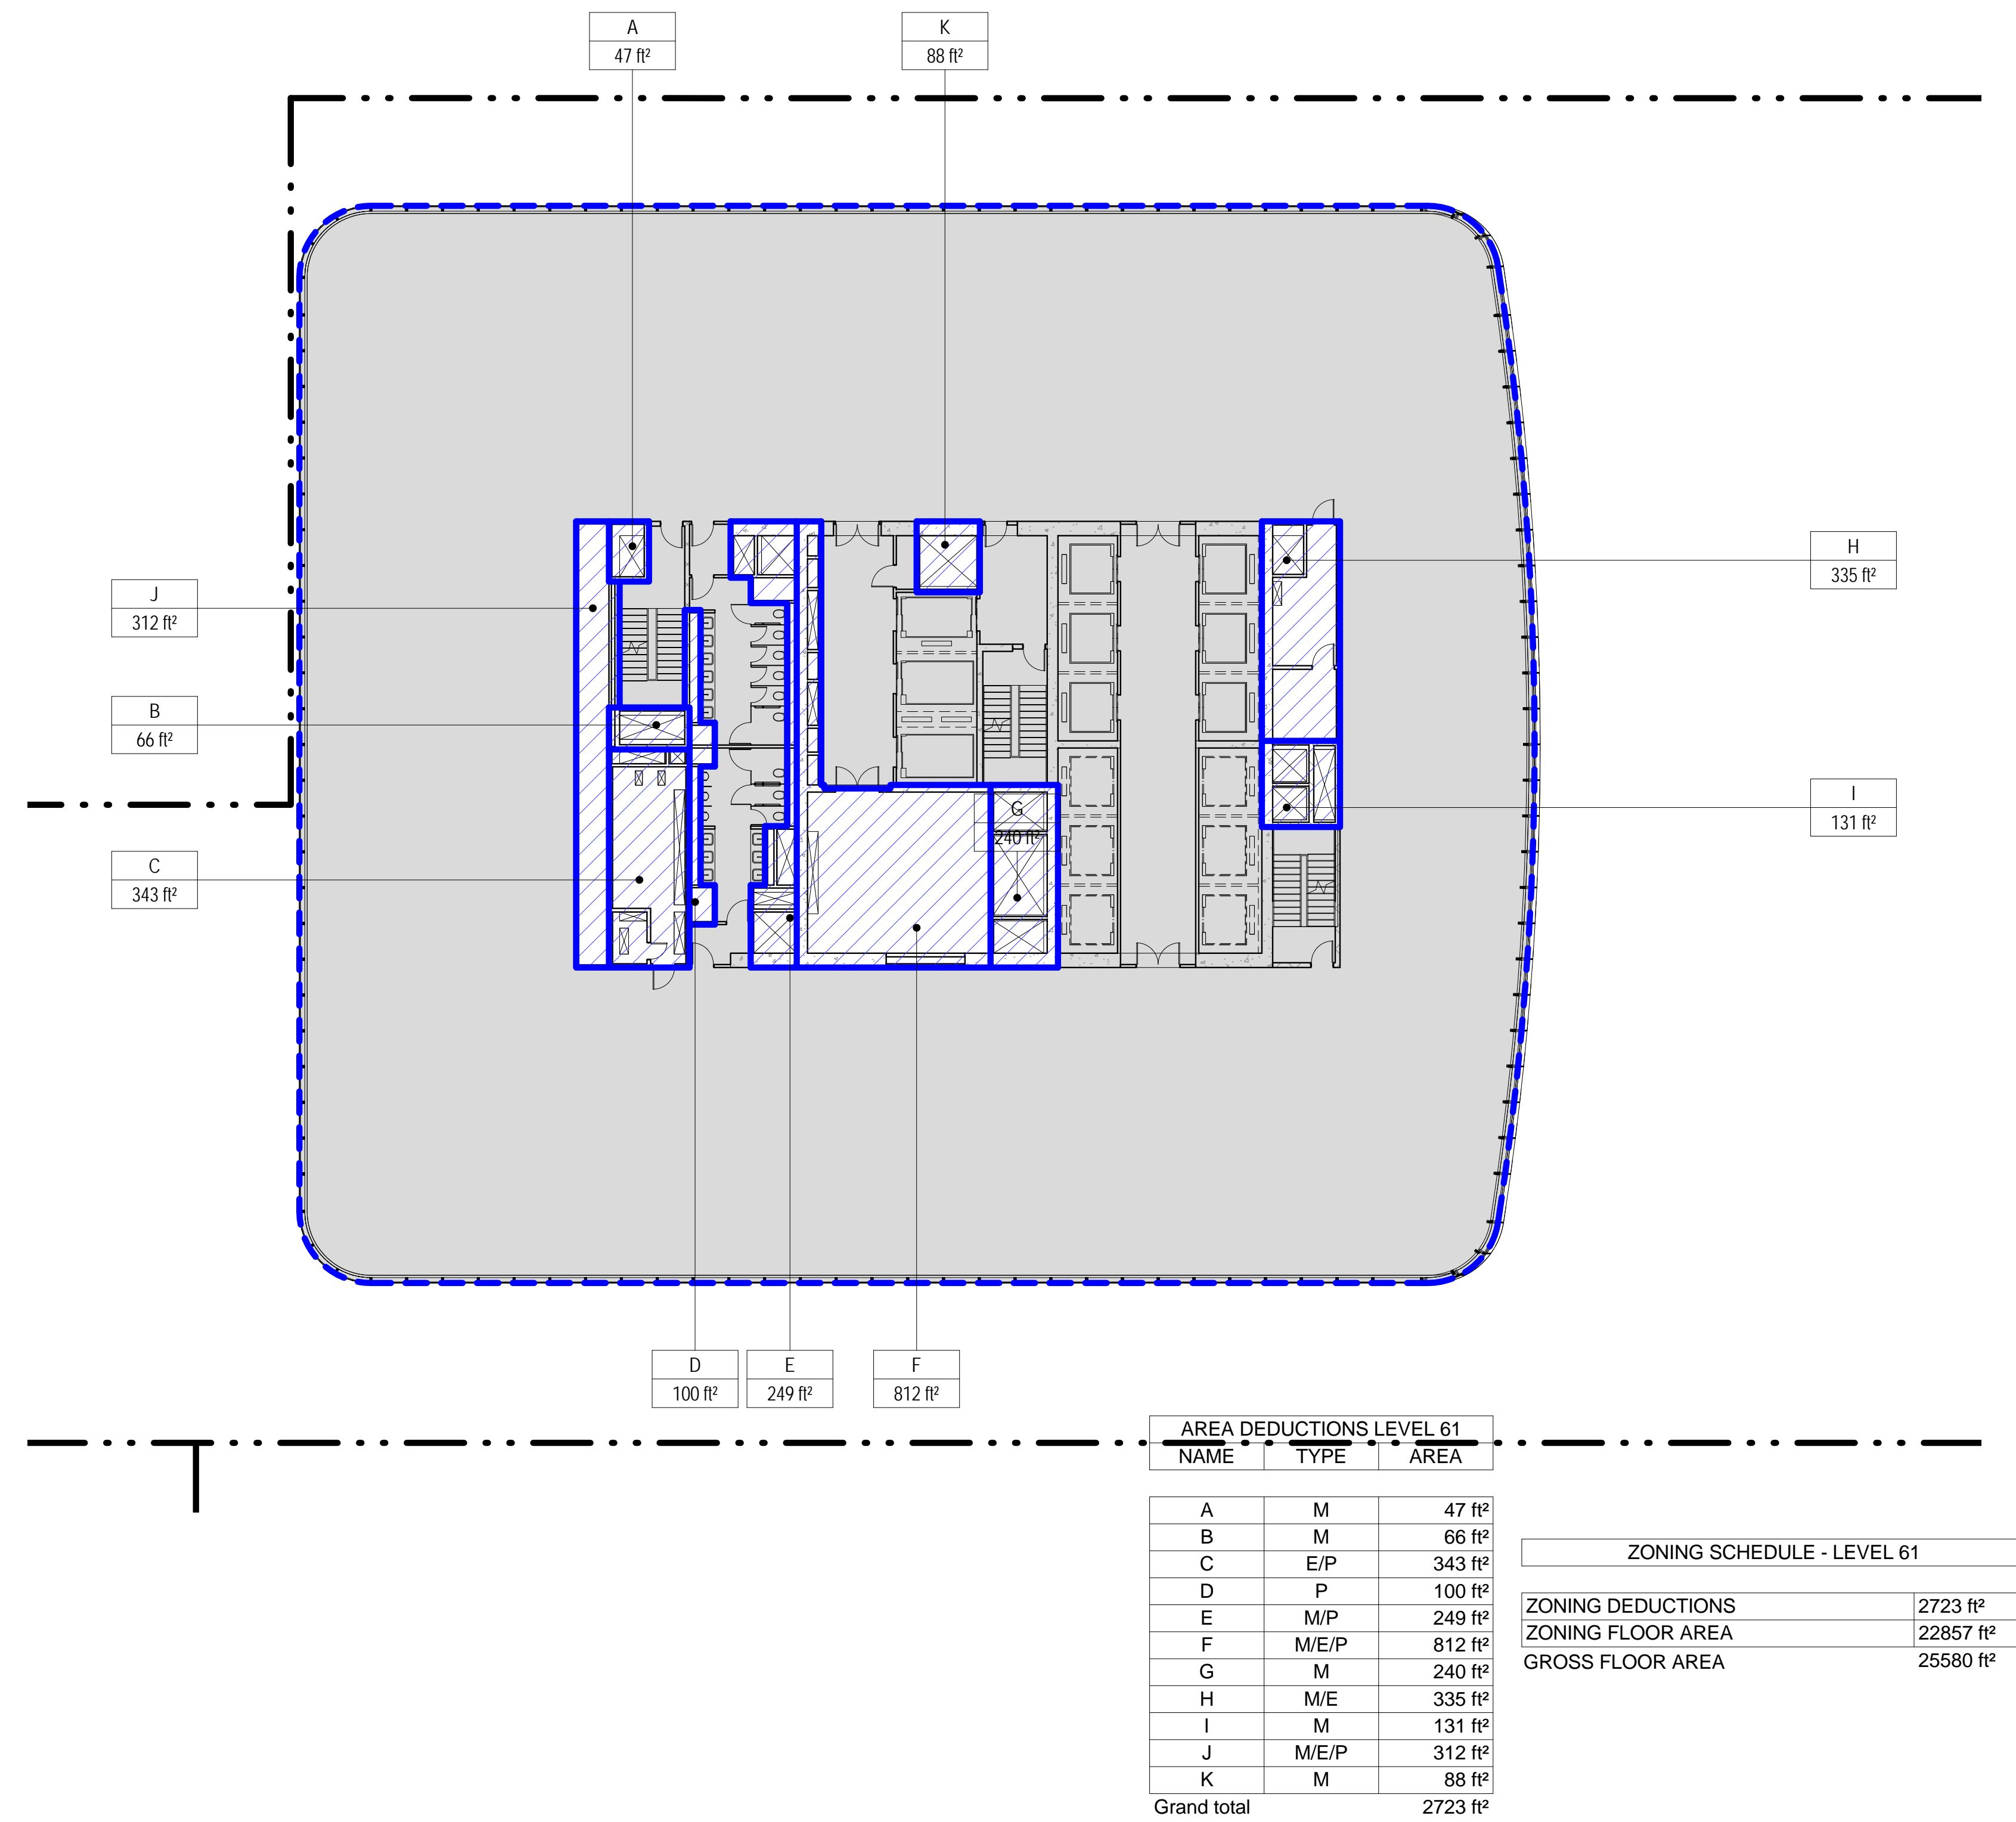

2 LEVEL 62 PLAN

SCALE: 1/16" = 1'-0"

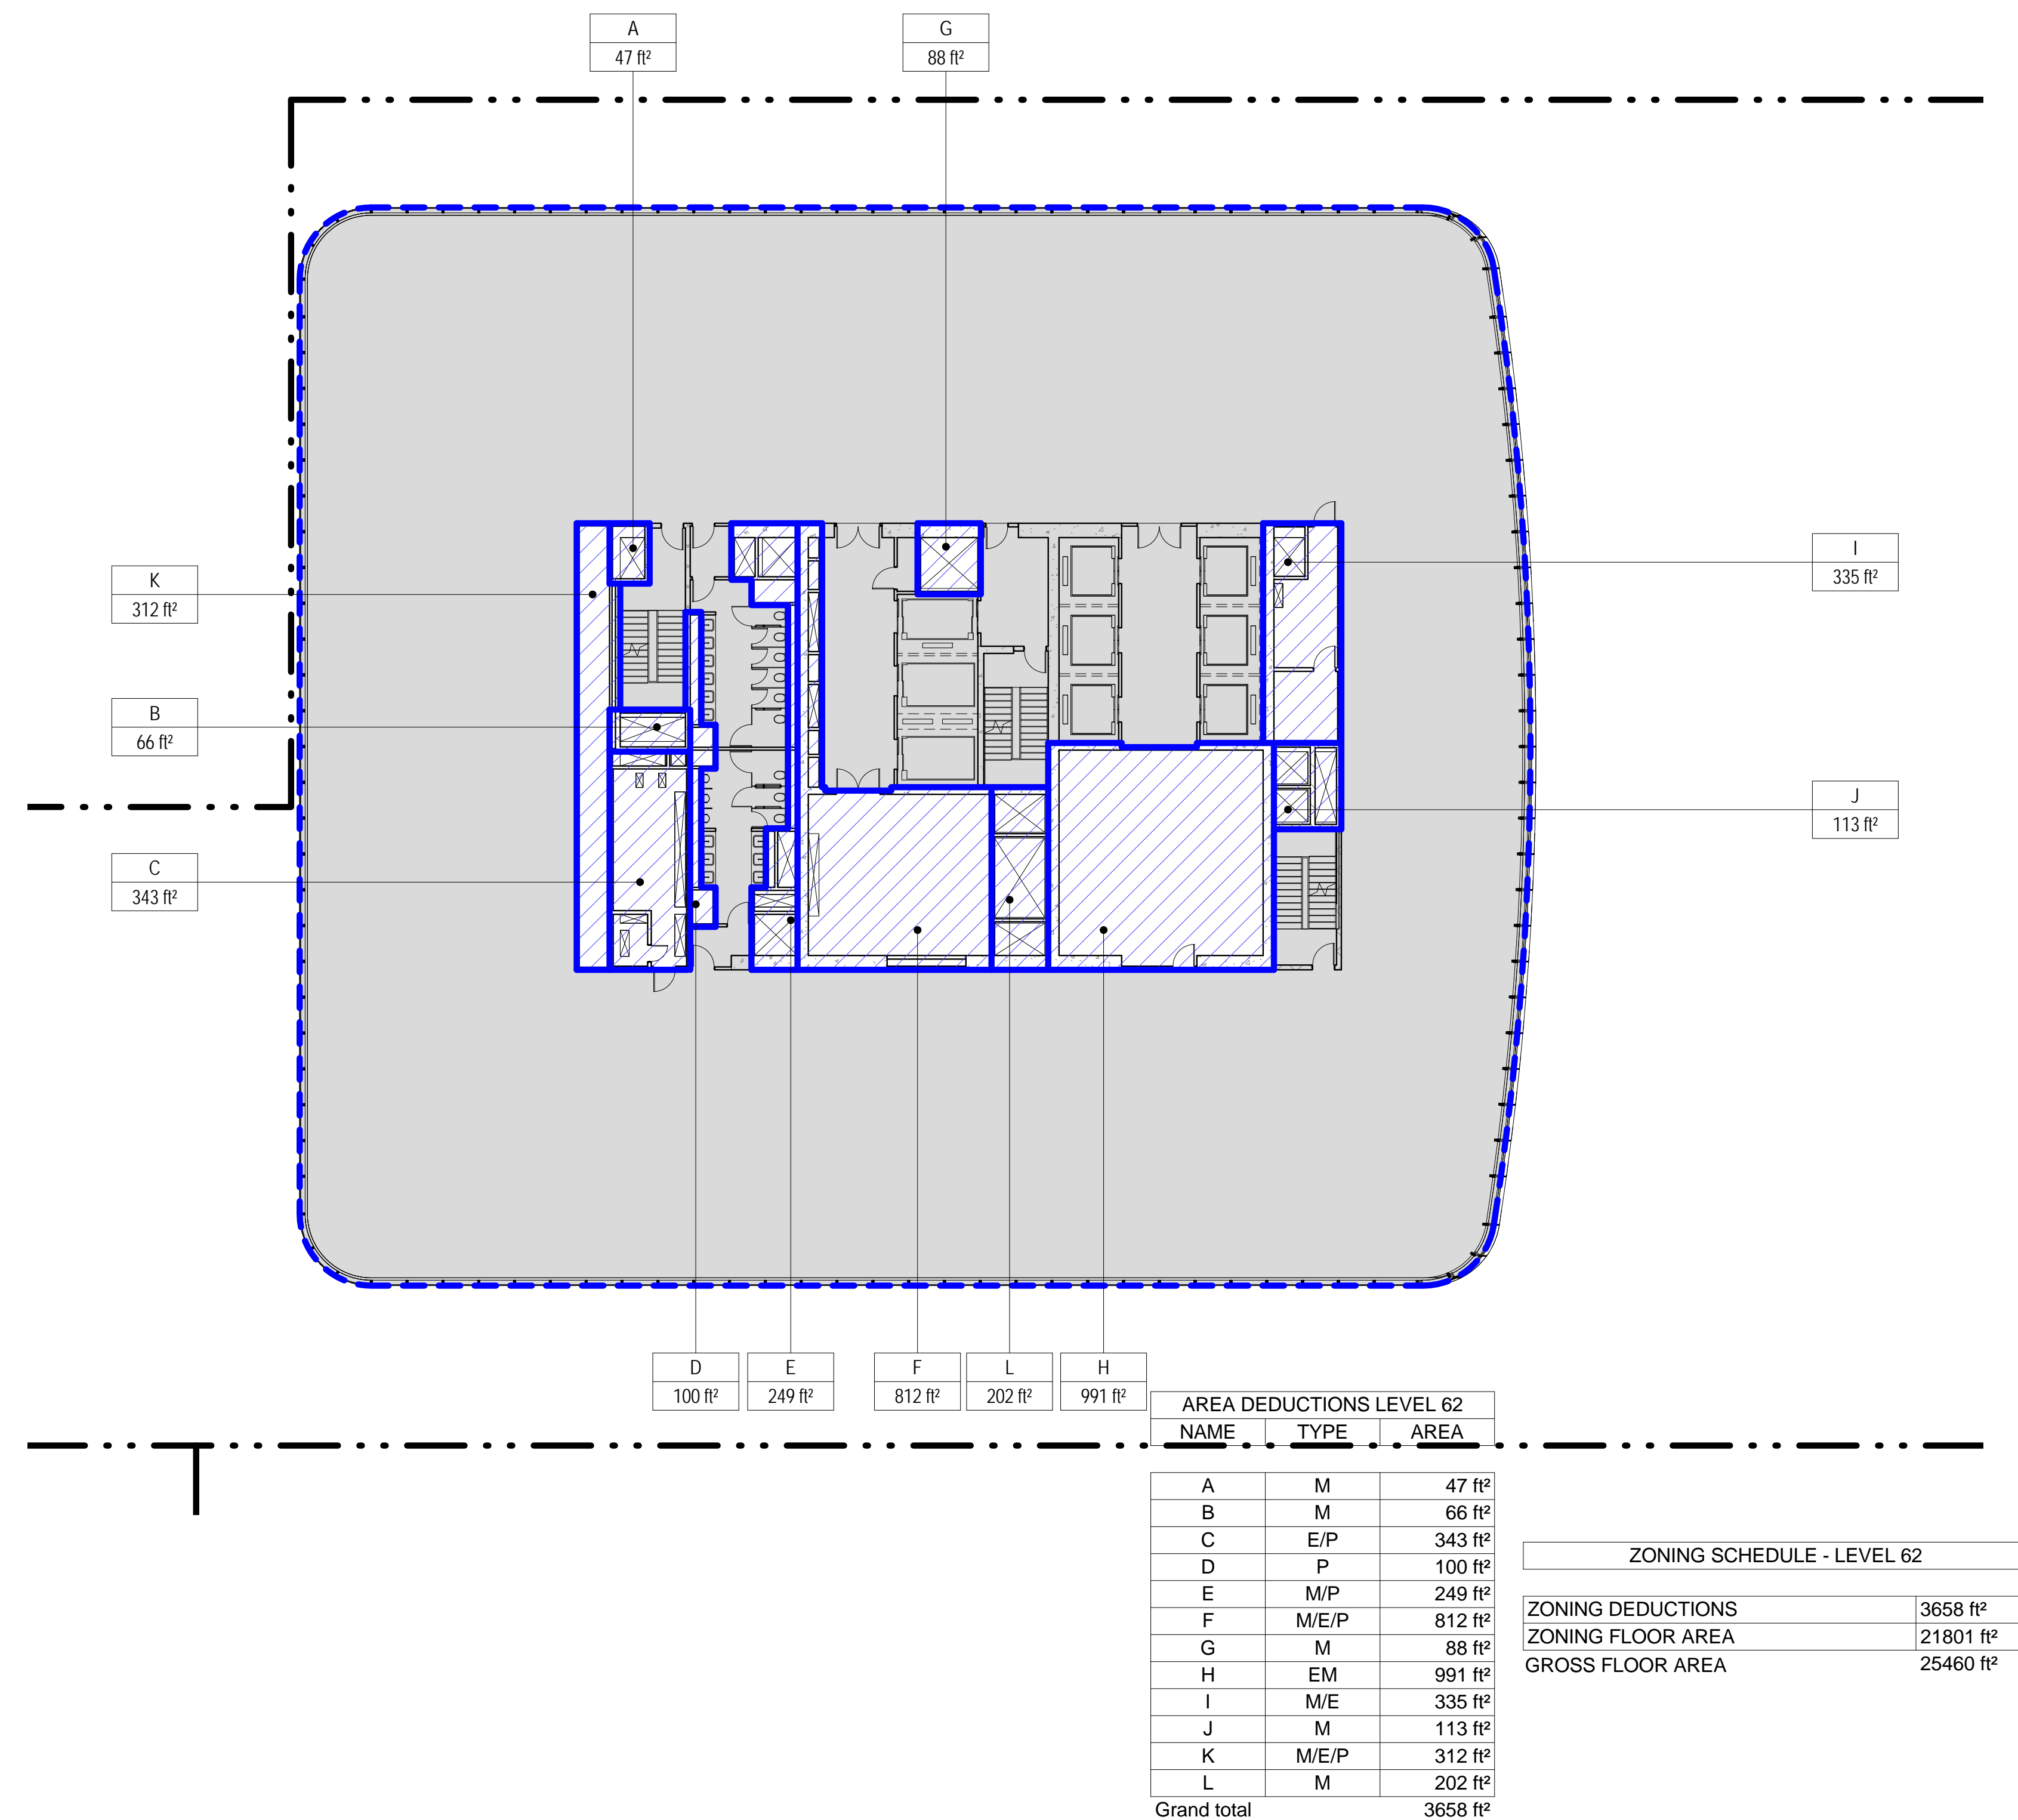

- ZONING LEGENDS**
- GROSS BUILDING AREA
 - ZONING AREA DEDUCTIONS
 - ZONING FLOOR AREA
 - RETAIL
 - MR MECHANICAL ROOM
 - M MECHANICAL
 - E ELECTRICAL/TEL./IT
 - P PLUMBING
 - EM ELEVATOR MACHINE ROOM

MANHATTAN WEST: NORTH TOWER
375 Ninth Avenue, New York, NY 10001
Client

Brookfield
Brookfield Place
250 Vesey Street, 15th Floor, New York, NY 10021

Architecture/Structural Engineering
SOM
Skidmore, Owings & Merrill LLP
14 Wall Street, New York, NY 10005

Civil Engineering
Philip Habib & Associates
102 Madison Avenue #11, New York, NY 10016

MEP Engineering
Jaros Baum & Bolles
80 Pine Street, New York, NY 10005

Vertical Transportation
Edgett Williams Consulting Group, Inc.
102 East Blithedale Ave., Suite 1, Mill Valley, California 94941

Sustainable Design
Viridian Energy & Environmental
50 Washington Street, Newark, CT 06854

Geotechnical Engineering
Mueser Rutledge Consulting Engineers
14 Penn Plaza, 225 W. 34th Street, New York, NY 10122

Landscape Consultant
Field Operations
475 10th Avenue, New York, NY 10018

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250 State Street #F1, North Haven, CT 06473

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Acoustical Consultant
Cerami & Associates
404 Fifth Avenue #8, New York, NY 10018

Vibration Consultant
Wilson, Uhrig & Associates, Inc.
65 Broadway, Suite 401, New York, NY 10006

Code Consultant
Code Consultants Professional Engineers PC
215 West 40th Street, 15th Floor, New York, NY 10018

Facade Maintenance Consultant
Entek Engineering LLC
166 Ames Street, Hackensack, NJ 07601

Wind Tunnel Consultant
Rowan Williams Davies & Irwin Inc.
650 Woodlawn Road West, Guelph, Ontario, Canada N1K 1B6

**PRELIMINARY
NOT FOR CONSTRUCTION**

Key Plan:

Seal & Signature:

Warning: It is a violation of the New York State Architecture Law (§§5.50) for any person, unless they are acting under the direction of a Licensed Architect, to alter this item in any way.

REGISTERED ARCHITECT
JAMES J. DOTTEN
JUN 10, 1964
STATE OF NEW YORK

No.	Date	Description
2	26 JUN 2014	ISSUED FOR FOUNDATION PERMIT
1	20 DEC 2013	ISSUED FOR FOUNDATION PERMIT

Sheet Name:

ZONING FLOOR AREA DEDUCTIONS - LEVEL 61-64

Project No.:	B-SCAN Sheet No.:
207150	Z-119.00


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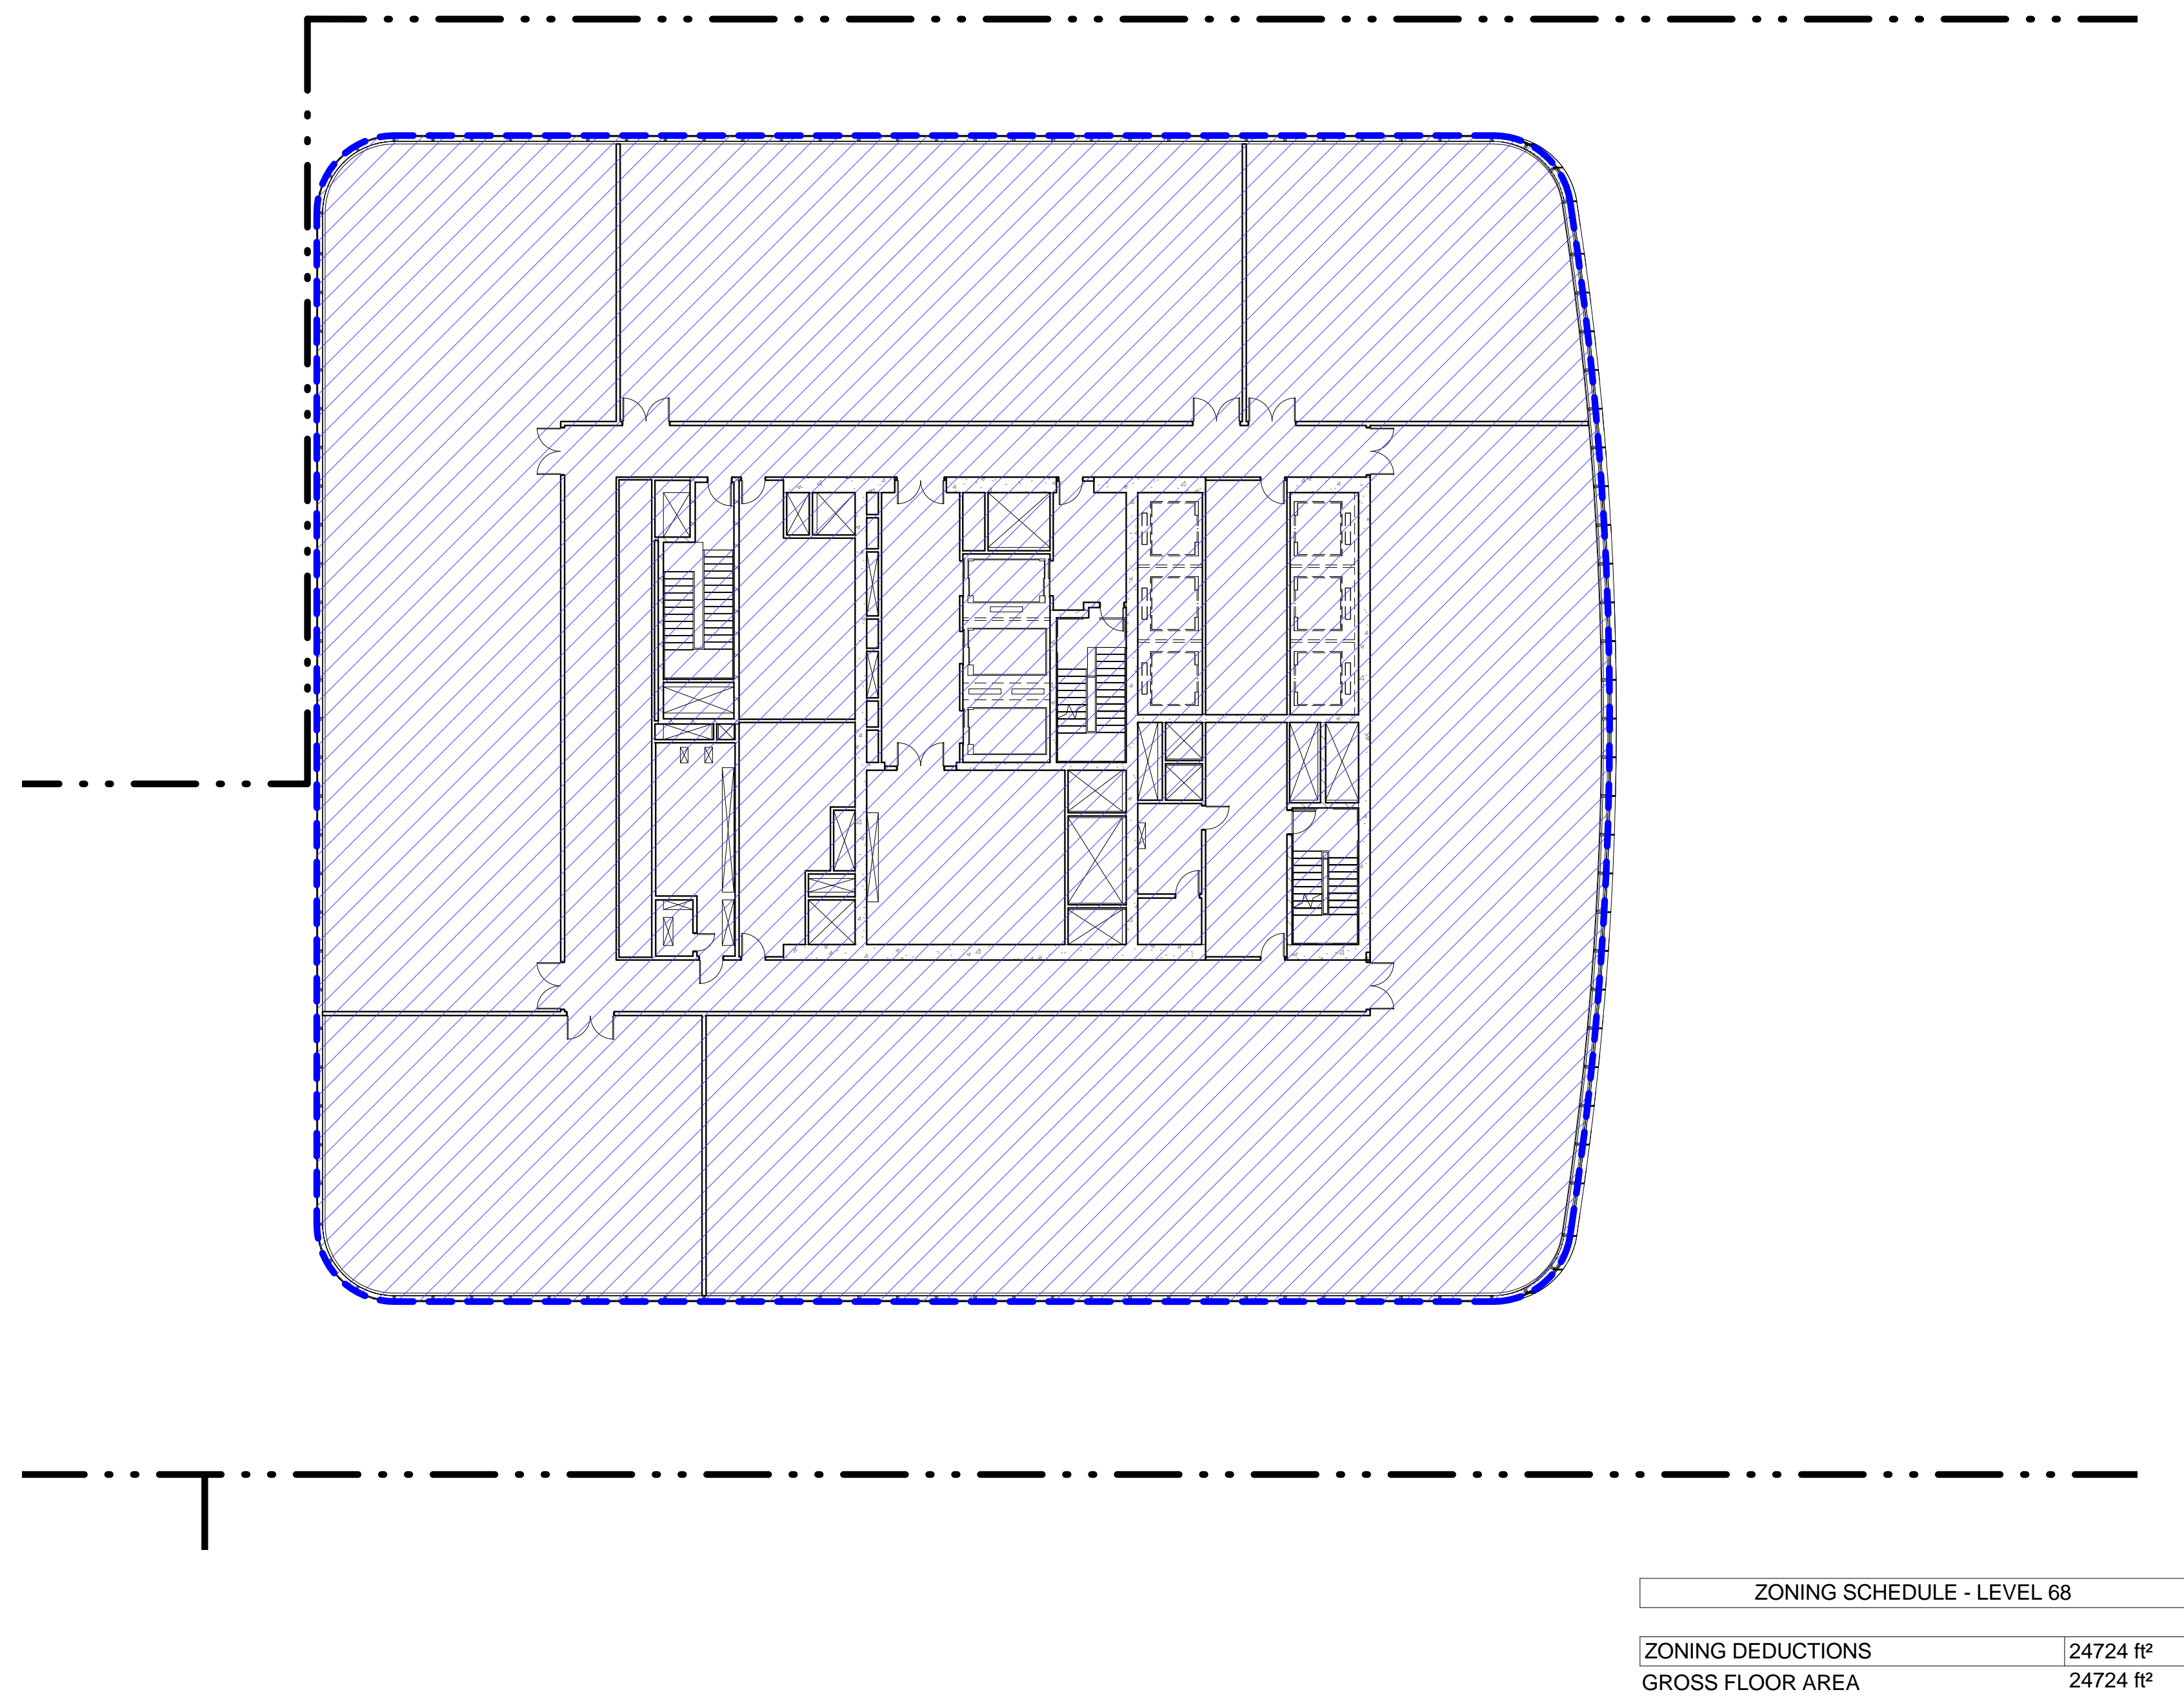
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Page No.: 26 OF 28


3 LEVEL 67 PLAN
SCALE: 1/16" = 1'-0"




4 LEVEL 68 PLAN
SCALE: 1/16" = 1'-0"

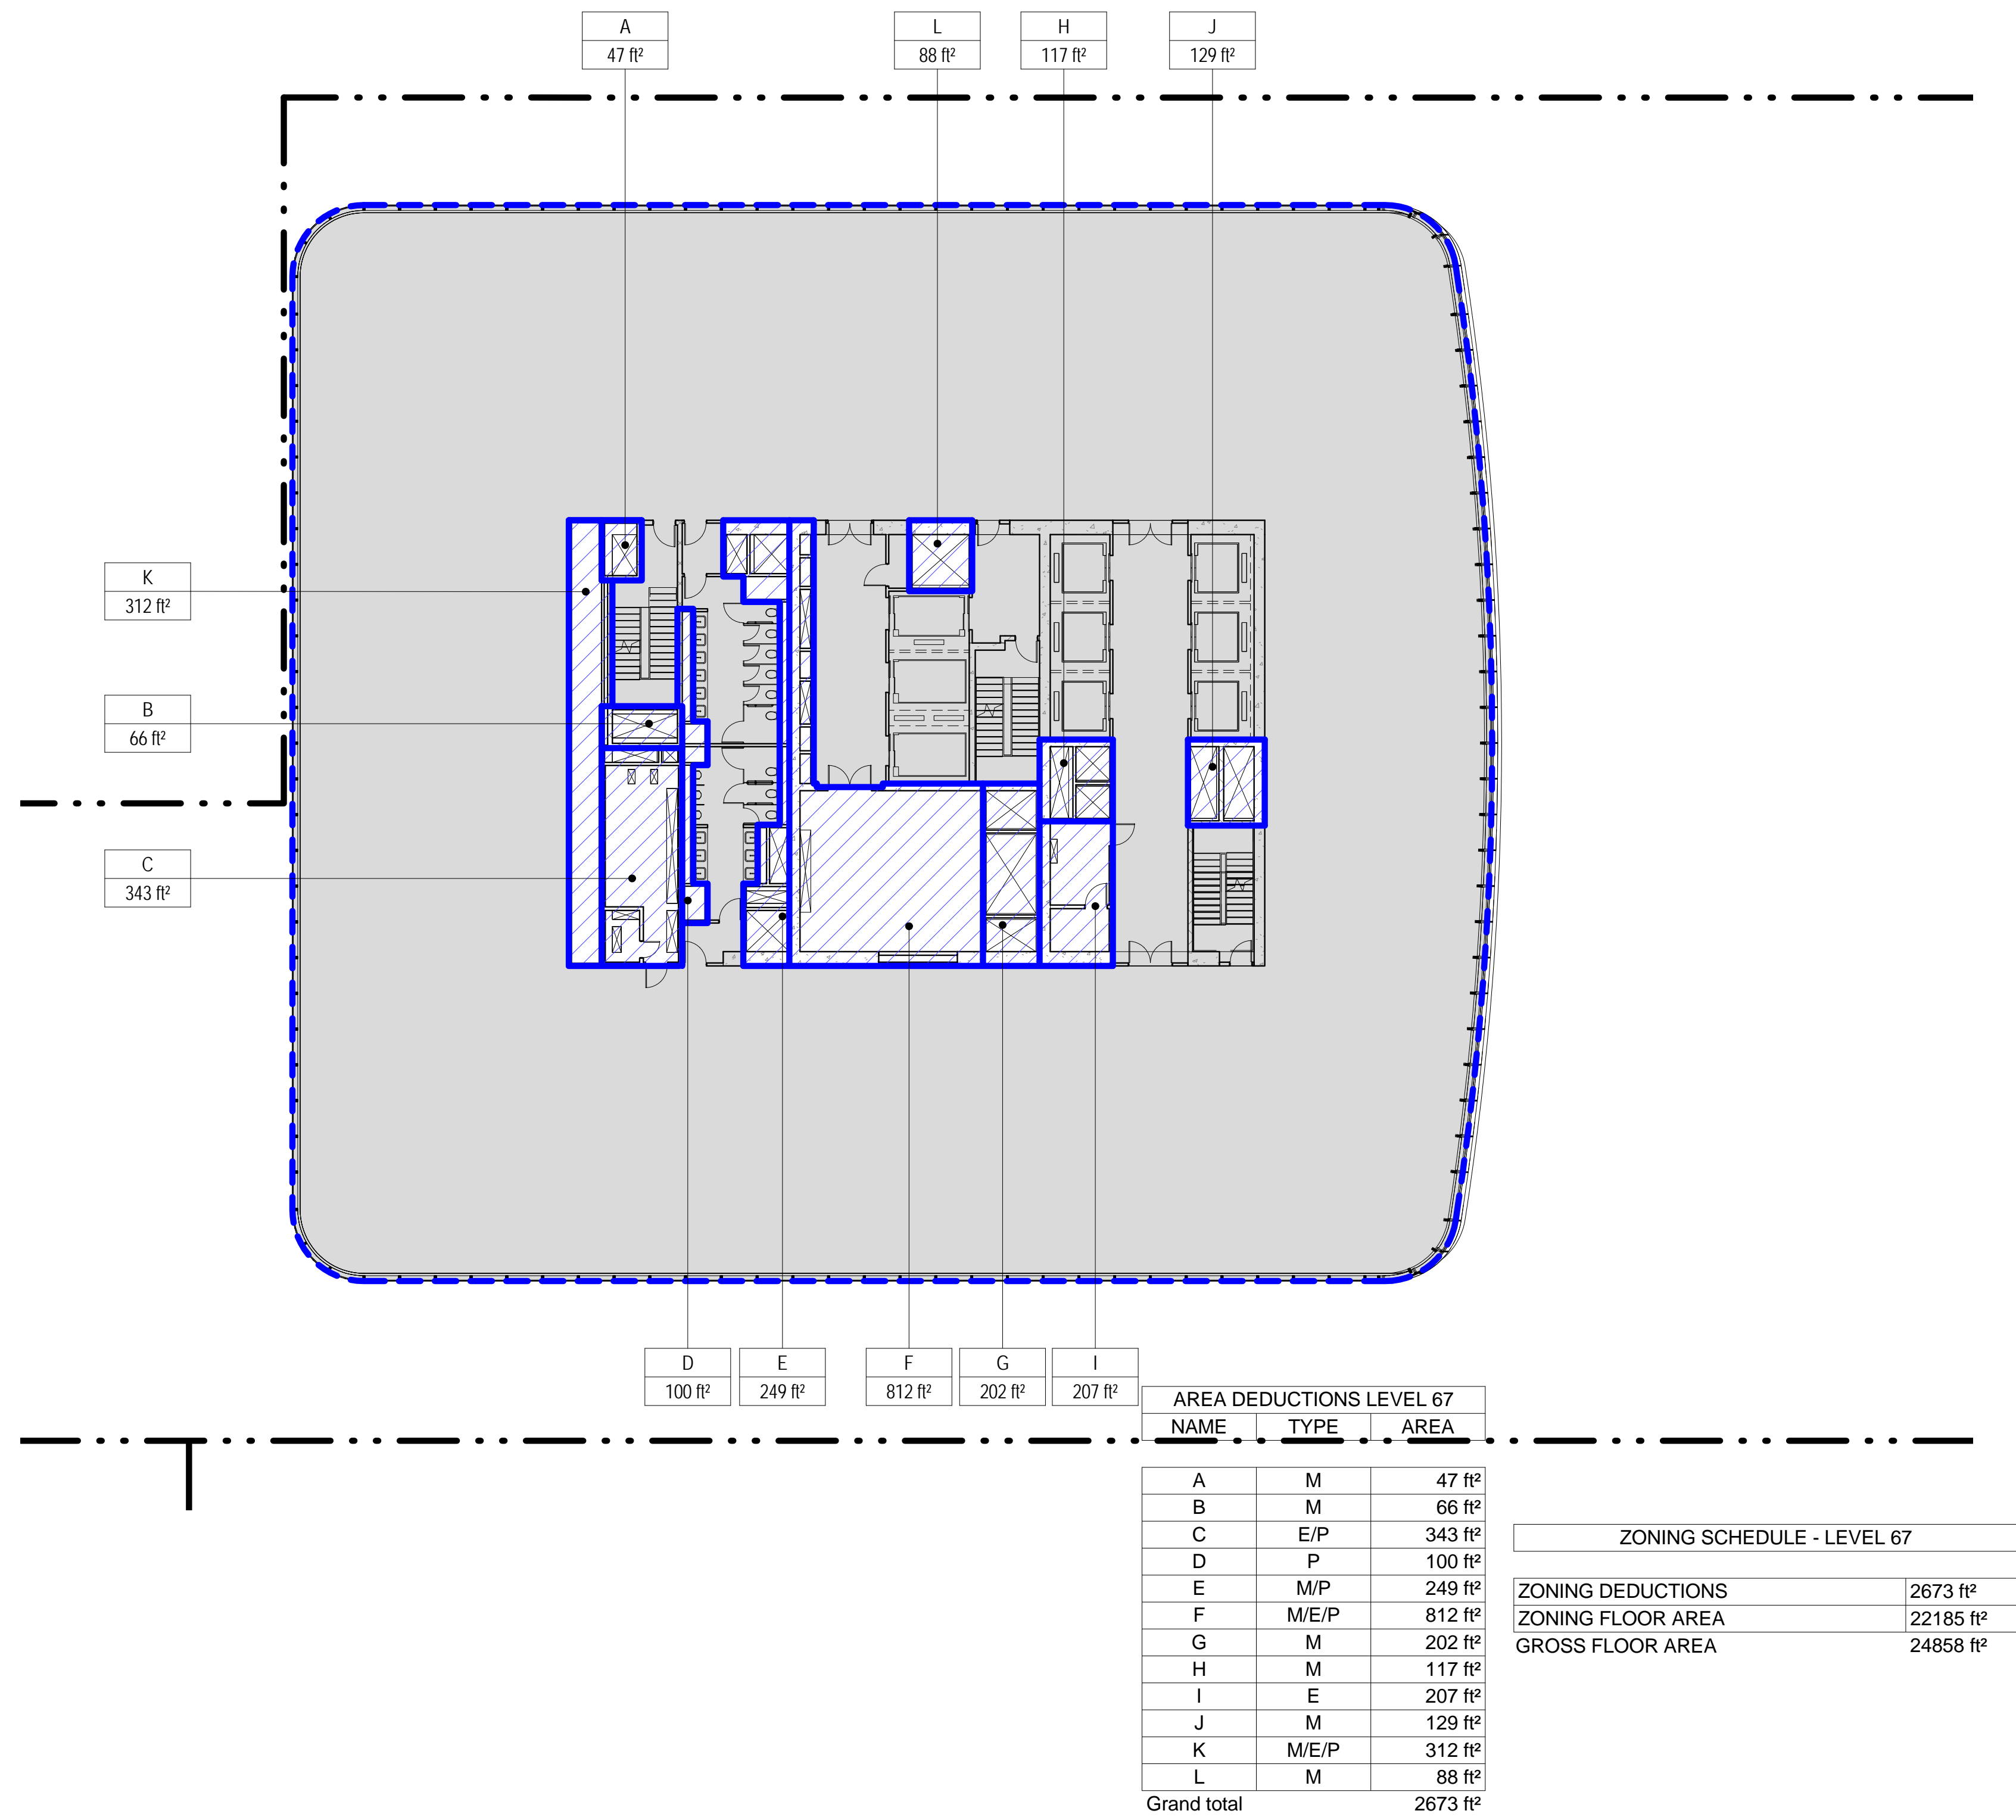

1 LEVEL 65 PLAN
SCALE: 1/16" = 1'-0"

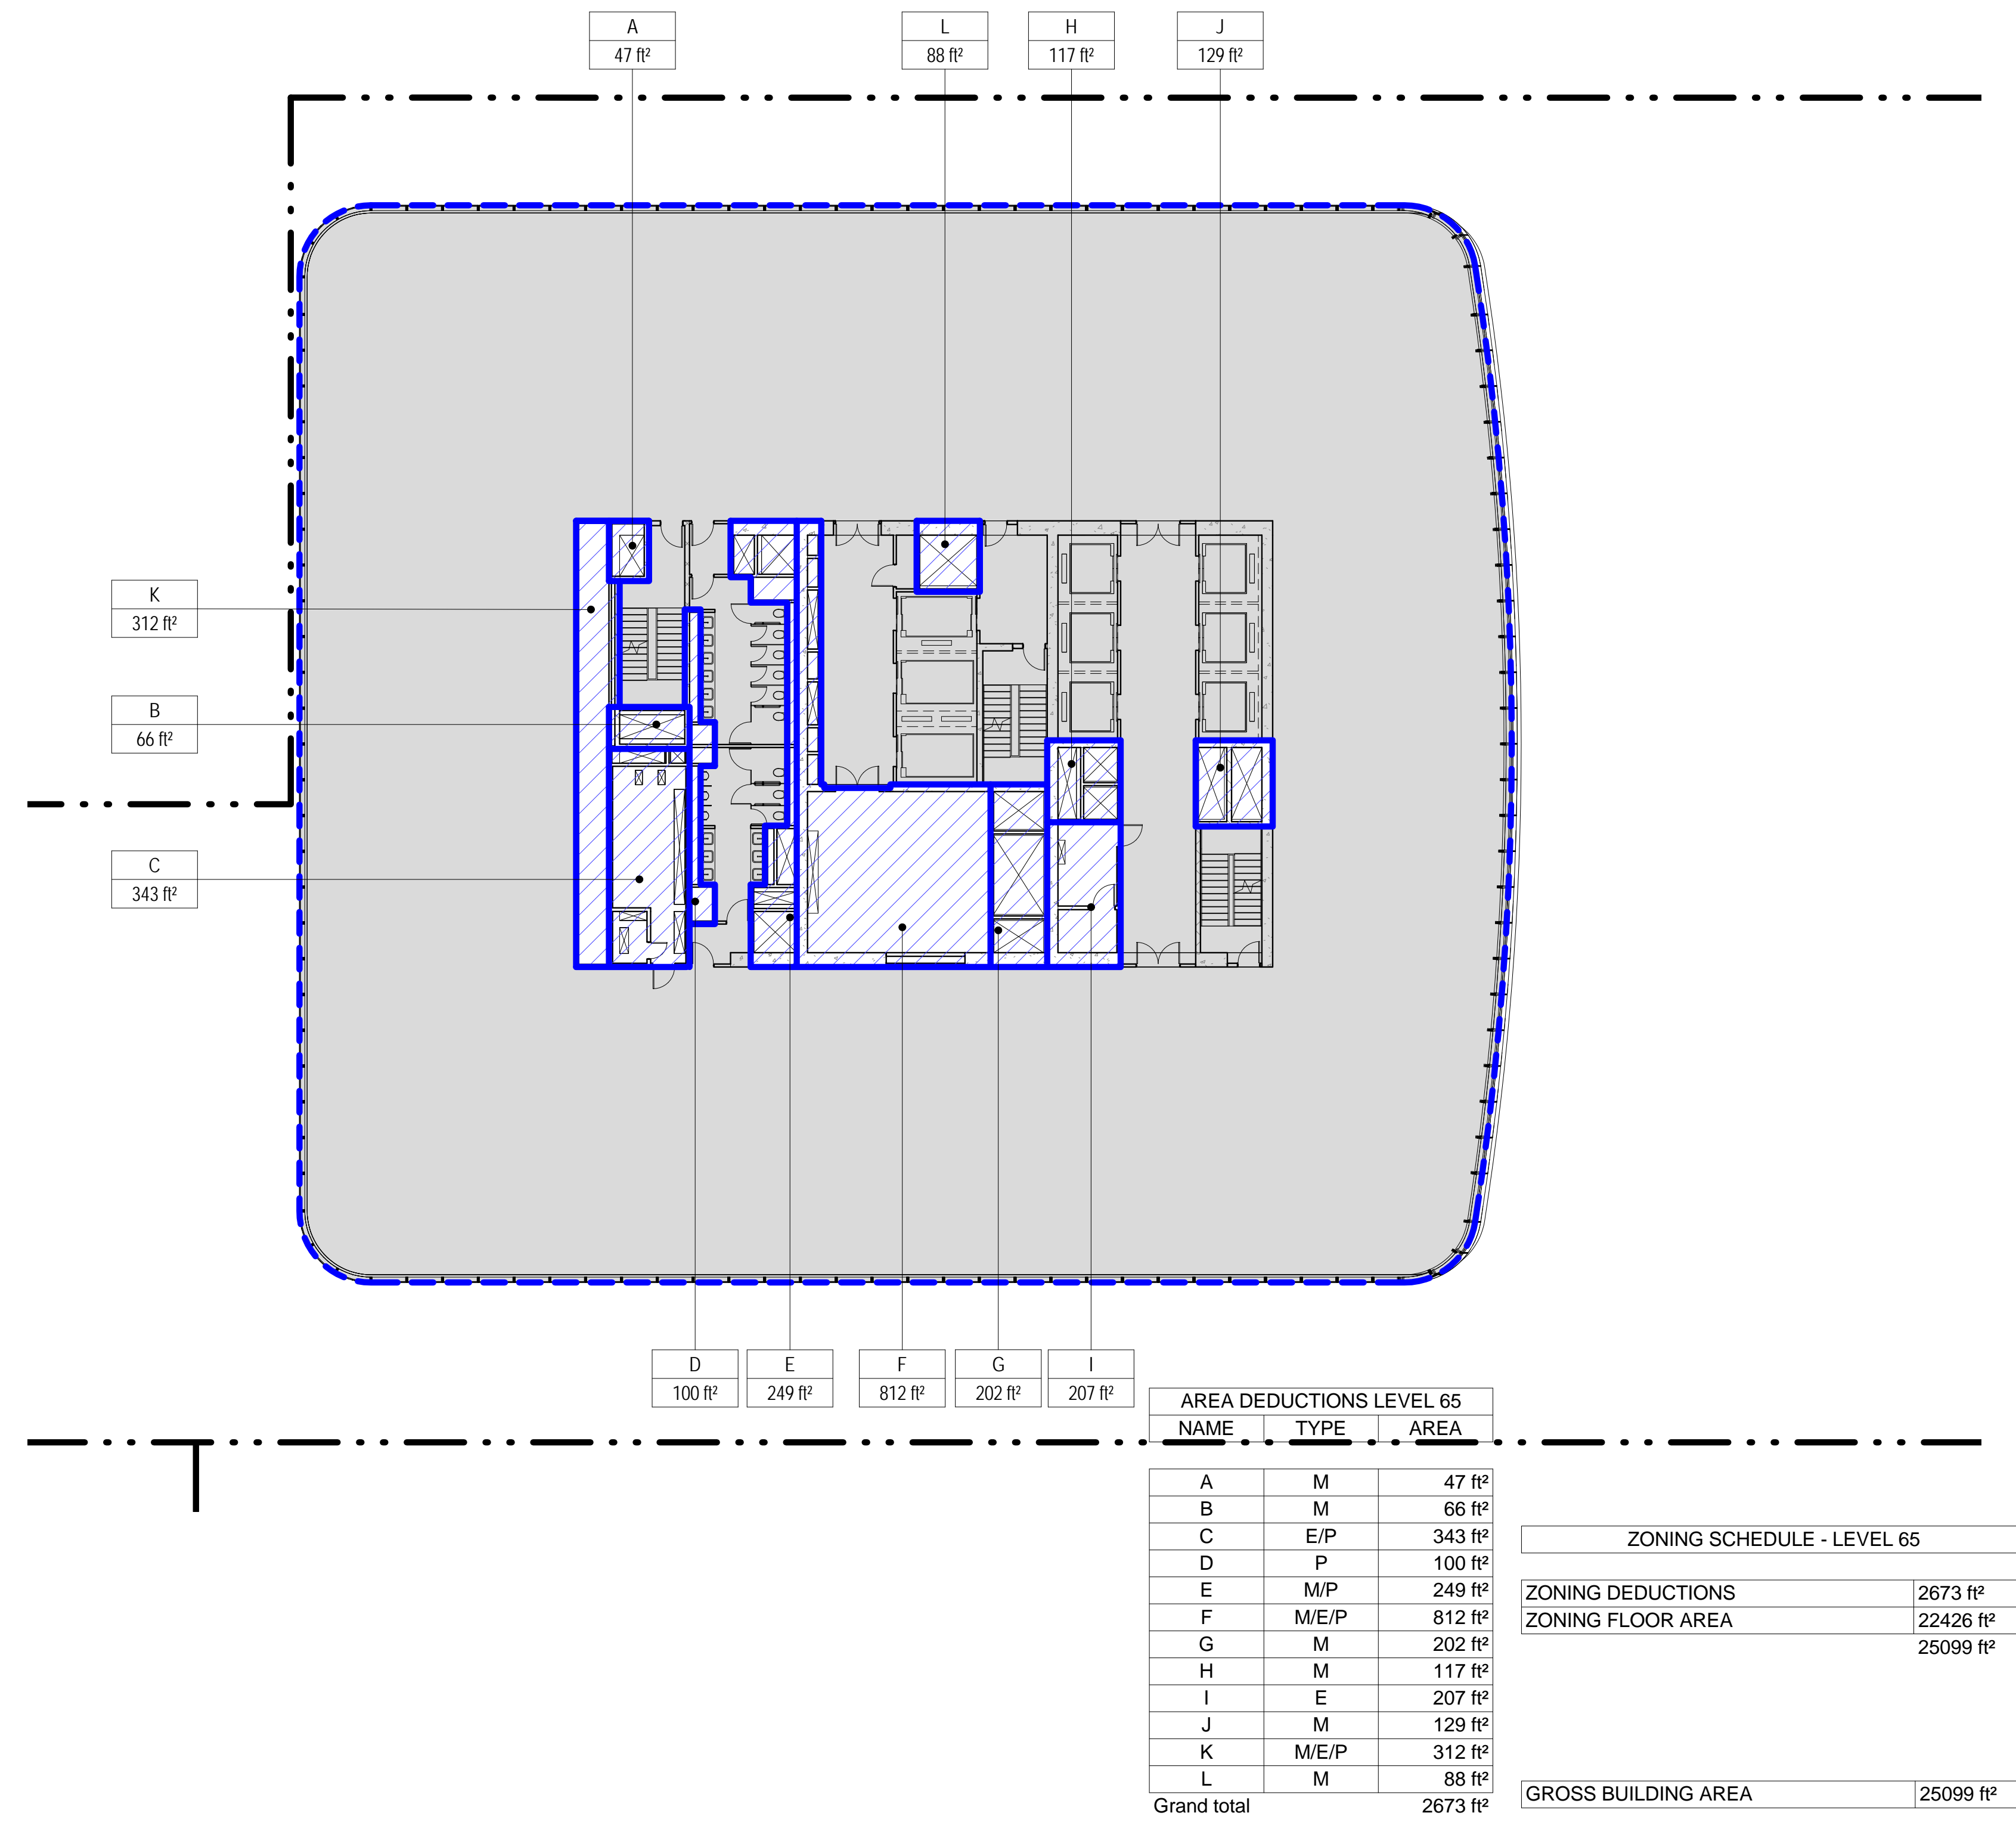

2 LEVEL 66 PLAN
SCALE: 1/16" = 1'-0"

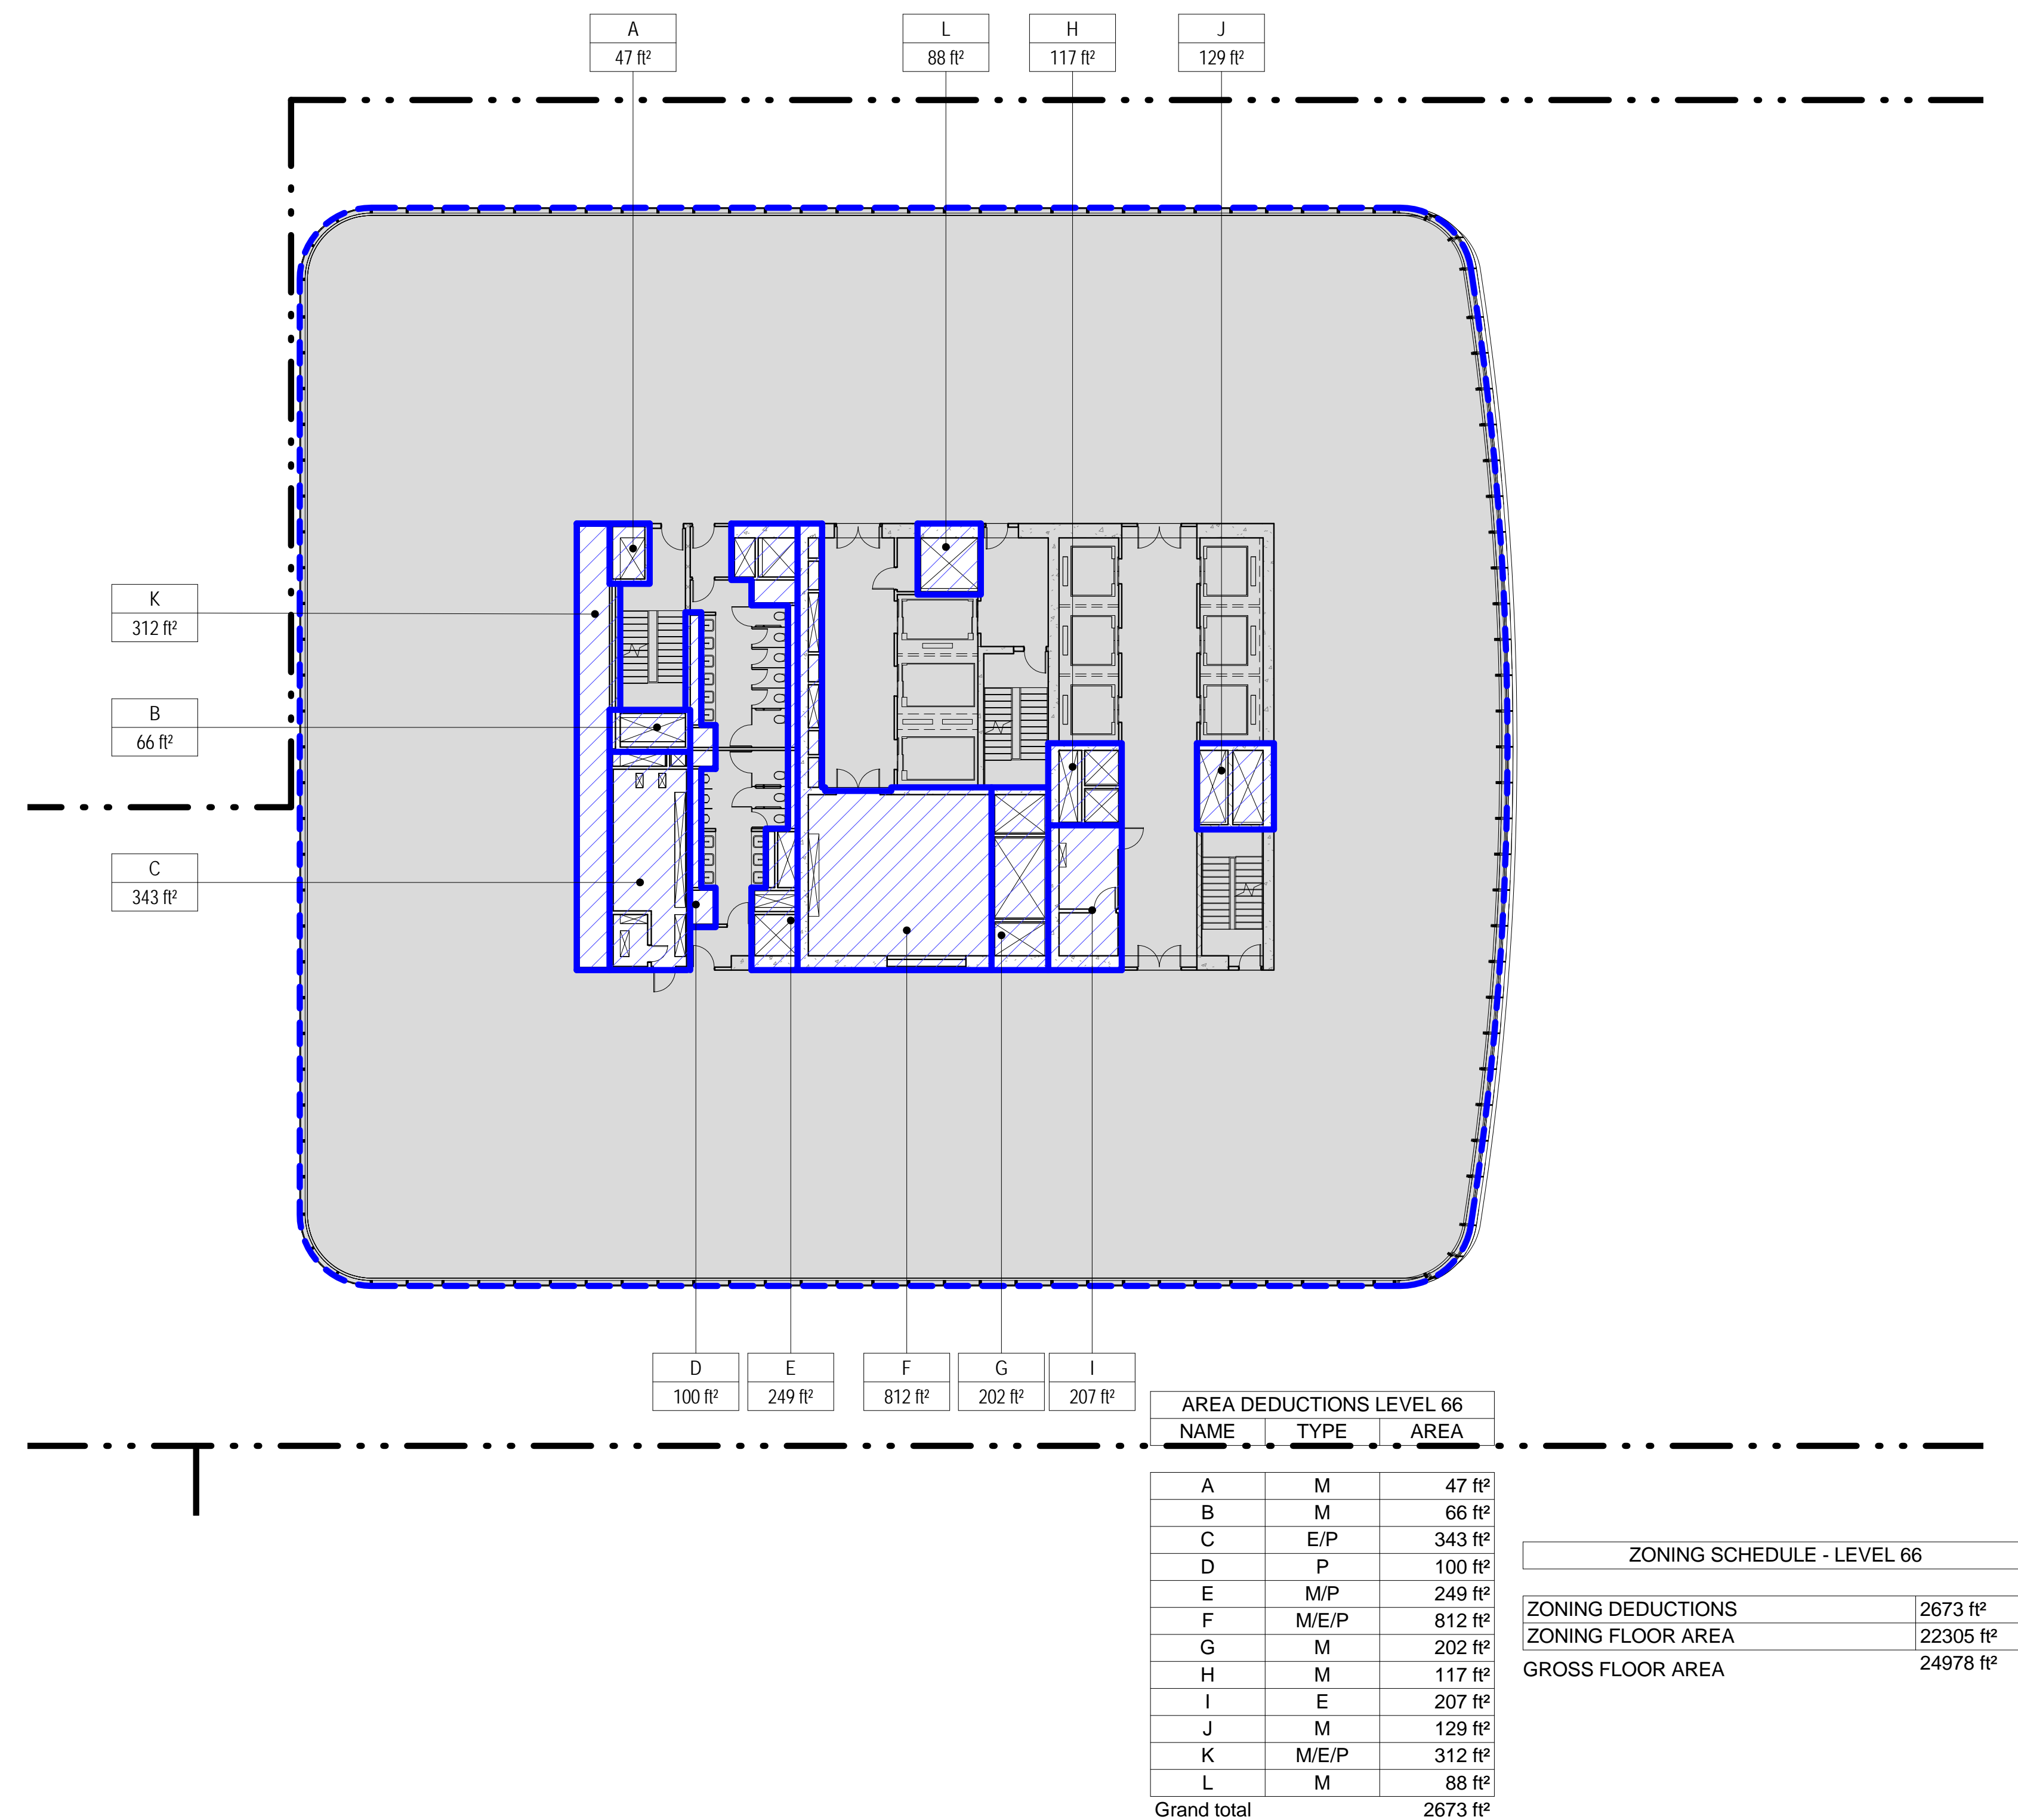

- ZONING LEGENDS**
- GROSS BUILDING AREA
 - ZONING AREA DEDUCTIONS
 - ZONING FLOOR AREA
 - RETAIL
 - MR MECHANICAL ROOM
 - M MECHANICAL
 - E ELECTRICAL/TEL./IT
 - P PLUMBING
 - EM ELEVATOR MACHINE ROOM

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No.	Date	Description
2	20 JUN 2014	ISSUED FOR FOUNDATION PERMIT
1	20 DEC 2013	ISSUED FOR FOUNDATION PERMIT

Sheet Name:

ZONING FLOOR AREA DEDUCTIONS - LEVEL 65-68


Project No.:	B-SCAN Sheet No.:
207150	Z-120.00

Date:	Sheet No.:
20 JUN 2014	Z-120

Scale:	Page No.:
1/16" = 1'-0"	27 OF 28

File No.:	Page No.:
Z-120	27 OF 28

ZONING FLOOR AREA DEDUCTIONS - LEVEL 65-68

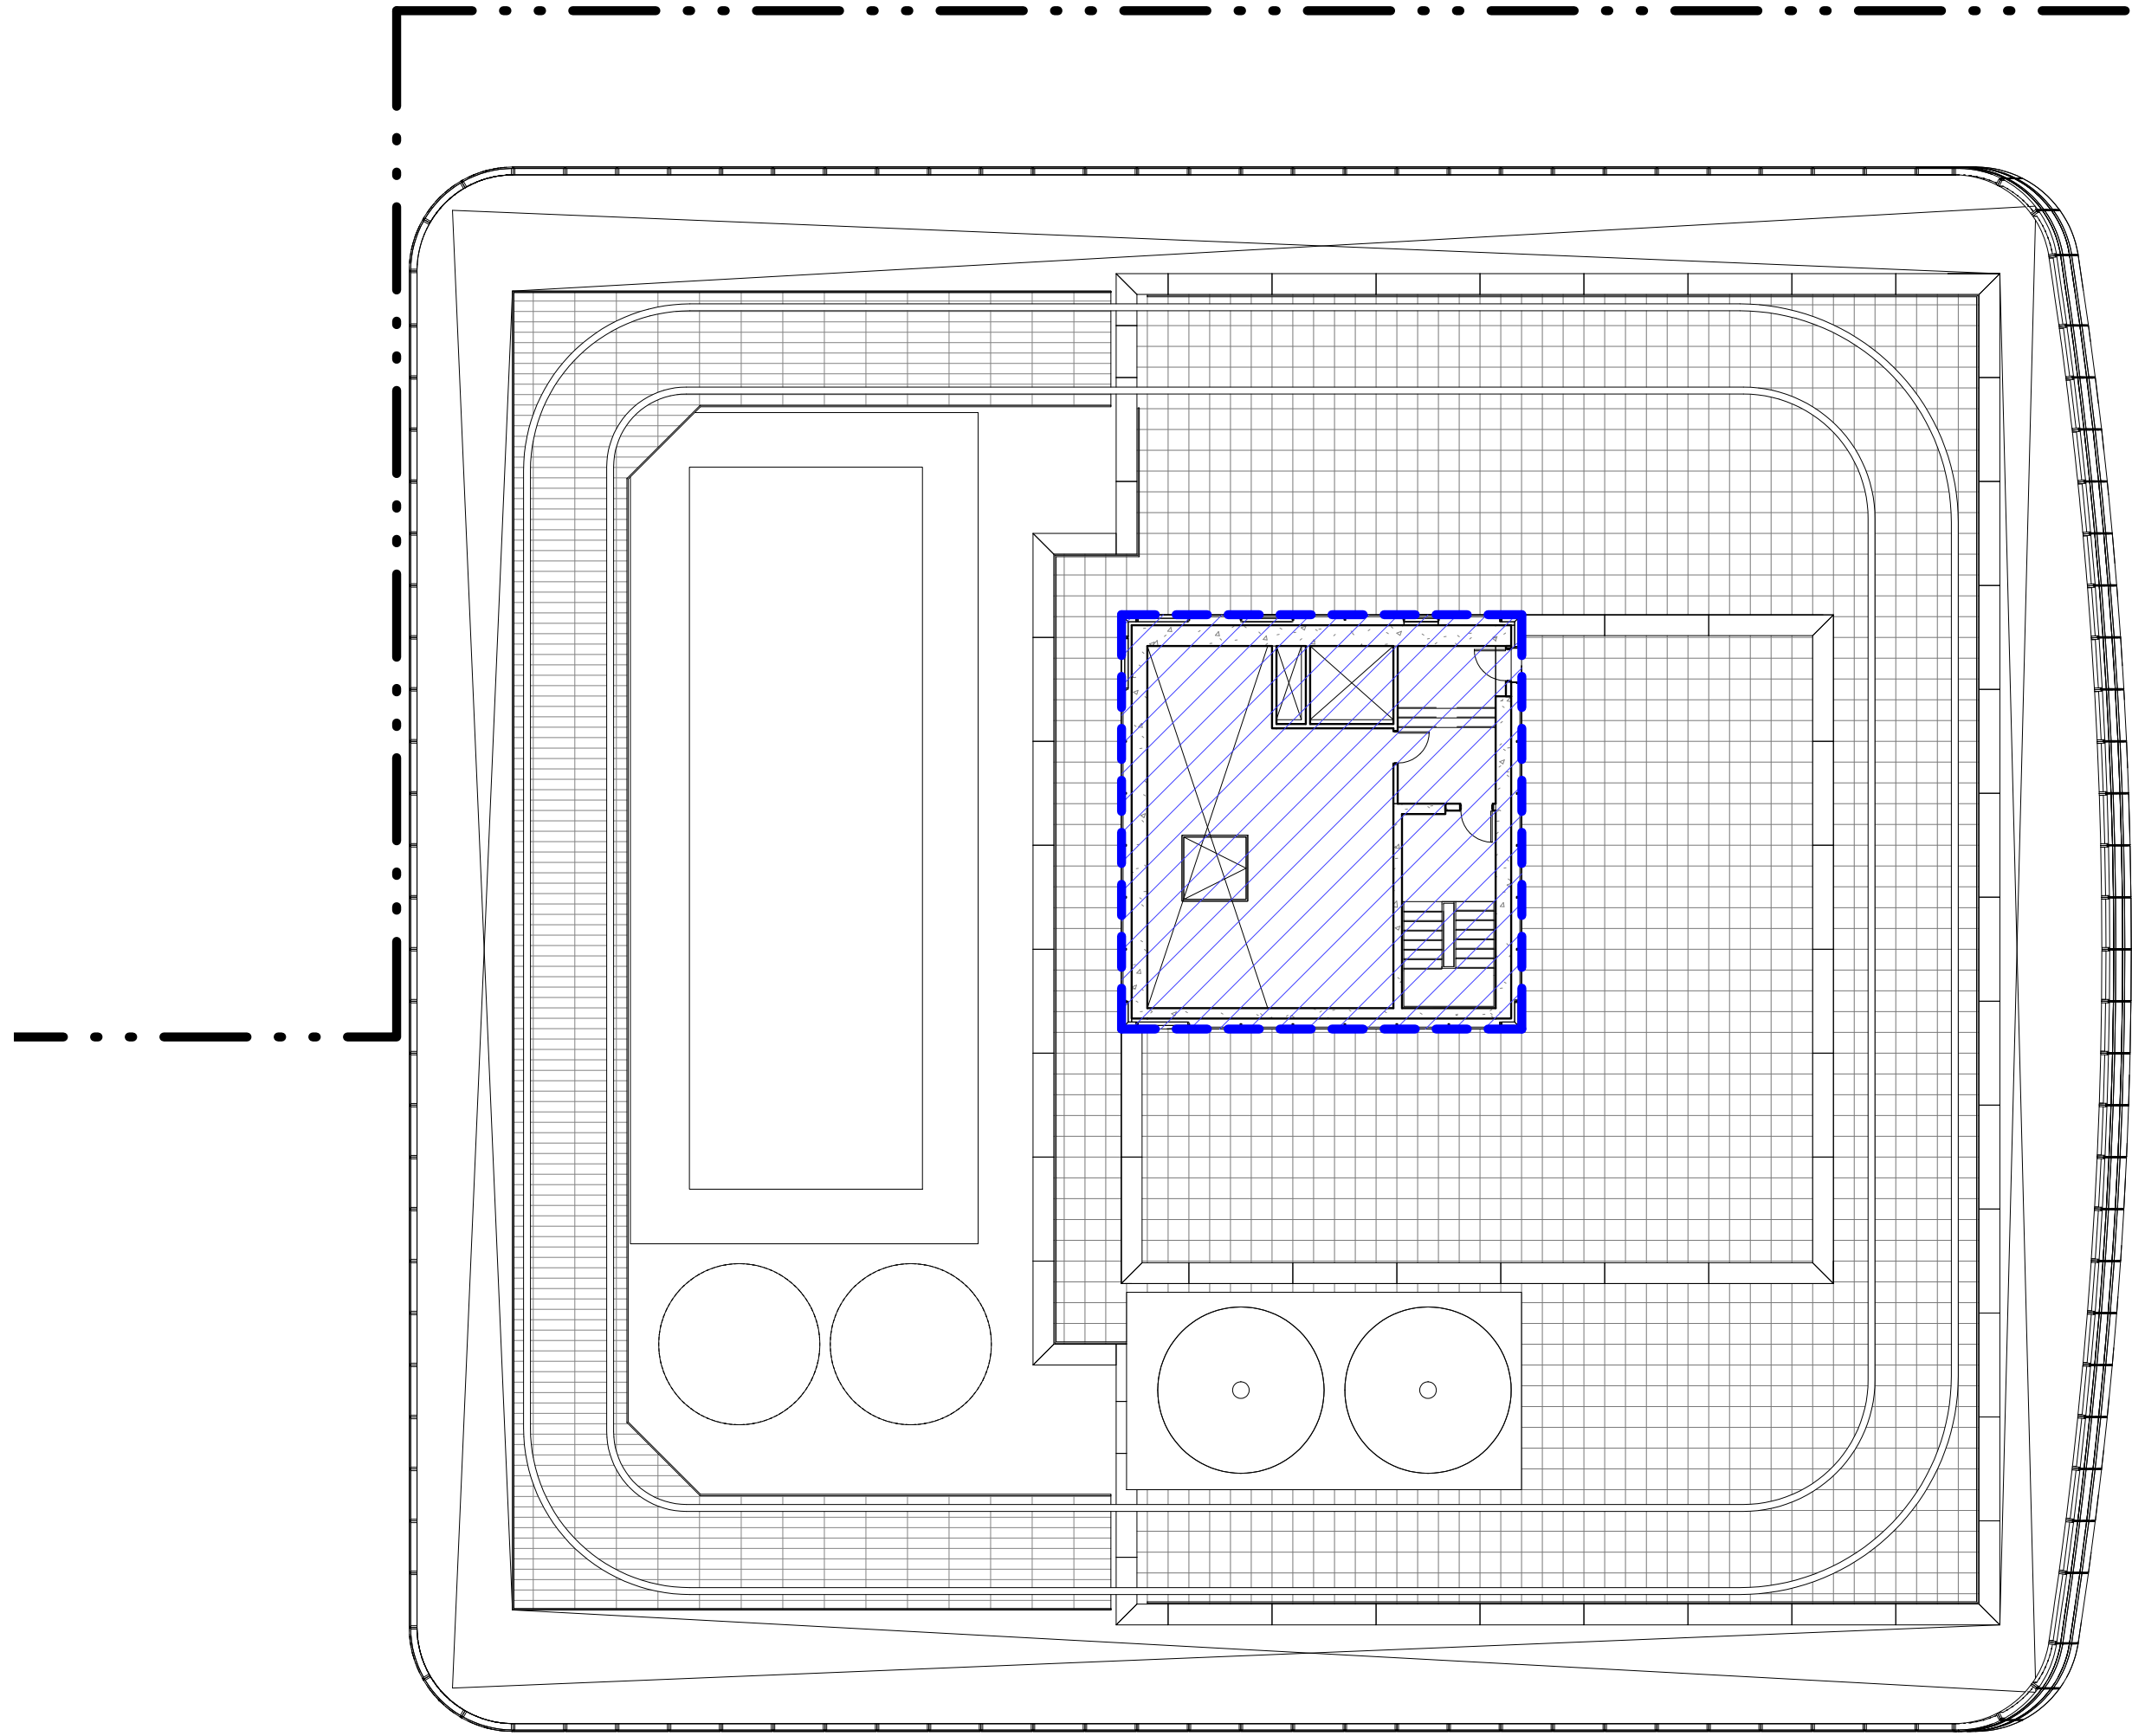


ZONING SCHEDULE - MECHANICAL PENTHOUSE ROOF

ZONING DEDUCTIONS	1534 R ²
GROSS FLOOR AREA	1534 R ²

3 MECH. PENTHOUSE ROOF PLAN

SCALE: 1/16" = 1'-0"

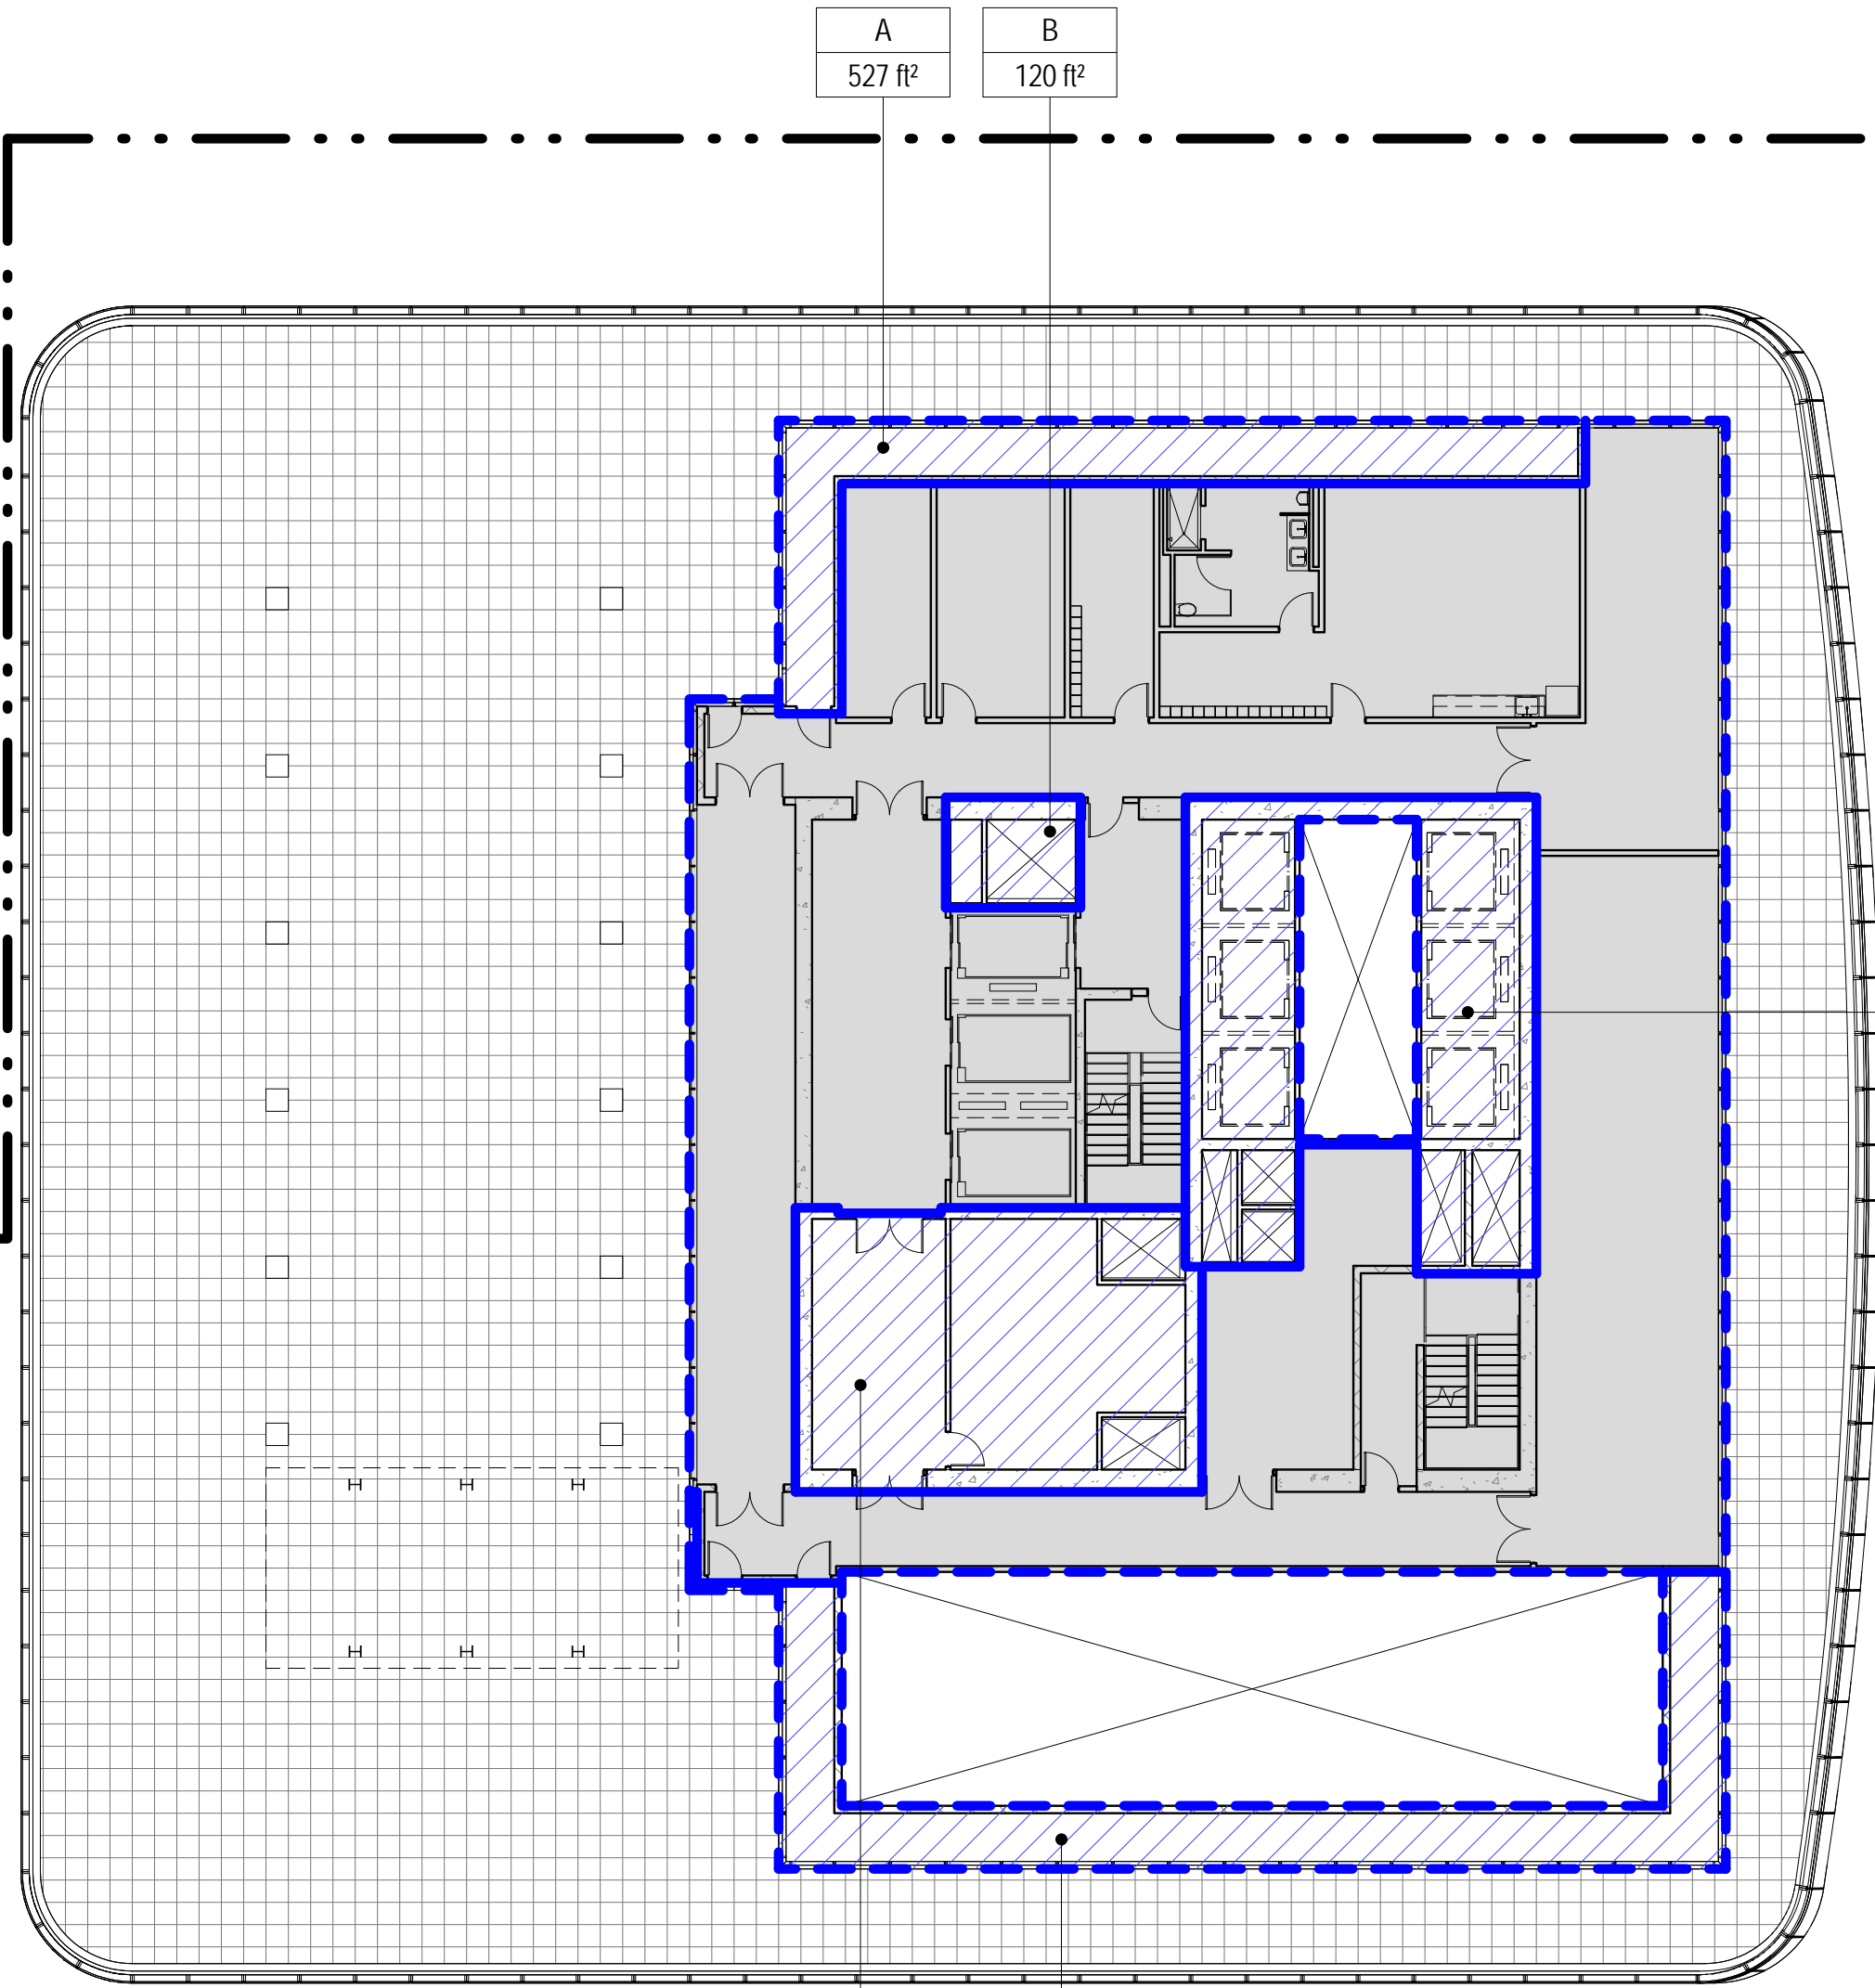

A	527 R ²
B	120 R ²

C	918 R ²
---	--------------------


D	918 R ²
E	725 R ²

AREA DEDUCTIONS LEVEL 69		
NAME	TYPE	AREA
A	M	527 R ²
B	E/P	120 R ²
C	M/E/P	918 R ²
D	M/E/P	918 R ²
E	M	725 R ²
Grand total		3208 R ²

ZONING SCHEDULE - LEVEL 69	
ZONING DEDUCTIONS	3208 R ²
ZONING FLOOR AREA	6635 R ²
GROSS BUILDING AREA	9843 R ²

1 LEVEL 69 PLAN

SCALE: 1/16" = 1'-0"

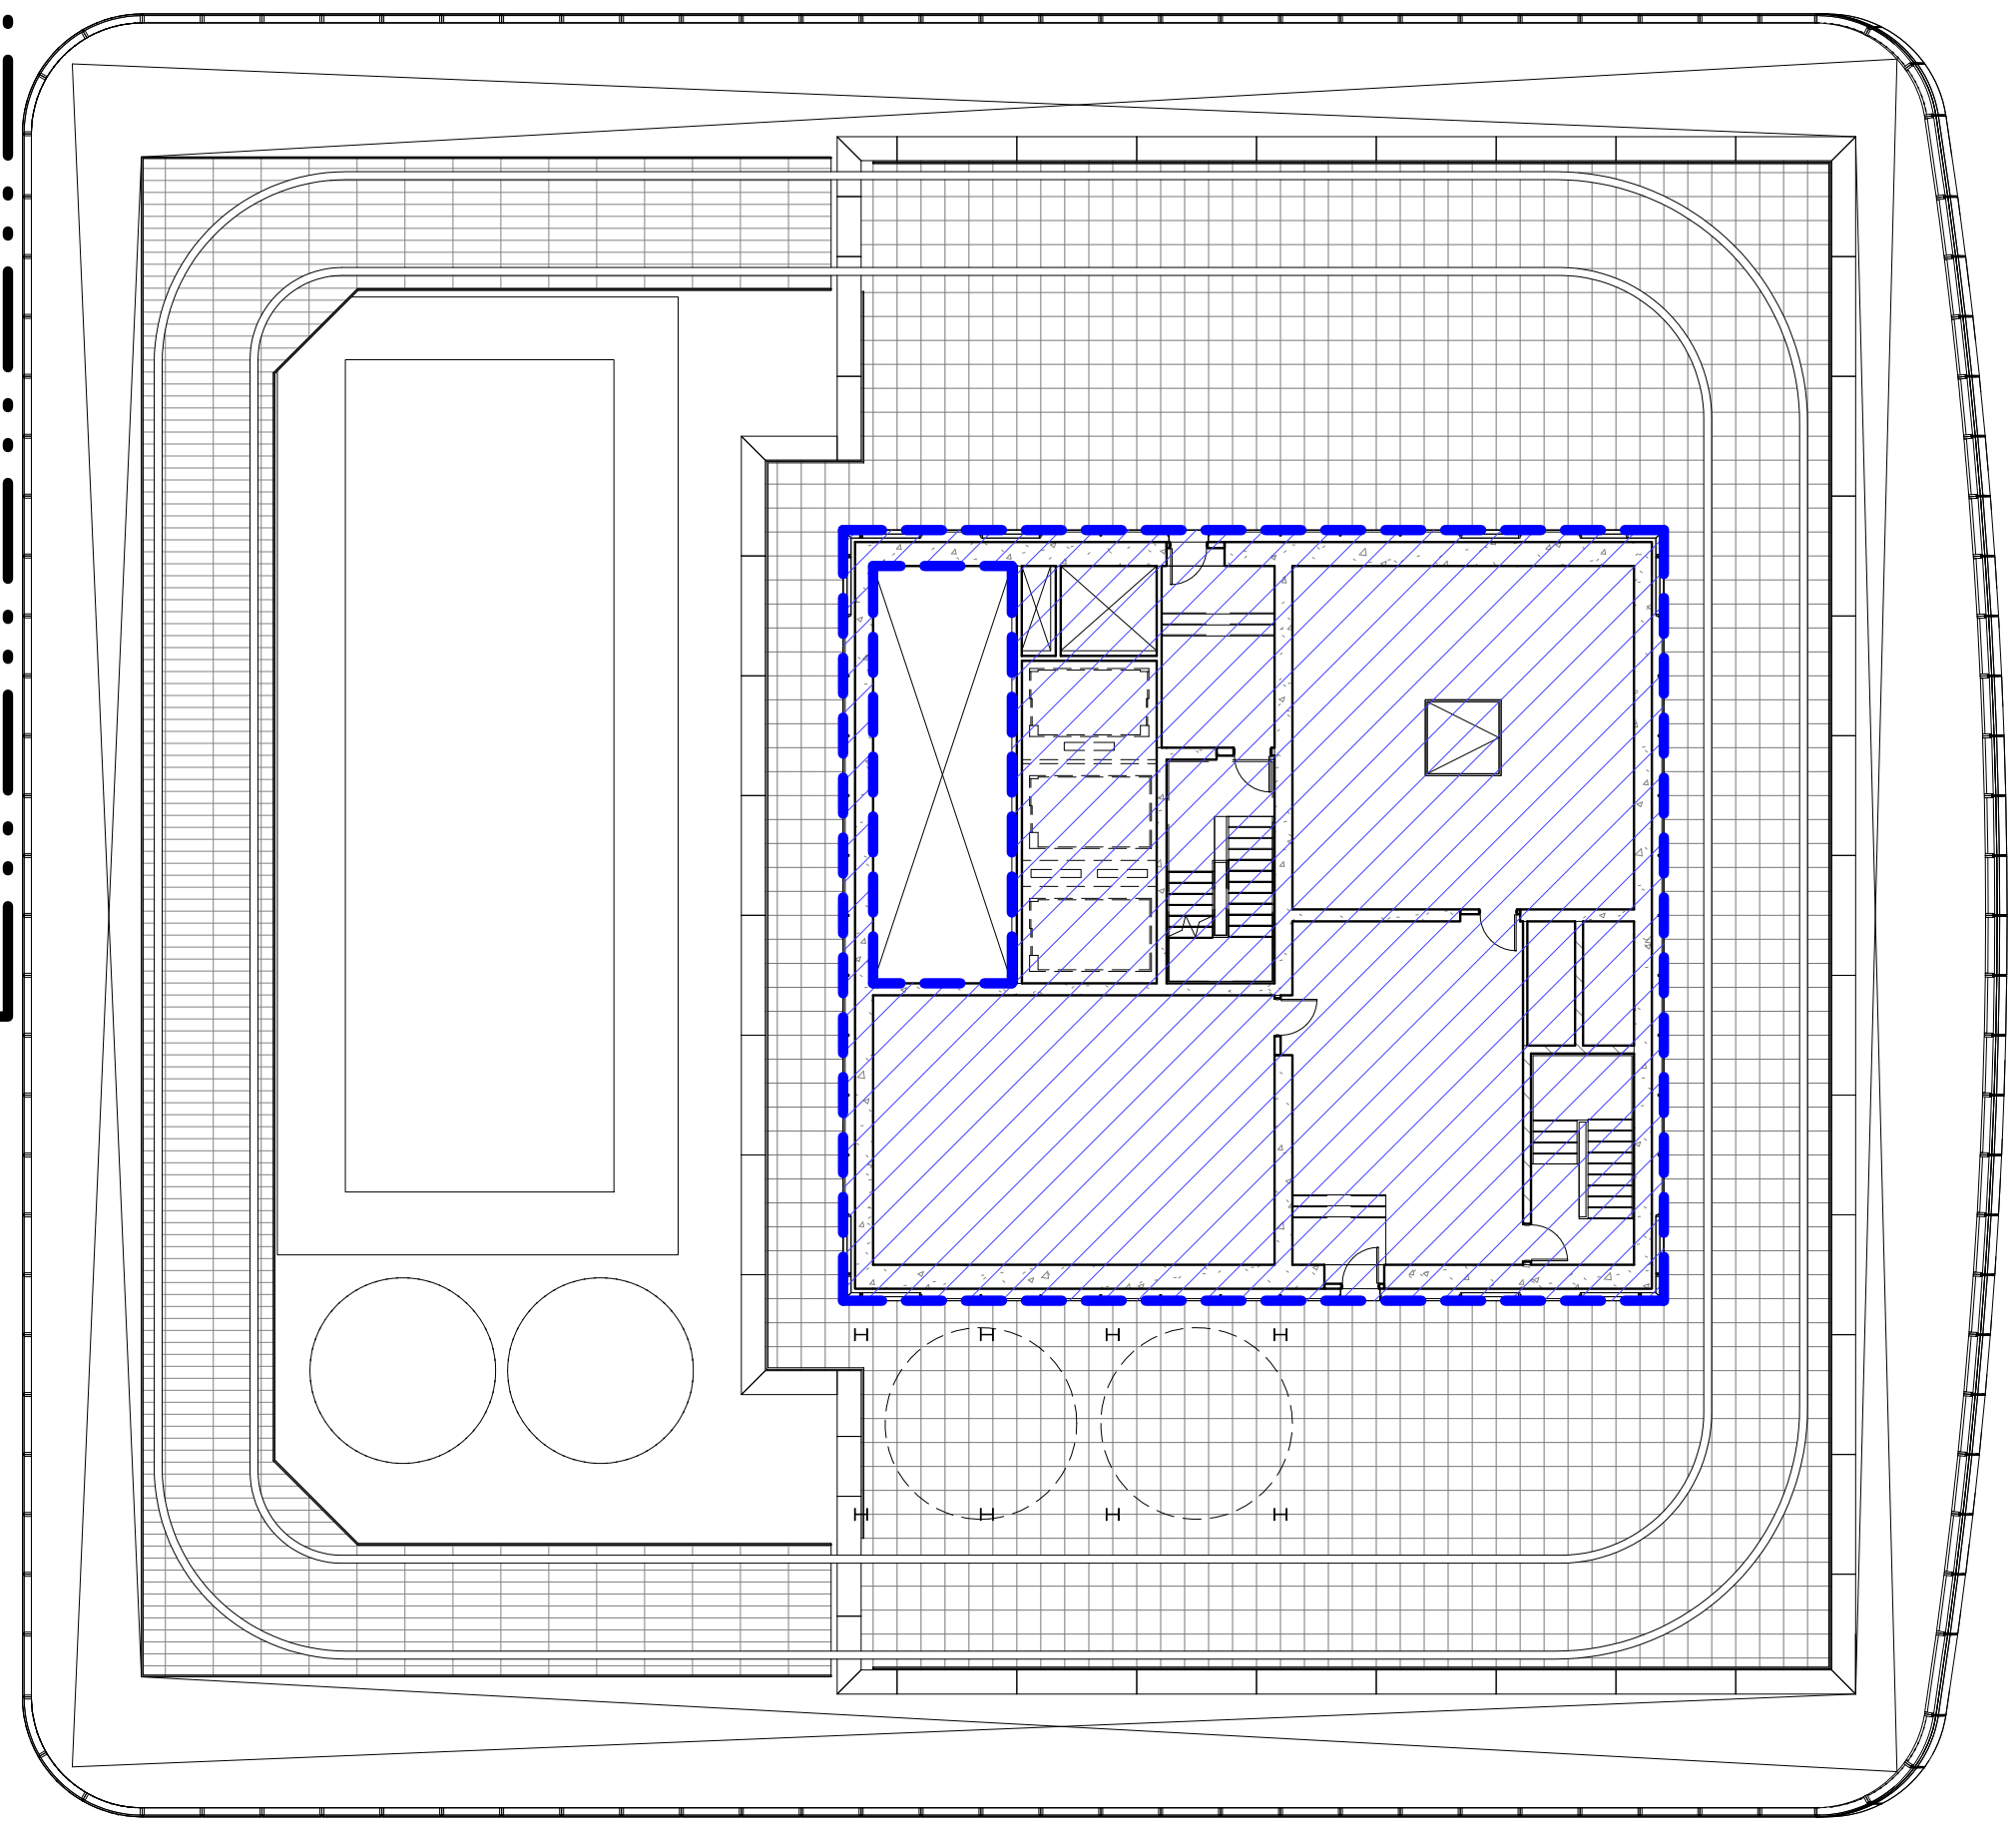

ZONING SCHEDULE - MECHANICAL PENTHOUSE	
ZONING DEDUCTIONS	4003 R ²
GROSS FLOOR AREA	4003 R ²

2 MECH. PENTHOUSE PLAN

SCALE: 1/16" = 1'-0"

- ZONING LEGENDS**
- GROSS BUILDING AREA
 - ZONING AREA DEDUCTIONS
 - ZONING FLOOR AREA
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 - MR MECHANICAL ROOM
 - M MECHANICAL
 - E ELECTRICAL/TEL./IT
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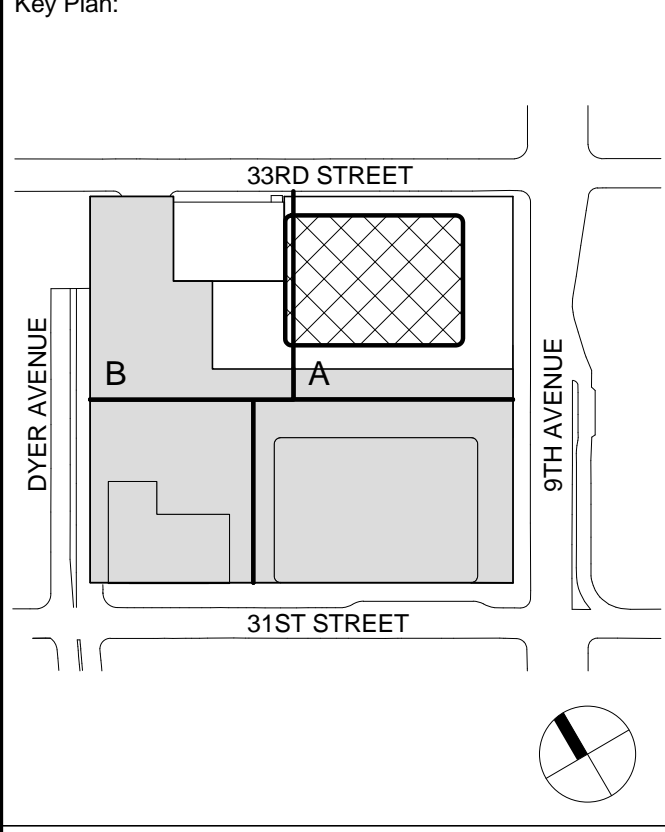
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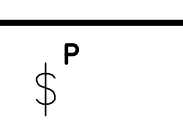

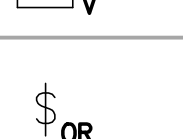


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No.	Date	Description
2	20 JUN 2014	ISSUED FOR FOUNDATION PERMIT
1	20 DEC 2013	ISSUED FOR FOUNDATION PERMIT

**ZONING FLOOR
AREA
DEDUCTIONS -
LEVEL 69 &
PENTHOUSE
ROOF PLANS**


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Date: 20 JUN 2014	Sheet No.: Z-121
Scale: 1/16" = 1'-0"	Page No.: 28 OF 28
File No.: Z-121	



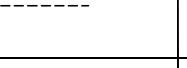

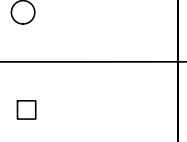
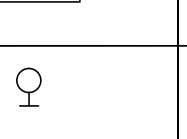
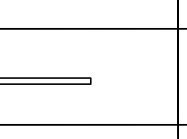
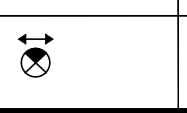




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DRAWING NUMBER	DRAWING TITLE	ISSUED DRAWING DATES		
		09.12.2014		
EN-001.00	NYC EC COMPLIANCE COVER SHEET	•		
EN-002.00	NYC EC COMPLIANCE MANDATORY MEASURES SHEET NO. 1	•		
EN-003.00	NYC EC COMPLIANCE MANDATORY MEASURES SHEET NO. 2	•		
EN-004.00	NYC EC COMPLIANCE ENERGY MODELING AND PRESCRIPTIVE PATH SHEET NO. 1	•		
EN-005.00	NYC EC COMPLIANCE ENERGY MODELING AND PRESCRIPTIVE PATH SHEET NO. 2	•		
EN-100.00	NYC EC COMPLIANCE LIGHTING CELLAR B1 FLOOR PLAN - PART A	•		
EN-101.00	NYC EC COMPLIANCE LIGHTING CELLAR 8 FLOOR PLAN - PART A	•		
EN-102.00	NYC EC COMPLIANCE LIGHTING CELLAR 8 FLOOR PLAN - PART B	•		
EN-103.00	NYC EC COMPLIANCE LIGHTING LEVEL 1 FLOOR PLAN	•		
EN-104.00	NYC EC COMPLIANCE LIGHTING LEVEL 2 FLOOR PLAN	•		
EN-105.00	NYC EC COMPLIANCE LIGHTING LEVEL 4 FLOOR PLAN	•		
EN-106.00	NYC EC COMPLIANCE LIGHTING LEVEL 5 FLOOR PLAN	•		
EN-107.00	NYC EC COMPLIANCE LIGHTING LEVEL 5-16 FLOOR PLAN	•		
EN-108.00	NYC EC COMPLIANCE LIGHTING LEVEL 17 FLOOR PLAN	•		
EN-109.00	NYC EC COMPLIANCE LIGHTING LEVEL 18 FLOOR PLAN	•		
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EN-111.00	NYC EC COMPLIANCE LIGHTING LEVEL 21-27 FLOOR PLAN	•		
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EN-134.00	NYC EC COMPLIANCE LIGHTING LEVEL 64-67 FLOOR PLAN	•		
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EN-136.00	NYC EC COMPLIANCE LIGHTING LEVEL 69 FLOOR PLAN	•		
EN-137.00	NYC EC COMPLIANCE LIGHTING ROOF PLAN MECH PENTHOUSE	•		
EN-138.00	NYC EC COMPLIANCE LIGHTING ROOF PLAN MECH PENTHOUSE ROOF	•		
EN-139.00	NYC EC COMPLIANCE LIGHTING SYSTEM CONTROLS SHEET NO. 1	•		

LIGHTING DEVICE SYMBOLS	
SYMBOL	LIGHTING DEVICES
	PILOT LIGHT SWITCH
	CEILING MOUNTED SENSOR
	VACANCY SENSOR SWITCH
	LIGHTING RELAY PANEL OVERRIDE SWITCH
	EMERGENCY NIGHT LIGHT

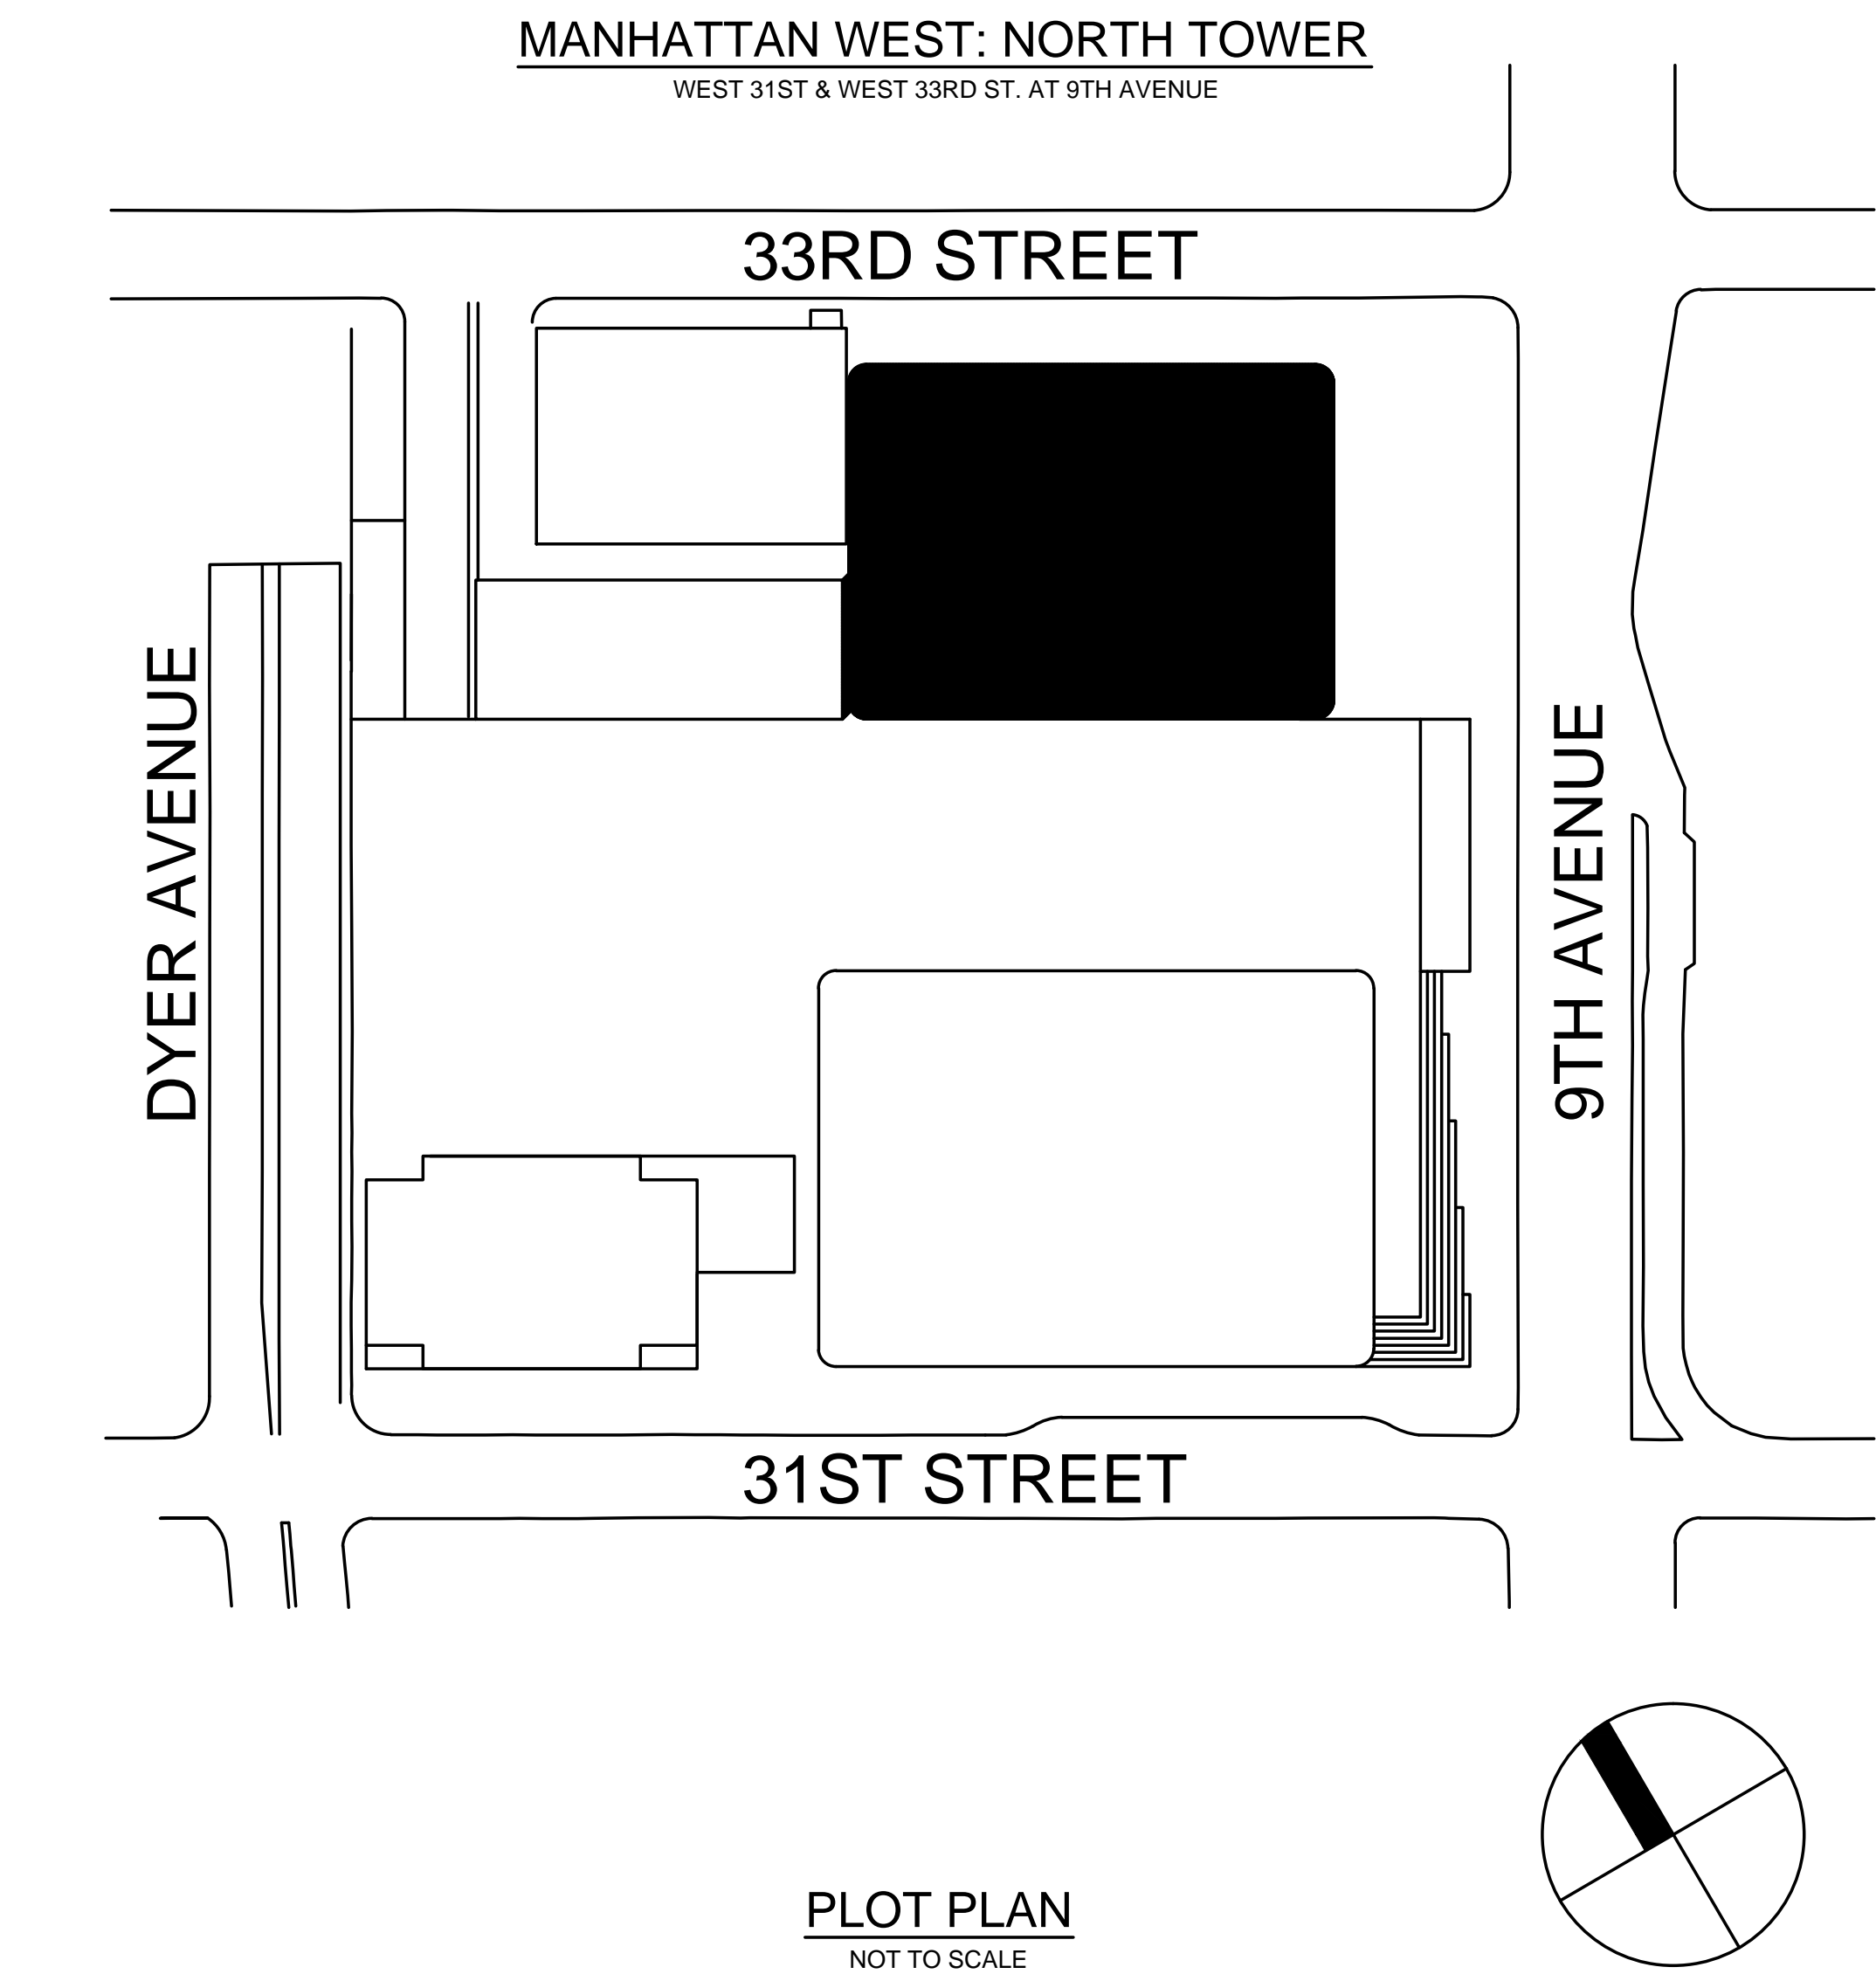ENERGY ANALYSIS 2011 NEW YORK CITY ENERGY CONSERVATION CODE CHAPTER 5 CLIMATE ZONE 4A				
2011 NEW YORK CITY ENERGY CONSERVATION CODE PROGRESS INSPECTIONS FOR ENERGY CODE COMPLIANCE – COMMERCIAL BUILDINGS				
	Inspection/Test	Periodic (minimum)	Reference Standard (See ECC Chapter 6) or Other Criteria	ECC or Other Citation
IIA	Envelope Inspections			
IIA1	Protection of exposed foundation insulation: Insulation shall be visually inspected to verify proper protection where applied to the exterior of basement or cellar walls, crawl-space walls and/or the perimeter of slab-on-grade floors.	As required during foundation work and prior to backfill	Approved construction documents	303.2.1; ASHRAE 90.1 – 5.8.1.7
IIA2	Insulation placement and R-values: Installed insulation for each component of the conditioned space envelope and at junctions between components shall be visually inspected to ensure that the R-values are marked, that such R-values conform to the R-values identified in the construction documents and that the insulation is properly installed. Certifications for unmarked insulation shall be similarly visually inspected.	As required to verify continuous enclosure while walls, ceilings and floors are open	Approved construction documents	303.1, 303.1.1, 303.1.2, 502.1, 502.2; ASHRAE 90.1 – 5.5, 5.6 or 11; 5.8.1
IIA3	Fenestration thermal values and product ratings: U-factors and SHGC values of installed fenestration shall be visually inspected for conformance with the U-factors and SHGC values identified in the construction drawings by verifying the manufacturer's NFRC labels or, where not labeled, using the ratings in ECC Tables 503.1.3(1), (2) and (3). Where ASHRAE 90.1 is used, visible light transmittance values shall also be verified.	As required during installation	Approved construction documents; NFRC 100, NFRC 200	303.1, 303.1.3, 502.3; ASHRAE 90.1 – 5.5, 5.6 or 11; 5.8.2
IIA4	Fenestration and door assembly product ratings for air leakage: Windows and sliding or swinging door assemblies, except site-built windows and/or doors, shall be visually inspected to verify that installed assemblies are listed and labeled by the manufacturer to the referenced standard. For curtain wall, storefront glazing, commercial entrance doors and revolving doors, the testing reports shall be reviewed to verify that the installed assembly complies with the standard cited in the approved plans.	As required during installation; prior to final construction inspection	NFRC 400, AAMA/WDMA/CSA 101/5.2/A440 ASTM E283; ANSI/DASMA 105	502.4; ASHRAE 90.1 – 5.4.3.2
IIA5	Fenestration areas: Dimensions of windows, doors and skylights shall be verified by visual inspection.	Prior to final construction inspection	Approved construction documents	502.3; ASHRAE 90.1 – 5.5.4, 5.6 or 11
IIA6	Sealing: Openings and penetrations in the building envelope, including site-built fenestration and doors, shall be visually inspected to verify that a continuous air barrier around the envelope forms an air-tight enclosure. The progress inspector shall visually inspect to verify that materials and/or assemblies have been tested and meet the requirements of the respective standards, or that the building is tested and meets the requirements of the standard, in accordance with the standard(s) cited in the approved plans.	As required during construction	Approved construction documents; ASTM E2178, ASTM E2357, ASTM E1677, ASTM E779, ASTM E283.	502.4.3, 502.4.7; ASHRAE 90.1 – 5.4.3.1
IIA7	Projection factors: Where the energy analysis utilized a projection factor > 0, the projection dimensions of overhangs, eaves or permanently attached shading devices shall be verified for conformance with approved plans by visual inspection.	Prior to final construction inspection	Approved construction documents, including energy analysis	502.3; ASHRAE 90.1 – 5.5.4, 5.6 or 11
IIA8	Loading dock weathertails: Weatherseals at loading docks shall be visually verified.	Prior to final construction inspection	Approved construction documents	502.4.5; ASHRAE 90.1 – 5.4.3.3
IIA9	Building entrance vestibules: Required entrance vestibules shall be visually inspected for proper operation.	Prior to final construction inspection	Approved construction documents	502.4.6; ASHRAE 90.1 – 5.4.3.4
IIIB	Mechanical and Service Water Heating Inspections			
IIIB1	Fireplaces: Provision of combustion air and tight-fitting fireplace doors shall be verified by visual inspection.	Prior to final construction inspection	Approved construction documents; ANSI Z21.60 (see also MC 904), ANSI Z21.50	303.1.5; BC 2111; MC Chapters 7, 9; FGC Chapter
IIIB2	Outdoor air intakes and exhaust openings: Dampers for stair and elevator shaft vents and other outdoor air intakes and exhaust openings integral to the building envelope shall be visually inspected to verify that such dampers, except where permitted to be gravity dampers, comply with approved construction drawings. Manufacturer's literature shall be reviewed to verify that the product has been tested and found to meet the standard.	As required during installation	Approved construction documents; AMCA 500D	502.4; ASHRAE 90.1 – 6.4.3.4
IIIB3	HVAC, service water heating and pool equipment sizing and performance: Equipment sizing, efficiencies and other performance factors of all major equipment units, as determined by the applicant of record, and no less than 15% of minor equipment units, shall be verified by visual inspection and, where necessary, review of manufacturer's data. Pool heaters and covers shall be verified by visual inspection.	Prior to final plumbing and construction inspection	Approved construction documents	503.2, 504.2, 504.7; ASHRAE 90.1 – 6.3, 6.4.1, 6.4.2, 6.8; 7.4, 7.8
IIIB4	HVAC system controls and economizers and service hot water system controls: No less than 20% of each type of required controls and economizers shall be verified by visual inspection and tested for functionality and proper operation. Such controls shall include, but are not limited to: Thermostatic; set point overlap restriction; Off-hour; Shut-off damper; Snow-melt system; Demand control systems; Outdoor heating systems; Zones; Economizers; Air systems; Variable air volume fan; Hydronic systems; Heat rejection equipment fan speed; Complex mechanical systems serving multiple zones; Ventilation; Energy recovery systems; Hot gas bypass limitation; Temperature; Service water heating; Hot water system; Pool heater and time switches; Exhaust hoods; Radiant heating systems. Controls with seasonally dependent functionality: Controls whose complete operation cannot be demonstrated due to prevailing weather conditions typical of the season during which progress inspections will be performed shall be permitted to be signed off for the purpose of a Temporary Certificate of Occupancy with only a visual inspection, provided, however, that the progress inspector shall perform a supplemental inspection where the controls are visually inspected and tested for functionality and proper operation during the next immediate season thereafter. The owner shall provide full access to the progress inspector within two weeks of the progress inspector's request for such access to perform the progress inspection. For such supplemental inspections, the Department shall be notified by the approved progress inspection agency of any unresolved deficiencies in the installed work within 180 days of such supplemental inspection.	After installation and prior to final electrical and construction inspection, except that for controls with seasonally dependent functionality, such testing shall be performed before sign-off for issuance of a Final Certificate of Occupancy	Approved construction documents, including control system narratives; ASHRAE Guideline 1: The HVAC Commissioning Process where applicable	503.2.4, 503.2.5.1, 503.2.11, 503.3, 503.4, 504.3, 504.6, 504.7; ASHRAE 90.1 – 6.3, 6.4, 6.5, 6.7.2.4, 7.4.4, 7.4.5
IIIB5	Duct, plenum and piping insulation and sealing: Installed duct and piping insulation shall be visually inspected to verify proper insulation placement and values. Joints, longitudinal and transverse seams and connections in ductwork shall be visually inspected for proper sealing.	After installation and prior to closing shafts, ceilings and walls	Approved construction documents; SMACNA Duct Construction Standards, Metal and Flexible	503.2.7, 503.2.8, 504.5; ASHRAE 90.1 – 6.3, 6.4.4.2, 6.8.2, 6.8.3; 7.4.3
IIIB6	Air leakage testing for high-pressure duct systems: For duct systems designed to operate at static pressures in excess of 3 inches w.g. (746 Pa), representative sections, as determined by the progress inspector, totaling at least 25% of the duct area, per ECC 503.2.7.1.3, shall be tested to verify that actual air leakage is below allowable amounts.	After installation and sealing and prior to closing shafts, ceilings and walls	Approved construction documents; SMACNA HVAC Air Duct Leakage Test Manual	503.2.7.1.3; ASHRAE 90.1 – 6.4.4.2
IIIC	Electrical Power and Lighting Systems			
IIIC1	Electrical metering: The presence and operation of individual meters or other means of monitoring individual apartments shall be verified by visual inspection for all apartments.	Prior to final electrical and construction inspection	Approved construction documents	505.7
IIIC2	Lighting in dwelling units: Lamps in permanently installed lighting fixtures shall be visually inspected to verify compliance with high-efficacy requirements.	Prior to final electrical and construction inspection	Approved construction documents	505.5.3
IIIC3	Interior lighting power: Installed lighting shall be verified for compliance with the lighting power allowance by visual inspection of fixtures, lamps, ballasts and transformers.	Prior to final electrical and construction inspection	Approved construction documents	505.5; ASHRAE 90.1 – 9.1, 9.2, 9.5, 9.6; 18CMV §101-07(c)(3)(v)(C)4
IIIC4	Exterior lighting: Installed lighting shall be verified for compliance with source efficacy and/or the lighting power allowance by visual inspection of fixtures, lamps, ballasts and relevant transformers.	Prior to final electrical and construction inspection	Approved construction documents	505.6; ASHRAE 90.1 – 9.4.4, 9.4.5; 18CMV §101-07(c)(3)(v)(C)4
IIIC5	Lighting controls: Each type of required lighting controls, including: occupant sensors; manual interior lighting controls; light-reduction controls; automatic lighting shut-off; daylight zone controls; sleeping unit controls; exterior lighting controls, shall be verified by visual inspection and tested for functionality and proper operation.	Prior to final electrical and construction inspection	Approved construction documents, including control system narratives	505.2, 505.2.2; ASHRAE 90.1 – 9.4.1, 9.4.1.2 (as modified by section ECC A102)
IIIC6	Exit signs: Installed exit signs shall be visually inspected to verify that the label indicates that they do not exceed maximum permitted wattage.	Prior to final electrical and construction inspection	Approved construction documents	505.4; ASHRAE 90.1 – 9.4.3
IIIC7	Tandem wiring: Tandem wiring shall be tested for functionality.	Prior to final electrical and construction inspection	Approved construction documents	505.3; ASHRAE 90.1 – 9.4.2
IIIC8	Electric motors (including but not limited to fan motors): Where required by the construction documents for energy code compliance, motor listing or labels shall be visually inspected to verify that they comply with the respective energy requirements in the construction documents.	Prior to final electrical and construction inspection	Approved construction documents	503.2.10; ASHRAE 90.1 – 10.4
IID	Other			
IID1	Maintenance information: Maintenance manuals for mechanical, service hot water and electrical equipment and systems requiring preventive maintenance shall be reviewed for applicability to installed equipment and systems before such manuals are provided to the owner. Labels required for such equipment or systems shall be inspected for accuracy and completeness.	Prior to sign-off or issuance of Final Certificate of Occupancy	Approved construction documents, including electrical drawings where applicable; ASHRAE Guideline 4: Preparation of Operating and Maintenance Documentation for Building Systems	303.3, 503.2.9.3; ASHRAE 90.1 – 4.2.2.3, 6.7.2.2, 8.7.2
Note:				
(i) Energy Analysis of Constructed Conditions. In accordance with Section 28-104.3 of the Administrative Code and section ECC 103.4, if constructed work differs from the last approved full energy analysis, an as-built energy analysis shall be submitted to the Department, listing the actual values used in the building for all applicable Energy Code regulated items and demonstrating that the building complies with the Energy Code. Such energy analysis shall be signed and sealed by a registered design professional. The progress inspector shall certify that to the best of his or her knowledge and belief the building as built complies with such signed and sealed energy analysis and construction drawings for energy code compliance; where no trade-offs have been used among disciplines, more than one registered design professional may sign and seal the elements of the energy analysis. The energy analysis shall be approved or accepted by the Department prior to sign-off.				

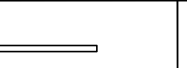ARCH DRAWING INDEX				
DRAWING NUMBER	DRAWING TITLE	ISSUED DRAWING DATES		
		09.12.2014		
EN-200.00	ENCLOSURE ASSEMBLIES	•		



LIGHTING FIXTURE SCHEDULE						
FIXTURE TYPE DESCRIPTION	SYMBOL	FIXTURE DESCRIPTION	LOCATION	UNITS	CONTROL GEAR	TOTAL SYSTEM WATTS
F1		LINEAR LED RECESSED DOWNLIGHT	RESTROOMS	PER FT.	ELECTRONIC DRIVER	7 W/FT.
LT01		RECESSED LED FIXED DOWNLIGHT, NOMINAL 4-1/2" SQUARE APERTURE AND 10" HOUSING DEPTH, SEMI-SPECULAR, NON-REDUCED CLEAR ALUM. REFLECTOR WITH WHITE PAINTED OVERLAP SELF-FLANGE, MICROPRISM GLASS LENS, DIMMABLE.	GROUND FLOOR LOBBY	EA.	DIMMING BALLAST	34 W
F2		LINEAR CORE VAPOR PROOF	SHOWERS	PER FT.	REMOTE DIMMING DRIVER	3.25 W/FT.
LT03		RECESSED LED WALL WASHER, NOMINAL 4-1/2" SQUARE APERTURE AND 11" HOUSING DEPTH, SEMI-SPECULAR, NON-REDUCED CLEAR ALUM. REFLECTOR WITH WHITE PAINTED OVERLAP SELF-FLANGE, FROSTED MICROPRISM GLASS LENS, DIMMABLE.	GROUND FLOOR LOBBY	EA.	DIMMING BALLAST	34 W
FA		5' COMPACT FLUORESCENT SEMI-RECESSED DOWNLIGHT	RESTROOMS	EA.	DIMMING BALLAST	32 W
FB		6' SQUARE COMPACT FLUORESCENT RECESSED DOWNLIGHT	ELEVATOR LOBBY	EA.	DIMMING BALLAST	26 W
FG		PENDANT-MOUNTED TWO LAMP FLUORESCENT GASKETED FIXTURE.	LOADING DOCK	EA.	ELECTRONIC BALLAST	120 W
FJ		LED WALL MOUNTED	PLENUM	EA.	REMOTE DIMMING DRIVER	26 W
FK		4' STRIP INDUSTRIAL FLUORESCENT PENDENT	GENERAL	EA.	ELECTRONIC BALLAST	32 W
FS		4' LINEAR FLUORESCENT LENSED SURFACE	STAIRWELLS	EA.	DIMMING DRIVER	32 W
FV		4' LINEAR INDUSTRIAL SURFACE	ELEVATOR/SUMP PUMP PIT	EA.	DIMMING DRIVER	64 W
EX		RECESSED WALL- OR CEILING-MOUNTED LED EXIT SIGN	GENERAL	PER FACE	INTEGRAL BATTERY PACK	5 W/ FACE (MAX)


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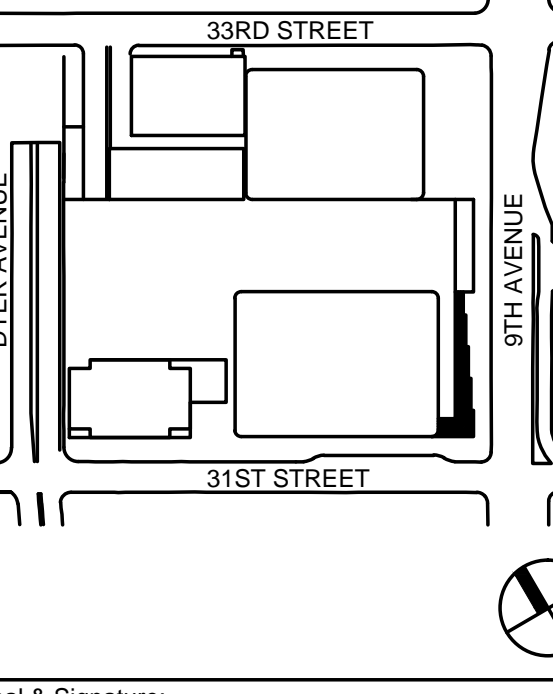
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
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Seal & Signature:



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COVER SHEET

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SHEET NOTES

TABLE 3 – AIR-CONDITIONING CONTROLS SYSTEMS WORKSHEET																															
SYSTEM TAG	AC-B-1 & AC-B-2	AC-B-3	AC-B-4	AC-B-5	AC-B-6	AC-B-7	AC-B-8	AC-6-1 thru AC-67-1	AC-B1-1	AC-B2-1	AC-B3-1	AC-1-1	AC-2-1	AC-4-1	AC-20-1B & 2B	AC-30-1B	AC-40-1B & 2B	AC-52-1B	AC-62-1B	AC-70-1B	AC-71-1B	AHU-4-1	AHU-4-2	HV-4-1&2	HV-4-3	HV-5-1	HV-5-2	HV-6B-1&2	HV-6B-3	HV-6B-4&5	
SUPPLY CFM	8,000	12,000	800	800	800	800	800	25,000	3,000	3,000	3,000	1,500	1,500	3,000	2,000	5,000	5,000	10,000	10,000	10,000	7,500	15,000	55,000	75,000	62,500	15,000	11,000	37,500	18,000	32,000	
SUPPLY ESP	1.0	1.0	1.0	1.0	1.0	1.0	1.0	2.5	0.75	0.75	0.75	0.75	0.75	0.75	0.5	0.75	0.75	1.0	1.0	1.0	1.0	2.0	2.0	2.0	1.5	2.0	2.0	2.0	1.5	1.5	
FAN SYSTEM HP	7-1/2	15	3/4	3/4	3/4	3/4	3/4	40	3	3	3	1-1/2	1-1/2	3	1-1/2	5	5	10	10	10	7-1/2	25	100	125	75	20	15	60	20	50	
OA CFM	0	0	150	150	150	150	150	4,500	0	0	0	0	0	0	0	0	0	0	0	0	0	3,000	11,000	75,000	62,500	15,000	11,000	37,500	18,000	32,000	
AUTOMATIC SHUTDOWN (SECTION 6.4.3.2.1)																															
N1	N2	N2	N2	N2	N2	N2	N2	C1	N1	N1	N1	N1	N1	N1	N1	N1	N1	N1	N1	N1	C1	C1	N1	N1	N1	N1	N1	N1	N1	N1	N1
DEAD BAND (SECTION 6.4.3.2.1)																															
N2	N2	N2	N2	N2	N2	N2	N2	N2	N2	N2	N2	N2	N2	N2	N2	N2	N2	N2	N2	N2	C1	C1	N2	N2	N2	N2	N2	N2	N2	N2	N2
SETBACK CONTROLS (SECTION 6.4.3.2.2)																															
N5	N5	N5	N5	N5	N5	N5	N5	N5	N5	N5	N5	N5	N5	N5	N5	N5	N5	N5	N5	N5	C1	C1	N1	N1	N1	N1	N1	N1	N1	N1	N1
OPTIMUM START CONTROLS (SECTION 6.4.3.2.3)																															
N1	N1	N3	N3	N3	N3	N3	N3	C1	C1	C1	C1	C1	C1	C1	N1	N1	N1	N1	N1	N1	C1	C1	N1	N1	N1	N1	N1	N1	N1	N1	N1
ZONE ISOLATION (SECTION 6.4.3.2.4)																															
N1	N1	N2	N2	N2	N2	N2	N2	C1	C1	C1	C1	C1	C1	C1	N1	N1	N1	N1	N1	N1	C1	C1	N1	N1	N1	N1	N1	N1	N1	N1	N1
SHUTOFF DAMPER CONTROLS (SECTION 6.4.3.3.4)																															
N1	N1	N2	N2	N2	N2	N2	N2	C1	C1	C1	C1	C1	C1	C1	N1	N1	N1	N1	N1	N1	C1	C1	N1	N1	N1	N1	N1	N1	N1	N1	N1
HEAT PUMP AUX HEAT CONTROL (SECTION 6.4.3.4)																															
N1	N1	N1	N1	N1	N1	N1	N1	N1	N1	N1	N1	N1	N1	N1	N1	N1	N1	N1	N1	N1	N1	N1	N1	N1	N1	N1	N1	N1	N1	N1	N1
HUMIDIFIER PREHEAT (SECTION 6.4.3.5)																															
N1	N1	N1	N1	N1	N1	N1	N1	N1	N1	N1	N1	N1	N1	N1	N1	N1	N1	N1	N1	N1	N1	N1	N1	N1	N1	N1	N1	N1	N1	N1	N1
HUMIDIFICATION & DEHUMIDIFICATION (SECTION 6.4.3.6)																															
N1	N1	N1	N1	N1	N1	N1	N1	N1	N1	N1	N1	N1	N1	N1	N1	N1	N1	N1	N1	N1	N1	N1	N1	N1	N1	N1	N1	N1	N1	N1	N1

TABLE 3 - CONTROLS LEGEND		
AUTOMATIC SHUTDOWN		OPTIMUM START CONTROLS
C1 COMPLYING NONRESIDENTIAL TIME SWITCH WITH OVERRIDE	C1	OPTIMUM START PROVIDED
C2 COMPLYING RESIDENTIAL TIME SWITCH WITH OVERRIDE	N1	N/A - SYSTEM NOT A HEAT PUMP
N1 N/A - UNIT CONTINUOUSLY OPERATES	N2	N/A <15 KBTU/H OR < 3/4 HP
N2 N/A - UNIT IS <15 KBTU/H OR < 3/4 HP	N3	N/A SUPPLY </= 10,000 CFM
N3 N/A - UNIT IS HOTEL/MOTEL GUESTROOM		
DEAD BAND		SHUTOFF DAMPER CONTROLS
C1 DUAL SET POINT CONTROL	C1	MOTORIZED SHUTOFF DAMPERS ON OA AND EXH
C2 MANUAL CHANGE OVER CONTROL	C2	GRAVITY SHUTOFF DAMPERS ON OA AND EXH
N1 N/A - SPECIAL OCCUPANCY	N1	N/A - UNIT CONTINUOUSLY OPERATES
N2 N/A - UNIT PROVIDES HEATING OR COOLING ONLY	N2	N/A - UNIT IS <15 KBTU/H OR < 3/4 HP
	N3	N/A - OA/EA FOR UNIT </= 300 CFM
		HUMIDIFICATION & DEHUMIDIFICATION
		C1 COMPLY - CONTROLS PROVIDED
		N1 N/A - NO HUMIDIFICATION AND/OR DEHUMIDIFICATION
SETBACK CONTROLS		ZONE ISOLATION
C1 SETBACK PROVIDED (DOWN TO 55°F)	C1	COMPLY - ISOLATION ZONES PROVIDED
N1 N/A - UNIT CONTINUOUSLY OPERATES	N1	N/A - UNIT CONTINUOUSLY OPERATES
N2 N/A - UNIT IS <15 KBTU/H OR < 3/4 HP	N2	N/A - UNIT IS <15 KBTU/H OR < 3/4 HP
N3 N/A - 99.6% WINTER DB > 40°F	N3	N/A - ALL ZONES ON SAME SCHEDULE
N4 N/A - RADIANT HEATING	N4	N/A - OA/EA FOR UNIT </= 5,000 CFM
N5 N/A - NO HEATING PROVIDED BY UNIT		
		DUCT/PLENUM INSULATION
		C1 COMPLYING INSULATION PROVIDED
		N1 N/A - ALL DUCTS LOCATED IN CONDITIONED SPACE

MISCELLANEOUS REQUIREMENTS - MANDATORY MEASURES

1. MECHANICAL EQUIPMENT NOT COVERED BY THE US NATIONAL APPLIANCE ENERGY CONSERVATION ACT (NAECA) OF 1987 SHALL BE PROVIDED A PERMANENT LABEL INSTALLED BY THE MANUFACTURER STATING THAT THE EQUIPMENT COMPLIES WITH THE REQUIREMENTS OF ASHRAE 90.1.

2. PACKAGED TERMINAL AIR CONDITIONERS AND HEAT PUMPS WITH SLEEVE SIZES LESS THAN 16 INCHES HIGH AND 42 INCHES WIDE SHALL BE PROVIDED WITH A FACTORY LABEL WHICH READS: "MANUFACTURED FOR REPLACEMENT APPLICATIONS ONLY; NOT TO BE INSTALLED IN NEW CONSTRUCTION PROJECTS."

3. A DEADBAND OF _____°F SHALL BE PROVIDED TO PREVENT THE HEATING SET POINT FROM EXCEEDING THE COOLING SET POINT.

4. THE LEAKAGE OF THE SPECIFIED DAMPERS SHALL BE LESS THAN THE 10 CFM / SQUARE FOOT FOR MOTORIZED DAMPERS AND 20 CFM / SQUARE FOOT FOR NONMOTORIZED DAMPERS AT 1.0 INCHES OF WATER GAUGE WHEN TESTED IN ACCORDANCE WITH AMCA STANDARD 500.

5. VENTILATION FANS WITH MOTORS GREATER THAN 3/4 HP SHALL HAVE CONTROLS WHICH AUTOMATICALLY SHUT OFF THE FANS WHEN NOT REQUIRED.
6. FREEZE PROTECTION SYSTEMS (SUCH AS HEAT TRACING) SHALL HAVE CONTROLS TO SHUT OFF THE SYSTEM WHEN THE OUTDOOR AIR TEMPERATURE IS ABOVE 40°F. SNOW/ICE MELTING SYSTEMS SHALL HAVE CONTROLS TO SHUT OFF THE SYSTEM WHEN THE PAVEMENT TEMPERATURE IS ABOVE 50°F.

7. CO₂ SENSORS, WHICH REDUCE THE OUTDOOR AIR INTAKE BELOW DESIGN RATES WHEN SPACES ARE PARTIALLY OCCUPIED, HAVE BEEN PROVIDED FOR SYSTEMS WITH DESIGN OUTDOOR AIR CAPACITIES GREATER THAN 3000 CFM SERVING AREAS HAVING AN AVERAGE DESIGN OCCUPANCY EXCEEDING 100 PEOPLE PER 1000 FT².

8. DUCTWORK USED FOR BOTH HEATING AND COOLING SHALL HAVE BE INSULATED WITH AN R-VALUE GREATER THAN OR EQUAL TO 3.5. RETURN AIR DUCTS ARE NOT TO BE INSULATED.
9. SUPPLY AND RETURN DUCTWORK AND PLENUMS LOCATED OUTDOORS AND SUPPLY DUCTWORK AND PLENUMS GREATER THAN 2 INCHES OF W.C. IN UNCONDITIONED SPACES SHALL BE A MINIMUM OF CLASS "A" SEALED. SUPPLY DUCTWORK AND PLENUMS LESS THAN 2 INCHES OF W.C. AND RETURN DUCTWORK IN UNCONDITIONED SPACES AND SUPPLY DUCTWORK AND PLENUMS GREATER THAN 2 INCHES OF W.C. AND EXHAUST DUCTWORK IN CONDITIONED SPACES SHALL BE A MINIMUM OF CLASS "B" SEALED. EXHAUST DUCTWORK AND PLENUMS LOCATED OUTDOORS AND IN UNCONDITIONED SPACE AND SUPPLY DUCTWORK AND PLENUMS LESS THAN 2 INCHES OF W.C. AND RETURN DUCTWORK IN CONDITIONED SPACE SHALL BE A MINIMUM OF CLASS "C" SEALED.

10. THIS CONTRACTOR IS REQUIRED TO PROVIDE RECORD DRAWINGS AND OWNER'S OPERATIONAL MANUALS. THIS CONTRACTOR IS ALSO RESPONSIBLE TO PARTICIPATE IN THE AIR AND WATER SYSTEM BALANCING AND ANY REQUIRED CONTROL SYSTEM COMMISSIONING.

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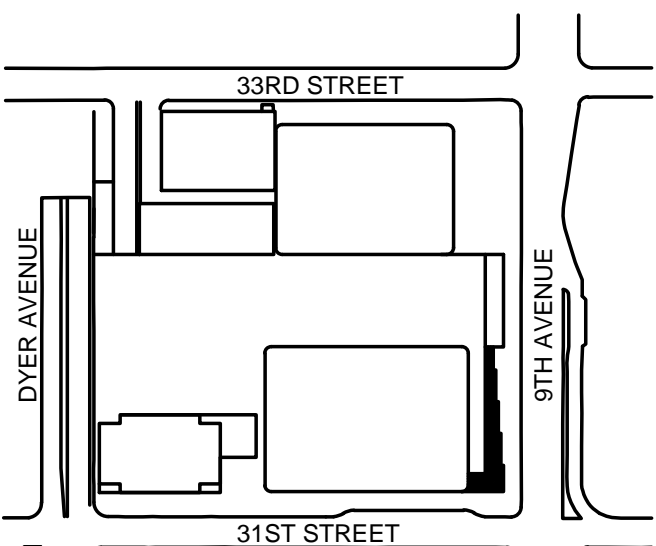
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Vertical Transportation

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Sustainable Design

Vindian Energy & Environmental
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Geo-Technical Engineering

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Landscape Consultant

Field Operations

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Security Consultant

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Blast Consultant

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Acoustical Consultant

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Vibration Consultant

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Code Consultant

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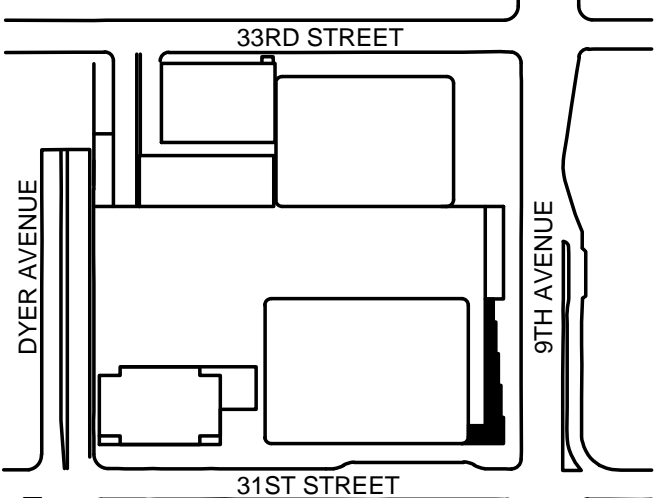
Facade Maintenance Consultant

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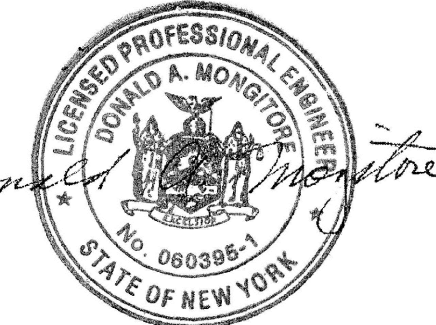
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Key Plan:



Seal & Signature:



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ENERGY
MODELING AND
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NEW YORK STATE ENERGY CODE COMPLIANCE
SECTION 6 - HEATING VENTILATING AND AIR CONDITIONING
PRESCRIPTIVE PATH

STANDARD: ASHRAE 90.1-2007 CLIMATE ZONE: 4A		
ITEM DESCRIPTION	PROPOSED DESIGN VALUE	CODE PRESCRIPTIVE VALUE AND CITATION
6.5.1: ECONOMIZERS	COOLING SYSTEM PROVIDED INCLUDES AN ECONOMIZER COMPLYING WITH SECTION 6.5.1 THROUGH 6.5.4)	EACH COOLING SYSTEM WITH A FAN SHALL INCLUDE AN AIR OR WATER ECONOMIZER MEETING THE REQUIREMENTS OF SECTIONS 6.5.1 THROUGH 6.5.4.
6.5.1.1: AIR ECONOMIZERS		
6.5.1.1.1: DESIGN CAPACITY	EQUIPMENT HAS BEEN SELECTED TO MEET THIS CAPACITY.	AIR ECONOMIZER SYSTEM SHALL BE CAPABLE OF MODULATING OUTDOOR AIR AND RETURN AIR DAMPERS TO PROVIDE UP TO 100% OF THE DESIGN SUPPLY AIR QUANTITY AS OUTDOOR AIR FOR COOLING.
6.5.1.1.2: CONTROL SIGNAL	THE CONTROL SEQUENCE OF THE EQUIPMENT HAS BEEN SPECIFIED TO MEET THIS REQUIREMENT.	ECONOMIZER SHALL BE CAPABLE OF BEING SEQUENCED WITH THE MECHANICAL COOLING EQUIPMENT AND SHALL NOT BE CONTROLLED BY MIXED AIR TEMPERATURE.
6.5.1.1.3: HIGH-LIMIT SHUTOFF	EQUIPMENT SPECIFIED MEETS THE REQUIREMENTS OF THESE TABLES.	HIGH LIMIT SHUT-OFF CONTROLS TYPE SPECIFIED SHALL BE LISTED IN TABLE 6.5.1.1.3A AND THE CONTROL'S SETTINGS SHALL COMPLY WITH TABLE 6.5.1.1.3B.
6.5.1.1.4: DAMPERS	THE DAMPERS HAVE BEEN SPECIFIED TO MEET THE MAXIMUM LEAKAGE REQUIREMENTS IN SECTION 6.4.3.3.4 AND TABLE 6.4.3.3.4.	BOTH RETURN AND OUTDOOR DAMPERS SHALL COMPLY WITH THE REQUIREMENTS OF SECTION 6.4.3.3.4.
6.5.1.1.5: RELIEF OF EXCESS OUTDOOR AIR	SYSTEM HAS BEEN PROVIDED WITH A MEANS TO RELIEVE THE EXCESS OUTDOOR AIR.	SYSTEMS SHALL PROVIDE A MEANS TO RELIEVE EXCESS OUTDOOR AIR DURING AIR ECONOMIZER OPERATION.
6.5.1.2: WATER ECONOMIZERS		
6.5.1.2.1: DESIGN CAPACITY	EQUIPMENT HAS BEEN SELECTED TO MEET THIS CAPACITY.	WATER ECONOMIZER SHALL BE CAPABLE OF PROVIDING UP TO 100% OF THE COOLING LOAD AT AN OUTDOOR AIR TEMPERATURE OF 50°F (DRY BULB) / 45°F (WET BULB).
6.5.1.2.2: MAXIMUM PRESSURE DROP	EQUIPMENT HAS BEEN SELECTED TO MEET THIS PRESSURE DROP.	PRECOOLING COILS AND HEAT EXCHANGERS USED AS PART OF THE WATER ECONOMIZER SYSTEM SHALL HAVE A PRESSURE DROP OF LESS THAN 15 FEET OF WATER OR A DEDICATED SECONDARY ECONOMIZER LOOP.
6.5.1.3: INTEGRATED ECONOMIZER CONTROL	THE CONTROL SEQUENCE OF THE EQUIPMENT HAS BEEN SPECIFIED TO MEET THIS REQUIREMENT.	ECONOMIZER SYSTEMS SHALL BE INTEGRATED WITH THE MECHANICAL COOLING SYSTEM AND BE CAPABLE OF PARTIAL COOLING.
6.5.1.4: ECONOMIZER SYSTEM HEATING IMPACT	THE EQUIPMENT AND CONTROL SEQUENCE OF THE EQUIPMENT HAS BEEN SPECIFIED TO MEET THIS REQUIREMENT.	ECONOMIZER SYSTEM DESIGN AND CONTROLS SHALL NOT INCREASE THE BUILDING HEATING ENERGY USE DURING NORMAL OPERATION.
6.5.2: SIMULTANEOUS HEATING AND COOLING LIMITATION		
6.5.2.1: ZONE CONTROLS	THE CONTROL SEQUENCE OF THE EQUIPMENT HAS BEEN SPECIFIED TO MEET THIS REQUIREMENT.	ZONE THERMOSTATIC CONTROLS SHALL BE PREVENT REHEATING, RECOOLING, MIXING OR SIMULTANEOUS SUPPLYING AIR THAT HAS BEEN PREVIOUSLY MECHANICALLY HEATED AND PREVIOUSLY MECHANICALLY COOLED.
6.5.2.2: HYDRONIC SYSTEM CONTROLS		
6.5.2.2.1: THREE-PIPE SYSTEM	A THREE PIPE SYSTEM IS NOT USED.	HYDRONIC SYSTEMS THAT USE A COMMON RETURN SYSTEM FOR BOTH HOT WATER AND CHILLED WATER SHALL NOT BE USED.
6.5.2.2.2: TWO-PIPE CHANGEOVER SYSTEM	THE EQUIPMENT AND CONTROL SEQUENCE OF THE EQUIPMENT HAS BEEN SPECIFIED TO MEET THIS REQUIREMENT.	SYSTEMS THAT USE A COMMON PIPING DISTRIBUTION SYSTEM SHALL COMPLY WITH THE FOLLOWING: A) THE DEADBAND BETWEEN CHANGEOVER FROM ONE MODE TO ANOTHER OF AT LEAST 15°F OUTDOOR AIR B) SYSTEM SHALL OPERATE IN ONE MODE FOR AT LEAST FOUR HOURS BEFORE CHANGING MODES C) RESET CONTROLS ARE PROVIDED THAT ALLOW HEATING AND COOLING SUPPLY TEMPERATURES AT THE CHANGEOVER POINT TO BE NO MORE THAN 30°F APART
6.5.2.2.3: HYDRONIC HEAT PUMP SYSTEM	THE EQUIPMENT AND CONTROL SEQUENCE OF THE EQUIPMENT HAS BEEN SPECIFIED TO MEET THIS REQUIREMENT.	HEAT PUMP SYSTEM SHALL HAVE CONTROLS CAPABLE OF PROVIDING A TEMPERATURE DEADBAND OF AT LEAST 20°F AND AN AUTOMATIC VALVE SHALL BE INSTALLED IN THE LOOP TO BYPASS ALL BUT THE MINIMAL FLOW AROUND THE COOLING TOWER.
6.5.2.3: DEHUMIDIFICATION	THE CONTROL SEQUENCE OF THE EQUIPMENT HAS BEEN SPECIFIED TO MEET THIS REQUIREMENT.	WHEN HUMIDIFICATION CONTROLS ARE PROVIDED, SUCH CONTROLS SHALL PREVENT REHEATING, MIXING OF HOT AND COLD AIR STREAMS, OR OTHER MEANS OF SIMULTANEOUS HEATING AND COOLING THE AIRSTREAM.
6.5.2.4: HUMIDIFICATION	A WATER ECONOMIZER SYSTEM HAS BEEN DESIGNED.	SYSTEMS WITH HYDRONIC COOLING AND HUMIDIFICATION SYSTEMS DESIGNED TO MAINTAIN INSIDE HUMIDITY AT GREATER THAN 35°F DEW POINT SHALL USE A WATER ECONOMIZER IF AN ECONOMIZER IS REQUIRED BY SECTION 6.5.1.
6.5.3: AIR SYSTEM DESIGN AND CONTROL		
6.5.3.1: FAN POWER LIMITATION	SEE TABLE 4	THE RATIO OF THE FAN SYSTEM POWER TO THE SUPPLY AIR FLOW RATE OF EACH HVAC SYSTEM AT DESIGN CONDITIONS SHALL NOT EXCEED THE ALLOWABLE FAN SYSTEM POWER SHOWN IN TABLE 6.5.3.1
6.5.3.2: VAV FAN CONTROL		
6.5.3.2.1: PART LOAD FAN POWER LIMITATION	EQUIPMENT HAS BEEN SELECTED TO MEET THIS REQUIREMENT.	INDIVIDUAL VAV FANS WITH MOTORS GREATER THAN 15 HP AND LARGER SHALL 1) BE DRIVEN BY MECHANICAL OR ELECTRICAL VARIABLE SPEED DRIVE OR 2) BE A VANE AXIAL FAN WITH VARIABLE PITCH BLADES OR 3) HAVE OTHER CONTROLS AND DEVICES THAT WILL RESULT IN MOTOR DEMAND OF NO MORE THAN 30% OF THE DESIGN WATTAGE AT 50% OF THE DESIGN AIR VOLUME WHEN THE STATIC PRESSURE SET POINT EQUALS ONE-THIRD OF THE TOTAL DESIGN STATIC PRESSURE.
6.5.3.2.2: STATIC PRESSURE SENSOR LOCATION	THE CONTROL EQUIPMENT HAS BEEN PLACED SUCH THAT THE SET POINT IS NO GREATER THAN 1/3 OF THE TOTAL DESIGN STATIC PRESSURE.	STATIC PRESSURE SENSOR LOCATIONS SHALL BE SUCH THAT THE CONTROLLER SET POINT IS NO GREATER THAN ONE-THIRD OF THE TOTAL DESIGN STATIC PRESSURE.
6.5.3.2.3: SETPOINT RESET	THE CONTROL EQUIPMENT HAS BEEN PLACED SUCH THAT THE STATIC PRESSURE SET POINT RESETS BASED ON THE ZONE REQUIRING THE MOST PRESSURE.	FOR SYSTEMS WITH DIRECT DIGITAL CONTROL OF INDIVIDUAL ZONE BOXES REPORTING TO THE CENTRAL CONTROL PANEL, STATIC PRESSURE SET POINT SHALL BE RESET BASED ON THE ZONE REQUIRING THE MOST PRESSURE.
6.5.4: HYDRONIC SYSTEM DESIGN AND CONTROL		
6.5.4.1: HYDRONIC VARIABLE FLOW SYSTEMS	EQUIPMENT HAS BEEN SELECTED TO MEET THIS REQUIREMENT.	HVAC PUMPING SYSTEMS SHALL HAVE MODULATING CONTROL VALVES. ALSO, PUMPS SERVING VARIABLE FLOW SYSTEMS EXCEEDING 100 FT OF HEAD AND MOTOR EXCEEDING 50 HP SHALL HAVE CONTROLS THAT WILL RESULT IN PUMP MOTOR DEMAND OF NO MORE THAN 30% OF THE DESIGN WATTAGE AT 50% OF THE DESIGN WATER.
6.5.4.2: PUMP ISOLATION	EQUIPMENT HAS BEEN SELECTED TO MEET THIS REQUIREMENT.	WHEN A CHILLER OR BOILER PLANT INCLUDES MORE THAN ONE PIECE OF EQUIPMENT, PROVISIONS SHALL BE MADE TO SHUT EACH DOWN INDIVIDUALLY.
6.5.4.3: CHILLED & HOT WATER TEMP RESET CONTROLS	THE EQUIPMENT AND CONTROL SEQUENCE OF THE EQUIPMENT HAS BEEN SPECIFIED TO MEET THIS REQUIREMENT.	CHILLED AND HOT WATER SYSTEMS WITH A DESIGN CAPACITY GREATER THAN 300,000 BTU/HR SUPPLYING CHILLED AND/OR HOT WATER TO COMFORT CONDITIONING SYSTEMS SHALL INCLUDE CONTROLS THAT AUTOMATICALLY RESET SUPPLY TEMPERATURE.
6.5.4.4: HYDRONIC HEAT PUMP SYSTEMS	EQUIPMENT HAS BEEN SELECTED TO MEET THIS REQUIREMENT.	EACH HYDRONIC HEAT PUMP SHALL HAVE A TWO-POSITION AUTOMATIC VALVE INTERLOCKED TO SHUT-OFF THE WATER WHEN THE COMPRESSOR IS OFF.

PROFESSIONAL'S STATEMENT

TO THE BEST OF OUR KNOWLEDGE, BELIEF AND PROFESSIONAL JUDGEMENT, THESE PLANS AND SPECIFICATIONS ARE IN COMPLIANCE WITH THE NEW YORK CITY ENERGY CONSERVATION CODE.

BUILDING DEPARTMENT NOTE:

THIS PLAN IS APPROVED ONLY FOR WORK INDICATED ON THE APPLICATION SPECIFICATION SHEET. ALL OTHER MATTERS SHOWN ARE NOT TO BE RELIED UPON, OR TO BE CONSIDERED AS EITHER BEING APPROVED OR IN ACCORDANCE WITH APPLICABLE CODES.

TABLE 4 - FAN POWER LIMITATION WORKSHEET										
TAG	SUPPLY FAN		RETURN FAN		EXHAUST FAN		SERIES FPB		TOTAL SYSTEM MOTOR (HP)	
	SUPPLY CFM	MOTOR (HP)	TAG	MOTOR (HP)	TAG	MOTOR (HP)	TAG	MOTOR (HP)		
F-3-1	58,000	40	-	-	-	-	-	-	40	
F-5-2&3	15,000	10	-	-	-	-	-	-	10	
	-	-	-	-	TX-4-1	7-1/2	-	-	7-1/2	
	-	-	-	-	TX-4-2	10	-	-	10	
	-	-	-	-	TX-4-3	10	-	-	10	
	-	-	-	-	TX-4-4	3	-	-	3	
	-	-	-	-	TX-4-5	2	-	-	2	
	-	-	-	-	TX-69-1	10	-	-	10	
	-	-	-	-	TX-69-2	10	-	-	10	
	-	-	-	-	TX-69-3	7-1/2	-	-	7-1/2	
	-	-	-	-	EF-4-1&2	20	-	-	20	
	-	-	-	-	EF-4-3	5	-	-	5	
	-	-	-	-	EF-4-4	10	-	-	10	
	-	-	-	-	EF-4-5	10	-	-	10	
	-	-	-	-	EF-5-1	20	-	-	20	
	-	-	-	-	EF-68-1&2	15	-	-	15	
	-	-	-	-	EF-A	1/2	-	-	1/2	
	-	-	-	-	EF-B	1/2	-	-	1/2	
	-	-	-	-	SX-4-1	40	-	-	40	
	-	-	-	-	SX-4-2	5	-	-	5	
	-	-	-	-	SX-69-1	25	-	-	25	
	-	-	-	-	SX-69-2	15	-	-	15	
	-	-	RSF-4-1&2	20	RSF-4-1&2	-	-	-	20	
	-	-	RSF-5-1	30	RSF-5-1	-	-	-	30	
AC-B-1 & AC-B-2	8,000	7-1/2							7-1/2	
AC-B-3	12,000	15							15	
AC-B-4	800	3/4							3/4	
AC-B-5	800	3/4							3/4	
AC-B-6	800	3/4							3/4	
AC-B-7	800	3/4							3/4	
AC-B-8	800	3/4							3/4	
AC-6-1 THRU AC-67-1	25,000	40							40	
AC-B1-1	3,000	3							3	
AC-B2-1	3,000	3							3	
AC-B3-1	3,000	3							3	
AC-1-1	1,500	1-1/2							1-1/2	
AC-2-1	1,500	1-1/2							1-1/2	
AC-4-1	3,000	3							3	
AC-20-1B & 2B	2,000	1-1/2							1-1/2	
AC-30-1B	5,000	5							5	
AC-40-1B & 2B	5,000	5							5	
AC-52-1B	10,000	10							10	
AC-62-1B	10,000	10							10	
AC-70-1B	10,000	10							10	
AC-71-1B	7,500	7-1/2							7-1/2	
AHU-4-1	15,000	25							25	
AHU-4-2	55,000	100							100	
HV-4-1&2	75,000	125							125	
HV-4-3	62,500	75							75	
HV-5-1	15,000	20							20	
HV-5-2	11,000	15							15	
HV-68-1&2	37,500	60							60	
HV-68-3	18,000	20							20	
HV-68-4&5	32,000	50							50	

TOTAL SUPPLY CFM

507,500

TOTAL SYSTEM MOTOR HP

620.25

TABLE 6.5.3.1 VALUE 0.00122 HP/CFM

NEW YORK CITY ENERGY CODE COMPLIANCE
SECTION 6 - HEATING VENTILATING AND AIR CONDITIONING
PRESCRIPTIVE PATH

STANDARD: ASHRAE 90.1-2007 CLIMATE ZONE: 4A		
ITEM DESCRIPTION	PROPOSED DESIGN VALUE	CODE PRESCRIPTIVE VALUE AND CITATION
6.5.5: HEAT REJECTION EQUIPMENT		
6.5.5.1: GENERAL		
6.5.5.2: FAN SPEED CONTROL	THE EQUIPMENT AND CONTROL SEQUENCE OF THE EQUIPMENT HAS BEEN SPECIFIED TO MEET THIS REQUIREMENT.	EACH FAN POWERED BY A MOTOR OF 7.5 HP OR LARGER SHALL HAVE THE CAPACITY TO OPERATE THE FAN AT TWO-THIRDS OF FULL SPEED OR LESS AND SHALL HAVE CONTROLS THAT AUTOMATICALLY CHANGED THE FAN SPEED TO CONTROL THE LEAVING FLUID TEMPERATURE OR CONDENSER TEMPERATURE/PRESSURE OF THE HEAT REJECTION DEVICE.
6.5.6: ENERGY RECOVERY		
6.5.6.1: EXHAUST AIR ENERGY RECOVERY	EQUIPMENT HAS BEEN SELECTED TO MEET THIS REQUIREMENT.	FAN SYSTEMS THAT HAVE BOTH A DESIGN CAPACITY OF 5000 CFM OR GREATER AND A MINIMUM OUTDOOR AIR SUPPLY OF 70% OR GREATER OF THE SUPPLY AIR SHALL HAVE AN ENERGY RECOVERY SYSTEM WITH AT LEAST AN EFFECTIVENESS OF 50%.
6.5.6.2: HEAT RECOVERY FOR SERVICE HW HEATING		
6.5.6.2.1: GENERAL	SYSTEM DESIGN COMPLIES WITH THESE REQUIREMENTS AND A HEAT RECOVERY SYSTEM IS REQUIRED.	HEAT RECOVERY SYSTEM SHALL BE INSTALLED IN SYSTEMS THAT OPERATE 24 HOURS / DAY, THE TOTAL INSTALLED HEAT REJECTION CAPACITY OF THE WATER-COOLED SYSTEM EXCEEDS 6,000,000 BTU/HR, AND THE DESIGN SERVICE WATER HEATING LOAD EXCEEDS 1,000,000 BTU/HR.
6.5.6.2.2: DESIGN CAPACITY	THE HEAT RECOVERY SYSTEM PROVIDED COMPLIES WITH THIS REQUIREMENT.	THE HEAT RECOVERY SYSTEM SHALL HAVE THE CAPACITY TO PROVIDE THE SMALLER OF THE TWO 1) 80% OF THE PEAK HEAT REJECTION AT DESIGN CONDITIONS OR 2) PREHEAT OF THE PEAK SERVICE HOT WATER DRAW TO 85°F.
6.5.7: EXHAUST HOODS		
6.5.7.1: KITCHEN HOODS	THE KITCHEN EXHAUST MAKEUP AIR COMPLIES WITH THESE REQUIREMENTS.	KITCHEN HOODS LARGER THAN 5000 CFM SHALL PROVIDE 50% OF ITS MAKEUP AIR WITH UNHEATED OR HEATED AIR NO MORE THAN 60F AND UNCOOLED AIR.
6.5.7.2: FUME HOODS	THE FUME HOOD MAKEUP AIR IS GREATER THAN 15,000 CFM AND INCLUDES VARIABLE AIR VOLUME HOOD EXHAUST AND ROOM SUPPLY SYSTEMS CAPABLE OF REDUCING EXHAUST AND MAKE UP VOLUME TO 50% OR LESS OF DESIGN VALUES OR DIRECT MAKEUP AIR SUPPLY EQUAL TO AT LEAST 75% OF THE EXHAUST RATE OR HEAT RECOVERY SYSTEMS TO PRECONDITIONED MAKEUP AIR FROM FUME HOOD EXHAUST IN ACCORDANCE WITH SECTION 6.5.6.1.	FUME HOODS SYSTEMS HAVING AN EXHAUST RATE GREATER THAN 15,000 CFM SHALL INCLUDE AT LEAST ONE OF THE FOLLOWING: 1) VARIABLE AIR VOLUME HOOD EXHAUST AND ROOM SUPPLY SYSTEMS CAPABLE OF REDUCING EXHAUST AND MAKE UP VOLUME TO 50% OR LESS OF DESIGN VALUES 2) DIRECT MAKEUP AIR SUPPLY EQUAL TO AT LEAST 75% OF THE EXHAUST RATE. 3) HEAT RECOVERY SYSTEMS TO PRECONDITIONED MAKEUP AIR FROM FUME HOOD EXHAUST IN ACCORDANCE WITH SECTION 6.5.6.1.
6.5.8: RADIANT HEATING SYSTEMS		
6.5.8.1: HEATING UNENCLOSED SPACES	RADIANT HEATING IS USED IN UNENCLOSED SPACES.	RADIANT HEATING SHALL BE USED WHEN HEATING REQUIRED FOR UNENCLOSED SPACES.
6.5.8.2: HEATING ENCLOSED SPACES	RADIANT HEATING CONFORMING WITH THE REQUIREMENTS IS USED IN ENCLOSED SPACES.	RADIANT HEATING SYSTEMS SHALL CONFORM TO THE FOLLOWING: 1) RADIANT HEATING CEILING FLOOR PANELS 2) COMBINATION OR HYBRID SYSTEMS INCORPORATING RADIANT HEATING PANELS 3) RADIANT HEATING PANELS USED IN CONJUNCTION WITH OTHER SYSTEMS.
6.5.9: HOT GAS BYPASS LIMITATION	EQUIPMENT HAS BEEN SELECTED TO MEET THIS CAPACITY.	COOLING SYSTEMS SHALL NOT USE HOT GAS BYPASS OR OTHER EVAPORATIVE PRESSURE CONTROL UNLESS THE SYSTEM IS DESIGNED WITH MULTIPLE STEPS OF UNLOADING OR CONTINUOUS CAPACITY MODULATION. THE CAPACITY OF THE HOT GAS BYPASS SHALL BE LIMITED AS INDICATED IN TABLE 6.5.9

NEW YORK CITY ENERGY CODE COMPLIANCE
SECTION 7 - SERVICE WATER HEATING
PRESCRIPTIVE PATH

STANDARD: ASHRAE 90.1-2007 CLIMATE ZONE: 4A		
ITEM DESCRIPTION	PROPOSED DESIGN VALUE	CODE PRESCRIPTIVE VALUE AND CITATION
7.5.1: SPACE HEATING & WATER HEATING	NOT INCLUDED IN THIS APPLICATION.	THE USE OF A INTEGRATED COMFORT HEATING AND SERVICE HOT WATER HEATER SHALL BE ALLOWED IF COMPIES WITH ALL OF SECTION 6 AND THE ENERGY INPUT FOR THE COMBINED SYSTEM IS LESS THAN 150,000 BTU/H OR IT IS DEMONSTRATED THAT THE USE OF A SINGLE HEAT SOURCE WILL CONSUME LESS ENERGY THAN SEPERATE UNITS.
7.5.2: SERVICE WATER HEATING EQUIPMENT	NOT INCLUDED IN THIS APPLICATION.	SERVICE WATER HEATING EQUIPMENT USED TO PROVIDE THE ADDITIONAL FUNCTION OF SPACE HEATING AS PART OF A INTEGRATED SYSTEM SHALL SATISFY ALL STATED REQUIREMENTS FOR THE SERVICE WATER HEATING EQUIPMENT.

MISCELLANEOUS REQUIREMENTS - PRESCRIPTIVE MEASURES

- THE AIR SIDE ECONOMIZER SYSTEM SHALL MODULATE THE OUTDOOR AIR AND RETURN AIR DAMPERS TO PROVIDE UP TO 100% OF THE DESIGN SUPPLY AIR QUANTITY AS OUTDOOR AIR FOR COOLING.
- THE AIR SIDE ECONOMIZER SHALL BE CAPABLE OF BEING SEQUENCED WITH THE MECHANICAL COOLING EQUIPMENT AND SHALL BE NOT CONTROLLED BY MIXED AIR TEMPERATURE.
- THE AIR SIDE ECONOMISER SHALL HAVE BOTH RETURN AND OUTDOOR DAMPERS WHICH HAVE A LEAKAGE OF LESS THAN THE 10 CFM / SQUARE FOOT FOR MOTORIZED DAMPERS AND 20 CFM / SQUARE FOOT FOR NONMOTORIZED DAMPERS AT 1.0 INCHES OF WATER GAUGE WHEN TESTED IN ACCORDANCE WITH AMCA STANDARD 500.
- THE WATER SIDE ECONOMISER SYSTEM SHALL BE CAPABLE OF PROVIDING UP TO 100% OF THE COOLING LOAD AT AN OUTDOOR AIR TEMPERATURE OF 50°F (DRY BULB) / 45°F (WET BULB)
- PRECOOLING COILS AND HEAT EXCHANGERS USED AS PART OF THE WATER SIDE ECONOMIZER SYSTEM SHALL HAVE A PRESSURE DROP OF LESS THAN 15 FEET OF WATER.
- THE WATER SIDE ECONOMIZER SYSTEMS SHALL BE INTEGRATED WITH THE MECHANICAL COOLING SYSTEM AND SHALL BE CAPABLE OF PARTIAL COOLING AND SHALL NOT INCREASE THE BUILDING HEATING ENERGY USE DURING NORMAL OPERATION.
- ZONE THERMOSTATIC CONTROLS SHALL PREVENT REHEATING, RECOOLING, MIXING OR SIMULTANEOUS SUPPLYING AIR THAT HAS BEEN PREVIOUSLY MECHANICALLY HEATED AND PREVIOUSLY MECHANICALLY COOLED.
- A THREE PIPE OR TWO-PIPE CHANGEOVER HYDRONIC SYSTEM SHALL NOT USED.
- THE HEAT PUMP SYSTEM SHALL HAVE CONTROLS CAPABLE OF PROVIDING A TEMPERATURE DEADBAND OF AT LEAST 20°F AND AN AUTOMATIC VALVE INSTALLED WITHIN THE LOOP TO BYPASS ALL BUT THE MINIMAL FLOW AROUND THE COOLING TOWER.
- EACH HYDRONIC HEAT PUMP SHALL HAVE A TWO-POSITION AUTOMATIC VALVE INTERLOCKED TO SHUT-OFF THE WATER WHEN THE COMPRESSOR IS OFF.
- HUMIDIFICATION CONTROLS THAT PREVENT REHEATING, MIXING OF HOT AND COLD AIR STREAMS, AND OTHER MEANS OF SIMULTANEOUS HEATING AND COOLING THE AIRSTREAM SHALL BE PROVIDED.
- INDIVIDUAL VAV FANS WITH MOTORS GREATER THAN 15 HP AND LARGER 1) SHALL BE DRIVEN BY A MECHANICAL OR ELECTRICAL VARIABLE SPEED DRIVE OR 2) SHALL HAVE A VANE AXIAL FAN WITH VARIABLE PITCH BLADES OR 3) SHALL HAVE OTHER CONTROLS AND DEVICES THAT WILL RESULT IN MOTOR DEMAND OF NO MORE THAN 30% OF THE DESIGN WATTAGE AT 50% OF THE DESIGN AIR VOLUME WHEN THE STATIC PRESSURE SET POINT EQUALS ONE-THIRD OF THE TOTAL DESIGN STATIC PRESSURE.
- STATIC PRESSURE SENSOR LOCATIONS SHALL BE PLACED SUCH THAT THE SETPOINT IS LESS THAN ONE-THIRD OF THE TOTAL DESIGN STATIC PRESSURE. INDIVIDUAL ZONES HAVE THEIR SETPOINT RESET BASED ON THE ZONE REQUIRING THE MOST PRESSURE.
- THE CHILLED WATER SYSTEM (IDENTIFY THE SYSTEM) AND HOT WATER SYSTEM (IDENTIFY THE SYSTEM) SHALL BE PROVIDED WITH CONTROLS THAT AUTOMATICALLY RESET SUPPLY TEMPERATURE WITH THE OUTDOOR AIR TEMPERATURE.

PROFESSIONAL'S STATEMENT

TO THE BEST OF OUR KNOWLEDGE, BELIEF AND PROFESSIONAL JUDGEMENT, THESE PLANS AND SPECIFICATIONS ARE IN COMPLIANCE WITH THE NEW YORK CITY ENERGY CONSERVATION CODE.

BUILDING DEPARTMENT NOTE:

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SHEET NOTES

MANHATTAN WEST:
NORTH TOWER

375 Ninth Avenue, New York, NY 10001

Client

C:\Users\B\Documents\apps\Buildinglog_4087128

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Civil Engineering

Philip Habib & Associates
102 Madison Avenue #11, New York, NY 10016

MEP Engineering

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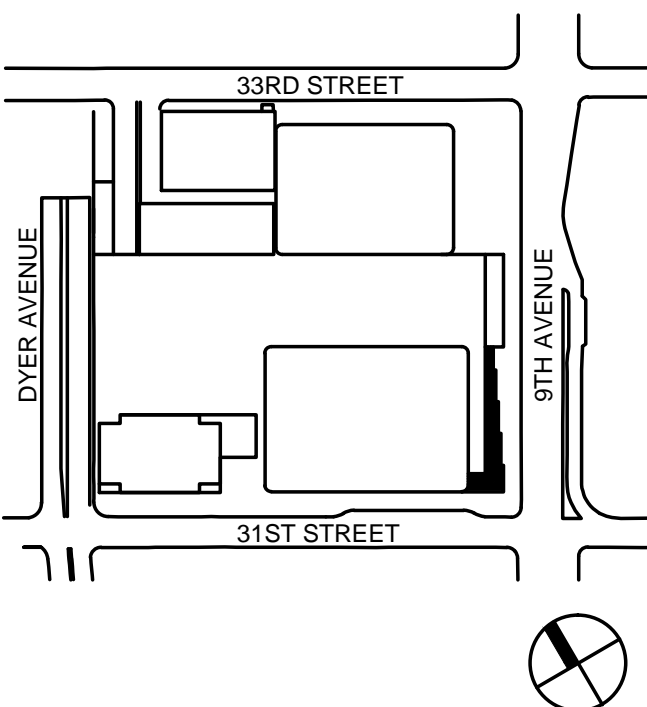
Facade Maintenance Consultant

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Project No.

14830.A.000

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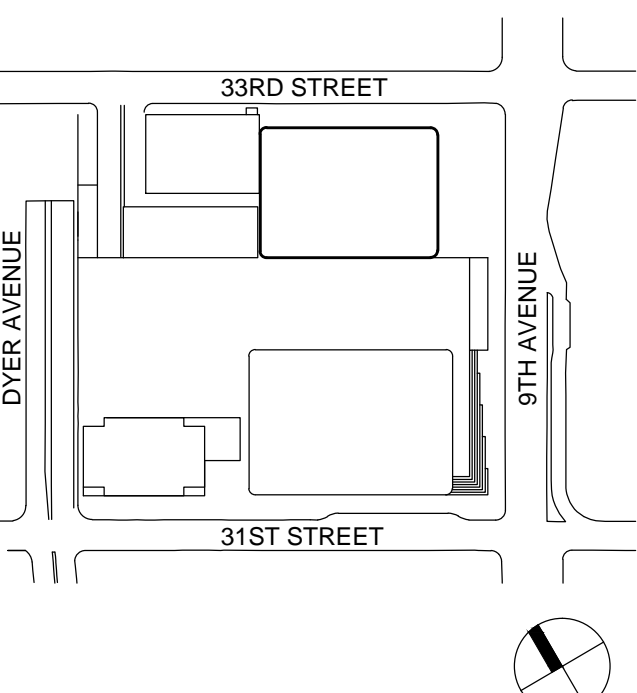
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NYC EC
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CELLAR B1
FLOOR PLAN -
PART A

Project No.: B-SCAN Sheet No.:

14830-A-000

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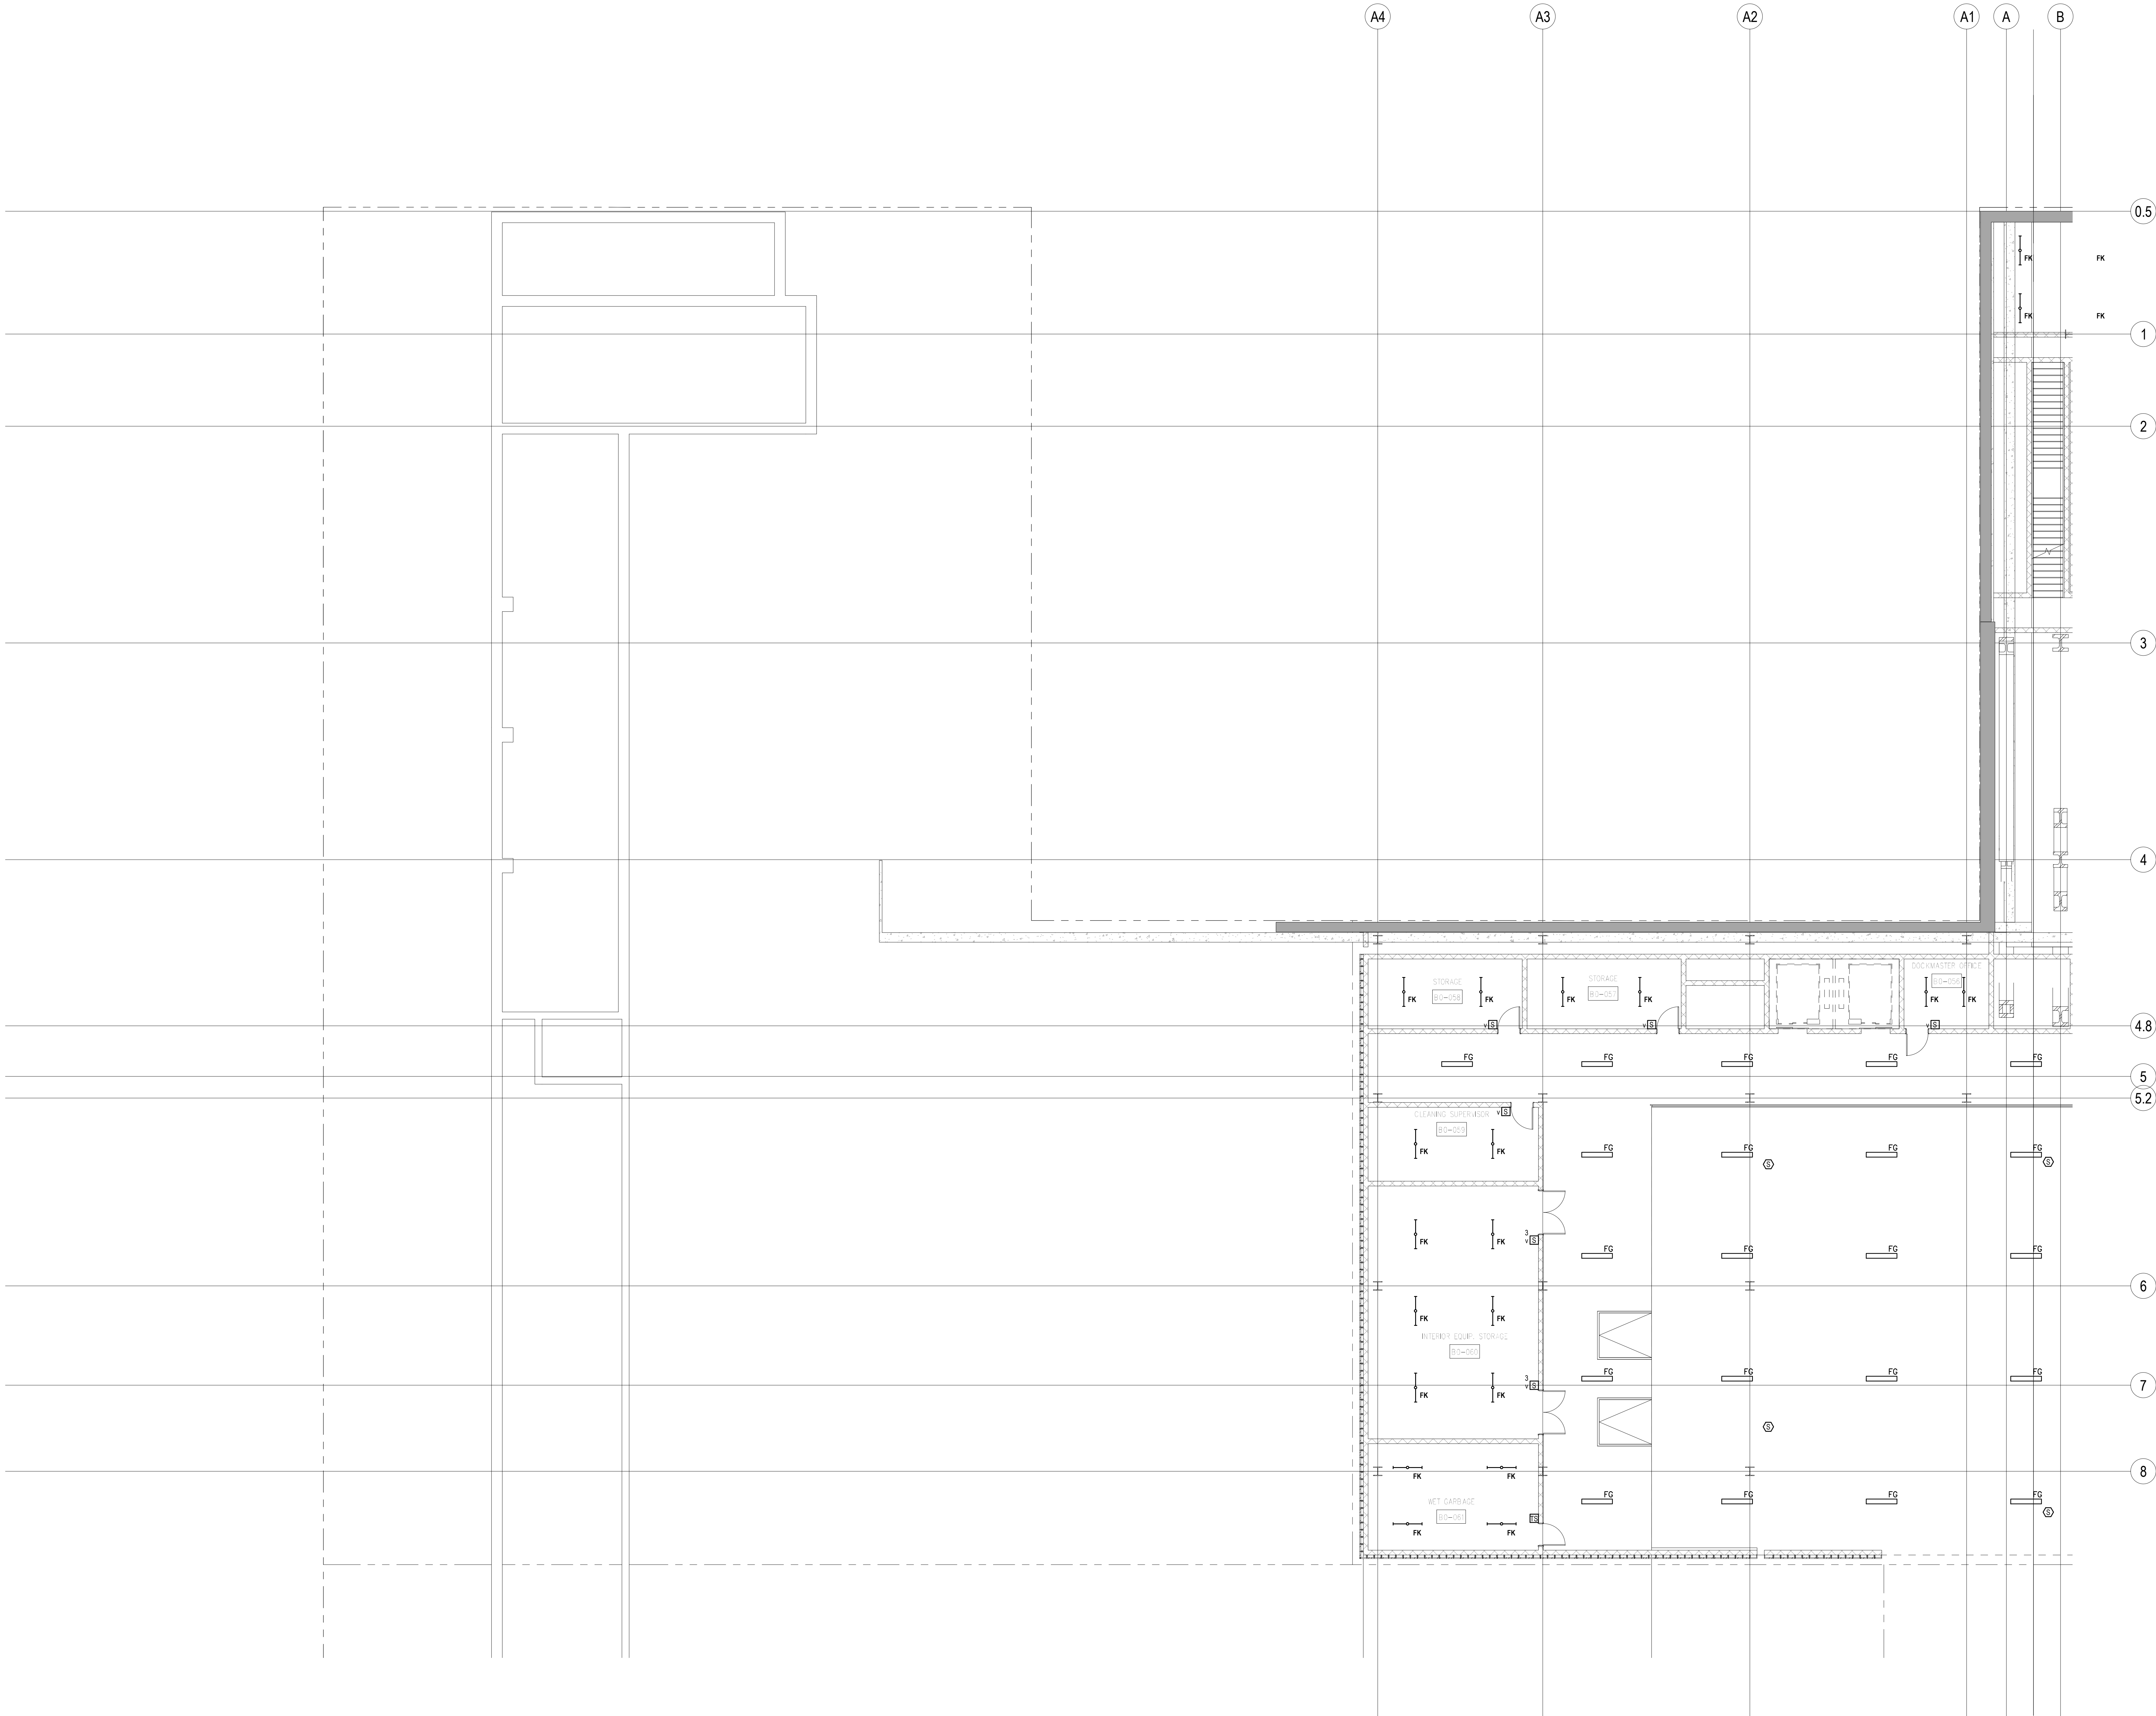
NYC EC
COMPLIANCE
LIGHTING
CELLAR B
FLOOR PLAN -
PART A

Project No.: 14830 A.000
Date: 20 JUN 2014
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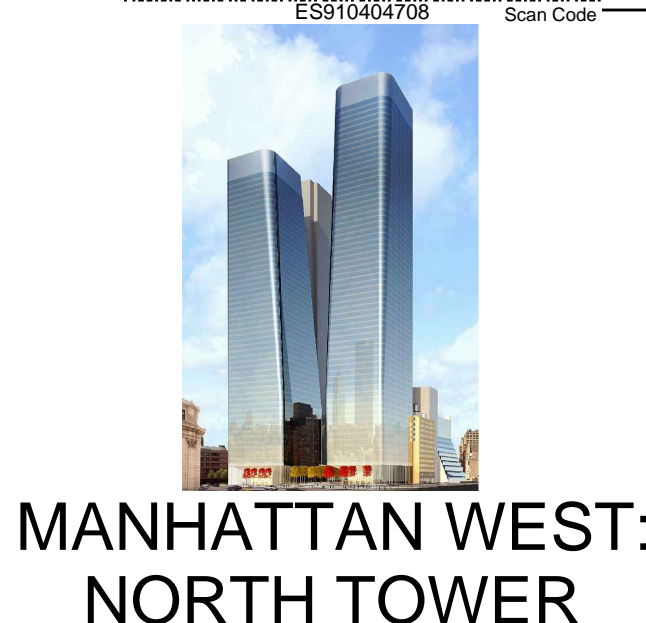
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**NYC EC
COMPLIANCE
LIGHTING
CELLAR B
FLOOR PLAN -
PART B**

Project No.: 14830.A.000	B-SCAN Sheet No.:
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NYC EC COMPLIANCE LIGHTING LEVEL 1 FLOOR PLAN

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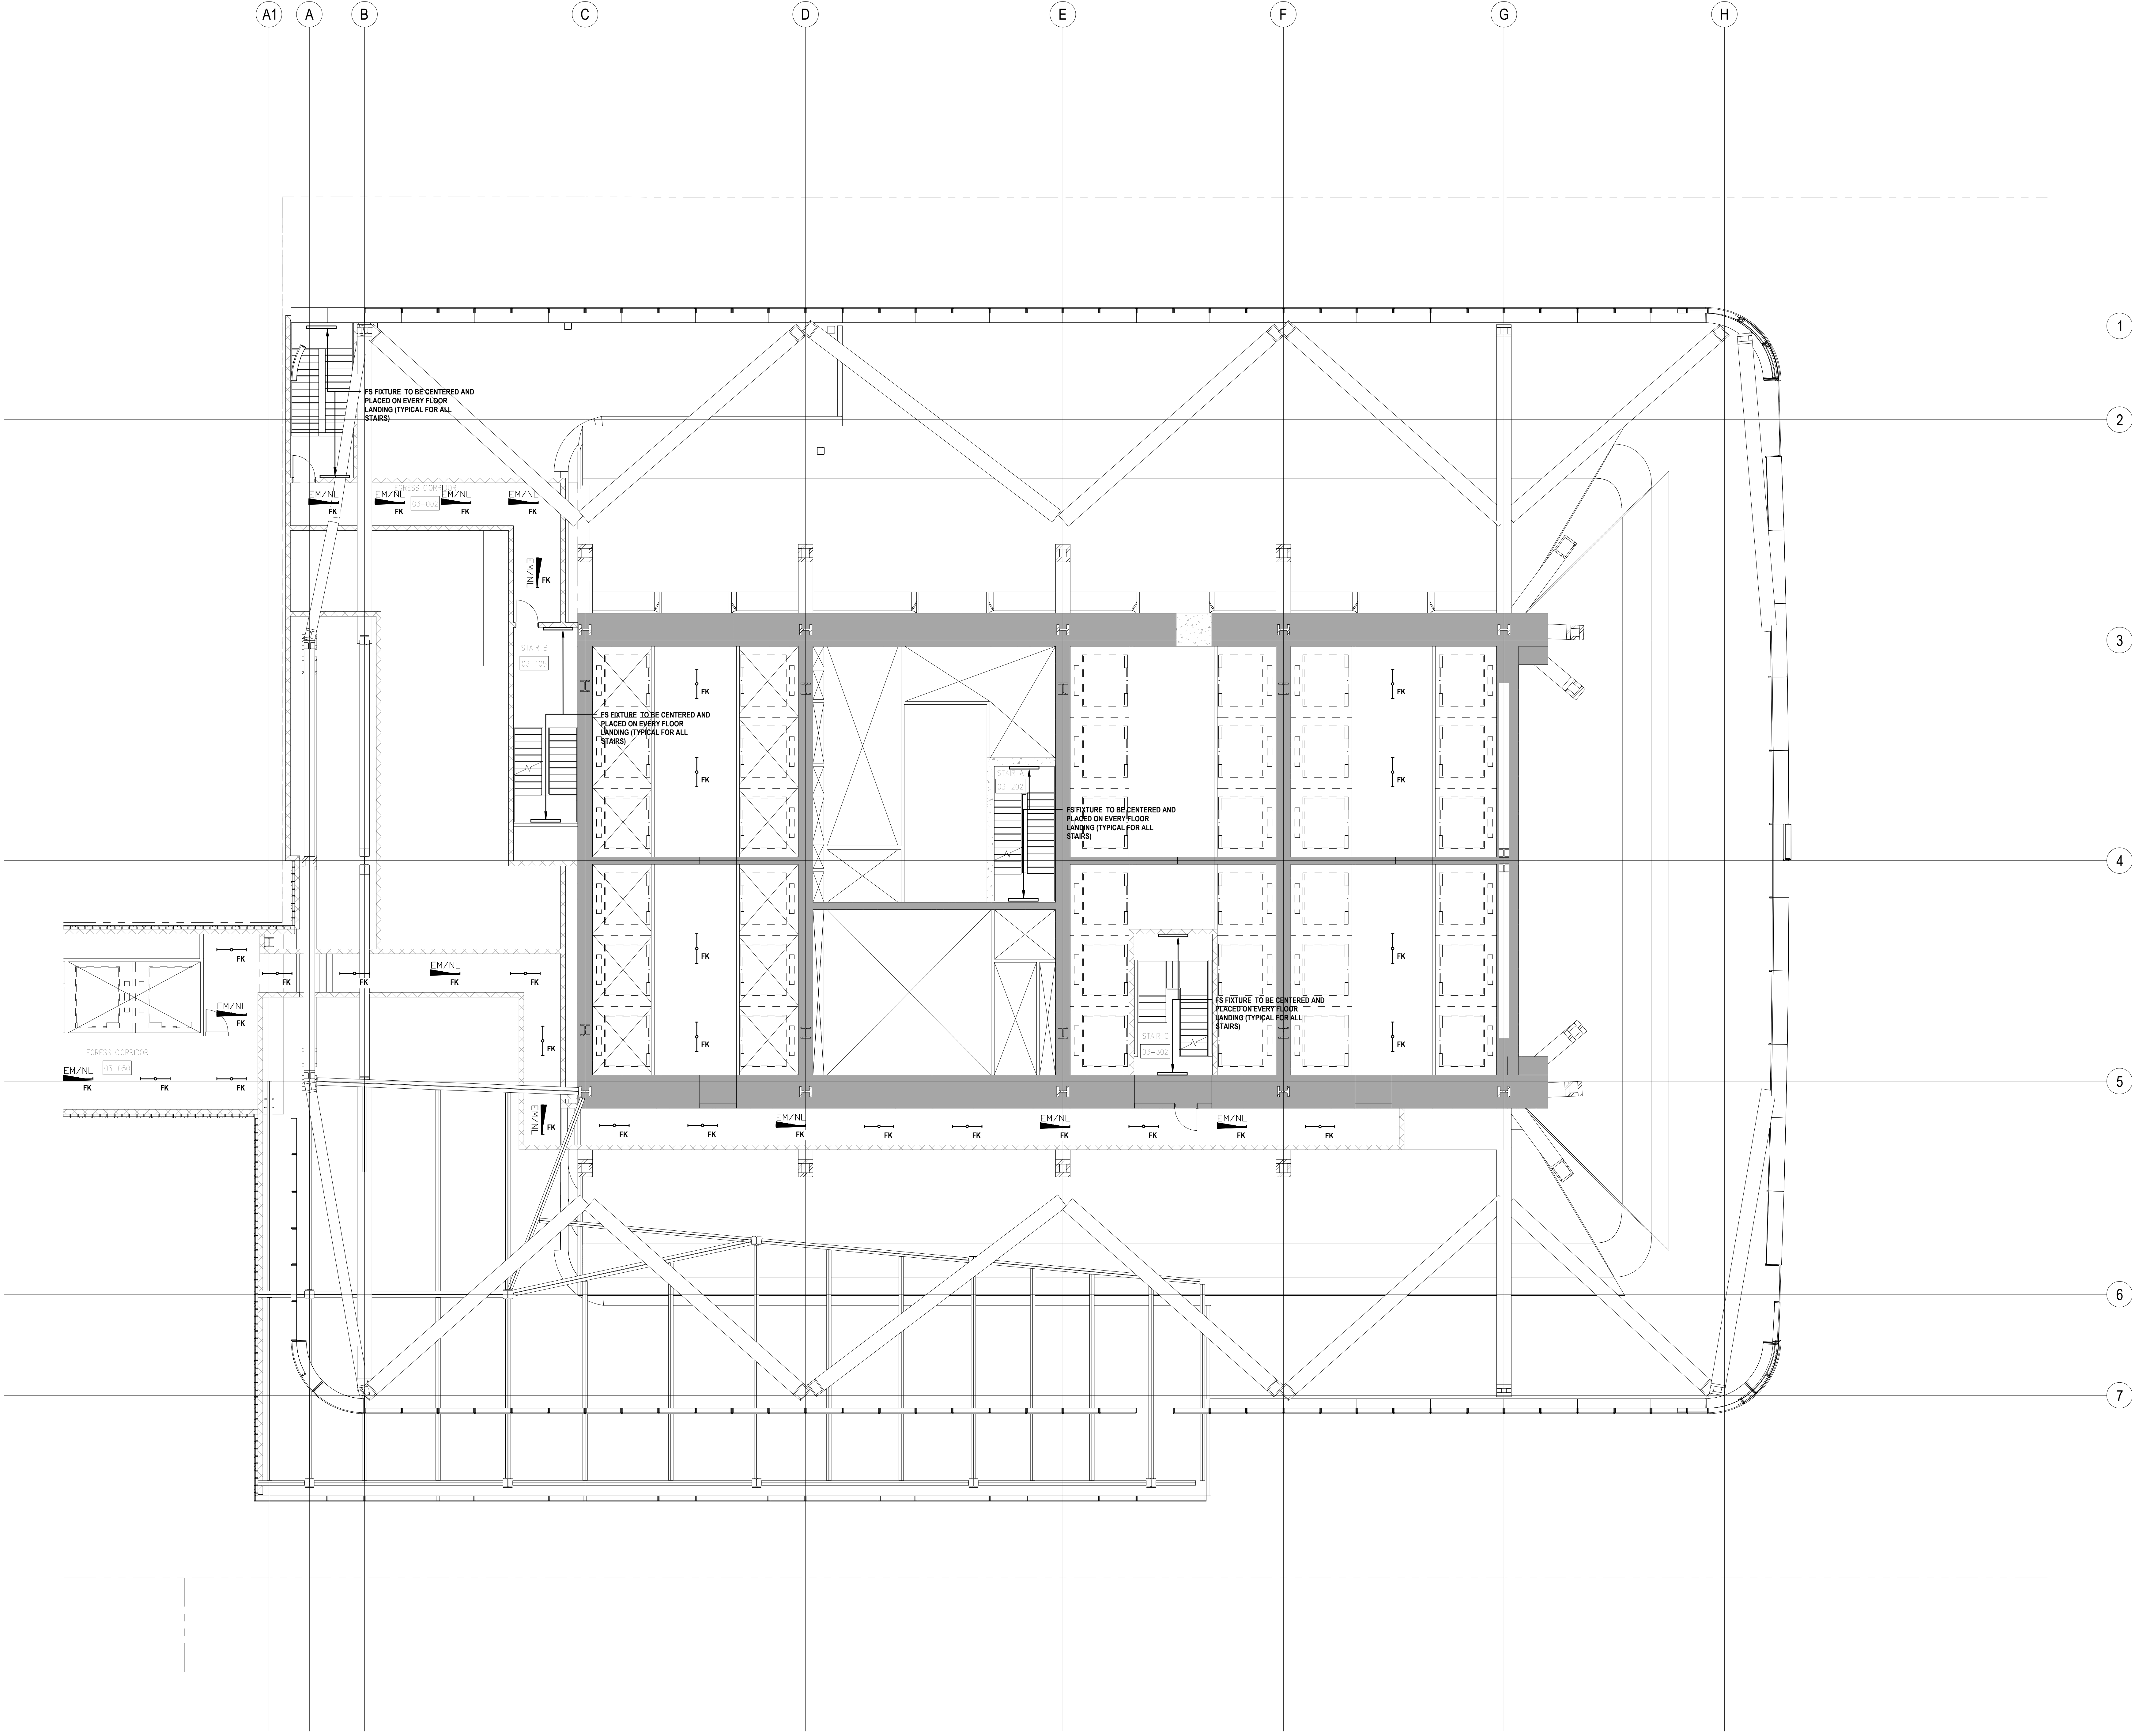
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
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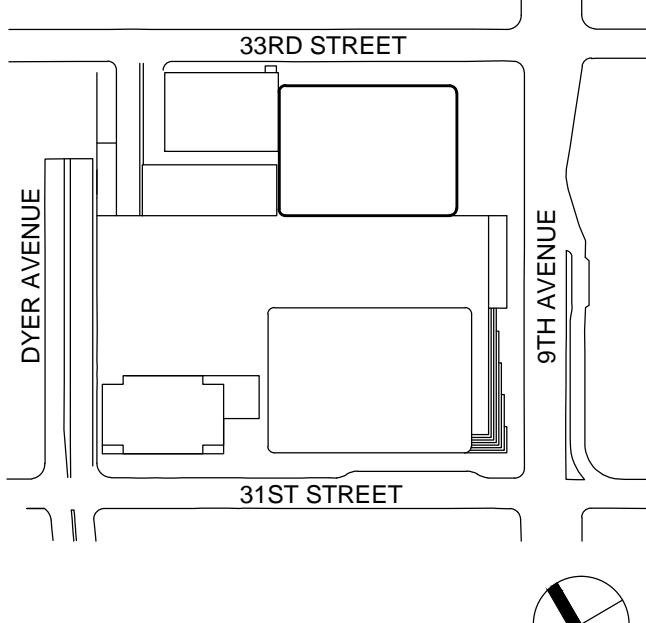
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
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**NYC EC
COMPLIANCE
LIGHTING
LEVEL 3
FLOOR PLAN**

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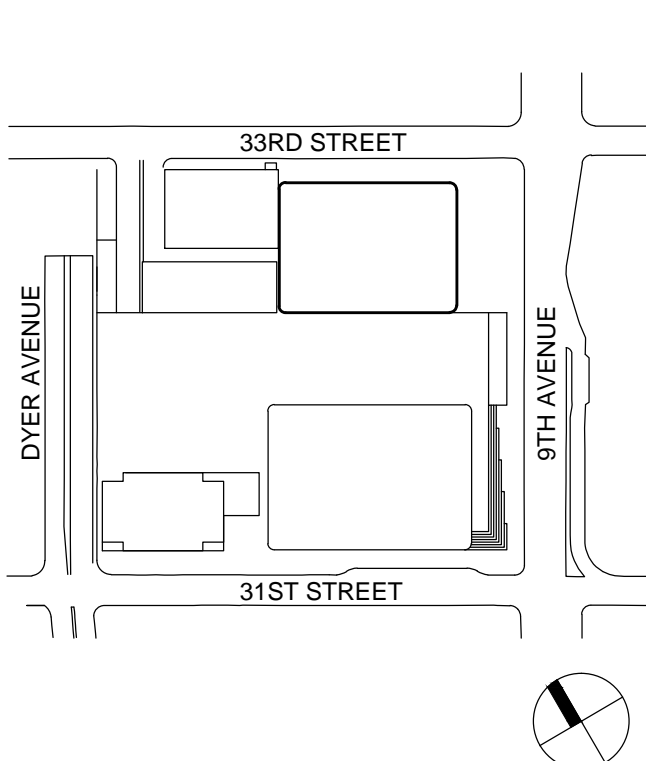
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**NYC EC
COMPLIANCE
LIGHTING
LEVEL 4
FLOOR PLAN**


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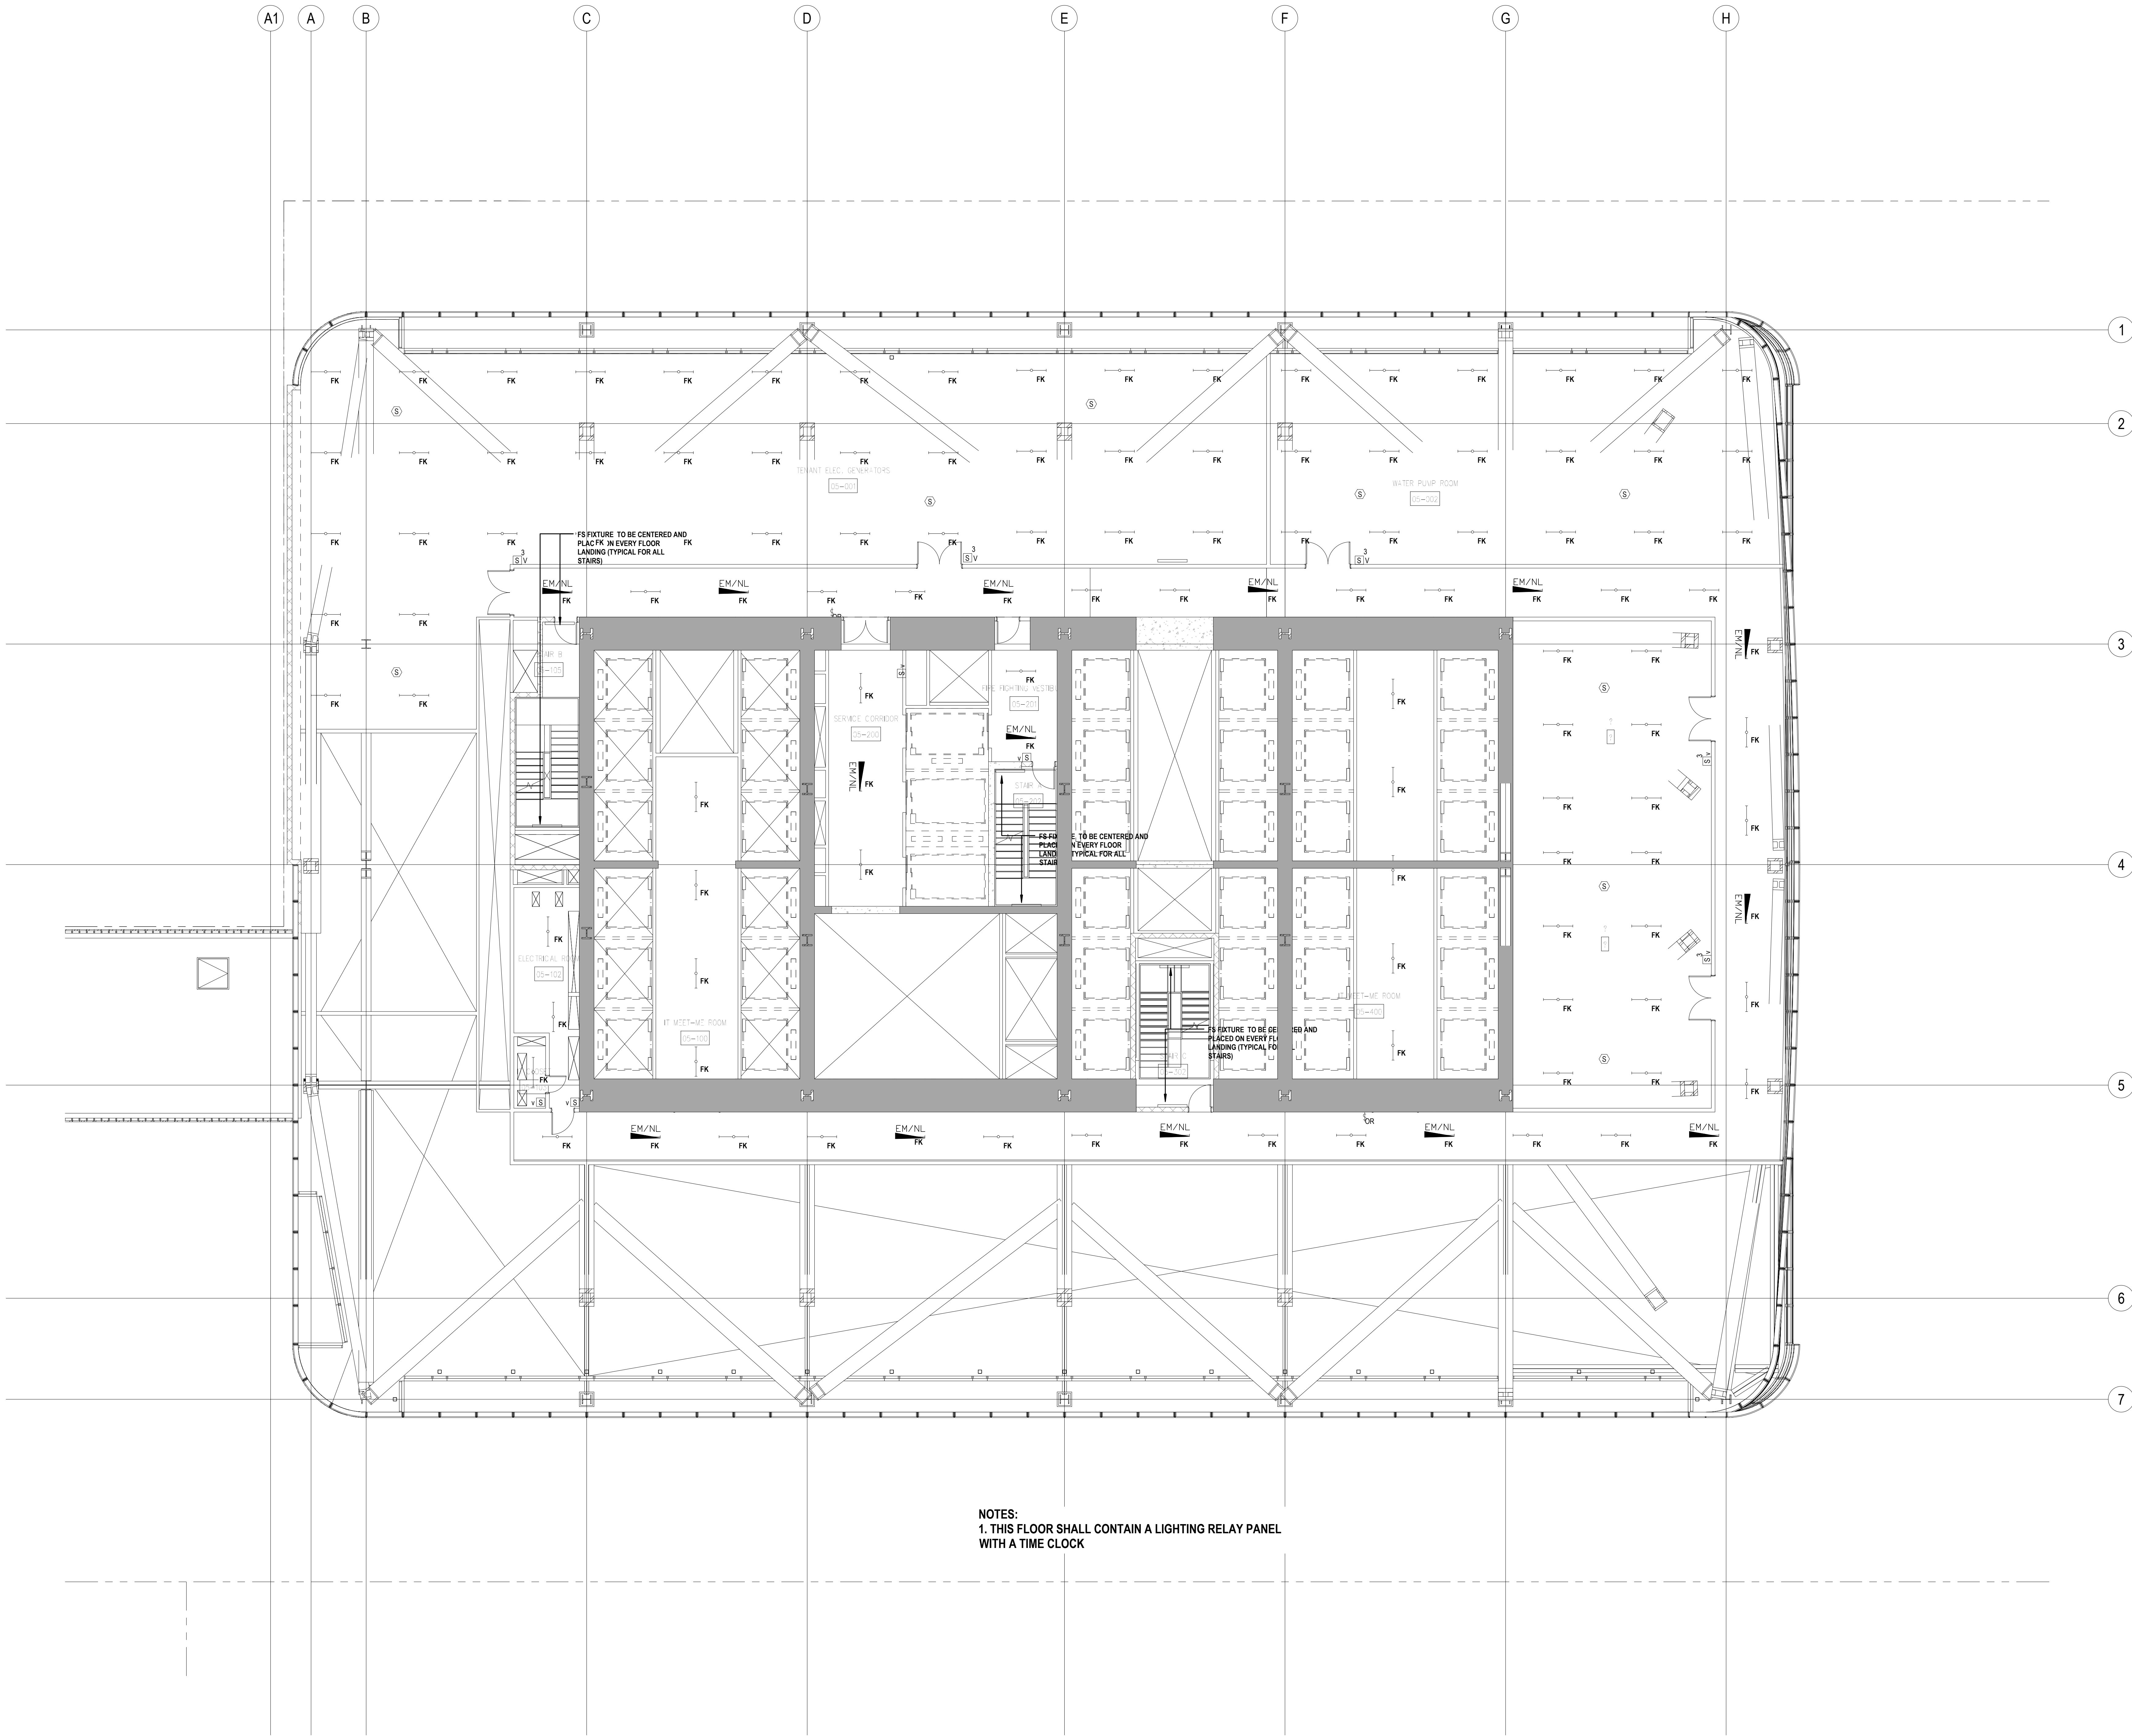
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


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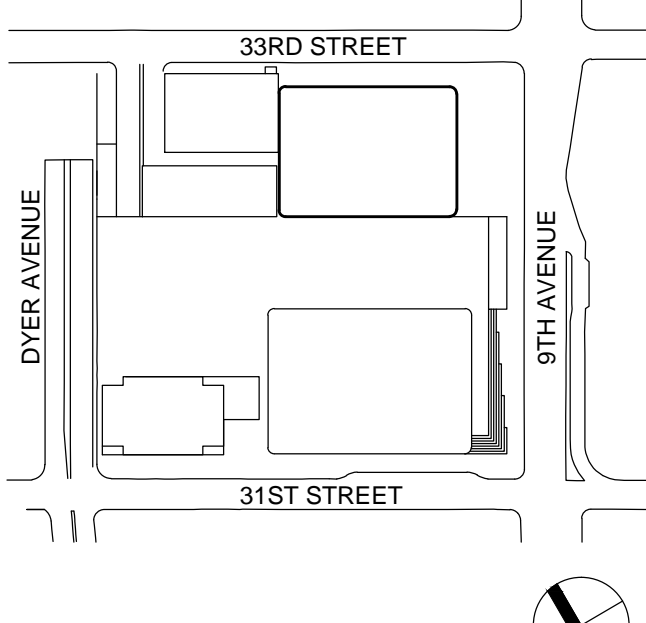
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
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**NYC EC
COMPLIANCE
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LEVEL 5
FLOOR PLAN**

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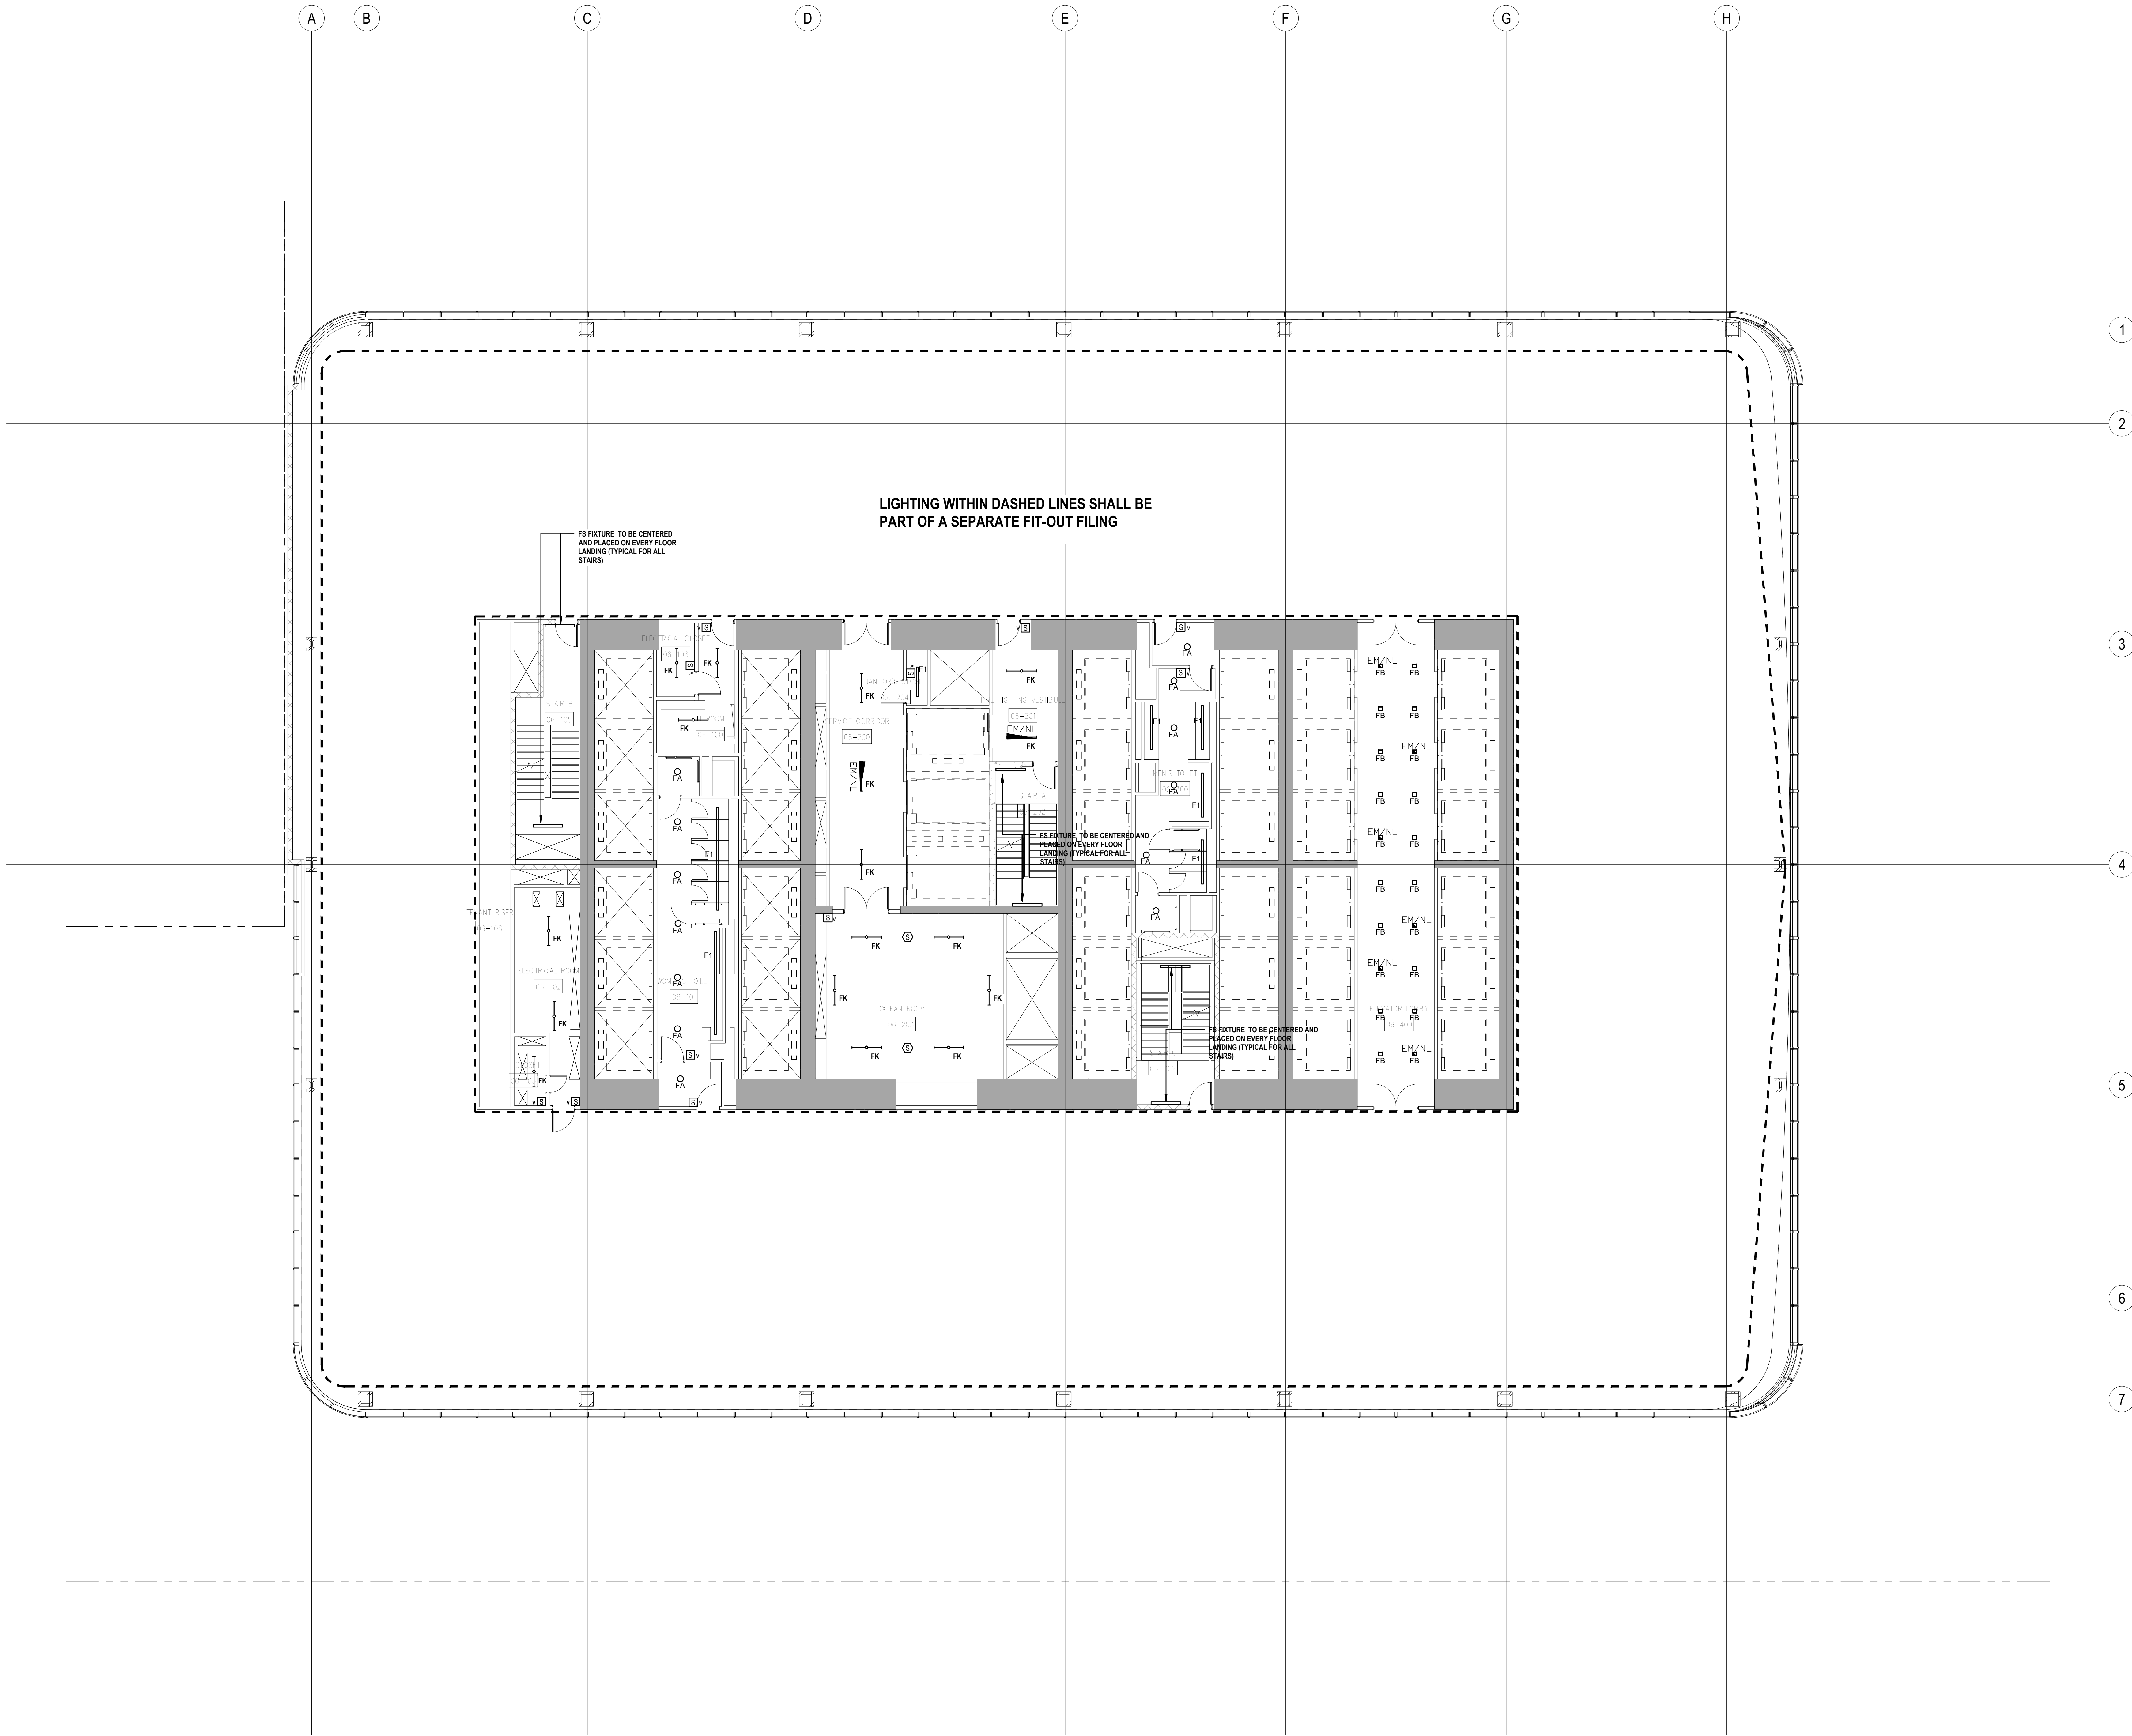
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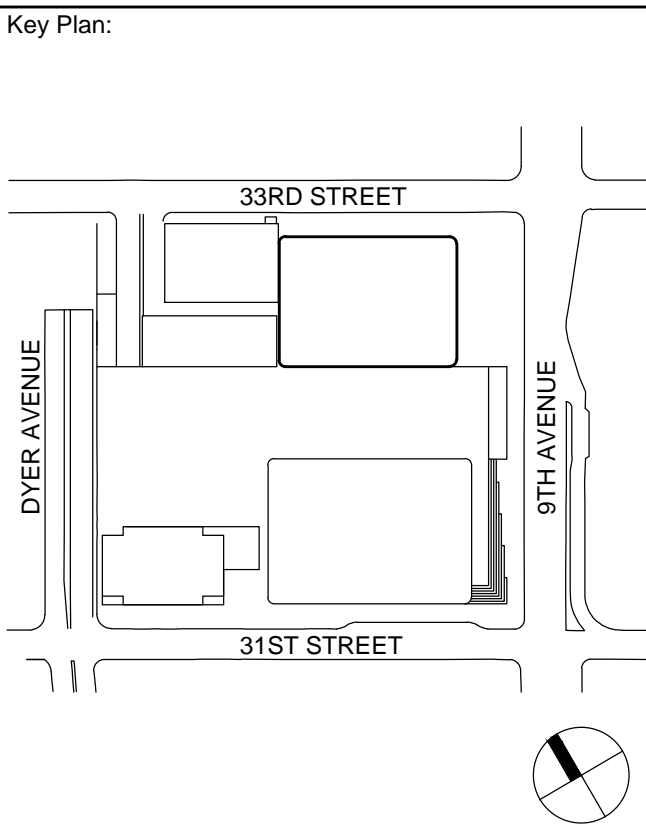
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No.	Date	Description
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NYC EC
COMPLIANCE
LIGHTING
LEVEL 6-16
FLOOR PLAN

Project No.: 14830.A.000
Date: 20 JUN 2014
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SHEET NOTES

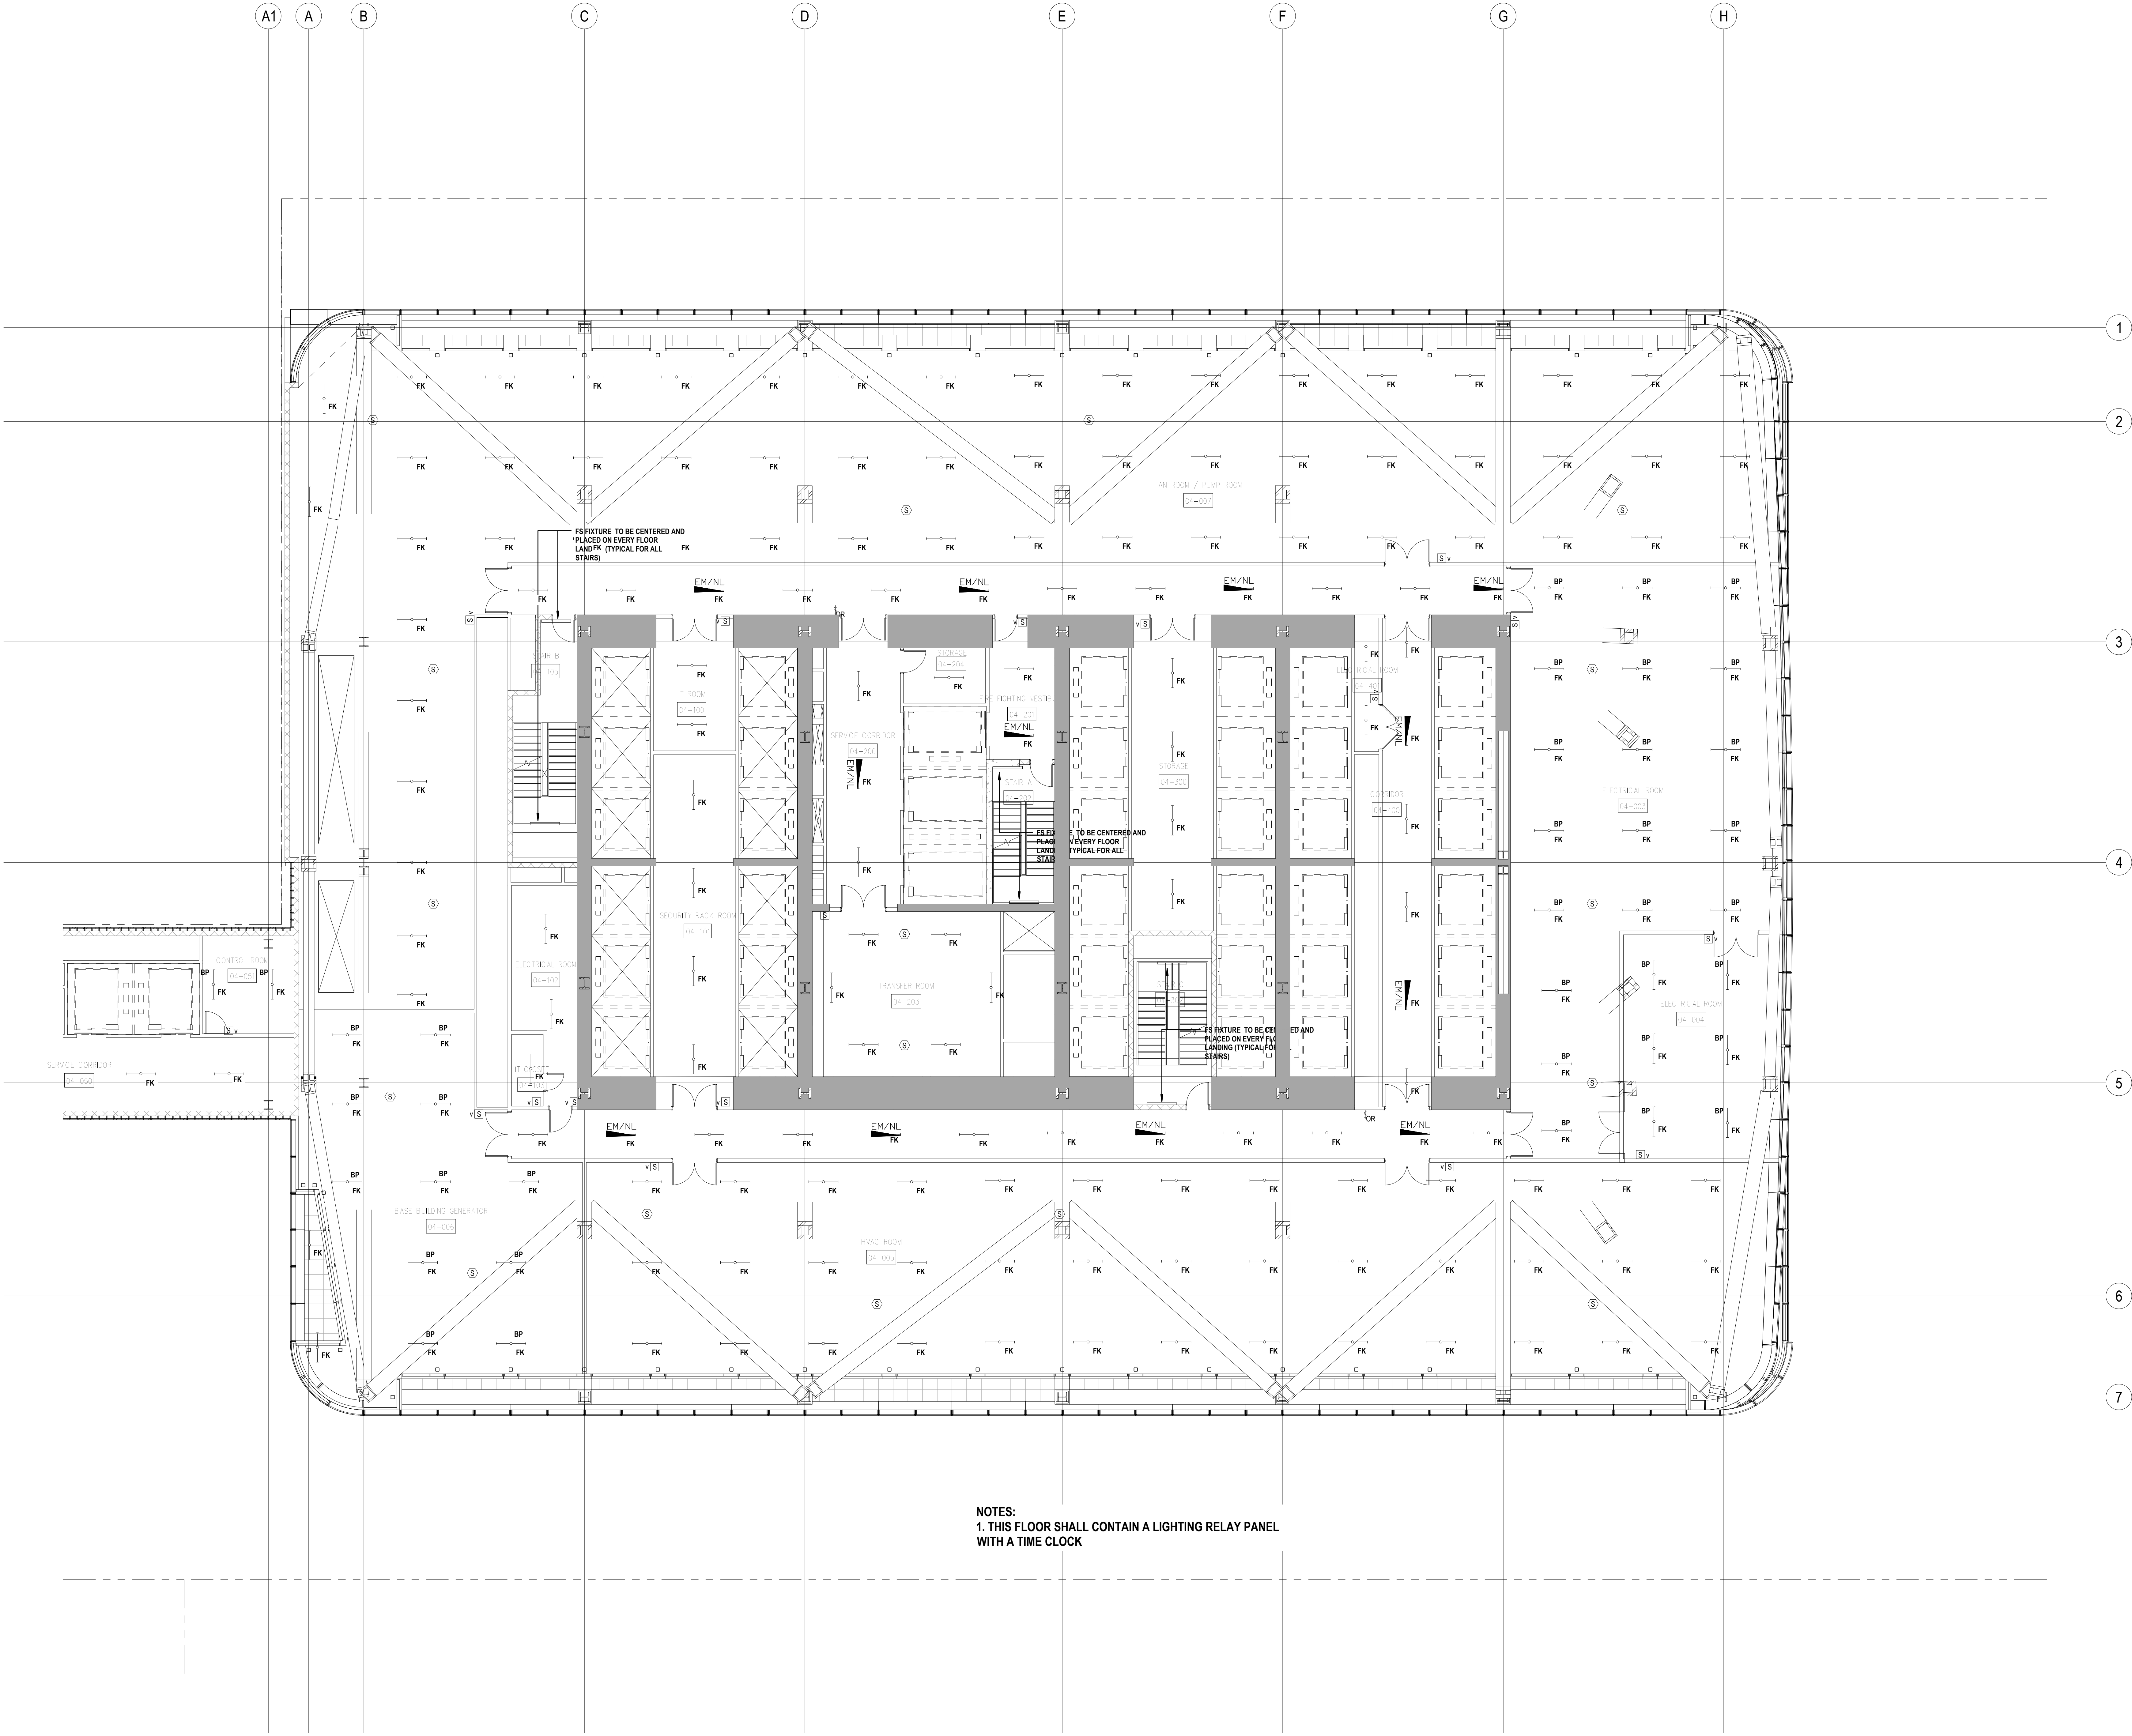

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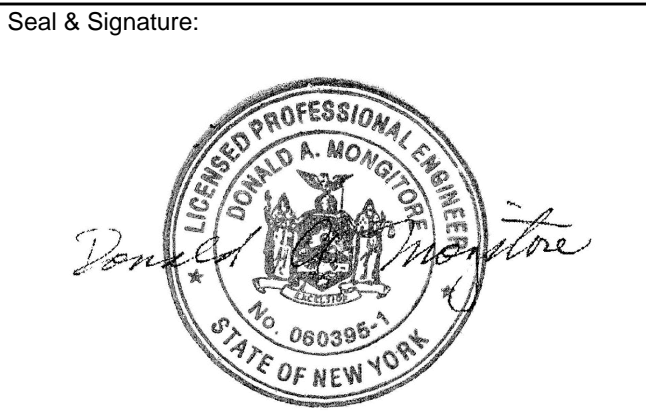
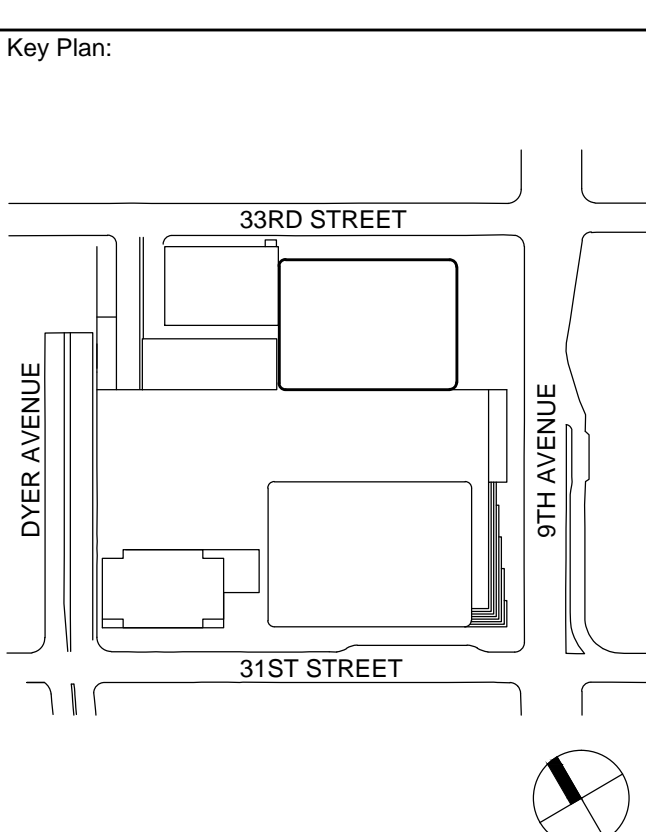
Acoustical Consultant
Cerami & Associates
404 Elm Avenue #5, New York, NY 10018

Vibration Consultant
Wilson, Uhrig & Associates, Inc.
65 Broadway, Suite 401, New York, NY 10006

Code Consultant
Code Consultants Professional Engineers PC
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Facade Maintenance Consultant
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166 Ames Street, Hackensack, NJ 07601

Wind Tunnel Consultant
Rowan Williams Davies & Irwin Inc.
650 Woodbine Road West, Guelph, Ontario, Canada N1K 1B8



No.	Date	Description
1	12 SEPT 2014	ISSUED FOR FOUNDATION PERMIT

NYC EC
COMPLIANCE
LIGHTING
LEVEL 17
FLOOR PLAN

Project No.: 14830-A-000	B-SCAN Sheet No.: EN-108.00
Date: 20 JUN 2014	
Scale: N.T.S.	
File No.:	Page No.:

PROFESSIONAL ENERGY STATEMENT
TO THE BEST OF MY KNOWLEDGE, BELIEF, AND PROFESSIONAL JUDGEMENT, THESE PLANS AND SPECIFICATIONS ARE IN COMPLIANCE WITH THE NEW YORK CITY ENERGY CONSERVATION CODE.



Client
Brookfield

Brookfield Place
250 Vesey Street, 15th Floor, New York, NY 10281

Architecture/Structural Engineering

SOM
Skidmore, Owings & Merrill LLP
14 Wall Street, New York, NY 10005

Civil Engineering
Philip Habib & Associates
102 Madison Avenue #11, New York, NY 10016

MEP Engineering
Jaros Baum & Bolles
80 Pine Street, New York, NY 10005

Vertical Transportation
Edgett Williams Consulting Group, Inc.
102 East Blithedale Ave. Suite 1, Mill Valley, California 94941

Sustainable Design
Viridian Energy & Environmental
50 Washington Street, Norwalk, CT 06854

Geo-Technical Engineering
Mueser Rutledge Consulting Engineers
14 Penn Plaza, 225 W. 34th Street #610, New York, NY 10122

Landscape Consultant
Field Operations
475 10th Avenue, New York, NY 10018

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Ducibella, Vantor & Santore
250 State Street #F1, North Haven, CT 06473

Blast Consultant
Weidinger Associates, Inc.
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Cerami & Associates
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MANHATTAN WEST:
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Client

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404 Elm Avenue #5, New York, NY 10018

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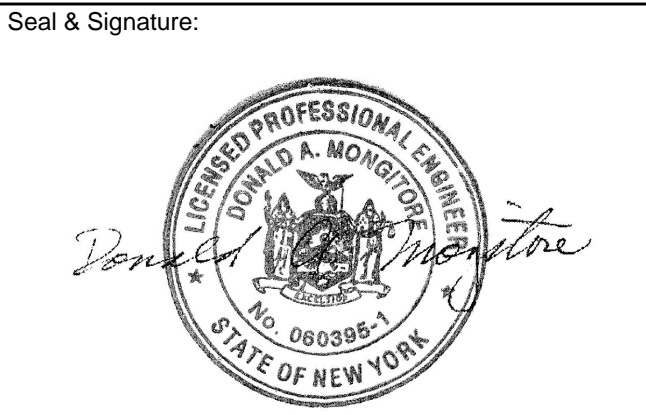
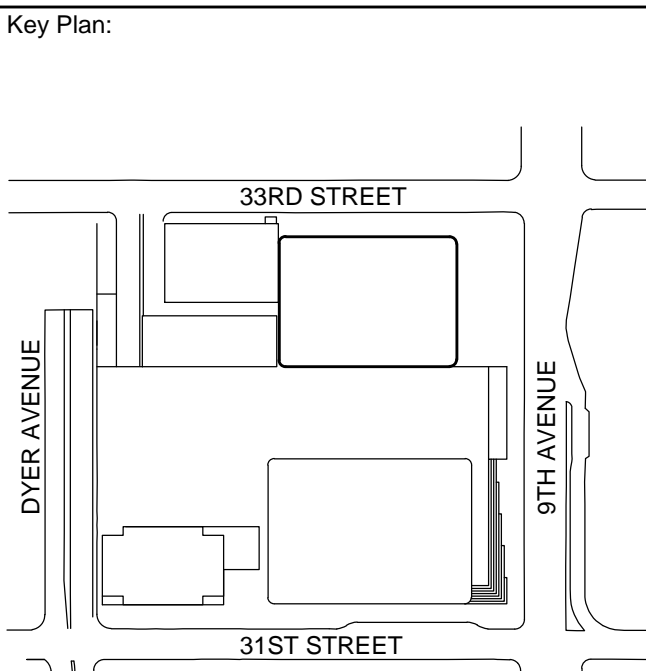
Code Consultants Professional Engineers PC
215 West 40th Street, 15th Floor, New York, NY 10018

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Wind Tunnel Consultant

Rowan Williams Davies & Irwin Inc.
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Ontario, Canada N1K 1B8




1	12 SEPT 2014	ISSUED FOR FOUNDATION PERMIT
No.	Date	Description
Sheet Name:		

NYC EC
COMPLIANCE
LIGHTING
LEVEL 19 - 20
FLOOR PLAN

Project No.:	B-SCAN Sheet No.:
14830-A.000	EN-110.00
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20 JUN 2014	
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PROFESSIONAL ENERGY STATEMENT

TO THE BEST OF MY KNOWLEDGE, BELIEF, AND PROFESSIONAL JUDGEMENT, THESE PLANS AND SPECIFICATIONS ARE IN COMPLIANCE WITH THE NEW YORK CITY ENERGY CONSERVATION CODE.



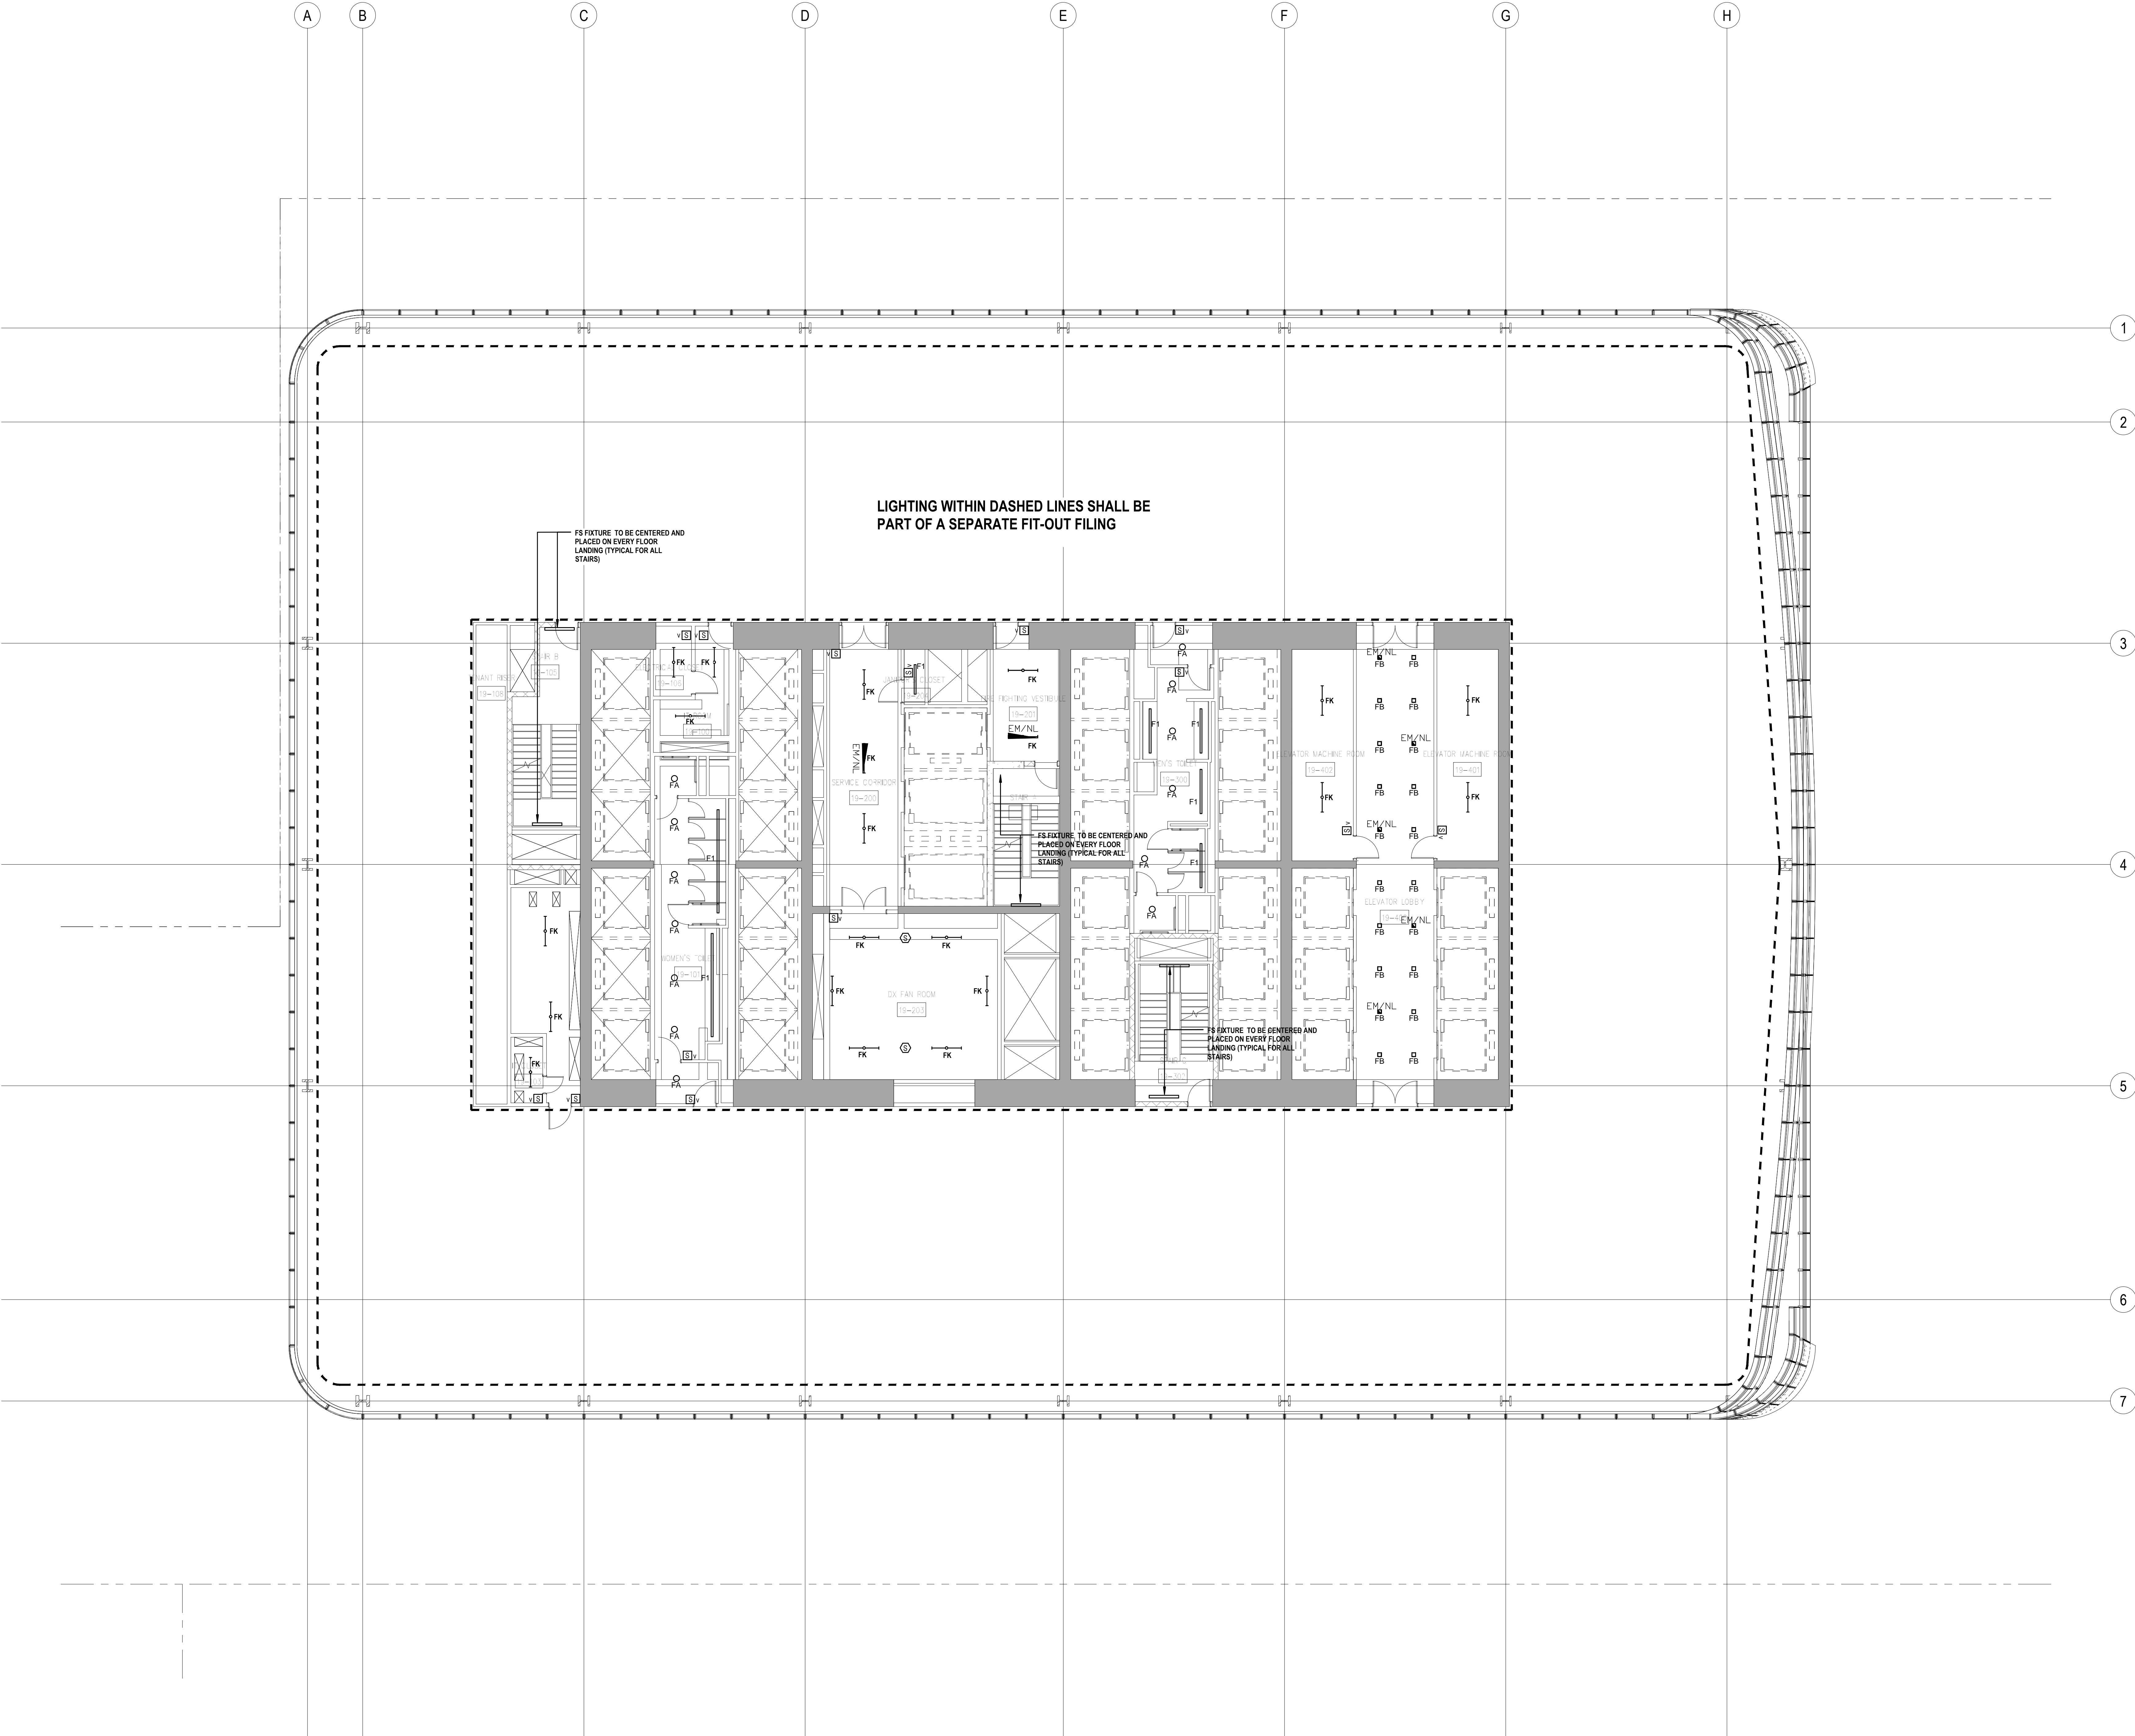

Client
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Blast Consultant
Weidinger Associates, Inc.
40 Wall Street, New York, NY 10005

Acoustical Consultant
Cerami & Associates
404 Elm Avenue #B, New York, NY 10018


Vibration Consultant
Wilson, Uhrig & Associates, Inc.
65 Broadway, Suite 401, New York, NY 10006

Code Consultant
Code Consultants Professional Engineers PC
215 West 40th Street, 15th Floor, New York, NY 10018

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Wind Tunnel Consultant
Rowan Williams Davies & Irwin Inc.
650 Woodbine Road West, Guelph
Ontario, Canada N1K 1B6

Key Plan:

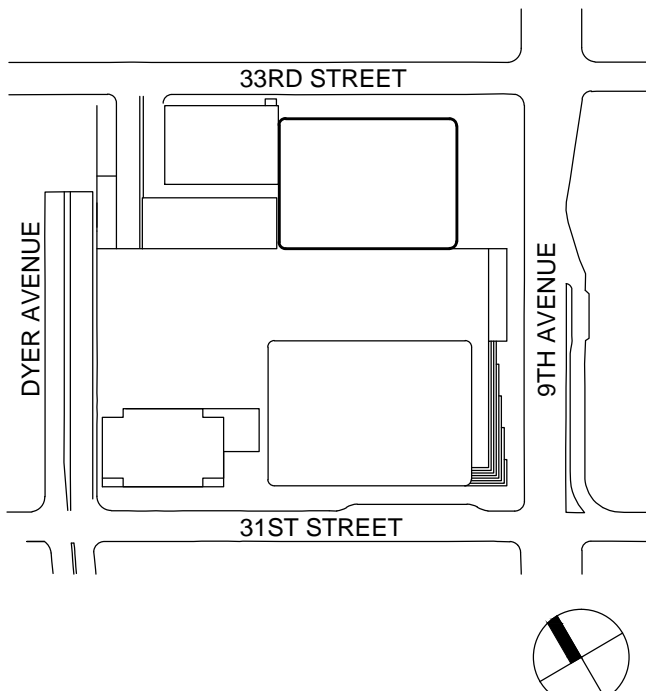

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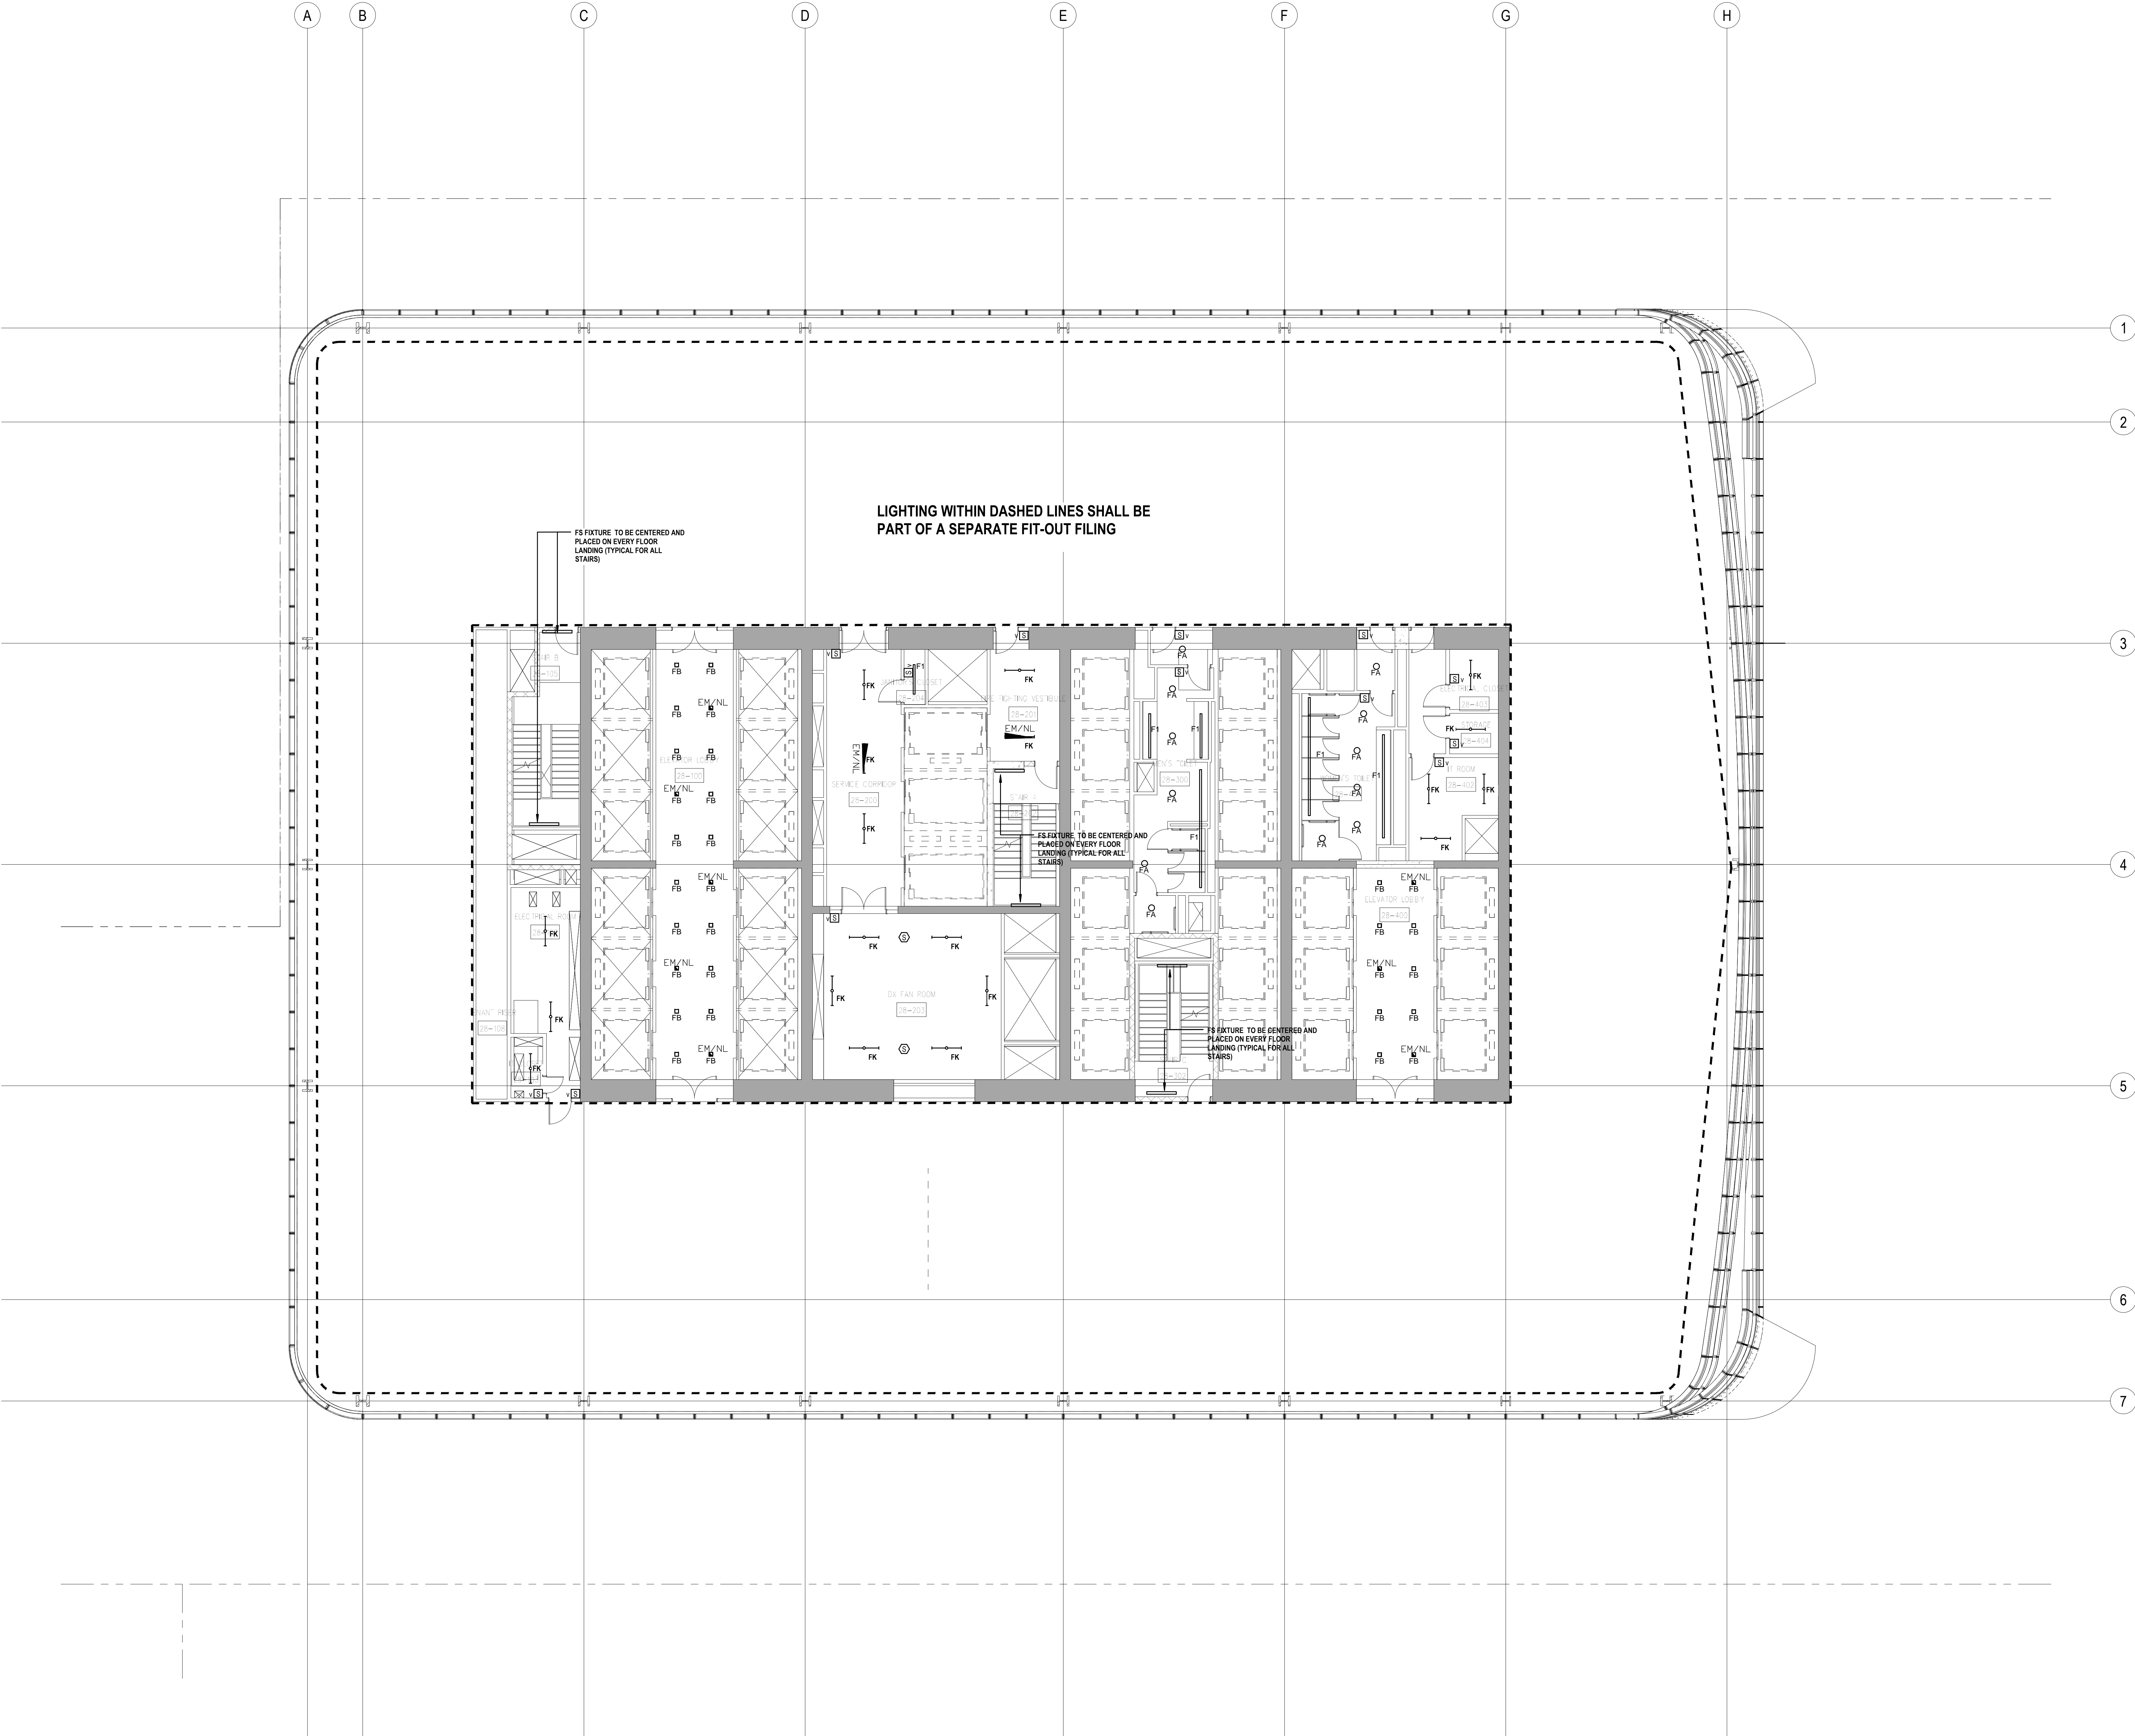


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NYC EC COMPLIANCE LIGHTING LEVEL 28 FLOOR PLAN

Project No.: 14830-A-000	B-SCAN Sheet No.: EN-112.00
Date: 20 JUN 2014	
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14 Beane Plaza, 225 W. 34th Street, #810

Landscape Consultants

Field Operations
475 10th Avenue, New York, NY 10019

Security Consultants

Ducibella, Vantor & Santore
250 State Street 454 North Haven, CT 06433

Plant Consultant

Weidlinger Associates, Inc.
40 Wall Street, New York, NY 10005

Accounted Capital

Cerami & Associates

3. *Discussion*

Wilson, Uhrig & Associates, Inc.

100

Code Consultants Professional Engineers P


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Entek Engineering LLC

Wind Tunnel Consultant
Rowan Williams Davies & Irwin Inc.

Ontario, Canada N1K

	Key Pla

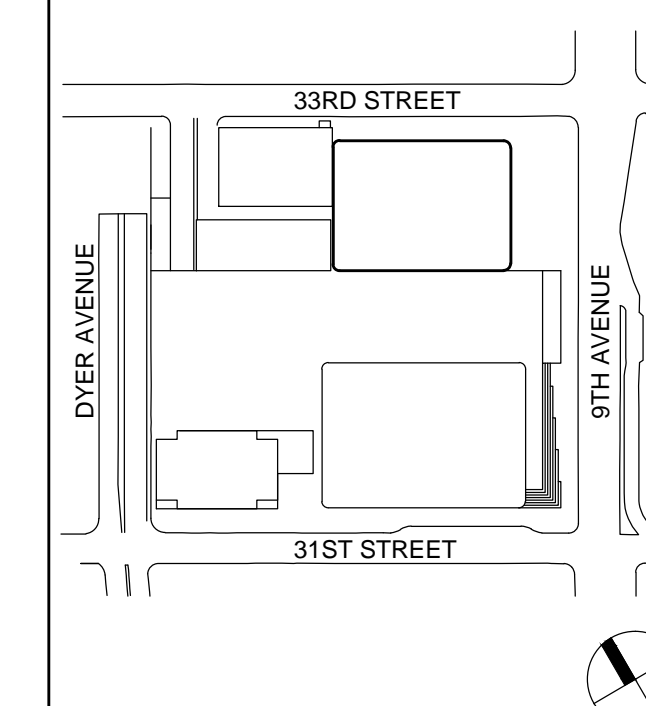

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1	12 SEPT 2014	ISSUED FOR FOUNDATION PERMIT
No.	Date	Description

NYC EC
COMPLIANCE
LIGHTING
LEVEL 29
FLOOR PLAN

Project No.: 14830.A.000	B-SCAN Sheet No.:
Date: 20 JUN 2014	EN-113.00
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PROFESSIONAL ENERGY STATEMENT

TO THE BEST OF MY KNOWLEDGE, BELIEF, AND PROFESSIONAL JUDGEMENT, THESE PLANS AND SPECIFICATIONS ARE IN COMPLIANCE WITH THE NEW YORK CITY ENERGY CONSERVATION CODE.



Client
Brookfield

Architecture/Structural Engineering
SOM
Skidmore, Owings & Merrill LLP
14 Wall Street, New York, NY 10005

Civil Engineering
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650 Woodbine Road West, Guelph, Ontario, Canada N1K 1B8

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NYC EC COMPLIANCE LIGHTING LEVEL 30 FLOOR PLAN

Project No.: 14830.A.000

Date: 20 JUN 2014

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SOM
Skidmore, Owings & Merrill LLP
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Civil Engineering
Philip Habib & Associates
102 Madison Avenue #11, New York, NY 10016

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Jaros Baum & Bolles
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Viridian Energy & Environmental
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Security Consultant
Ducibella, Vantor & Santore
250 State Street #F1, North Haven, CT 06473

Blast Consultant
Weidinger Associates, Inc.
40 Wall Street, New York, NY 10005


Acoustical Consultant
Cerami & Associates
404 Fifth Avenue #5, New York, NY 10018

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Wilson, Uhrig & Associates, Inc.
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Rowan Williams Davies & Irwin Inc.
650 Woodbine Road West, Guelph, Ontario, Canada N1K 1B6





No.	Date	Description
1	12 SEPT 2014	ISSUED FOR FOUNDATION PERMIT

NYC EC
COMPLIANCE
LIGHTING
LEVEL 31
FLOOR PLAN

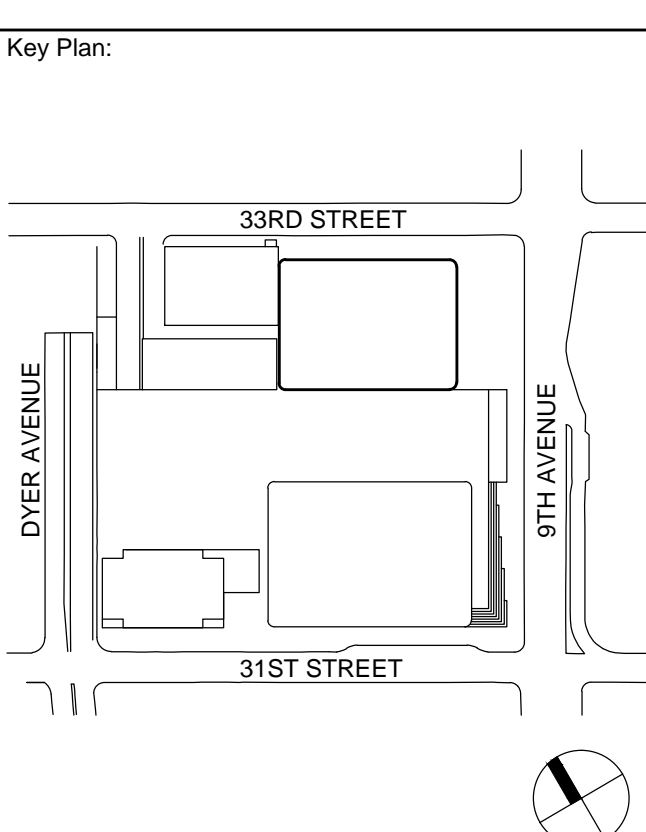Project No.: 14830.A.000	B-SCAN Sheet No.: EN-115.00
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PROFESSIONAL ENERGY STATEMENT
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MANHATTAN WEST:
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650 Woodbine Road West, Guelph
Ontario, Canada N1K 1B8

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No. Date Description

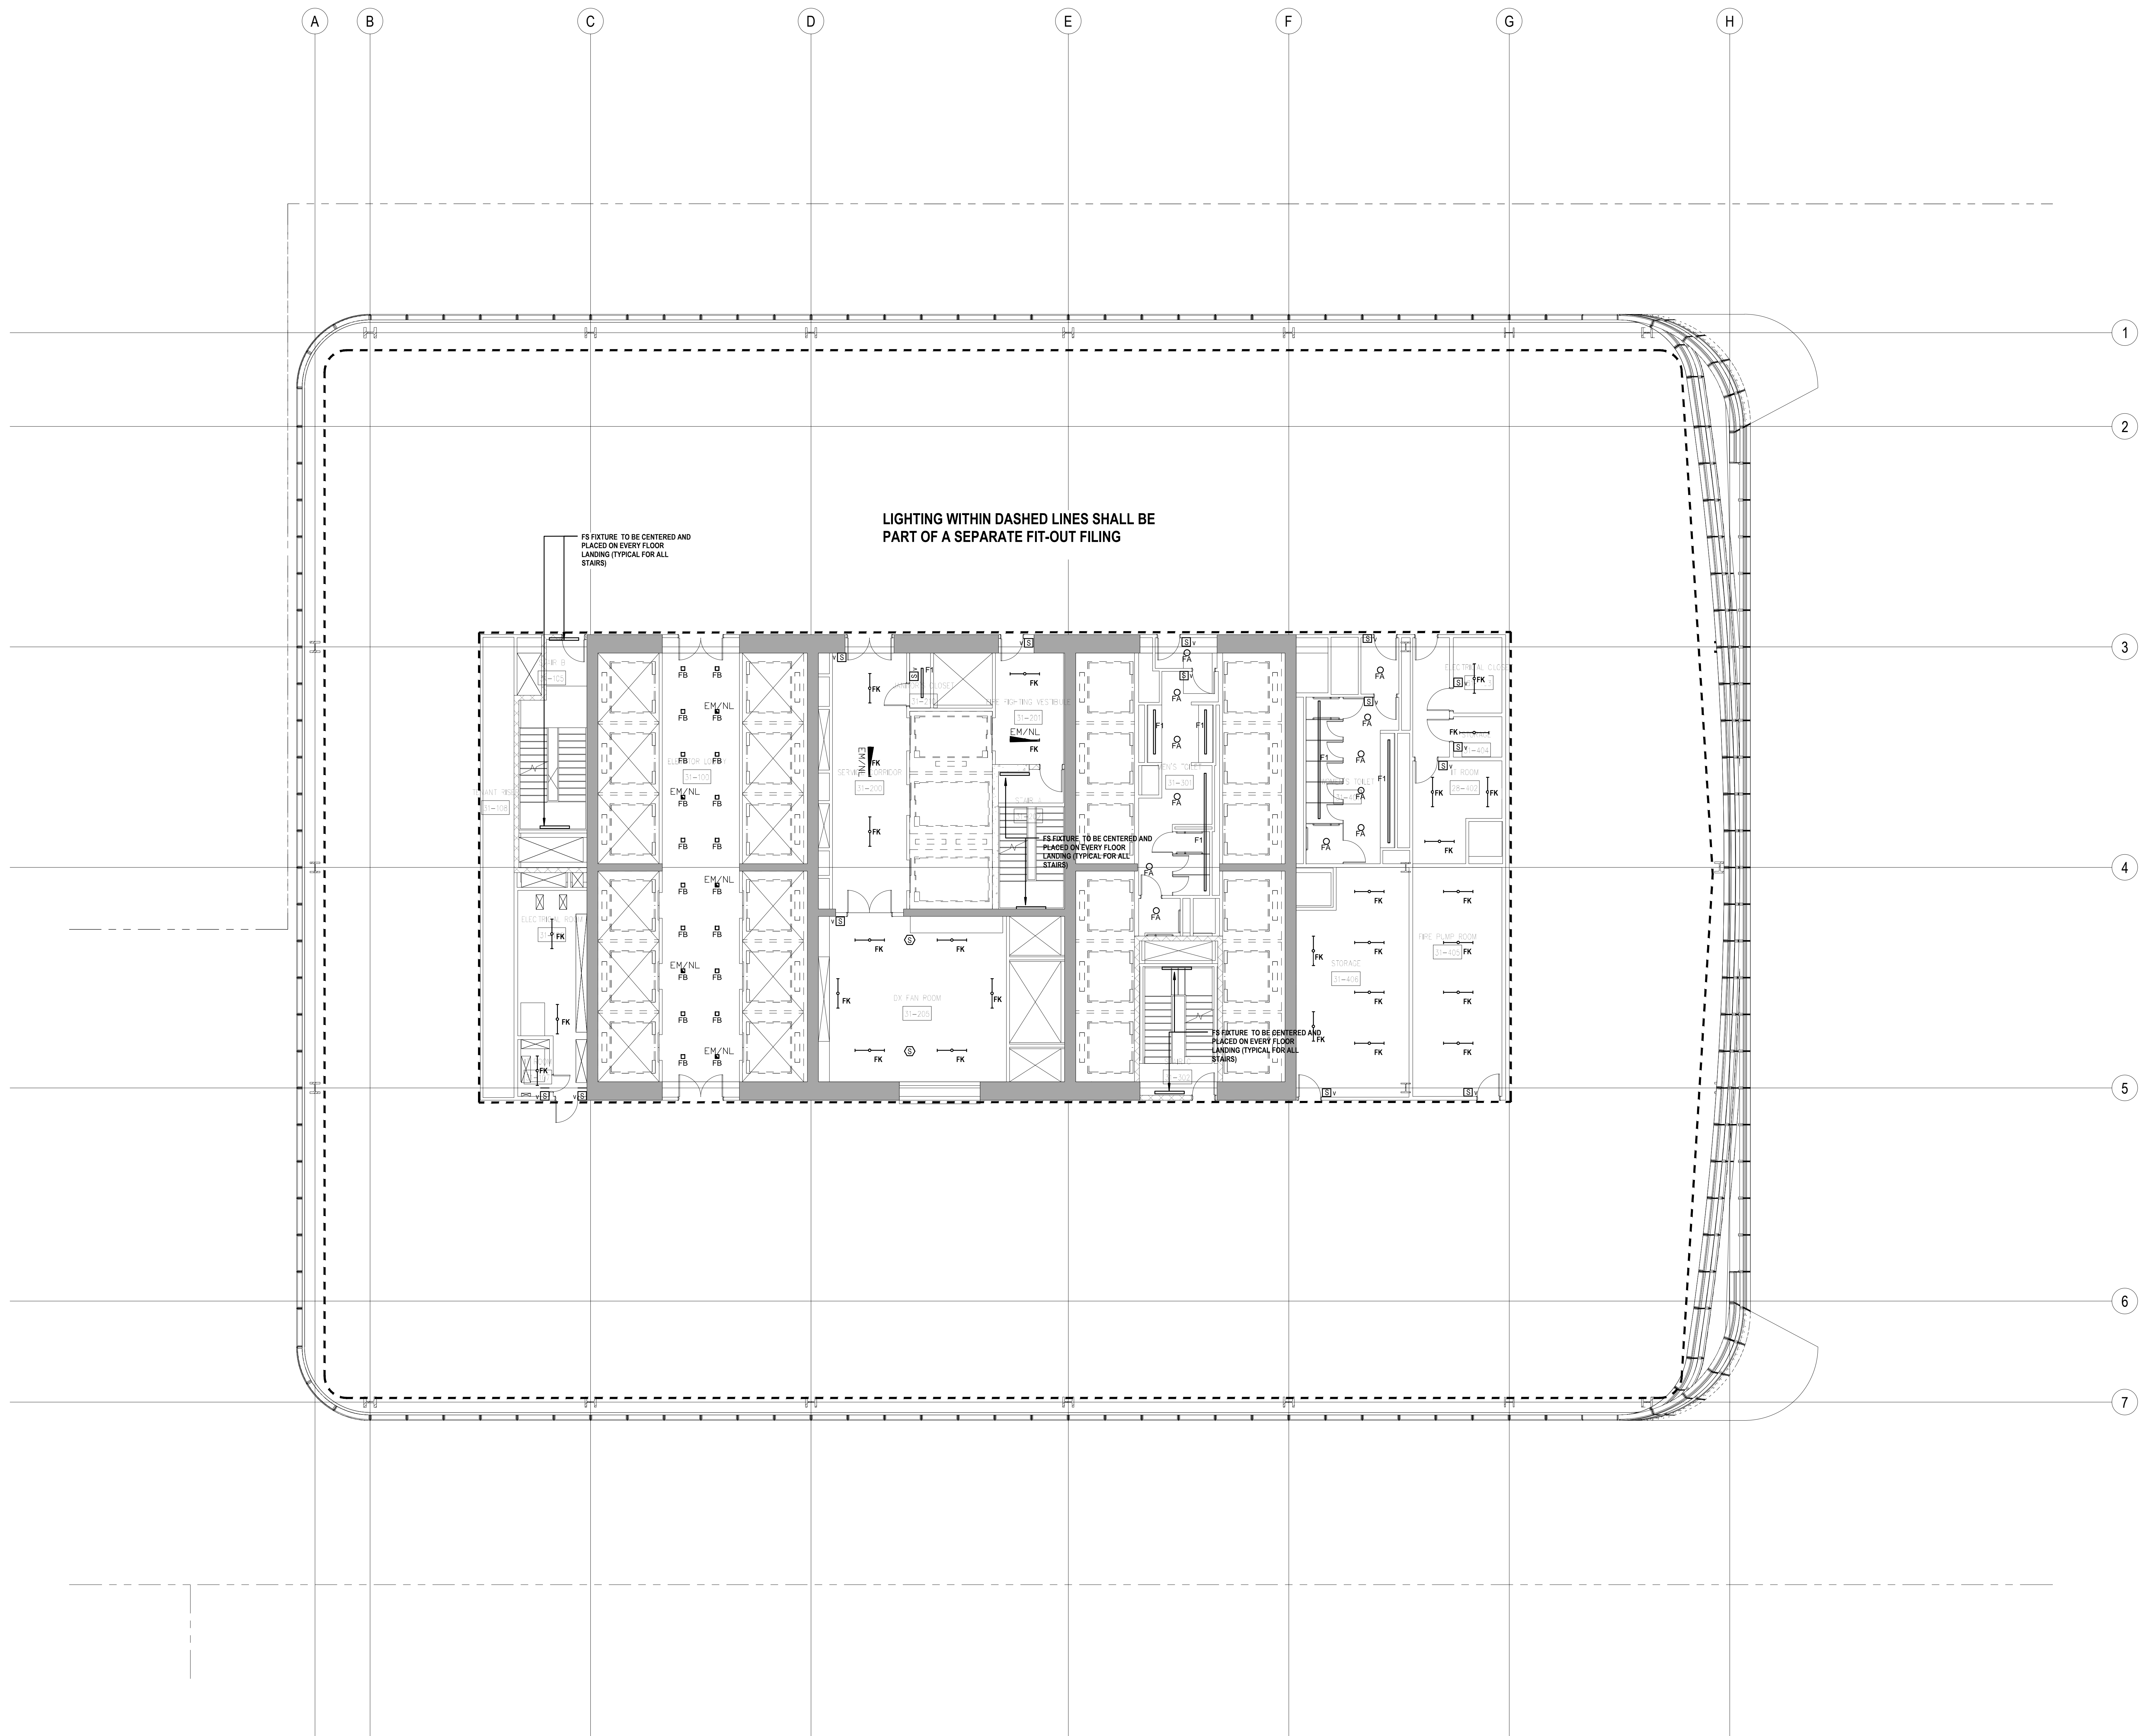Sheet Name:

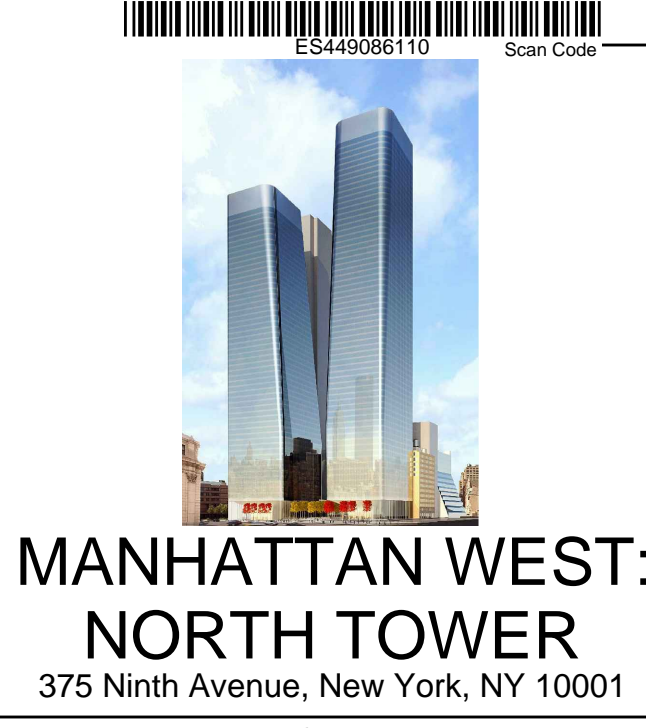NYC EC
COMPLIANCE
LIGHTING
LEVEL 32
FLOOR PLAN

Project No.:
14830.A.000

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20 JUN 2014

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EN-116.00

PROFESSIONAL ENERGY STATEMENT
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SHEET NOTES



Client
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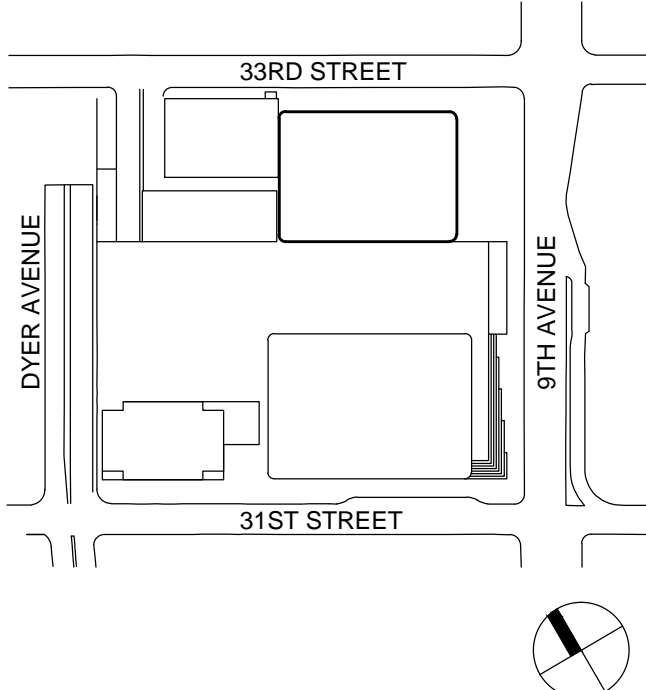
Facade Maintenance Consultant
Entek Engineering LLC
166 Ames Street, Hackensack, NJ 07601

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Rowan Williams Davies & Irwin Inc.
650 Woodbine Road West, Guelph, Ontario, Canada N1K 1B8

Key Plan:



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No.	Date	Description
1	12 SEPT 2014	ISSUED FOR FOUNDATION PERMIT

NYC EC
COMPLIANCE
LIGHTING
LEVEL 39
FLOOR PLAN

Project No.: 14830.A.000	B-SCAN Sheet No.: EN-118.00
Date: 20 JUN 2014	
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PROFESSIONAL ENERGY STATEMENT
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SHEET NOTES



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Wind Tunnel Consultant
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650 Woodbine Road West, Guelph, Ontario, Canada N1K 1B8

Key Plan:



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No. Date Description

Sheet Name:

NYC EC COMPLIANCE LIGHTING LEVEL 40-41 FLOOR PLAN

Project No.: 14830.A.000

Date: 20 JUN 2014

Scale: N.T.S.

File No.: B-SCAN Sheet No.: EN-119.00

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PROFESSIONAL ENERGY STATEMENT
TO THE BEST OF MY KNOWLEDGE, BELIEF, AND PROFESSIONAL JUDGEMENT, THESE PLANS AND SPECIFICATIONS ARE IN COMPLIANCE WITH THE NEW YORK CITY ENERGY CONSERVATION CODE.

SHEET NOTES



Client
Brookfield

Brookfield Place
250 Vesey Street, 15th Floor, New York, NY 10281

Architecture/Structural Engineering

SOM
Skidmore, Owings & Merrill LLP
14 Wall Street, New York, NY 10005

Civil Engineering
Philip Habib & Associates
102 Madison Avenue #11, New York, NY 10016

MEP Engineering
Jaros Baum & Bolles
80 Pine Street, New York, NY 10005

Vertical Transportation
Edgett Williams Consulting Group, Inc.
102 East Blithedale Ave. Suite 1, Mill Valley, California 94941

Sustainable Design
Viridian Energy & Environmental
50 Washington Street, Norwalk, CT 06854

Geo-Technical Engineering
Mueser Rutledge Consulting Engineers
14 Penn Plaza, 225 W. 34th Street #610,
New York, NY 10122

Landscape Consultant
Field Operations
475 10th Avenue, New York, NY 10018

Security Consultant
Ducibella, Vantor & Santore
250 State Street #F1, North Haven, CT 06473

Blast Consultant
Weidinger Associates, Inc.
40 Wall Street, New York, NY 10005



Acoustical Consultant
Cerami & Associates
404 Elm Avenue #5, New York, NY 10018

Vibration Consultant
Wilson, Uhrig & Associates, Inc.
65 Broadway, Suite 401, New York, NY 10006

Code Consultant
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Entek Engineering LLC
166 Ames Street, Hackensack, NJ 07601

Wind Tunnel Consultant
Rowan Williams Davies & Irwin Inc.
650 Woodbine Road West, Guelph
Ontario, Canada N1K 1B6

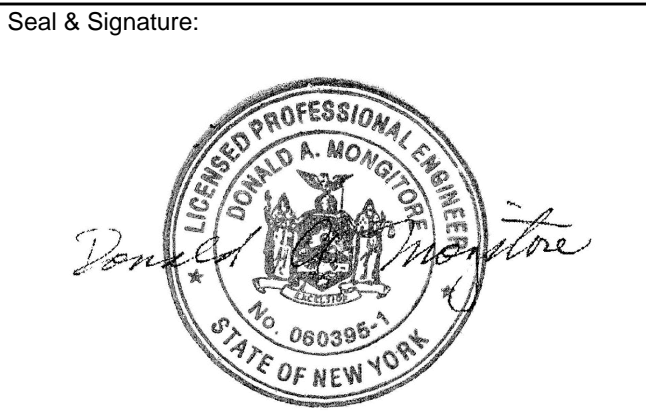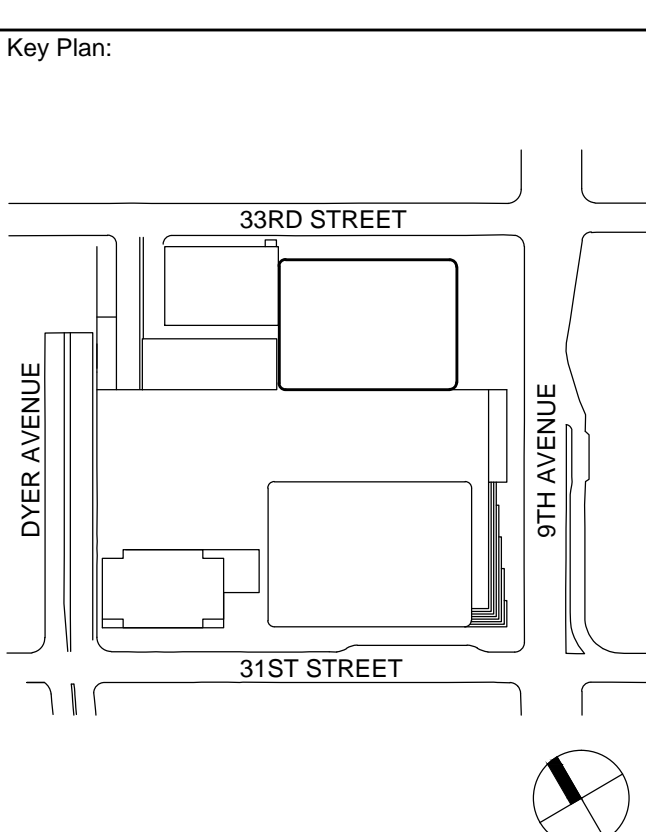


No.	Date	Description
1	12 SEPT 2014	ISSUED FOR FOUNDATION PERMIT

NYC EC
COMPLIANCE
LIGHTING
LEVEL 42
FLOOR PLAN

Project No.: 14830.A.000	B-SCAN Sheet No.: EN-120.00
Date: 20 JUN 2014	
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File No.:	Page No.:

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SHEET NOTES

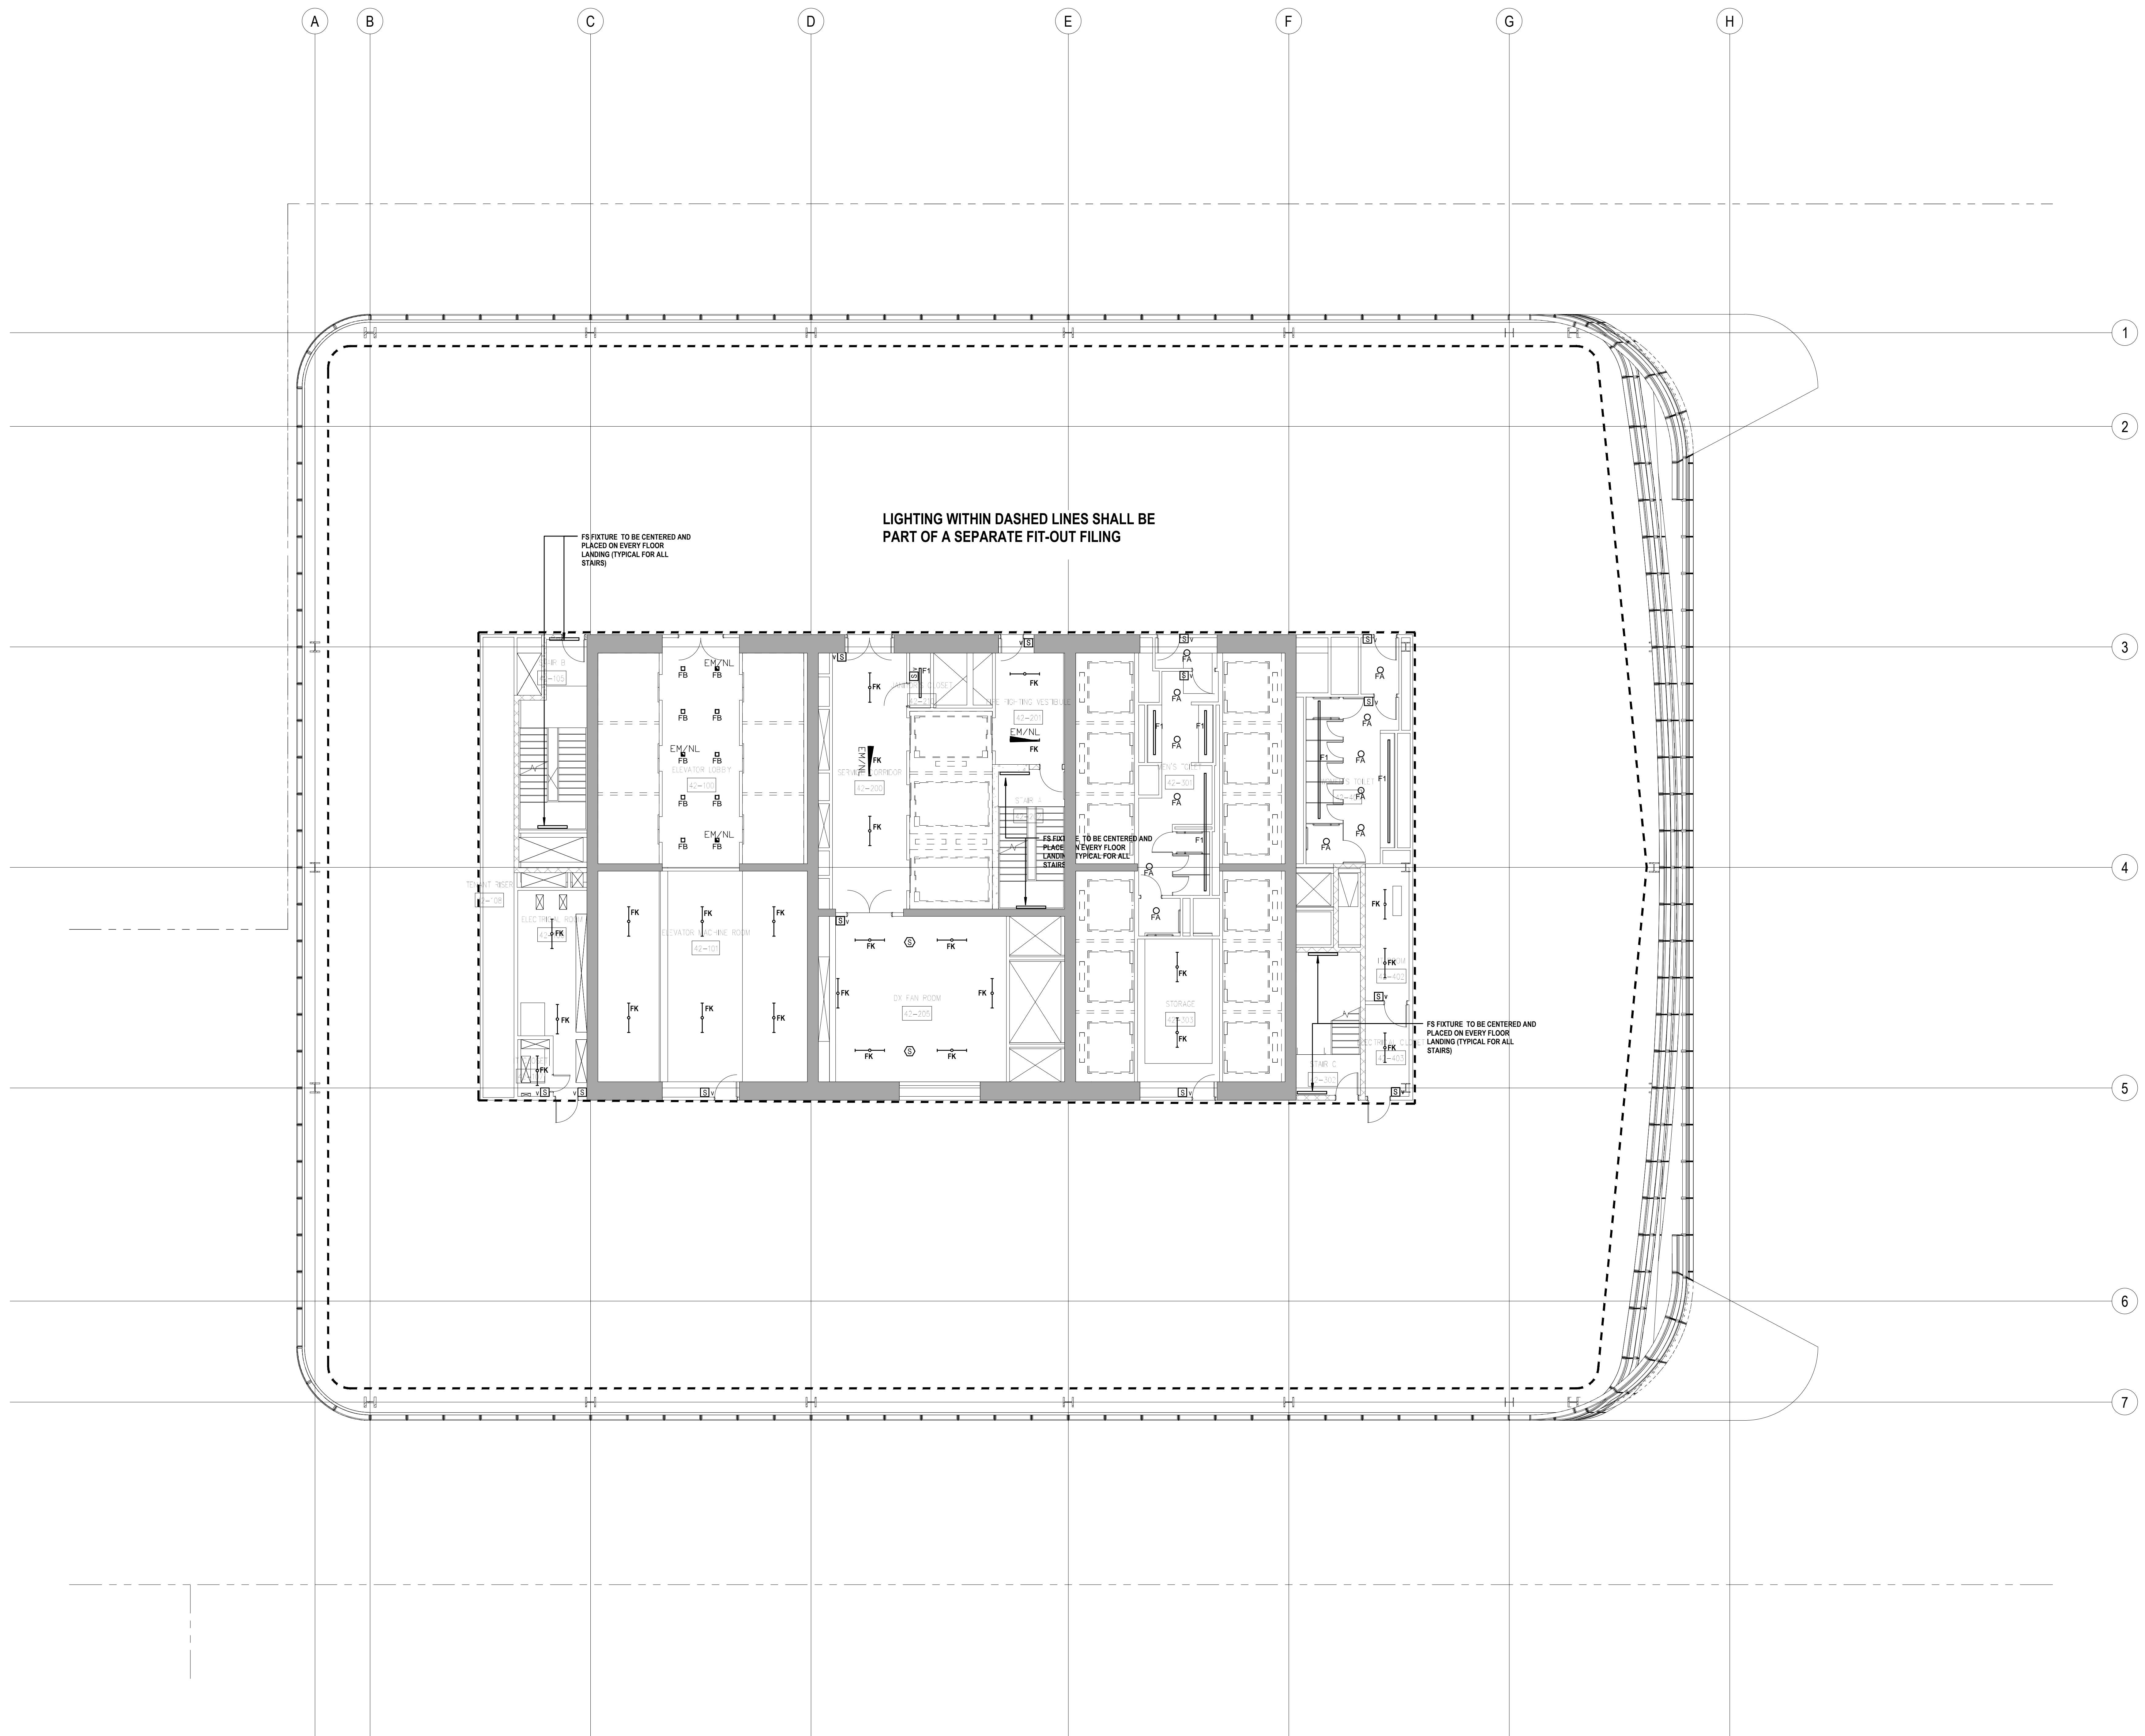

Client
Brookfield

Brookfield Place
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Ducibella, Vantor & Santore
250 State Street #F1, North Haven, CT 06473

Blast Consultant
Weidinger Associates, Inc.
40 Wall Street, New York, NY 10005


Acoustical Consultant
Cerami & Associates
404 Elm Avenue #5, New York, NY 10018

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Wilson, Uhrig & Associates, Inc.
65 Broadway, Suite 401, New York, NY 10006

Code Consultant
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166 Ames Street, Hackensack, NJ 07601

Wind Tunnel Consultant
Rowan Williams Davies & Irwin Inc.
650 Woodbine Road West, Guelph
Ontario, Canada N1K 1B6

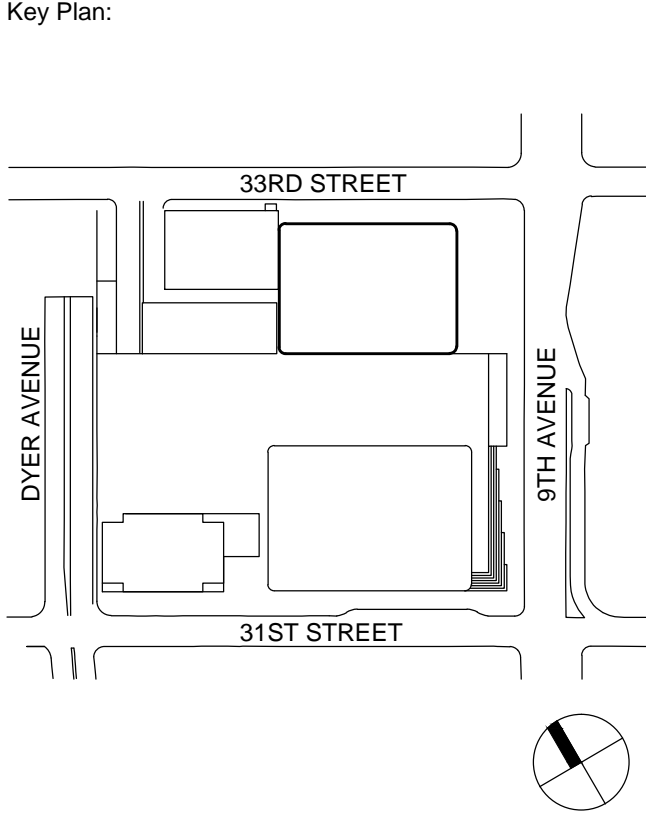


No.	Date	Description
1	12 SEPT 2014	ISSUED FOR FOUNDATION PERMIT

NYC EC
COMPLIANCE
LIGHTING
LEVEL 49
FLOOR PLAN

Project No.: 14830.A.000	B-SCAN Sheet No.: EN-122.00
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650 Woodbine Road West, Guelph, Ontario, Canada N1K 1B6

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Sheet Name:

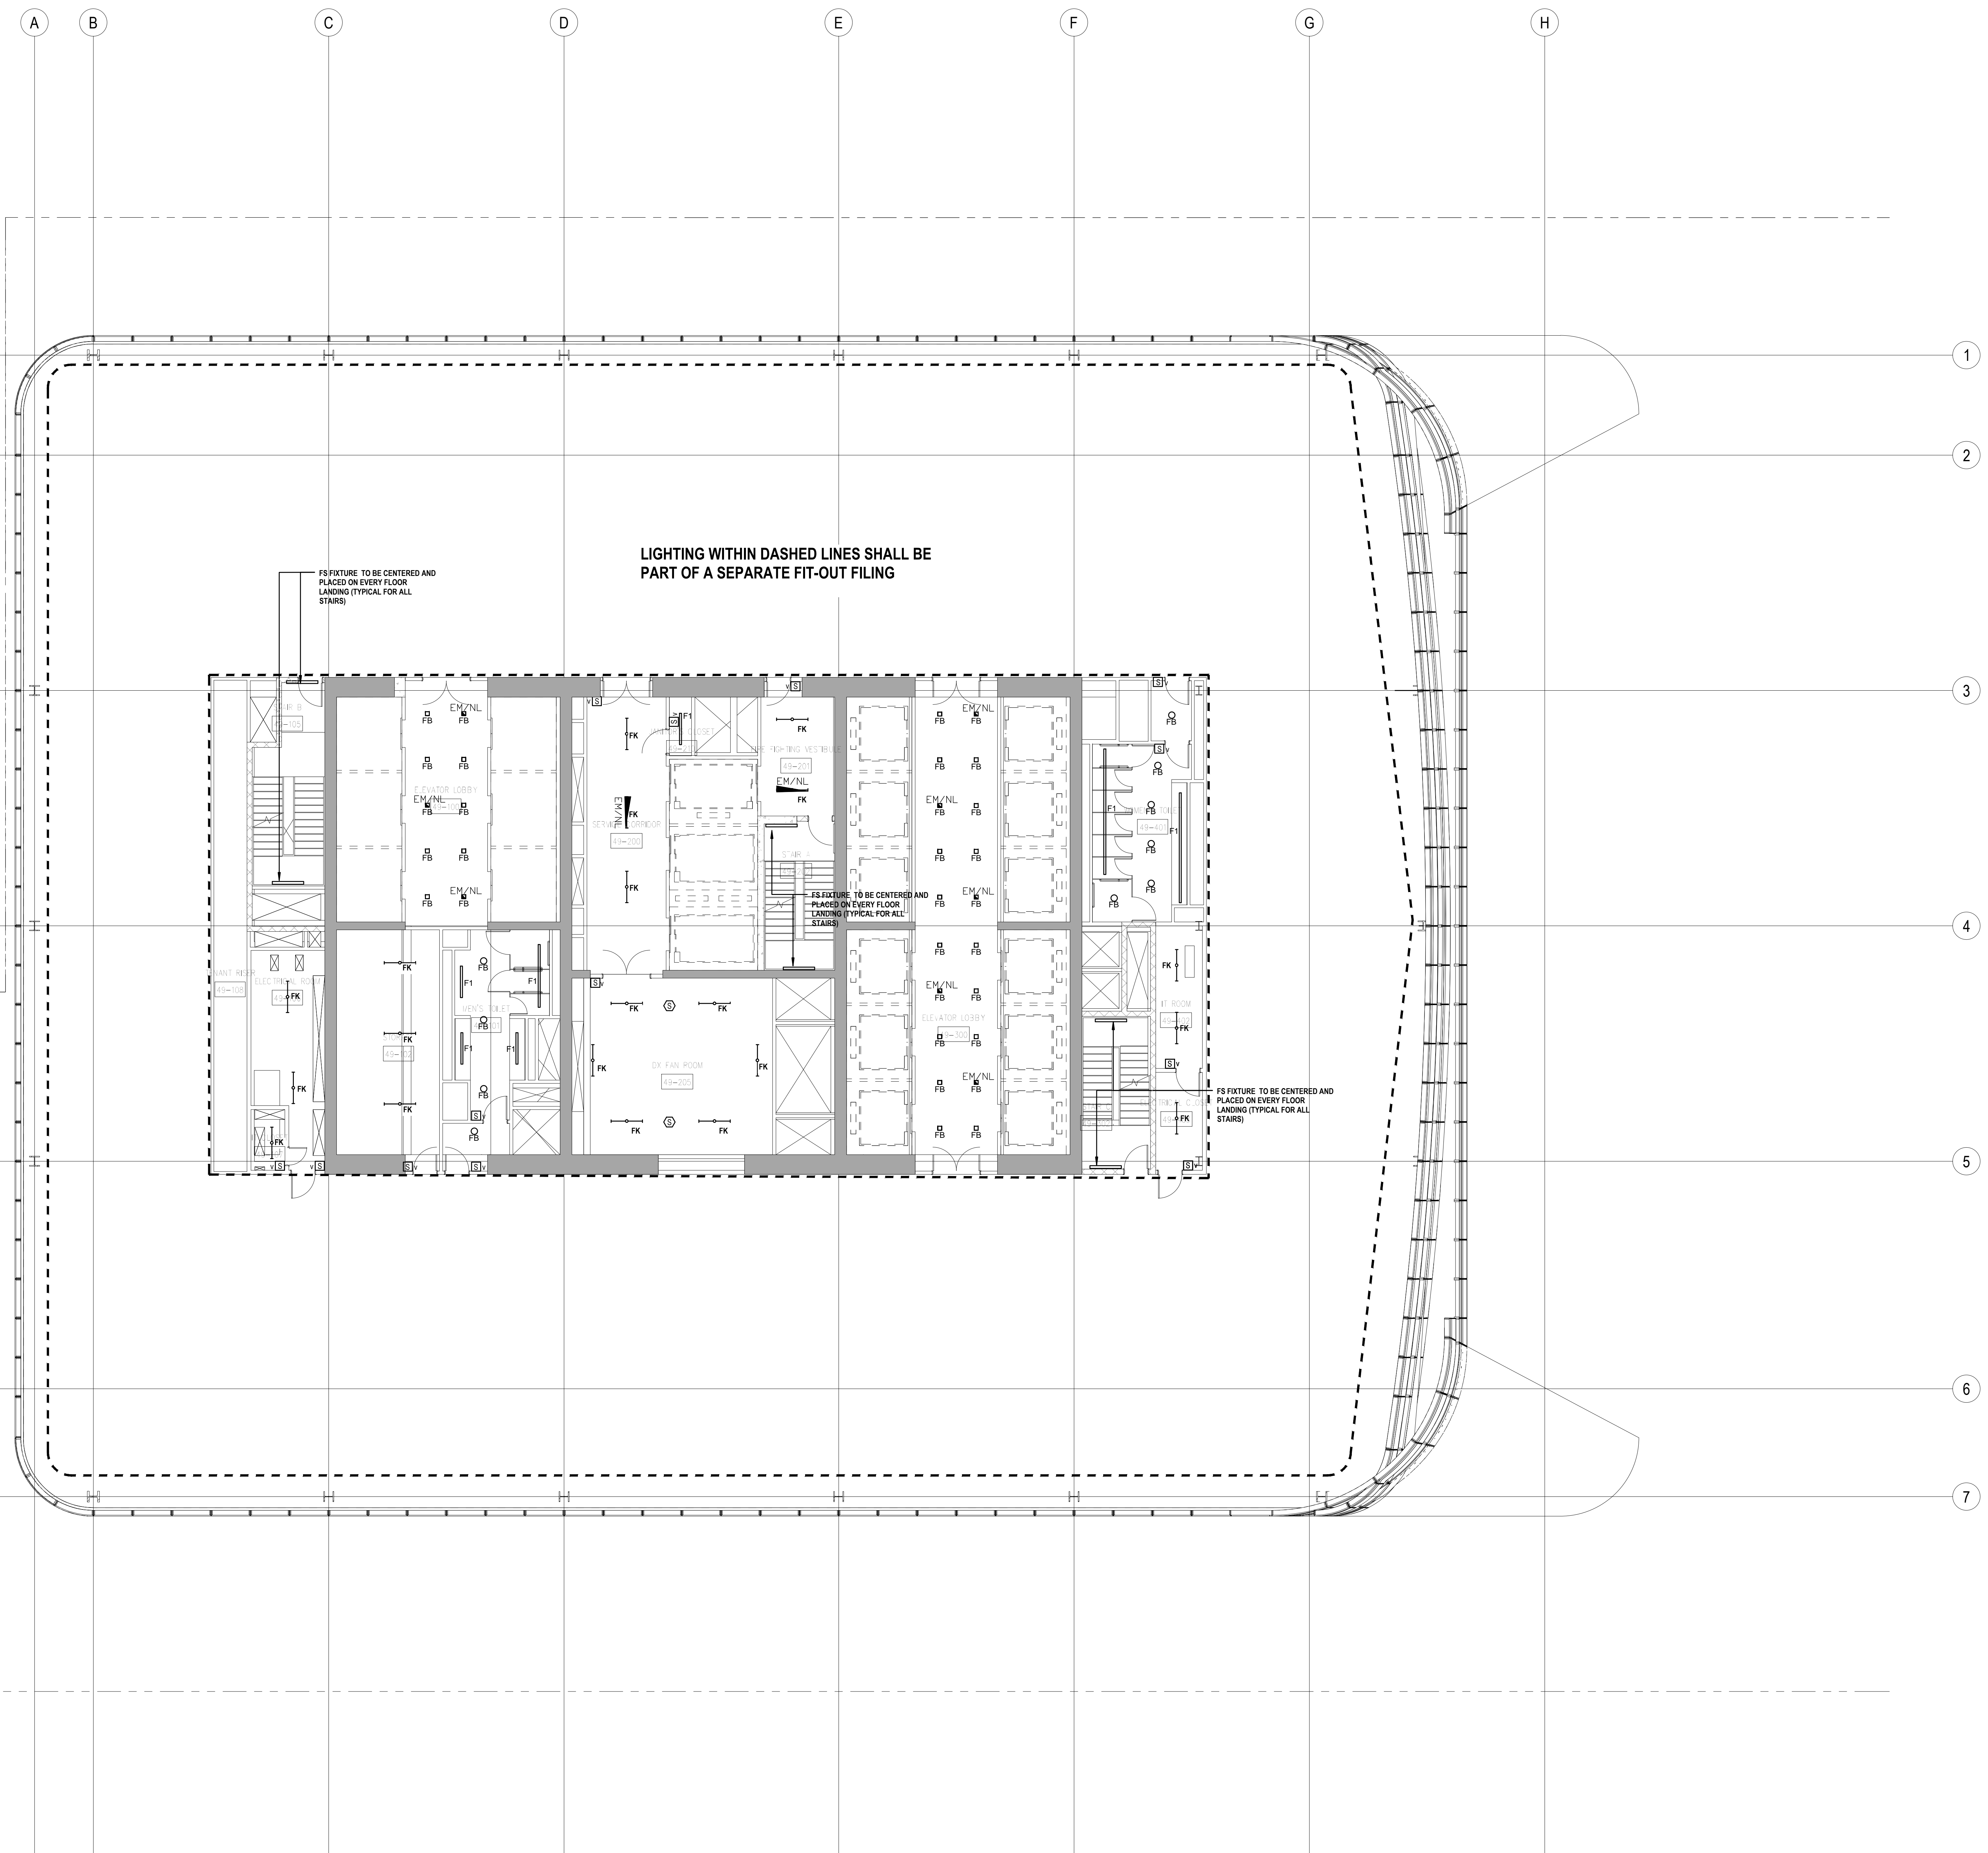NYC EC COMPLIANCE LIGHTING LEVEL 52 FLOOR PLAN

Project No.: 14830.A.000

Date: 20 JUN 2014

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File No.: B-SCAN Sheet No.: EN-124.00

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Brookfield
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Ducibella, Vantor & Santore
250 State Street #F1, North Haven, CT 06473

Blast Consultant
Weidinger Associates, Inc.
40 Wall Street, New York, NY 10005



Acoustical Consultant
Cerami & Associates
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Wilson, Uhrig & Associates, Inc.
65 Broadway, Suite 401, New York, NY 10006

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Wind Tunnel Consultant
Rowan Williams Davies & Irwin Inc.
650 Woodlawn Road West, Guelph, Ontario, Canada N1K 1B8




No.	Date	Description
1	12 SEPT 2014	ISSUED FOR FOUNDATION PERMIT

NYC EC COMPLIANCE LIGHTING LEVEL 53 FLOOR PLAN

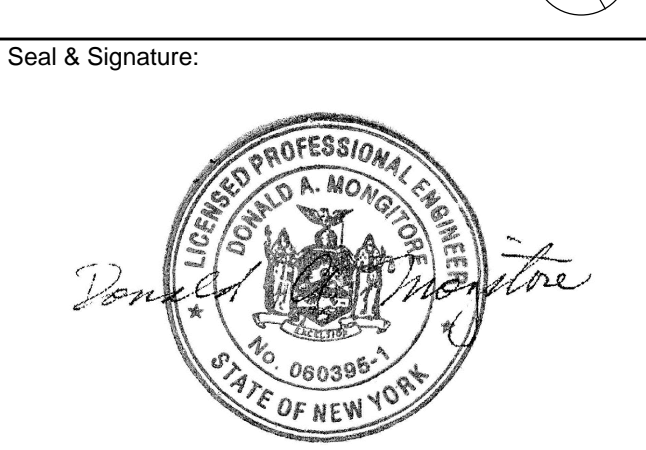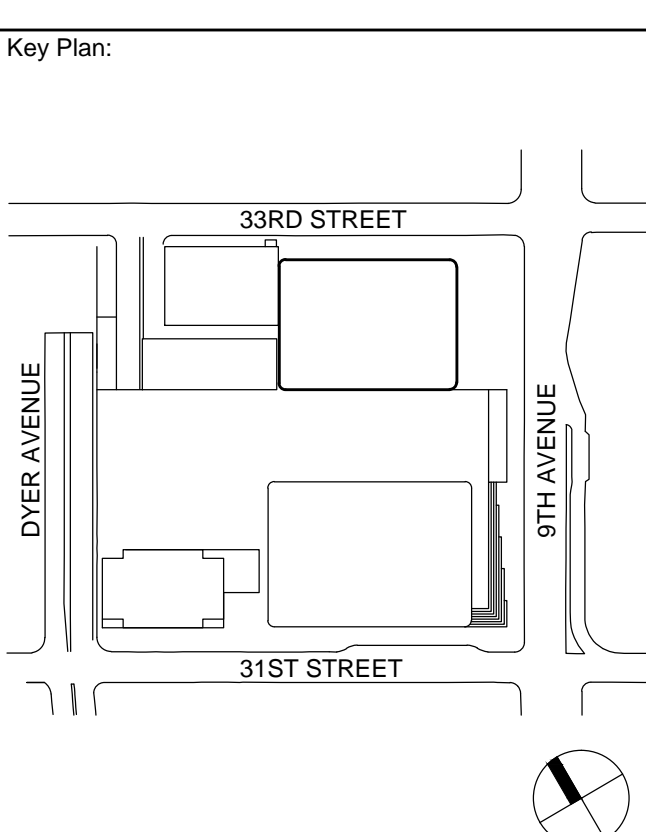Project No.: 14830.A.000	B-SCAN Sheet No.: EN-125.00
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SHEET NOTES

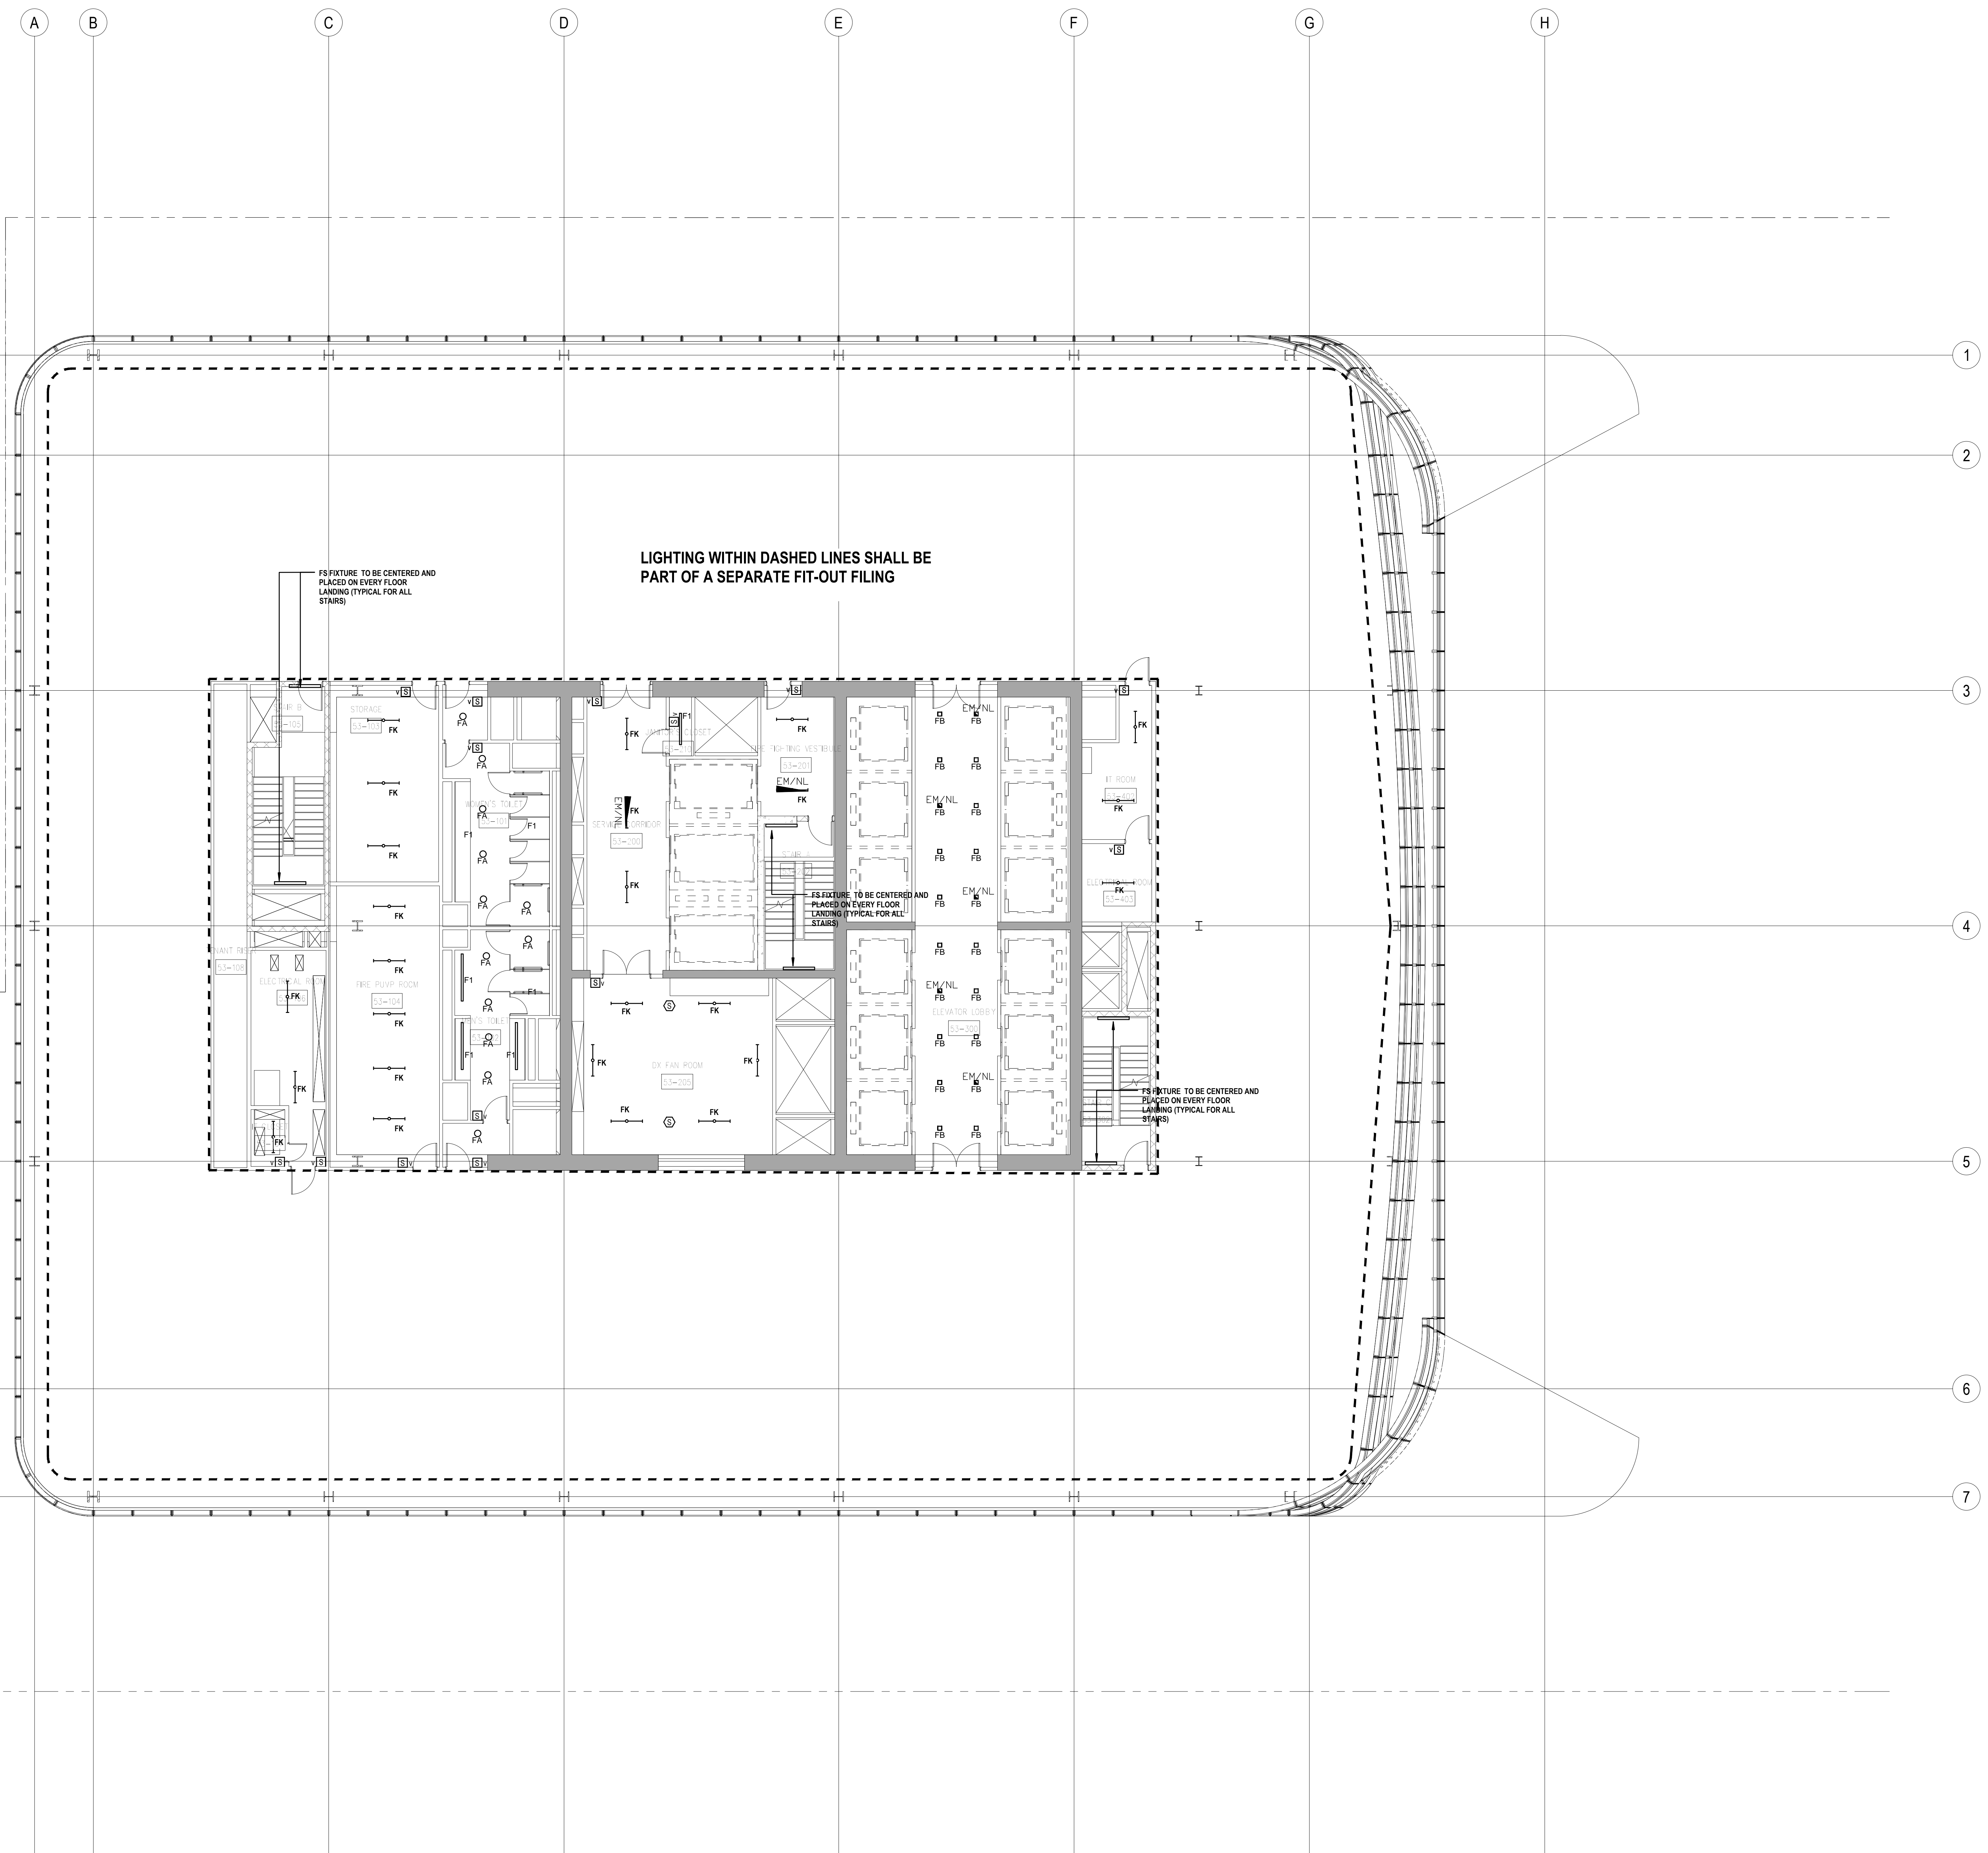

Client
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Blast Consultant
Weidinger Associates, Inc.
40 Wall Street, New York, NY 10005

Acoustical Consultant
Cerami & Associates
404 Elm Avenue #5, New York, NY 10018


Vibration Consultant
Wilson, Uhrig & Associates, Inc.
65 Broadway, Suite 401, New York, NY 10006

Code Consultant
Code Consultants Professional Engineers PC
215 West 40th Street, 15th Floor, New York, NY 10018

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Entek Engineering LLC
166 Ames Street, Hackensack, NJ 07601

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Rowan Williams Davies & Irwin Inc.
650 Woodbine Road West, Guelph, Ontario, Canada N1K 1B8

Key Plan:

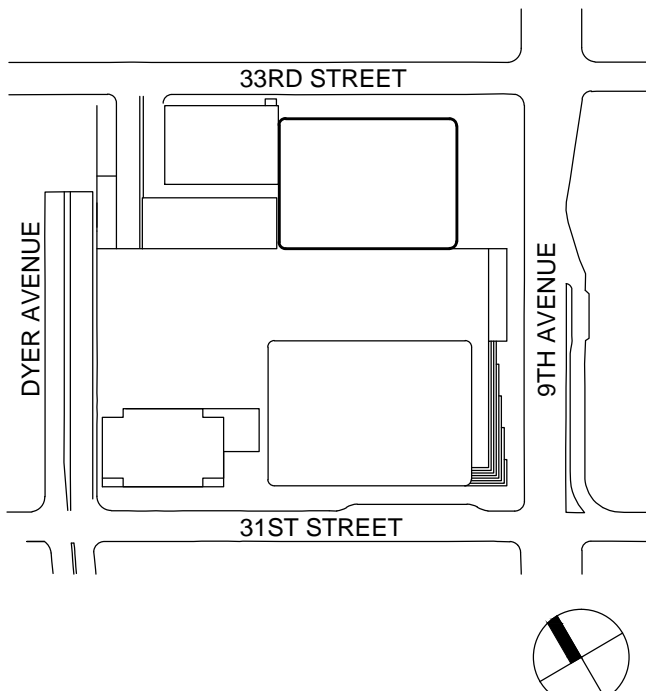

Seal & Signature:



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No. Date Description

Sheet Name:

NYC EC COMPLIANCE LIGHTING LEVEL 54 FLOOR PLAN

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LIGHTING WITHIN DASHED LINES SHALL BE PART OF A SEPARATE FIT-OUT FILING

FS FIXTURE TO BE CENTERED AND PLACED ON EVERY FLOOR LANDING (TYPICAL FOR ALL STAIRS)

FS FIXTURE TO BE CENTERED AND PLACED ON EVERY FLOOR LANDING (TYPICAL FOR ALL STAIRS)

FS FIXTURE TO BE CENTERED AND PLACED ON EVERY FLOOR LANDING (TYPICAL FOR ALL STAIRS)



Client

Brookfield

Brookfield Place
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Architecture/Structural Engineering

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Landscape Consultant

Field Operations

Security Consultants

Ducibella, Vantor & Santore
250 State Street 454, North Haven, CT 06473

Asset Consultant

Weidlinger Associates, Inc.
40 Wall Street, New York, NY 10005

Accounting Consultant

Cerami & Associates

342 *Journal of Management Inquiry* 20(3)

Wilson, Uhrig & Associates, Inc.

Code Consultants Professional Engineers P


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Entek Engineering LLC

Wind Tunnel Consultant

Rowan Williams Davies & Irwin Inc.

Key Pla

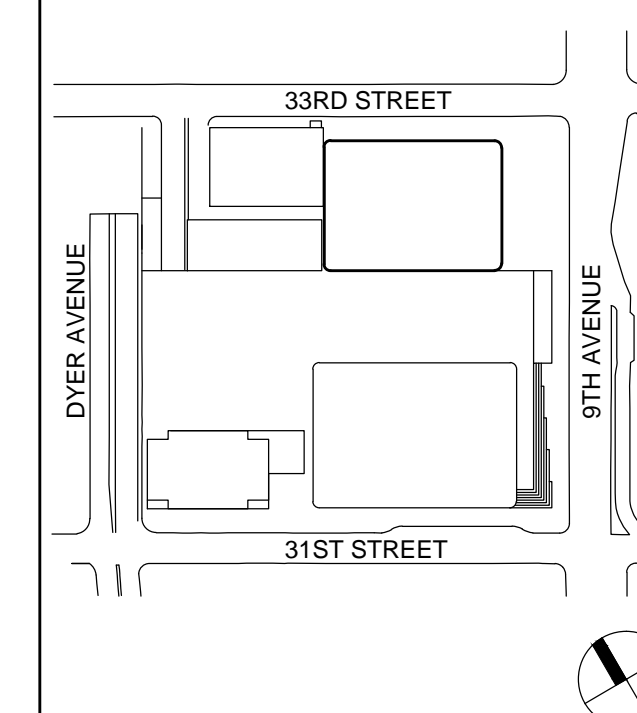

Seal & Signature



NYC EC
COMPLIANCE
LIGHTING
LEVEL 55
FLOOR PLAN

Project No.:

14830.A.00

Date: 22.11.22

20 JUN 2015

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EN-127 00

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PROFESSIONAL ENERGY STATEMENT

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SHEET NOTES



Client
Brookfield

Brookfield Place
250 Vesey Street, 15th Floor, New York, NY 10281

Architecture/Structural Engineering
SOM
Skidmore, Owings & Merrill LLP
14 Wall Street, New York, NY 10005

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Philip Habib & Associates
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Vertical Transportation
Edgett Williams Consulting Group, Inc.
102 East Blithedale Ave. Suite 1, Mill Valley, California 94941

Sustainable Design
Viridian Energy & Environmental
50 Washington Street, Norwalk, CT 06854

Geo-Technical Engineering
Mueser Rutledge Consulting Engineers
14 Penn Plaza, 225 W. 34th Street #610, New York, NY 10122

Landscape Consultant
Field Operations
475 10th Avenue, New York, NY 10018

Security Consultant
Ducibella, Vantor & Santore
250 State Street #F1, North Haven, CT 06473

Blast Consultant
Weidinger Associates, Inc.
40 Wall Street, New York, NY 10005


Acoustical Consultant
Cerami & Associates
404 Elm Avenue #5, New York, NY 10018

Vibration Consultant
Wilson, Uhrig & Associates, Inc.
65 Broadway, Suite 401, New York, NY 10006

Code Consultant
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215 West 40th Street, 15th Floor, New York, NY 10018

Facade Maintenance Consultant
Entek Engineering LLC
166 Ames Street, Hackensack, NJ 07601

Wind Tunnel Consultant
Rowan Williams Davies & Irwin Inc.
650 Woodbine Road West, Guelph, Ontario, Canada N1K 1B8

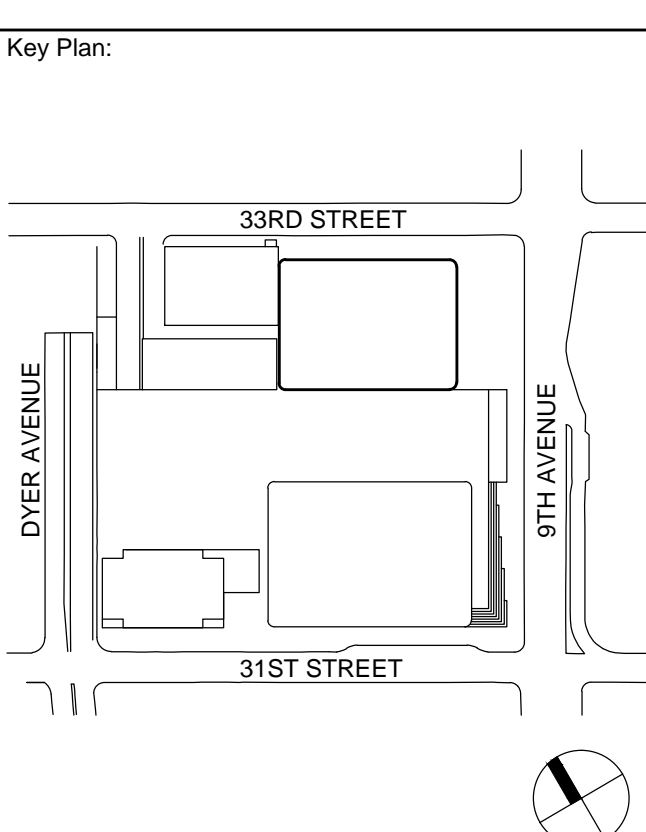

No.	Date	Description
1	12 SEPT 2014	ISSUED FOR FOUNDATION PERMIT

NYC EC
COMPLIANCE
LIGHTING
LEVEL 56
FLOOR PLAN

Project No.: 14830.A.000	B-SCAN Sheet No.: EN-128.00
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SHEET NOTES



MANHATTAN WEST:
NORTH TOWER
375 Ninth Avenue, New York, NY 10001

Client
Brookfield

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Blast Consultant
Weidinger Associates, Inc.
40 Wall Street, New York, NY 10005

Acoustical Consultant
Cerami & Associates
404 Elm Avenue #5, New York, NY 10018


Vibration Consultant
Wilson, Uhrig & Associates, Inc.
65 Broadway, Suite 401, New York, NY 10006

Code Consultant
Code Consultants Professional Engineers PC
215 West 40th Street, 15th Floor, New York, NY 10018

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650 Woodbine Road West, Guelph
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Key Plan:



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1 12 SEPT 2014 ISSUED FOR FOUNDATION PERMIT
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**NYC EC
COMPLIANCE
LIGHTING
LEVEL 57-58
FLOOR PLAN**

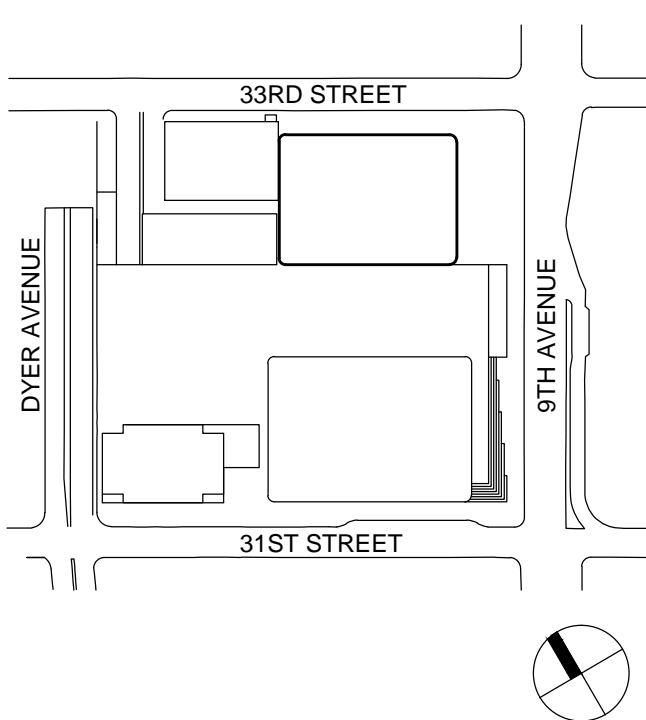Project No.:

14830.A.000

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20 JUN 2014

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MANHATTAN WEST:
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Client
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Code Consultants Professional Engineers PC
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Facade Maintenance Consultant
Entek Engineering LLC
166 Ames Street, Hackensack, NJ 07601


Wind Tunnel Consultant
Rowan Williams Davies & Irwin Inc.
650 Woodbine Road West, Guelph
Ontario, Canada N1K 1B8

Code Consultants Professional Engineers PC
215 West 40th Street, 15th Floor, New York, NY 10018


Facade Maintenance Consultant
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PROFESSIONAL ENERGY STATEMENT
TO THE BEST OF MY KNOWLEDGE, BELIEF, AND PROFESSIONAL
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No.	1	12 SEPT 2014	ISSUED FOR FOUNDATION PERMIT
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NYC EC
COMPLIANCE
LIGHTING
LEVEL 62
FLOOR PLAN

Project No.:	14830.A.000	B-SCAN Sheet No.:	EN-132.00
Date:	20 JUN 2014		
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Client

Brookfield
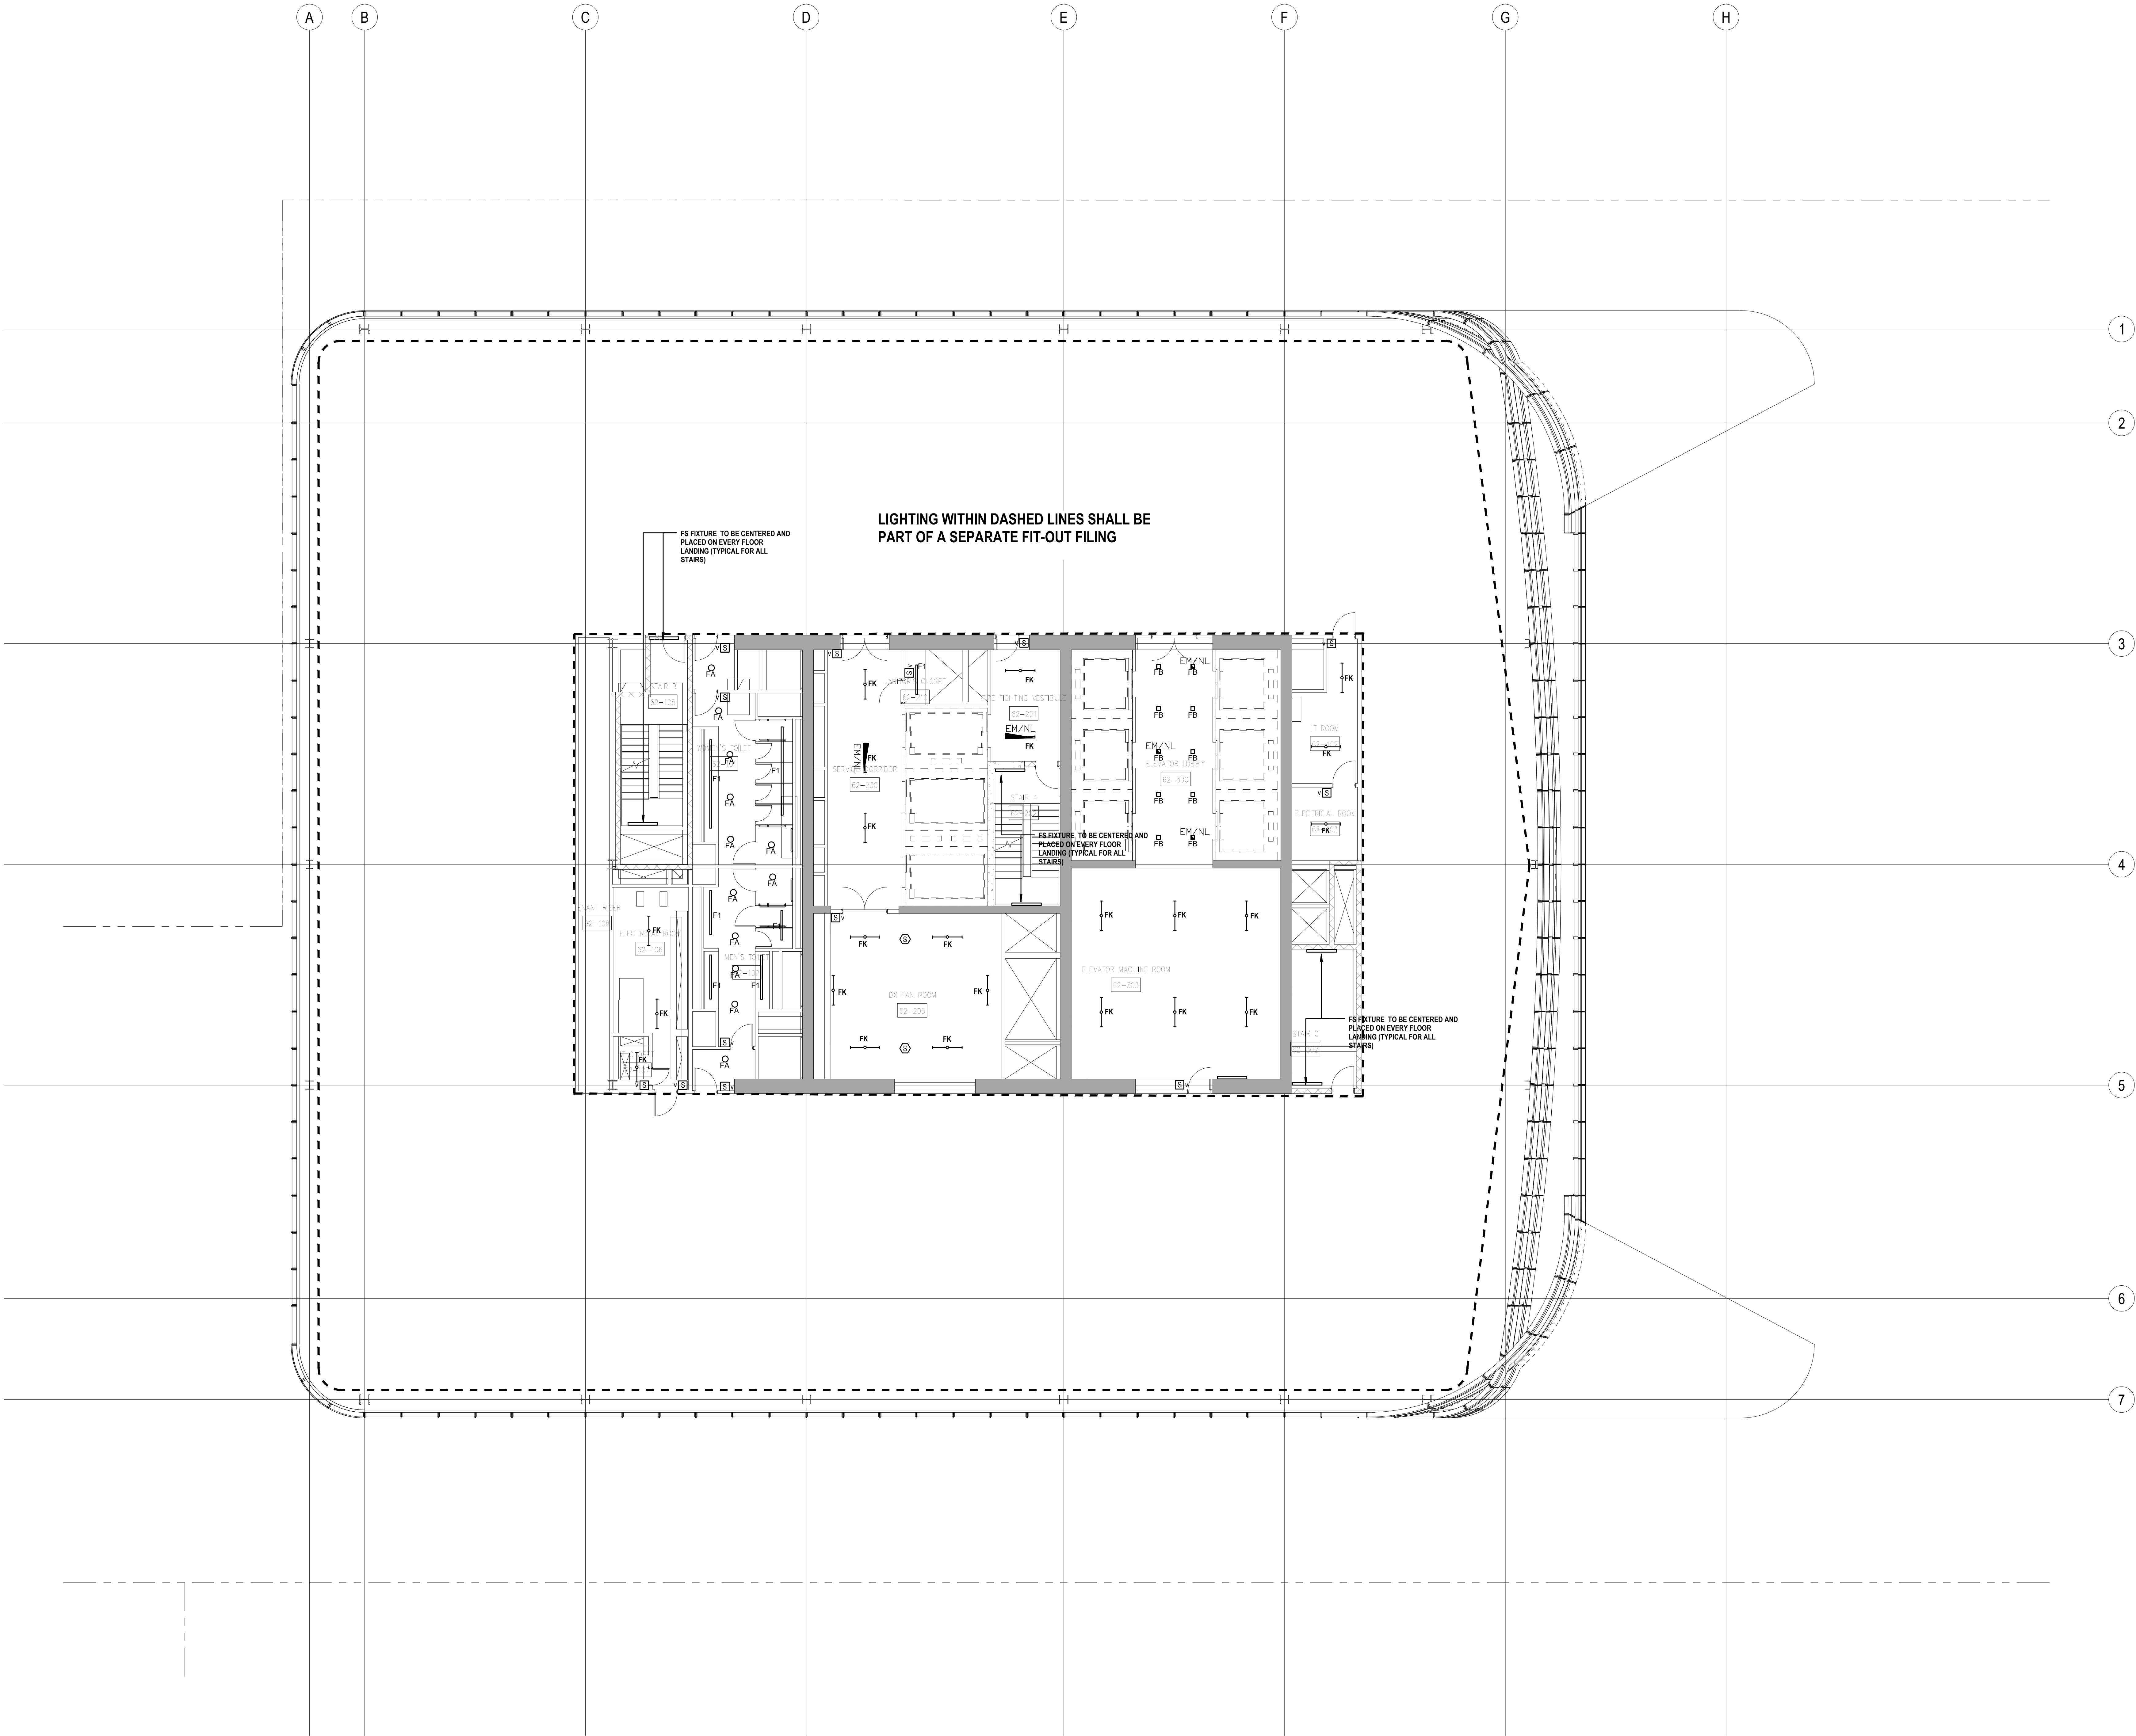
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Ducibella, Vantor & Santore
250 State Street #F1, North Haven, CT 06473

Blast Consultant
Weidinger Associates, Inc.
40 Wall Street, New York, NY 10005


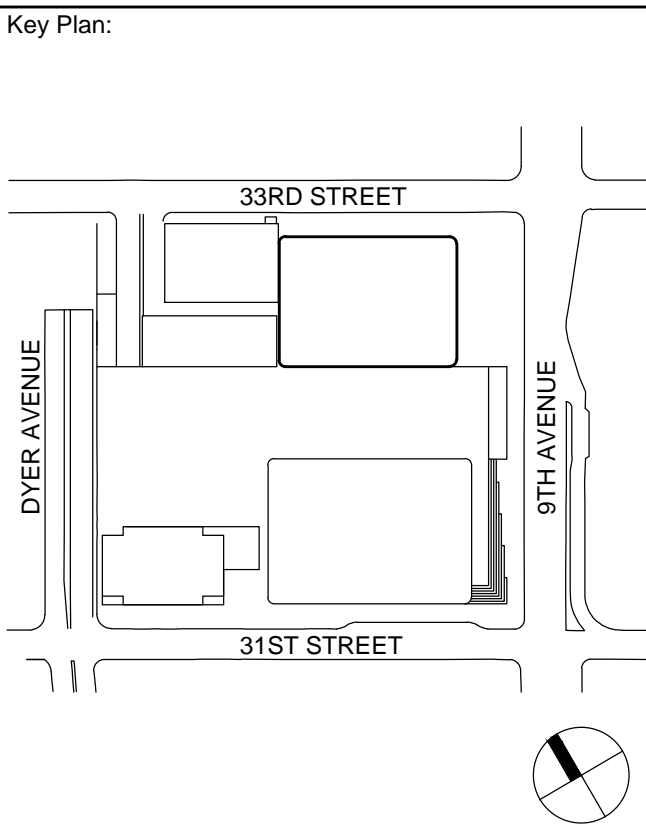
Acoustical Consultant
Cerami & Associates
404 Elm Avenue #5, New York, NY 10018

Vibration Consultant
Wilson, Uhrig & Associates, Inc.
65 Broadway, Suite 401, New York, NY 10006

Code Consultant
Code Consultants Professional Engineers PC
215 West 40th Street, 15th Floor, New York, NY 10018

Facade Maintenance Consultant
Entek Engineering LLC
166 Ames Street, Hackensack, NJ 07601

Wind Tunnel Consultant
Rowan Williams Davies & Irwin Inc.
650 Woodbine Road West, Guelph, Ontario, Canada N1K 1B8

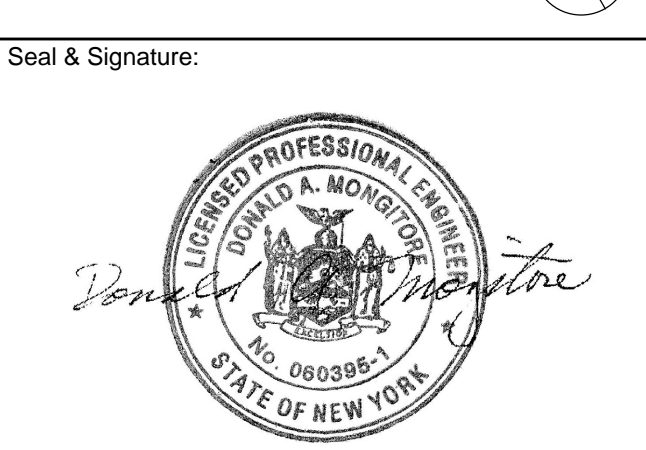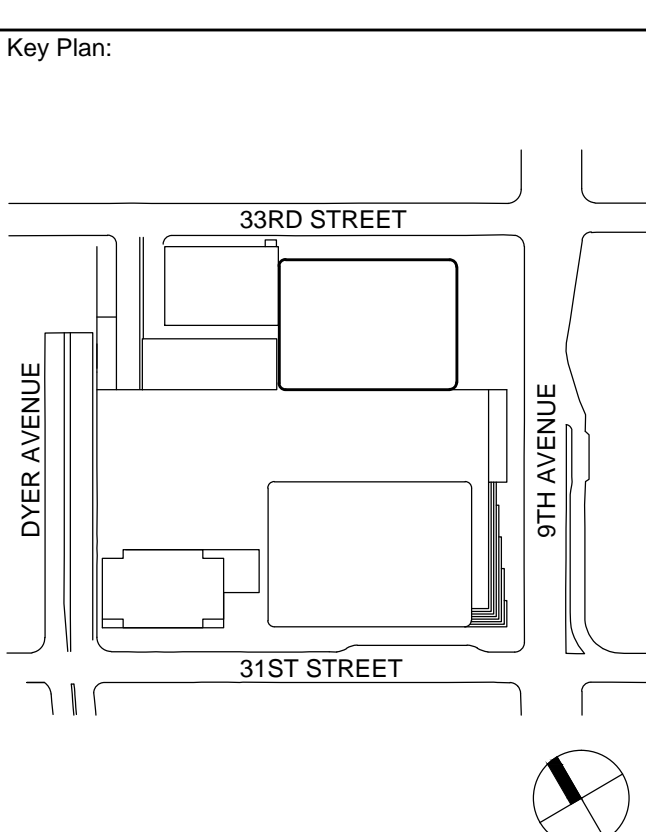


No.	Date	Description
1	12 SEPT 2014	ISSUED FOR FOUNDATION PERMIT

NYC EC
COMPLIANCE
LIGHTING
LEVEL 63
FLOOR PLAN

Project No.: 14830.A.000	B-SCAN Sheet No.: EN-133.00
Date: 20 JUN 2014	
Scale: N.T.S.	
File No.:	Page No.:

PROFESSIONAL ENERGY STATEMENT
TO THE BEST OF MY KNOWLEDGE, BELIEF, AND PROFESSIONAL JUDGEMENT, THESE PLANS AND SPECIFICATIONS ARE IN COMPLIANCE WITH THE NEW YORK CITY ENERGY CONSERVATION CODE.

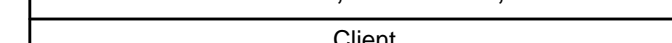

Age Group	Male (%)	Female (%)
18-24	52	48
25-34	45	55
35-44	58	42
45-54	40	60
55+	55	45

Brookfield Place
250 Vesey Street, 15th Floor, New York, NY 10281

Architecture/Structural Engineering

Skidmore, Owings & Merrill LLP
14 Wall Street, New York, NY 10005

Civil Engineering

Philip Habib & Associates
102 Madison Avenue #11, New York, NY 10016

MEP Engineering

Jaros Baum & Bolles
80 Pine Street, New York, NY 10005

Vertical Transportation

Edgett Williams Consulting Group, Inc.
102 East Blithedale Ave. Suite 1, Mill Valley, California 949

Sustainable Design

Viridian Energy & Environmental
50 Washington Street, Norwalk, CT 06854

Geo-Technical Engineering

Mueser Rutledge Consulting Engineers
14 Penn Plaza, 225 W. 34th Street #610,
New York, NY 10122

Landscape Consultation

Field Operations
475 10th Avenue, New York, NY 10018

Security Consultant

Ducibella, Vantor & Santore
250 State Street #F1, North Haven, CT 06473

Blast Consultant

Weidlinger Associates, Inc.
40 Wall Street, New York, NY 10005

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215 West 40th Street, 15th Floor, New York, NY 10018


Academy Maintenance Consultant

Entek Engineering LLC
166 Ames Street, Hackensack, NJ 07601

Wind Tunnel Consultants

Rowan Williams Davies & Irwin Inc.
650 Woodlawn Road West, Guelph

Key Plan

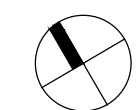

Seal & Signature



1	12 SEPT 2014	ISSUED FOR FOUNDATION PERMIT
No.	Date	Description

NYC EC
COMPLIANCE
LIGHTING
LEVEL 64-67
FLOOR PLAN

Project No.:

14830.A.00

Date: 20 JUN 201

Scale:

B-SCAN Sheet 1


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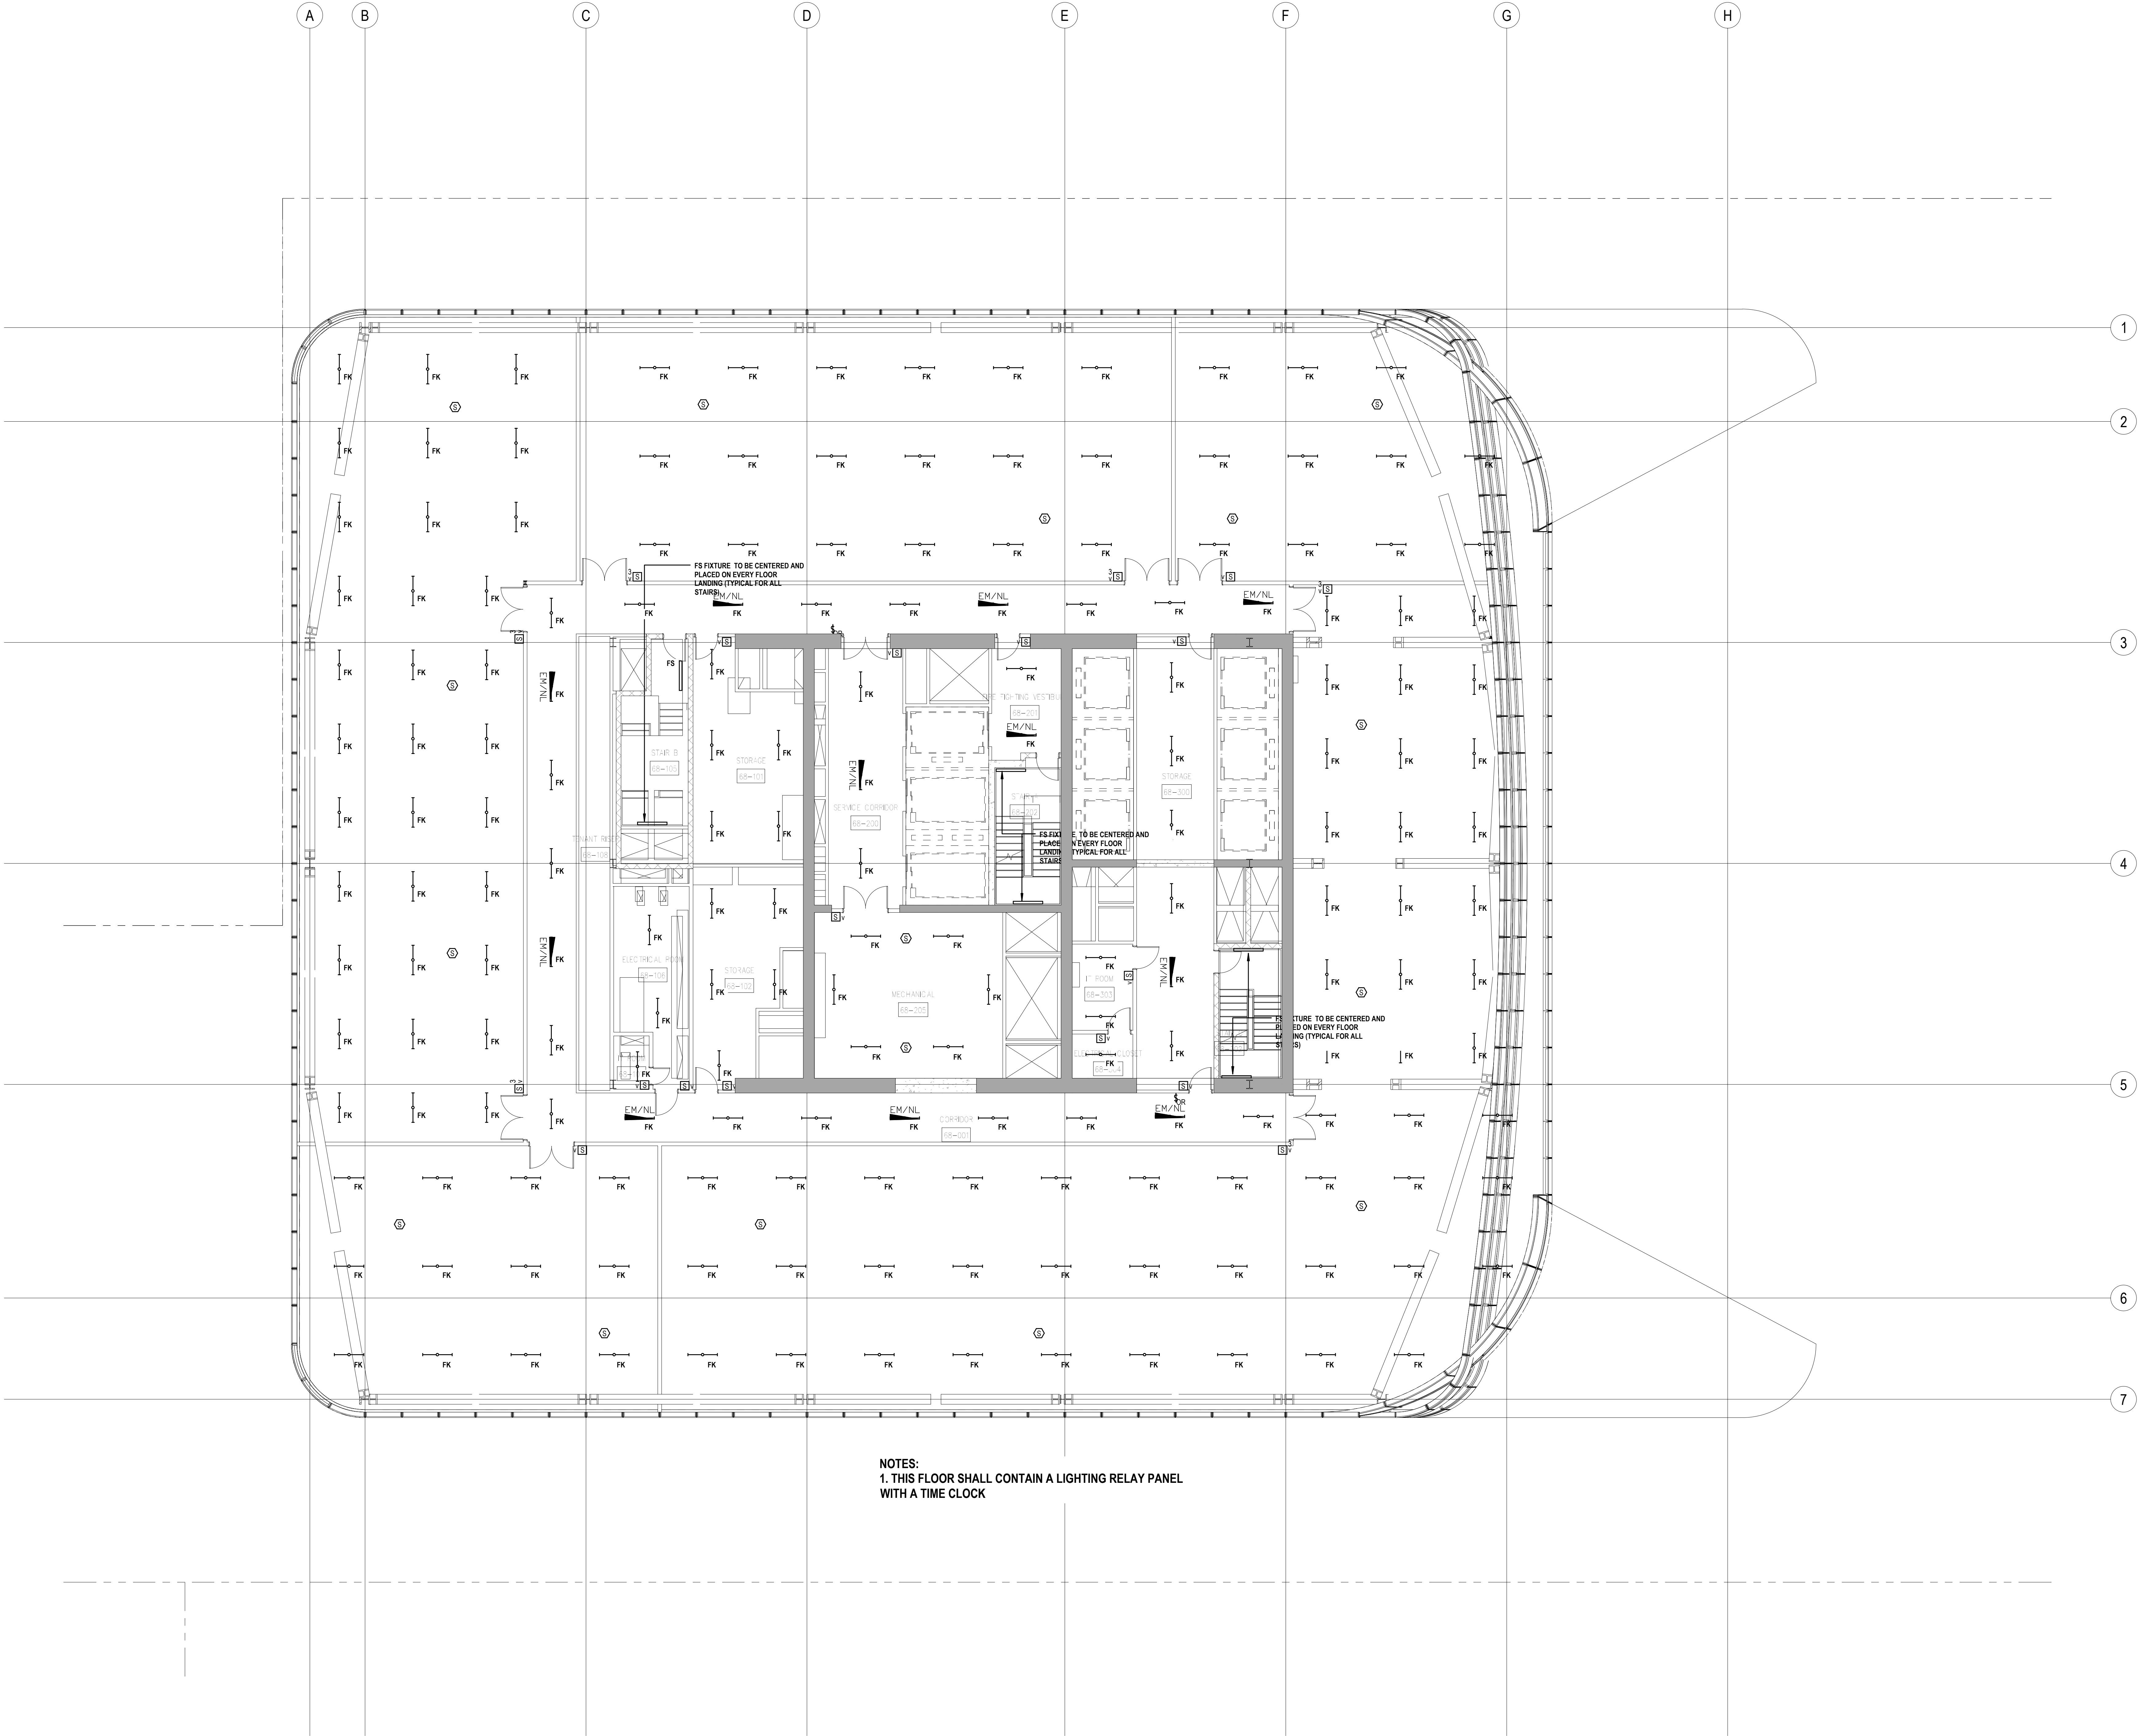
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PROFESSIONAL ENERGY STATEMENT

TO THE BEST OF MY KNOWLEDGE, BELIEF, AND PROFESSIONAL JUDGEMENT, THESE PLANS AND SPECIFICATIONS ARE IN COMPLIANCE WITH THE NEW YORK CITY ENERGY



SHEET NOTES

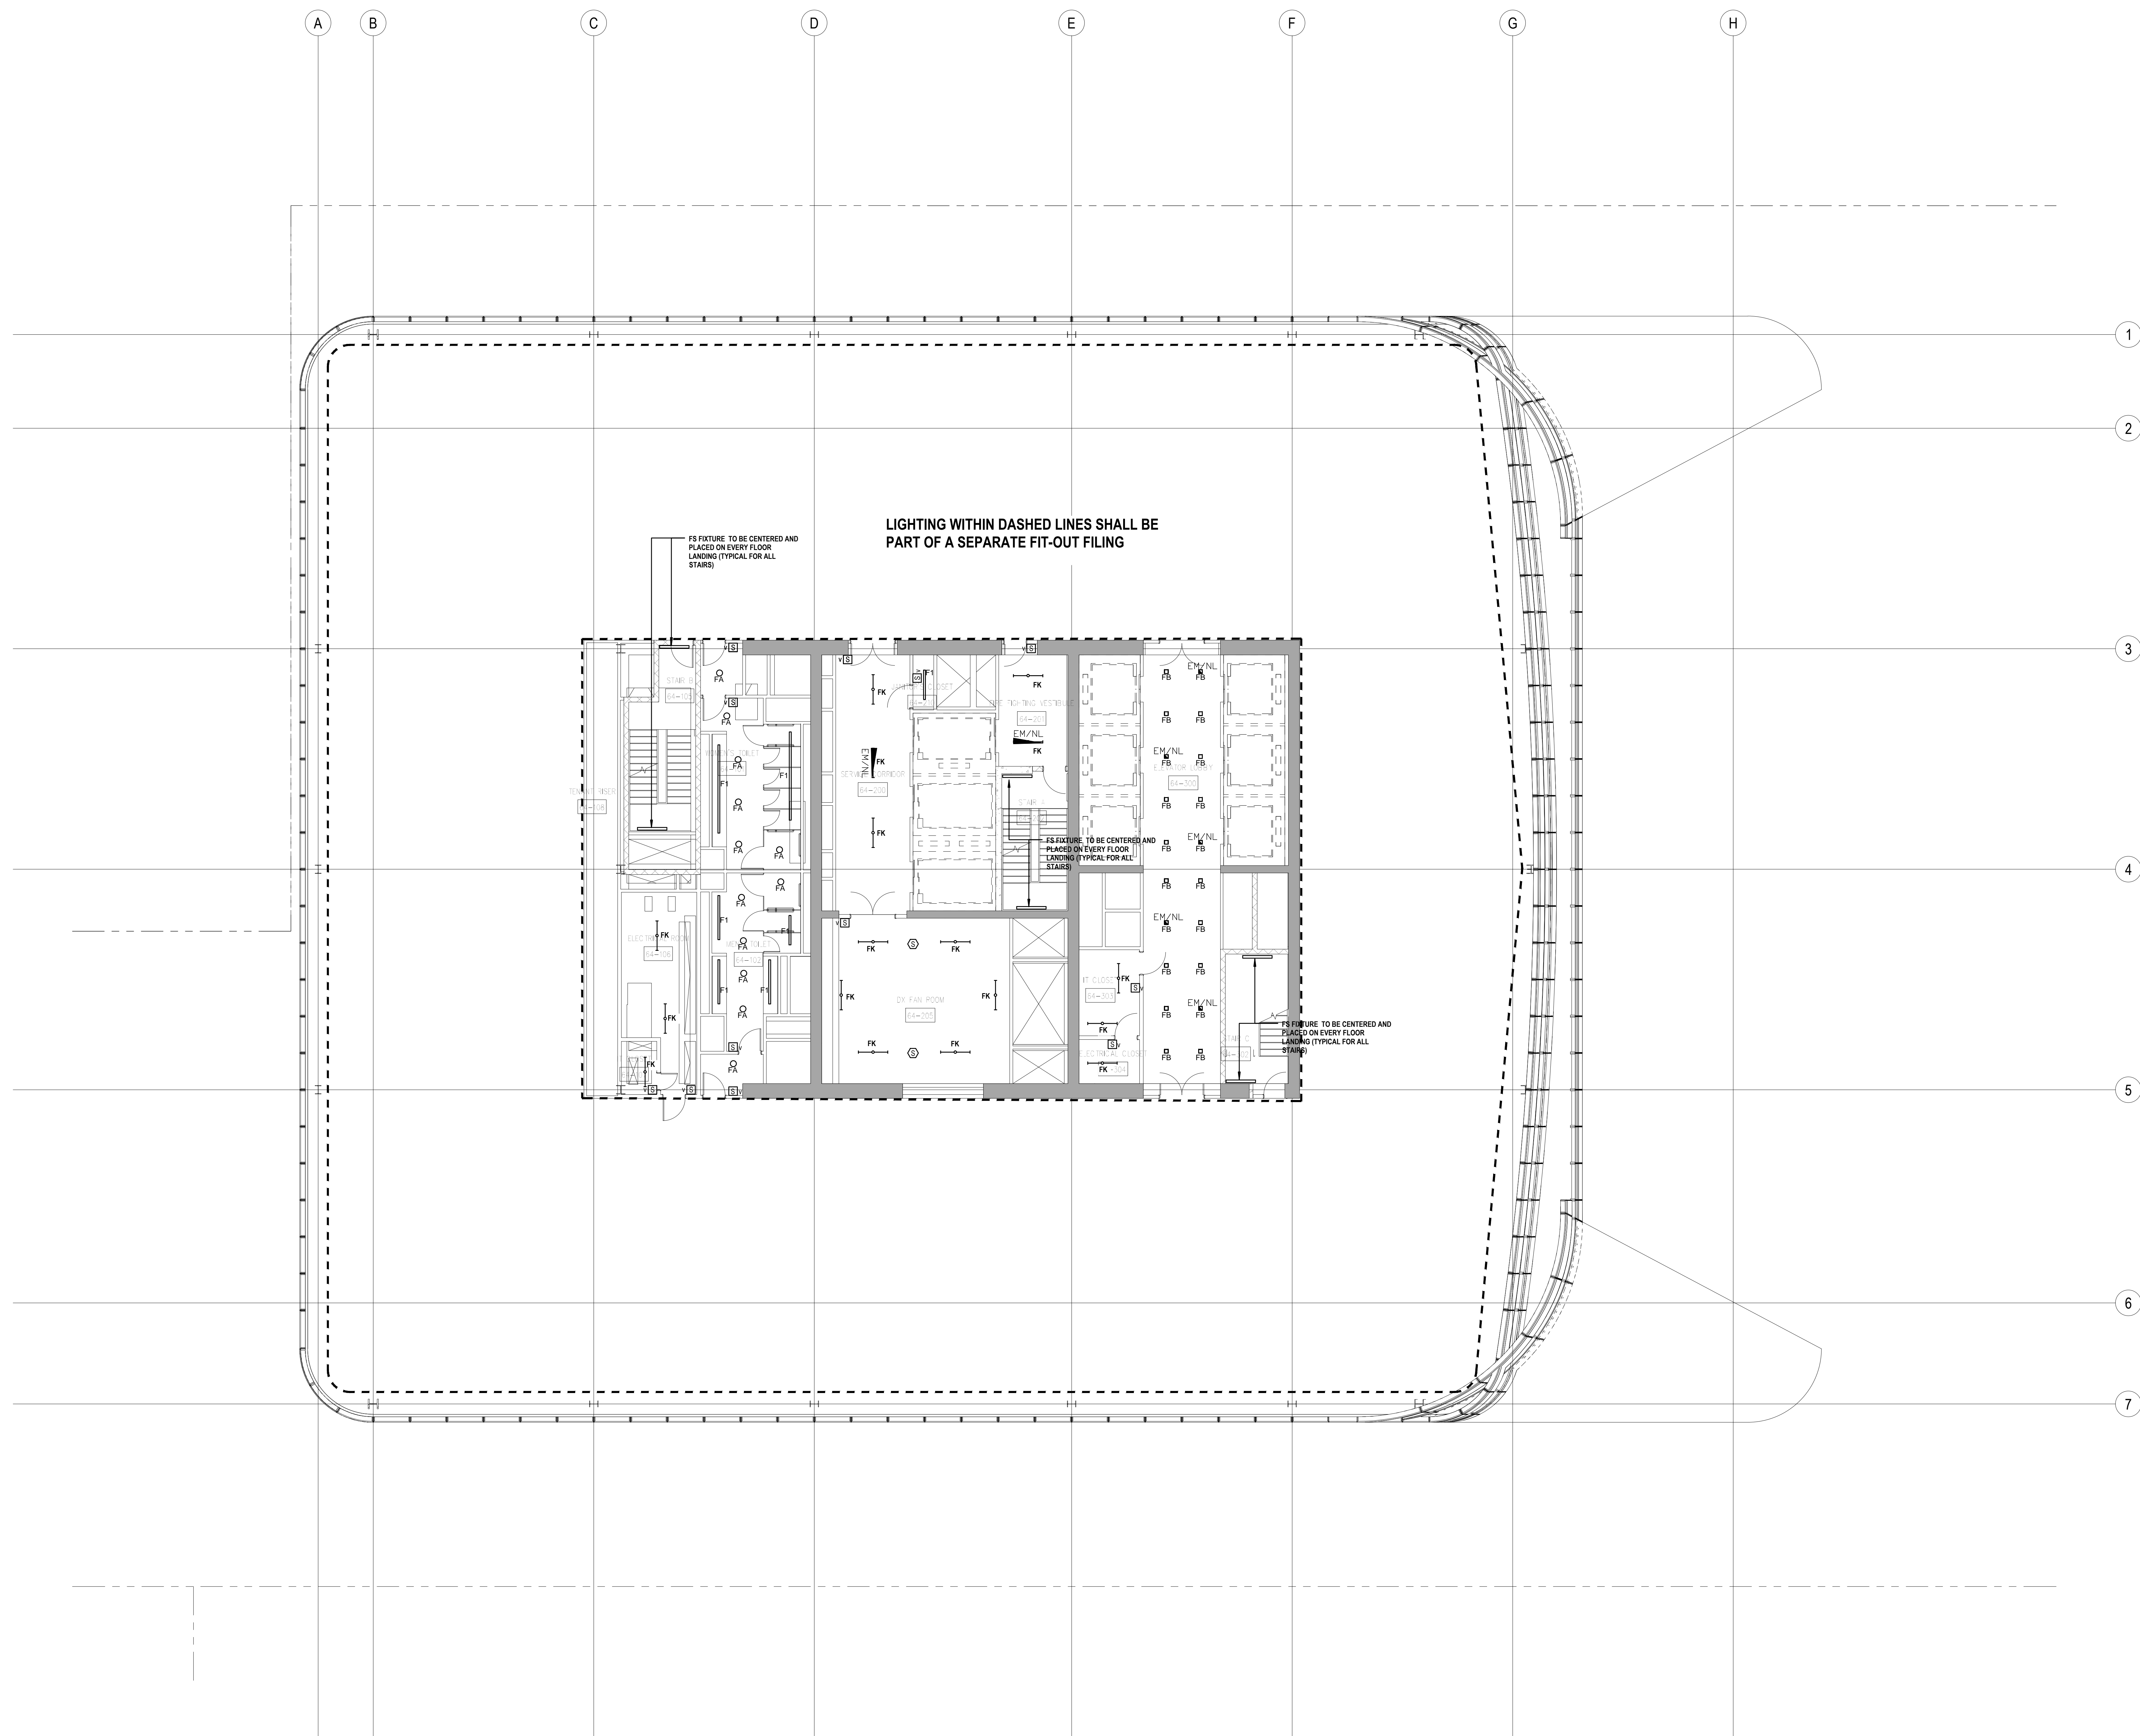

NOTES:
1. THIS FLOOR SHALL CONTAIN A LIGHTING RELAY PANEL
WITH A TIME CLOCK

PROFESSIONAL ENERGY STATEMENT
TO THE BEST OF MY KNOWLEDGE, BELIEF, AND PROFESSIONAL
JUDGEMENT, THESE PLANS AND SPECIFICATIONS ARE IN
COMPLIANCE WITH THE NEW YORK CITY ENERGY
CONSERVATION CODE.

MANHATTAN WEST:
NORTH TOWER
375 Ninth Avenue, New York, NY 10001

Client
Brookfield
Brookfield Place
250 Vesey Street, 15th Floor, New York, NY 10281

Architecture/Structural Engineering
SOM
Skidmore, Owings & Merrill LLP
14 Wall Street, New York, NY 10005

Civil Engineering
Philip Habib & Associates
102 Madison Avenue #11, New York, NY 10016

MEP Engineering
Jaros Baum & Bolles
80 Pine Street, New York, NY 10005

Vertical Transportation
Edgett Williams Consulting Group, Inc.
102 East Blithedale Ave. Suite 1, Mill Valley, California 94941

Sustainable Design
Viridian Energy & Environmental
50 Washington Street, Norwalk, CT 06854

Geo-Technical Engineering
Mueser Rutledge Consulting Engineers
14 Penn Plaza, 225 W. 34th Street #610,
New York, NY 10122

Landscape Consultant
Field Operations
475 10th Avenue, New York, NY 10018

Security Consultant
Ducibella, Vantor & Santore
250 State Street #F1, North Haven, CT 06473

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166 Ames Street, Hackensack, NJ 07601

Wind Tunnel Consultant
Rowan Williams Davies & Irwin Inc.
650 Woodbine Road West, Guelph
Ontario, Canada N1K 1B6

Key Plan:

Seal & Signature:

No.	1	12 SEPT 2014	ISSUED FOR FOUNDATION PERMIT
Date			
Description			
Sheet Name:			

NYC EC
COMPLIANCE
LIGHTING
LEVEL 68
FLOOR PLAN

Project No.:	B-SCAN Sheet No.:
14830-A.000	
Date:	20 JUN 2014
Scale:	N.T.S.
File No.:	Page No.:

EN-135.00

SHEET NOTES



Client
Brookfield

Brookfield Place
250 Vesey Street, 15th Floor, New York, NY 10281

Architecture/Structural Engineering

SOM
Skidmore, Owings & Merrill LLP
14 Wall Street, New York, NY 10005

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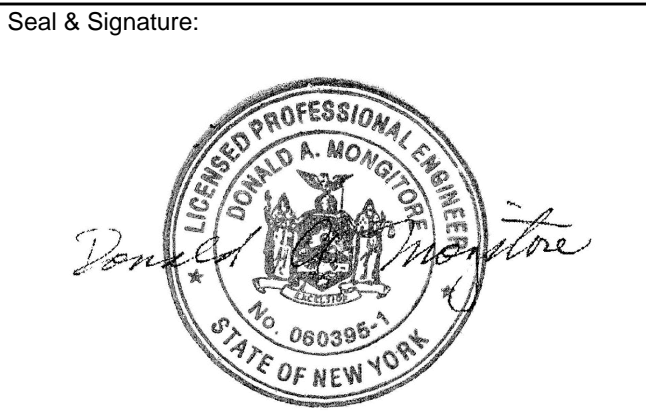
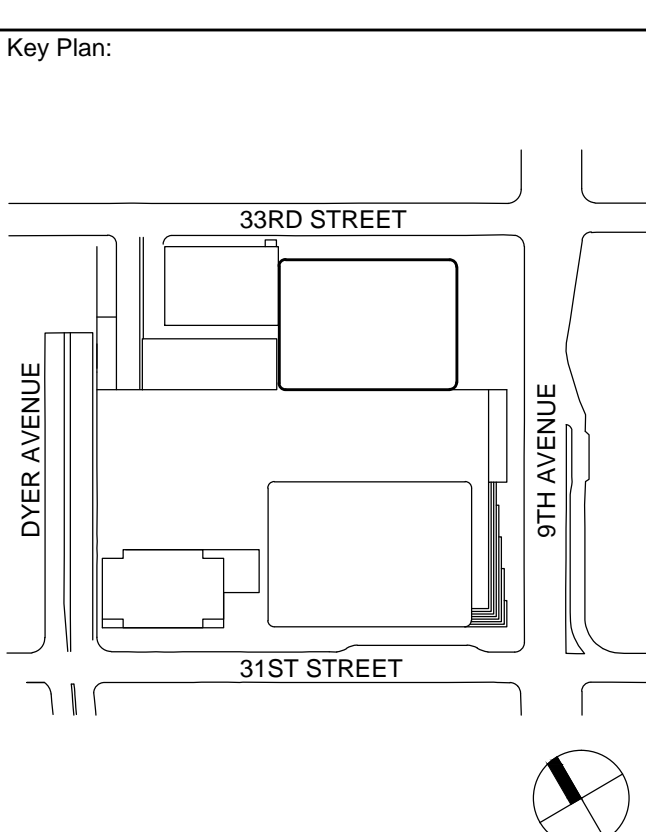
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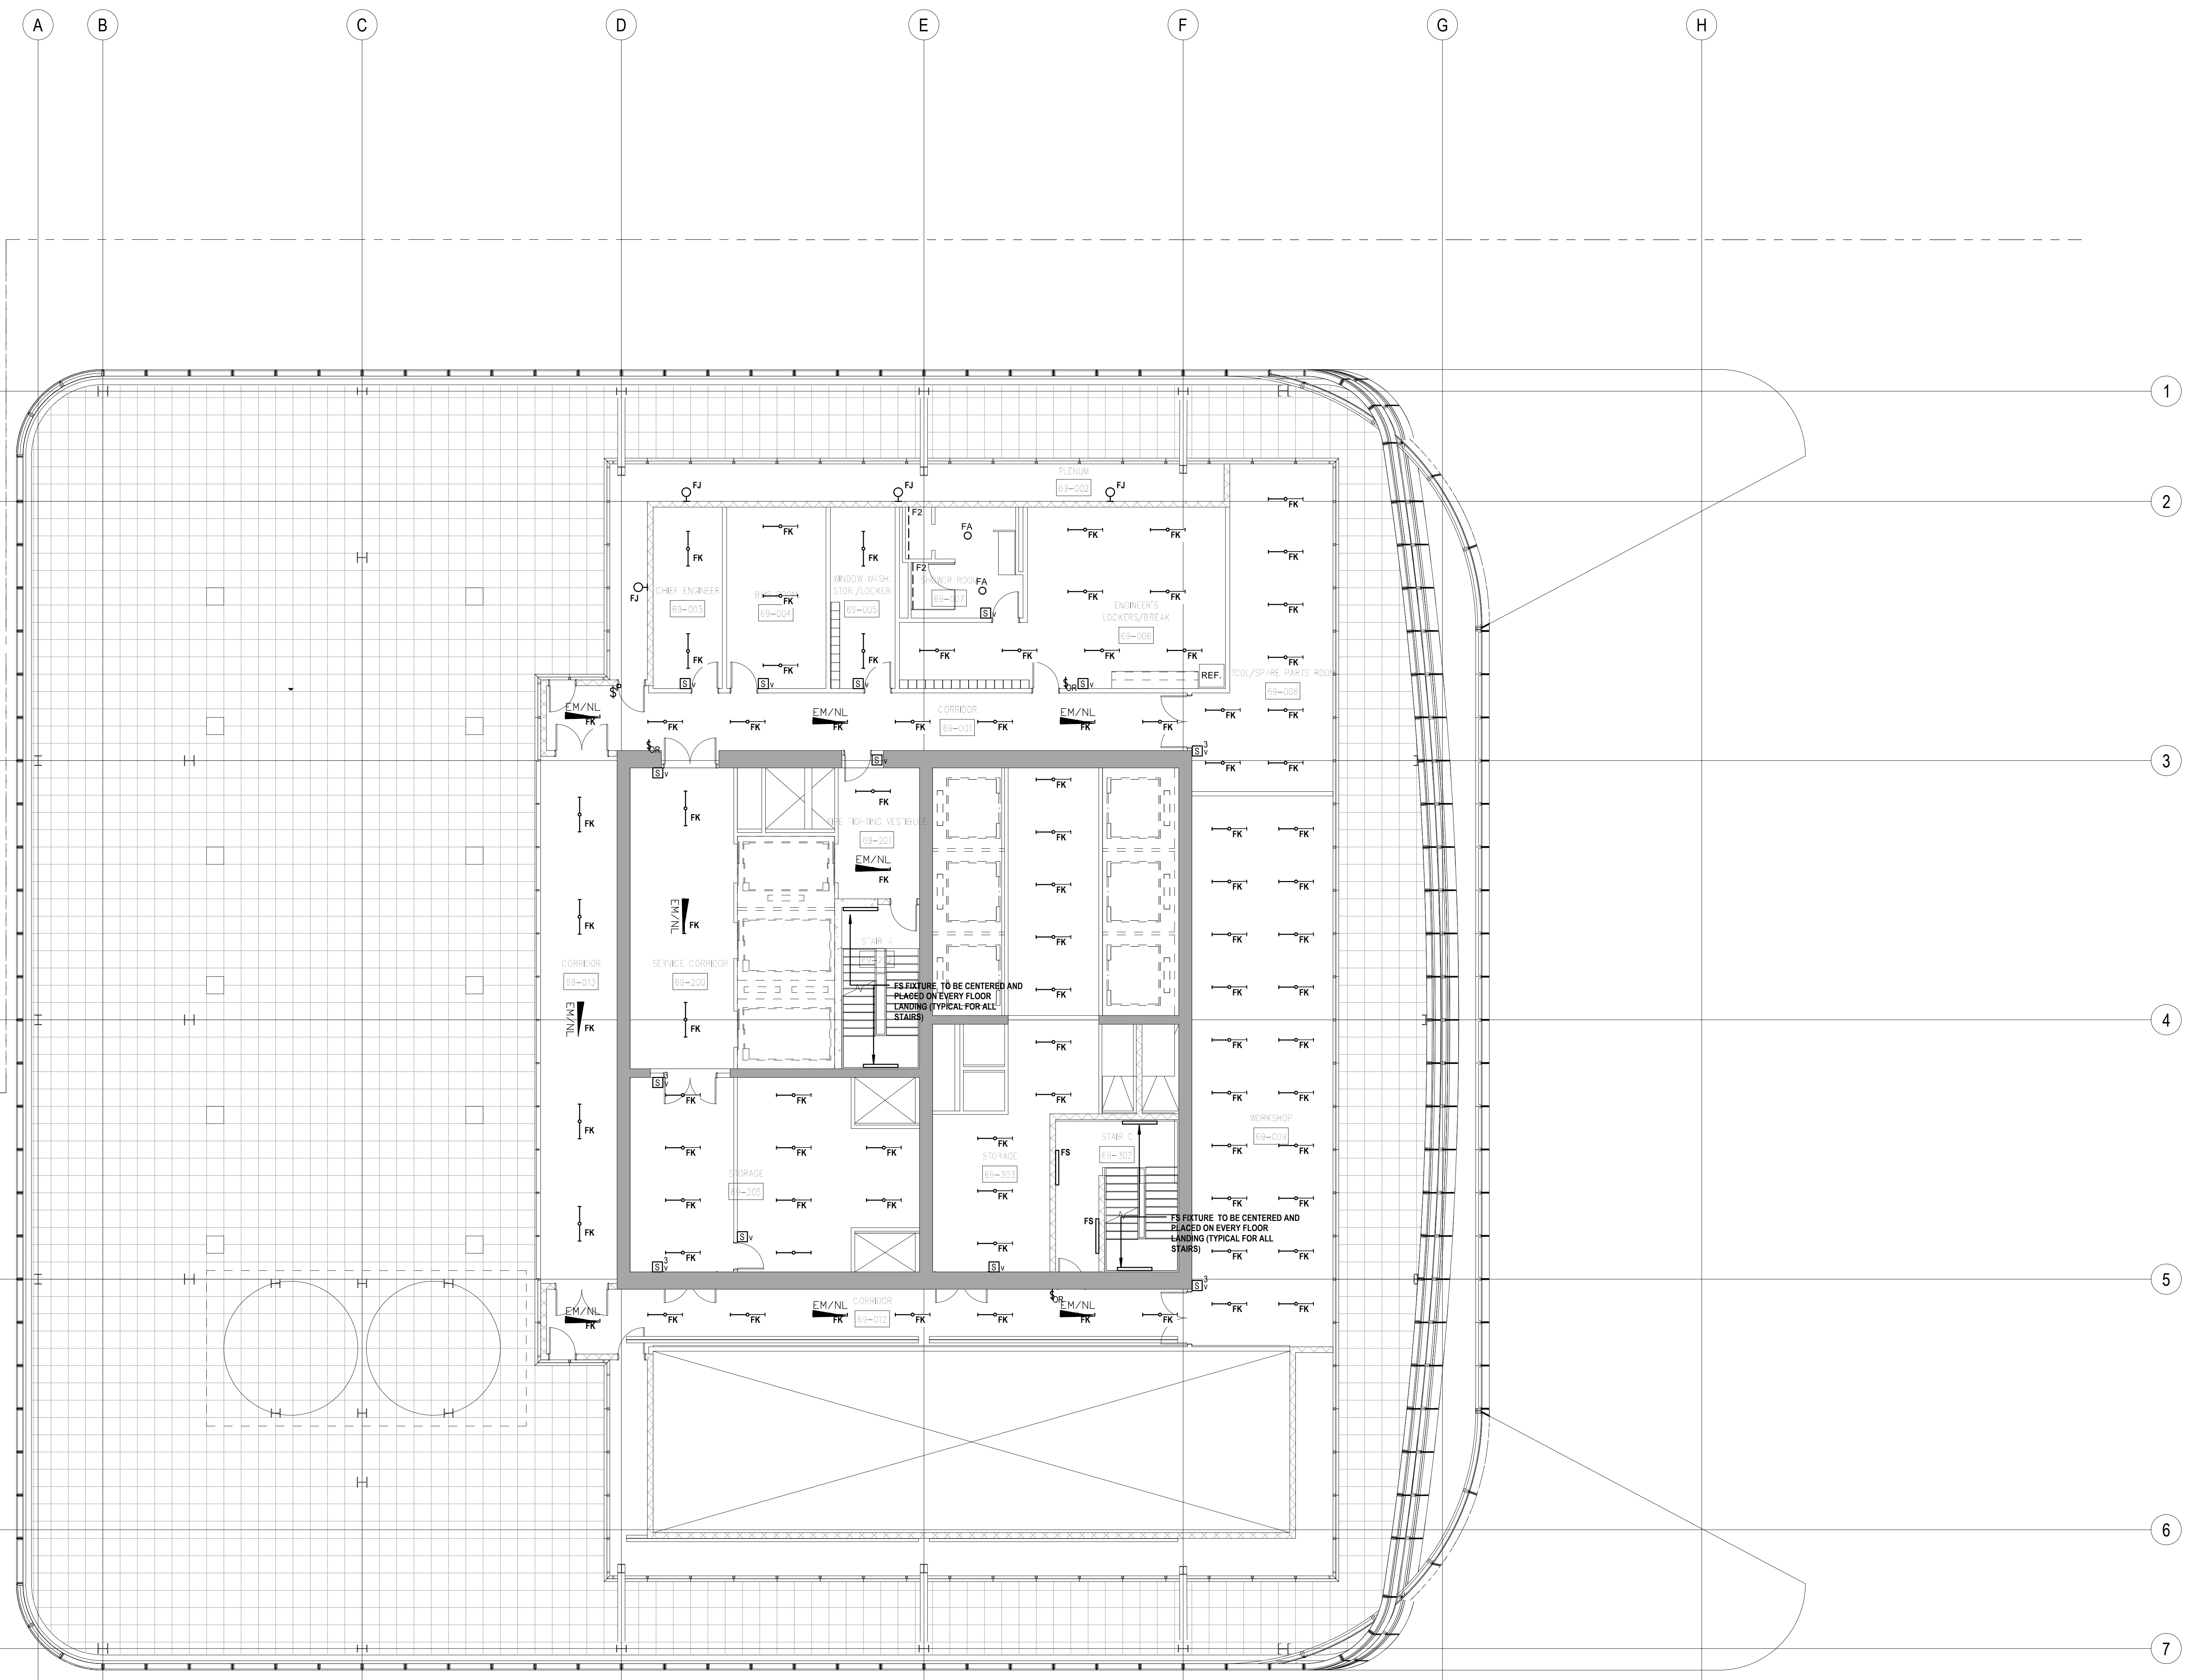
No.	Date	Description
1	12 SEPT 2014	ISSUED FOR FOUNDATION PERMIT

NYC EC
COMPLIANCE
LIGHTING
LEVEL 69
FLOOR PLAN

Project No.: 14830.A.000	B-SCAN Sheet No.: EN-136.00
Date: 20 JUN 2014	
Scale: N.T.S.	
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PROFESSIONAL ENERGY STATEMENT
TO THE BEST OF MY KNOWLEDGE, BELIEF, AND PROFESSIONAL JUDGEMENT, THESE PLANS AND SPECIFICATIONS ARE IN COMPLIANCE WITH THE NEW YORK CITY ENERGY CONSERVATION CODE.

NOTES:
1. THIS FLOOR SHALL CONTAIN A LIGHTING RELAY PANEL WITH A TIME CLOCK



SHEET NOTES



MANHATTAN WEST:
NORTH TOWER
375 Ninth Avenue, New York, NY 10001

Client

Brookfield

Brookfield Plaza
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Architecture/Structural Engineering

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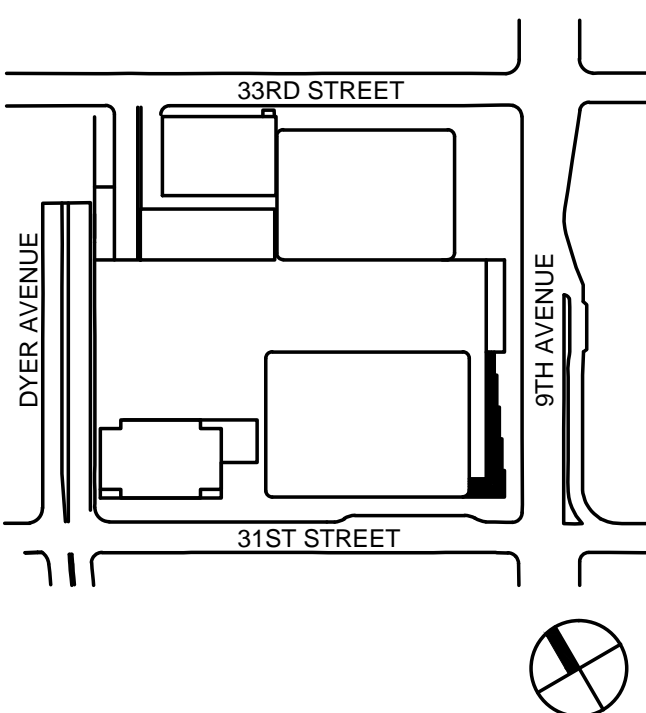
Facade Maintenance Consultant

Entek Engineering LLC
166 Ames Street, Hackensack, NJ 07601


Wind Tunnel Consultant

Rowan Williams Davies & Irwin Inc.
650 Woodlawn Road West, Guelph
Ontario, Canada N1K 1B5

Key Plan:



Seal & Signature:

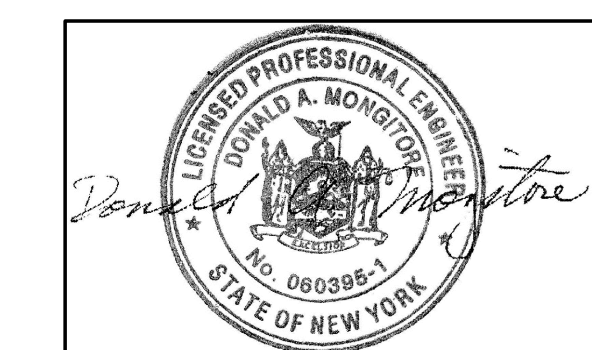

No.	Date	Description
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NYC EC
COMPLIANCE
LIGHTING
SYSTEM
CONTROLS
SHEET NO. 1

Project No.:

14830.A.000

Date:

20 JUN 2014

Scale:

N.T.S.

File No.:

B-SCAN Sheet No.:

EN-139.00

Date:

20 JUN 2014

Scale:

N.T.S.

Page No.:

LP-B-01#1	1	LIGHTING
LP-B-01#2	2	LIGHTING
LP-B-01#3	3	LIGHTING
LP-B-01#4	4	LIGHTING
LP-B-01#5	5	LIGHTING
LP-B-01#6	6	LIGHTING
LP-B-01#7	7	LIGHTING
LP-B-01#8	8	LIGHTING
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SPARE	11	SPARE
SPARE	12	SPARE
SPARE	13	SPARE
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SPARE	21	SPARE
SPARE	22	SPARE
SPARE	23	SPARE
SPARE	24	SPARE

SEE NOTE # 2

LIGHT SWEEP
RELAY PANEL SCHEDULE - CELLAR B

NOTES:
1. PROVIDE 24-POLE LIGHTING RELAY SYSTEM, GE LIGHT SWEEP, INCLUDE IN BID SYSTEM START-UP AND COMMISSIONING BY GE REPRESENTATIVE.
2. TIE IN 2 LOW VOLTAGE OVERRIDE SWITCHES TO LIGHTING CONTROL SYSTEM
3. RELAY PANEL SHALL CONTAIN TIME CLOCK TO AUTOMATICALLY TURN OFF ALL THE LIGHTS.

LP-3-01#1	1	LIGHTING
LP-3-01#2	2	LIGHTING
LP-3-01#3	3	LIGHTING
LP-3-01#4	4	LIGHTING
LP-3-01#5	5	LIGHTING
LP-3-01#6	6	LIGHTING
LP-3-01#7	7	LIGHTING
LP-3-01#8	8	LIGHTING
LP-3-01#9	9	LIGHTING
LP-3-01#10	10	LIGHTING
SPARE	11	SPARE
SPARE	12	SPARE
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SPARE	21	SPARE
SPARE	22	SPARE
SPARE	23	SPARE
SPARE	24	SPARE

SEE NOTE # 2

LIGHT SWEEP
RELAY PANEL SCHEDULE - LEVEL 3

NOTES:
1. PROVIDE 24-POLE LIGHTING RELAY SYSTEM, GE LIGHT SWEEP, INCLUDE IN BID SYSTEM START-UP AND COMMISSIONING BY GE REPRESENTATIVE.
2. TIE IN 2 LOW VOLTAGE OVERRIDE SWITCHES TO LIGHTING CONTROL SYSTEM
3. RELAY PANEL SHALL CONTAIN TIME CLOCK TO AUTOMATICALLY TURN OFF ALL THE LIGHTS.

LP-4-01#1	1	LIGHTING
LP-4-01#2	2	LIGHTING
LP-4-01#3	3	LIGHTING
LP-4-01#4	4	LIGHTING
LP-4-01#5	5	LIGHTING
LP-4-01#6	6	LIGHTING
LP-4-01#7	7	LIGHTING
LP-4-01#8	8	LIGHTING
LP-4-01#9	9	LIGHTING
LP-4-01#10	10	LIGHTING
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SPARE	12	SPARE
SPARE	13	SPARE
SPARE	14	SPARE
SPARE	15	SPARE
SPARE	16	SPARE
SPARE	17	SPARE
SPARE	18	SPARE
SPARE	19	SPARE
SPARE	20	SPARE
SPARE	21	SPARE
SPARE	22	SPARE
SPARE	23	SPARE
SPARE	24	SPARE

SEE NOTE # 2

LIGHT SWEEP
RELAY PANEL SCHEDULE - LEVEL 4

NOTES:
1. PROVIDE 24-POLE LIGHTING RELAY SYSTEM, GE LIGHT SWEEP, INCLUDE IN BID SYSTEM START-UP AND COMMISSIONING BY GE REPRESENTATIVE.
2. TIE IN 2 LOW VOLTAGE OVERRIDE SWITCHES TO LIGHTING CONTROL SYSTEM
3. RELAY PANEL SHALL CONTAIN TIME CLOCK TO AUTOMATICALLY TURN OFF ALL THE LIGHTS.

LP-5-01#1	1	LIGHTING
LP-5-01#2	2	LIGHTING
LP-5-01#3	3	LIGHTING
LP-5-01#4	4	LIGHTING
LP-5-01#5	5	LIGHTING
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SPARE	19	SPARE
SPARE	20	SPARE
SPARE	21	SPARE
SPARE	22	SPARE
SPARE	23	SPARE
SPARE	24	SPARE

SEE NOTE # 2

LIGHT SWEEP
RELAY PANEL SCHEDULE - LEVEL 5

NOTES:
1. PROVIDE 24-POLE LIGHTING RELAY SYSTEM, GE LIGHT SWEEP, INCLUDE IN BID SYSTEM START-UP AND COMMISSIONING BY GE REPRESENTATIVE.
2. TIE IN 2 LOW VOLTAGE OVERRIDE SWITCHES TO LIGHTING CONTROL SYSTEM
3. RELAY PANEL SHALL CONTAIN TIME CLOCK TO AUTOMATICALLY TURN OFF ALL THE LIGHTS.

LP-68-01#1	1	LIGHTING
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LP-68-01#4	4	LIGHTING
LP-68-01#5	5	LIGHTING
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SPARE	11	SPARE
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SPARE	21	SPARE
SPARE	22	SPARE
SPARE	23	SPARE
SPARE	24	SPARE

SEE NOTE # 2

LIGHT SWEEP
RELAY PANEL SCHEDULE - LEVEL 68

NOTES:
1. PROVIDE 24-POLE LIGHTING RELAY SYSTEM, GE LIGHT SWEEP, INCLUDE IN BID SYSTEM START-UP AND COMMISSIONING BY GE REPRESENTATIVE.
2. TIE IN 2 LOW VOLTAGE OVERRIDE SWITCHES TO LIGHTING CONTROL SYSTEM
3. RELAY PANEL SHALL CONTAIN TIME CLOCK TO AUTOMATICALLY TURN OFF ALL THE LIGHTS.



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LP-69-01#4	4	LIGHTING
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LP-69-01#8	8	LIGHTING
LP-69-01#9	9	LIGHTING
LP-69-01#10	10	LIGHTING
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SPARE	12	SPARE
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SPARE	14	SPARE
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SEE NOTE # 2

LIGHT SWEEP
RELAY PANEL SCHEDULE - LEVEL 69


NOTES:
1. PROVIDE 24-POLE LIGHTING RELAY SYSTEM, GE LIGHT SWEEP, INCLUDE IN BID SYSTEM START-UP AND COMMISSIONING BY GE REPRESENTATIVE.
2. TIE IN 2 LOW VOLTAGE OVERRIDE SWITCHES TO LIGHTING CONTROL SYSTEM
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PROFESSIONAL ENERGY STATEMENT
TO THE BEST OF MY KNOWLEDGE, BELIEF, AND PROFESSIONAL JUDGEMENT, THESE PLANS AND SPECIFICATIONS ARE IN COMPLIANCE WITH THE NEW YORK CITY ENERGY CONSERVATION CODE.



- NOTES:
1. ALL WIRING SHALL BE IN CONDUIT.
 2. DIAGRAM IS SCHEMATIC TO INDICATE DESIGN INTENT. COORDINATE EXACT WIRING REQUIREMENTS WITH EQUIPMENT VENDOR.
 3. COORDINATE EXACT LOCATION OF DEVICE WITH ARCHITECT AND FIELD CONDITIONS.
 4. WIRING DIAGRAM SHOWN TYPICAL FOR OCCUPANCY SENSORS LOCATED IN CORRIDOR.

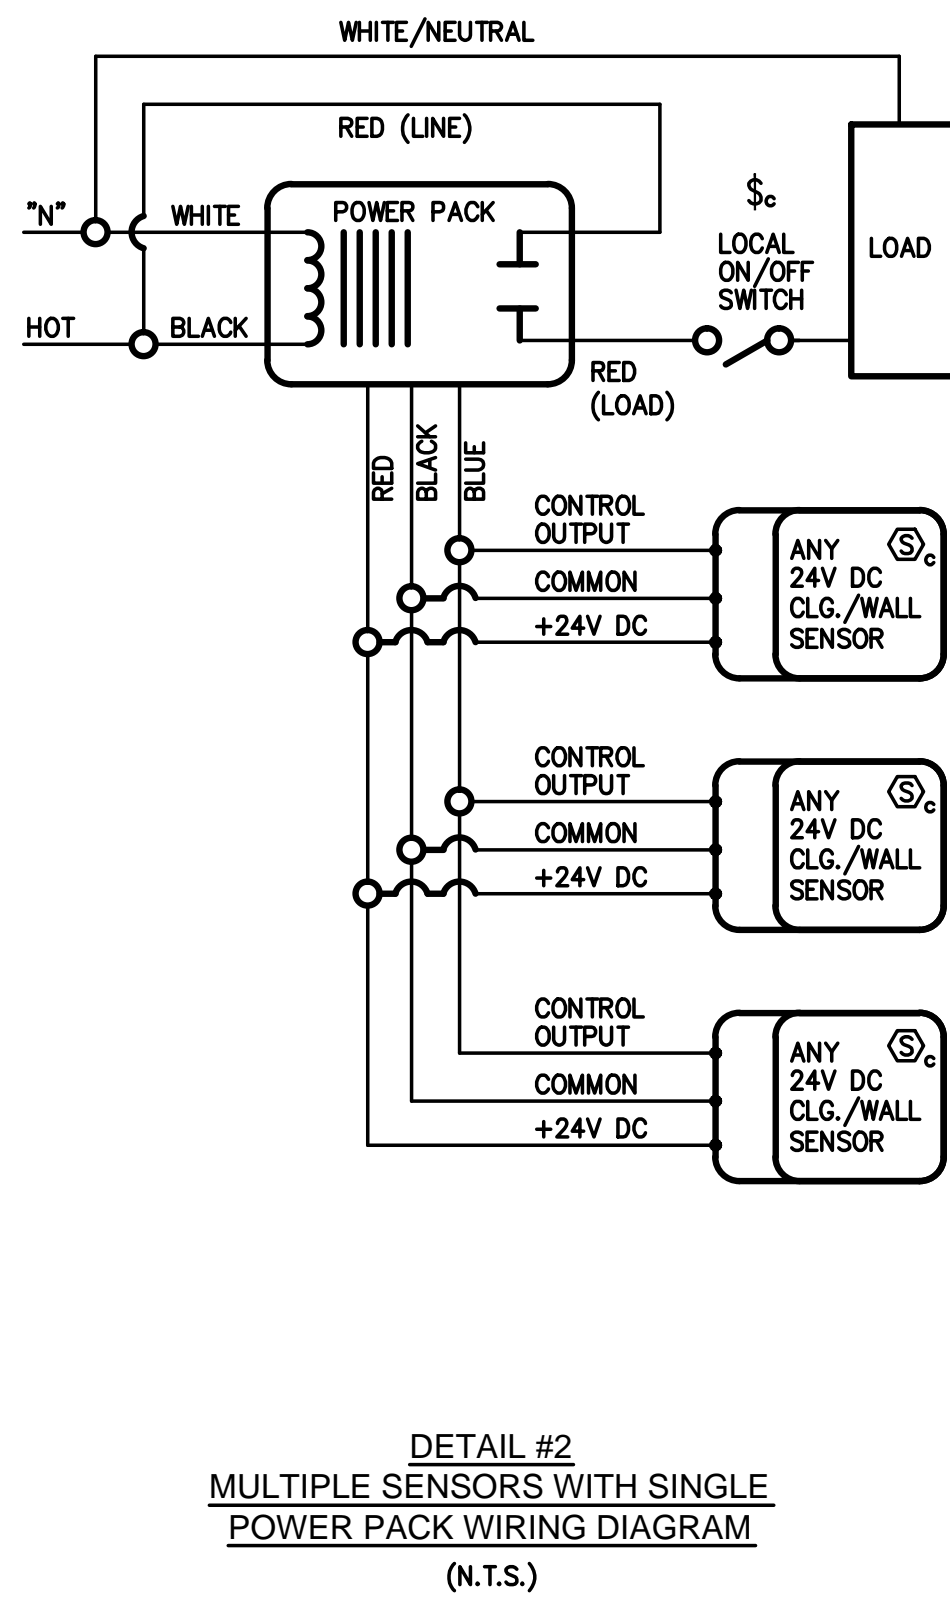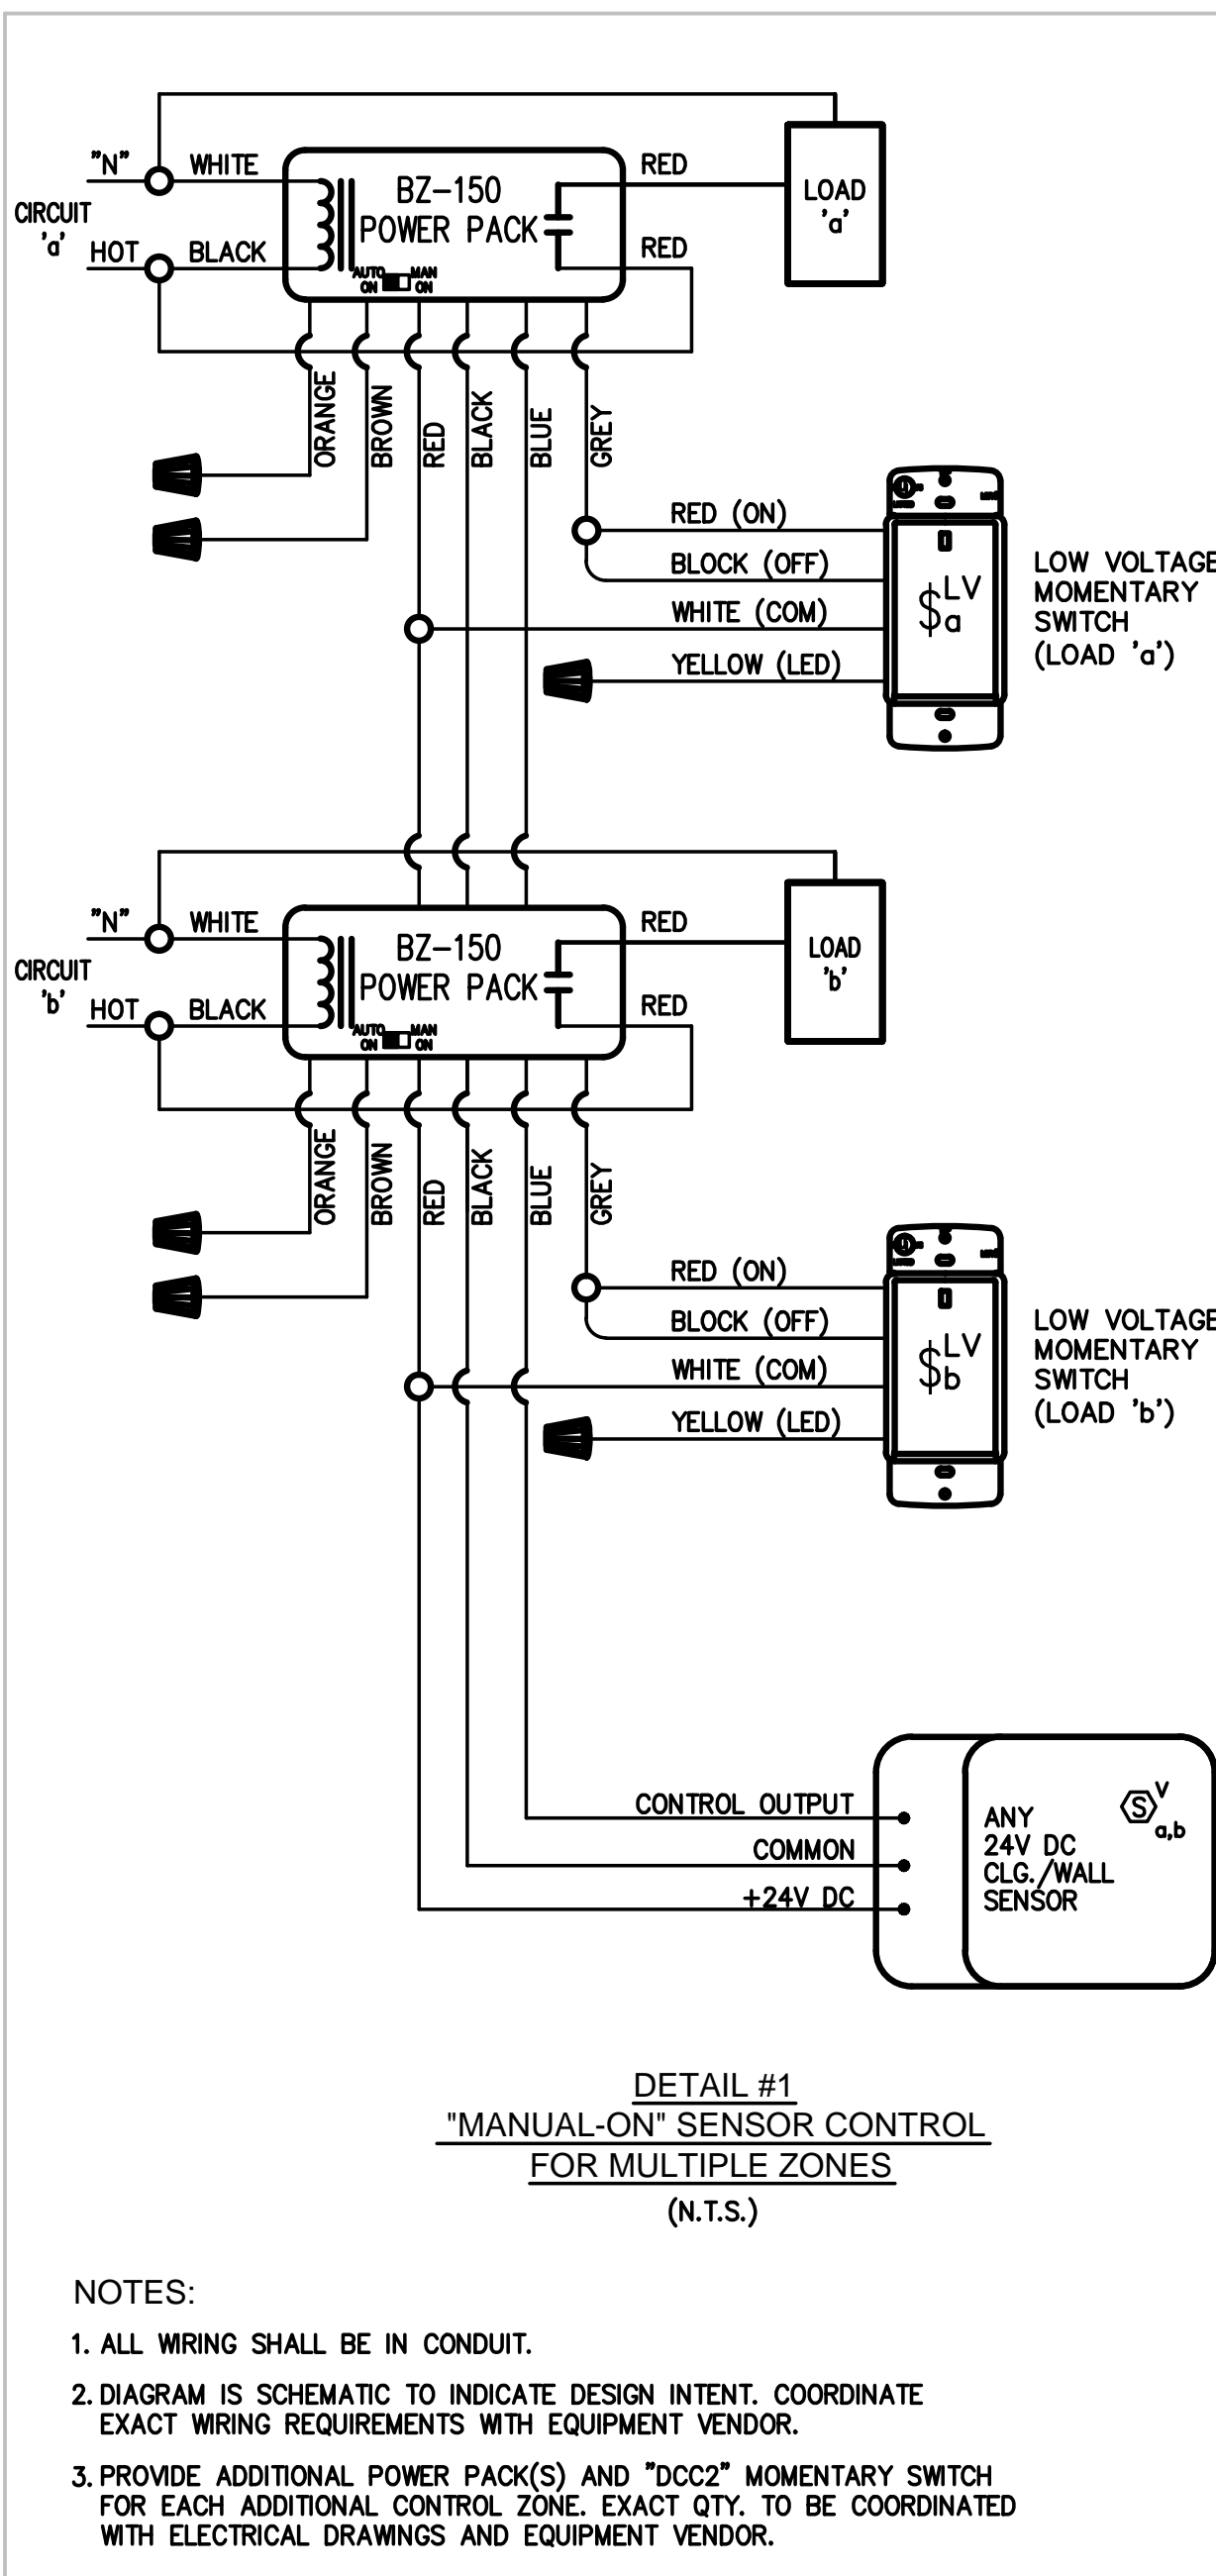LOBBY (GROUND FLOOR) DIMMING CONTROLS

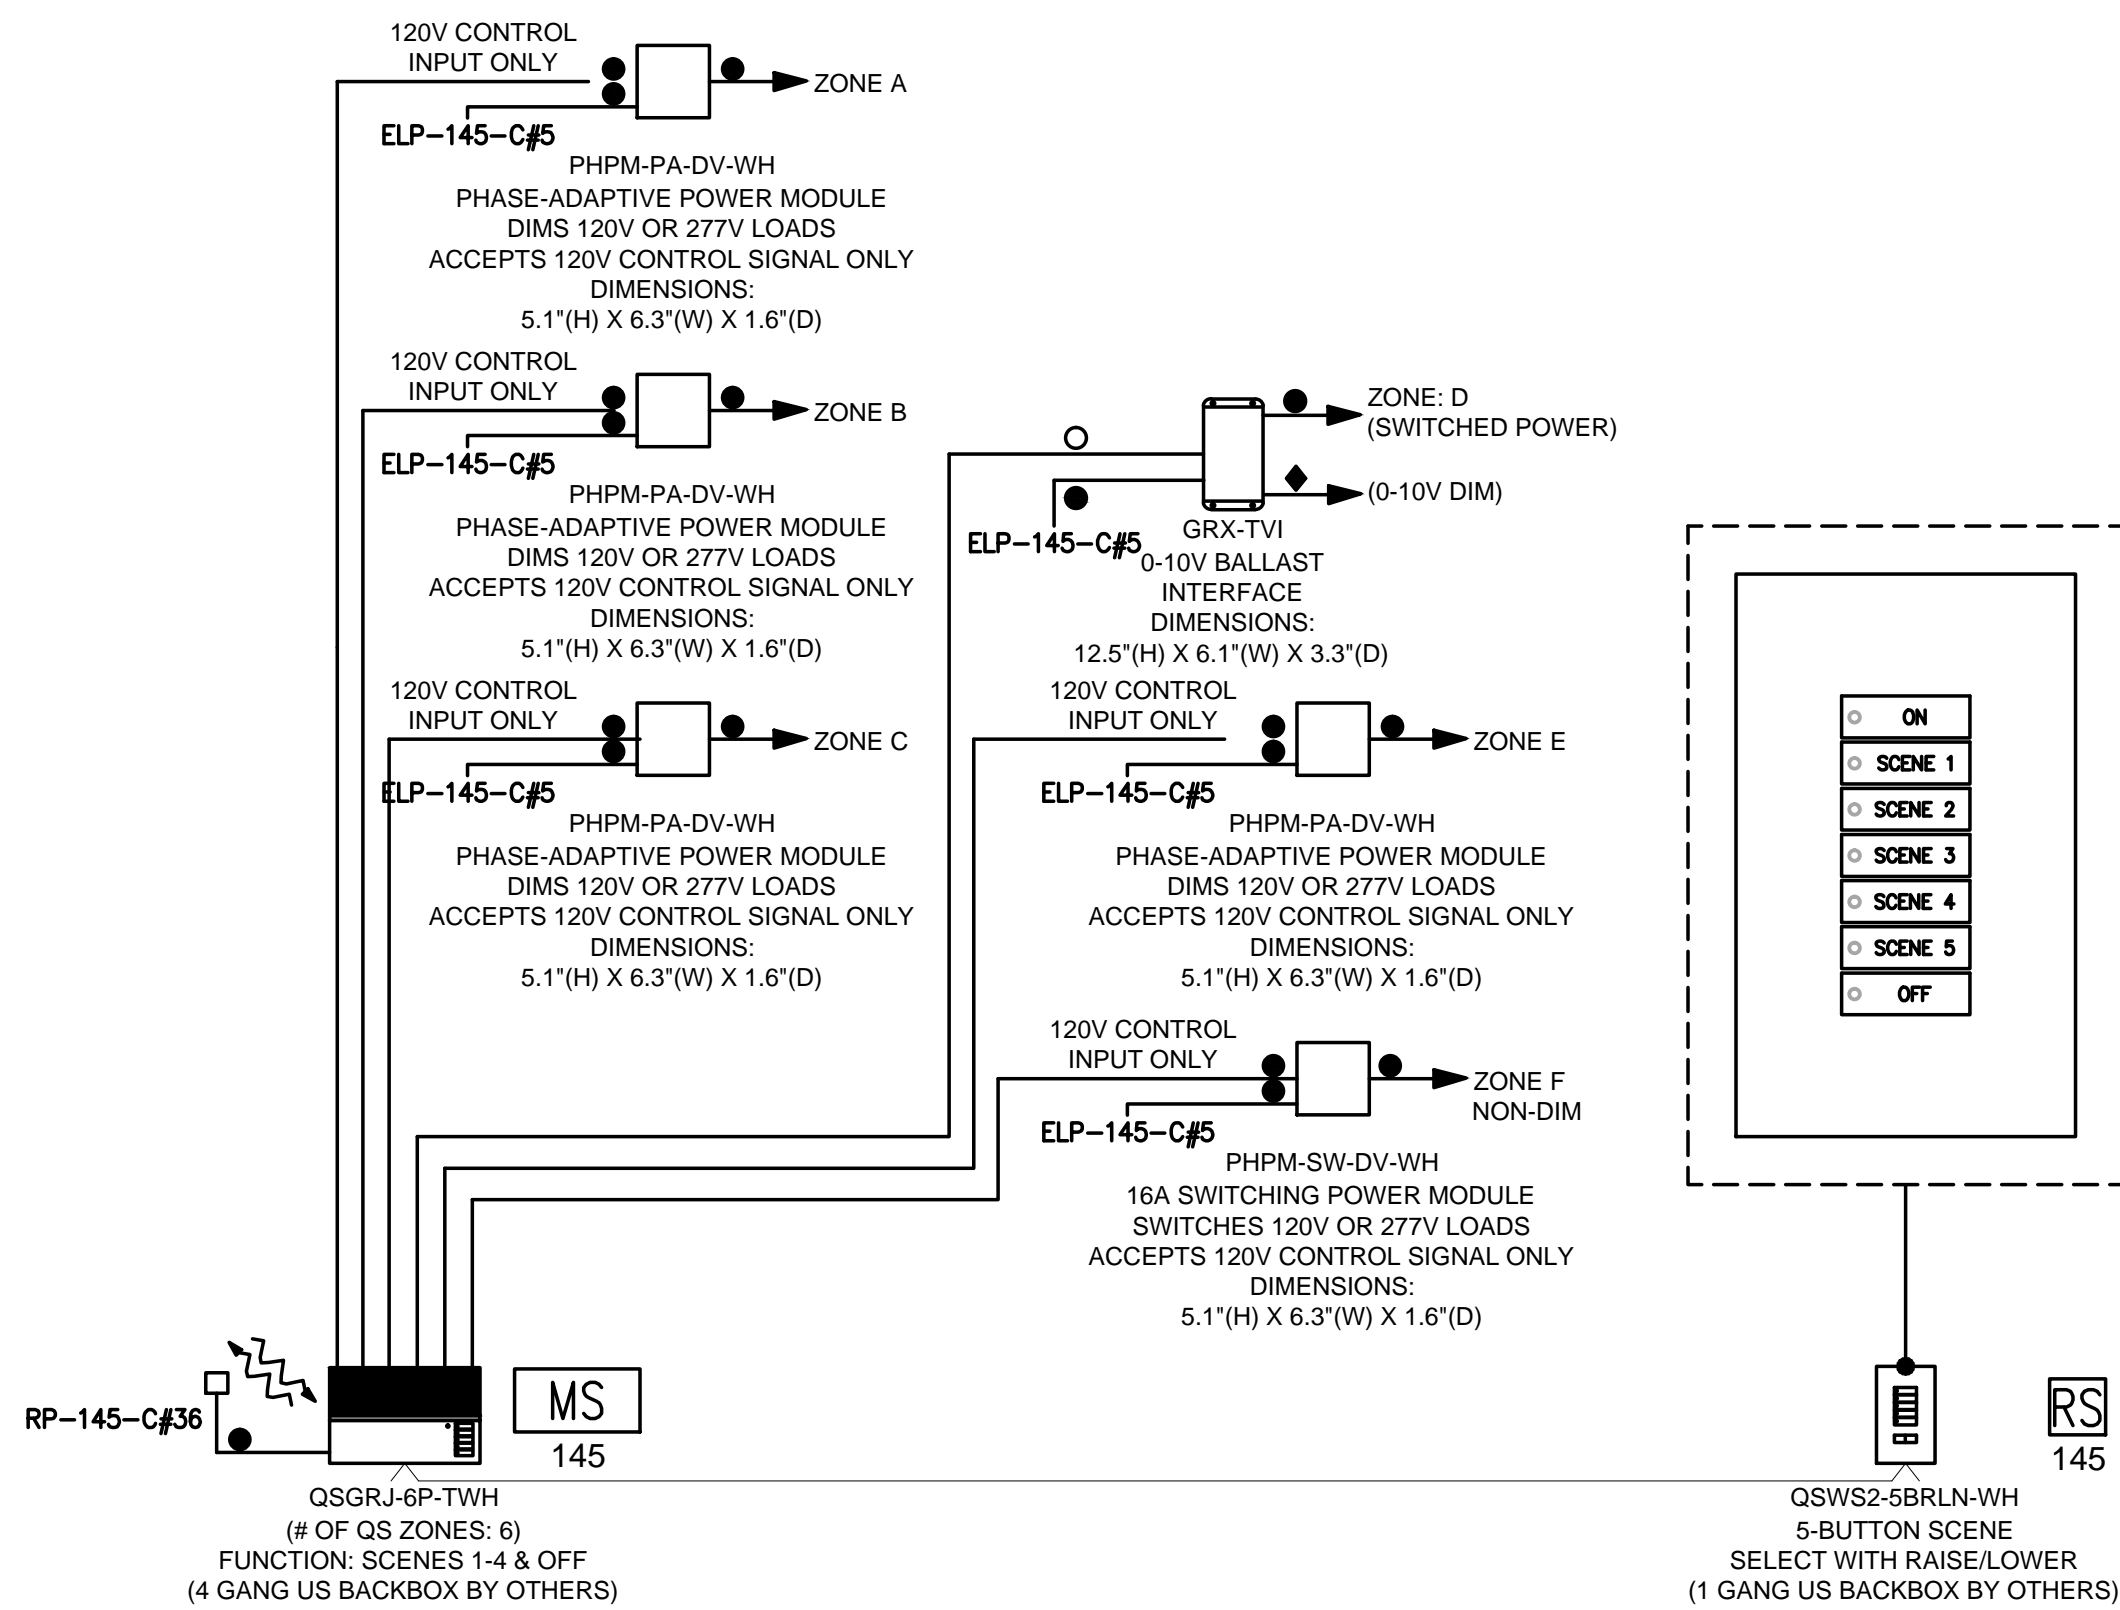


NYCECC BUILDING ENVELOPE REQUIREMENTS - OPAQUE ELEMENTS (ECCOVS TABLE 502.1.2)							
CLIMATE ZONE 4, COMMERCIAL BUILDING							
ENVELOPE TYPE	ENVELOPE AREA	MAXIMUM U-FACTOR	PROPOSED U-FACTOR	MAXIMUM SHGC	PROPOSED SHGC	MAXIMUM F-FACTOR	PROPOSED F-FACTOR
A. ROOF'S							
A1 INSULATION ENTIRELY ABOVE DECK - PLAZA		U-0.048	U-0.025	-	-	-	-
A2 INSULATION ENTIRELY ABOVE DECK - TOWER		U-0.048	U-0.025	-	-	-	-
B. WALLS							
B1 METAL FRAMED - CURTAIN WALL	191,870 SF	U-0.064	U-0.179	-	-	-	-
B2 METAL FRAMED - STOREFRONT	538 SF	U-0.064	U-0.090	-	-	-	-
B3 METAL FRAMED - SHADOW BOX	10,679 SF	U-0.064	U-0.179	-	-	-	-
B4 MASS - CONCRETE MASONRY UNIT	40,988 SF	U-0.104	U-0.128	-	-	-	-
C. BELOW GRADE WALLS							
C1 MASS - CONCRETE WALL	10,793 SF	-	-	C-1.140	C-0.550	-	-
D. SLAB-ON-GRADE FLOORS							
D1 UNHEATED SLABS	-	-	-	-	-	F-0.730	F-0.460

NYCECC BUILDING ENVELOPE REQUIREMENTS - FENESTRATION (ECCOVS TABLE 502.3)					
CLIMATE ZONE 4, COMMERCIAL BUILDING					
FENESTRATION TYPE	FENESTRATION AREA	MAXIMUM U-FACTOR	PROPOSED U-FACTOR	MAXIMUM SHGC	PROPOSED SHGC
METAL FRAMING WITH OR WITHOUT THERMAL BREAK					
CURTAIN WALL (GL01) - PF = 0.25	402,951 SF	U-0.500	U-0.420	SHGC: 0.400	SHGC: 0.290
STOREFRONT (GL02) - PF = 0.25	23,975 SF	U-0.500	U-1.06	SHGC: 0.400	SHGC: 0.880


NYCECC BUILDING ENVELOPE MANDATORY PROVISIONS			
CLIMATE ZONE 4, COMMERCIAL BUILDING			
SECTION	TITLE	DESCRIPTION	COMPLIANCE
502.4.1	WINDOW AND DOOR ASSEMBLIES	The air leakage of window and sliding or swinging door assemblies that are part of the building envelope shall be determined in accordance with AIAA/NOMMA/CA/SEA/IGL or NFRC 400 by an accredited, independent laboratory, and labeled and certified by the manufacturer and shall not exceed 0.3 cfm per square foot (1.5 L/s/m ²), and swinging doors no more than 0.5 cfm per square foot (2.6 L/s/m ²).	COMPLIES
502.4.2	CURTAIN WALL, STOREFRONT GLAZING AND COMMERCIAL ENTRANCE DOORS	Curtain wall, storefront glazing and commercial glazed swinging entrance doors and revolving doors shall be tested for air leakage at 1.57 pounds per square foot (psf) (75 Pa) in accordance with ASTM E 283. For curtain walls and storefront glazing, the maximum air leakage rate shall be 0.3 cubic foot per minute per square foot (cfm/ft ²) (5 L/s/m ²) of fenestration area. For commercial glazed swinging entrance doors and revolving doors, the maximum air leakage rate shall be 1.00 cfm/ft ² (16.3 L/s/m ²) of door area when tested in accordance with ASTM E 283.	COMPLIES
502.4.3	CONTINUOUS AIR BARRIER	Except for unheated structures and as permitted by this section, a continuous air barrier shall be installed, sealing all seams, openings, and penetrations of the building and shall be sealed with caulking materials or closed with gasketing systems compatible with the construction materials and location. Joints and seams shall be sealed in the same manner or taped or covered with a moisture vapor permeable wrapping material. Sealing materials spanning joints between construction materials shall allow for expansion and contraction of the construction materials. Such air barrier shall have all the following characteristics: 1. Continuous throughout the envelope with all joints and seams sealed and with sealed connections between all transitions in planes and changes in materials and at penetrations. 2. Joined and sealed in a flexible manner to the air barrier component of adjacent assemblies, allowing for the relative movement of these assemblies and components. 3. Installed in accordance with the manufacturer's instructions and in such a manner as to achieve the performance requirements. 4. Penetrations of the continuous air barrier shall be made in a way such that the integrity of the continuous air barrier is maintained.	COMPLIES
502.4.4	OUTDOOR AIR INTAKES AND EXHAUST OPENINGS	Seal and insulator shall vents and other outdoor air inlets and exhaust openings integral to the building envelope shall be equipped with not less than a Class I weatherstripped, leakage-rated damper with a maximum leakage rate of 4 cfm per square foot (6.8 L/s/m ²) at 1.0 inch water gauge (w.g.) (1250 Pa) when tested in accordance with AIA/CA 5000.	COMPLIES
502.4.5	LOADING DOCK WEATHERSEALS	Cargo doors and loading dock doors shall be equipped with weatherseals to restrict infiltration when vehicles are parked in the doorway.	COMPLIES
502.4.6	VESTIBULES	A door that separates conditioned space from the exterior shall be protected with an enclosed vestibule, with all doors opening into and out of the vestibule equipped with self-closing doors. Vestibules shall be designed so that in passing through the vestibule it is not necessary for the interior and exterior doors to open at the same time. Exceptions: 1. Does not intend to be used as a building entrance door, such as doors to mechanical or electrical equipment rooms. 2. Doors opening directly from a sleeping unit or dwelling unit. 3. Does not open directly from a space less than 3,000 square feet (279 m ²) in area. 4. Revolving doors. 5. Doors used primarily to facilitate vehicular movement or material handling and adjacent personnel doors.	DOES NOT COMPLY

BUILDING ENVELOPE MATERIALS			
MATERIAL ID	DESCRIPTION	LOCATION	COMMENTS
GLASS			
GL01	1 1/4" INSULATED GLASS UNIT COMPOSED OF 3/8" CLEAR LOW-IRON, HEAT STRENGTHENED OUTER LITE WITH A LOW-E COATING ON THE NO. 2 SURFACE + 1/2" BLACK STAINLESS STEEL SPACER WITH ARGON FILL + 3/8" CLEAR LOW-IRON FULLY TEMPERED HEAT SOAKED INNER LITE	TOWER CURTAIN WALL VISION	GL01B IS A THERMALLY CURVED VERSION OF GL01 ASSEMBLY.
GL02	1 1/4" UNHEATED SAFETY GLASS COMPOSED OF 3/8" LOW-IRON HEAT STRENGTHENED GLASS + A 0.067" PVB INTERLAYER + 3/8" LOW-IRON HEAT STRENGTHENED GLASS	STOREFRONT VISION GLAZING	GL02B IS A THERMALLY CURVED VERSION OF GL02 ASSEMBLY.
GL03	1 1/4" INSULATED GLASS UNIT COMPOSED OF 3/8" CLEAR LOW-IRON, HEAT STRENGTHENED OUTER LITE WITH A LOW-E COATING ON THE NO. 2 SURFACE + 1/2" SPACER WITH ARGON FILL + 3/8" CLEAR LOW-IRON INNER LITE	TOWER CURTAIN WALL	GL03B IS A THERMALLY CURVED VERSION OF GL03 ASSEMBLY.
GL04	2 3/8" UNHEATED GLASS FR COMPOSED OF 3/4" LOW-IRON TEMPERED GLASS + 0.067" IONOPLAST INTERLAYER + 3/4" LOW-IRON TEMPERED GLASS + 0.067" IONOPLAST INTERLAYER + 3/4" LOW-IRON TEMPERED GLASS	STOREFRONT FINS	
GL05	3/8" LAMINATED SAFETY GLASS COMPOSED OF 3/8" LOW-IRON GLASS + 0.067" IONOPLAST INTERLAYER + 3/8" LOW-IRON GLASS WITH A CUSTOM CERAMIC FRIT ON THE NO. 2 SURFACE	STOREFRONT CANOPY	
GL06	1/2" LOW-IRON FULLY TEMPERED GLASS	STOREFRONT DOORS/REVOLVERS	
GL07	1 1/4" INSULATED GLASS UNIT COMPOSED OF 3/8" CLEAR LOW-IRON, HEAT STRENGTHENED OUTER LITE WITH A LOW-E COATING ON THE NO. 2 SURFACE + 1/2" BLACK STAINLESS STEEL SPACER WITH ARGON FILL + 3/8" CLEAR LOW-IRON HEAT STRENGTHENED INNER LITE	TOWER CURTAIN WALL SHADOW BOX	GL07B IS A THERMALLY CURVED VERSION OF GL07 ASSEMBLY.
INSULATION			
INS04	EXTRUDED POLYSTYRENE INSULATION	ROOF DECK	
INS06	EXTRUDED POLYSTYRENE INSULATION	PLAZA DECK	
INS09	SEMI-RIGID MINERAL FIBER INSULATION	CURTAIN WALL / STOREFRONT	
METAL			
MTL04	STAINLESS STEEL BRIGHT DIRECTIONAL POLISH	STOREFRONT INTERIOR MULLIONS	
MTL08	STAINLESS STEEL NON-DIRECTIONAL MIRROR POLISH	STOREFRONT EXTERIOR MULLIONS	
MTL20	PAINTED ALUMINUM	TOWER CURTAIN WALL EXTERIOR MULLIONS	
MTL21	PAINTED ALUMINUM	TOWER CURTAIN WALL INTERIOR MULLIONS	
MTL22	PAINTED ALUMINUM	TOWER CURTAIN WALL SPANDREL/SHADOW BOX	
PAVERS			
PAW01	CONCRETE PAVERS	ROOF DECK	
STONE			
ST05	STONE	PLAZA DECK	

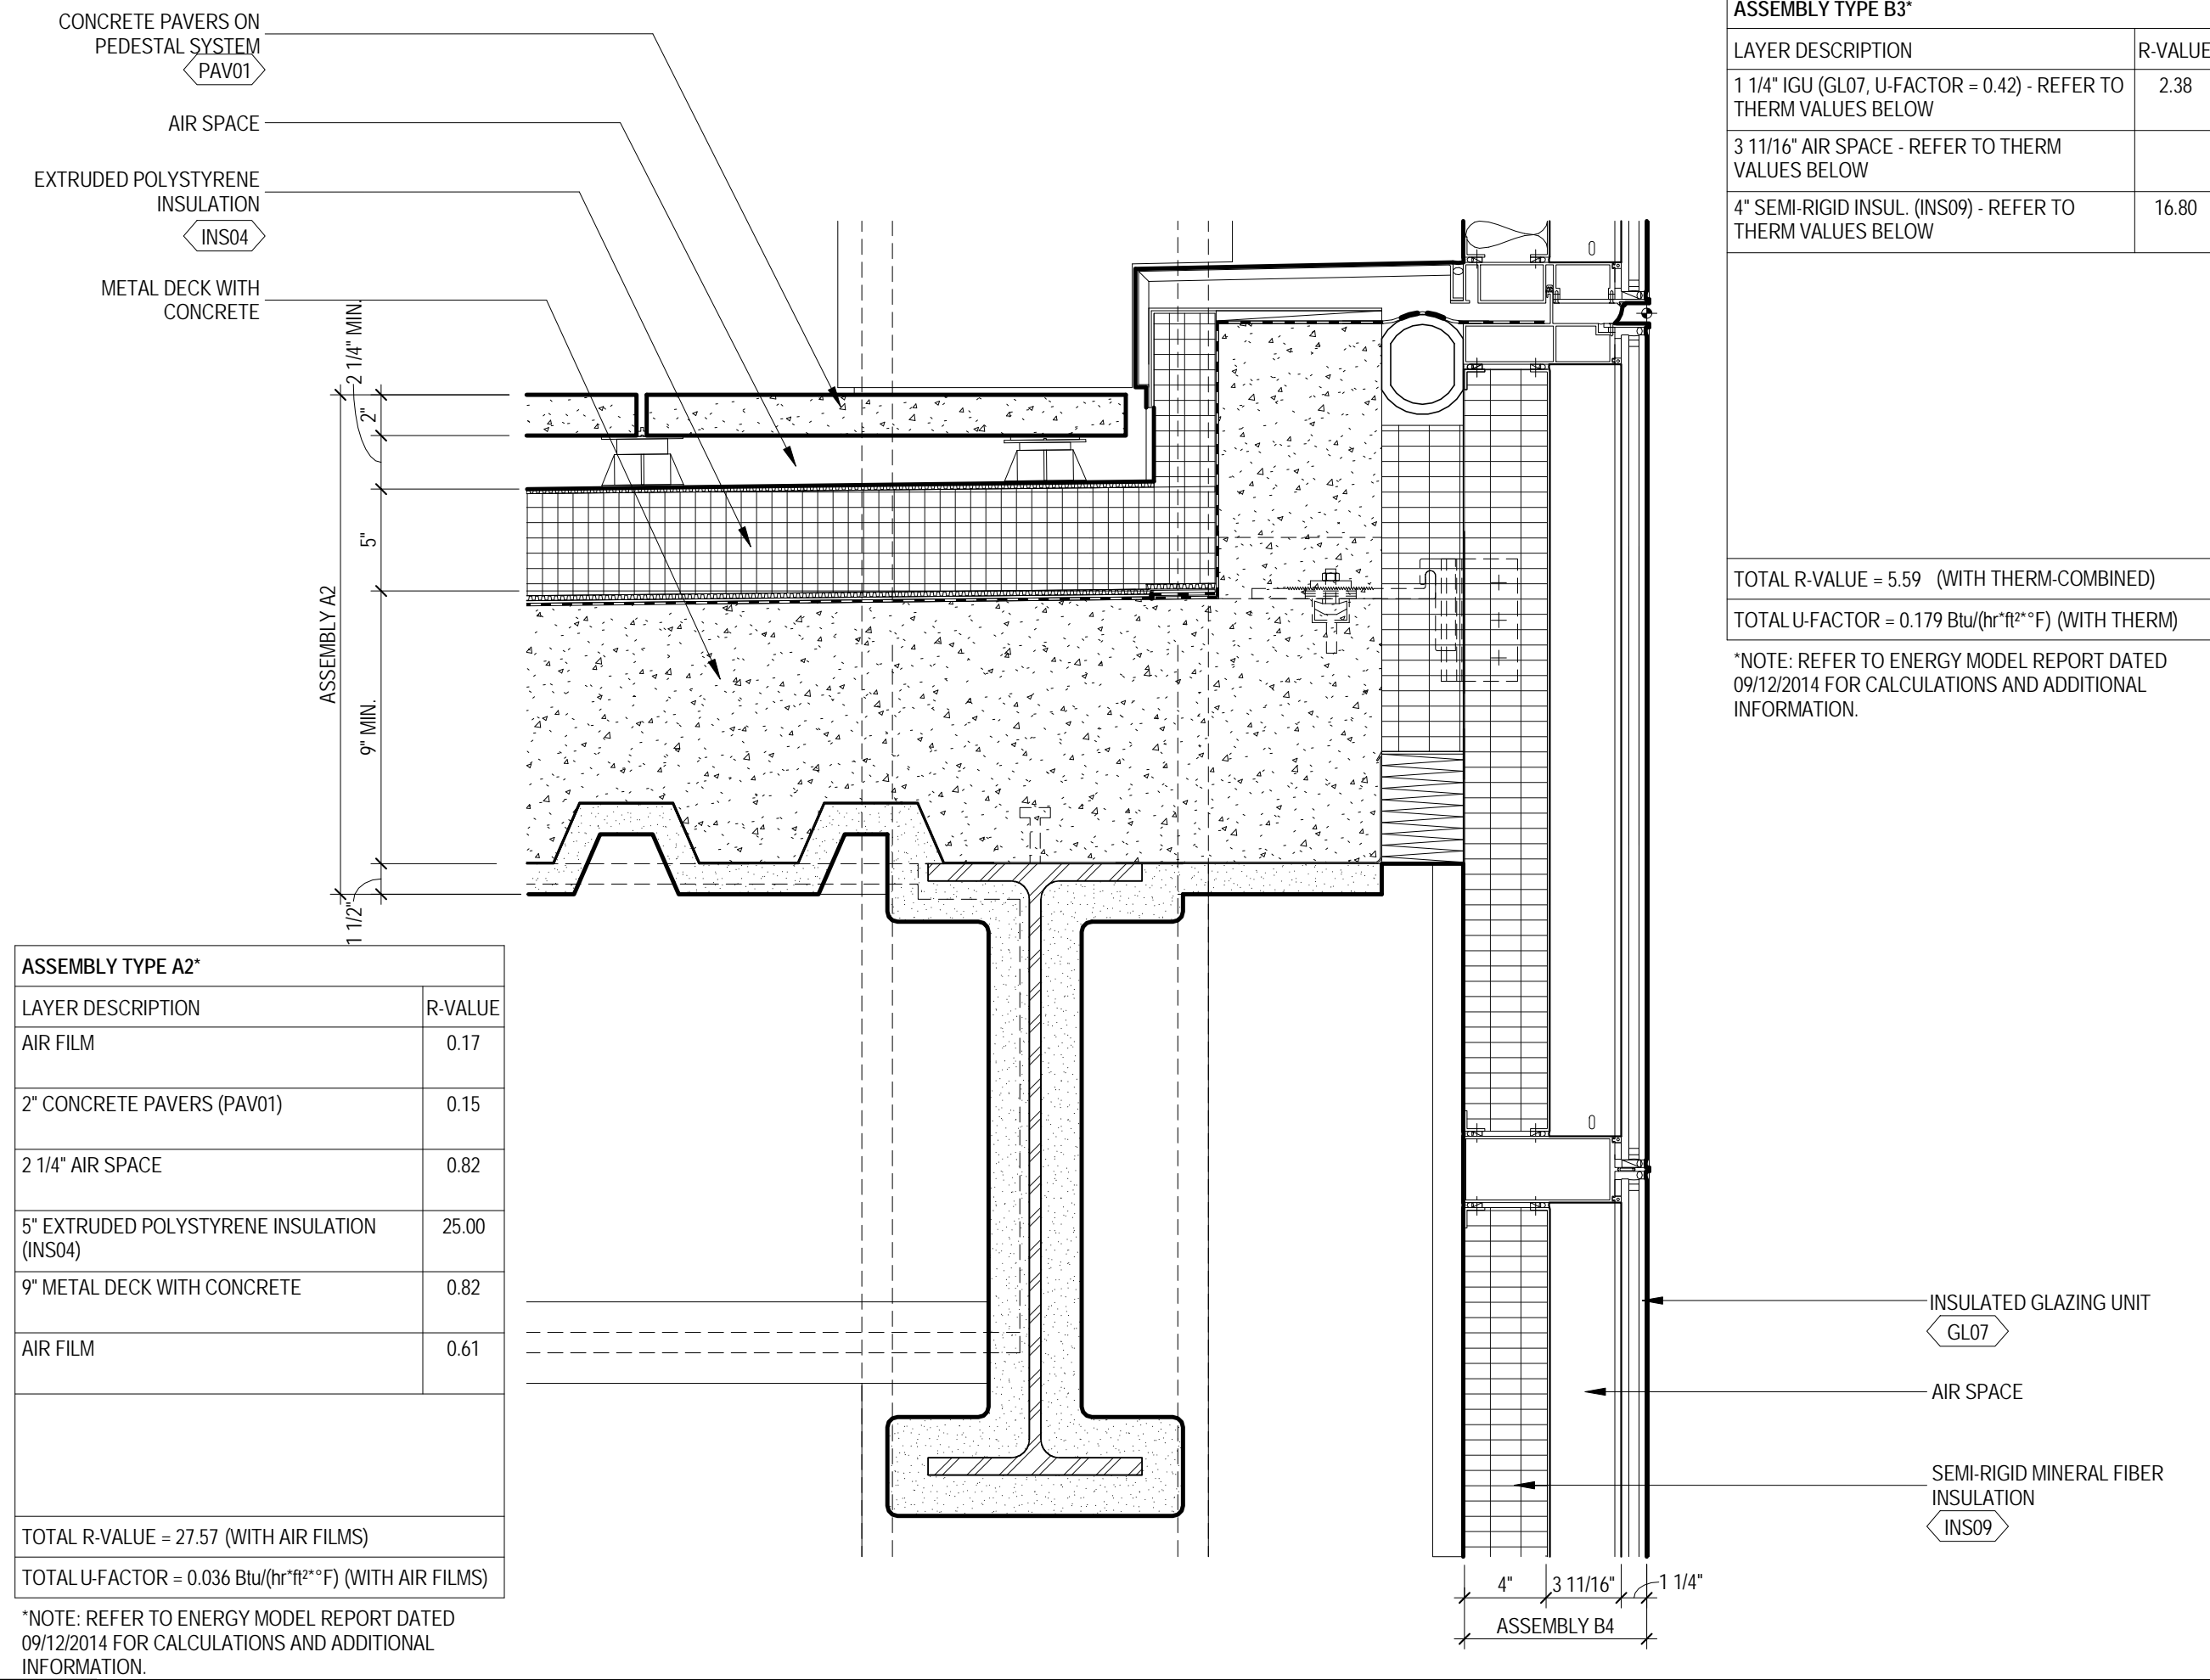


6 ROOF ASSEMBLY AT TOWER

SCALE: NTS

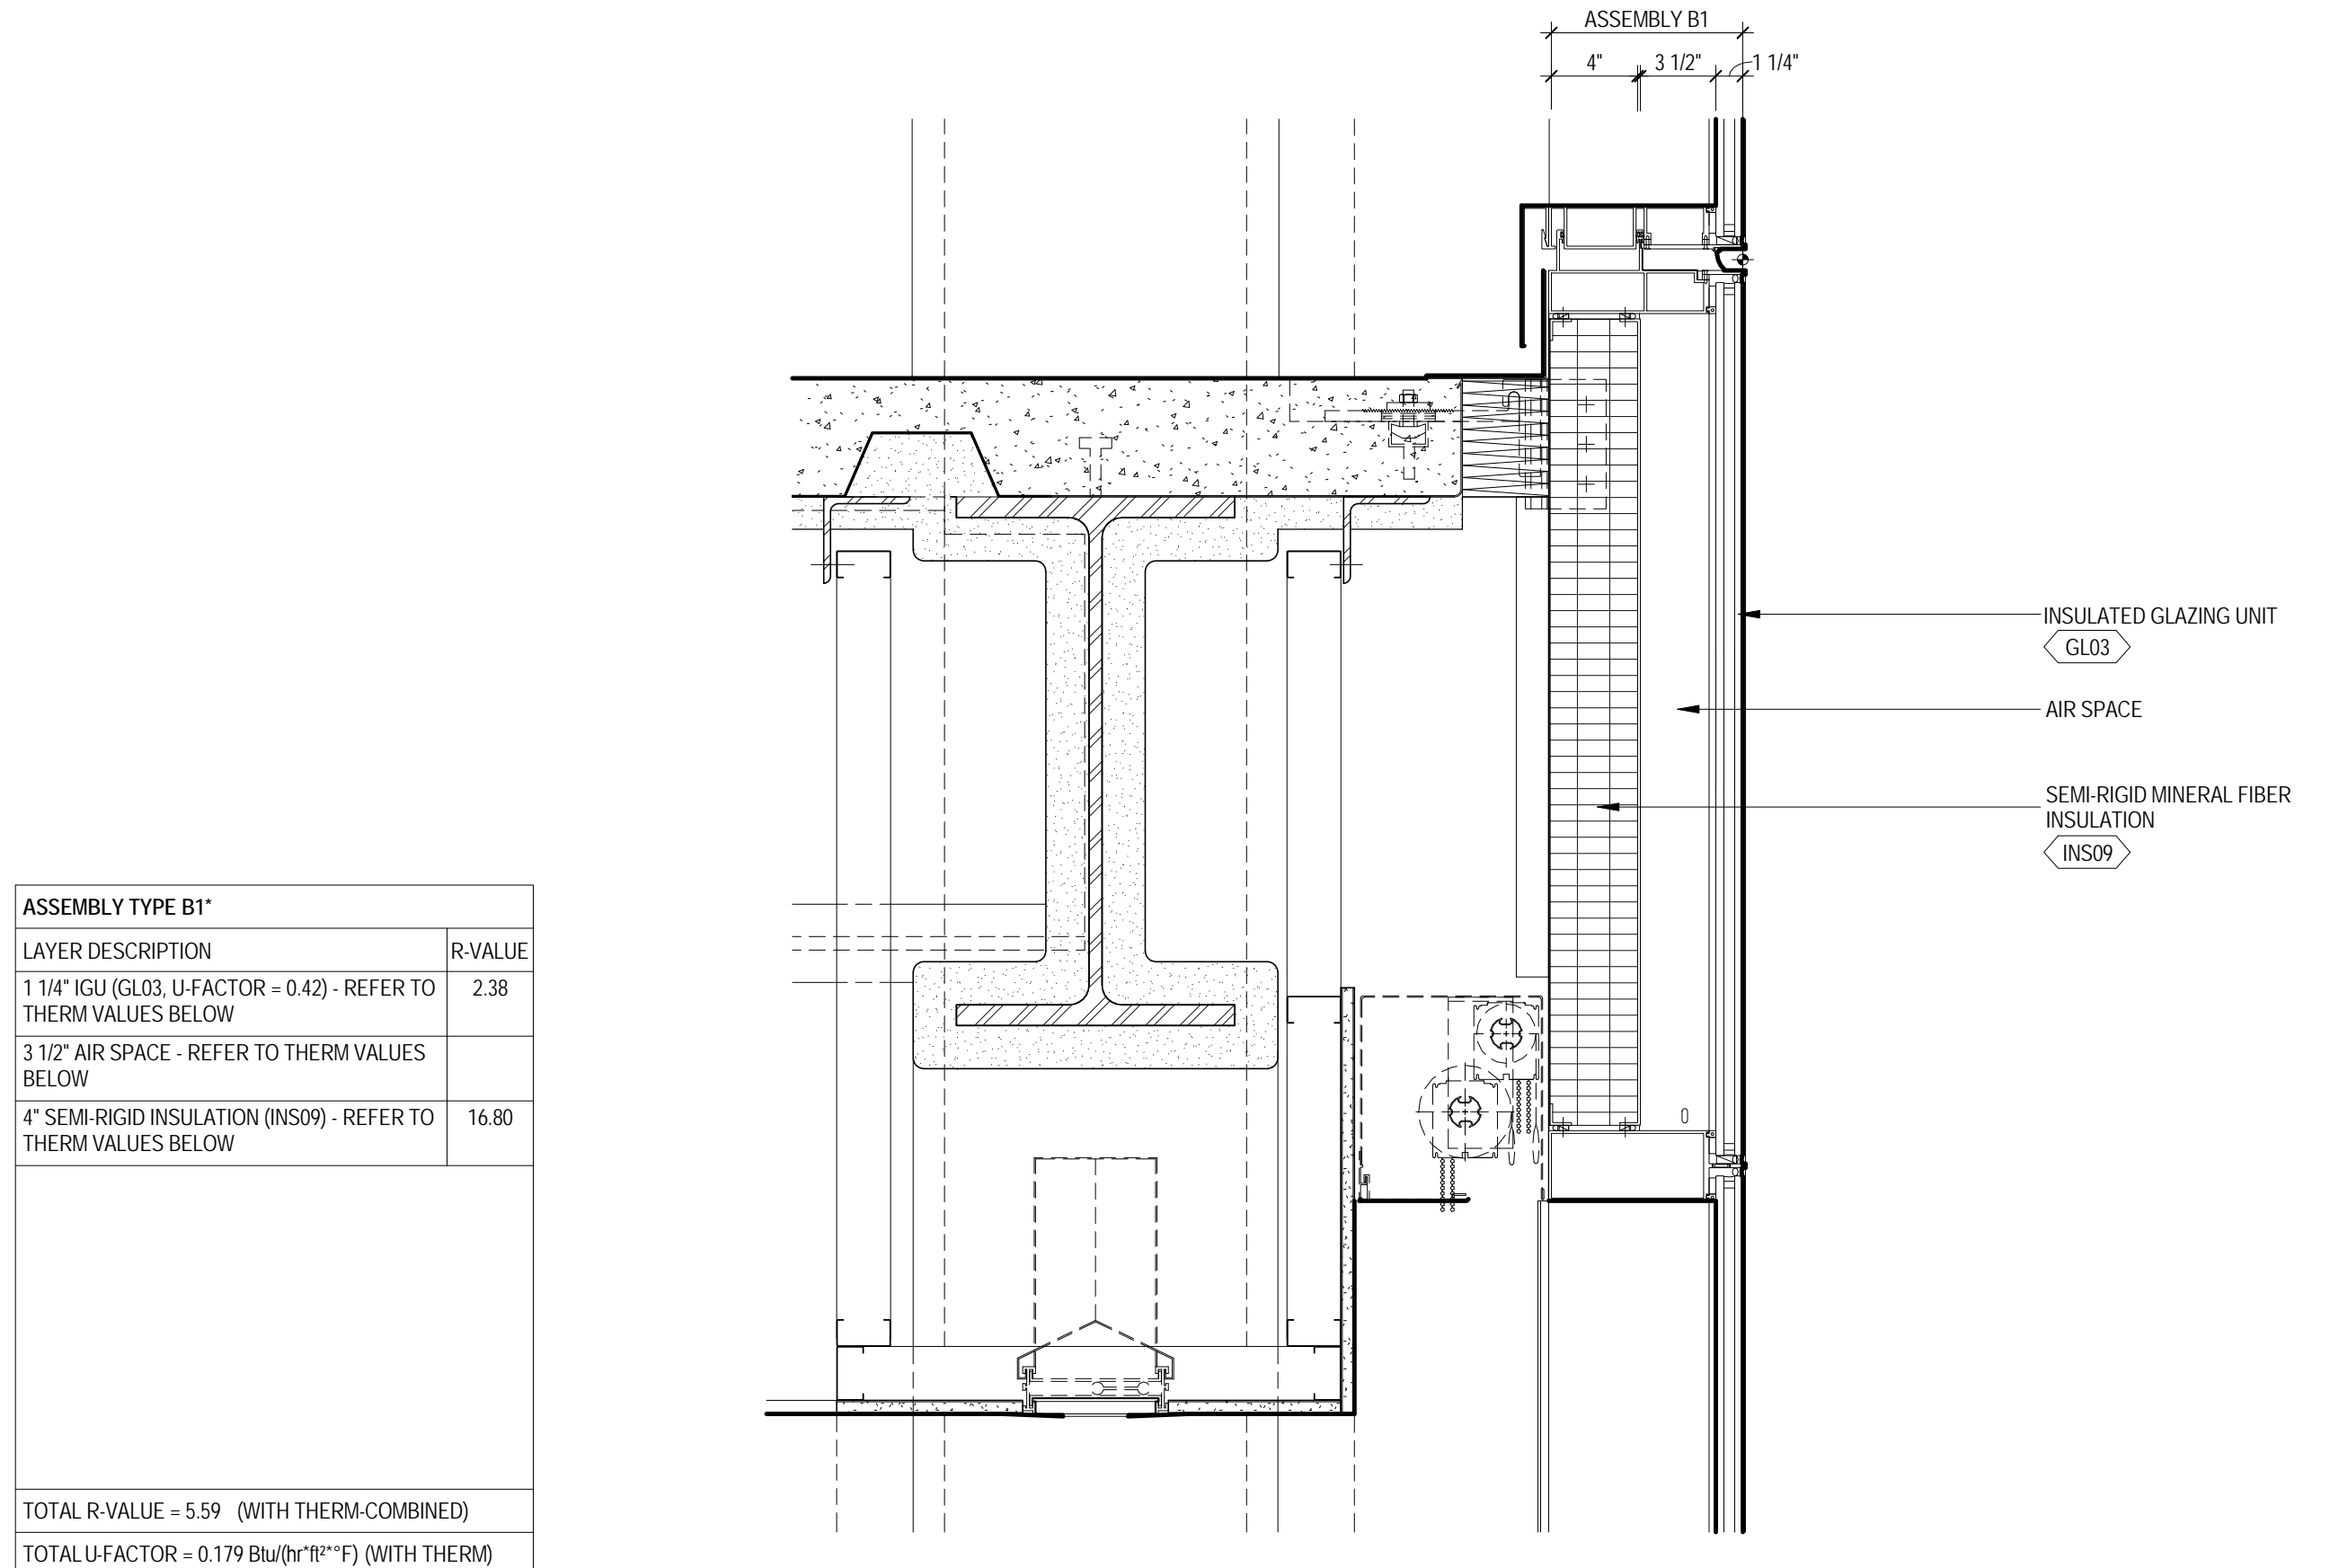

5 WALL/FLOOR ASSEMBLY AT CURTAIN WALL

SCALE: NTS

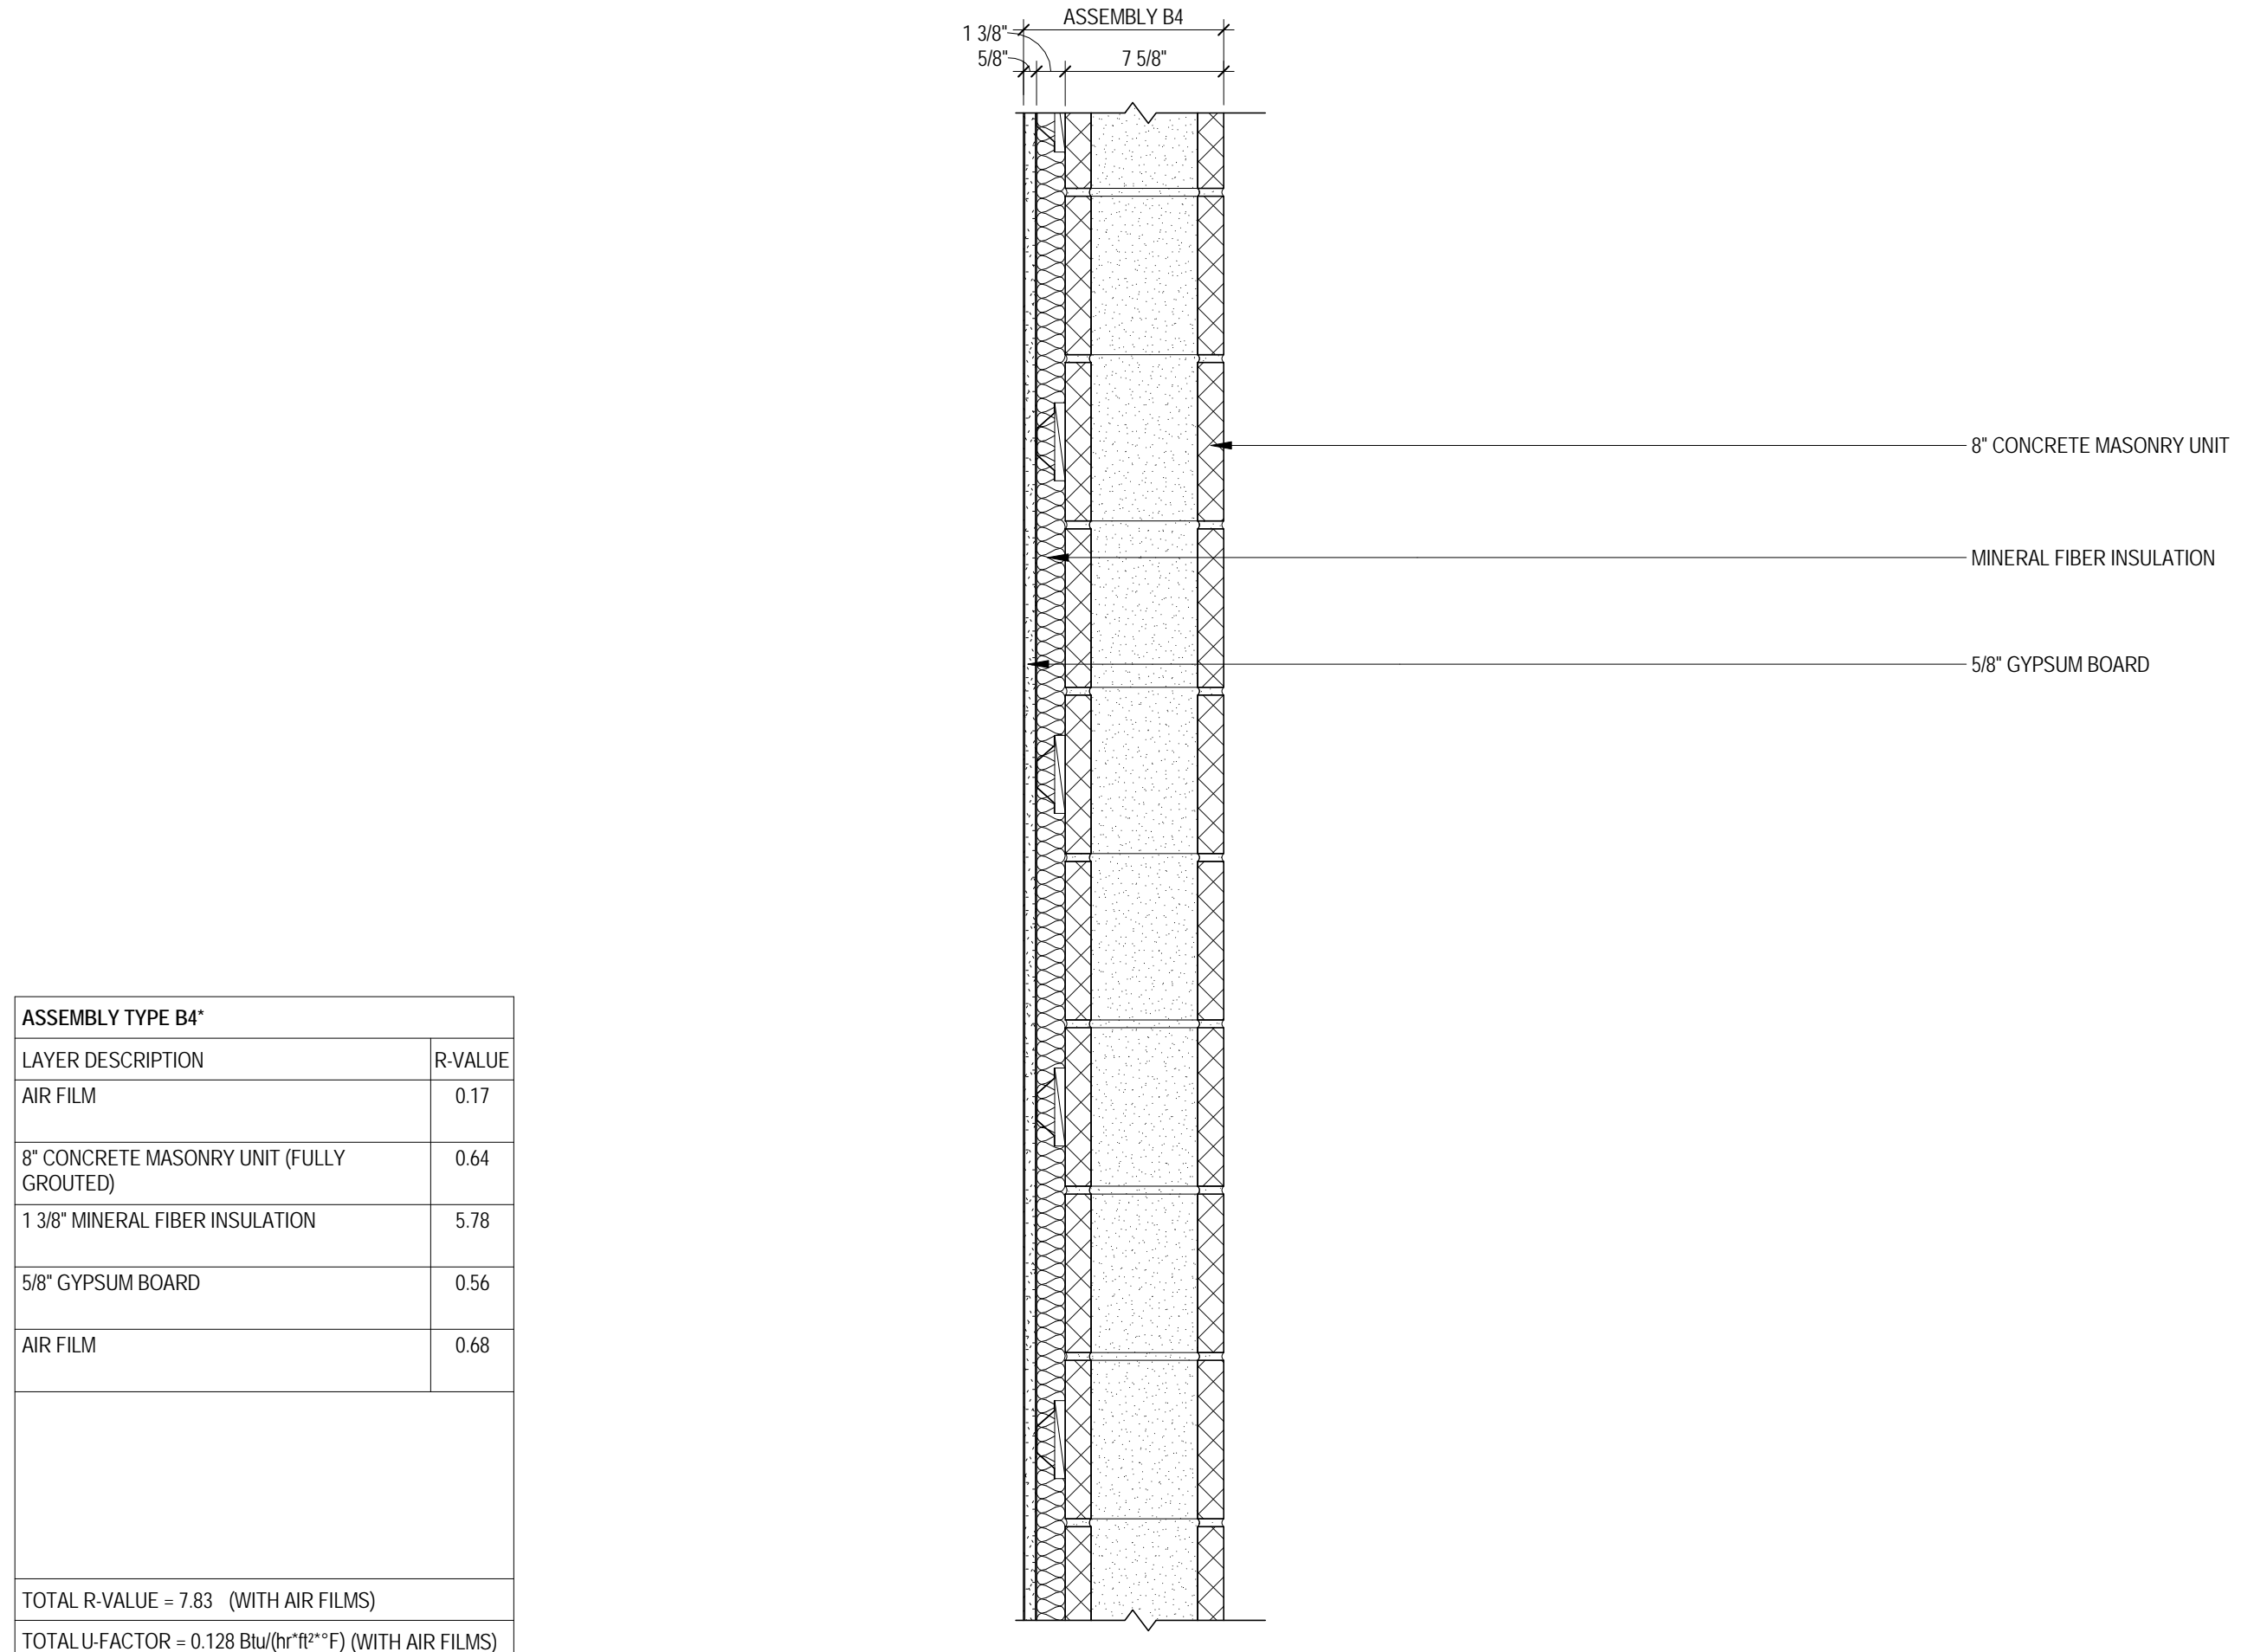

4 WALL ASSEMBLY AT CONCRETE MASONRY WALL


SCALE: 1/2" = 1'-0"

ASSEMBLY TYPE B2'	
LAYER DESCRIPTION	R-VALUE
1 5/8" SEMI-RIGID INSULATION (INS09) - REFER TO THERM VALUES BELOW	5.51

TOTAL R-VALUE = 1.12 (WITH THERM COMBINED)
TOTAL U-FACTOR = 0.890 (Btu/h*(ft²)*°F)
*NOTE: REFER TO ENERGY MODEL REPORT DATED 09/12/2014 FOR CALCULATIONS AND ADDITIONAL INFORMATION.


3 WALL ASSEMBLY AT STOREFRONT

SCALE: NTS

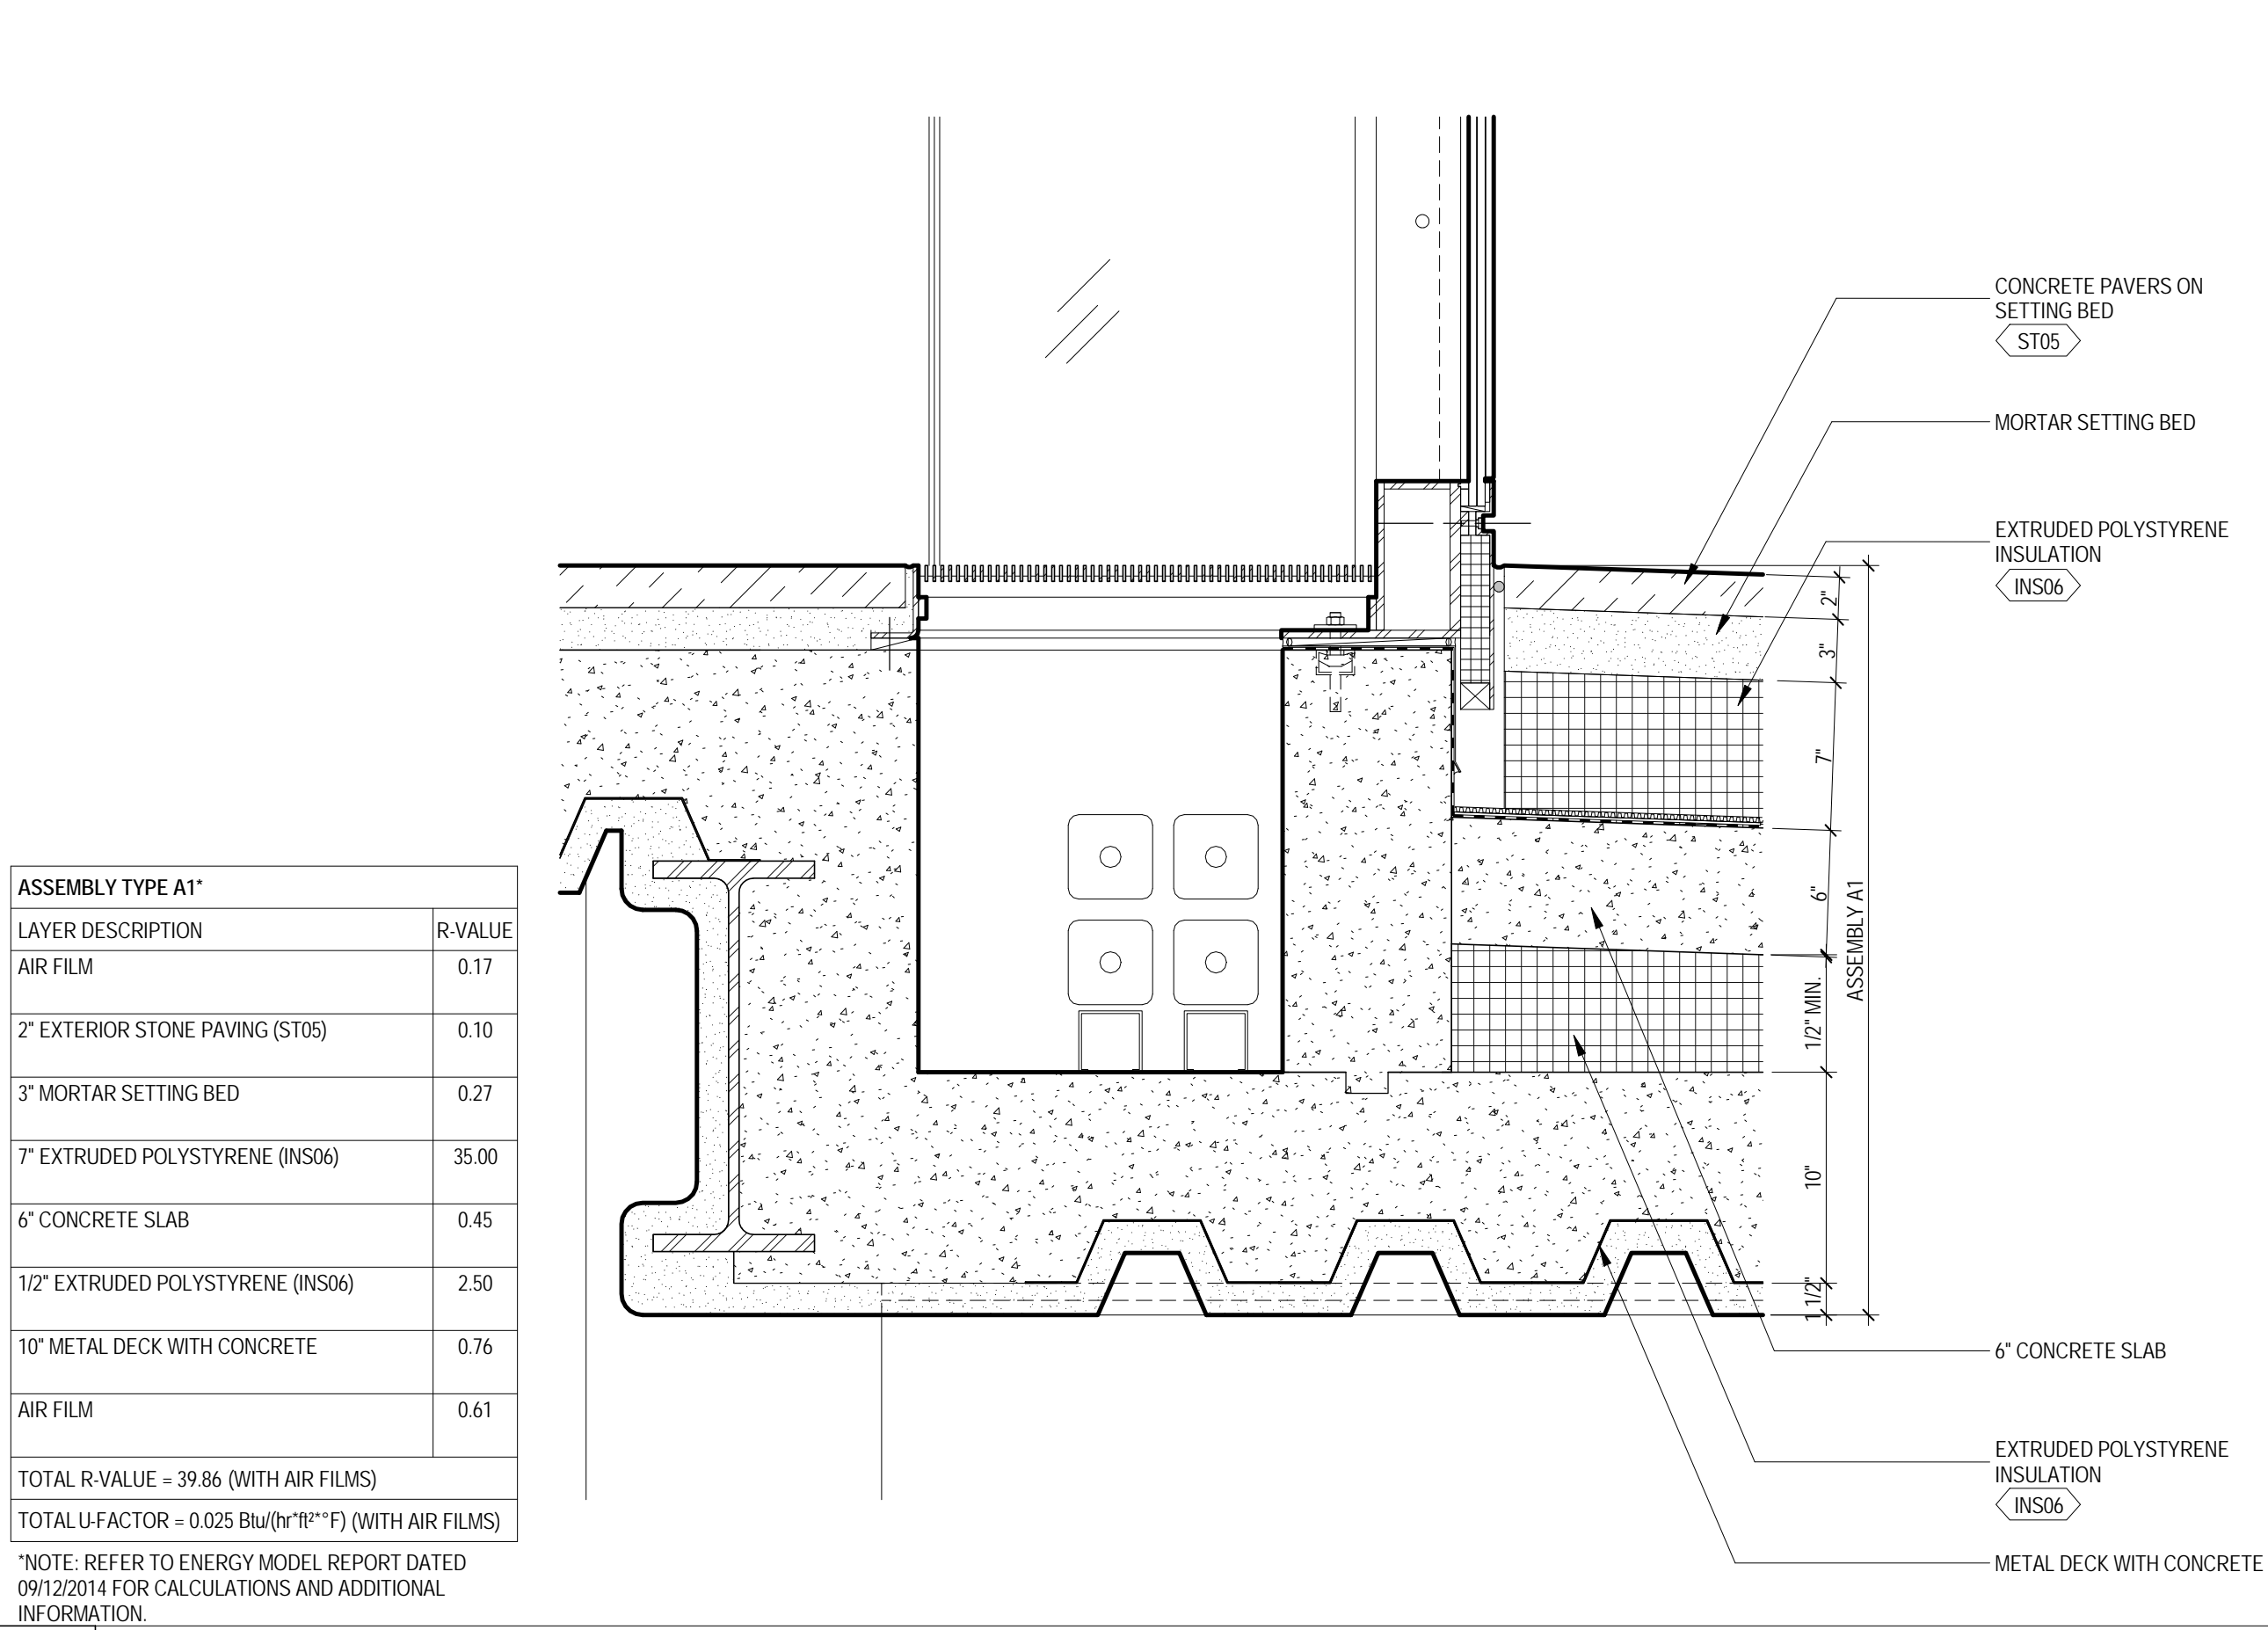

2 ROOF ASSEMBLY AT PLAZA

SCALE: NTS

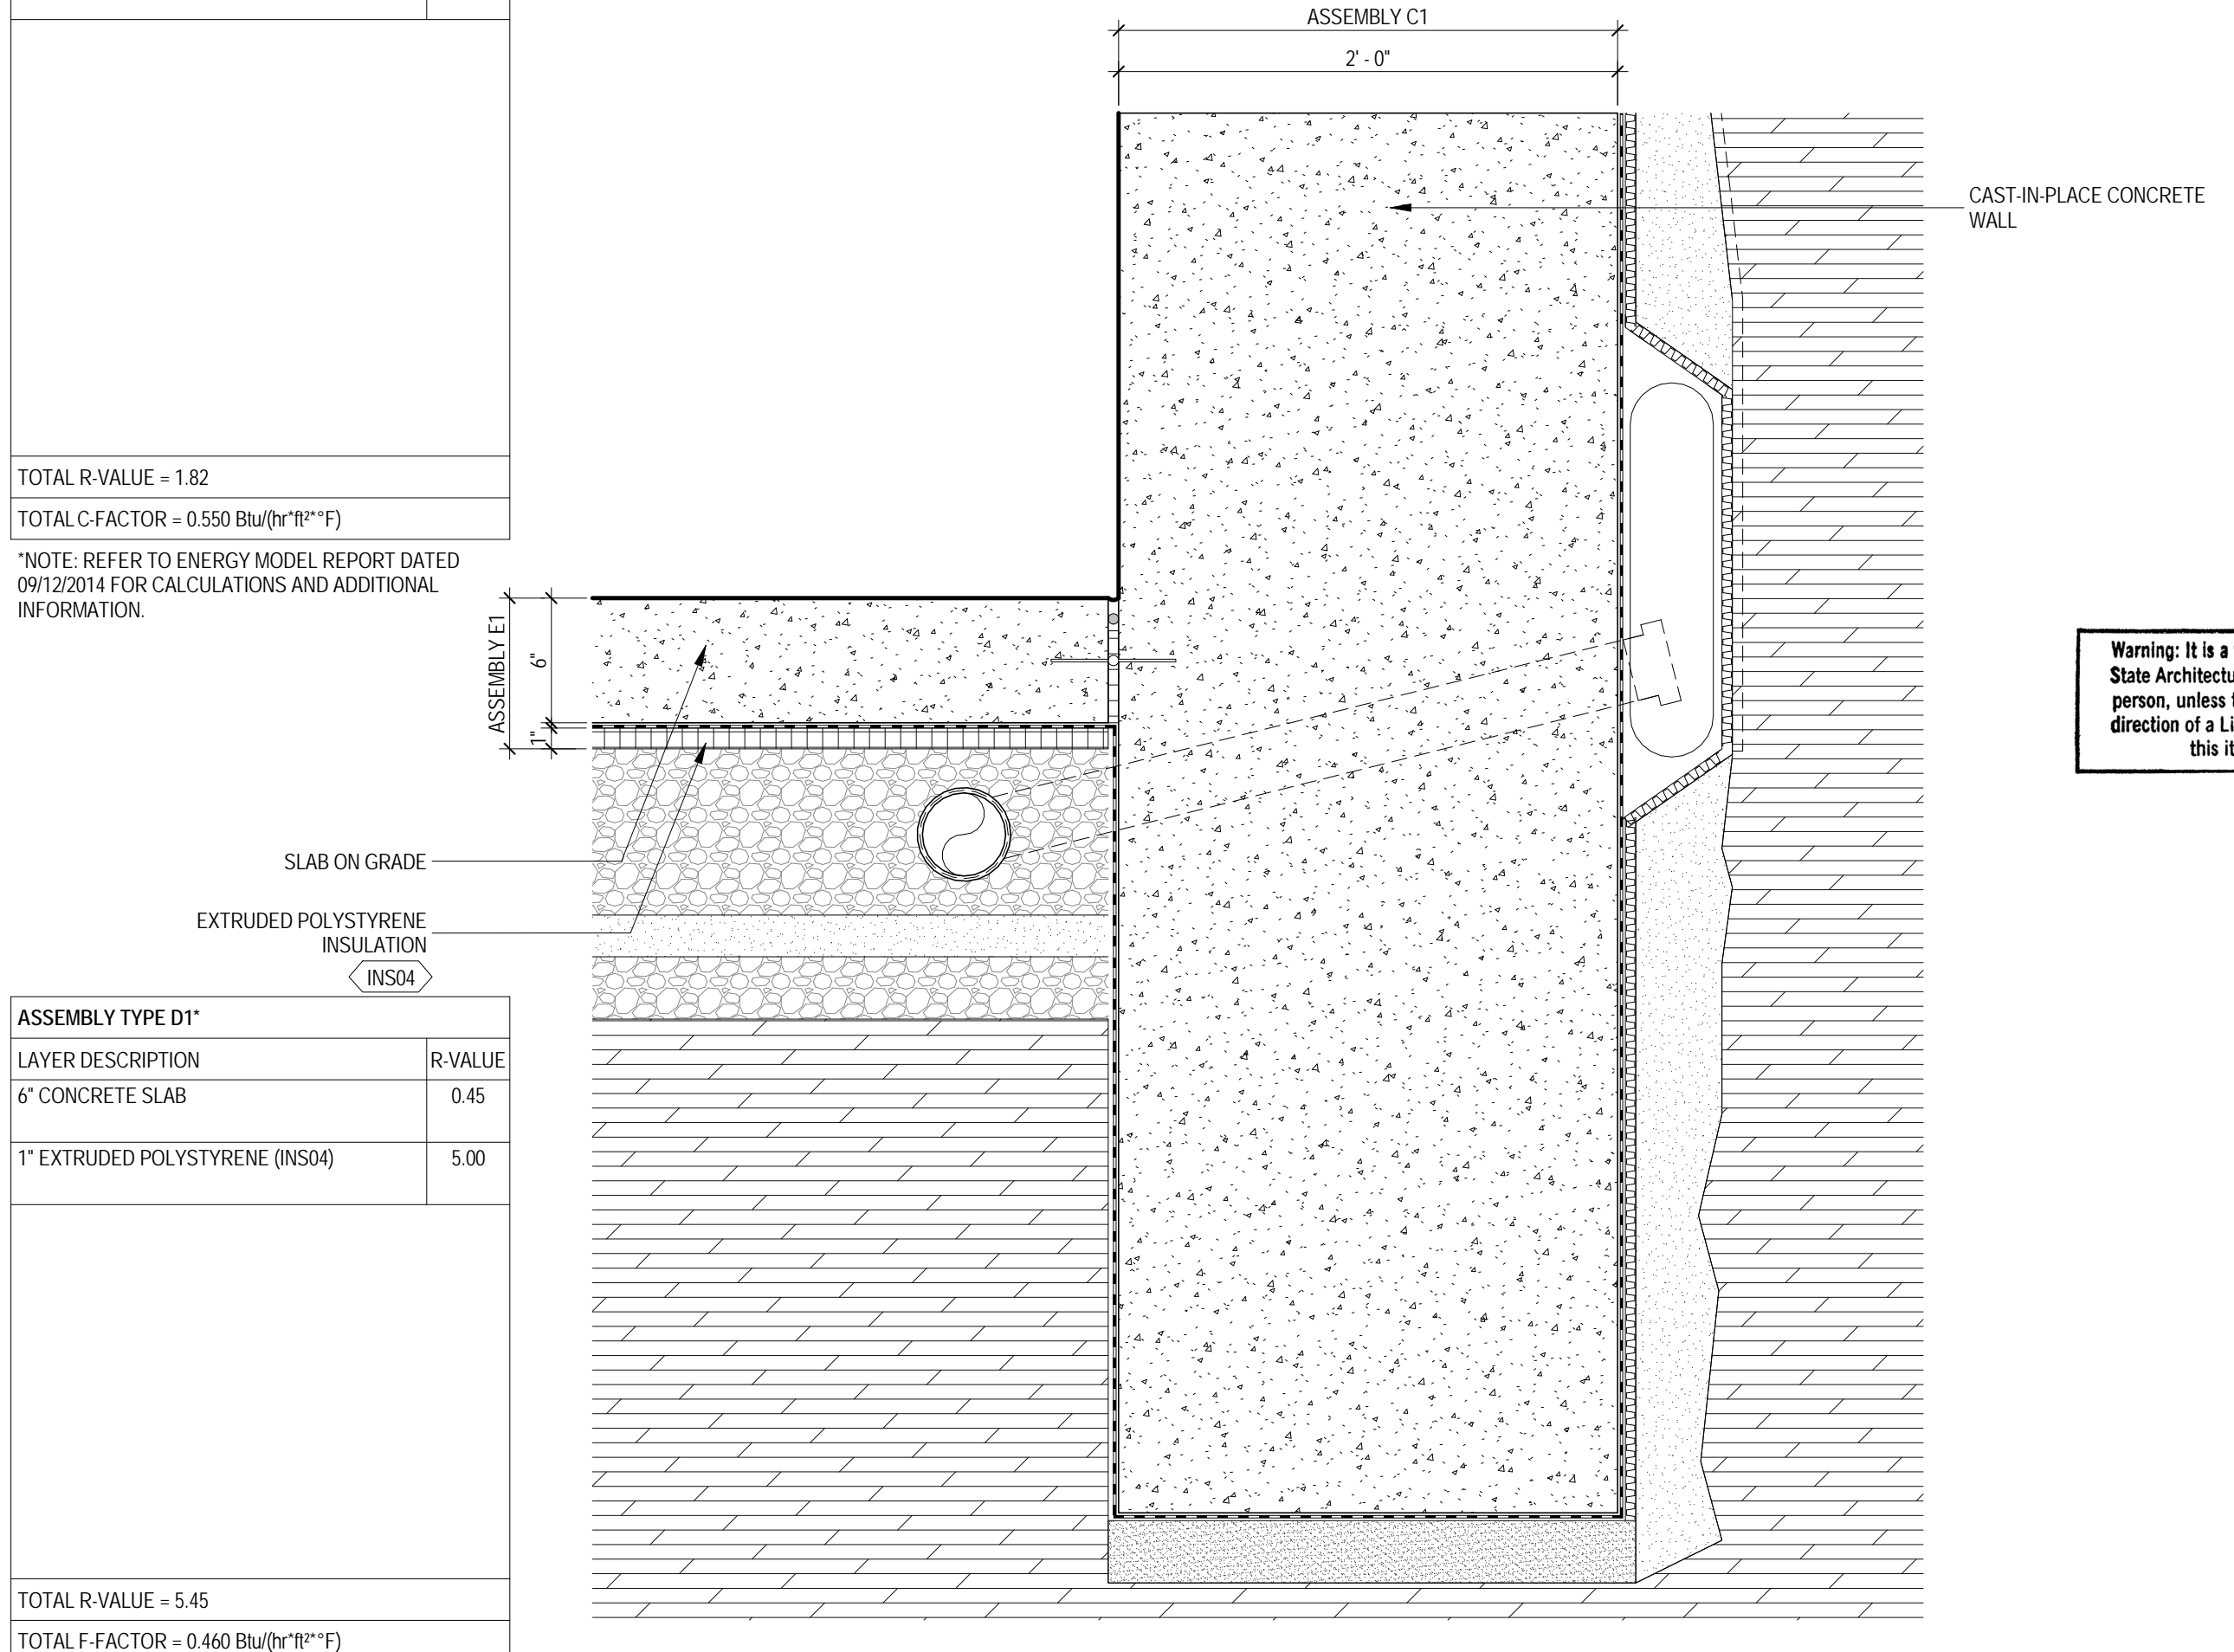

1 WALL/FLOOR ASSEMBLY AT PERIMETER FOOTING

SCALE: 1/2" = 1'-0"

ASSEMBLY TYPE D1'	
LAYER DESCRIPTION	R-VALUE
4" CONCRETE SLAB	0.45
1" EXTRUDED POLYSTYRENE (INS04)	5.00

TOTAL R-VALUE = 5.45
TOTAL U-FACTOR = 0.185 (Btu/h*(ft²)*°F)
*NOTE: REFER TO ENERGY MODEL REPORT DATED 09/12/2014 FOR CALCULATIONS AND ADDITIONAL INFORMATION.



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MEP Engineering

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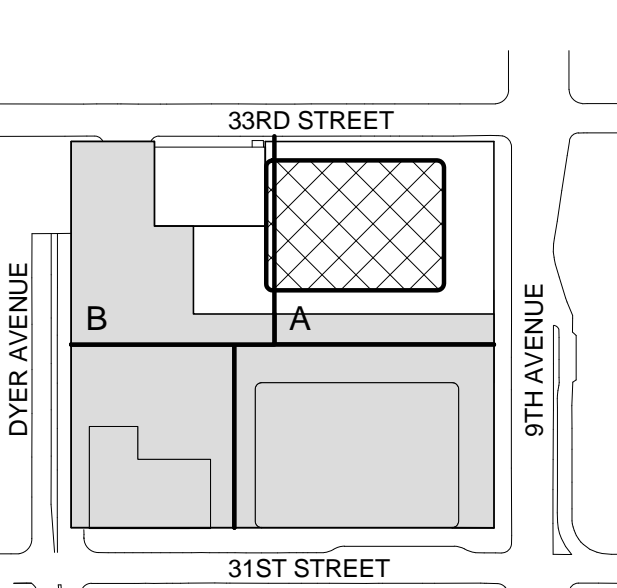
Wind Tunnel Consultant

Rowan Williams Davies & Irwin Inc.
650 Woodlawn Road West, Guelph Ontario, Canada N1K 1B8


Warning: It is a violation of the New York State Architecture Law (§§8.500) for any person, unless they are acting under the direction of a Licensed Architect, to alter this item in any way.

PRELIMINARY
NOT FOR CONSTRUCTION

Key Plan:




Seal & Signature:

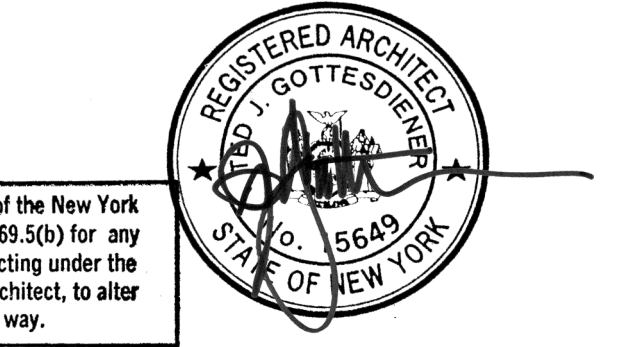


No.	12 SEP 2014	ISSUED FOR FOUNDATION PERMIT
Date	12 SEP 2014	Description
Sheet Name:	ENCLOSURE ASSEMBLIES	

Project No.: 207150
Date: 12 SEP 2014
Scale: 1/2" = 1'-0"
File No.: EN-200


Sheet No.: EN-200.00
Page No.: 1 OF 30

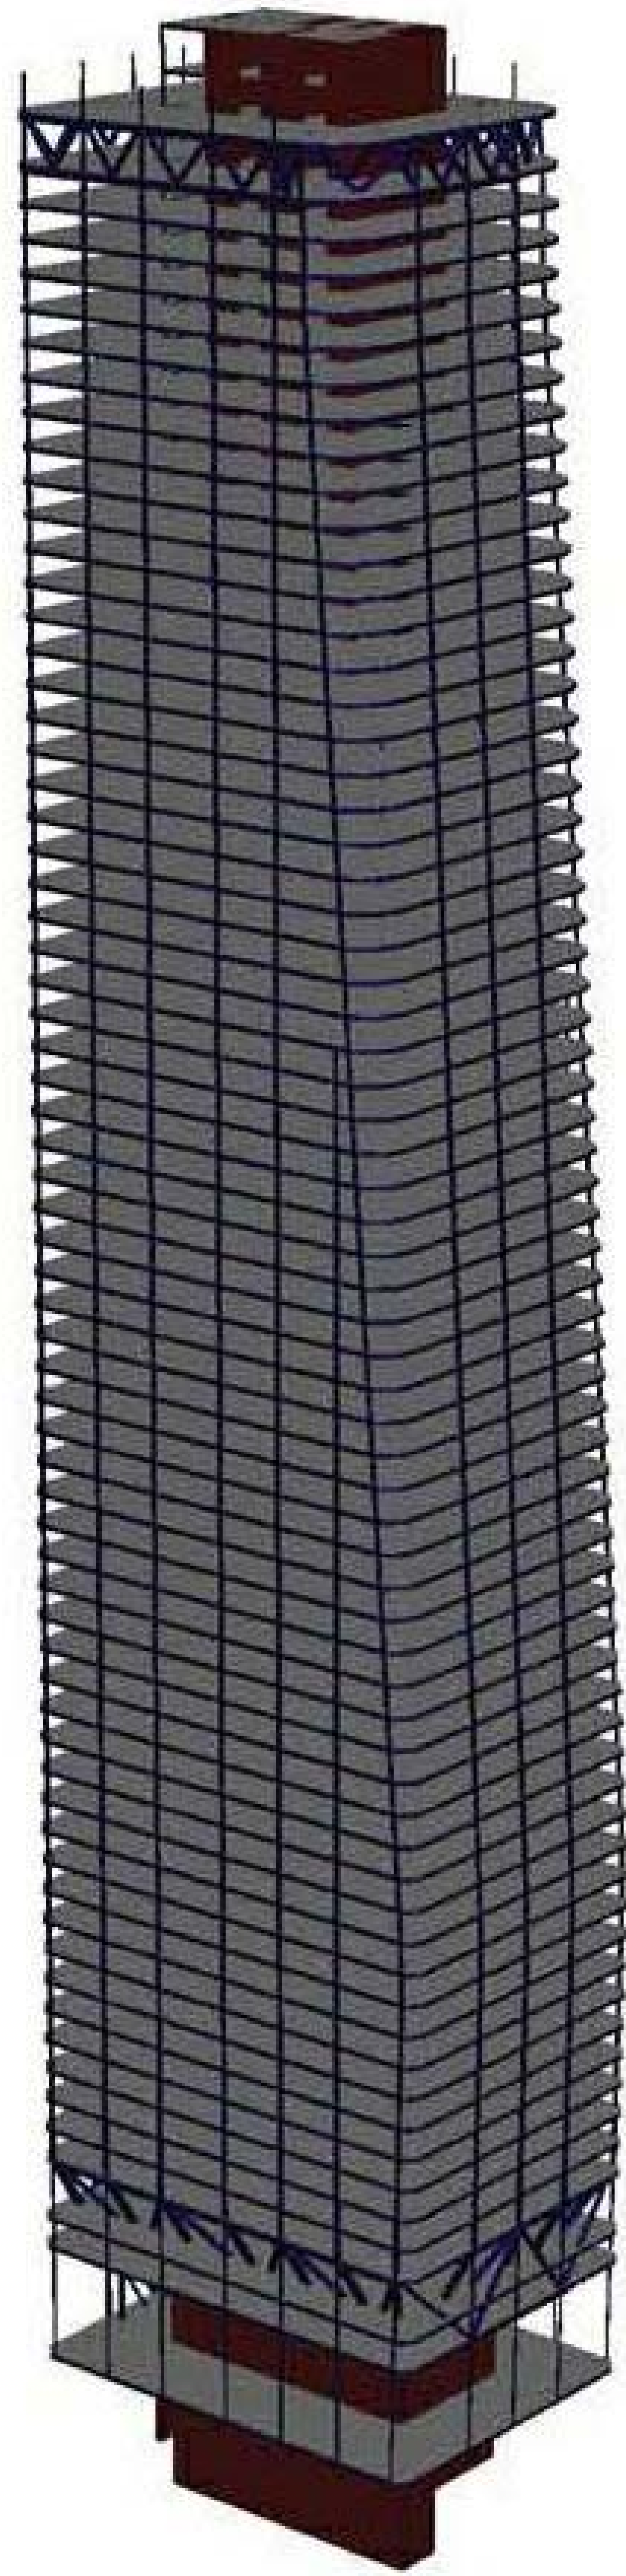

OVERALL STRUCTURAL SYSTEM

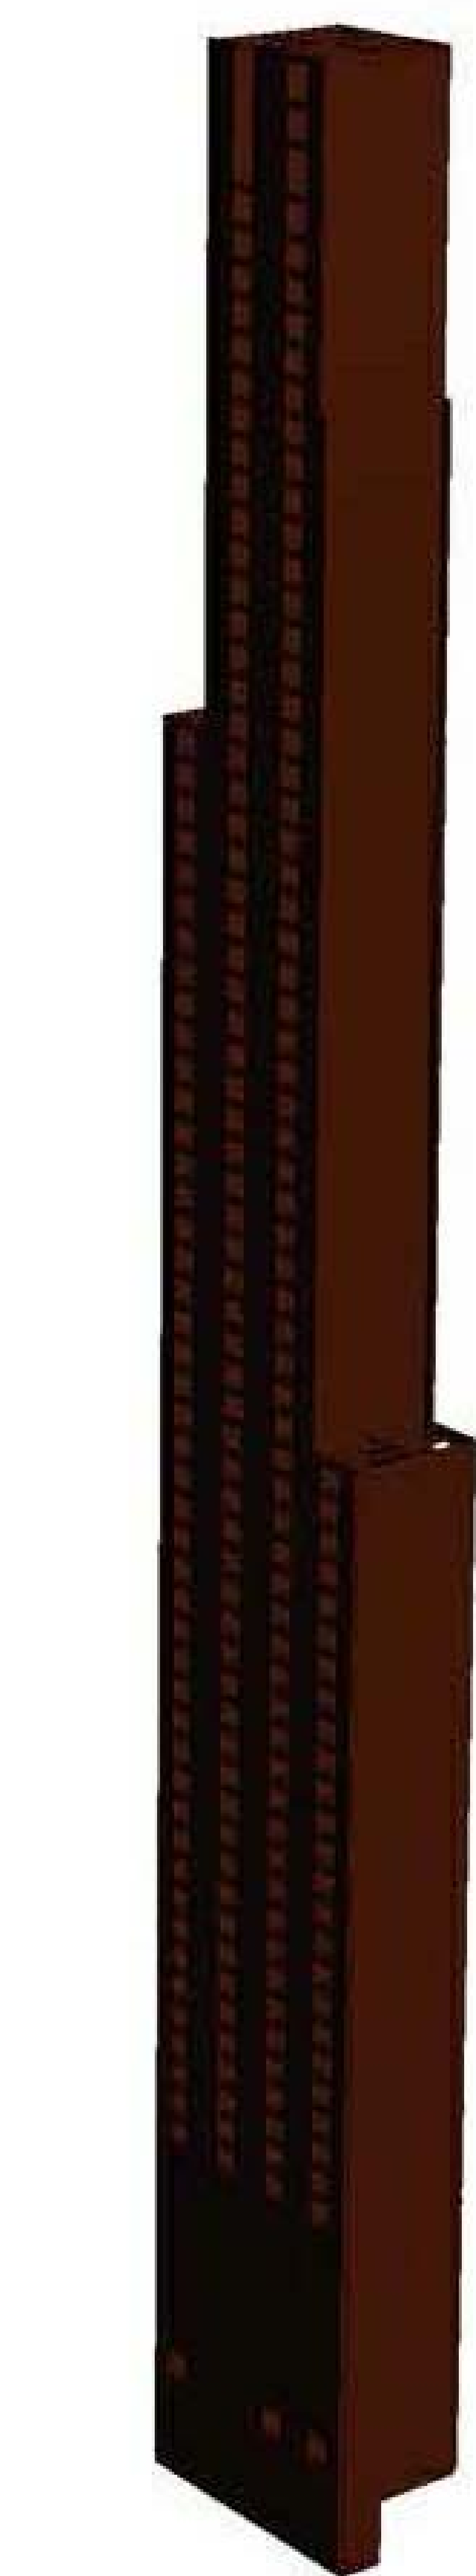

REINFORCED CONCRETE CORE WALLS

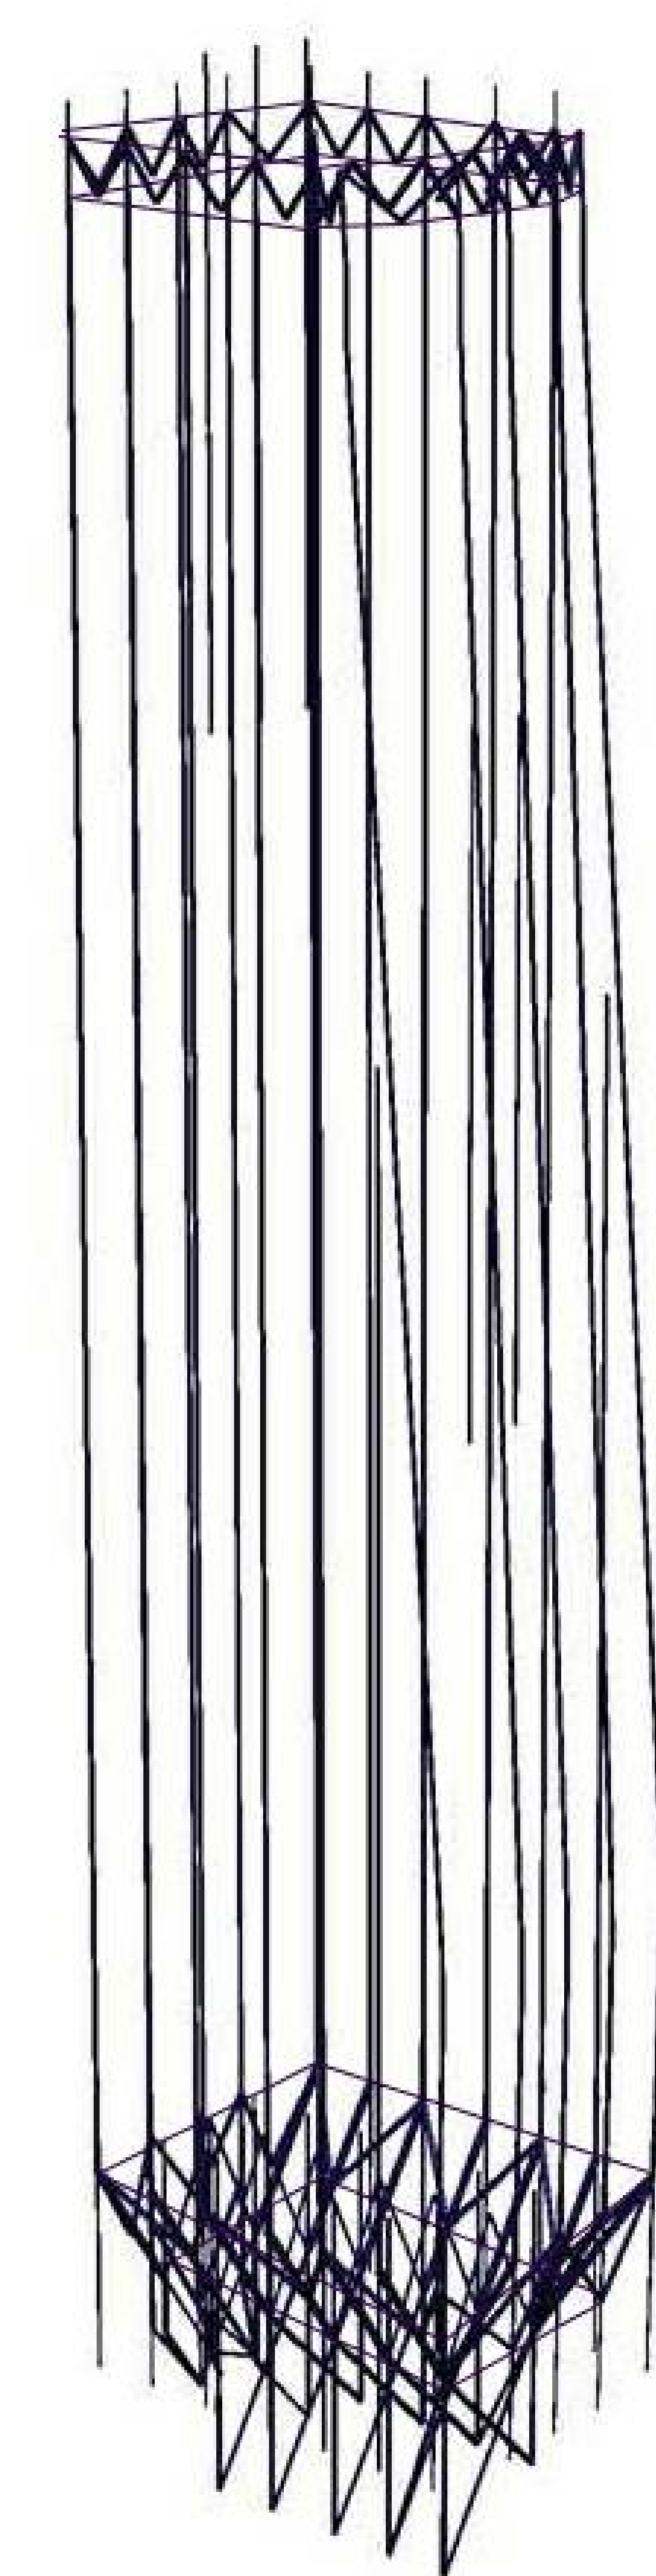

STEEL COLUMNS, "KICKERS" & BELT TRUSSES



COMPOSITE DECK & STEEL FLOOR FRAMING

STRUCTURAL DRAWINGS		
DOB Sheet Number	DRAWING NAME	SCALE
S-001.00	STRUCTURAL SYSTEMS DRAWING AND SHEET LIST	NTS
S-002.00	TYPICAL STRUCTURAL SYMBOLS AND ABBREVIATIONS	NTS
S-003.00	EXCAVATION AND FOUNDATION NOTES	NTS
S-004.00	STRUCTURAL CONCRETE NOTES	NTS
S-005.00	STRUCTURAL STEEL AND METAL DECK NOTES	NTS
S-010.00	LOADING DIAGRAMS	NTS
S-011.00	LOADING DIAGRAMS	NTS
S-050.00	OVERALL LEVEL B PLAN	NTS
S-051.00	OVERALL GROUND FLOOR PLAN	NTS
S-092.00	FOUNDATION LOWER PLAN (TRACK LEVEL)	1/8"=1'-0"
S-093.00	FOUNDATION UPPER PLAN	1/8"=1'-0"
S-094.00	CELLAR B1 PITS FLOOR FRAMING PLAN	1/8"=1'-0"
S-095.00	CELLAR B1 FLOOR FRAMING PLAN - PART A	1/8"=1'-0"
S-096.00	CELLAR B1 FLOOR FRAMING PLAN - PART B	1/8"=1'-0"
S-097.00	CELLAR B FLOOR FRAMING PLAN - PART A	1/8"=1'-0"
S-098.00	CELLAR B FLOOR FRAMING PLAN - PART B	1/8"=1'-0"
S-100.00	GROUND FLOOR FRAMING PLAN - LOBBY - PART A	1/8"=1'-0"
S-101.00	GROUND FLOOR FRAMING PLAN - LOBBY - PART B	1/8"=1'-0"
S-102.00	2ND FLOOR FRAMING PLAN	1/8"=1'-0"
S-103.00	3RD FLOOR FRAMING PLAN	1/8"=1'-0"
S-104.00	4TH FLOOR FRAMING PLAN - MECHANICAL	1/8"=1'-0"
S-105.00	5TH FLOOR FRAMING PLAN - MECHANICAL MEZZANINE	1/8"=1'-0"
S-106.00	6TH FLOOR FRAMING PLAN - LOW-RISE	1/8"=1'-0"
S-116.00	16TH FLOOR FRAMING PLAN - TYPICAL LOW-RISE	1/8"=1'-0"
S-131.00	31ST FLOOR FRAMING PLAN - MID-RISE	1/8"=1'-0"
S-137.00	37TH FLOOR FRAMING PLAN - TYPICAL MID-RISE	1/8"=1'-0"
S-153.00	53RD FLOOR FRAMING PLAN - HIGH-RISE	1/8"=1'-0"
S-159.00	59TH FLOOR FRAMING PLAN - TYPICAL HIGH-RISE	1/8"=1'-0"
S-168.00	68TH FLOOR FRAMING PLAN - MECHANICAL	1/8"=1'-0"
S-169.00	68TH FLOOR FRAMING PLAN - MECHANICAL MEZZANINE	1/8"=1'-0"
S-170.00	ROOF FRAMING PLAN - MECHANICAL PENTHOUSE	1/8"=1'-0"
S-171.00	ROOF FRAMING PLAN	1/8"=1'-0"
S-201.00	TOWER ELEVATIONS	AS NOTED
S-202.00	TOWER ELEVATIONS	AS NOTED
S-203.00	TOWER SECTIONS	AS NOTED
S-204.00	TOWER SECTIONS	AS NOTED
S-301.00	CORE WALL CONT. FOOTING SECTIONS & DETAILS	AS NOTED
S-302.00	CORE WALL CONT. FOOTINGS SECTIONS & DETAILS	AS NOTED
S-307.00	SPREAD FOOTING SCHEDULE, SECTIONS & DETAILS	AS NOTED
S-310.00	WEST PERIMETER COLUMN FOUNDATION SECTIONS & DETAILS	AS NOTED
S-311.00	WEST PERIMETER COLUMN FOUNDATION SECTIONS & DETAILS	AS NOTED
S-315.00	FOUNDATION WALL ELEVATIONS	AS NOTED
S-316.00	FOUNDATION WALL SECTIONS & DETAILS	AS NOTED
S-317.00	FOUNDATION WALL SECTIONS & DETAILS	AS NOTED
S-318.00	FOUNDATION WALL SECTIONS & DETAILS	AS NOTED
S-325.00	SLAB-ON-GRADE SECTIONS & DETAILS	AS NOTED
S-340.00	REINFORCED CONCRETE CORE WALL SCHEDULE, SECTIONS & DETAILS	AS NOTED
S-341.00	TYPICAL REINFORCED CONCRETE WALL DETAILS	AS NOTED
S-342.00	CORE WALL REINFORCEMENT LAYOUT	AS NOTED
S-343.00	CORE WALL REINFORCEMENT LAYOUT	AS NOTED
S-344.00	CORE WALL REINFORCEMENT LAYOUT	AS NOTED
S-345.00	CORE WALL REINFORCEMENT LAYOUT	AS NOTED
S-346.00	CORE WALL REINFORCEMENT LAYOUT	AS NOTED
S-347.00	CORE WALL REINFORCEMENT LAYOUT	AS NOTED
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S-353.00	CORE WALL REINFORCEMENT LAYOUT	AS NOTED
S-354.00	CORE WALL REINFORCEMENT LAYOUT	AS NOTED
S-355.00	LINK BEAM SCHEDULES, SECTIONS & DETAILS	AS NOTED
S-356.00	LINK BEAM SECTION AND DETAILS	AS NOTED
S-360.00	CORE WALL ELEVATIONS ALONG LINE 3	AS NOTED
S-361.00	CORE WALL ELEVATIONS ALONG LINE 5	AS NOTED
S-362.00	CORE WALL ELEVATIONS ALONG LINE C	AS NOTED
S-363.00	CORE WALL ELEVATIONS ALONG LINE D	AS NOTED
S-364.00	CORE WALL ELEVATIONS ALONG LINE E	AS NOTED
S-365.00	CORE WALL ELEVATIONS ALONG LINE F	AS NOTED
S-366.00	CORE WALL ELEVATIONS ALONG LINE G	AS NOTED
S-367.00	CORE WALL ELEVATIONS ALONG LINE 4	AS NOTED
S-368.00	CORE WALL ELEVATIONS WITHIN SERVICE CORE BETWEEN LINES D & E	AS NOTED
S-370.00	REINFORCED CONCRETE BEAM SCHEDULE, SECTIONS & DETAILS	AS NOTED
S-375.00	REINFORCED CONCRETE SLAB SCHEDULE, SECTIONS & DETAIL	AS NOTED
S-401.00	STRUCTURAL STEEL COLUMN SCHEDULE, SECTIONS & DETAILS	AS NOTED
S-402.00	STRUCTURAL STEEL COLUMN SCHEDULE, SECTIONS & DETAILS	AS NOTED
S-405.00	KICKER COLUMNS AT CORE LINES C TO F - SCHEDULES, ELEVATIONS, SECTIONS & DETAILS	AS NOTED
S-406.00	KICKER COLUMNS AT CORE LINE G - SCHEDULES, ELEVATIONS, SECTIONS & DETAILS	AS NOTED
S-407.00	KICKER COLUMNS AT CORE LINE 3 & 5 SCHEDULES, ELEVATIONS, SECTIONS & DETAILS	AS NOTED
S-408.00	KICKER COLUMN AT LINE B - SCHEDULE, ELEVATIONS, SECTIONS & DETAILS	AS NOTED
S-409.00	COLUMNS & DIAGONALS ON LINE A BELOW LEVEL 6 - SECTIONS & DETAILS	AS NOTED
S-410.00	KICKER COLUMN SECTIONS & DETAILS	AS NOTED
S-411.00	COLUMNS & DIAGONALS EAST OF LINE J BELOW LEVEL 1 - SECTIONS & DETAILS	AS NOTED
S-415.00	LOWER BELT TRUSS SCHEDULES, SECTIONS & DETAILS	AS NOTED
S-416.00	UPPER BELT TRUSS SCHEDULES, SECTIONS & DETAILS	AS NOTED
S-417.00	BELT TRUSS SECTIONS & DETAILS	AS NOTED
S-420.00	TYPICAL STRUCTURAL STEEL SECTIONS & DETAILS	AS NOTED
S-421.00	TYPICAL STRUCTURAL STEEL SECTIONS & DETAILS	AS NOTED
S-422.00	RETAIL SECTIONS	AS NOTED
S-501.00	METAL DECK SLAB SCHEDULES, SECTIONS & DETAILS	AS NOTED

STRUCTURAL SYSTEM DESCRIPTION

A. FOUNDATIONS

1. Foundation System

The primary foundation system for the North Tower is a series of continuous reinforced concrete footings on rock supporting the Tower's central reinforced concrete core walls. These footings are excavated in the underlying rock beginning near the Track Level of the site. The nominal rock capacity at Track Level is 40 to 60TSP. The footings under the core will be embedded into the sound rock to enhance the allowable strength increases per the NYC Building Code. A significant number of rock anchor tie-downs will be required primarily under the north and south continuous footings of the core to resist the overturning forces from the applied wind loads. In addition to the continuous footings under the core, a mega column foundation will be constructed on the west face of the Tower to take the load from the perimeter columns which "kick" in from the north, south and west sides towards the middle of each face. These foundations are constructed near the B Level and occur just behind the existing retaining wall and Platform support structure.

B. SUPERSTRUCTURE

1. Gravity System

The North Tower will consist of seventy-one stories above grade and one below-grade level. Height above Plaza Level is currently anticipated to be approximately 995'. Typical floor-to-floor heights in the office floors will be 13'-6". The eastern face of the building curves back to the west over the height of the Tower leading to a smaller floor plan at the top.

The gravity system will utilize reinforced concrete slab on composite metal deck supported by structural steel floor beams and girders outside of the core wall system and one-way reinforced concrete beams and slabs within the core area. The floor beams and girders will frame to either perimeter columns, spandrel beams or the concrete core at the center of the building. The column elements will be rolled shapes where possible. Built-up structural steel column shapes will likely be required in the lower portions of the building where loads are the highest. The majority of exterior columns along grid line 1 and 7 will "kick back" to the concrete core below level 6. The mechanical floor will have in-plane bracing to take out the tension forces. Additional bracing is utilized below level 6 along grid line A and B, to take the shear force due to unbalanced live load cases. With all the gravity loads transferred back to the core, the uplift due to wind or seismic is also reduced. At the two major mechanical levels, structural steel belt trusses are used which aid in equalizing the columns loads. The belt trusses will also provide system redundancy for progressive collapse mitigation.

2. Lateral System

The lateral system will be a ductile reinforced concrete core system. The flange wall thickness varies from 54" to 24", and the web wall thickness varies from 24" to 18". The core wall concrete strength is 10000 psi at the lower portion and 8000 psi at upper portion for all the walls. The core walls are currently designed for wind loads based on the Wind Tunnel testing results from the 50% DD model extrapolated by SOM to the new height. Revised wind tunnel loads are pending.

PRELIMINARY STRUCTURAL QUANTITIES			
Gross Building Area (not including Slab-on-Grade)		1,934,000 sf (within Tower footprint)	
STRUCTURAL CONCRETE			
Foundations	Concrete Rebar	3200 cy 370 tons	0.04 cf/sf 0.38 psf
Core Walls/Link Beams Below Level 6	Concrete Rebar	9500 cy 1580 tons	0.13 cf/sf 1.63 psf
Core Walls/Link Beams Above Level 6	Concrete Rebar	29100 cy 4200 tons	0.41 cf/sf 4.34 psf
Composite Deck Slab	Concrete Rebar	20350 tons 650 tons	0.28 cf/sf 0.67 psf
Core Beams & Slabs	Concrete Rebar	6300 cy 580 tons	0.09 cf/sf 0.60 psf
Total Quantity	Concrete Rebar	68450 cy 10210 tons	0.96 cf/sf 10.56 psf
STRUCTURAL STEEL			
Columns Above Level 6		5600 tons	5.79 psf
Kicker Columns, Lower Belt Trusses, & Diagonals Below Level 6 (Including Embedded Steel)		4200 tons	4.34 psf
Upper Belt Trusses and Outrigger Trusses		1200 tons	1.24 psf
Floor Beams & Girders		7500 tons	7.76 psf
Embedded Steel in Link Beams		400 tons	0.41 psf
Connections		1700 tons	1.76 psf
Misc.		240 tons	0.25 psf
Total Quantity		20840 tons	21.55 psf

NOTES:

- The quantities given are anticipated and only include materials required for the primary structural system within the footprint of the tower. The quantities above exclude exterior cladding support, miscellaneous mechanical support framing, stairs, window washing framing, elevator framing, cooling tower framing, secondary services framing and framing for entrance canopies. Removable steel work required for temporary building stability or shoring during construction is also excluded. These quantities exclude additional concrete required for MEP pads, architectural curbs, pit walls, and additional reinforcement bar required for slab openings.
- The above quantities do include progressive collapse based on project security recommendations and direction from Brookfield.
- The above quantities do not include the structural components outside the footprint of the tower as documented in the structural drawings.
- The above quantities do not include seismic special detailing or blast requirements, if required.
- The above quantities do not include rock tie-downs.
- The above quantities do not include slab-on-grade.
- The baseline structure has been designed to accommodate the security criteria developed for this project which is more stringent than that currently required by NYC code.

This alternative would base the design on the approach outlined in the NYC code. The following preliminary tonnage savings are expected:

- Structural Steel Columns = 1900 tons (including connection allowances)
- Structural Steel Kicker Columns, Belt Trusses and Outrigger Trusses = 1400 tons (including connection allowances)



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MEP Engineering

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Acoustical Consultant

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Code Consultant


Code Consultants Professional Engineers PC
215 West 40th Street, 15th Floor, New York, NY 10018

Facade Maintenance Consultant


Entek Engineering LLC
186 Ames Street, Hackensack, NJ 07601

Wind Tunnel Consultant

Rowan Williams Davies & Irwin Inc.
650 Woodlawn Road West, Guelph Ontario, Canada N1K 1B6

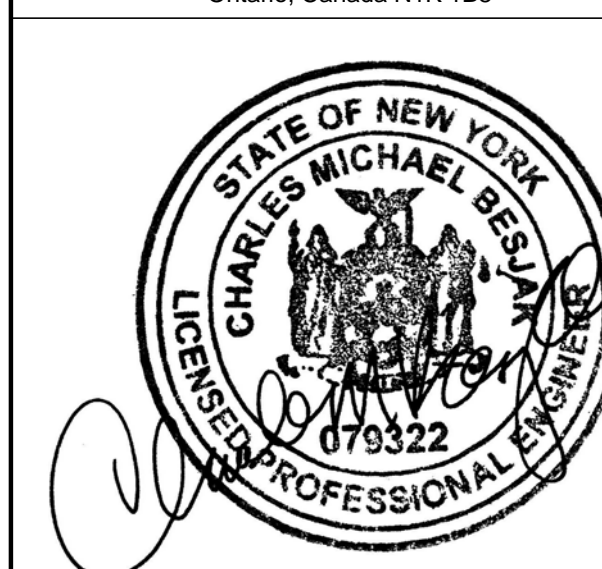

Key Plan:

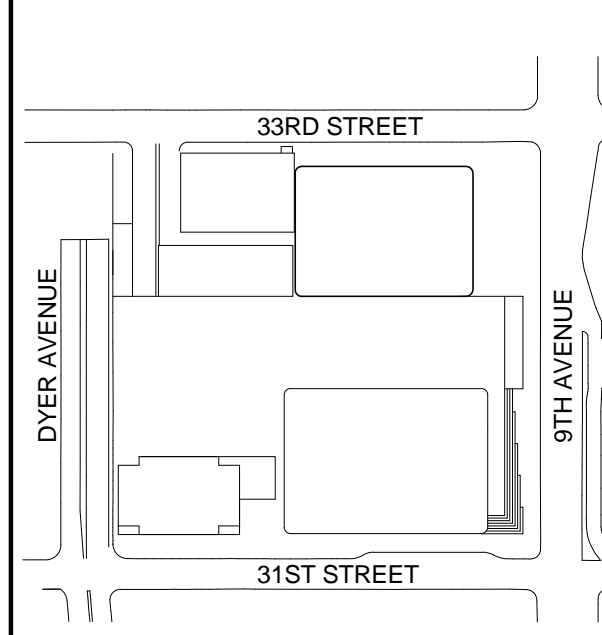

Seal & Signature:

PRELIMINARY
NOT FOR CONSTRUCTION

6	20 JUN 2014	ISSUED FOR FOUNDATION BID
5	20 JUN 2014	ISSUED FOR FOUNDATION PERMIT
4	20 DEC 2013	ISSUED FOR FOUNDATION PERMIT
3	15 NOV 2013	ISSUED FOR 50% PROGRESS PRICING
2	12 JUL 2013	ISSUED FOR 60% DESIGN DEVELOPMENT
1	18 MAR 2012	ISSUED FOR RECONCILIATION













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STRUCTURAL
SYSTEMS
DRAWING AND
SHEET LIST

Project No.: 211157	B-SCAN Sheet No.: S-001.00
Date: 20 JUN 2014	Sheet No.: S-001
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File No.: S-001	Page No.: 1 of 90



MANHATTAN WEST:
NORTH TOWER
375 Ninth Avenue, New York, NY 10001

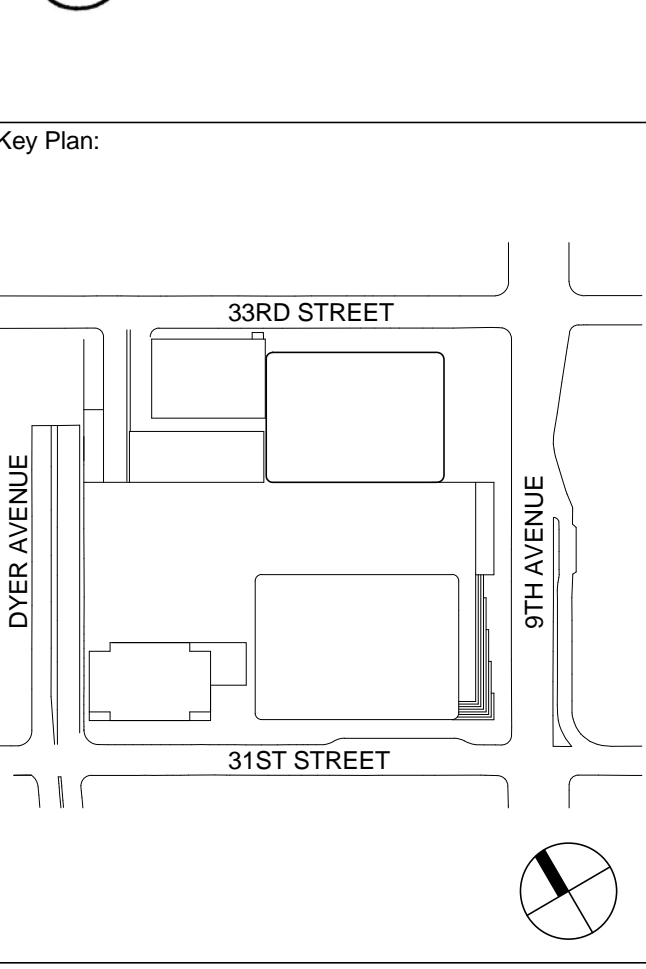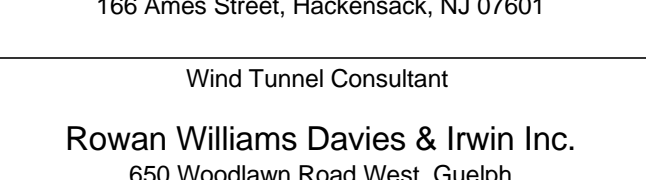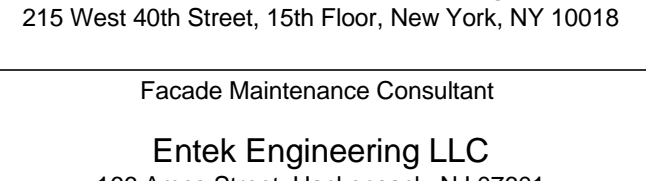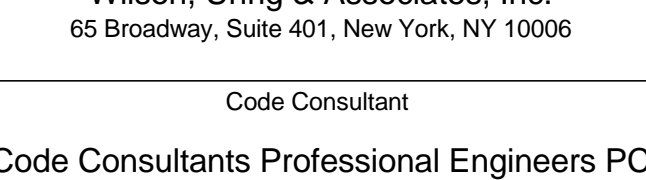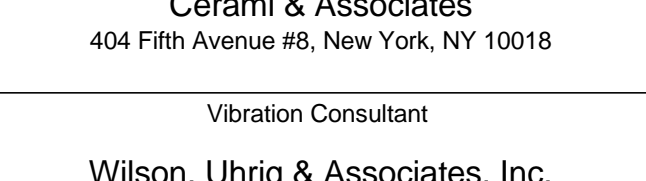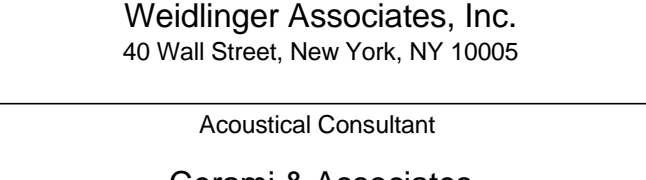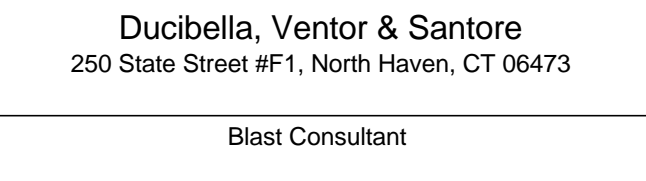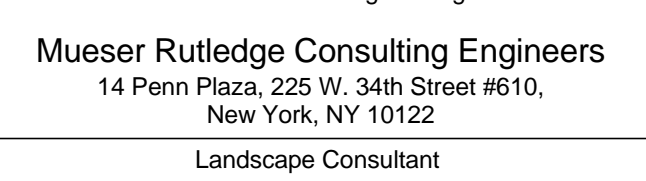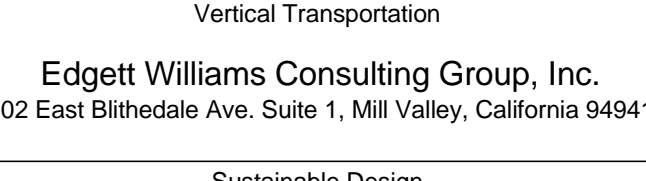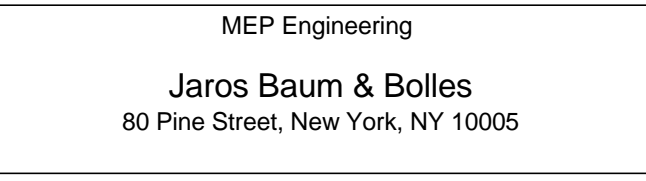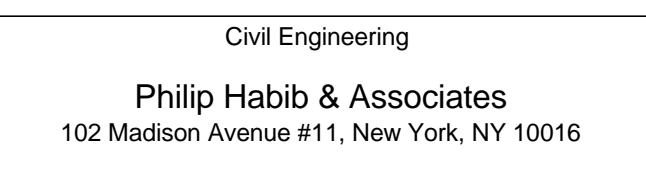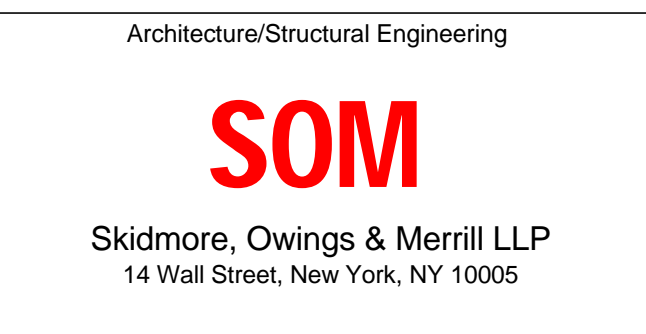

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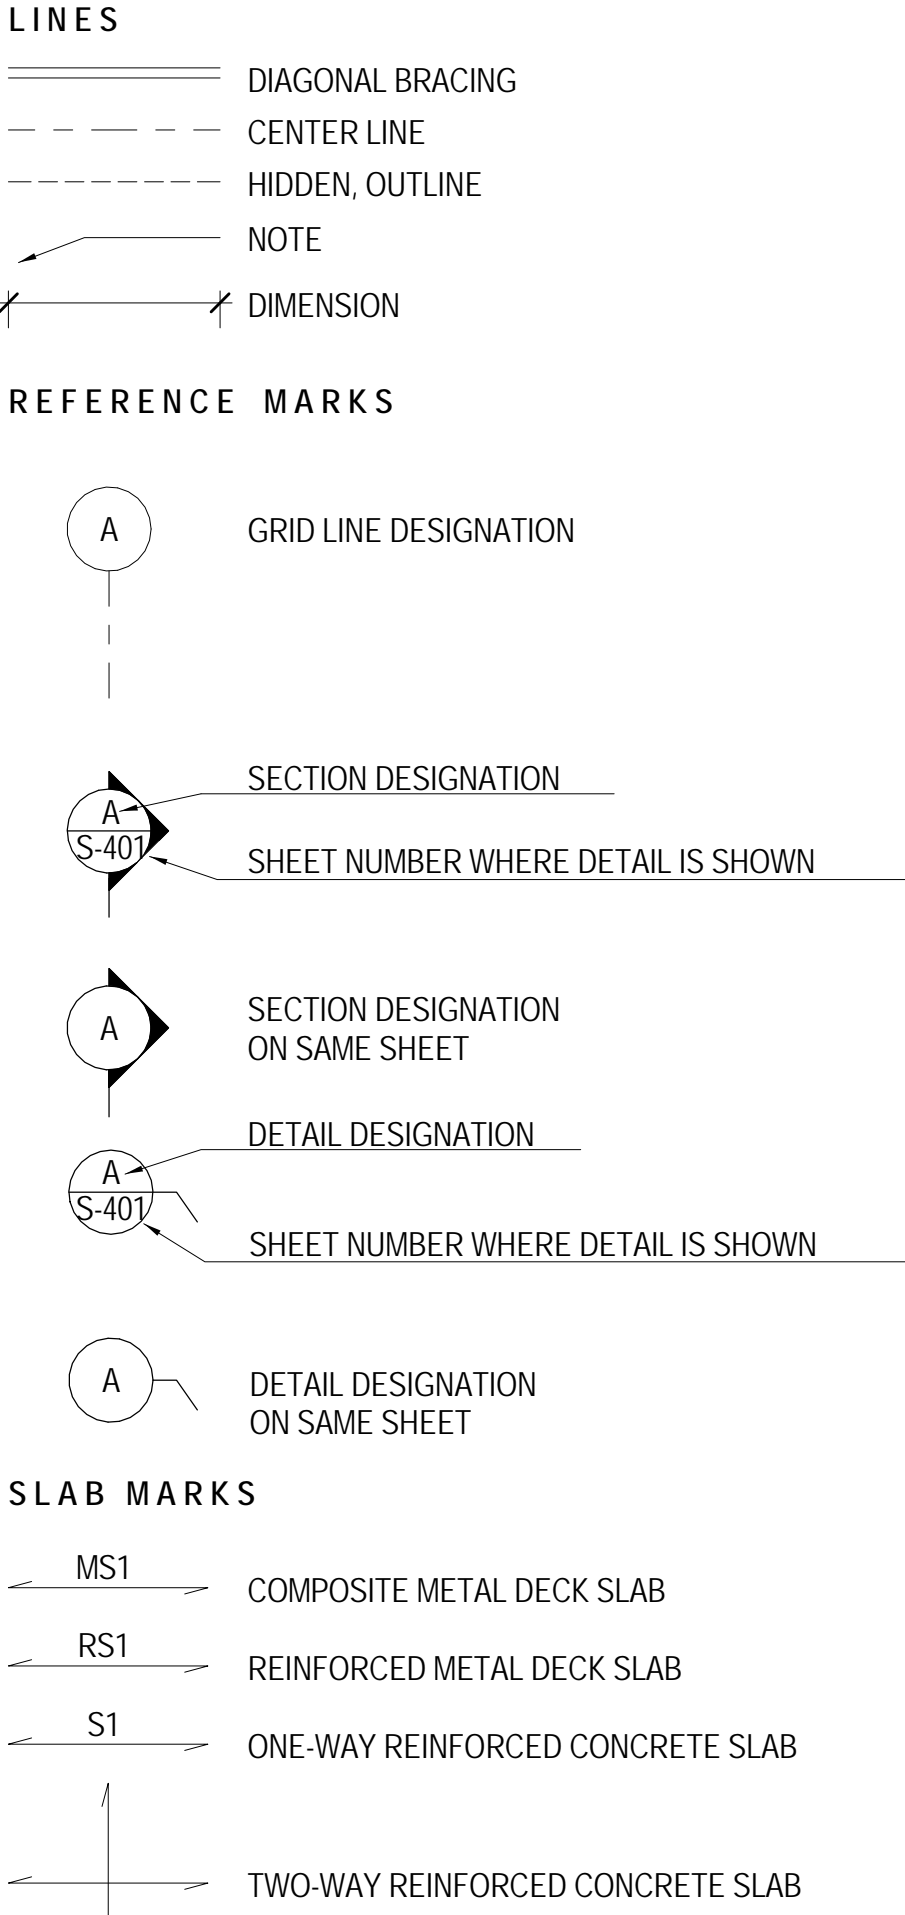
PRELIMINARY
NOT FOR CONSTRUCTION

6	20 JUN 2014	ISSUED FOR FOUNDATION BID
5	20 JUN 2014	ISSUED FOR FOUNDATION PERMIT
4	20 DEC 2013	ISSUED FOR FOUNDATION PERMIT
3	15 NOV 2013	ISSUED FOR 30% PROGRESS PRICING
2	12 JUL 2013	ISSUED FOR 90% DESIGN DEVELOPMENT
1	19 MAR 2012	ISSUED FOR RECONCILIATION


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TYPICAL
STRUCTURAL
SYMBOLS AND
ABBREVIATIONS





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Date: 20 JUN 2014	Sheet No.: S-002
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BASIC SYMBOLS					
BACK	FILLET	PLUG SLOT	GROOVE OR BUTT		
SUPPLEMENTARY SYMBOLS					
BACKING	WELD AROUND	FIELD WELD	CONTOUR FLUSH	CONVEX	



PAINT SYSTEM IDENTIFICATION	
II	INTERIOR EXPOSED STRUCTURAL STEEL WITH INTUMESCENT FIREPROOFING
IP	INTERIOR EXPOSED STRUCTURAL STEEL WITHOUT INTUMESCENT FIREPROOFING
EP	EXTERIOR EXPOSED STRUCTURAL STEEL
EC	EPOXY BARRIER COATING SYSTEM

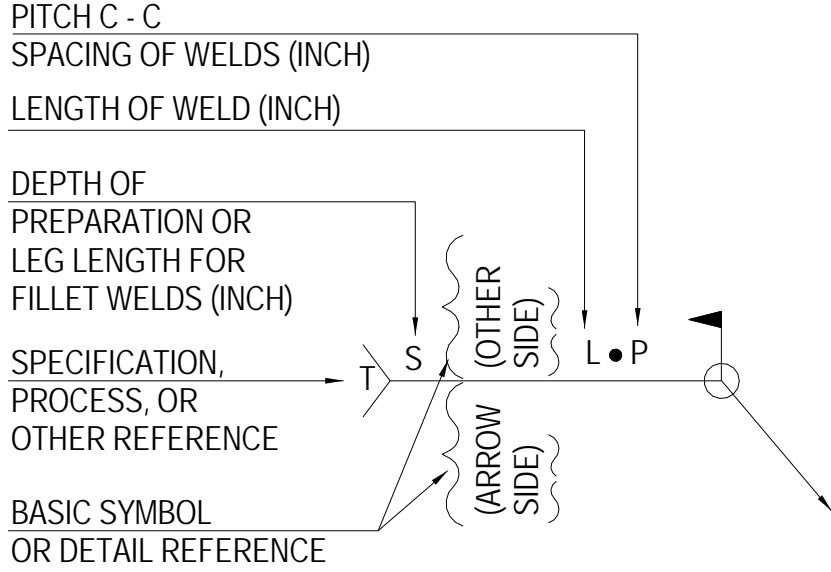

ABBREVIATIONS	
ACI	= AMERICAN CONCRETE INSTITUTE
AESS	= ARCHITECTURALLY EXPOSED STRUCTURAL STEEL
AISC	= AMERICAN INSTITUTE OF STEEL CONSTRUCTION
AISI	= AMERICAN IRON AND STEEL INSTITUTE
APPROX	= APPROXIMATE, APPROXIMATELY
ARCH	= ARCHITECT, ARCHITECTURAL
ASCE	= AMERICAN SOCIETY OF CIVIL ENGINEERS
ASTM	= AMERICAN SOCIETY OF CIVIL ENGINEERS
AWS	= AMERICAN WELDING SOCIETY
B/	= BOTTOM OF
C-C	= CENTER-TO-CENTER
CONC	= CONCRETE
CONT	= CONTINUOUS
CU	= CUBIC
DEG	= DEGREE
DIA	= DIAMETER
DIAG	= DIAGONAL
EA	= EACH
EW, EF	= EACH WAY, EACH FACE
EOS	= EDGE OF SLAB
E	= ELEVATOR SHAFT
EL	= ELEVATION
EXT	= EXTERIOR
FDN	= FOUNDATION
FTG	= FOOTING
GA	= GAUGE, GAGE
GALV	= GALVANIZED
HORIZ	= HORIZONTAL
HP	= HIGH POINT
HSS	= HOLLOW STRUCTURAL SHAPE
IBC	= INTERNATIONAL BUILDING CODE
INT	= INTERIOR
KIPS	= THOUSANDS OF POUNDS
KLF	= KIPS PER LINEAL FOOT
KSF	= KIPS PER SQUARE FOOT
KSI	= KIPS PER SQUARE INCH
LB(S)	= POUND(S)
LOC	= LOCATION
LLV	= LONG LEG VERTICAL
LLH	= LONG LEG HORIZONTAL
LWT	= LIGHTWEIGHT
M	= MECHANICAL SHAFT
MAX	= MAXIMUM
MEZZ	= MEZZANINE
MIN	= MINIMUM
MISC	= MISCELLANEOUS
NTS	= NOT TO SCALE
NWT	= NORMAL WEIGHT
O.C.	= ON CENTER
OPP.	= OPPOSITE
PERP	= PERPENDICULAR
PL	= PLATE
PLF	= POUNDS PER LINEAL FOOT
PSF	= POUNDS PER SQUARE FOOT
PSI	= POUNDS PER SQUARE INCH
REQD	= REQUIRED
REV	= REVISION, REVISED
S	= STAIR OPENING
S.C.	= SLIP-CRITICAL
SCHED	= SCHEDULE
SECT	= SECTION
SHT	= SHEET
SIM	= SIMILAR
SPEC	= SPECIFICATION
S.S.	= STAINLESS STEEL
STRUC	= STRUCTURE, STRUCTURAL
T/	= TOP OF
TYP.	= TYPICAL
U.N.O.	= UNLESS NOTED OTHERWISE
V.I.F.	= VERIFY IN FIELD
W/	= WITH
W/O	= WITHOUT
W.P.	= WORK POINT
W.W.F.	= WELDED WIRE FABRIC

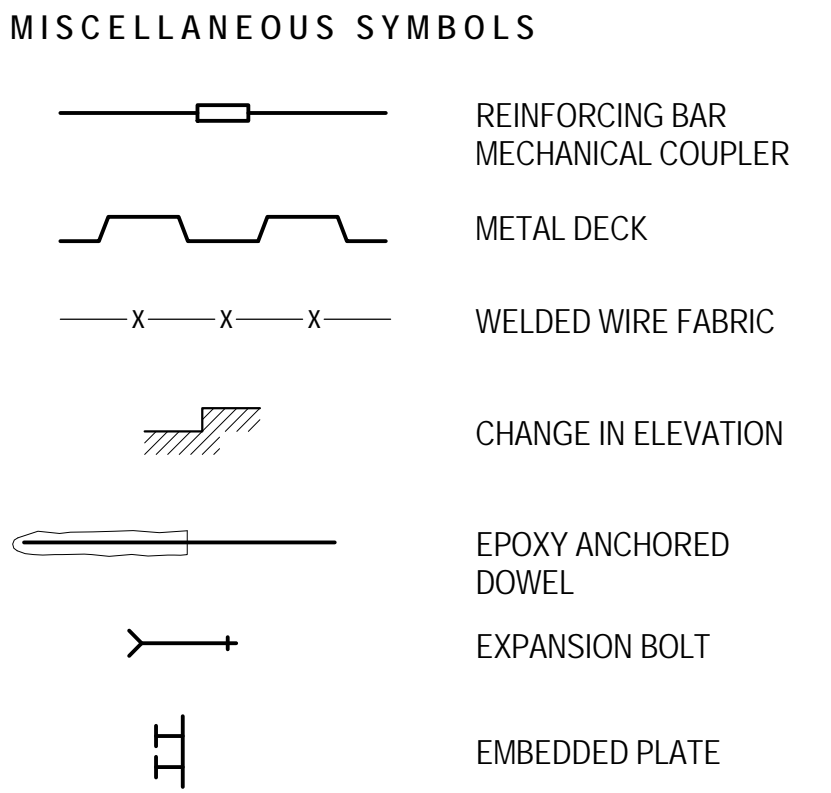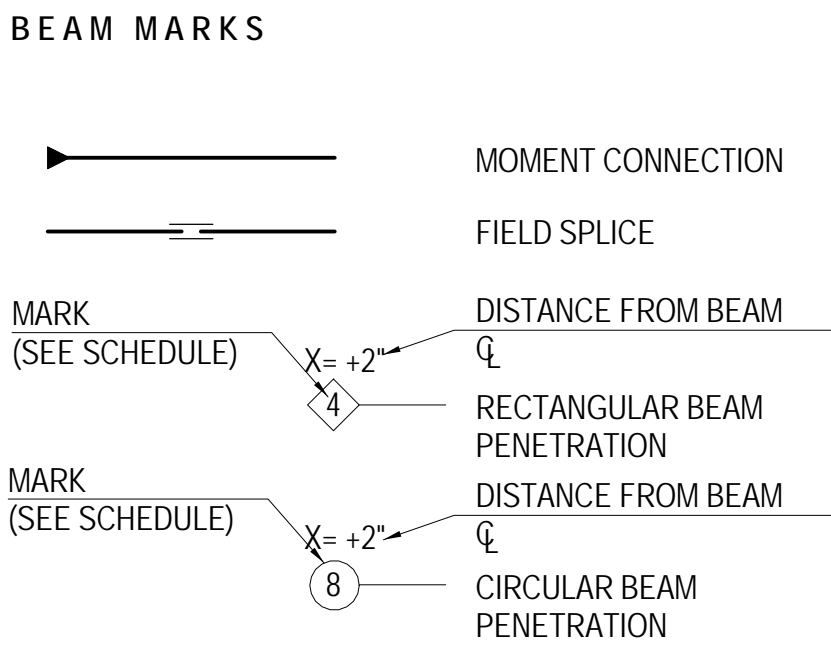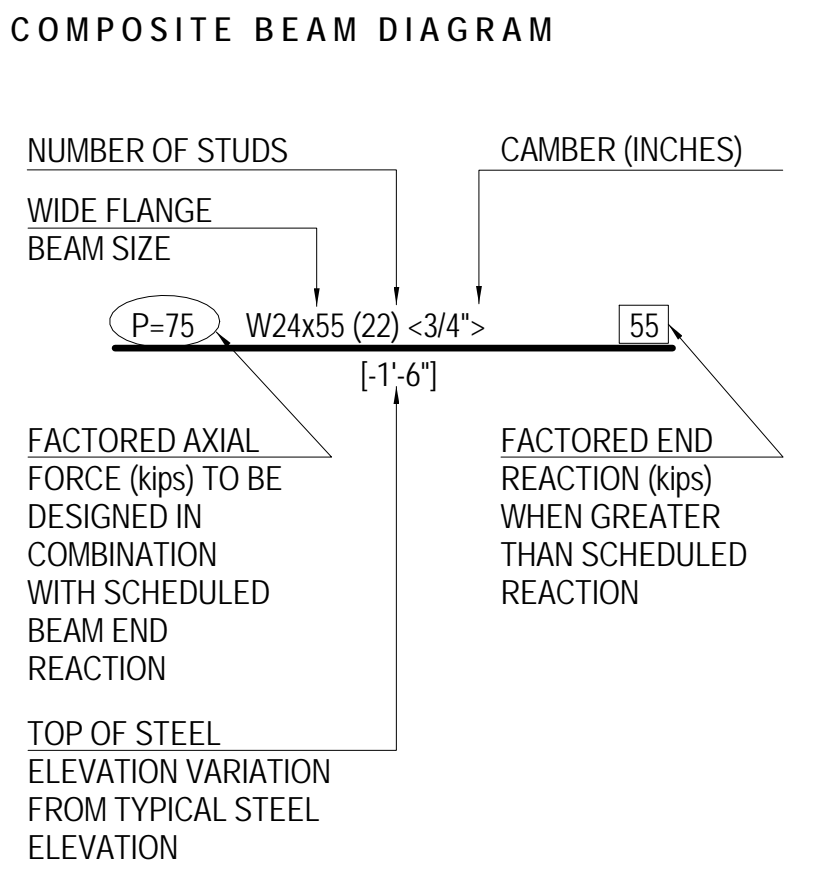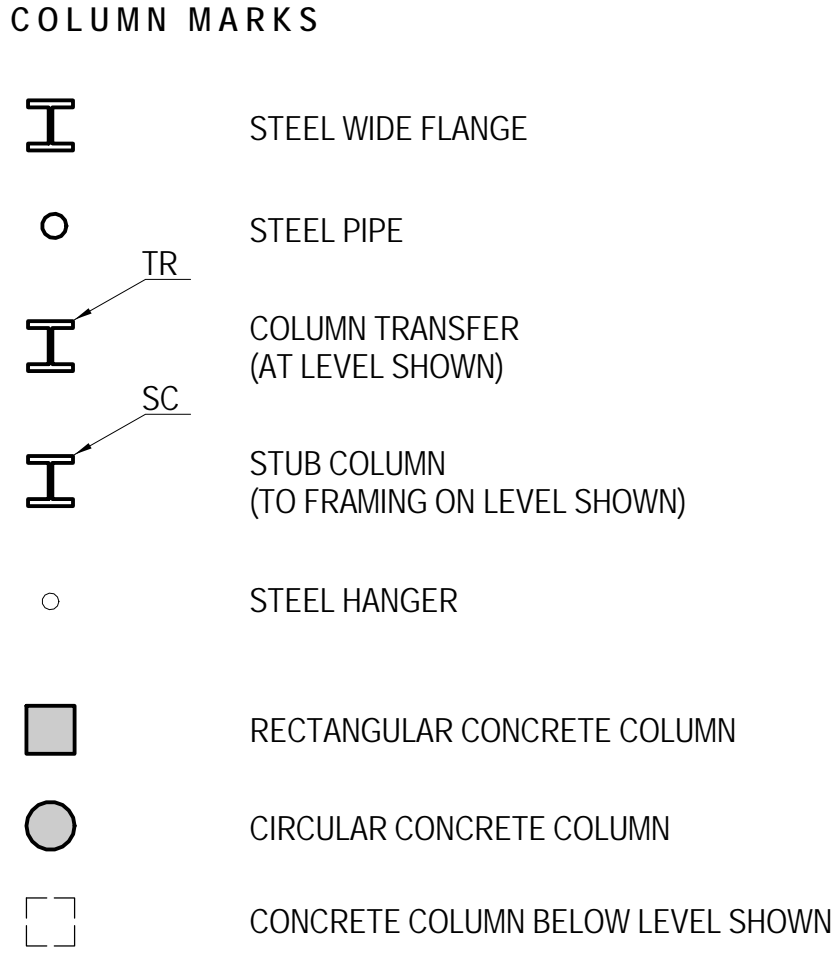GENERAL EXCAVATION NOTES

1. THE GENERAL EXCAVATION PROGRAM, INCLUDING METHODS, SEQUENCES, PROTECTION OF EXCAVATION SURFACES, ETC., SHALL BE THE COMPLETE AND SOLE RESPONSIBILITY OF THE CONTRACTOR. SOIL RETENTION SYSTEMS WILL BE REQUIRED IN ALL THE NON-ROCK EXCAVATION ZONES, ESPECIALLY ADJACENT TO ROADWAYS AND RAILROAD TRACKS. EXCAVATION-RETENTION SYSTEM DESIGN, INSTALLATION, MAINTENANCE, AND REMOVAL SHALL ALSO BE THE COMPLETE AND SOLE RESPONSIBILITY OF THE CONTRACTOR. THE CONTRACTOR SHALL PROVIDE ALL MEASURES AND PRECAUTIONS NECESSARY TO PREVENT DAMAGE AND MINIMIZE SETTLEMENT OF EXISTING OR NEW CONSTRUCTION INSIDE OR OUTSIDE THE PROJECT LIMITS. ANY DAMAGE TO NEW OR EXISTING CONSTRUCTION, INSIDE OR OUTSIDE OF THE PROJECT LIMITS, CAUSED BY EXCAVATION TECHNIQUES OR MOVEMENTS OF THE ANY SOIL RETENTION SYSTEM IS THE SOLE RESPONSIBILITY OF THE CONTRACTOR. WHEN EXCAVATION IS NEAR THE TRACKS, RAILROAD PROTECTION IS REQUIRED. WHEN EXCAVATION IS NEAR THE TRACKS, SUPPORT OF THE TRACKS IS REQUIRED.
2. THE CONTRACTOR SHALL RETAIN A LICENSED PROFESSIONAL ENGINEER IN THE STATE OF NEW YORK ACCEPTABLE TO THE ENGINEER-OF-RECORD TO DESIGN AND INSPECT THE ROCK EXCAVATION PROGRAM AND ANY EXCAVATION-RETENTION SYSTEM COMPONENTS, INCLUDING ALL MEASURES REQUIRED TO SUPPORT, EITHER PERMANENTLY OR TEMPORARILY, ADJACENT FOUNDATIONS, BUILDINGS, RAILROAD TRACKS, STREETS, PROPERTIES, SIDEWALKS, AND UTILITIES. THESE MEASURES INCLUDE UNDERPINNING, ROCK BOLTING, SHOTCRETING, TIEBACKS, SHEETING, AND SHORING.
3. THE ROCK EXCAVATION PROGRAM AND ANY EXCAVATION-RETENTION SYSTEMS SHALL BE DESIGNED AND INSTALLED IN ACCORDANCE WITH THE GEOTECHNICAL DESIGN PARAMETERS AND SOIL PRESSURES AS INDICATED IN THE GEOTECHNICAL EXPLORATION REPORT. REFER TO NOTE #19 BELOW.
4. SLOT OR LINE DRILL AS REQUIRED.
5. PLUG ALL SLEEPS & LENSES IN ROCK WITH GROUT AS REQUIRED.
6. BLASTING OPERATIONS SHALL COMPLY WITH ALL LOCAL & STATE LAWS, RULES AND REGULATIONS. ALL BLASTING OPERATIONS SHALL COMPLY WITH AMTRAK BLASTING SPECIFICATIONS.
7. BLASTING OPERATIONS SHALL COMPLY WITH THE RECOMMENDATIONS OF THE OWNERS BLAST CONSULTANT, ESPECIALLY WITH REGARD TO COORDINATING TIMING AND EFFECTS OF BLASTING WITH EXISTING RAILROAD OPERATIONS. ALL BLASTING OPERATIONS SHALL COMPLY WITH AMTRAK BLASTING SPECIFICATIONS.
8. AFTER CONCRETE HAS BEEN PLACED, BLASTING SHALL NOT OCCUR WITHIN A 50-FOOT RADIUS UNLESS WRITTEN PERMISSION IS OBTAINED FROM THE ENGINEER-OF-RECORD. ALL BLASTING OPERATIONS SHALL COMPLY WITH AMTRAK BLASTING SPECIFICATIONS.
9. THE CONTRACTOR SHALL COORDINATE ALL GENERAL EXCAVATION WORK AND ALL ELEMENTS OF ANY SOIL RETENTION SYSTEMS WITH ALL ELEMENTS OF THE PERMANENT BUILDINGS.
10. PRIOR TO ANY GENERAL EXCAVATION OR INSTALLATION OF ELEMENTS OF ANY SOIL RETENTION SYSTEM, THE CONTRACTOR SHALL ESTABLISH A GRID OF SURVEY POINTS AROUND THE PERIMETER OF THE AREA TO BE EXCAVATED, INCLUDING POINTS UP TO 200 FEET BEYOND THE PERIMETER AND POINTS ON ADJACENT EXISTING STRUCTURES TO REMAIN. THESE POINTS SHALL BE SURVEYED FOR VERTICAL AND HORIZONTAL MOVEMENT AT FREQUENT INTERVALS DURING ACTUAL EXCAVATION, AND CONTINUED DURING EACH SUBSEQUENT PHASE OF THE WORK, AND SUBMITTED TO THE ARCHITECT FOR INFORMATION. MONITORING POINTS WILL ALSO BE REQUIRED ON ALL RAILROAD TRACKS THAT HAVE ANY EXCAVATION OR DOWATERING ADJACENT TO THEM. A DETAILED MONITORING PROGRAM SHALL BE PREPARED AND SUBMITTED TO THE RAILROADS AS WELL AS THE RESULTS OF THE MONITORING PROGRAM.
11. EXCAVATION WORK SHALL BE BASED UPON ENGINEERED DRAWINGS PREPARED BY THE CONTRACTOR INCLUDING PLANS AND SECTIONS OF EXCAVATION SEQUENCES. THE EXCAVATION SEQUENCES SHALL BE CONTROLLED TO MATCH THE REQUIREMENTS OF ALL NEW AND EXISTING CONSTRUCTION WORK.
12. THE GENERAL EXCAVATION ACROSS THE SITE SHALL NOT EXTEND DEEPER THAN THE SLAB-ON-GRADE GRANULAR FILL SUBGRADE ELEVATION. THE DEEPER EXCAVATIONS FOR GRADE BEAMS, SPREAD FOOTINGS, PITS, ETC., SHALL BE EXCAVATED ON AN INDIVIDUAL, LOCALIZED BASIS DOWN FROM THE SLAB-ON-GRADE SUBGRADE.
13. THE CONTRACTOR SHALL BE RESPONSIBLE FOR THE DESIGN OF ANY STRUCTURAL COMPONENTS WHICH ARE TO RESIST TEMPORARY LOADS AS PART OF THE CONTRACTOR'S EXCAVATION-RETENTION PROGRAM.
14. EXCAVATION BELOW THE SLAB LEVEL REQUIRED FOR PITS SHALL BE RETAINED BY LOCALIZED EXCAVATION-RETENTION SYSTEMS, AS MAY BE NECESSARY, BASED ON THE CONTRACTOR'S DESIGN USING APPROPRIATE EARTHROCK AND HYDRAULIC PRESSURES AS INDICATED IN THE GEOTECHNICAL EXPLORATION REPORT, AND OTHER CONSTRUCTION LOADING.
15. THE CONTRACTOR SHALL PROVIDE POSITIVE PROTECTION (MATS/SHEET COVERINGS), FOR ALL EXCAVATION FACES, TO PROTECT FACES FROM INSTABILITY AND DETERIORATION DUE TO RAIN, WIND OR SNOWICE.
16. THE CONTRACTOR SHALL PROVIDE SURFACE DRAINAGE CHANNELS AND SUMPS AND SUMP PUMPS TO PROTECT ALL EXCAVATIONS FROM FLOODING. FLOODING OF ANY EXCAVATION AFTER APPROVAL OF ANY SUBGRADE WILL BE CAUSE FOR THE COMPLETE REPREPARATION AND APPROVAL OF THE SUBGRADE, INCLUDING REMOVAL OF CONCRETE MUD SLABS, IF ANY EXIST. NO DISCHARGE OF ANY DEWATERING OPERATION IS TO BE MADE ONTO AMTRAK PROPERTY. IF THE CONTRACTOR DISCHARGES ANY WATER INTO EXISTING STORMWATER FACILITIES ON AMTRAK, THEN THE CONTRACTOR IS TO PROVIDE PROOF THAT THE SYSTEM CAN HANDLE THE FLOWS. UPON THE COMPLETION OF THE DEWATERING, THE CONTRACTOR IS TO CLEAN PIPES OF ALL DEBRIS THAT HAS ACCUMULATED AS A RESULT OF THE DEWATERING OPERATION.
17. AFTER COMPLETION OF EACH EXCAVATION PHASE, IN EACH AREA, THE SITE SHALL BE DEWATERED, AS REQUIRED, BEFORE (OR AS) THE EXCAVATION PROCEEDS. THE CONTRACTOR SHALL PROVIDE ALL CONSTRUCTION AND EQUIPMENT FOR THE DEWATERING SYSTEM INCLUDING, BUT NOT LIMITED TO, TRENCHES, SUMPS, DEWATERING WELLS, WELL POINTS, OBSERVATION WELLS, PUMPING SYSTEM, DISPOSAL LOCATION, SETTLING BASINS, MAINTENANCE AND EMERGENCY BACK-UP EQUIPMENT, ETC. AT ALL TIMES, THE DEWATERING SYSTEM SHALL MAINTAIN THE WATER LEVEL A MINIMUM OF 3 FEET BELOW THE DEEPEST FOUNDATION SUBGRADE. THE DEWATERING SYSTEM SHALL BE MAINTAINED UNTIL ALL LOWER LEVEL AND GROUND FLOOR SLABS, PERIMETER WALLS AND WATERPROOFING ARE INSTALLED AND THE PERMANENT BUILDING DRAINAGE SYSTEM IS FULLY OPERATIONAL.
18. THE OWNER'S SOIL TESTING AGENCY SHALL REVIEW AND CONTINUOUSLY MONITOR THE EXCAVATION, DEWATERING AND SOIL RETENTION SYSTEMS. THE CONTRACTOR SHALL INSTALL AND CONTINUOUSLY SURVEY: (A) VERTICAL AND HORIZONTAL MOVEMENTS OF THE TOP OF THE SOIL RETENTION SYSTEM; (B) BENCH MARKS ADJACENT TO AND AWAY FROM THE SITE PERIMETER FOR VERTICAL AND HORIZONTAL MOVEMENTS; (C) INCLINOMETERS INSTALLED ALONG THE PERIMETER OF THE EXCAVATION, PRIOR TO THE START OF EXCAVATION; AND (D) OBSERVATION WELLS FOR MONITORING WATER LEVELS BELOW GROUND SURFACE. REFER TO FINAL SOIL CONSULTANT'S REPORT FOR MONITORING REQUIREMENTS.
19. ALL WORK IS SUBJECT TO CONTROLLED INSPECTION AS REQUIRED BY THE NEW YORK CITY BUILDING CODE.
20. A GEOTECHNICAL EXPLORATION REPORT, INCLUDING SOIL AND ROCK BORING DATA, HAS BEEN PREPARED BY MUESER RUTLEDGE CONSULTING ENGINEERS, 14 PENN PLAZA, 225 WEST 34TH STREET, NEW YORK, NY 10122.
21. FOR ADDITIONAL REQUIREMENTS, SEE SPECIFICATIONS.

312300	EXCAVATION & FILL
312316.26	ROCK EXCAVATION
312319	CONSTRUCTION DEWATERING
312313	ROCK GROUTING
315100	EXCAVATION SUPPORT AND PROTECTION
316813	ROCK FOUNDATION ANCHORS
334619	UNDERSLAB DRAINAGE PIPING
071000	FOUNDATION WATERPROOFING

22. THE CONTRACTOR SHALL BE RESPONSIBLE FOR THE DESIGN OF ANY STRUCTURAL COMPONENTS WHICH ARE TO RESIST TEMPORARY LOADS AS PART OF THE CONTRACTOR'S EXCAVATION-RETENTION PROGRAM.

GENERAL FOUNDATION NOTES

1. FOUNDATION DESIGN AND CONSTRUCTION SHALL BE IN ACCORDANCE WITH THE NEW YORK CITY BUILDING CODE LATEST EDITION, EXCEPT AS VARIANCES ARE OBTAINED.
2. THE GEOTECHNICAL REPORT BY MRCE CONTAINING BORING AND TEST PIT INFORMATION IS PROVIDED FOR INFORMATION.
3. THE FOUNDATION OF THE BUILDING CONSISTS OF:
 - LARGE "MEGA COLUMN" FOUNDATION WALL
 - SPREAD FOOTINGS
 - STRIP FOOTINGS
4. FOOTINGS AND GRADE BEAMS SHALL BE FOUNDED UPON UNDISTURBED, NATURAL ROCK SUBGRADE WITH A MINIMUM ALLOWABLE BEARING CAPACITY OF 20 TSF TO 40 TSF AS INDICATED ON THE DRAWINGS. THE BOTTOM OF THE FOOTING ELEVATIONS AND ROCK BEARING CAPACITIES AS SHOWN ON THE DRAWINGS ARE ESTIMATED FROM THE ROCK BORING DATA. FINAL EXACT BEARING ELEVATIONS SHALL BE FIELD DETERMINED AND ROCK BEARING CAPACITIES VERIFIED BY THE OWNERS SOIL TESTING LABORATORY DURING CONSTRUCTION.
5. THE ROCK SUBGRADE FOR ALL FOOTINGS, GRADE BEAMS, AND SLABS SHALL BE INSPECTED AND APPROVED BY THE OWNERS TESTING AGENCY IMMEDIATELY PRIOR TO PLACING FOUNDATION CONCRETE OR CONCRETE MUD SLABS.
6. ALL ORGANIC AND/OR OTHER UNSUITABLE MATERIALS SHALL BE REMOVED FROM FOUNDATION AND SLAB SUBGRADES AND BACKFILL AREAS, AND THEN BACKFILLED WITH LEAN CONCRETE (f_c=2000 psi).
7. PROVIDE TEMPORARY BRACING FOR ALL BASEMENT WALLS, IN ACCORDANCE WITH THE GEOTECHNICAL DESIGN PARAMETERS AND SOIL PRESSURES AS INDICATED IN THE GEOTECHNICAL EXPLORATION REPORT. UNTIL THE GROUND FLOOR AND LOWER LEVEL SLABS HAVE BEEN PLACED, AND THE CONCRETE HAS ATTAINED FULL DESIGN STRENGTH.
8. NO MUD SLABS, FOOTINGS OR STRUCTURAL SLABS SHALL BE PLACED INTO OR AGAINST SUBGRADES CONTAINING FREE WATER, FROST OR ICE. SHOULD WATER OR FROST ENTER A FOOTING/MUD SUBSTRUCTURAL SLAB EXCAVATION AFTER SUBGRADE APPROVAL, THE SUBGRADE SHALL BE RESPECTED BY THE OWNERS SOIL TESTING AGENCY AFTER REMOVAL OF WATER, FROST, OR ICE.
9. THE CONTRACTOR SHALL PROVIDE ALL NECESSARY MEASURES TO PREVENT ANY WATER, FROST, OR ICE FROM PENETRATING ANY FOOTING OR STRUCTURAL MUD SLAB SUBGRADE BEFORE AND AFTER PLACING OF CONCRETE, AND UNTIL SUCH SUBGRADES ARE FULLY PROTECTED BY THE PERMANENT BUILDING STRUCTURE.
10. ALL SLAB AND FOOTING MUD SLABS SHALL BE THOROUGHLY CLEANED IMMEDIATELY PRIOR TO CONCRETE PLACEMENT.
11. THE CONCRETE FOR EACH ISOLATED OR COMBINED FOOTING SHALL BE PLACED IN ONE (1) CONTINUOUS POUR.
12. SLABS ON-GRADE SHALL BE PLACED OVER A CONTINUOUS VAPOR BARRIER OVER A MINIMUM OF 8" COMPACTED GRANULAR MATERIAL.
13. SEE PLUMBING AND CIVIL DRAWINGS FOR UNDERFLOOR AND PERIMETER WALL DRAINAGE SYSTEMS, AND SPECIAL GRANULAR FILL MATERIALS FOR SUCH DRAINAGE SYSTEMS.
14. SEE ARCHITECTURAL DRAWINGS FOR ALL WATERPROOFING AND DAM PROOFING DETAILS.
15. ELEVATIONS ON THE FOUNDATION PLANS ARE GIVEN RELATIVE TO THE NORTH AMERICAN VERTICAL DATUM OF 1988 (NAV88). FOR REFERENCE, 0.0' NAV88 = 301.675' PENN RAIL ROAD TUNNELS DATUM.

GEOTECHNICAL ASSUMPTIONS:

1. ALL FOUNDATION DESIGNS ARE BASED ON RECOMMENDATIONS PROVIDED BY MRCE PRIOR TO THE FINAL GEOTECHNICAL REPORT AND ON THE FINAL GEOTECHNICAL REPORT TITLED "FOUNDATION DESIGN RECOMMENDATIONS, 5TH AVENUE DEVELOPMENT, NEW YORK, NEW YORK" DATED JUNE 10,2008, EXCEPT AS NOTED IN ITEM 3 BELOW.
2. THE TOP 1'-0" OF ROCK BELOW BALLAST IS ASSUMED TO BE TOO FRACTURED TO PROVIDE RESISTANCE TO LOAD.
3. ALLOWABLE ROCK BEARING CAPACITY AT TRACK LEVEL HAS BEEN ASSUMED TO BE 60 TSF. THIS IS TO BE VERIFIED BY ADDITIONAL BORINGS BY MRCE.
4. ALLOWABLE ROCK BEARING CAPACITY NEAR LEVEL B1 HAS BEEN ASSUMED TO BE 40 TSF.
5. AN ALLOWABLE ROCK BEARING CAPACITY INCREASE OF 10% PER FOOT OF EMBEDMENT INTO ROCK (BEYOND THE FIRST FOOT) UP TO A 100% INCREASE HAS BEEN ASSUMED IN MOST CASES REGARDLESS OF THE ELEVATION OF THE ROCK.
6. FOR TENSION RESISTANCE, UNIT WEIGHT OF BUOYANT ROCK ASSUMED TO BE 100 pcf.
7. LATERAL LOADS APPLIED TO THE TOPS OF FOOTINGS BY THE STRUCTURE ARE ASSUMED TO BE TRANSFERRED TO THE ROCK ENTIRELY THROUGH FRICTION ON THE SIDE AND BOTTOM OF THE FOOTING AND PASSIVE PRESSURE RESISTANCE OF THE ROCK AGAINST THE FOOTING.
8. TENSION CAPACITY BASED ON A FAILURE CONE OF 45° FROM THE BOTTOM OF THE CAISSON SHAFT.
9. B/FRICTIONLESS CAISSON SHAFT ELEVATIONS INDICATED ON THE DRAWINGS HAVE BEEN BASED UPON THE FOLLOWING:
 - THE ASSUMPTION PROVIDED BY MRCE THAT NO ADDITIONAL SURCHARGE LOAD MAY BE APPLIED TO THE EXISTING ROCK BOLTED RETAINING WALLS.
 - THE ASSUMPTION PROVIDED BY MRCE OF A 1:2 INFLUENCE LINE EXTENDING FROM THE INTERFACE OF THE WALL AND THE ROCK AT THE BOTTOM OF THE EXISTING RETAINING WALL.
 - ASSUMED LOCATION OF THE EXISTING RETAINING WALL BASED UPON SURVEY DATA PROVIDED BY MEDINA.
10. ADDITIONAL ROCK BOLTS INTO THE EXISTING RETAINING WALL ARE ASSUMED TO BE ADDED AS REQUIRED.
11. THE TOP OF FOOTING ELEVATION ARE GENERALLY ASSUMED TO MATCH THE TOP OF SOUND ROCK ELEVATION.
12. T/FOUNDATION ELEVATIONS INDICATED ON THE DRAWINGS HAVE BEEN BASED UPON THE FOLLOWING INFORMATION:
 - TRAIL PROFILE AND OFFSET FROM TRAIL TO T/ROCK SHOWN ON "TERMINAL STATION WEST, TYPICAL SECTIONS, CONTRACT DRAWING NO. 2112B" DATED FEBRUARY 1906 WITH REVISIONS ON SEPT. 20, 1907 AND NOV. 15, 1909 FOR THE PENNSYLVANIA, NEW YORK AND LONG ISLAND RAILROAD COMPANY.
 - FOUNDATION AND DRAINAGE CONFLICT ANALYSIS PERFORMED BY TURNER AND EVALUATED BY PARSONS BRINCKERHOFF RECEIVED BY SOM ON 24 APRIL, 2008.
 - T/SOUND ROCK ELEVATIONS PROVIDED BY MRCE IN THE FINAL GEOTECHNICAL REPORT.



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Brookfield

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14 Wall Street, New York, NY 10005

Civil Engineering
Philip Habb & Associates
102 Madison Avenue #11, New York, NY 10016

MEP Engineering
Jaros Baum & Bolles
80 Pine Street, New York, NY 10005

Vertical Transportation
Edgett Williams Consulting Group, Inc.
102 East Bliffedale Ave. Suite 1, Mill Valley, California 94041

Sustainable Design
Viridian Energy & Environmental
50 Washington Street, Norwalk, CT 06854

Geo-Technical Engineering
Mueser Rutledge Consulting Engineers
14 Penn Plaza, 225 W. 34th Street #610,
New York, NY 10122

Landscape Consultant
Field Operations
475 10th Avenue, New York, NY 10018

Security Consultant
Ducibella, Venter & Santore
250 State Street #F1, North Haven, CT 06473

Blast Consultant
Weidlinger Associates, Inc.
40 Wall Street, New York, NY 10005

Acoustical Consultant
Cerami & Associates
404 Fifth Avenue #8, New York, NY 10018

Vibration Consultant
Wilson, Uhrig & Associates, Inc.
65 Broadway, Suite 401, New York, NY 10006

Code Consultant
Code Consultants Professional Engineers PC
215 West 40th Street, 15th Floor, New York, NY 10018

Facade Maintenance Consultant
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Seal & Signature

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Excavation and Foundation Notes

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- CONCRETE NOTES
- A. GENERAL

1. SHOP DRAWINGS FOR FORMWORK AND REINFORCING SHALL BE APPROVED PRIOR TO FORMWORK CONSTRUCTION OR REINFORCING FABRICATION AND PLACEMENT.

2. IN ADDITION TO CAMBERS SHOWN, CAMBER FORMWORK TO COMPENSATE FOR DEFLECTION OF FORMS UNDER THE WET WEIGHT OF CONCRETE AS REQUIRED TO ACHIEVE THE SPECIFIED TOLERANCES.

3. SLAB ON GRADE THICKNESSES SHALL BE FIVE (5) INCHES FOR SIDEWALKS, SIX (6) INCHES FOR BASEMENT AND PLAZA SLABS, EIGHT (8) INCHES FOR AUTOMOBILE DRIVEWAY AREAS, AND TEN (10) INCHES FOR TRUCK TRAFFIC AREAS, UNLESS NOTED OTHERWISE.

4. CONCRETE BEAMS AND SLABS SHALL NOT BE SLEEVED, BOXED, BUT OUT OR HAVE THEIR REINFORCING INTERRUPTED EXCEPT AS SHOWN ON THE STRUCTURAL DRAWINGS.

5. EXPOSED CONCRETE CORNERS SHALL HAVE 3/4 INCH CHAMFERS UNLESS NOTED OTHERWISE.

6. REFER TO ARCHITECTURAL DRAWINGS FOR THE TYPE, SIZE AND LOCATION OF FLOOR FINISHES, FLOOR DEPRESSIONS AND CURBS.

7. REFER TO ARCHITECTURAL DRAWINGS FOR WATERPROOFING AND DAMPROOFING REQUIREMENTS.

8. PROVIDE SLEEVES AND BLOCKOUTS AS SHOWN ON THE APPROVED HVAC, ELECTRICAL, FIRE PROTECTION AND PLUMBING SHOP DRAWINGS IN ACCORDANCE WITH THE STRUCTURAL DETAILS.

9. INSERTS AND EMBEDMENTS SHALL BE ANCHORED SECURELY AND POSITIONED SO THAT THEY WILL BE FLUSH WITH THE FINISHED CONCRETE SURFACE TO A TOLERANCE OF 1/8 INCH, UNLESS NOTED OTHERWISE.

10. PERFORM AND SUBMIT INSTRUMENT SURVEYS OF ALL FINISHED REINFORCED CONCRETE AND STEEL DECK CONCRETE SLAB SURFACES. CONDUCT SURVEYS IMMEDIATELY BOTH BEFORE AND AFTER REMOVAL OF FORMWORK AND/OR SHORING SYSTEMS.

11. REFER TO SPECIFICATION SECTION 031000, "CONCRETE FORMWORK," SECTION 032000, "CONCRETE REINFORCEMENT," AND SECTION 033000, "CAST-IN-PLACE CONCRETE" FOR ADDITIONAL REQUIREMENTS.

12. REFER TO "STATEMENT OF SPECIAL INSPECTIONS" FOR SPECIAL INSPECTION REQUIREMENTS AND THE SPECIFICATIONS FOR THE REQUIRED PROGRAM OF TESTING AND INSPECTIONS. PROVIDE MATERIAL TESTS, DATA AND ACCESS AS REQUIRED TO FACILITATE SPECIAL INSPECTIONS AND OWNER MONITORING.
- B. CONCRETE

1. CAST-IN-PLACE CONCRETE SHALL BE OF THE TYPES AND MINIMUM 28-DAY COMPRESSIVE STRENGTHS AND MAXIMUM WATER-CEMENT RATIOS AS SHOWN IN THE CONCRETE MATERIAL SCHEDULE.

2. ALL CONCRETE SHALL CONTAIN A WATER-REDUCING OR HIGH-RANGE WATER-REDUCING, PLASTICIZING ADMIXTURE.

3. CONCRETE PERMANENTLY EXPOSED TO WEATHER SHALL CONTAIN AN APPROVED AIR-ENTRAINING ADMIXTURE.

4. CONCRETE ELEMENTS WITH A LEAST CROSS-SECTIONAL DIMENSION GREATER THAN 48 INCHES SHALL BE CONSIDERED TO BE "MASS CONCRETE."
- C. REINFORCING

1. MATERIALS:

a. REINFORCING BARS:

ASTM A615, ASTM A706 (WELDABLE REBAR) GRADE 60.

b. WELDED WIRE FABRIC (WWF):

ASTM A185

c. STRUCTURAL MACRO FIBERS:

ASTM C1116, MIN. 2 INCH LENGTH

d. ANCHOR RODS:

ASTM A1559 UNLESS NOTED OTHERWISE.

2. CONCRETE REINFORCEMENT SHALL BE DETAILED, FABRICATED, LABELED, SUPPORTED, SPACED IN FORMS, AND SECURED IN PLACE IN ACCORDANCE WITH THE PROCEDURES AND REQUIREMENTS OUTLINED IN THE LATEST EDITIONS OF THE "BUILDING CODE REQUIREMENTS FOR REINFORCED CONCRETE," ACI 318, AND THE "MANUAL OF STANDARD PRACTICE FOR DETAILING REINFORCED CONCRETE STRUCTURES," ACI 315.

3. REINFORCING SPLICES SHALL CONFORM TO THE REQUIREMENTS OF ACI 318, BUT NOT LESS THAN 36 BAR DIAMETERS, UNLESS NOTED OTHERWISE.

4. WELDED WIRE FABRIC SPLICES SHALL BE LAPPED EIGHT (8) INCHES AND TIED SECURELY.

5. MACRO FIBERS AT A DOSAGE RATE OF 4 LB/CU YARD MAY BE SUBSTITUTED FOR WELDED WIRE FABRIC IN STEEL DECK SLABS AND FILL CONCRETE OVER STRUCTURAL SLABS. SLABS WITH MACRO FIBERS SHALL HAVE #3 BY 2'-0" AT 12 INCHES ON CENTER AT CONSTRUCTION JOINTS IN ADDITION TO THE REINFORCING BARS SHOWN.

6. MECHANICAL COUPLERS SHALL BE USED WHERE NOTED AND OTHERWISE AT THE CONTRACTOR'S OPTION. COUPLERS SHALL DEVELOP IN TENSION 125% OF THE BAR STRENGTH UNLESS NOTED OTHERWISE.

7. DOWELS SHALL MATCH THE SIZE AND NUMBER OF MAIN REINFORCING, UNLESS NOTED OTHERWISE.

8. FIELD WELDING OR BENDING OF REINFORCING IS NOT PERMITTED EXCEPT WHERE SHOWN ON THE DRAWINGS OR OTHERWISE APPROVED.

9. MINIMUM REINFORCING, UNLESS NOTED OTHERWISE:

a. WALLS AND STRUCTURAL SLABS: #4 AT 12" EACH WAY, EACH FACE.

b. SLABS ON GRADE: 1 LAYER 6X6 - W2.9XW2.9 WWF.

c. FILL/WEAR SLABS: 1 LAYER 6X6 - W1.4XW1.4 WWF.

d. MEP EQUIPMENT PADS: 1 LAYER 6X6 - W4.0XW4.0 WWF.

10. MINIMUM REINFORCING FOR EXTERIOR AND VEHICLE TRAFFIC SLABS ON GRADE, GALVANIZED OR EPOXY COATED UNLESS NOTED OTHERWISE:

a. SIDEWALKS, PLAZAS: 1 LAYER 4X4 - W2.9XW2.9 WWF.

b. AUTO TRAFFIC AREAS: 1 LAYER 4X4 - W6.0XW6.0 WWF.

c. TRUCK TRAFFIC AREAS: 1 LAYER 4X4 - W7.0XW7.0 WWF.

11. BAR SUPPORTS SHALL BE GALVANIZED OR EPOXY COATED. BAR SUPPORTS IN CONTACT WITH EXPOSED SURFACES SHALL ALSO BE PLASTIC TIPPED.

12. SLAB-ON-GRADE REINFORCING SHALL BE SUPPORTED BY CONCRETE BLOCKS.
- D. CONSTRUCTION JOINTS:

1. CONSTRUCTION JOINTS IN ALL WALLS, SLABS AND BEAMS SHALL NOT BE FURTHER APART THAN 90 FEET IN ANY DIRECTION.

2. CONSTRUCTION JOINTS SHALL BE WIRE BRUSHED, CLEANED AND MOISTENED IMMEDIATELY PRIOR TO PLACING NEW CONCRETE.

3. PLACE SLABS ON GRADE IN STRIP POURS OF A MAXIMUM WIDTH OF 15 FEET WITH A MINIMUM OF 24 HOURS BETWEEN ADJACENT POURS.

4. SLABS ON GRADE STRIP POURED SLABS SHALL HAVE SAWCUT CONTROL JOINTS AT 15'-0" CENTERS IN EACH DIRECTION AT THE FOLLOWING MAXIMUM CENTERS, UNLESS SHOWN OTHERWISE:

a. 4 INCH SLAB: 10 FEET

b. 5 INCH SLAB: 12 FEET

c. 6 INCH OR GREATER SLAB: 15 FEET

5. CONSTRUCTION JOINTS IN STEEL DECK SLABS SHALL BE LOCATED A MINIMUM OF 18 INCHES FROM ANY BEAM LINE.

6. PROVIDE SHEAR KEYS AT ALL BEAM, REINFORCED SUSPENDED SLAB, GRADE BEAM, MAT AND FOUNDATION WALL CONSTRUCTION JOINTS. REFER TO STEEL DECK DETAILS FOR REQUIREMENTS AT STEEL DECK SLABS. REFER TO DETAILS FOR SLAB-ON-GRADE AND SLAB ON METAL DECK CONSTRUCTION JOINT REQUIREMENTS.

7. CONSTRUCTION JOINTS SHALL BE LOCATED ONLY IN ACCORDANCE WITH APPROVED SHOP DRAWINGS.

8. ALLOW A MINIMUM OF THREE (3) HOURS BETWEEN PLACEMENT OF CONCRETE FOR COLUMNS, WALLS OR PIERS AND PLACEMENT OF CONCRETE ON THE ADJACENT FLOOR.
- E. ELECTRICAL CONDUIT

1. CONDUIT SHALL BE STEEL OR RIGID PLASTIC ONLY.

2. MAXIMUM CONDUIT DIAMETER IS 1/6 THE SLAB DEPTH.

3. CONDUIT SHALL BE LOCATED IN THE CENTER 1/3 OF THE SLAB AND AS SHOWN IN THE STEEL DECK DETAILS.

4. CLEAR DISTANCE BETWEEN CONDUITS SHALL BE 3 TIMES THE CONDUIT DIAMETER.

5. CONDUIT SHALL BE SECURELY TIED TO REINFORCING TO PREVENT DISPLACEMENT DURING CONCRETE PLACEMENT.

6. CONDUIT SHALL BE PLACED ONLY IN ACCORDANCE WITH SHOP DRAWINGS APPROVED BY THE STRUCTURAL ENGINEER.
- F. CURING AND SEALING

1. PROVIDE APPROVED CURING COMPOUND AND SEALER FOR THE TOP SURFACE OF ALL SLAB WORK, UNLESS NOTED OTHERWISE.

2. PROVIDE APPROVED CURING COMPOUND, SEALER, AND HARDENER FOR ALL SLABS IN M.E.P. AND STORAGE AREAS, UNLESS NOTED OTHERWISE.

3. MOIST CURE PARKING SLABS FOR A MINIMUM OF 7 DAYS.

4. MOIST CURE CONCRETE FILLS AND TOPPINGS PLACED OVER STRUCTURAL SLABS.

5. CURE FORMED CONCRETE IN FORMS OR PROVIDE APPROVED CURING COMPOUND.
- G. DRILLED IN ANCHORS AND REINFORCING BARS

1. DRILLED IN EXPANSION ANCHORS, ADHESIVE ANCHORS AND GROUTED BARS MAY BE USED ONLY WHERE SHOWN ON THE DRAWINGS.

2. DRILLED IN BARS SHALL BE ADHESIVE ANCHORED UNLESS NOTED OTHERWISE.

3. CONDUCT A PRE-CONSTRUCTION CONFERENCE AT LEAST 14 DAYS PRIOR TO INSTALLATION OF ANCHORS TO VERIFY MATERIALS AND PROCEDURES. CONFERENCE SHALL BE ATTENDED BY REPRESENTATIVES OF THE MANUFACTURER, INSTALLER, CONTRACTOR AND ARCHITECT.

4. ADHESIVE ANCHORED BARS SHALL BE INSTALLED BY TRAINED PERSONNEL IN ACCORDANCE WITH THE MANUFACTURER'S INSTRUCTIONS AND THE INSTALLATION SHALL BE MONITORED AND APPROVED BY THE MANUFACTURER'S REPRESENTATIVE.

1.5 FOR EPOXY COATED BARS WITH COVER LESS THAN 3 BAR DIAMETERS, OR CLEAR SPACING LESS THAN 6 BAR DIAMETERS

1.2 FOR ALL OTHER EPOXY COATED BARS

6. LAP SPlice LENGTHS (ACI 12.15.1) ARE MULTIPLES OF TENSION DEVELOPMENT LENGTHS:

CLASS A - 1.0 LD, WHERE 50% OR LESS BARS ARE LAP SPICED AT A SECTION FOR A DISTANCE EQUAL TO THE REQUIRED LAP SPlice LENGTH, OR

CLASS B - 1.3 LD, AT ALL OTHER LOCATIONS.

7. ALL ADJACENT LAP SPICES IN SLAB-ON-GRADE SHALL BE STAGGERED BY A MINIMUM DISTANCE EQUAL TO THE REQUIRED LAP SPlice LENGTH.

8. USE MECHANICAL SPlice FOR #14 AND #18 BAR SIZES.

CONCRETE MATERIALS SCHEDULE					
LOCATION	COMPRESSIVE STRENGTH (28 DAY U.N.C.)	MAX. SIZE AGGREGATE	SUPPLEMENTARY MATERIALS	MAXIMUM W/C RATIO	AIR CONTENT
STRIP FOOTINGS	8,000 PSI @ 28 DAYS	1"	FLY ASH AND/OR SLAG	0.45	3% MAXIMUM
SHEAR WALLS	10,000 PSI 8,000 PSI @ 56 DAYS	3/4"	FLY ASH AND/OR SLAG SILICA FUME REQUIRED FOR F'C ≥ 10,000 PSI	0.30 (10 KSI) 0.45 (6 TO 9 KSI)	3% TO 5% MAXIMUM
BASEMENT WALLS	5,000 PSI	3/4"		0.50	3% MAXIMUM
SLABS AND BEAMS	5,000 PSI	3/4"		0.50	3% MAXIMUM
EXPOSED TO FREEZING	5,000 PSI @ 28 DAYS	3/4"		0.45	4.5% TO 7.5%
SLABS ON STEEL DECK	4,000 PSI @ 28 DAYS	3/4"	MACRO FIBERS	0.50	3% MAXIMUM
TIGHT POURS	COORDINATE W/ELEMENTS	3/8"	COORDINATE W/ELEMENT	COORDINATE W/ELEMENT	3% MAXIMUM
TOPPING/FILL SLABS	4,000 PSI @ 28 DAYS	3/4"	MACRO FIBERS FLY ASH AND/OR SLAG	0.40	3% INTERIOR 3% TO 7% EXTERIOR

NOTES:
1. ALL CONCRETE NORMAL WEIGHT UNLESS NOTED OTHERWISE.

TENSION DEVELOPMENT LENGTH AND CLASS 'A' TENSION LAP SPlice LENGTH																								
BAR SIZE	f'c = 4000 psi				f'c = 5000 psi				f'c = 6000 psi				f'c = 7000 psi				f'c = 8000 psi				f'c = 10000 psi			
	TOP BARS		OTHER BARS		TOP BARS		OTHER BARS		TOP BARS		OTHER BARS		TOP BARS		OTHER BARS		TOP BARS		OTHER BARS		TOP BARS		OTHER BARS	
	CASE 1	CASE 2	CASE 1	CASE 2	CASE 1	CASE 2	CASE 1	CASE 2	CASE 1	CASE 2	CASE 1	CASE 2	CASE 1	CASE 2	CASE 1	CASE 2	CASE 1	CASE 2	CASE 1	CASE 2	CASE 1	CASE 2	CASE 1	CASE 2
#3	19	28	15	22	17	25	13	19	15	23	12	18	14	21	12	16	13	20	12	15	12	18	12	14
#4	25	37	19	29	22	33	17	26	20	31	16	24	19	28	15	22	18	26	14	20	16	24	12	18
#5	31	47	24	36	28	42	22	32	25	38	20	29	24	35	18	27	22	33	17	25	20	30	15	23
#6	37	56	29	43	33	50	26	38	31	46	24	35	28	42	22	33	26	40	20	30	24	35	18	27
#7	54	81	42	63	49	73	37	56	44	66	34	51	41	61	32	47	38	58	30	44	34	51	27	40
#8	62	93	48	71	55	83	43	64	51	76	39	58	47	70	36	54	44	66	34	51	39	59	30	45
#9	70	105	54	81	63	94	48	72	57	85	44	66	53	79	41	61	49	74	38	57	44	66	34	51
#10	79	118	61	91	70	105	54	81	64	96	49	74	59	89	46	69	56	83	43	64	50	75	38	57
#11	87	131	67	101	78	117	60	90	71	107	55	82	66	99	51	76	62	93	48	71	55	83	43	64
#14	105	157	81	121	94	140	72	108	86	128	66	99	79	119	61	91	74	111	57	85	66	99	51	76
#18	139	209	107	161	125	187	96	144	114	171	88	131	106	158	81	122	98	148	76	114	88	132	68	102

NOTES:
1. TABULATED TENSION DEVELOPMENT LENGTHS ARE GIVEN IN INCHES, AND ARE CALCULATED FOR REINFORCEMENT CONFORMING TO ASTM A615 GRADE 60 AS PER THE REQUIREMENTS OF ACI 318 (2005).

2. CASES 1 AND 2 DEPEND UPON CONCRETE COVER AND THE CENTER-TO-CENTER SPACING OF THE BARS, DEFINED AS FOLLOWS:
CASE 1: CLEAR SPACING AT LEAST ONE (1) BAR DIAMETER
CLEAR COVER AT LEAST ONE (1) BAR DIAMETER
STIRRUPS OR TIES THROUGHOUT THE DEVELOPMENT LENGTH NOT LESS THAN THE CODE MINIMUM
OR
CLEAR SPACING AT LEAST TWO (2) BAR DIAMETERS
CLEAR COVER AT LEAST ONE (1) BAR DIAMETER
CASE 2: ALL OTHER CASES

3. TOP BARS ARE DEFINED AS HORIZONTAL BARS WITH MORE THAN 12 INCHES OF CONCRETE CAST BELOW THE BARS.

4. TABULATED TENSION DEVELOPMENT LENGTHS HAVE BEEN CALCULATED WITH RESPECT TO NORMALWEIGHT CONCRETE. FOR LIGHTWEIGHT CONCRETE, MULTIPLY THE TABULATED VALUES BY 1.3.


5. FOR EPOXY COATED BARS, MULTIPLY THE TABULATED VALUES BY ONE OF THE FOLLOWING FACTORS:
1.5 FOR EPOXY COATED BARS WITH COVER LESS THAN 3 BAR DIAMETERS, OR CLEAR SPACING LESS THAN 6 BAR DIAMETERS
1.2 FOR ALL OTHER EPOXY COATED BARS

6. LAP SPlice LENGTHS (ACI 12.15.1) ARE MULTIPLES OF TENSION DEVELOPMENT LENGTHS:
CLASS A - 1.0 LD, WHERE 50% OR LESS BARS ARE LAP SPICED AT A SECTION FOR A DISTANCE EQUAL TO THE REQUIRED LAP SPlice LENGTH, OR
CLASS B - 1.3 LD, AT ALL OTHER LOCATIONS.

7. ALL ADJACENT LAP SPICES IN SLAB-ON-GRADE SHALL BE STAGGERED BY A MINIMUM DISTANCE EQUAL TO THE REQUIRED LAP SPlice LENGTH.

8. USE MECHANICAL SPlice FOR #14 AND #18 BAR SIZES.

LENTION MECHANICAL SPLICES

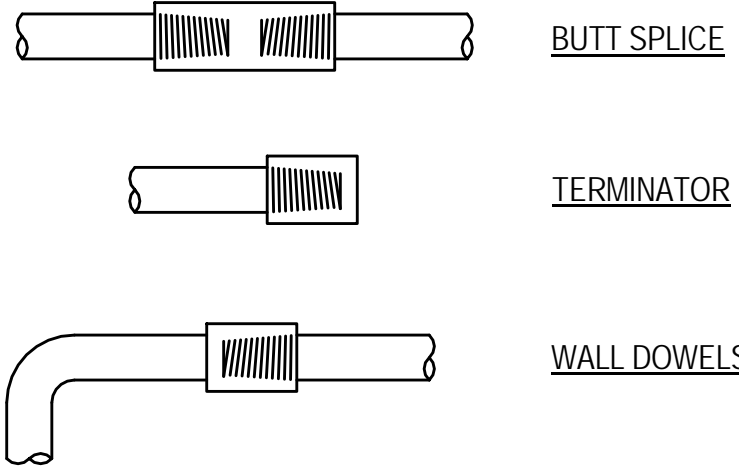

NOTE: USE LENTION MECHANICAL SPLICES OR MECHANICAL SPLICES THAT MEET OR EXCEED STRENGTH OF EQUIVALENT LENTION SPlice.

MINIMUM CONCRETE COVER

CONCRETE SURFACE EXPOSURE	MINIMUM CONCRETE CLEAR COVER
FOOTINGS/CAISSONS	3"
CORE WALLS/BUTTRESS WALLS	1"
SLAB - ON - GRADE	2"
SLABS	3/4"
BEAMS	1 1/2"
COLUMNS	1 1/2"
SLAB ON COMPOSITE DECK	3/4"
FOUNDATION WALLS	2" O.F./1" I.F.

COMPRESSION LAP SPlice LENGTH AND COMPRESSION DEVELOPMENT LENGTH

BAR SIZE	COMPRESSION LAP SPlice	COMPRESSION DEVELOPMENT LENGTH					
		f'c = 4000 psi	f'c = 5000 psi	f'c = 6000 psi	f'c = 7000 psi	f'c = 8000 psi	f'c = 10000 psi
#3	12	8	8	8	8	8	8
#4	15	10	9	9	9	9	9
#5	19	12	12	12	12	12	12
#6	23	15	14	14	14	14	14
#7	27	17	16	16	16	16	16
#8	30	19	18	18	18	18	18
#9	34	22	21	21	21	21	21
#10	39	25	23	23	23	23	23
#11	43	27	26	26	26	26	26
#14	SEE NOTE 2	33	31	31	31	31	31
#18	SEE NOTE 2	43	41	41	41	41	41

NOTES:
1. TABULATED COMPRESSION DEVELOPMENT LENGTHS AND COMPRESSION LAP SPICES ARE GIVEN IN INCHES, AND ARE CALCULATED FOR REINFORCEMENT CONFORMING TO ASTM A615 GRADE 60 AS PER THE REQUIREMENTS OF ACI 318-05.

2. USE MECHANICAL SPlice FOR #14 AND #18 BAR SIZES.



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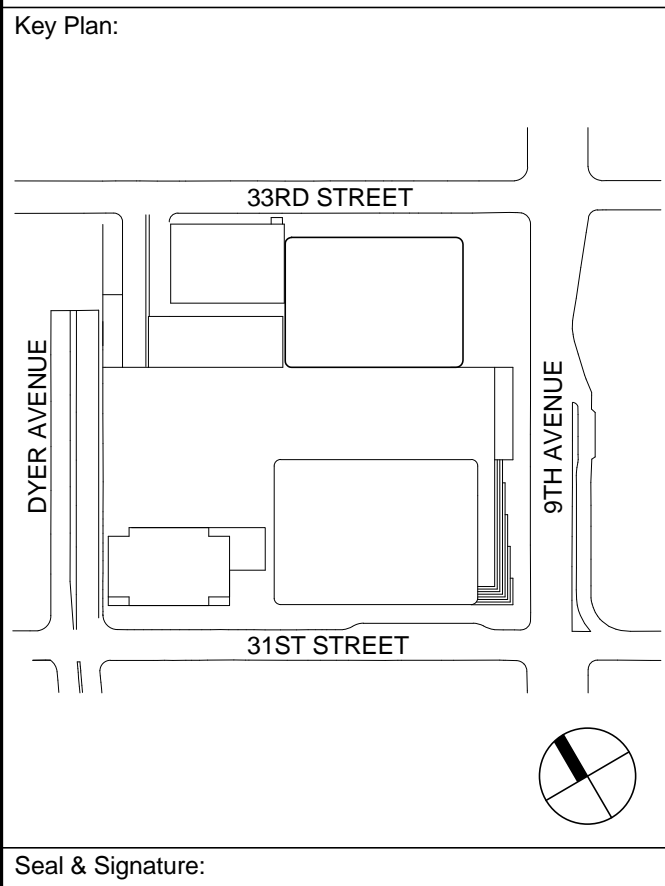
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Seal & Signature:

PRELIMINARY
NOT FOR CONSTRUCTION

6	20 JUN 2014	ISSUED FOR FOUNDATION BID
5	20 JUN 2014	ISSUED FOR FOUNDATION PERMIT
4	20 DEC 2013	ISSUED FOR FOUNDATION PERMIT
3	15 NOV 2013	ISSUED FOR 90% PROGRESS PRICING
2	12 JUL 2013	ISSUED FOR 90% DESIGN DEVELOPMENT
1	18 MAR 2012	ISSUED FOR RECONCILIATION

No. Date Description
Sheet Name:

**STRUCTURAL
CONCRETE
NOTES**

STRUCTURAL STEEL NOTES

A. GENERAL

1. ALL DETAILING, FABRICATION AND ERECTION SHALL CONFORM TO AISC (LRFD) SPECIFICATIONS AND CODES, LATEST EDITION.

2. ALL WELDING WORK SHALL CONFORM TO THE AWS D1.1 "STRUCTURAL WELDING CODE - STEEL," LATEST EDITION, AND SHALL BE PERFORMED BY AWS CERTIFIED WELDERS.

3. ALL STEEL BEAM SIZES FOLLOWED BY A NUMBER IN PARENTHESES, (XX), ARE COMPOSITE BEAMS WITH SHEAR STUDS. SEE "STRUCTURAL METAL DECK NOTES" FOR ADDITIONAL INFORMATION.

4. COMPOSITE BEAMS ARE NOT REQUIRED TO BE SHORED, UNLESS NOTED OTHERWISE.

5. THERE SHALL BE NO FIELD CUTTING OF STRUCTURAL STEEL MEMBERS FOR THE WORK OF OTHER TRADES WITHOUT PRIOR REVIEW BY THE ARCHITECT.

6. ALL STRUCTURAL STEEL SHALL BE FIREPROOFED TO ATTAIN THE APPLICABLE FIRE RATING REQUIRED BY CODE WITH UL APPROVED SPRAYED-ON CEMENTIOUS FIREPROOFING MATERIALS. SEE THE ARCHITECTURAL DRAWINGS FOR SPECIFIC FIREPROOFING REQUIREMENTS. ALL STEEL SURFACES ENCASED IN CONCRETE, ELEVATOR GUIDE BEAMS, AND PENTHOUSE ROOF FRAMING DO NOT REQUIRE SPRAY FIREPROOFING.

7. AFTER FABRICATION AND JUST PRIOR TO SITE APPLICATION OF SPRAY-ON FIREPROOFING, ALL STEEL SHALL BE CLEANED OF ALL RUST, LOOSE MILL SCALE AND OTHER FOREIGN MATERIALS. PRIMING AND PAINTING OF THE STRUCTURAL STEEL WILL NOT BE REQUIRED EXCEPT FOR STEEL WHICH IS PERMANENTLY EXPOSED.

8. ALL ELEVATIONS ARE REFERENCED TO THE NORTH AMERICAN VERTICAL DATUM OF 1988 (NAV88) FOR REFERENCE 0.0 NAV88 = 301.75 PENN RAIL ROAD TUNNELS DATUM

9. SEE SPECIFICATION SECTION 05120, "STRUCTURAL STEEL," FOR ADDITIONAL REQUIREMENTS NOT NOTED HEREIN.

B. MATERIALS

1. STRUCTURAL STEEL GRADES SHALL BE AS FOLLOWS:

BUILT-UP STEEL COLUMNS: ASTM A572 Gr. 50
FLOOR BEAMS: ASTM A992 - GRADE 50
W14 COLUMNS, HANGERS, & BRACED FRAME DIAGONALS: ASTM A913 - GRADE 45
W12, W24, W26, W36 COLUMNS: ASTM A992 - GRADE 50
W1 DIAGONALS: ASTM A992 - GRADE 50
CONNECTIONS, PLATES: ASTM A572 - GRADE 50
ANGLES: ASTM A36 - GRADE 36
WELDING: E70XX ELECTRODES

2. ALL STRUCTURAL STEEL TUBING SHALL BE ASTM A500, GRADE B, UNLESS NOTED OTHERWISE.

3. ALL STRUCTURAL STEEL PIPE SHALL BE ASTM A53, TYPE E, GRADE B, UNLESS NOTED OTHERWISE.

4. ALL BOLTS, NUT AND WASHERS SHALL CONFORM TO THE REQUIREMENTS OF ASTM A325 OR A490.

C. CONNECTIONS

1. ALL CONNECTIONS, EXCEPT FOR THOSE CONNECTIONS COMPLETELY DESIGNED ON THE DRAWINGS, SHALL BE DESIGNED AND DETAILED BY THE FABRICATOR. DETAILING SHALL BE PERFORMED USING RATIONAL ENGINEERING DESIGN AND STANDARD PRACTICE IN ACCORDANCE WITH THE REQUIREMENTS OF THE CONTRACT DOCUMENTS. THE GENERAL DETAILS SHOWN ON THE DRAWINGS ARE CONCEPTUAL ONLY AND DO NOT INDICATE THE REQUIRED NUMBER OF BOLTS OR WELD SIZES, UNLESS SPECIFICALLY NOTED. THE CONTRACTOR SHALL SUBMIT ENGINEERING CALCULATIONS AND CONNECTION DETAIL DRAWINGS FOR EACH CONNECTION TYPE. MEMBER SIZE, AND REACTION INDICATED ON THE DRAWINGS FOR REVIEW BY THE ARCHITECT PRIOR TO THE SUBMITTAL OF THE STRUCTURAL STEEL SHOP DRAWINGS. AFTER REVIEW BY THE ARCHITECT, THESE DETAIL DRAWINGS SHALL BE UTILIZED AS THE STANDARD FOR FABRICATION AND SHOP DRAWING DETAILING. THE DESIGN CALCULATIONS SHALL BE PREPARED AND SEALED BY A QUALIFIED PROFESSIONAL ENGINEER LICENSED IN THE STATE OF NEW YORK.

2. ALL CONNECTIONS, UNLESS NOTED OTHERWISE, SHALL BE SIMPLE SHEAR CONNECTIONS UTILIZING "SHORT-SLOTTED" HOLES AND HIGH-STRENGTH BOLTS IN BEARING-TYPE CONNECTIONS WITH THREADS EXCLUDED FROM THE SHEAR PLANE. THE CONNECTION CAPACITIES SHALL BE AS SHOWN IN NOTE C5 BELOW, OR AS NOTED ON THE STRUCTURAL FRAMING PLANS.

3. BEAM-TO-COLUMN CONNECTIONS SHALL BE MOMENT CONNECTED WHERE SHOWN ON THE DRAWINGS. THE WEB SHEAR CONNECTION FOR THESE MEMBERS SHALL UTILIZE SINGLE SHEAR PLATE SLIP-CRITICAL TYPE CONNECTIONS WITH HIGH-STRENGTH BOLTS WITH THREADS EXCLUDED FROM THE SHEAR PLANE FOR THE CAPACITIES SHOWN IN NOTE C5 BELOW.

4. ALL BOLTS SHALL BE FULLY TORQUED FOR BOTH SLIP CRITICAL AND BEARING TYPE CONNECTIONS.

5. MINIMUM SERVICE END REACTIONS (ASD) FOR STANDARD ROLLED SHAPES:

W36 160 kips W16 40 kips C18 35 kips
W33 135 kips W14 30 kips C15 30 kips
W30 115 kips W12 20 kips C12 10 kips
W27 85 kips W10 15 kips C10 10 kips
W24 75 kips W8 10 kips C9,C8 6 kips
W21 60 kips W6 10 kips C7,C6 6 kips
W18 50 kips W5 10 kips

ANY MEMBERS WITH END REACTIONS EXCEEDING THE VALUES LISTED ABOVE ARE INDICATED ON THE PLANS, EITHER WITH BOXED END REACTIONS OR IN TABULAR FORM.

6. THE MINIMUM NUMBER OF BOLTS PER CONNECTION SHALL BE TWO (2) 3/4 INCH DIAMETER, A325 BOLTS.

7. MINIMUM FILLET WELD SIZES SHALL COMPLY WITH THE AISC SPECIFICATION REQUIREMENTS, BUT SHALL NOT BE LESS THAN 1/4 INCH, UNLESS NOTED OTHERWISE.

D. DETAILING AND FABRICATION

1. THE CONTRACTOR SHALL SUBMIT DETAILED, ENGINEERED, COORDINATED AND CHECKED SHOP DRAWINGS FOR ALL STRUCTURAL STEEL TO THE ARCHITECT FOR REVIEW PRIOR TO THE START OF FABRICATION AND/OR ERECTION.

2. ALL BEAMS SHALL BE FABRICATED WITH THE NATURAL CAMBER UP. PROVIDE ADDITIONAL CAMBERS AS INDICED IN BRACKETS -<XX> ON THE STRUCTURAL DRAWINGS. FOR CANTILEVERS, CAMBER SHALL BE MEASURED AT THE FREE END.

3. ALL SIMPLE SHEAR CONNECTIONS SHALL BE CAPABLE OF END ROTATION AS PER THE REQUIREMENTS OF AISC SPECIFICATION, CHAPTER J1.2, "SIMPLE CONNECTIONS."

4. ALL BEAMS FRAMING INTO NEW CONCRETE WALLS SHALL BE DETAILED TO SUIT THE HORIZONTAL FIELD TOLERANCES

E. ERECTION

1. THE CONTRACTOR SHALL BE RESPONSIBLE FOR THE CONTROL OF ALL ERECTION PROCEDURES AND SEQUENCES, ESPECIALLY WITH RELATION TO TEMPERATURE DIFFERENTIALS, ERECTION TOLERANCES, AND WITH RESPECT TO STRUCTURAL STEEL FRAMING INTO REINFORCED CONCRETE WALLS.

2. SURVEY THE TOPS OF ALL COLUMNS AT EACH LEVEL. RECORD X, Y & Z - COORDINATES MEASURED CONSISTANTLY FROM AN ESTABLISHED BENCHMARK. PROVIDE A COPY OF THE SURVEY DATA TO THE ARCHITECT AND STRUCTURAL ENGINEER WITHIN TWO DAYS OF THE COMPLETION OF EACH SURVEY.

3. ALL ERECTION PROCEDURES, DESIGNS AND CALCULATIONS SHALL BE PERFORMED BY THE CONTRACTOR'S QUALIFIED PROFESSIONAL ENGINEER LICENSED IN THE STATE OF NEW YORK. ANY REVIEW OF SUCH CALCULATIONS AND/OR DRAWINGS BY THE ARCHITECT WILL BE SOLELY LIMITED TO ANY EFFECTS ON THE INTEGRITY OF THE PERMANENT PRIMARY STRUCTURE.

4. ALL ADDITIONAL STEEL REQUIRED BY THE CONTRACTOR FOR ERECTION PURPOSES AND SITE ACCESS OF STOCKPILED MATERIALS SHALL BE PROVIDED AT NO COST TO THE OWNER. ALL SUCH ADDITIONAL STEEL SHALL BE REMOVED BY THE CONTRACTOR UNLESS APPROVED BY THE OWNER IN WRITING.

5. THE CONTRACTOR SHALL SUBMIT A METHODS STATEMENT FOR ALL STRUCTURAL STEEL/METAL DECK ERECTION PROGRAMS.

F. NON-SELF-SUPPORTING STEEL FRAMES

THE STEEL STRUCTURE (COMPRISED OF GRAVITY COLUMNS, FLOOR BEAMS, FLOOR BRACING, BRACED FRAMES AND MOMENT FRAMES) IS A NON SELF-SUPPORTING FRAME. THE FLOOR DIAPHRAGM (METAL DECK AND HARDENED CONCRETE SLAB TOPPING) AND R/C CONCRETE WALLS ARE REQUIRED TO PROVIDE STABILITY AND STRENGTH TO RESIST THE LOADS FOR WHICH THE FRAME IS DESIGNED. THE CONTRACTOR SHALL PROVIDE AND INSTALL TEMPORARY SUPPORT AS NECESSARY UNTIL THE COMPLETE STRUCTURE IS ERECTED.

G. TESTING AND INSPECTION

TESTING AND INSPECTION OF BOTH SHOP AND FIELD STRUCTURAL STEEL FABRICATION AND ERECTION WORK, INCLUDING WELDED AND BOLTED CONNECTIONS, SHALL BE AS FOLLOWS:

1. ALL STRUCTURAL STEEL FABRICATION AND ERECTION SHALL BE VISUALLY INSPECTED.

2. ALL WELDERS SHALL BE AWS CERTIFIED.

3. ALL WELDS SHALL BE AWS/AISC PREQUALIFIED.

4. ALL WELDS SHALL BE VISUALLY INSPECTED PER AWS D1.1. WELD MEASUREMENTS SHALL BE PERFORMED FOR 15% OF ALL WELDS ON A RANDOM BASIS.

5. MAGNETIC PARTICLE TESTING IN ACCORDANCE WITH ASTM E709 SHALL BE PERFORMED FOR A MINIMUM OF:

A. 10% OF ALL FILLET WELDS CHOSEN AT RANDOM, FINAL PHASE ONLY.

B. 100% OF TENSION MEMBER CONNECTION WELDS (I.E., HANGER CONNECTION PLATES, ETC.) FOR ROOT AND FINAL PASSES.

6. ULTRASONIC TESTING IN ACCORDANCE WITH AWS D1.1 SHALL BE PERFORMED FOR A MINIMUM OF:

A. 100% OF ALL FULL PENETRATION WELDS.

B. 20% OF ALL COLUMN SPLICE WELDS, CHOSEN AT RANDOM.

7. ULTRASONIC TESTING AND VISUAL INSPECTION IN ACCORDANCE WITH ASTM A435 SHALL BE UTILIZED TO VERIFY BASE MATERIALS FOR LAMINATIONS, INCLUSIONS, AND OTHER DISCONTINUITIES AS FOLLOWS:

A. ALL STRUCTURAL STEEL PLATES GREATER THAN 1 1/2" THICK USED FOR THE CAISSON CORE STEEL, FOR THE CAISSON CAP TRANSFER GIRDERS, AND FOR THE DIAGONAL JOINT ASSEMBLIES w/ THE BEAMS IN THE CONTINUOUS CAISSON CAPS PRIOR TO FABRICATION.

B. ALL COLUMN FLANGES AND WEBS WITHIN STRUCTURAL SHAPE GROUPS 4 AND 5 AS DEFINED BY AISC LOCATED AT MOMENT CONNECTIONS. TEST AREA IS DEFINED AS 6" ABOVE AND BELOW BEAM FLANGE CONNECTION.

C. ALL GUSSET PLATES USED IN X-BRACED FRAMES GREATER THAN 1 1/2" THICK.

D. ALL COLUMN FLANGES IN COLUMNS WITH GUSSET PLATES ATTACHED TO BOTH FLANGES. TEST AREA IS DEFINED AS 6" AT 2'-0" INTERVALS.

8. ALL BOLTED CONNECTIONS SHALL BE VISUALLY INSPECTED AND TESTED WITH A CALIBRATED TORQUE WRENCH TO VERIFY A MINIMUM OF 25% OF BOLTS IN EACH CONNECTION (2 BOLTS PER CONNECTION MINIMUM).

9. THE REQUIRED CONTACT SURFACE CONDITIONS OF ALL SHEAR CONNECTIONS SHALL BE VISUALLY INSPECTED IMMEDIATELY PRIOR TO BEAM ERECTION. THE CONTRACTOR SHALL BE RESPONSIBLE FOR ALL REMEDIAL WORK REQUIRED TO CONTACT SURFACES.

10. THE OWNER'S STRUCTURAL STEEL TESTING SHALL PERFORM ALL FIELD INSPECTION AND TESTING AS OUTLINED ABOVE, AND MONITOR THE CONTRACTOR'S INSPECTION AND TESTING OUTLINED ABOVE FOR ALL SHOP WORK. IF THE CONTRACTOR'S QUALITY CONTROL PROGRAM IS NOT AISC CERTIFIED, THE CONTRACTOR SHALL ENGAGE AN APPROVED STRUCTURAL STEEL TESTING LABORATORY, ACCEPTABLE TO THE OWNER, WHO SHALL PERFORM ALL SHOP TESTING AND INSPECTION.

11. THE STRUCTURAL STEEL FABRICATOR AND ERECTOR SHALL SCHEDULE ALL WORK TO ALLOW THE ABOVE INSPECTION AND TESTING REQUIREMENTS TO BE COMPLETED.

STRUCTURAL STEEL PAINTING

1. ALL STRUCTURAL STEEL SHALL BE CLEANED AND PAINTED AS REQUIRED BY THE TECHNICAL SPECIFICATIONS.

2. ALL STRUCTURAL STEEL TO RECEIVE SPRAYED-ON FIREPROOFING AND/OR TO BE ENCASED IN CONCRETE DOES NOT REQUIRE PAINTING UNLESS NOTED OTHERWISE.

3. THE FOLLOWING STRUCTURAL STEEL ELEMENTS REQUIRE CLEANING AND PAINTING SYSTEMS:

A. ELEVATOR SEPARATOR BEAMS: CLEANED, PRIMED

B. NON-FIREPROOFED, INTERIOR STRUCTURAL STEEL: CLEANED, PRIMED; FIELD PAINTED (1 COAT)

STRUCTURAL METAL DECK NOTES

1. ALL METAL DECK SHALL BE FABRICATED FROM STEEL TYPE ASTM A446, GRADE A, HAVING A MINIMUM YIELD STRENGTH OF 40,000 PSI. ALL FLOOR DECKING SHALL BE HOT-DIPPED GALVANIZED, OR PHOSPHATIZED AND PAINTED. ALL DECKING AT ROOF LEVELS, PARKING/VEHICULAR LEVELS, LOADING DOCK/FREIGHT AREAS, AND SIDEWALK AREAS SHALL BE HOT-DIPPED GALVANIZED. ALL INSULATED METAL ROOF DECKING SHALL BE FORMED WITH TELESCOPED ENDS TO ALLOW ENDS OF SHEETS TO BE LAPPED A MINIMUM OF 2 INCHES.

2. ALL METAL DECK SHALL BE DESIGNED FOR THE SPAN AND LOADING CONDITIONS SHOWN ON THE STRUCTURAL DRAWINGS AND IN THE METAL DECK SCHEDULE. NONCELLULAR METAL DECK SHALL BE PROVIDED IN ALL AREAS, UNLESS NOTED OTHERWISE.

3. METAL DECK SECTION PROPERTIES SHALL BE COMPUTED IN ACCORDANCE WITH THE AISI "SPECIFICATION FOR THE DESIGN OF COLD FORMED STEEL STRUCTURAL MEMBERS", LATEST EDITION, UNLESS NOTED OTHERWISE.

4. THE MINIMUM GAGE OF ALL METAL DECK SHALL BE 18 GAGE WHEN THE CONCRETE TOPPING SLAB THICKNESS IS LESS THAN OR EQUAL TO 4 1/2" AND 16 GAGE WHEN CONCRETE TOPPING SLAB THICKNESS IS GREATER THAN 4 1/2".

5. THE METAL DECK CONTRACTOR SHALL SUBMIT, TO THE ARCHITECT FOR REVIEW, STRUCTURAL ENGINEERING CALCULATIONS, PREPARED AND SEALED BY A QUALIFIED PROFESSIONAL ENGINEER REGISTERED IN THE STATE OF NEW YORK, PROVIDE PUBLISHED MANUFACTURERS' DATA, AND INDEPENDENTLY CERTIFIED LOAD TEST DATA, VERIFYING THAT THE METAL DECK AND RELATED DECK ACCESSORIES SATISFY THE SPECIFIED LOADING AND DEFLECTION REQUIREMENTS FOR THE SPANS INDICATED ON THE DRAWINGS.

6. THE CONTRACTOR SHALL PROVIDE DETAILED, COORDINATED AND CHECKED SHOP DRAWINGS INDICATING LOCATION, GAGE AND SIZE OF EACH PIECE OF DECKING AND RELATED ACCESSORIES. THE DRAWINGS SHALL CLEARLY SHOW WELDING DETAILS TO STRUCTURAL FRAMING ELEMENTS, SIDE LAP CONNECTION DETAILS, DECK OPENING/EDGE CLOSURES, AND WHERE REQUIRED, SUPPLEMENTARY DECK AND/OR CLOSURE REINFORCING.

7. ALL NON-CELLULAR COMPOSITE METAL DECK SHALL HAVE WIDE RIBS SUITABLE FOR SHEAR STUD PLACEMENT WHERE STUDS ARE REQUIRED. THE CONFIGURATION OF THE METAL DECK SHALL BE SUCH AS TO DEVELOP THE FULL HORIZONTAL SHEAR VALUE OF THE STUD FOR THE PARTICULAR METAL DECK-SLAB CONFIGURATION PER THE AISC SPECIFICATIONS, LATEST EDITION, AND AS REQUIRED BY NOTE 17C HEREIN.

8. ALL DECKING SHALL BE WELDED TO STRUCTURAL STEEL BY QUALIFIED WELDERS USING PRE-QUALIFIED PROCEDURES. THE TECHNICAL SPECIFICATIONS ESTABLISH A PROCEDURE FOR PRE-QUALIFICATION OF THE PLUG WELDING OF THE STEEL DECKING TO THE STRUCTURAL STEEL FOR THE PARTICULAR GAGES USED. PRIOR TO THE START OF ERECTION OF THE STEEL DECK, EACH WELDER SHALL BE QUALIFIED USING THIS PROCEDURE AS WITNESSED BY THE OWNER'S TESTING LABORATORY.

9. ALL METAL DECK SHALL BE WELDED AT 12 INCHES MAXIMUM ON CENTER TO THE SUPPORTING STEEL WITH A 3/4 INCH DIAMETER PLUG WELD. SIDE LAPS SHALL BE FASTENED AT 30 INCHES MAXIMUM ON CENTER.

10. THE METAL DECK SHALL BE DESIGNED TO BE UNSHORED AND CONTINUOUS OVER A MINIMUM OF THREE (3) SPANS IN THE DIRECTION INDICATED. METAL DECKING FOR SINGLE AND DOUBLE SPANS, IF REQUIRED, SHALL ALSO SATISFY THE SPECIFIED LOAD AND DEFLECTION REQUIREMENTS, NOTED HEREIN.

11. THE METAL DECK SHALL BE DESIGNED FOR AN ASSUMED SUITABLE CONSTRUCTION LIVE LOAD TAKING INTO CONSIDERATION THE PARTICULAR METHOD OF CONCRETE PLACEMENT TO BE USED ON THE PROJECT. SPAN AND LOAD CONDITIONS INDICATED BY THE SUPPORTING FRAMEWORK, OPENINGS, AND ACTUAL DECK PIECE SIZES UTILIZED. THE ASSUMED CONSTRUCTION LIVE LOAD SHALL NOT BE LESS THAN 20 PSF. THE CONTRACTOR SHALL NOT EXCEED THE ASSUMED CONSTRUCTION DESIGN LIVE LOAD WITHOUT FIRST TAKING ALL NECESSARY SAFETY PRECAUTIONS SUCH AS SHORING, ETC. ADDITIONALLY, FOLLOW ALL APPLICABLE CITY, LOCAL AND AISI REQUIREMENTS FOR TEMPORARY CONSTRUCTION LOADINGS, IF MORE STRINGENT.

12. COMPOSITE METAL DECK DESIGN CRITERIA: (CELLULAR AND NON-CELLULAR DECKS)

A. METAL DECK: (CONSTRUCTION LOADS ONLY)

1A. MAXIMUM DECK DEFLECTION FOR CONCRETE WET WEIGHT SHALL BE LESS THAN OR EQUAL TO L/240, BUT NOT TO EXCEED 1/2"; COMPUTED EITHER ON A SINGLE SPAN BASIS, OR ON LOADING ONLY ONE (1) SPAN FOR MULTIPLE SPAN CONDITIONS.

2A. MAXIMUM STRESS IN DECK FOR CONCRETE WET WEIGHT AND CONSTRUCTION LOADS SHALL BE LESS THAN OR EQUAL TO 0.6 Fy (Fy = YIELD STRESS) COMPUTED ON A SINGLE SPAN BASIS, OR ON LOADING TWO ADJACENT SPANS FOR MULTIPLE SPAN CONDITIONS.

3A. ALLOW FOR AN AVERAGE OF 5 PSF WET CONCRETE WEIGHT FOR CONCRETE LEVELING (AS PER SPECIFICATIONS) IN ADDITION TO THE SPECIFIED SLAB THICKNESS, FOR STRESS AND DEFLECTION CALCULATIONS.

4A. PROVIDE DECK SHORING, IF REQUIRED, TO MEET THE CONDITIONS OF ITEMS NO. 1, 2, AND 3 ABOVE.

5A. ALL FORM DECKS, FOR REINFORCED CONCRETE SLABS, SHALL BE DESIGNED FOR THE SAME CRITERIA STATED IN ITEMS NOS. 1, 2, 3, AND 4 ABOVE.

B. COMPOSITE METAL DECK SLAB: (FINAL DESIGN LOAD)

1B. THE DECK SHALL DEVELOP FULL COMPOSITE ACTION FOR IMPOSED LOADS AS SHOWN IN THE DECK SCHEDULE.

2B. MAXIMUM DEFLECTION UNDER SUPERIMPOSED LOAD SHALL BE LESS THAN OR EQUAL TO L/360.

3B. MAXIMUM STRESS IN DECK FOR TOTAL LOAD USING APPROPRIATE NON-COMPOSITE AND COMPOSITE PROPERTIES SHALL BE LESS THAN OR EQUAL TO 0.75 FY.

4B. MAXIMUM ALLOWABLE STRESS IN CONCRETE SHALL BE AS PER ACI 318, LATEST EDITION.

5B. THE COMPOSITE DECK SHALL BE DESIGNED ON THE BASIS OF OBTAINING A MINIMUM FACTOR OF SAFETY OF 2 FOR THE TOTAL SUPERIMPOSED LOAD ON A SINGLE SPAN BASIS. TEST RESULTS SHALL BE FURNISHED TO SUBSTANTIATE THE FACTOR OF SAFETY.

16. SHEAR STUDS:

A. ALL SHEAR STUD PLACEMENT DIAGRAM SHOWN REPRESENT IDEALIZED CONDITIONS, AND ACTUAL FRAMING CONFIGURATIONS MAY REQUIRE ADDITIONAL MODIFICATIONS AND INTERPRETATIONS.

B. THE CONTRACTOR SHALL SUBMIT CHECKED SHOP DRAWINGS INDICATING THE SHEAR STUD LAYOUT, INCLUDING SIZE, SPACING AND GROUPING, FOR EACH BEAM.

C. THE NUMBER OF STUDS PER BEAM AS SHOWN ON THE DRAWINGS INCLUDES REDUCTIONS BASED ON RIB WIDTH, NUMBER OF STUDS PER CELL, DECK RIB ORIENTATION, AND SLAB THICKNESS AS PER AISC SPECIFICATIONS FOR COMPOSITE CONSTRUCTION, LATEST EDITION. THE ASSUMED ALLOWABLE HORIZONTAL SHEAR DESIGN VALUE (ASD) FOR A NOMINAL 3/4"-DIA. x 6" LONG STUD IS 10.5 KIPS PER STUD FOR NON-CELLULAR DECK WITH LIGHTWEIGHT CONCRETE AND 12.5 KIPS PER STUD FOR NON-CELLULAR DECK WITH NORMAL WEIGHT CONCRETE. THE ASSUMED DECK NOMINAL RIB HEIGHT IS 3". AND THE ASSUMED AVERAGE CONCRETE RIB WIDTH IS 6". THE METAL DECK CONTRACTOR SHALL SUBMIT LOAD TEST DATA VERIFYING THE HORIZONTAL SHEAR CAPACITY OF SHEAR STUDS FOR DIFFERENT DECK TYPES AND CELL CONFIGURATIONS, AS DETAILED ON THE SHOP DRAWINGS. IF ANY OF THE ASSUMPTIONS LISTED ABOVE ARE VIOLATED, THE METAL DECK CONTRACTOR SHALL SUBMIT STRUCTURAL DESIGN CALCULATIONS, PREPARED AND SEALED BY A PROFESSIONAL ENGINEER LICENSED IN THE STATE OF NEW YORK, BASED ON THE DETAILED SHOP DRAWINGS. PROVIDE ALL EXTRA STUDS AS MAY BE REQUIRED TO ACHIEVE THE TOTAL HORIZONTAL SHEAR CAPACITY.

D. MAXIMUM SPACING OF STUDS SHALL BE 12" ON CENTER.

E. SHEAR STUDS SHALL BE EITHER WELDED DIRECTLY TO STRUCTURAL STEEL ELEMENTS AT LOCATIONS WITHOUT DECK OR WELDED TYPE THROUGH THE METAL DECK BY PREQUALIFIED METHODS. IF THROUGH DECK WELDING IS UNFEASIBLE, THE STUDS SHALL BE INSTALLED IN PRE-PUNCHED HOLES IN THE METAL DECK. THE CONTRACTOR SHALL ESTABLISH SPECIFIC WELDING REQUIREMENTS FOR EACH THICKNESS OF FRAMING ELEMENT AND/OR GAGE OF METAL DECK.

17. THE OWNER'S TESTING LABORATORY SHALL INSPECT AND TEST ALL METAL DECK AND SHEAR STUD INSTALLATION WORK. SEE TECHNICAL SPECIFICATION SECTION 05310, "STEEL DECK" FOR ADDITIONAL TESTING AND INSPECTION REQUIREMENTS.

18. CONDUIT SHALL NOT BE PLACED IN STRUCTURAL SLABS.

19. ALL ELEVATIONS ARE REFERENCED TO A LOCAL SITE DATUM, WHERE Z = 0'-0" = 44'-6" BOROUGH OF MANHATTAN DATUM (2.75' ABOVE NATIONAL GEODETIC SURVEY VERTICAL DATUM OF 1929; MEAN SEA LEVEL, SANDY HOOK, NEW JERSEY).

20. SEE SPECIFICATION SECTION 05310, "STEEL DECK," FOR ADDITIONAL REQUIREMENTS.



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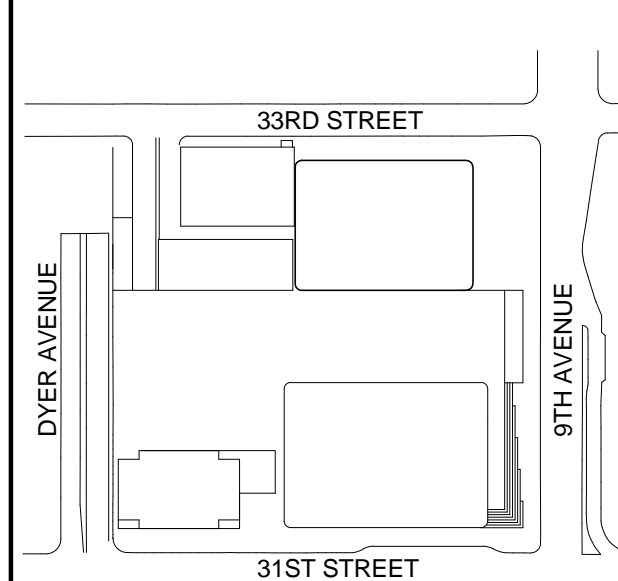
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Key Plan:



Seal & Signature

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NOT FOR CONSTRUCTION

6	20 JUN 2014	ISSUED FOR FOUNDATION BID
5	20 JUN 2014	ISSUED FOR FOUNDATION PERMIT
4	20 DEC 2013	ISSUED FOR FOUNDATION PERMIT
3	15 NOV 2013	ISSUED FOR 50% PROGRESS PRICING
2	12 JUL 2013	ISSUED FOR 90% DESIGN DEVELOPMENT
1	19 MAR 2012	ISSUED FOR RECONCILIATION

No. Date Description

Sheet Name

STRUCTURAL
STEEL AND
METAL DECK
NOTES

Project No.: 211157	B-SCAN Sheet No.: S-005.00
Date: 20 JUN 2014	Sheet No.: S-005
Scale: 1/2" = 1'-0"	Page No.: 5 of 90
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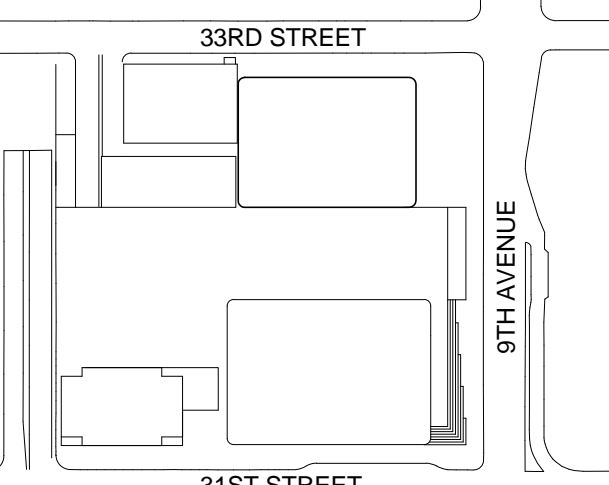
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No. Date Description
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**LOADING
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211157

Date:

20 JUN 2014

Scale:

As indicated

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S-010

B-SCAN Sheet No.:

S-010.00


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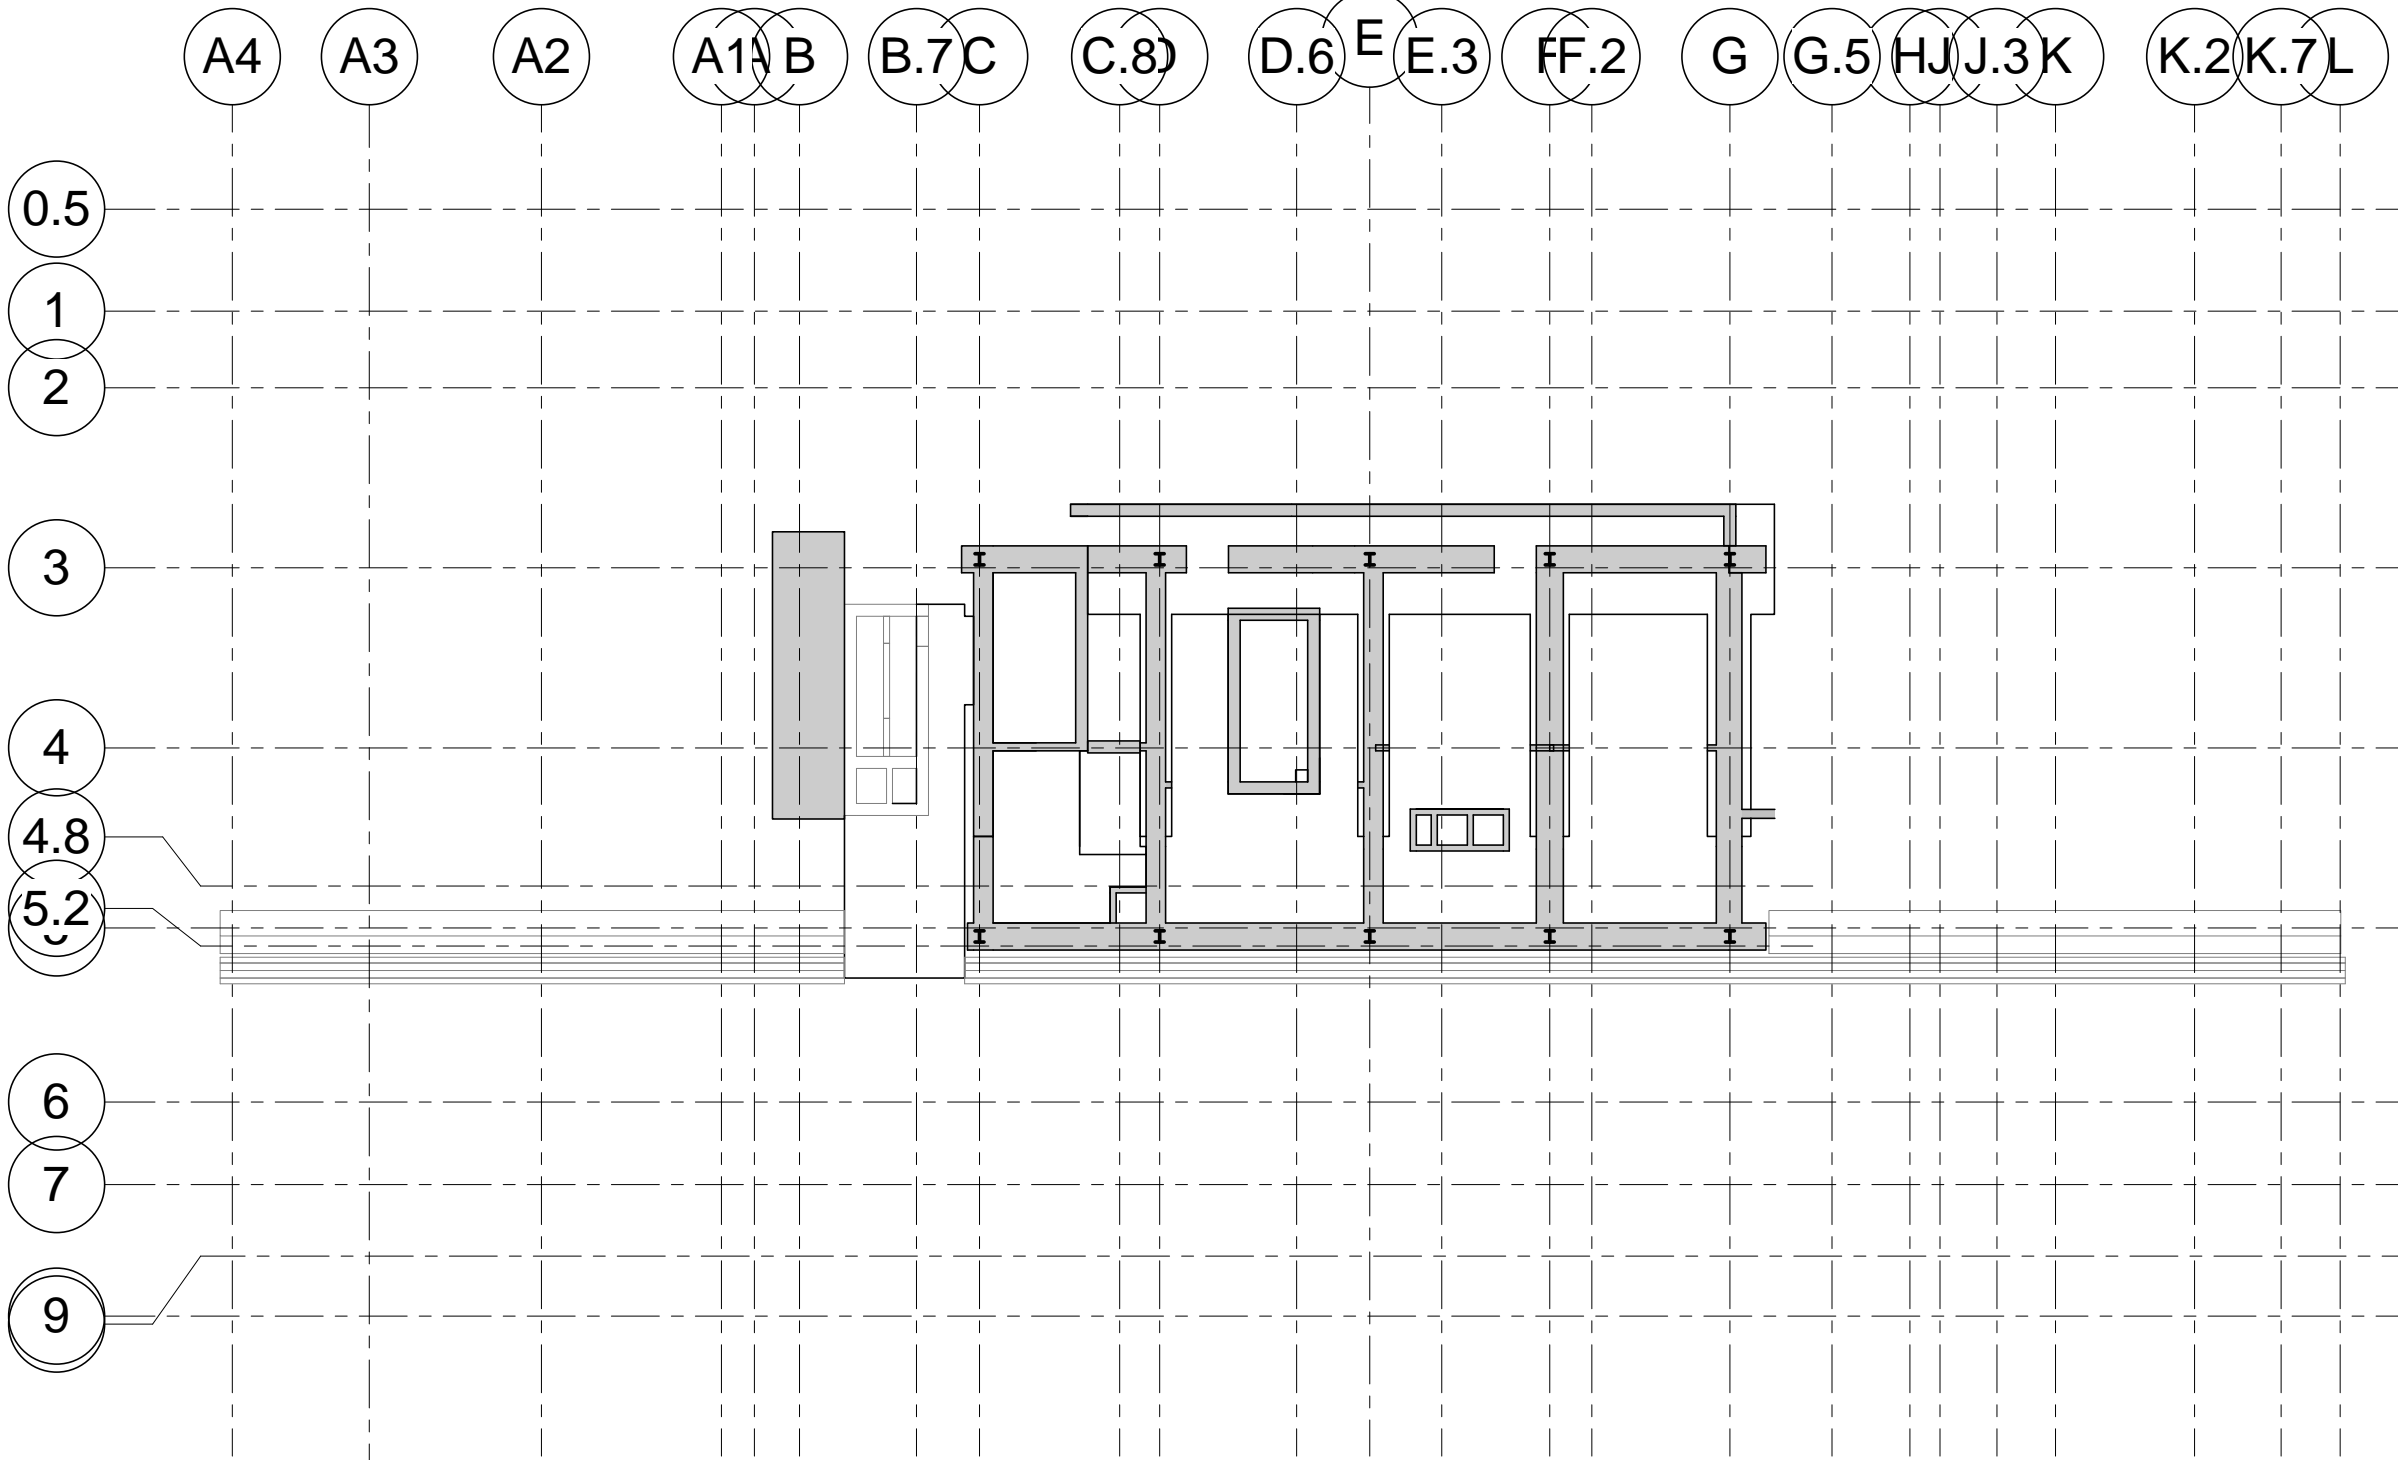
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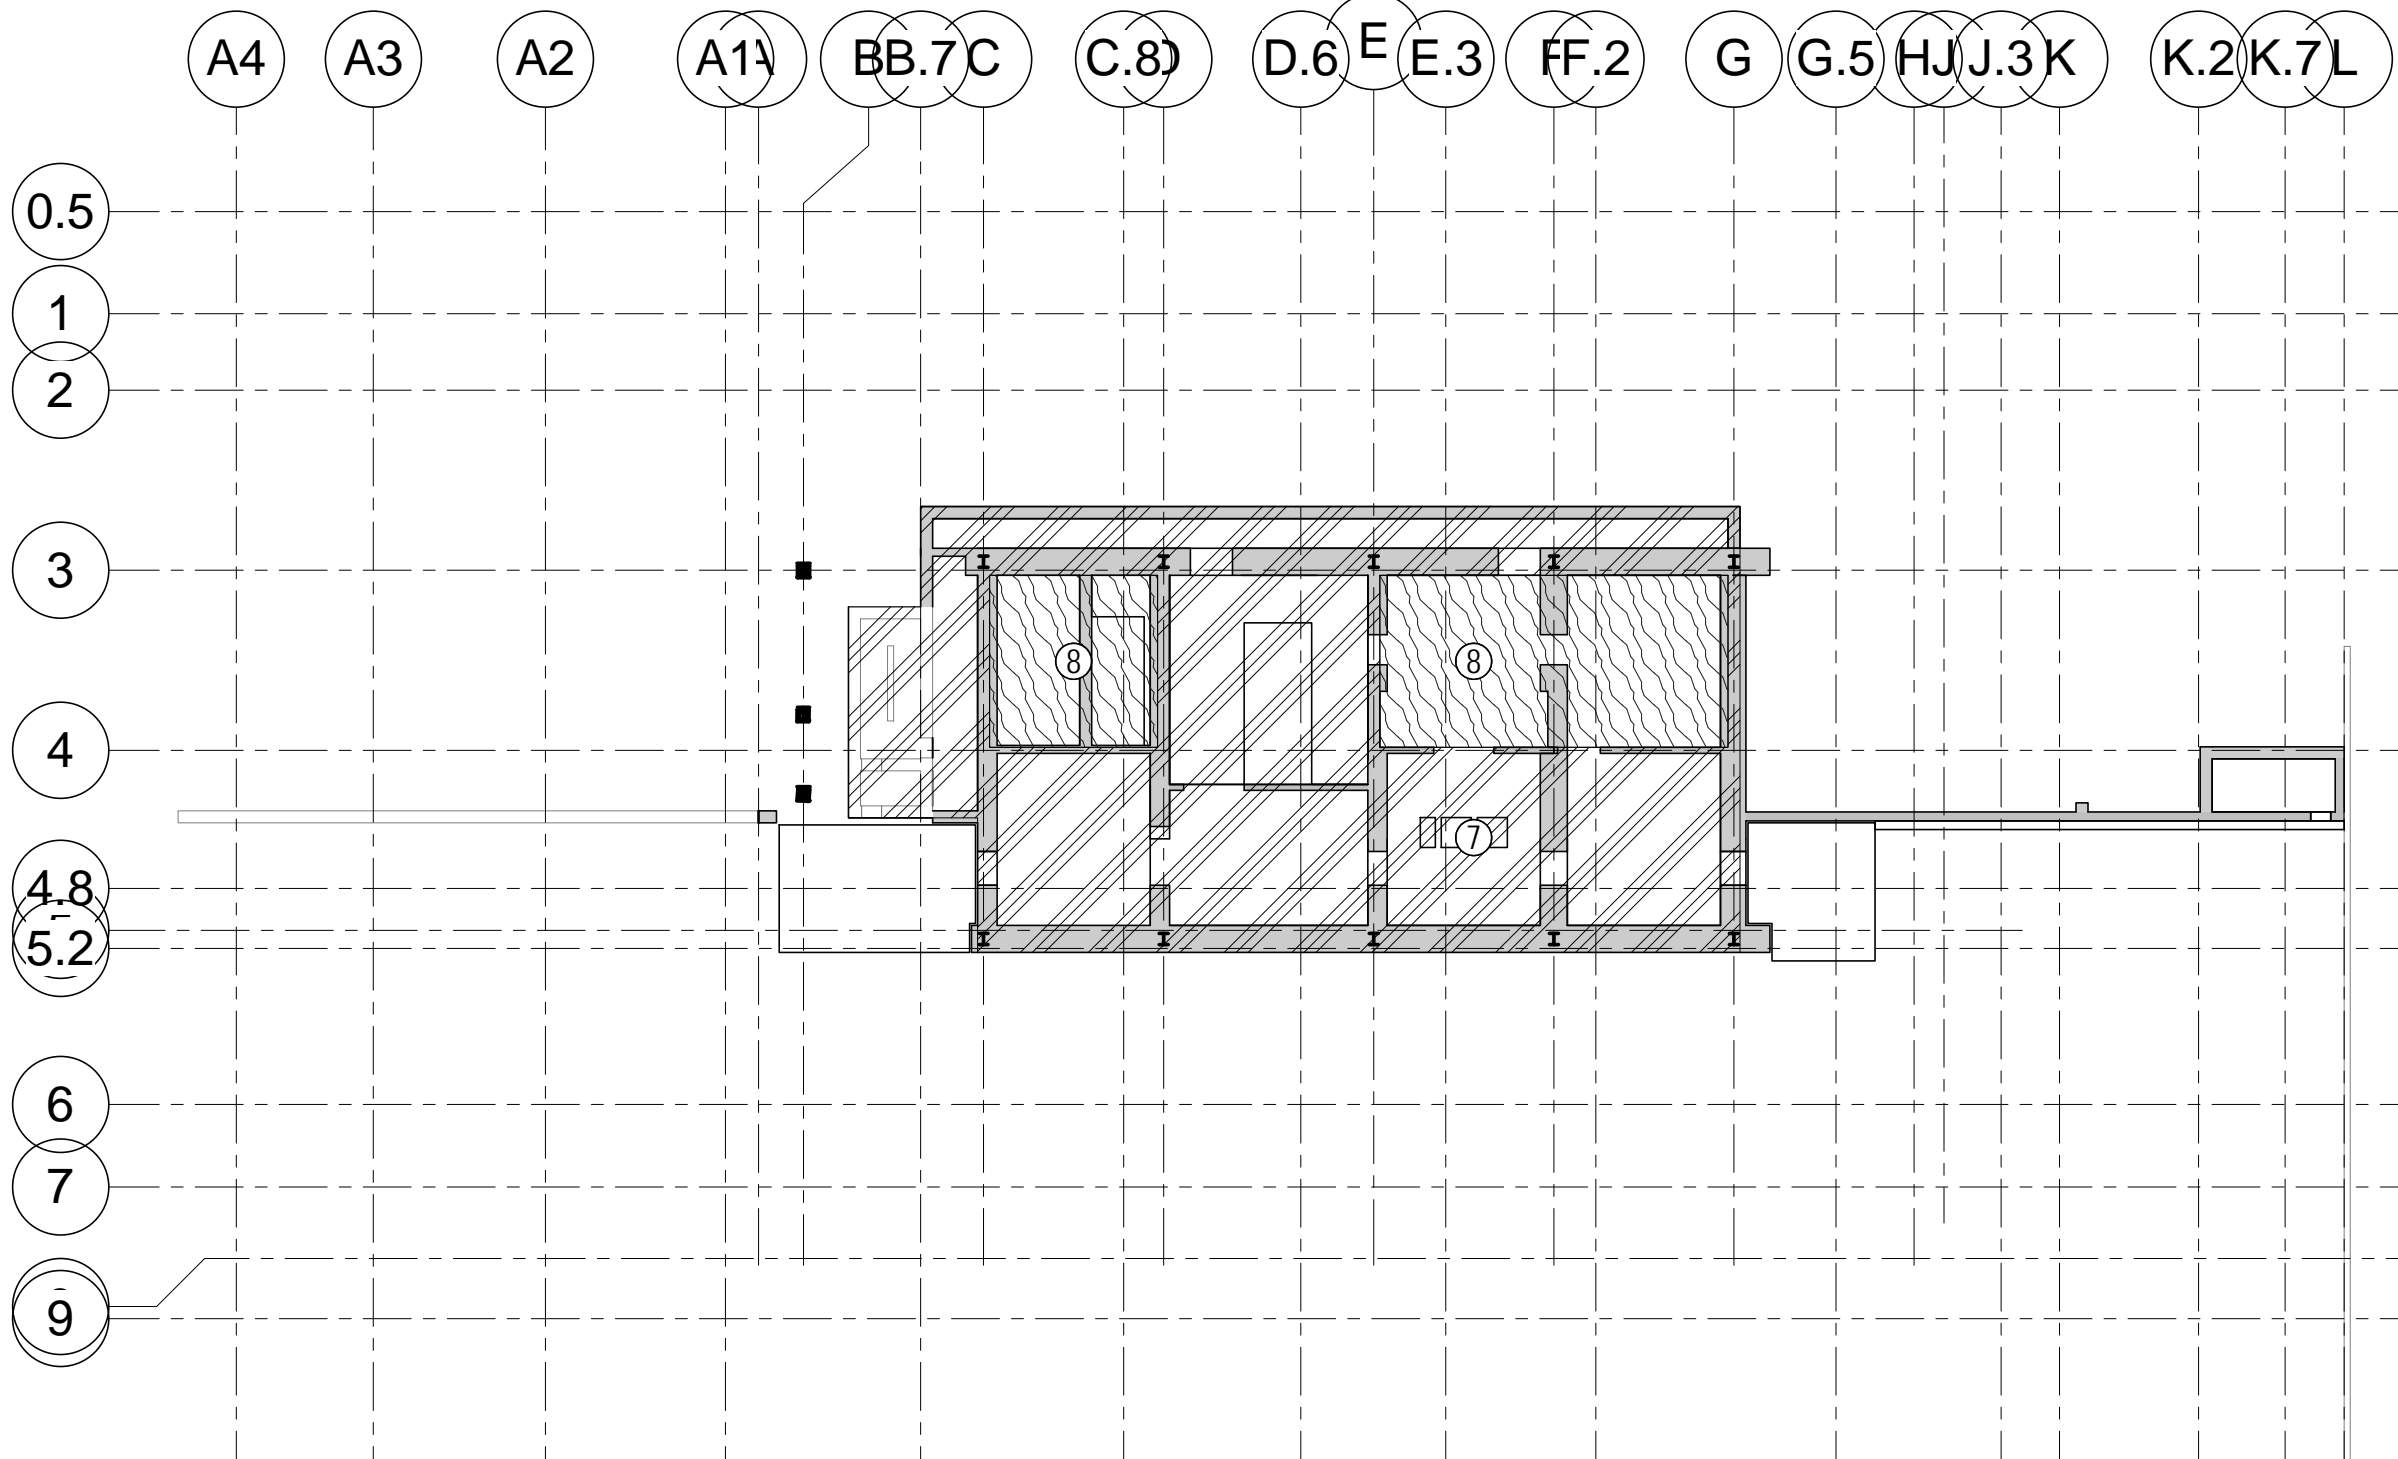
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②	MECHANICAL	60	150
③	HEAVY MECHANICAL	60	225
④	LIGHT MECHANICAL	50	100
⑤	OFFICE	45	50
⑥	PLAZA	60	100
⑦	CORRIDOR	50	100
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⑨	BACK OF HOUSE	50	50
⑩	ROOF MECH	60	250
⑪	RETAIL	60	100




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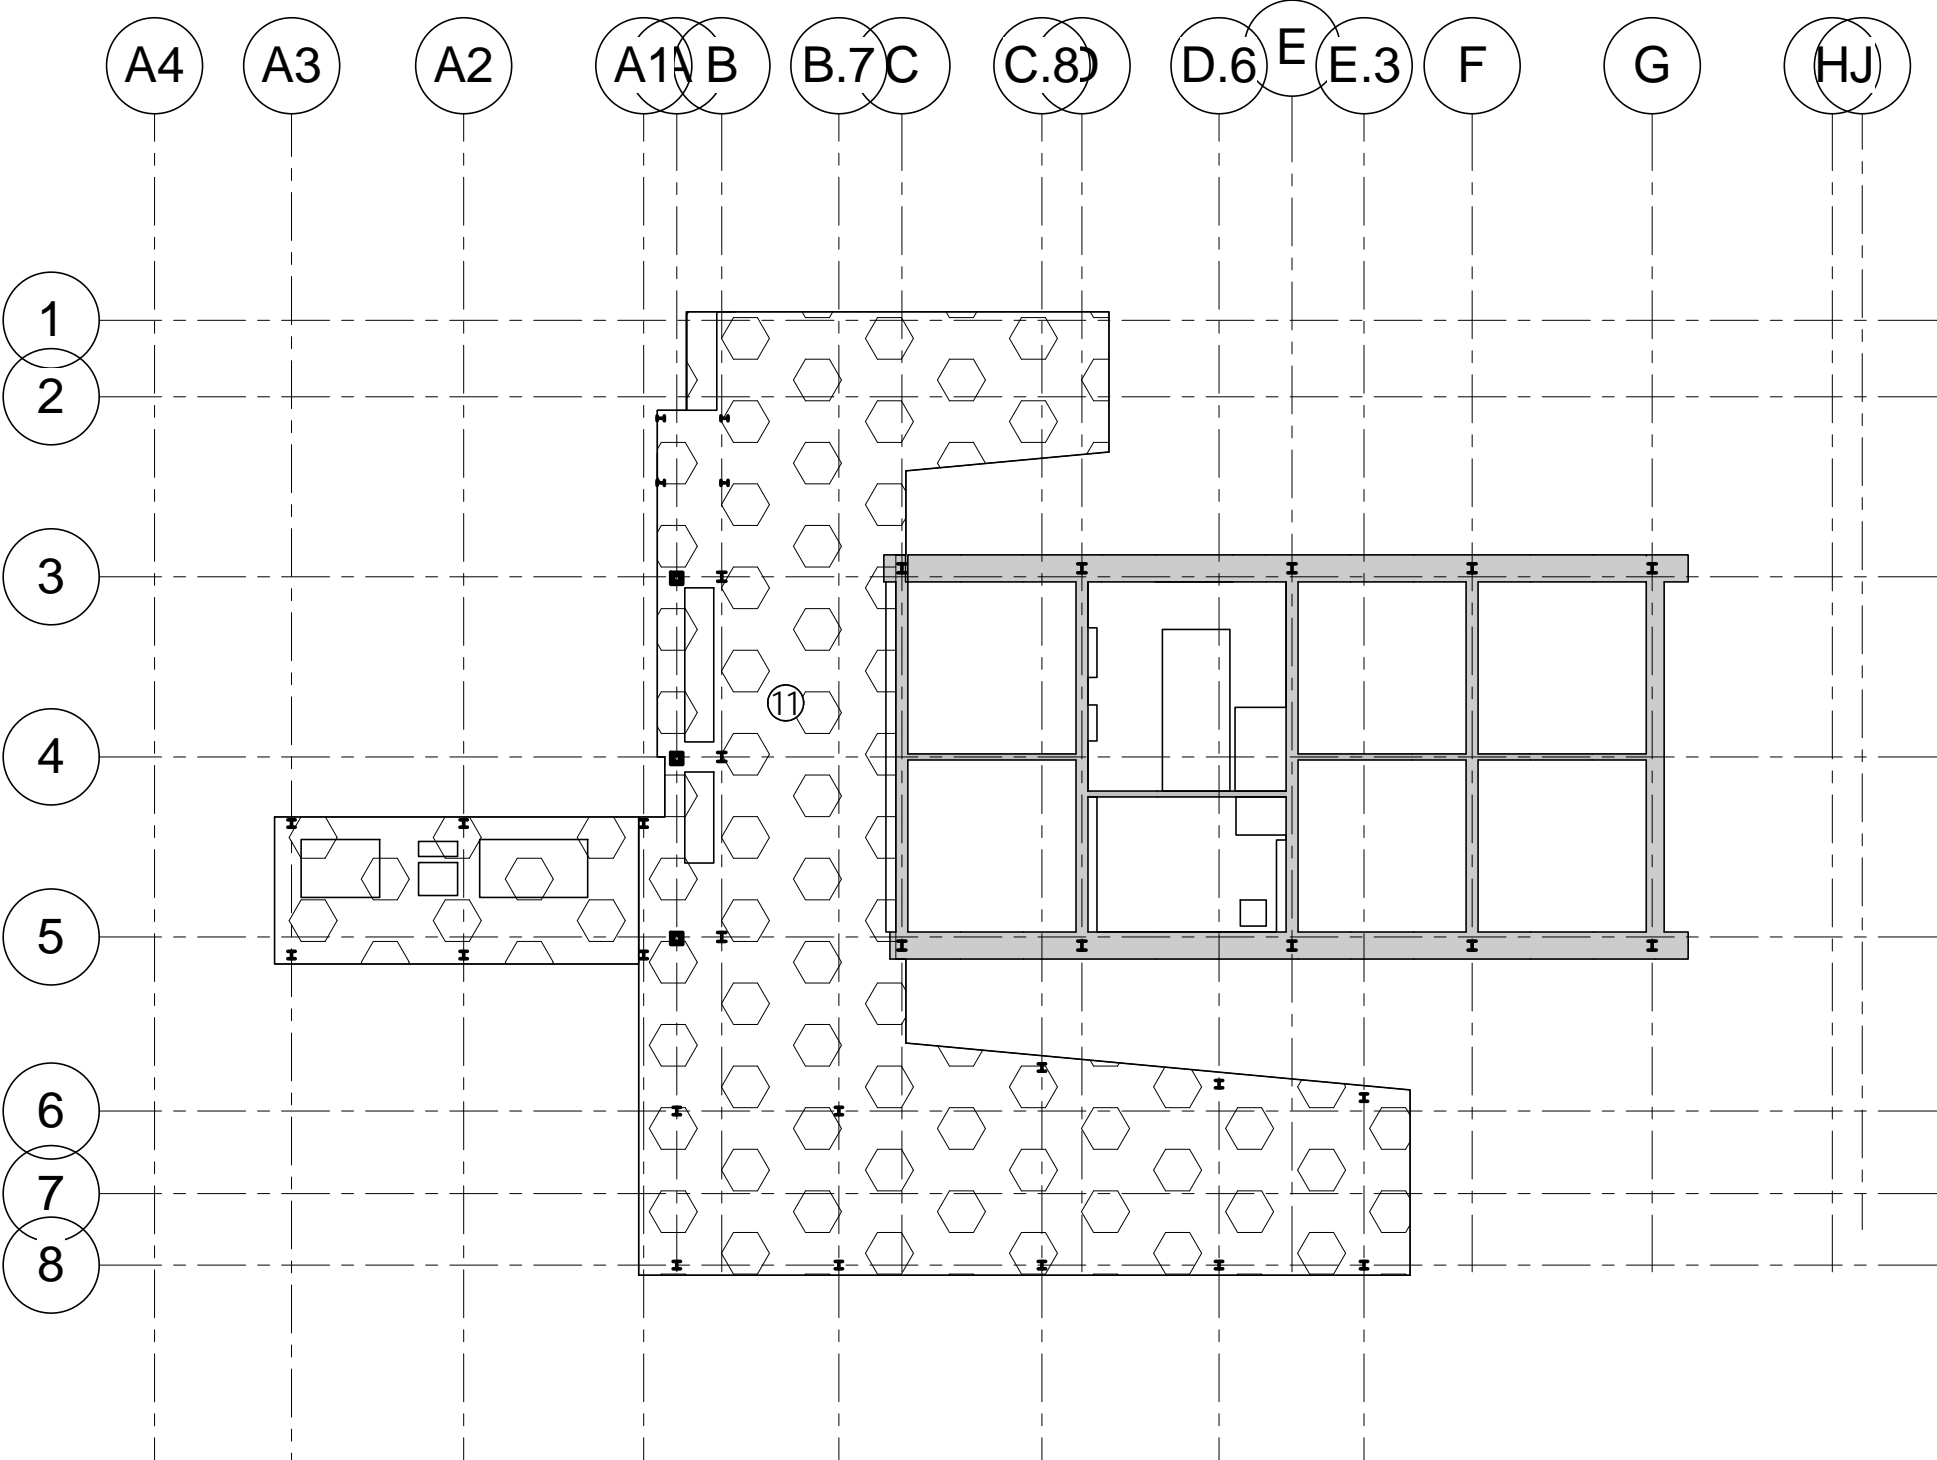
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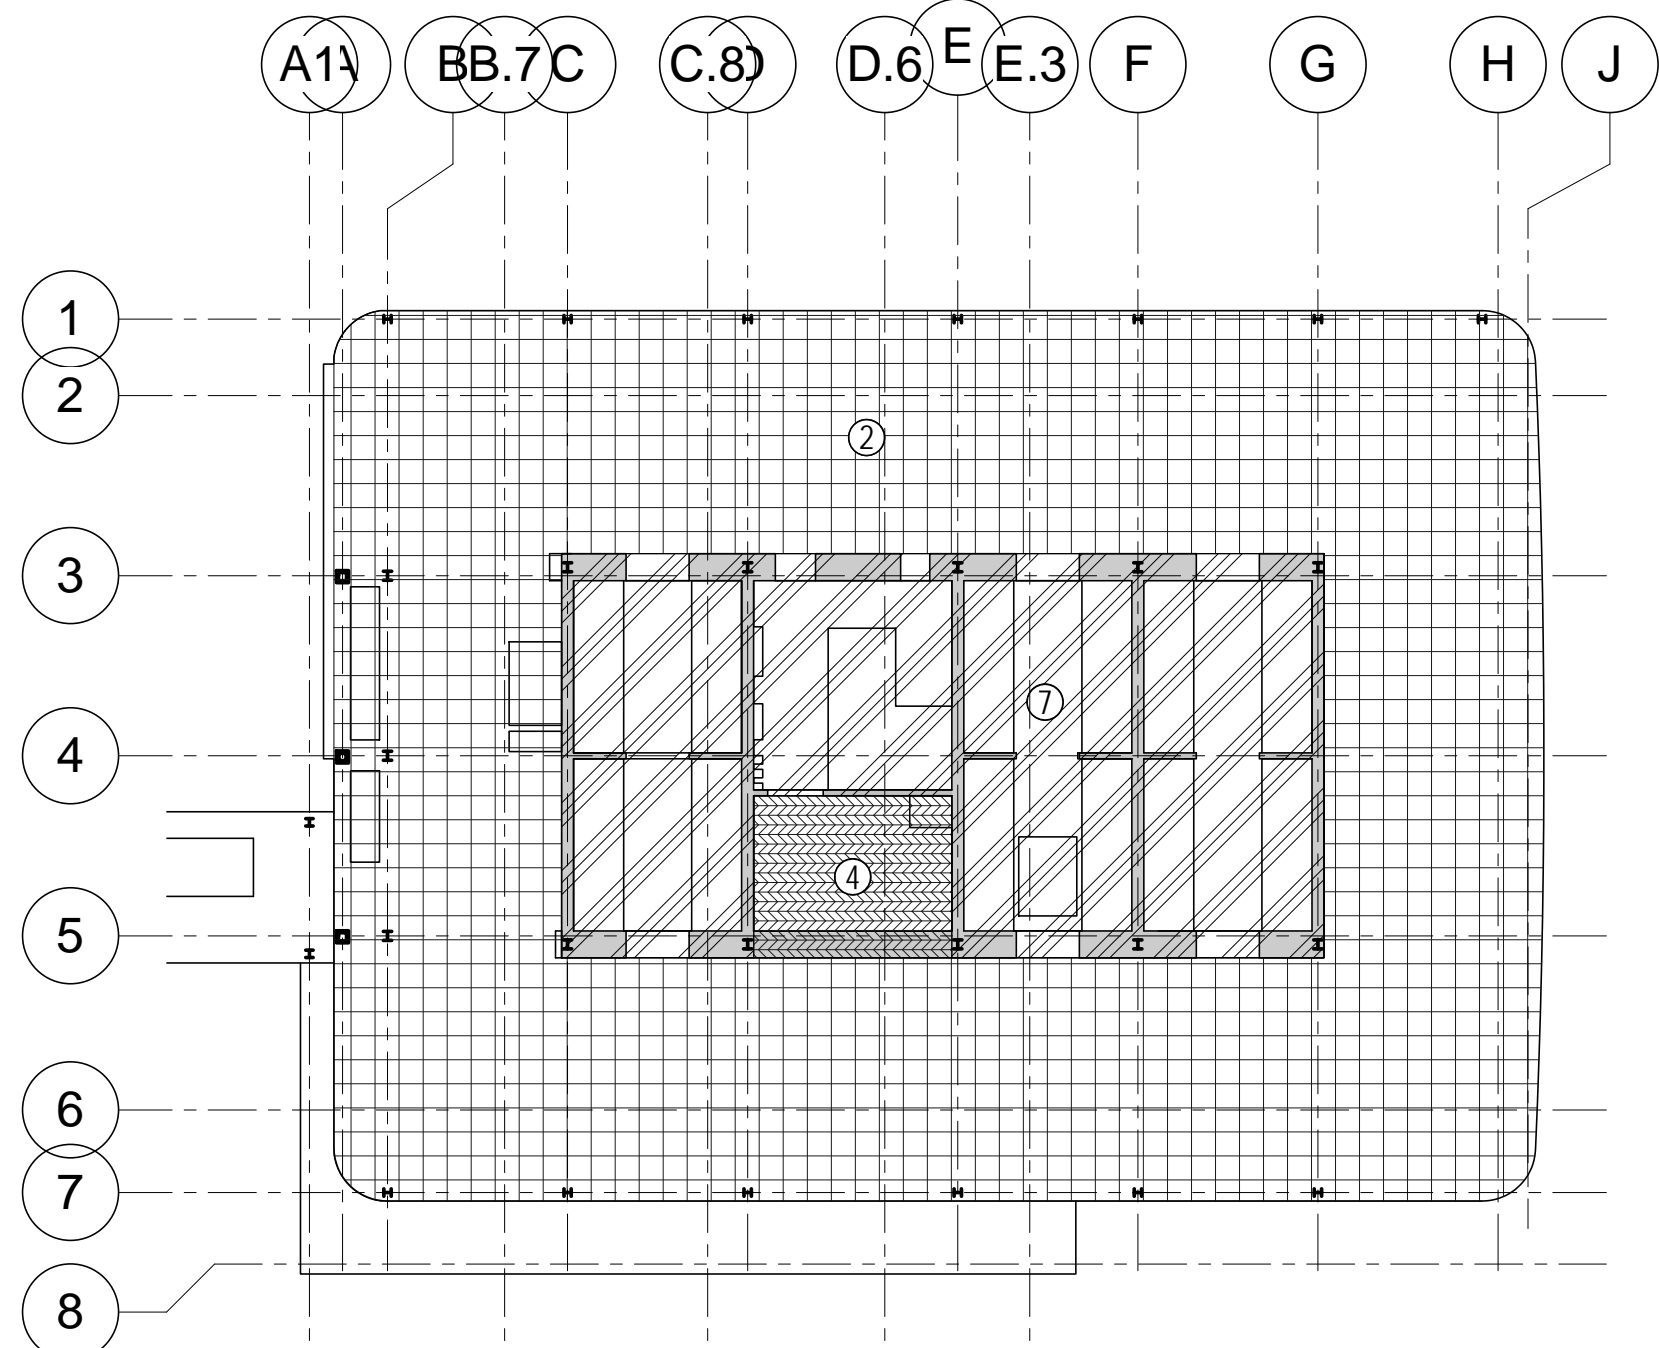
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NOT TO SCALE




4 LEVEL 1 LOADING DIAGRAM
1/32" = 1'-0"

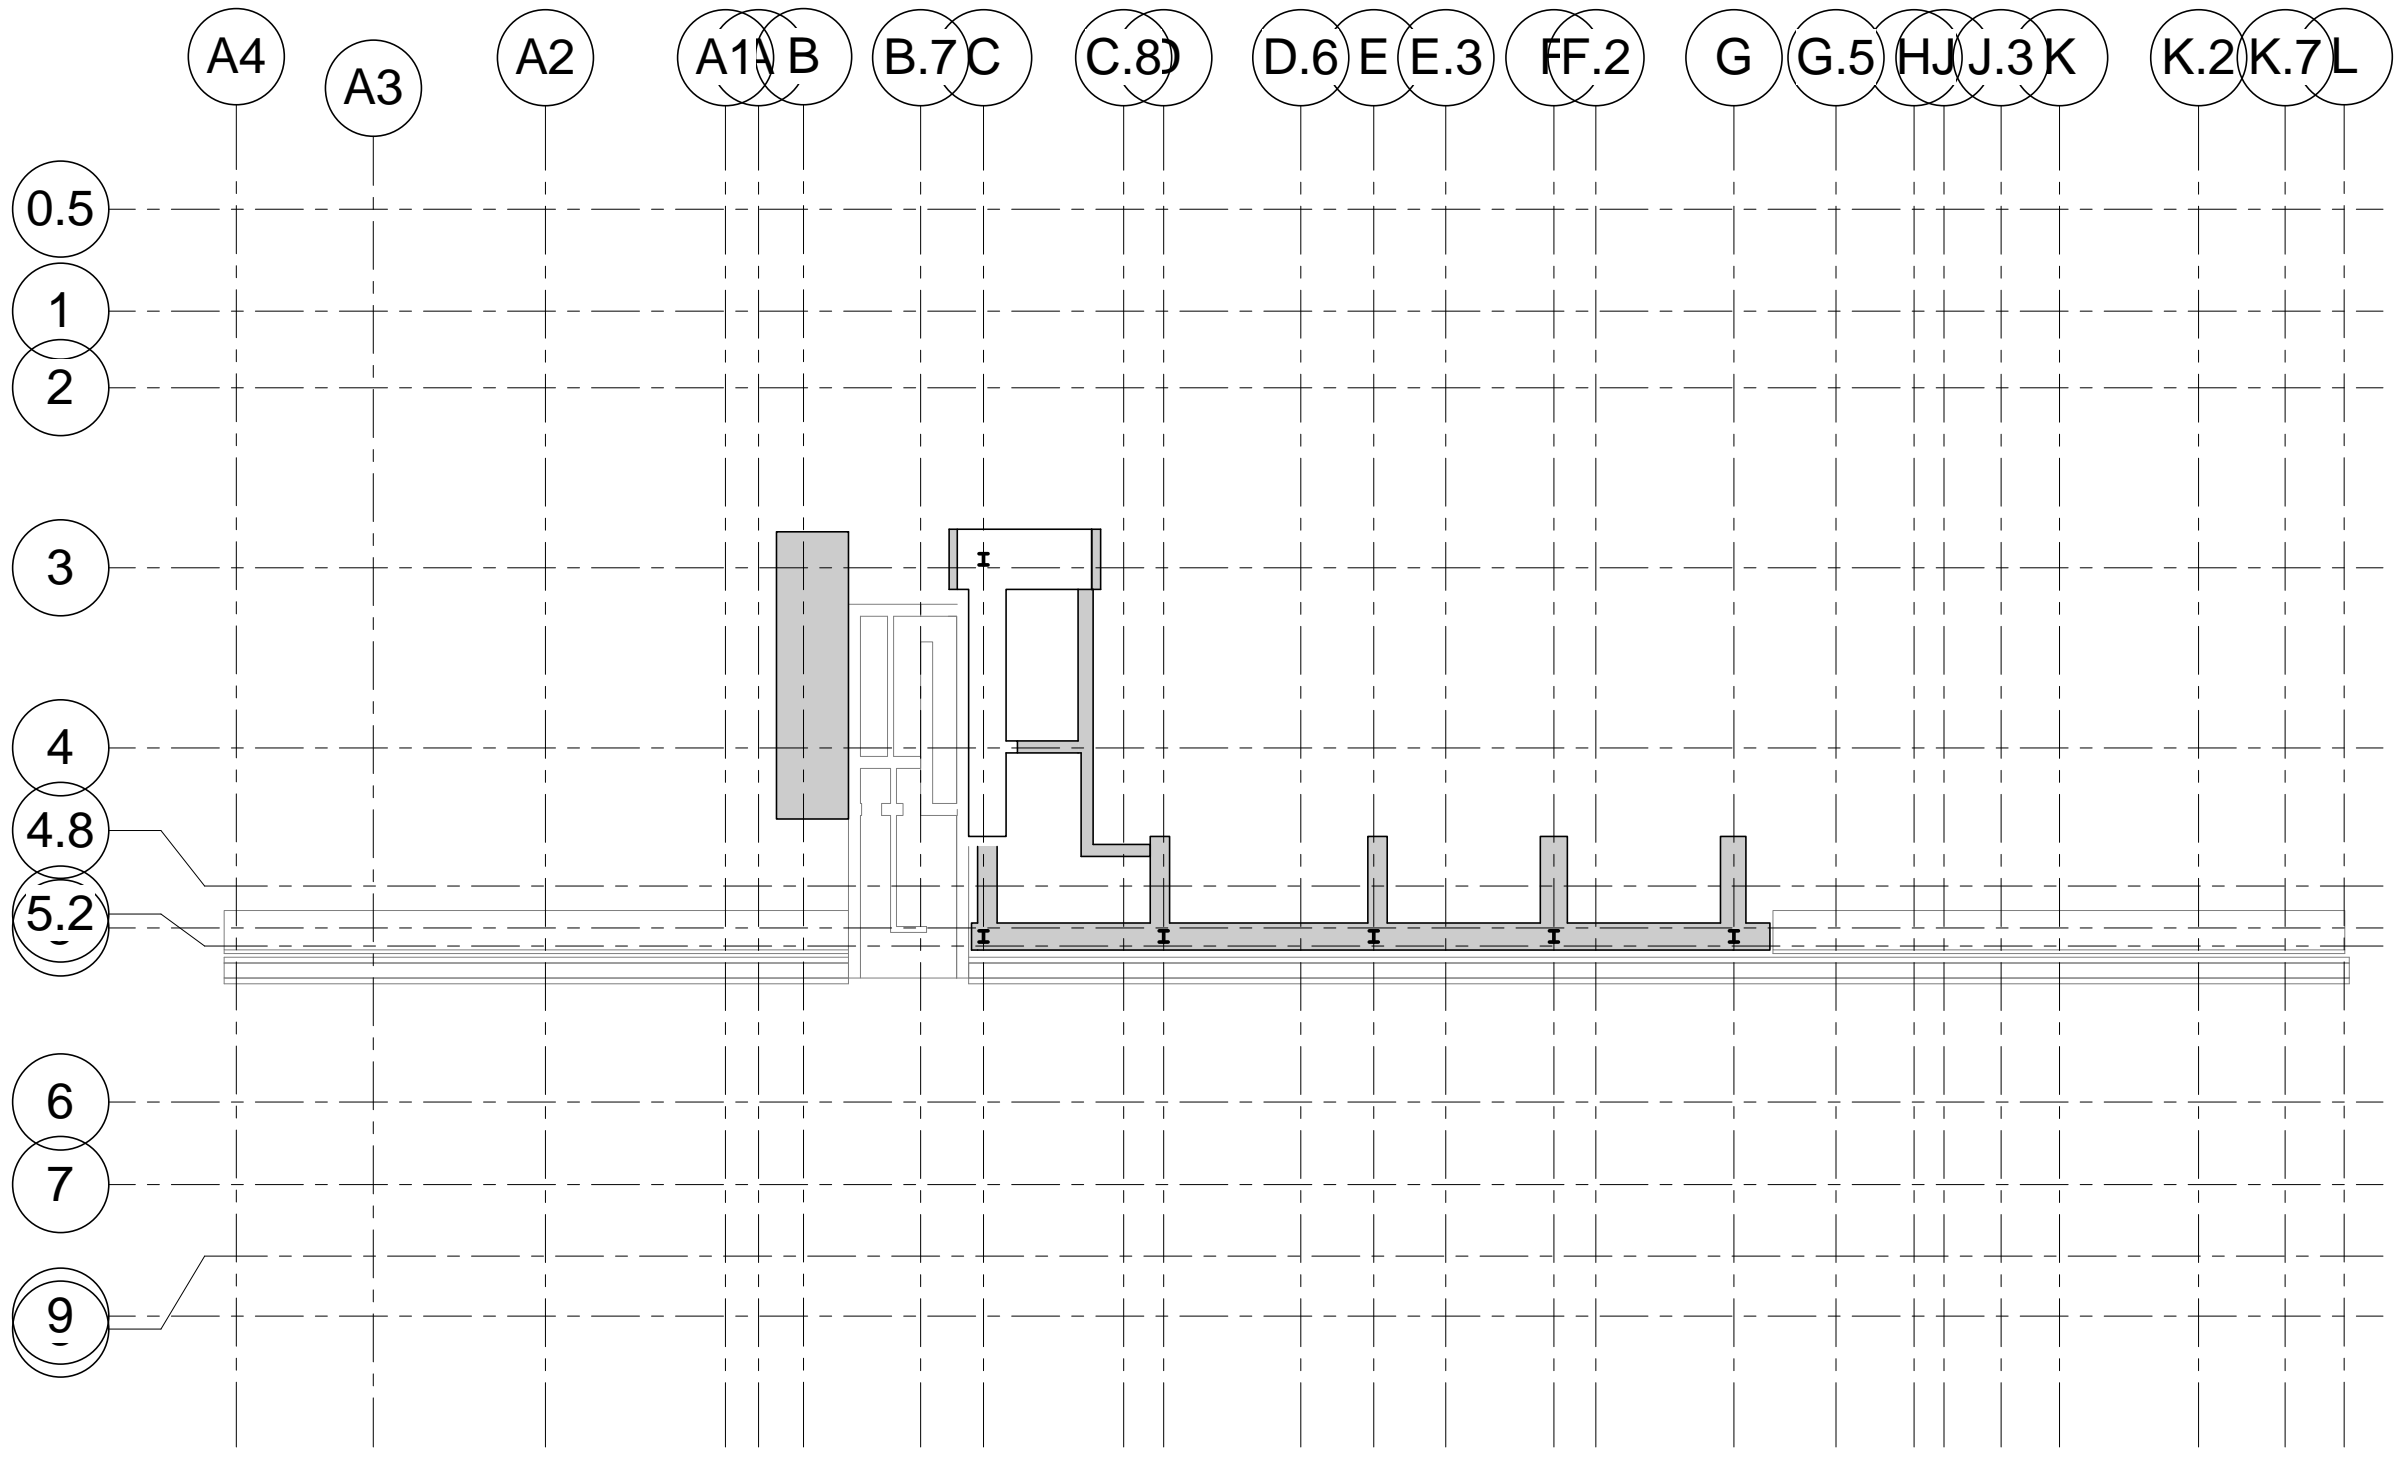


5 LEVEL 2 LOADING DIAGRAM
1/32" = 1'-0"

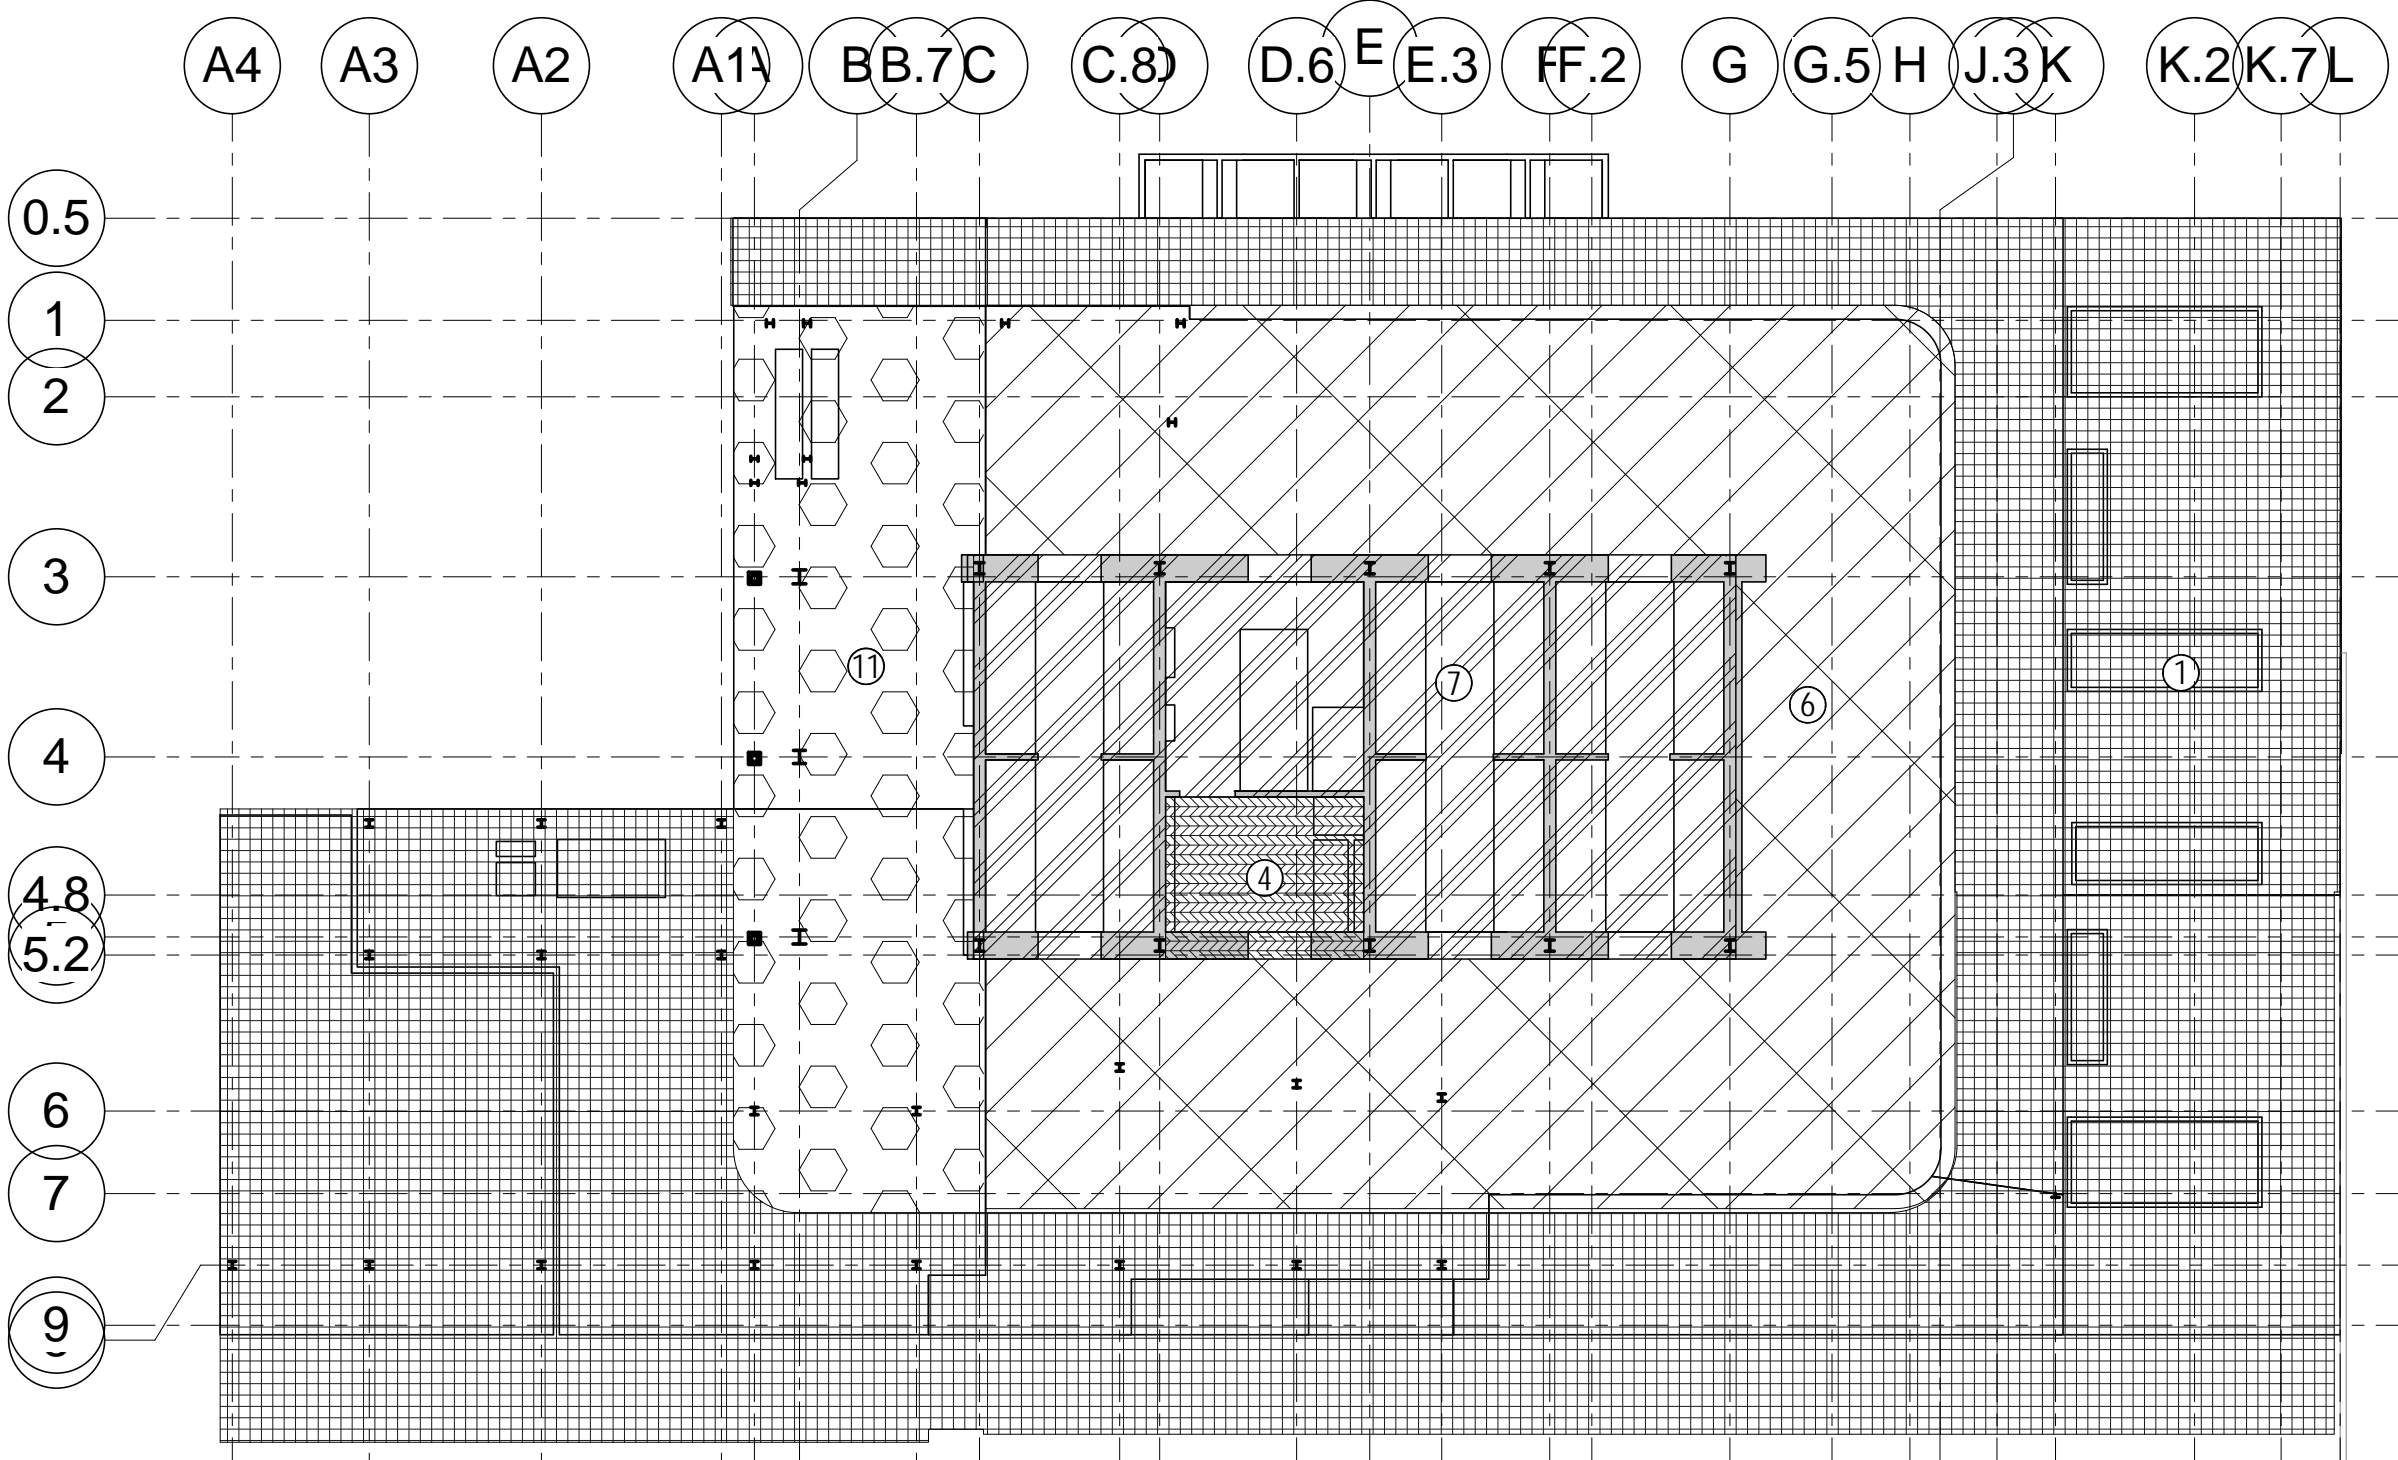

6 LEVEL 4 MECH. LOADING DIAGRAM
1/32" = 1'-0"

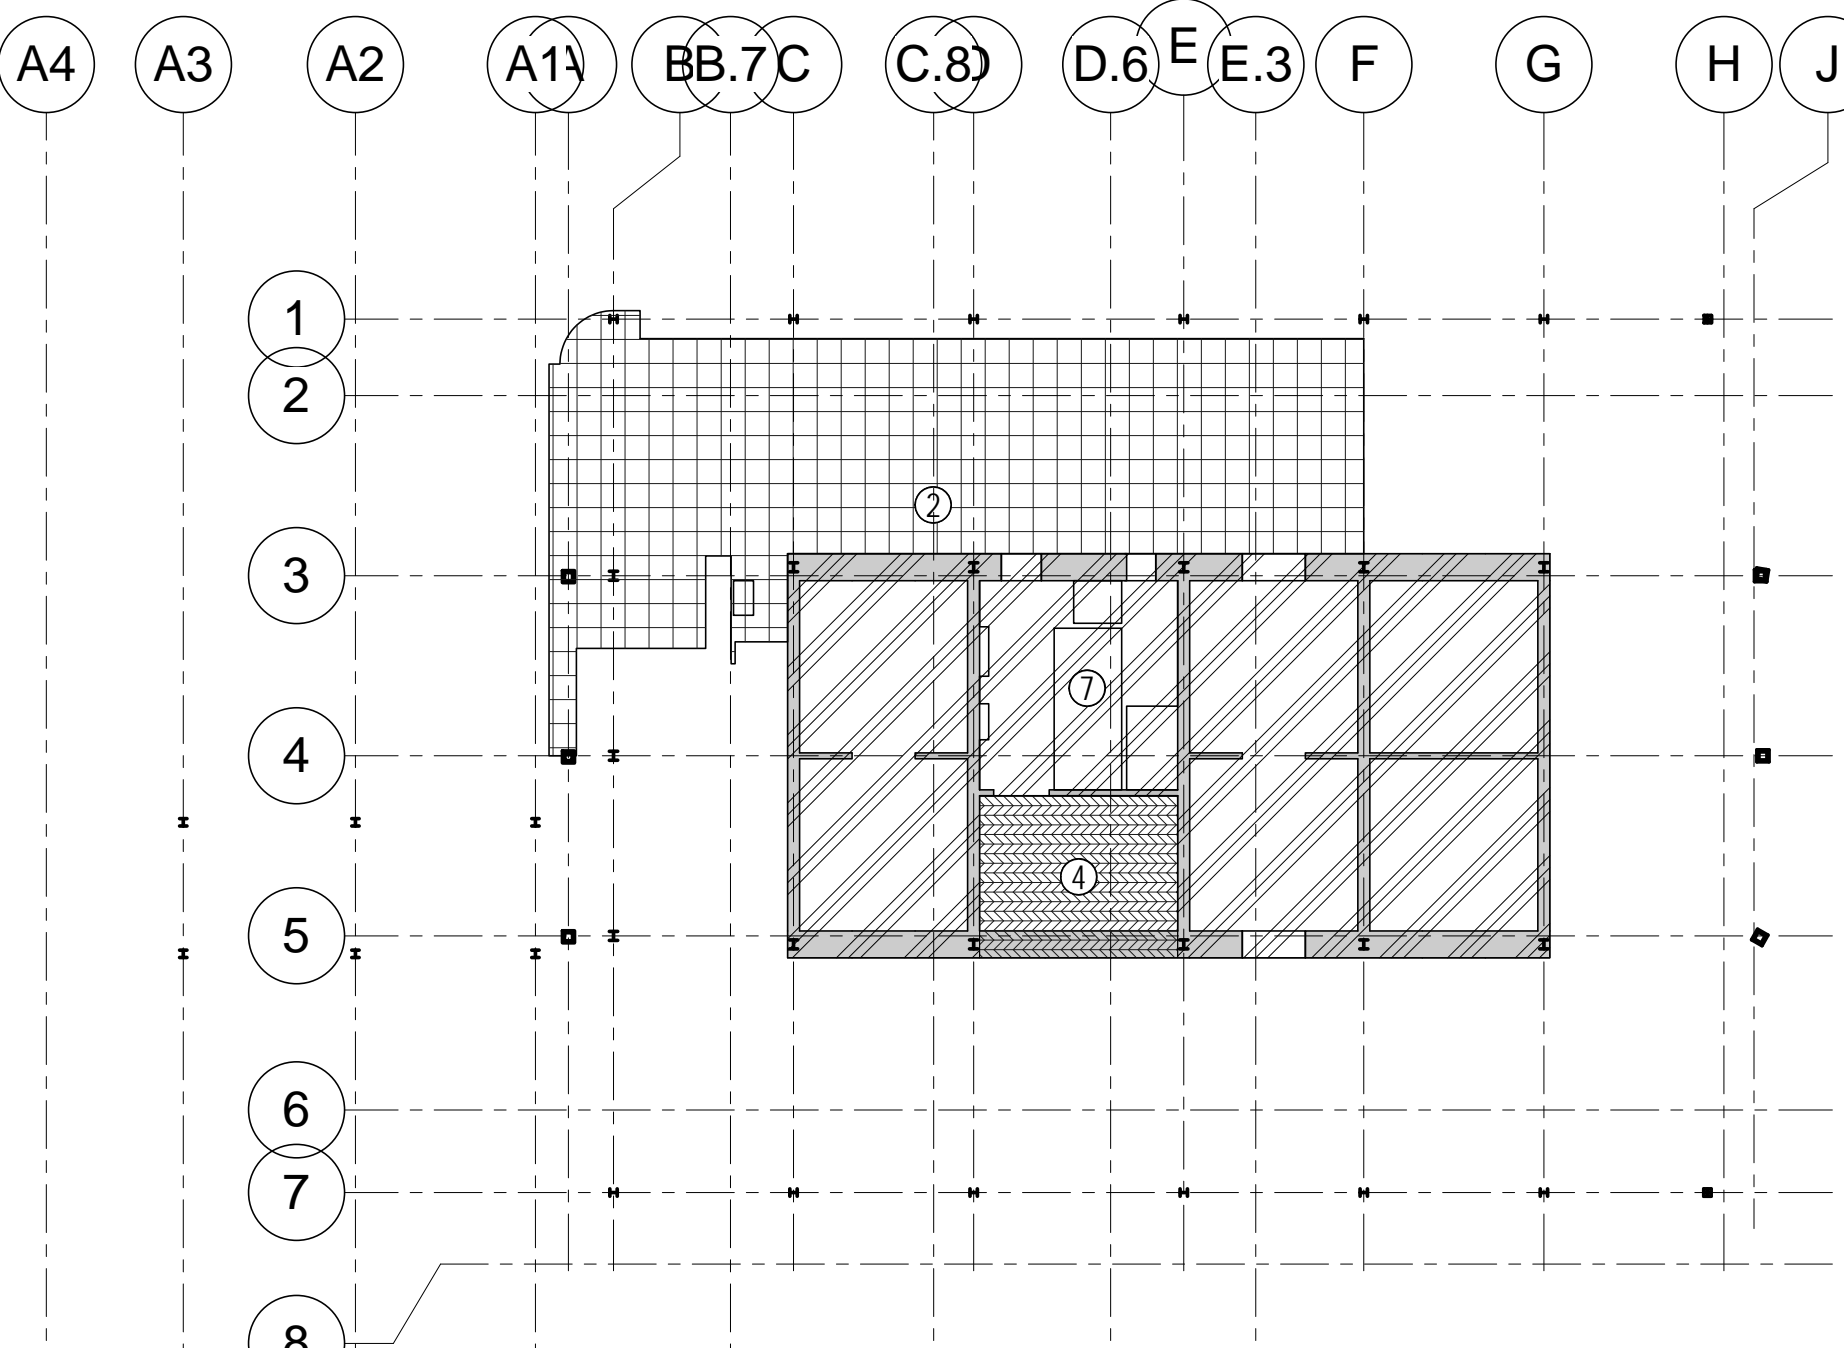

7 LEVEL 5 MECHANICAL MEZZ. LOADING DIAGRAM
1/32" = 1'-0"

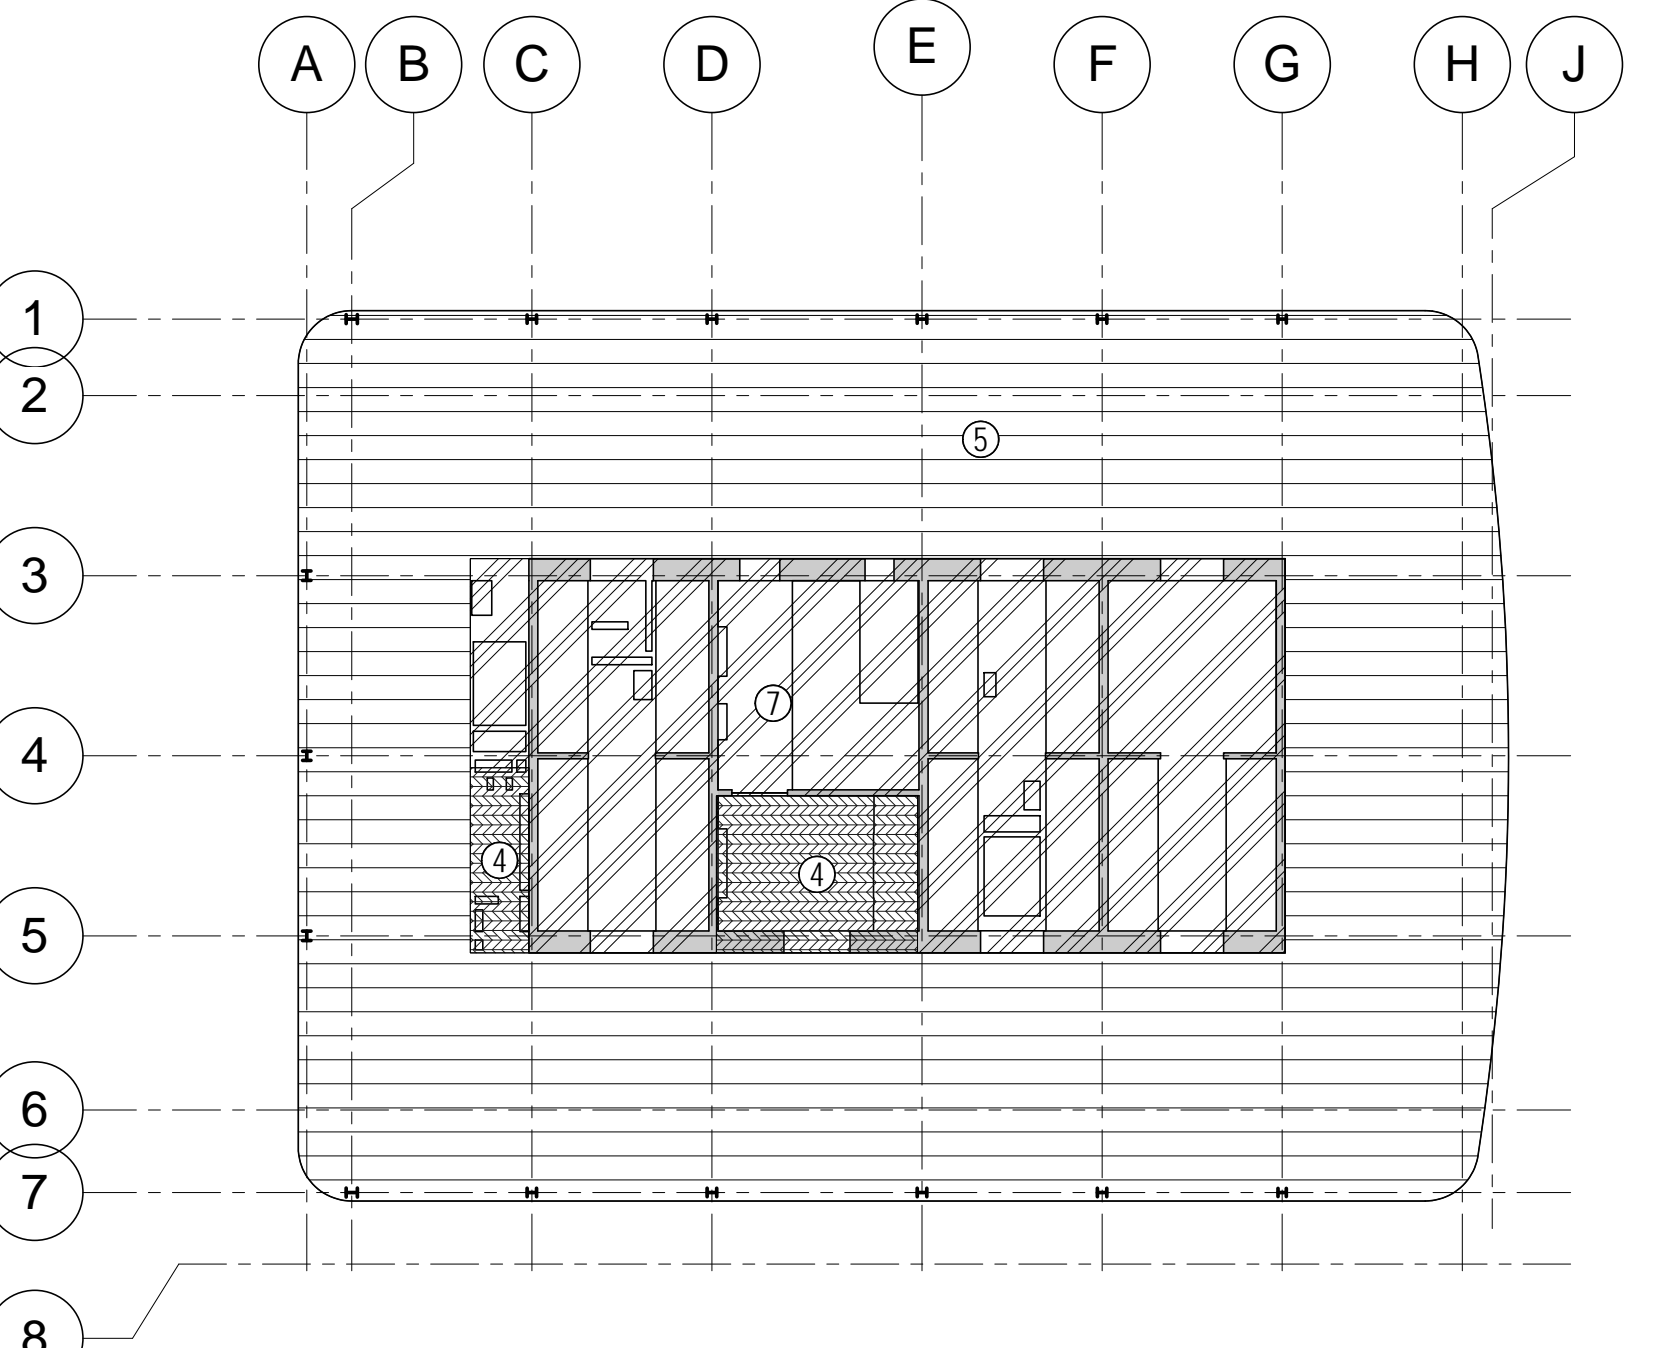

8 LEVEL 22 TYP LOW-RISE LOADING DIAGRAM
1/32" = 1'-0"



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New York, NY 10122

Landscape Consultant
Field Operations
475 10th Avenue, New York, NY 10018

Security Consultant
Ducibella, Ventor & Santoro
250 State Street #F1, North Haven, CT 06473

Blast Consultant
Weidinger Associates, Inc.
40 Wall Street, New York, NY 10005


Acoustical Consultant
Cerami & Associates
404 Fifth Avenue #8, New York, NY 10018

Vibration Consultant
Wilson, Uhrig & Associates, Inc.
65 Broadway, Suite 401, New York, NY 10006


Code Consultant
Code Consultants Professional Engineers PC
215 West 40th Street, 15th Floor, New York, NY 10018

Facade Maintenance Consultant
Entek Engineering LLC
166 Ames Street, Hackensack, NJ 07601

Wind Tunnel Consultant
Rowan Williams Davies & Irwin Inc.
650 Woodlawn Road West, Guelph
Ontario, Canada N1K 1B8

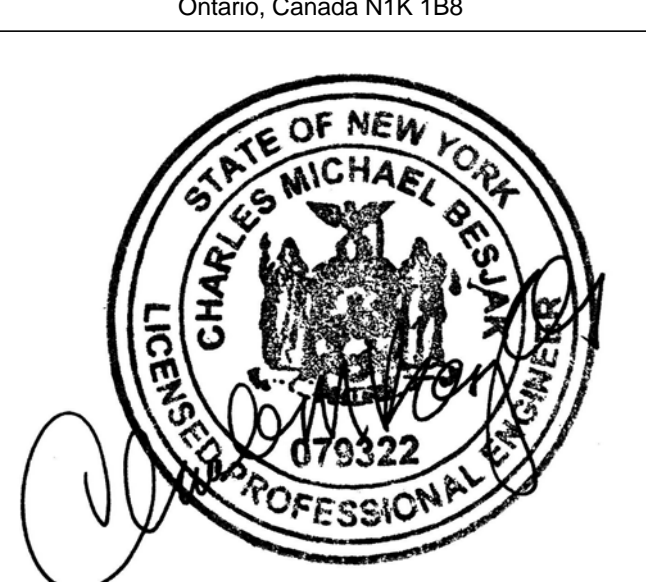

Key Plan:

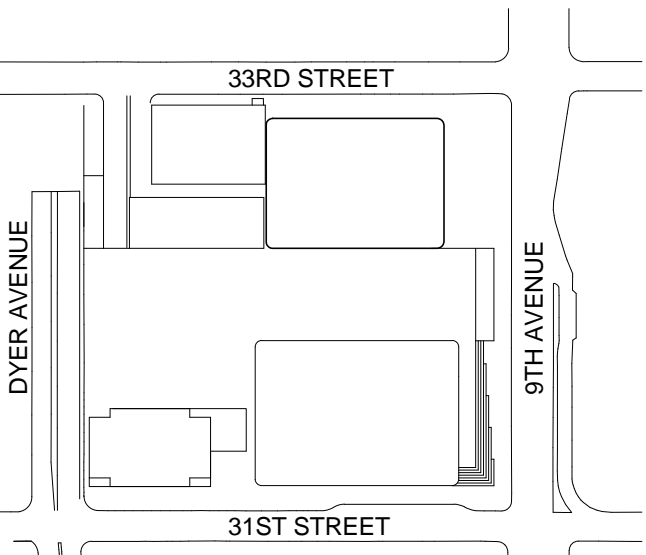

Seal & Signature:


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5	20 JUN 2014	ISSUED FOR FOUNDATION PERMIT
4	20 DEC 2013	ISSUED FOR FOUNDATION PERMIT
3	15 NOV 2013	ISSUED FOR 30% PROGRESS PRICING
2	12 JUL 2013	ISSUED FOR 90% DESIGN DEVELOPMENT
1	19 MAR 2012	ISSUED FOR RECONCILIATION

No. Date Description
Sheet Name:

**OVERALL
LEVEL B PLAN**

Project No.: 211157	B-SCAN Sheet No.: S-050.00
Date: 20 JUN 2014	Sheet No.: S-050
Scale: 1/16" = 1'-0"	Page No.: 8 of 90
File No.: S-050	

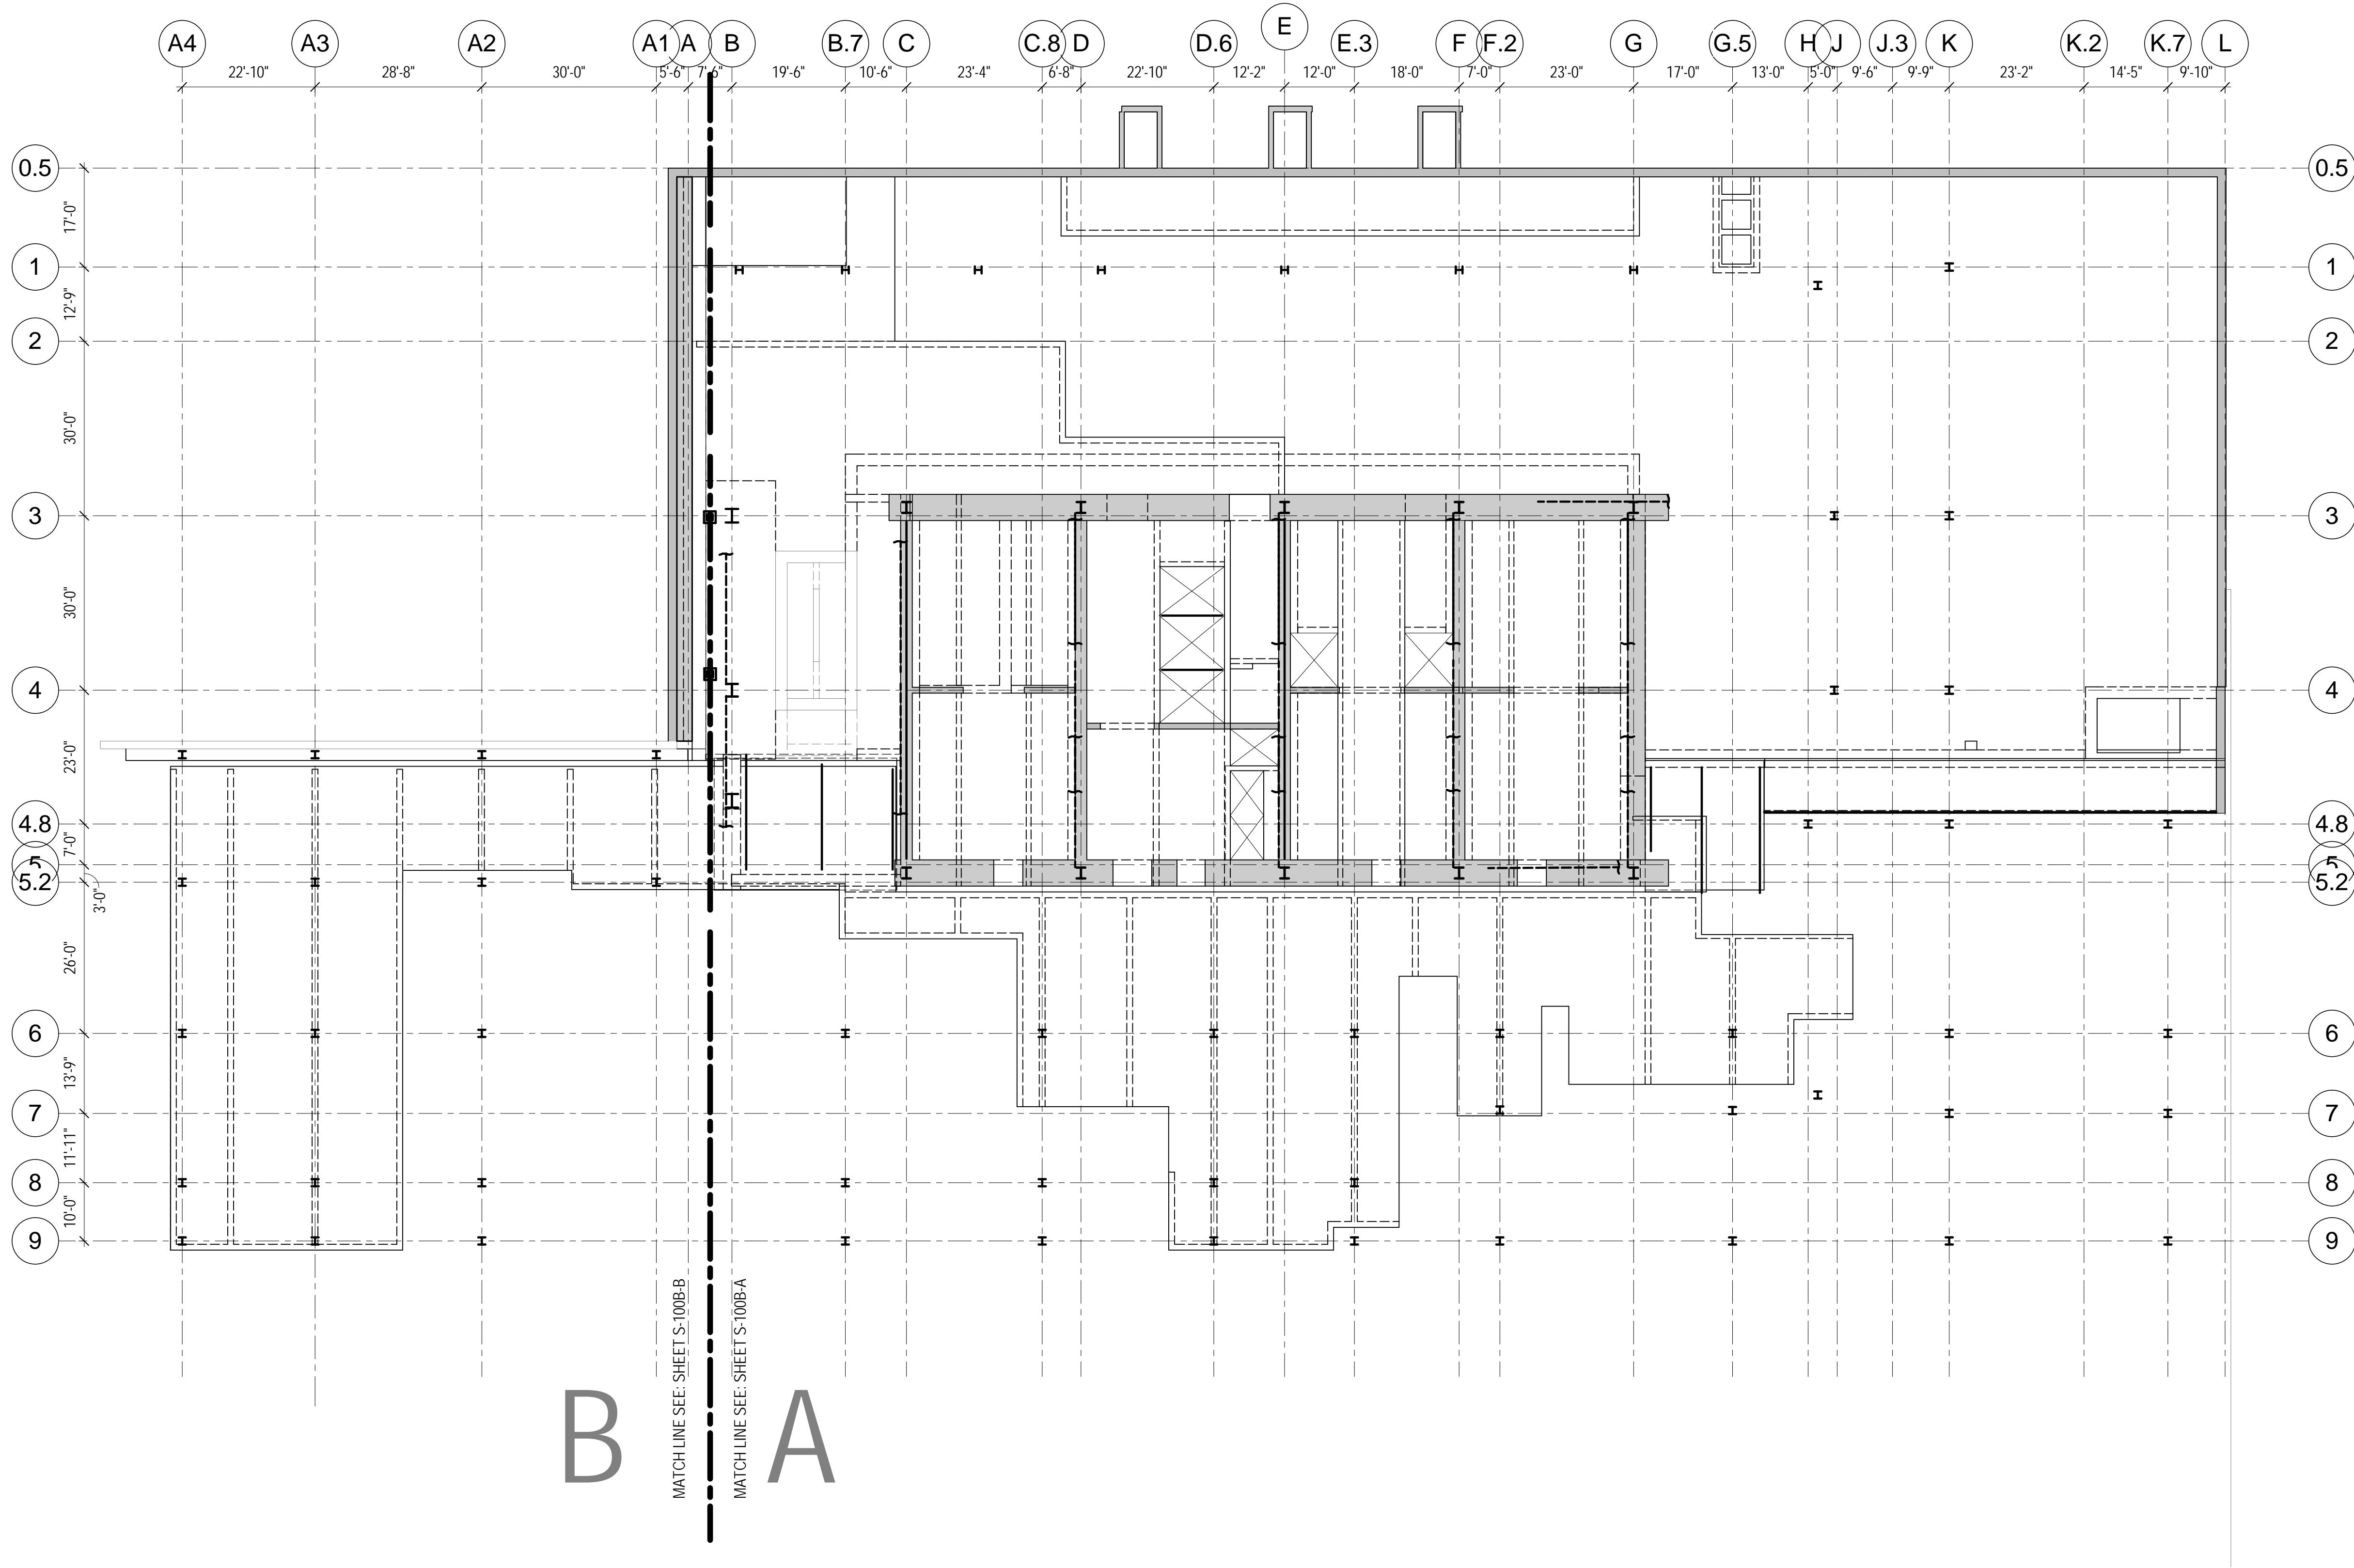

1 OVERALL LEVEL B PLAN
1/16" = 1'-0"



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Vertical Transportation
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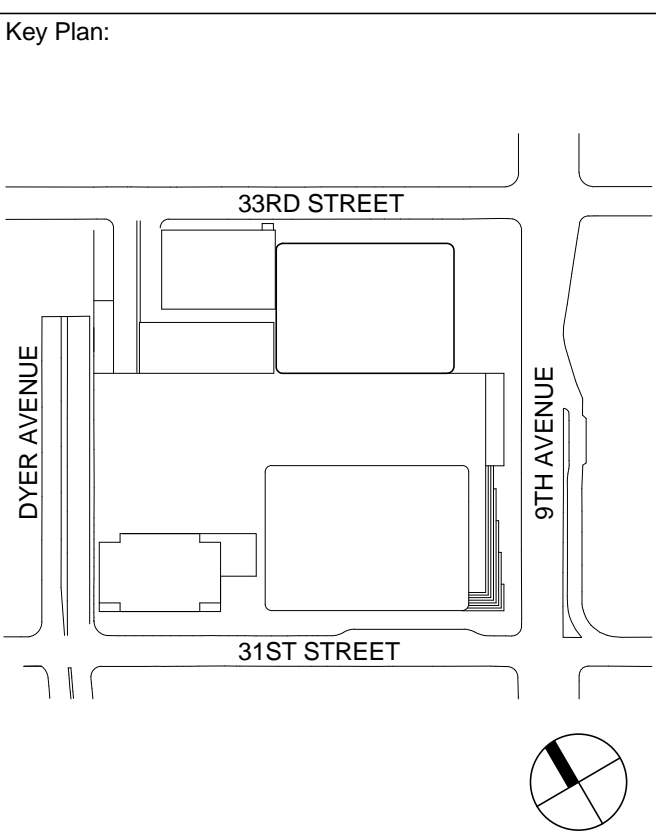
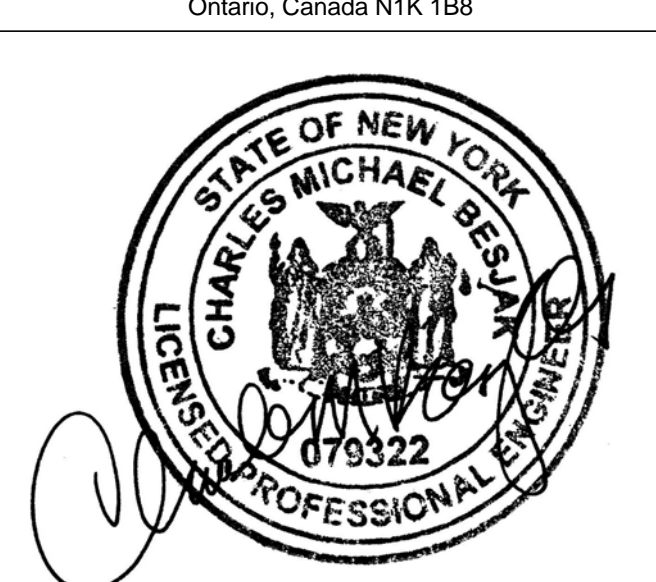
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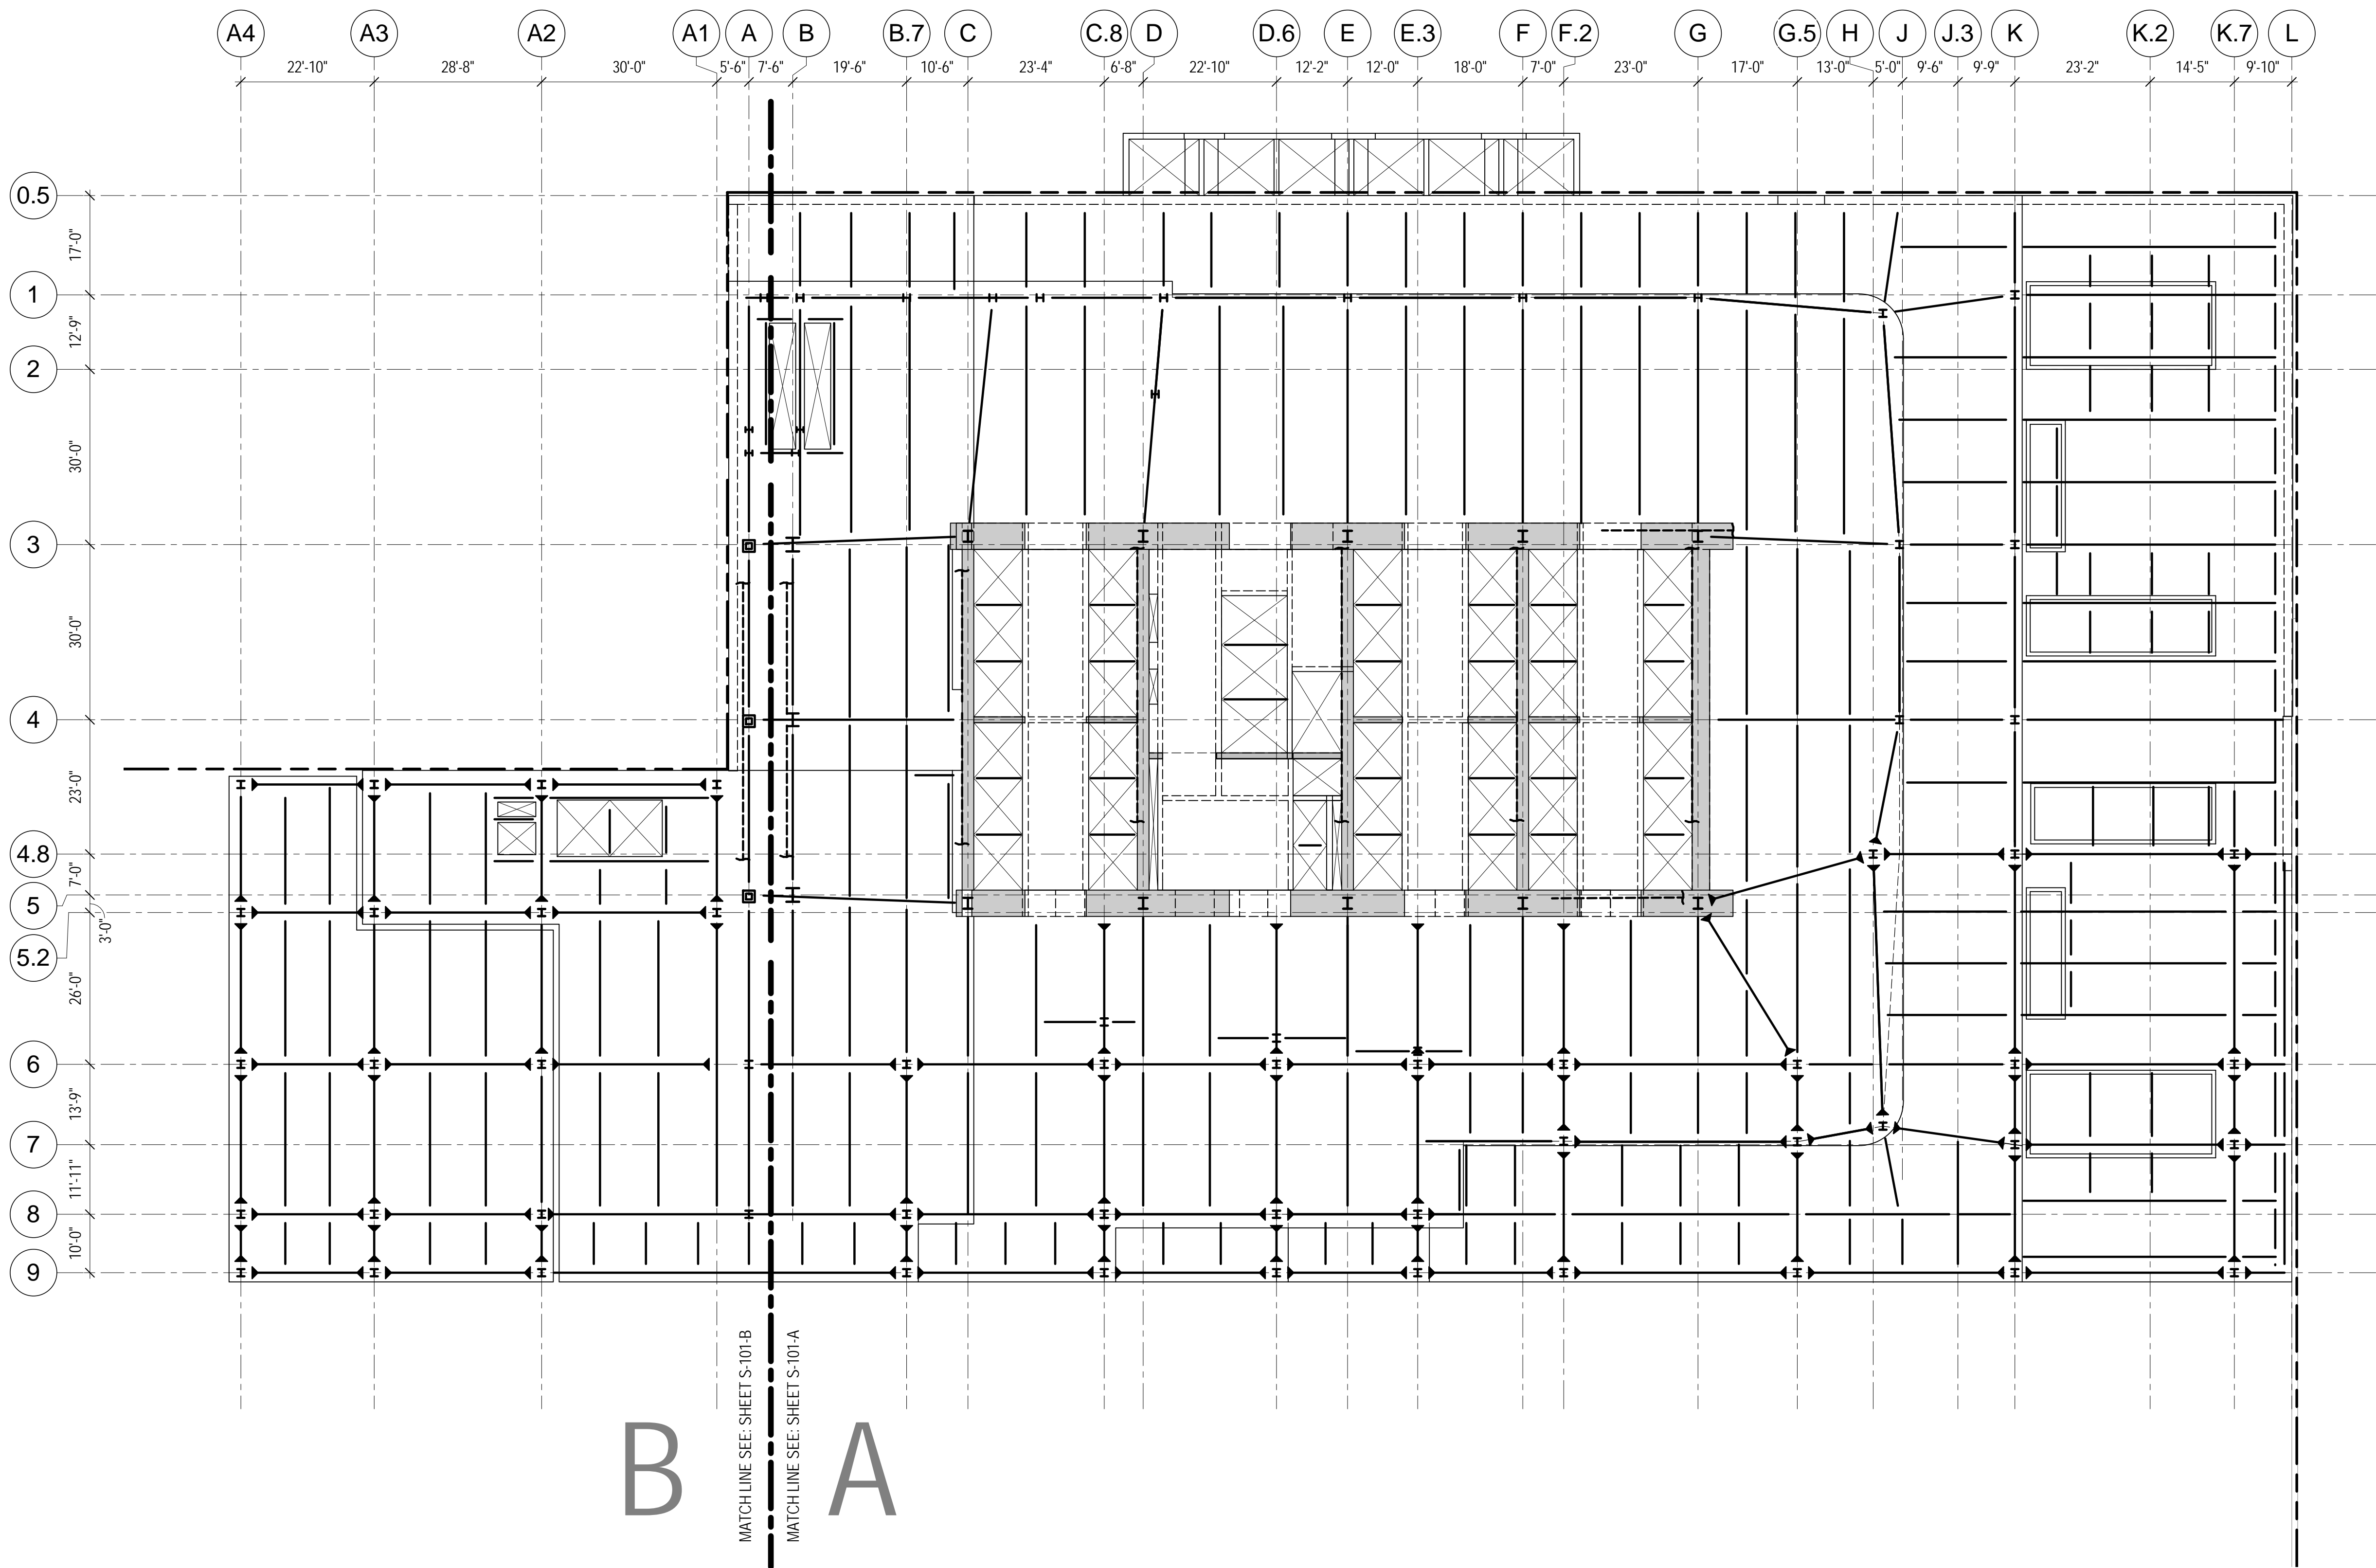
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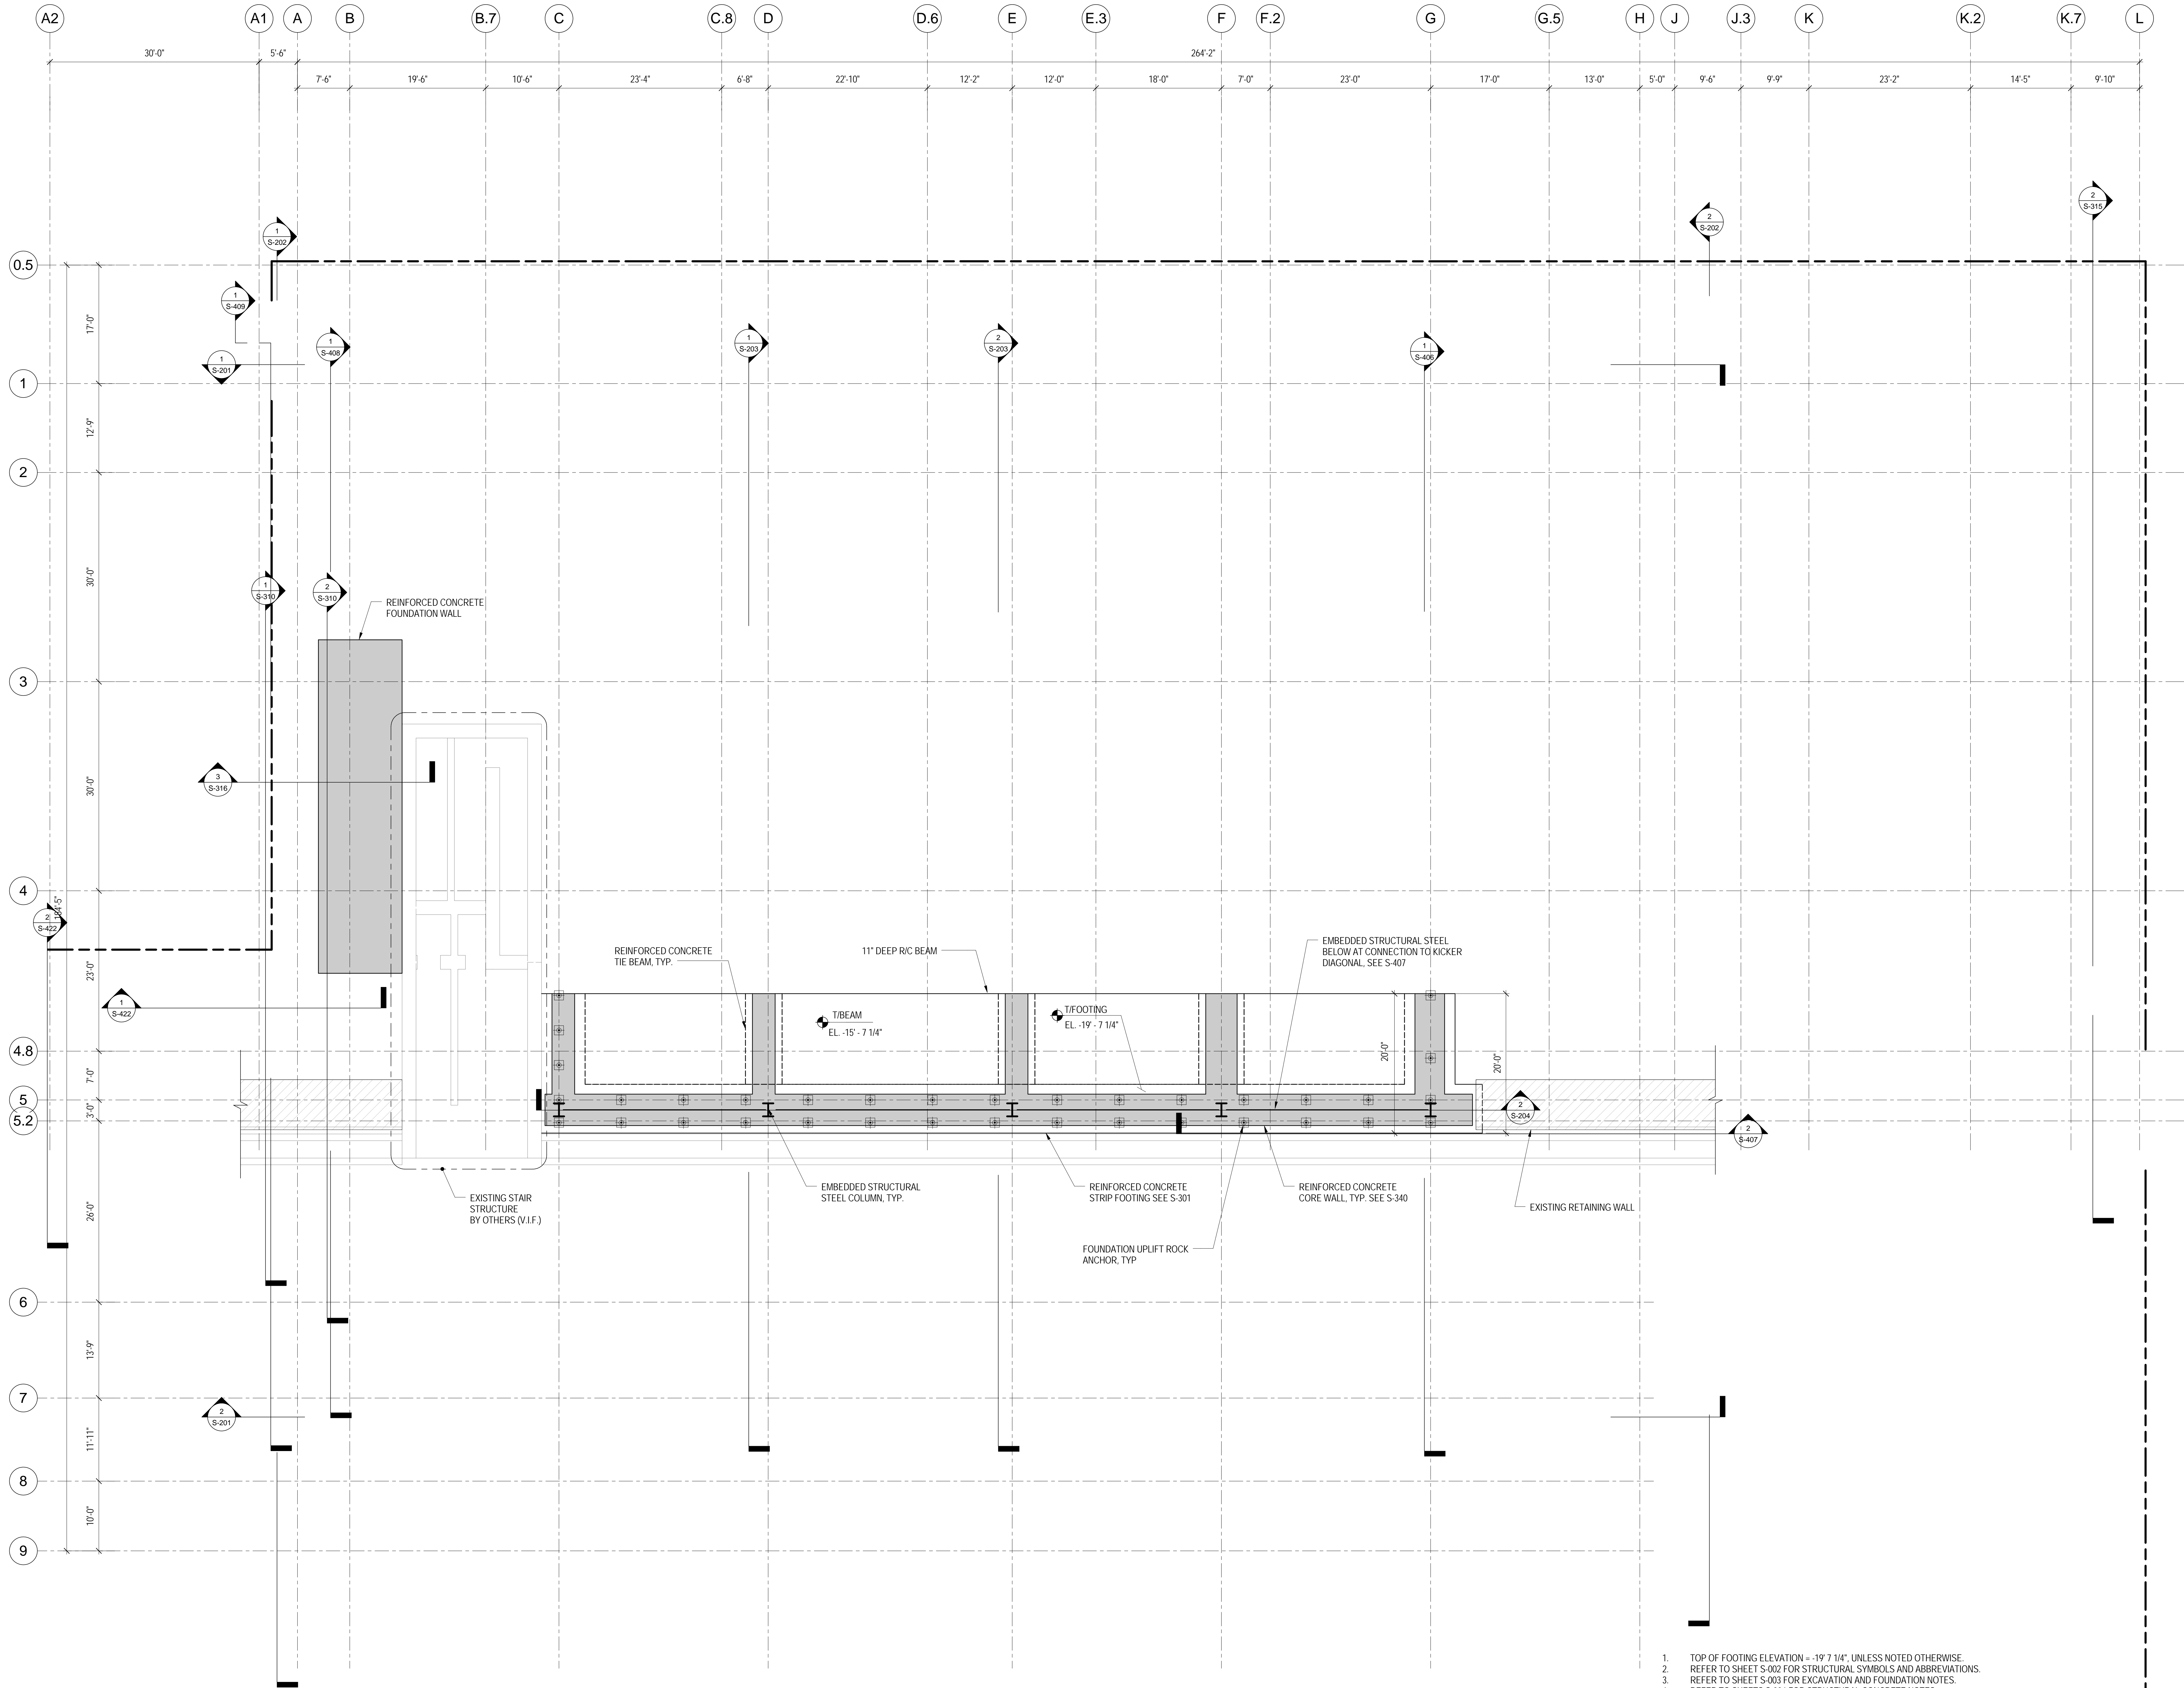
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OVERALL
GROUND FLOOR
PLAN

Project No.: 211157
Date: 20 JUN 2014
Scale: 1/16" = 1'-0"
File No.: S-051
B-SCAN Sheet No.: S-051.00
Sheet No.: S-051
Page No.: 9 of 90



1 OVERALL GROUND FLOOR PLAN
1/16" = 1'-0"



1 FOUNDATION LOWER PLAN (TRACK LEVEL)
1/8" = 1'-0"

1. TOP OF FOOTING ELEVATION = -19' 7 1/4", UNLESS NOTED OTHERWISE.
2. REFER TO SHEET S-002 FOR STRUCTURAL SYMBOLS AND ABBREVIATIONS.
3. REFER TO SHEET S-003 FOR EXCAVATION AND FOUNDATION NOTES.
4. REFER TO SHEET S-004 FOR STRUCTURAL CONCRETE NOTES.
5. REFER TO SHEETS S-005 FOR STRUCTURAL STEEL AND METAL DECK NOTES.
6. REFER TO SHEETS S-201 THROUGH S-204 FOR OVERALL BUILDING ELEVATIONS AND SECTIONS.
7. REFER TO SHEETS S-301 AND S-302 FOR CORE WALL CONTINUOUS FOOTINGS SECTIONS AND DETAILS.
8. REFER TO SHEET S-305 FOR CAISSON SCHEDULE, SECTIONS AND DETAILS.
9. REFER TO SHEET S-340 FOR REINFORCED CONCRETE CORE WALL SCHEDULE, SECTIONS AND DETAILS.
10. REFER TO SHEET S-341 FOR TYPICAL REINFORCED CONCRETE WALL DETAILS.
11. REFER TO SHEET S-355 FOR LINK BEAM SCHEDULES, SECTIONS AND DETAILS.
12. REFER TO SHEETS S-360 THROUGH S-368 FOR CORE WALL ELEVATIONS.
13. REFER TO SHEETS S-405 TO S-407 FOR EMBEDDED STRUCTURAL STEEL ELEVATIONS, SCHEDULES, SECTIONS AND DETAILS.
14. REFER TO DRAWINGS PREPARED BY ENTUITIVE FOR ADJACENT PLATFORM STRUCTURE.



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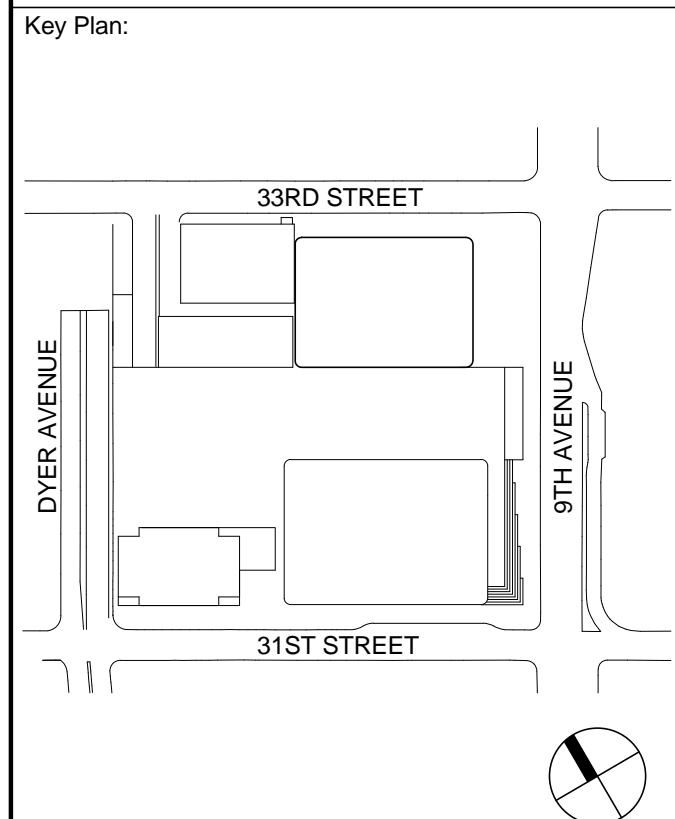
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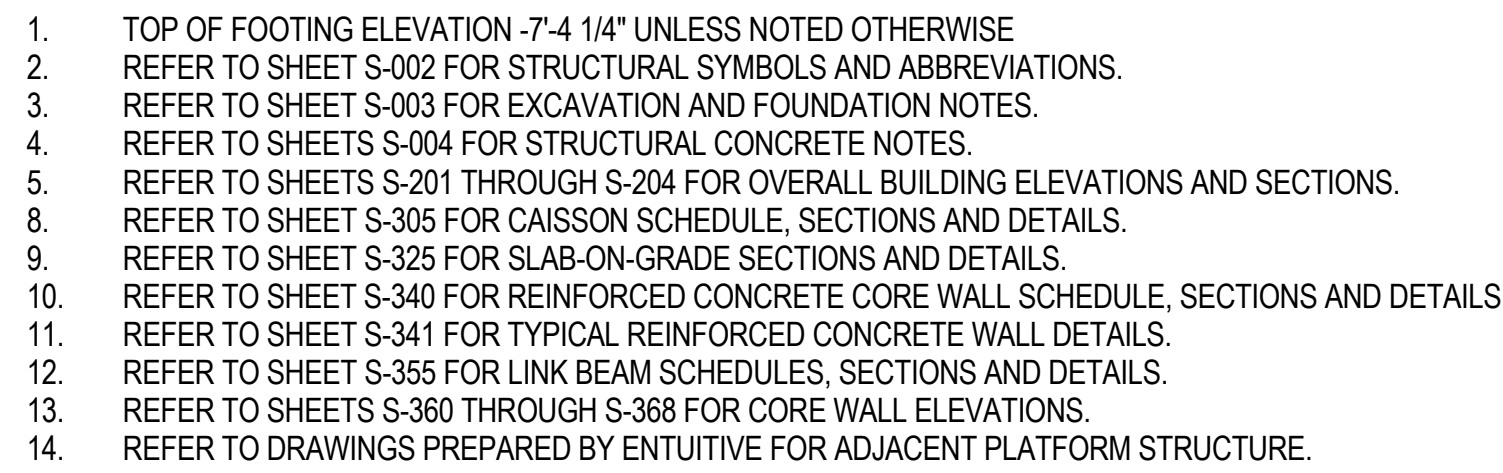
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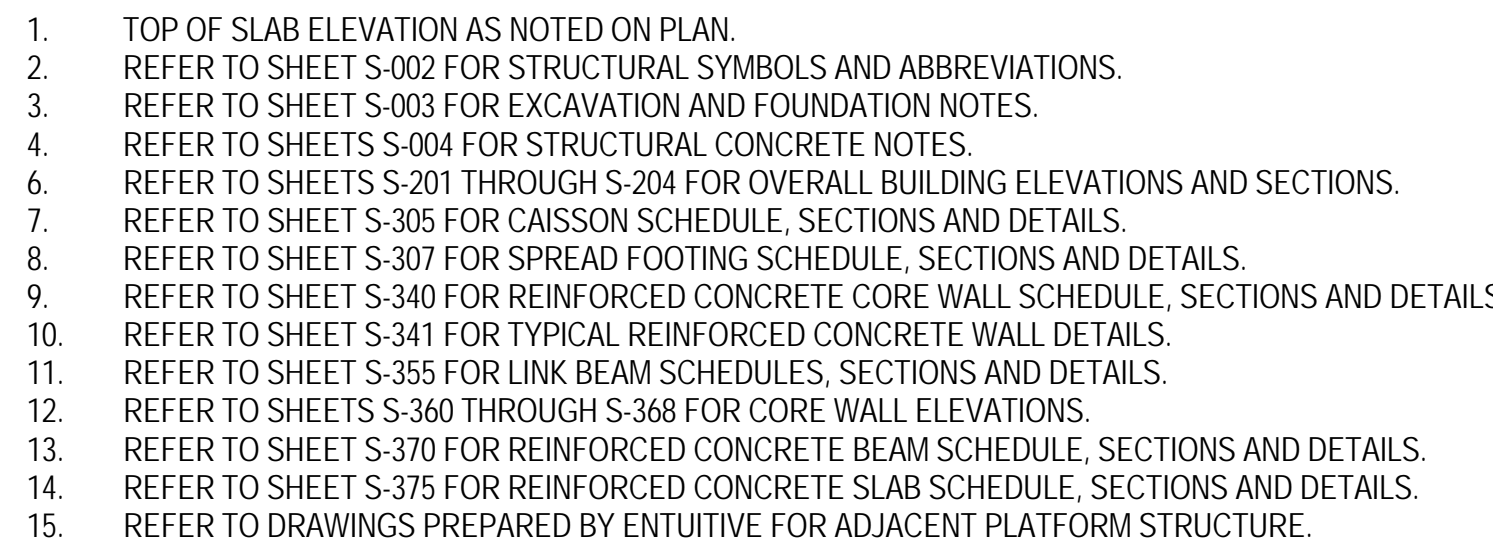
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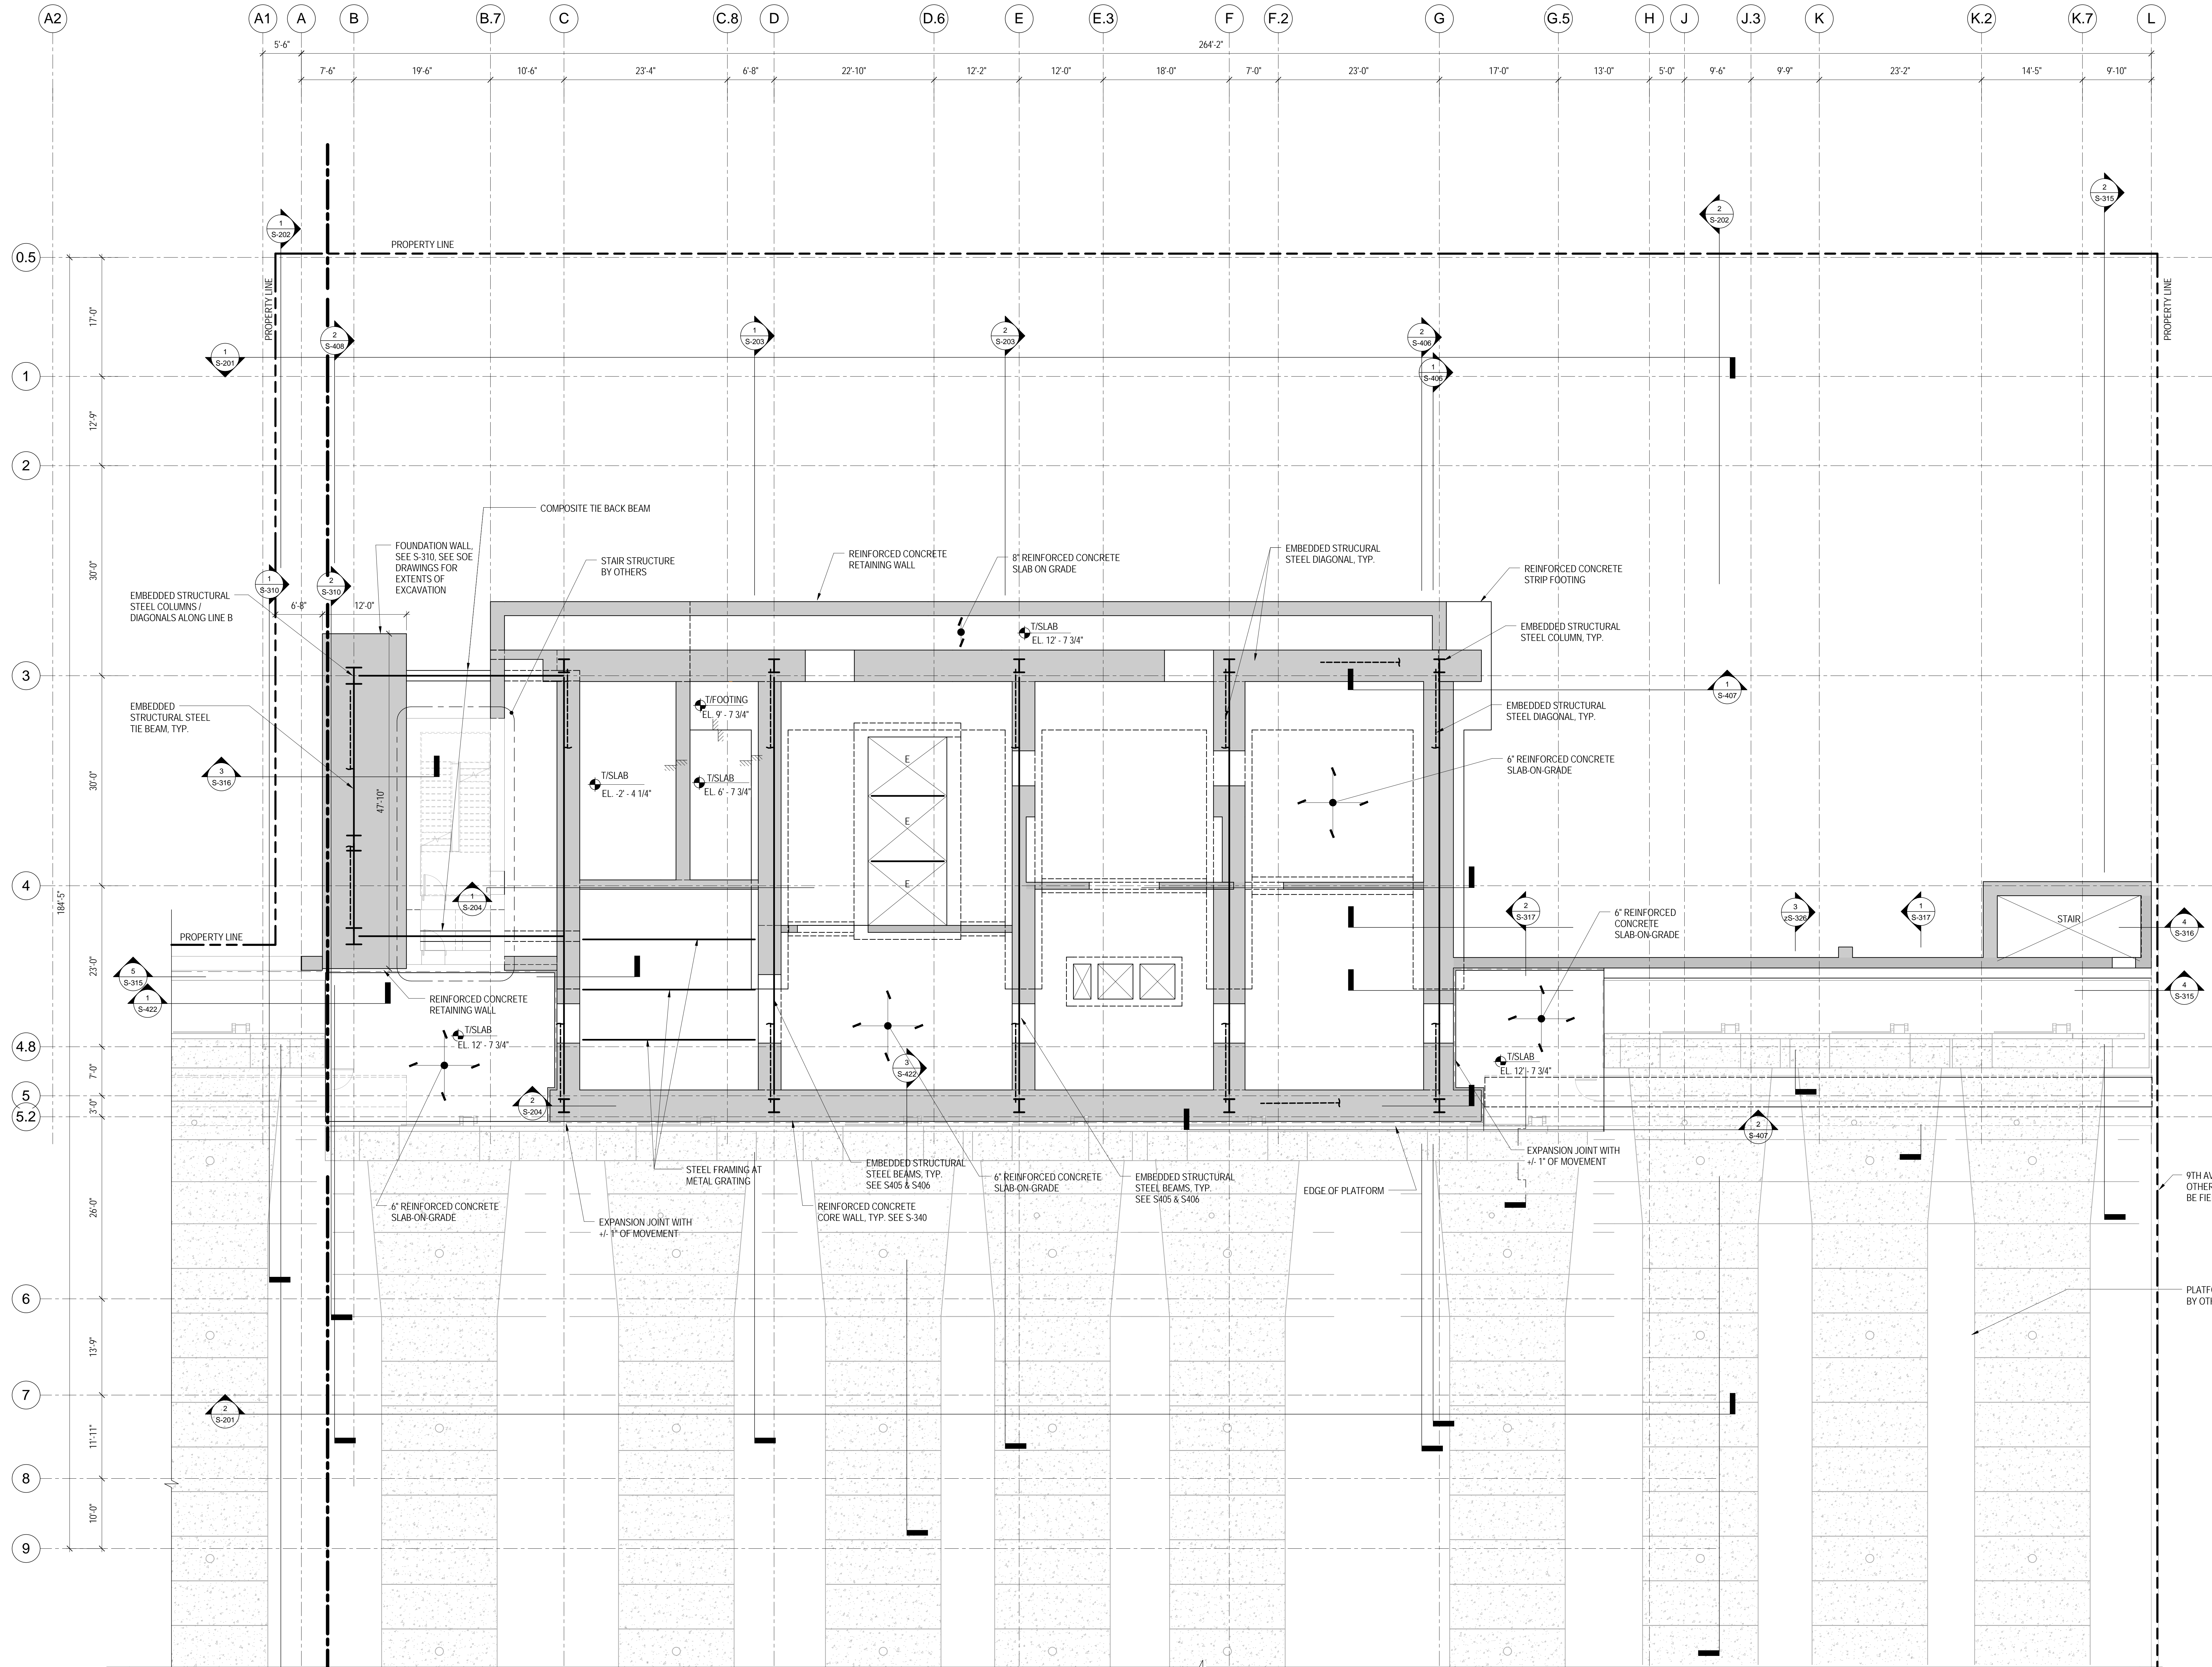
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**FOUNDATION
LOWER PLAN
(TRACK LEVEL)**

Project No.: 211157	B-SCAN Sheet No.: S-092.00
Date: 20 JUN 2014	Sheet No.: S-FND
Scale: 1/8" = 1'-0"	Page No.: 10 of 90
File No.: S-FND	









1 CELLAR B1 FLOOR FRAMING PLAN - PART A

1/8" = 1'-0"

1. TOP OF SLAB ELEVATION = +12'-7 3/4". UNLESS NOTED OTHERWISE.
2. REFER TO SHEET S-002 FOR STRUCTURAL SYMBOLS AND ABBREVIATIONS.
3. REFER TO SHEET S-003 FOR EXCAVATION AND FOUNDATION NOTES.
4. REFER TO SHEETS S-004 FOR STRUCTURAL CONCRETE NOTES.
5. REFER TO SHEETS S-005 FOR STRUCTURAL STEEL AND METAL DECK NOTES.
6. REFER TO SHEETS S-201 THROUGH S-204 FOR OVERALL BUILDING ELEVATIONS AND SECTIONS.
7. REFER TO SHEETS S-201 AND S-202 FOR CORE WALL CONTINUOUS FOOTINGS SECTIONS AND DETAILS.
8. REFER TO SHEET S-315 FOR SPREAD FOOTING SCHEDULE, SECTIONS AND DETAILS.
9. REFER TO SHEET S-316 FOR GRADE BEAM SCHEDULE, SECTIONS AND DETAILS.
10. REFER TO SHEETS S-320 THROUGH S-322 FOR FOUNDATION WALL ELEVATIONS, SECTIONS AND DETAILS.
11. REFER TO SHEET S-330 FOR SLAB-ON-GRADE SECTIONS AND DETAILS.
12. REFER TO SHEET S-330 FOR REINFORCED CONCRETE CORE WALL SCHEDULE, SECTIONS AND DETAILS.
13. REFER TO SHEET S-351 FOR TYPICAL REINFORCED CONCRETE WALL DETAILS.
14. REFER TO SHEET S-355 FOR LINK BEAM SCHEDULES, SECTIONS AND DETAILS.
15. REFER TO SHEETS S-360 THROUGH S-368 FOR CORE WALL ELEVATIONS.
16. REFER TO SHEET S-370 FOR REINFORCED CONCRETE BEAM SCHEDULE, SECTIONS AND DETAILS.
17. REFER TO SHEET S-375 FOR REINFORCED CONCRETE SLAB SCHEDULE, SECTIONS AND DETAILS.
18. REFER TO SHEET S-401 FOR STRUCTURAL STEEL COLUMN SCHEDULE, SECTIONS AND DETAILS.
19. REFER TO DRAWINGS PREPARED BY ENTUITIVE FOR ADJACENT PLATFORM STRUCTURE.

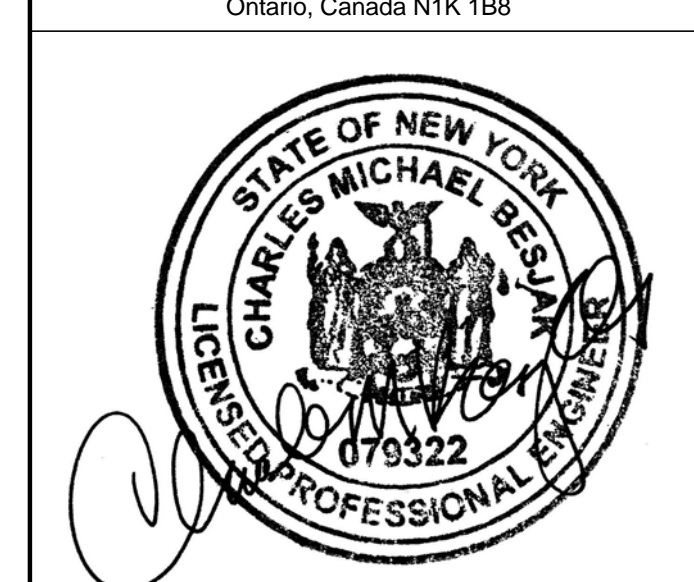

Key Plan:

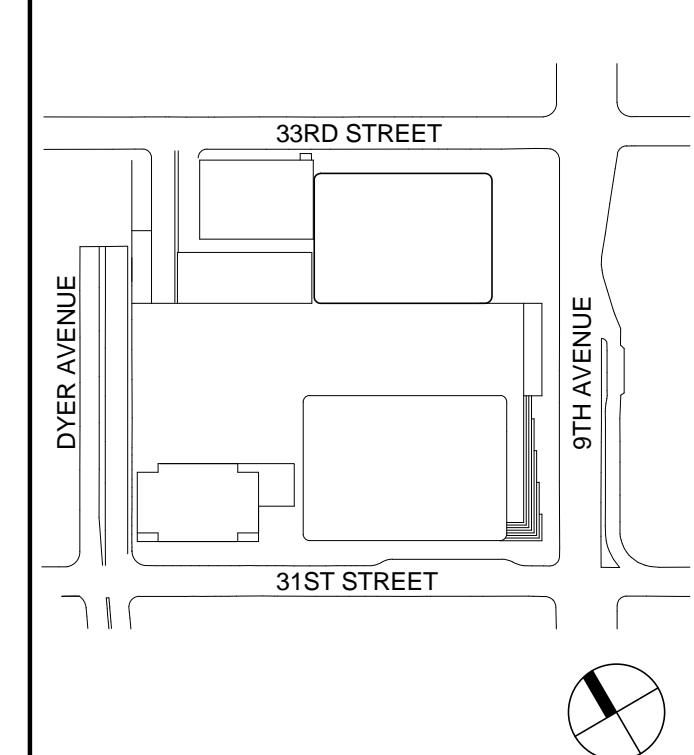

Seal & Signature:

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Project No.: 211157
Date: 20 JUN 2014
Scale: 1/8" = 1'-0"

Sheet Name: CELLAR B1 FLOOR FRAMING PLAN - PART A

Project No.: 211157
Date: 20 JUN 2014
Scale: 1/8" = 1'-0"


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
Page No.: 13 of 90

1 CELLAR B1 FLOOR FRAMING PLAN - PART B

1/8" = 1'-0"

1. TOP OF SLAB ELEVATION = +12'-7 3/4"; UNLESS NOTED OTHERWISE.
2. REFER TO SHEET S-202 FOR STRUCTURAL SYMBOLS AND ABBREVIATIONS.
3. REFER TO SHEET S-203 FOR EXCAVATION AND FOUNDATION NOTES.
4. REFER TO SHEETS S-204 FOR STRUCTURAL CONCRETE NOTES.
5. REFER TO SHEETS S-205 FOR STRUCTURAL STEEL AND METAL DECK NOTES.
6. REFER TO SHEETS S-201 THROUGH S-204 FOR OVERALL BUILDING ELEVATIONS AND SECTIONS.
7. REFER TO SHEETS S-301 AND S-302 FOR CORE WALL CONTINUOUS FOOTINGS SECTIONS AND DETAILS.
8. REFER TO SHEET S-315 FOR SPREAD FOOTING SCHEDULE, SECTIONS AND DETAILS.
9. REFER TO SHEET S-316 FOR GRADE BEAM SCHEDULE, SECTIONS AND DETAILS.
10. REFER TO SHEETS S-320 THROUGH S-322 FOR FOUNDATION WALL ELEVATIONS, SECTIONS AND DETAILS.
11. REFER TO SHEET S-330 FOR SLAB-ON-GRADE SECTIONS AND DETAILS.
12. REFER TO SHEET S-350 FOR REINFORCED CONCRETE CORE WALL SCHEDULE, SECTIONS AND DETAILS.
13. REFER TO SHEET S-351 FOR TYPICAL REINFORCED CONCRETE WALL DETAILS.
14. REFER TO SHEET S-355 FOR LINK BEAM SCHEDULES, SECTIONS AND DETAILS.
15. REFER TO SHEETS S-360 THROUGH S-368 FOR CORE WALL ELEVATIONS.
16. REFER TO SHEET S-370 FOR REINFORCED CONCRETE BEAM SCHEDULE, SECTIONS AND DETAILS.
17. REFER TO SHEET S-375 FOR REINFORCED CONCRETE SLAB SCHEDULE, SECTIONS AND DETAILS.
18. REFER TO SHEET S-401 FOR STRUCTURAL STEEL COLUMN SCHEDULE, SECTIONS AND DETAILS.
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Brookfield
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
Acoustical Consultant
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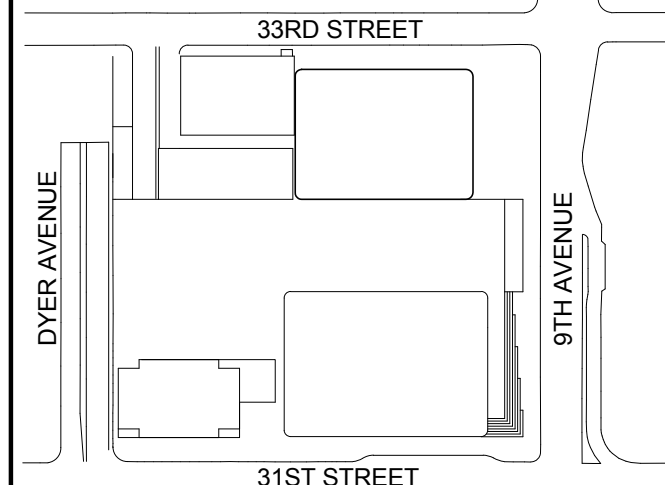
Code Consultant
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Key Plan:

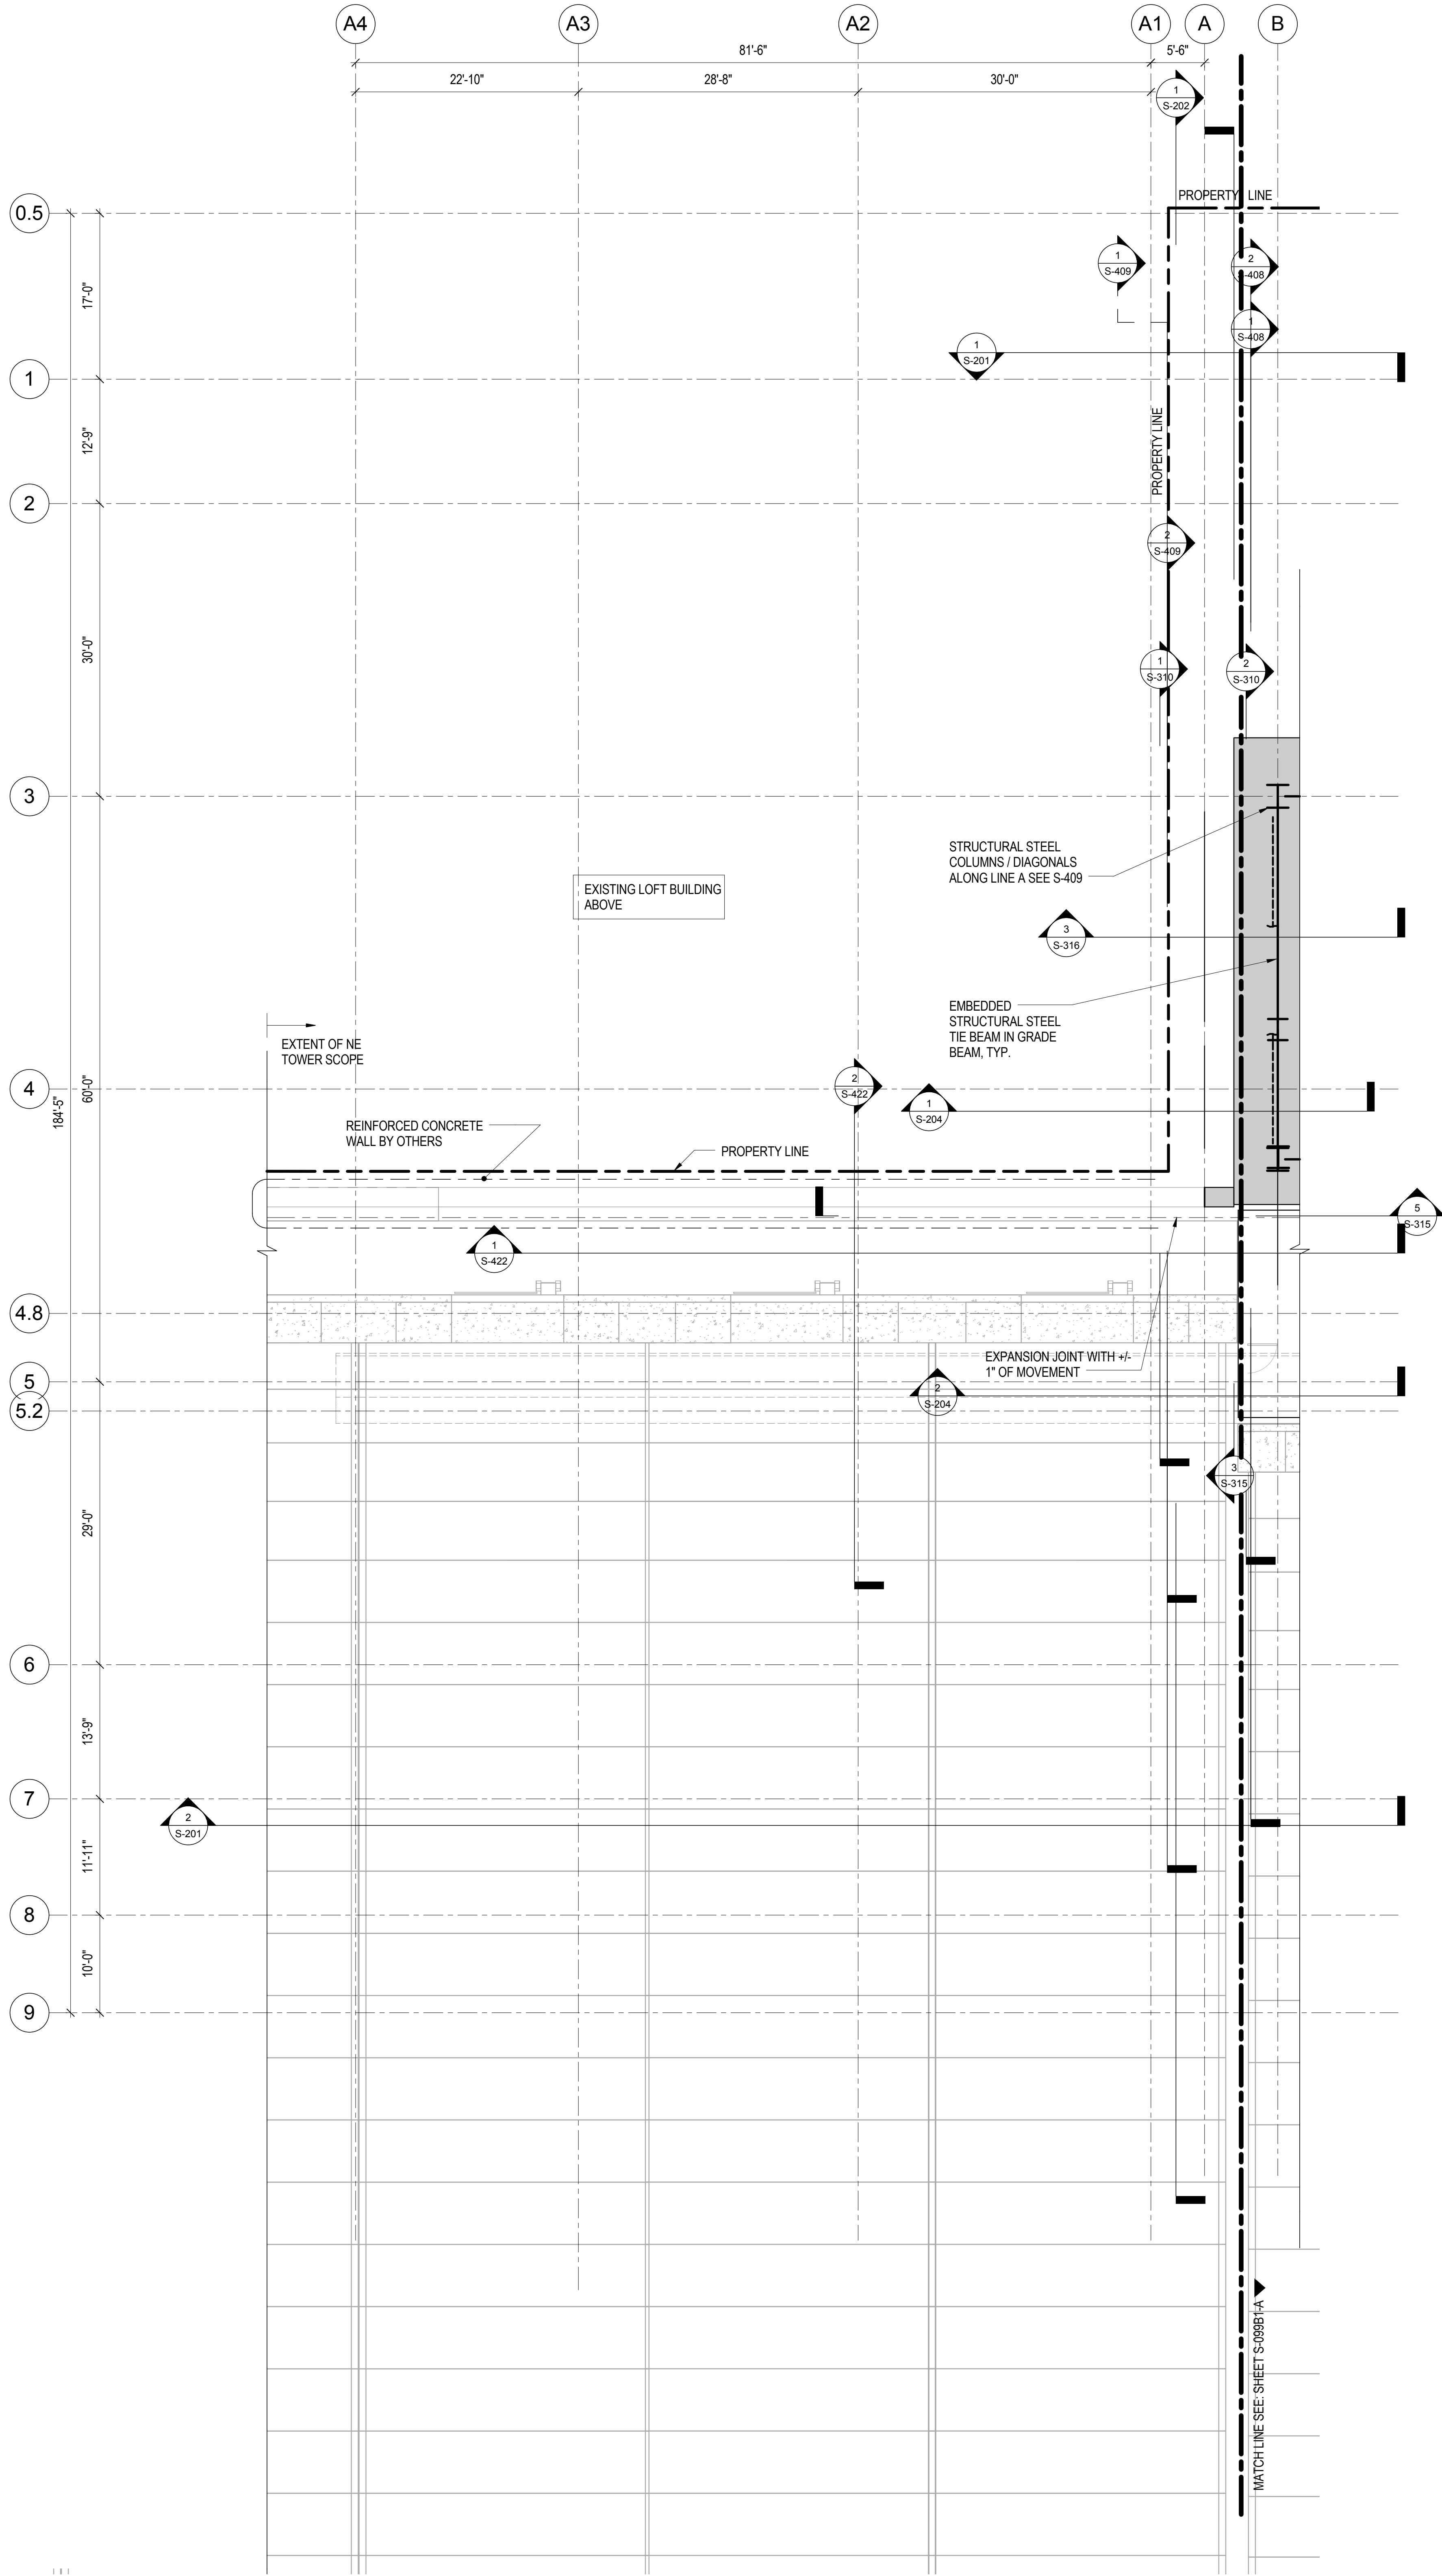

Seal & Signature:

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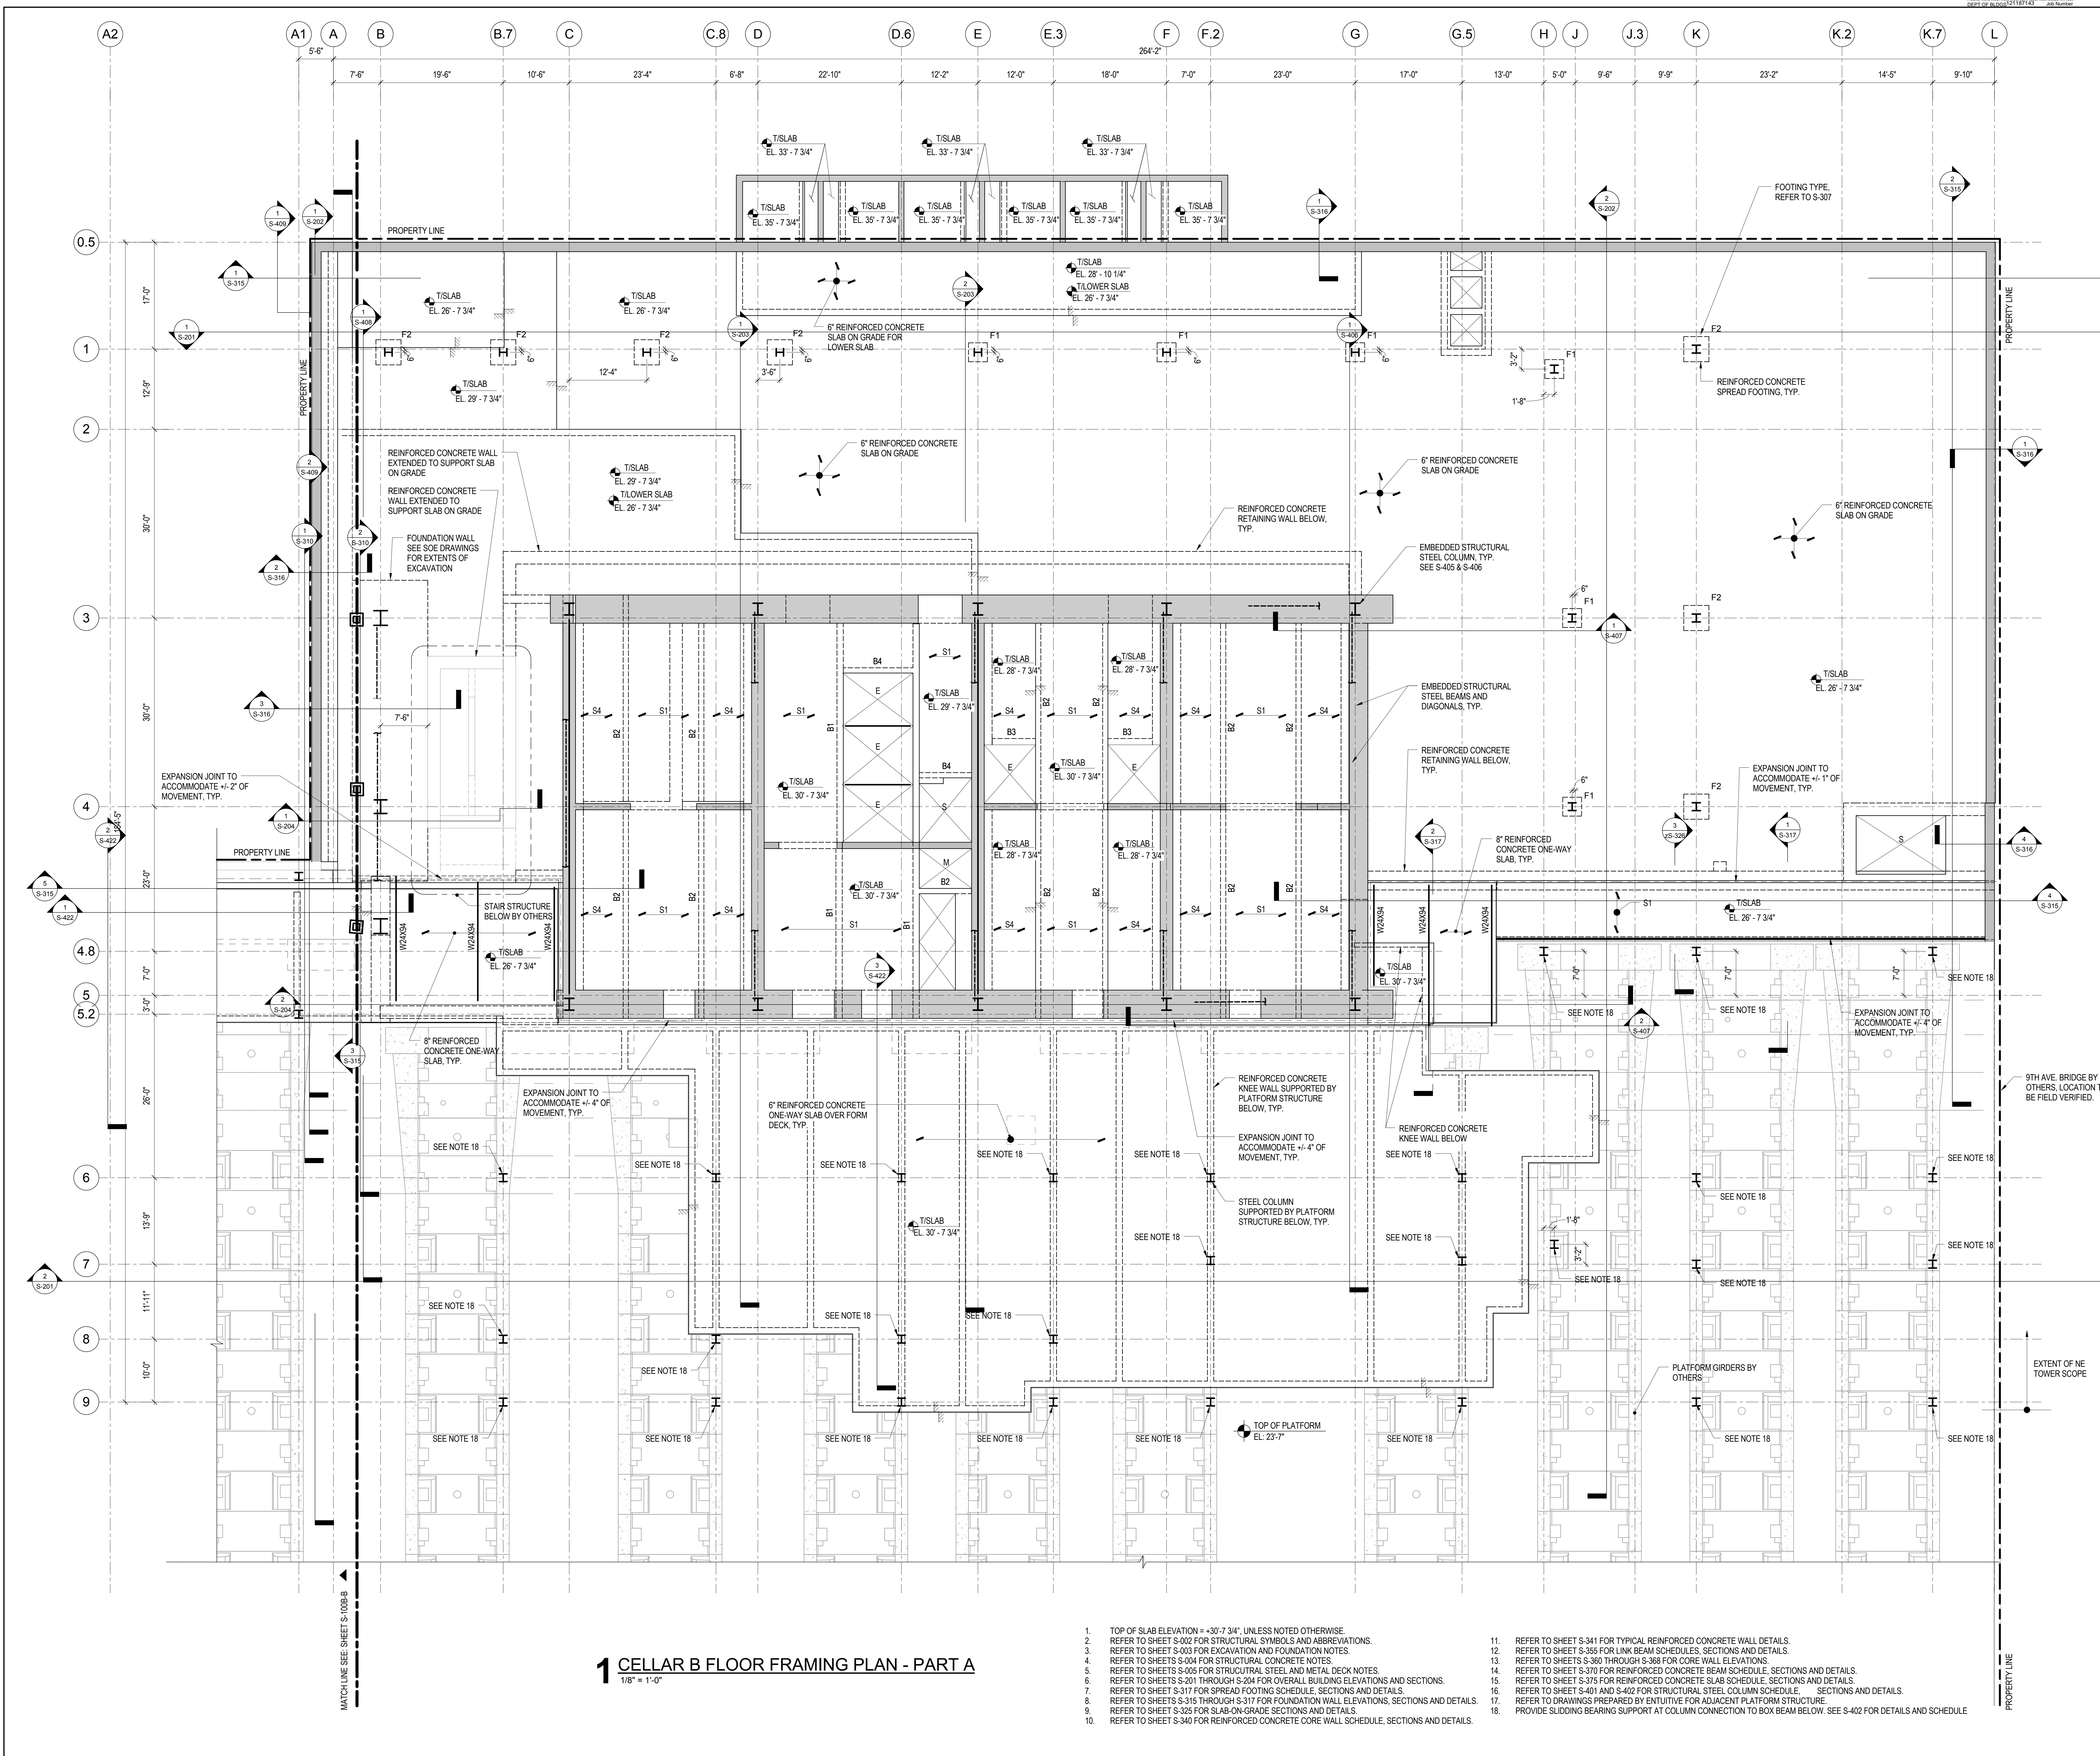
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1	18 MAR 2012	ISSUED FOR RECONCILIATION

Sheet Name:
**CELLAR B1
FLOOR FRAMING
PLAN - PART B**

Project No.:	B-SCAN Sheet No.:
211157	S-096.00

Date:	Sheet No.:
20 JUN 2014	S-099B1-B

Scale:	Page No.:
1/8" = 1'-0"	14 of 90



1 CELLAR B FLOOR FRAMING PLAN - PART A
1/8" = 1'-0"

1. TOP OF SLAB ELEVATION = +30'-7 3/4" UNLESS NOTED OTHERWISE.
2. REFER TO SHEET S-002 FOR STRUCTURAL SYMBOLS AND ABBREVIATIONS.
3. REFER TO SHEET S-003 FOR EXCAVATION AND FOUNDATION NOTES.
4. REFER TO SHEETS S-004 FOR STRUCTURAL CONCRETE NOTES.
5. REFER TO SHEETS S-005 FOR STRUCTURAL STEEL AND METAL DECK NOTES.
6. REFER TO SHEETS S-201 THROUGH S-204 FOR OVERALL BUILDING ELEVATIONS AND SECTIONS.
7. REFER TO SHEET S-317 FOR SPREAD FOOTING SCHEDULE, SECTIONS AND DETAILS.
8. REFER TO SHEETS S-315 THROUGH S-317 FOR FOUNDATION WALL ELEVATIONS, SECTIONS AND DETAILS.
9. REFER TO SHEET S-325 FOR SLAB-ON-GRADE SECTIONS AND DETAILS.
10. REFER TO SHEET S-340 FOR REINFORCED CONCRETE CORE WALL SCHEDULE, SECTIONS AND DETAILS.
11. REFER TO SHEET S-341 FOR TYPICAL REINFORCED CONCRETE WALL DETAILS.
12. REFER TO SHEET S-355 FOR LINK BEAM SCHEDULES, SECTIONS AND DETAILS.
13. REFER TO SHEETS S-360 THROUGH S-368 FOR CORE WALL ELEVATIONS.
14. REFER TO SHEET S-370 FOR REINFORCED CONCRETE BEAM SCHEDULE, SECTIONS AND DETAILS.
15. REFER TO SHEET S-375 FOR REINFORCED CONCRETE SLAB SCHEDULE, SECTIONS AND DETAILS.
16. REFER TO SHEET S-401 AND S-402 FOR STRUCTURAL STEEL COLUMN SCHEDULE, SECTIONS AND DETAILS.
17. REFER TO SHEETS S-315 THROUGH S-317 FOR FOUNDATION WALL ELEVATIONS, SECTIONS AND DETAILS.
18. PROVIDE SLIDING BEARING SUPPORT AT COLUMN CONNECTION TO BOX BEAM BELOW. SEE S-402 FOR DETAILS AND SCHEDULE.

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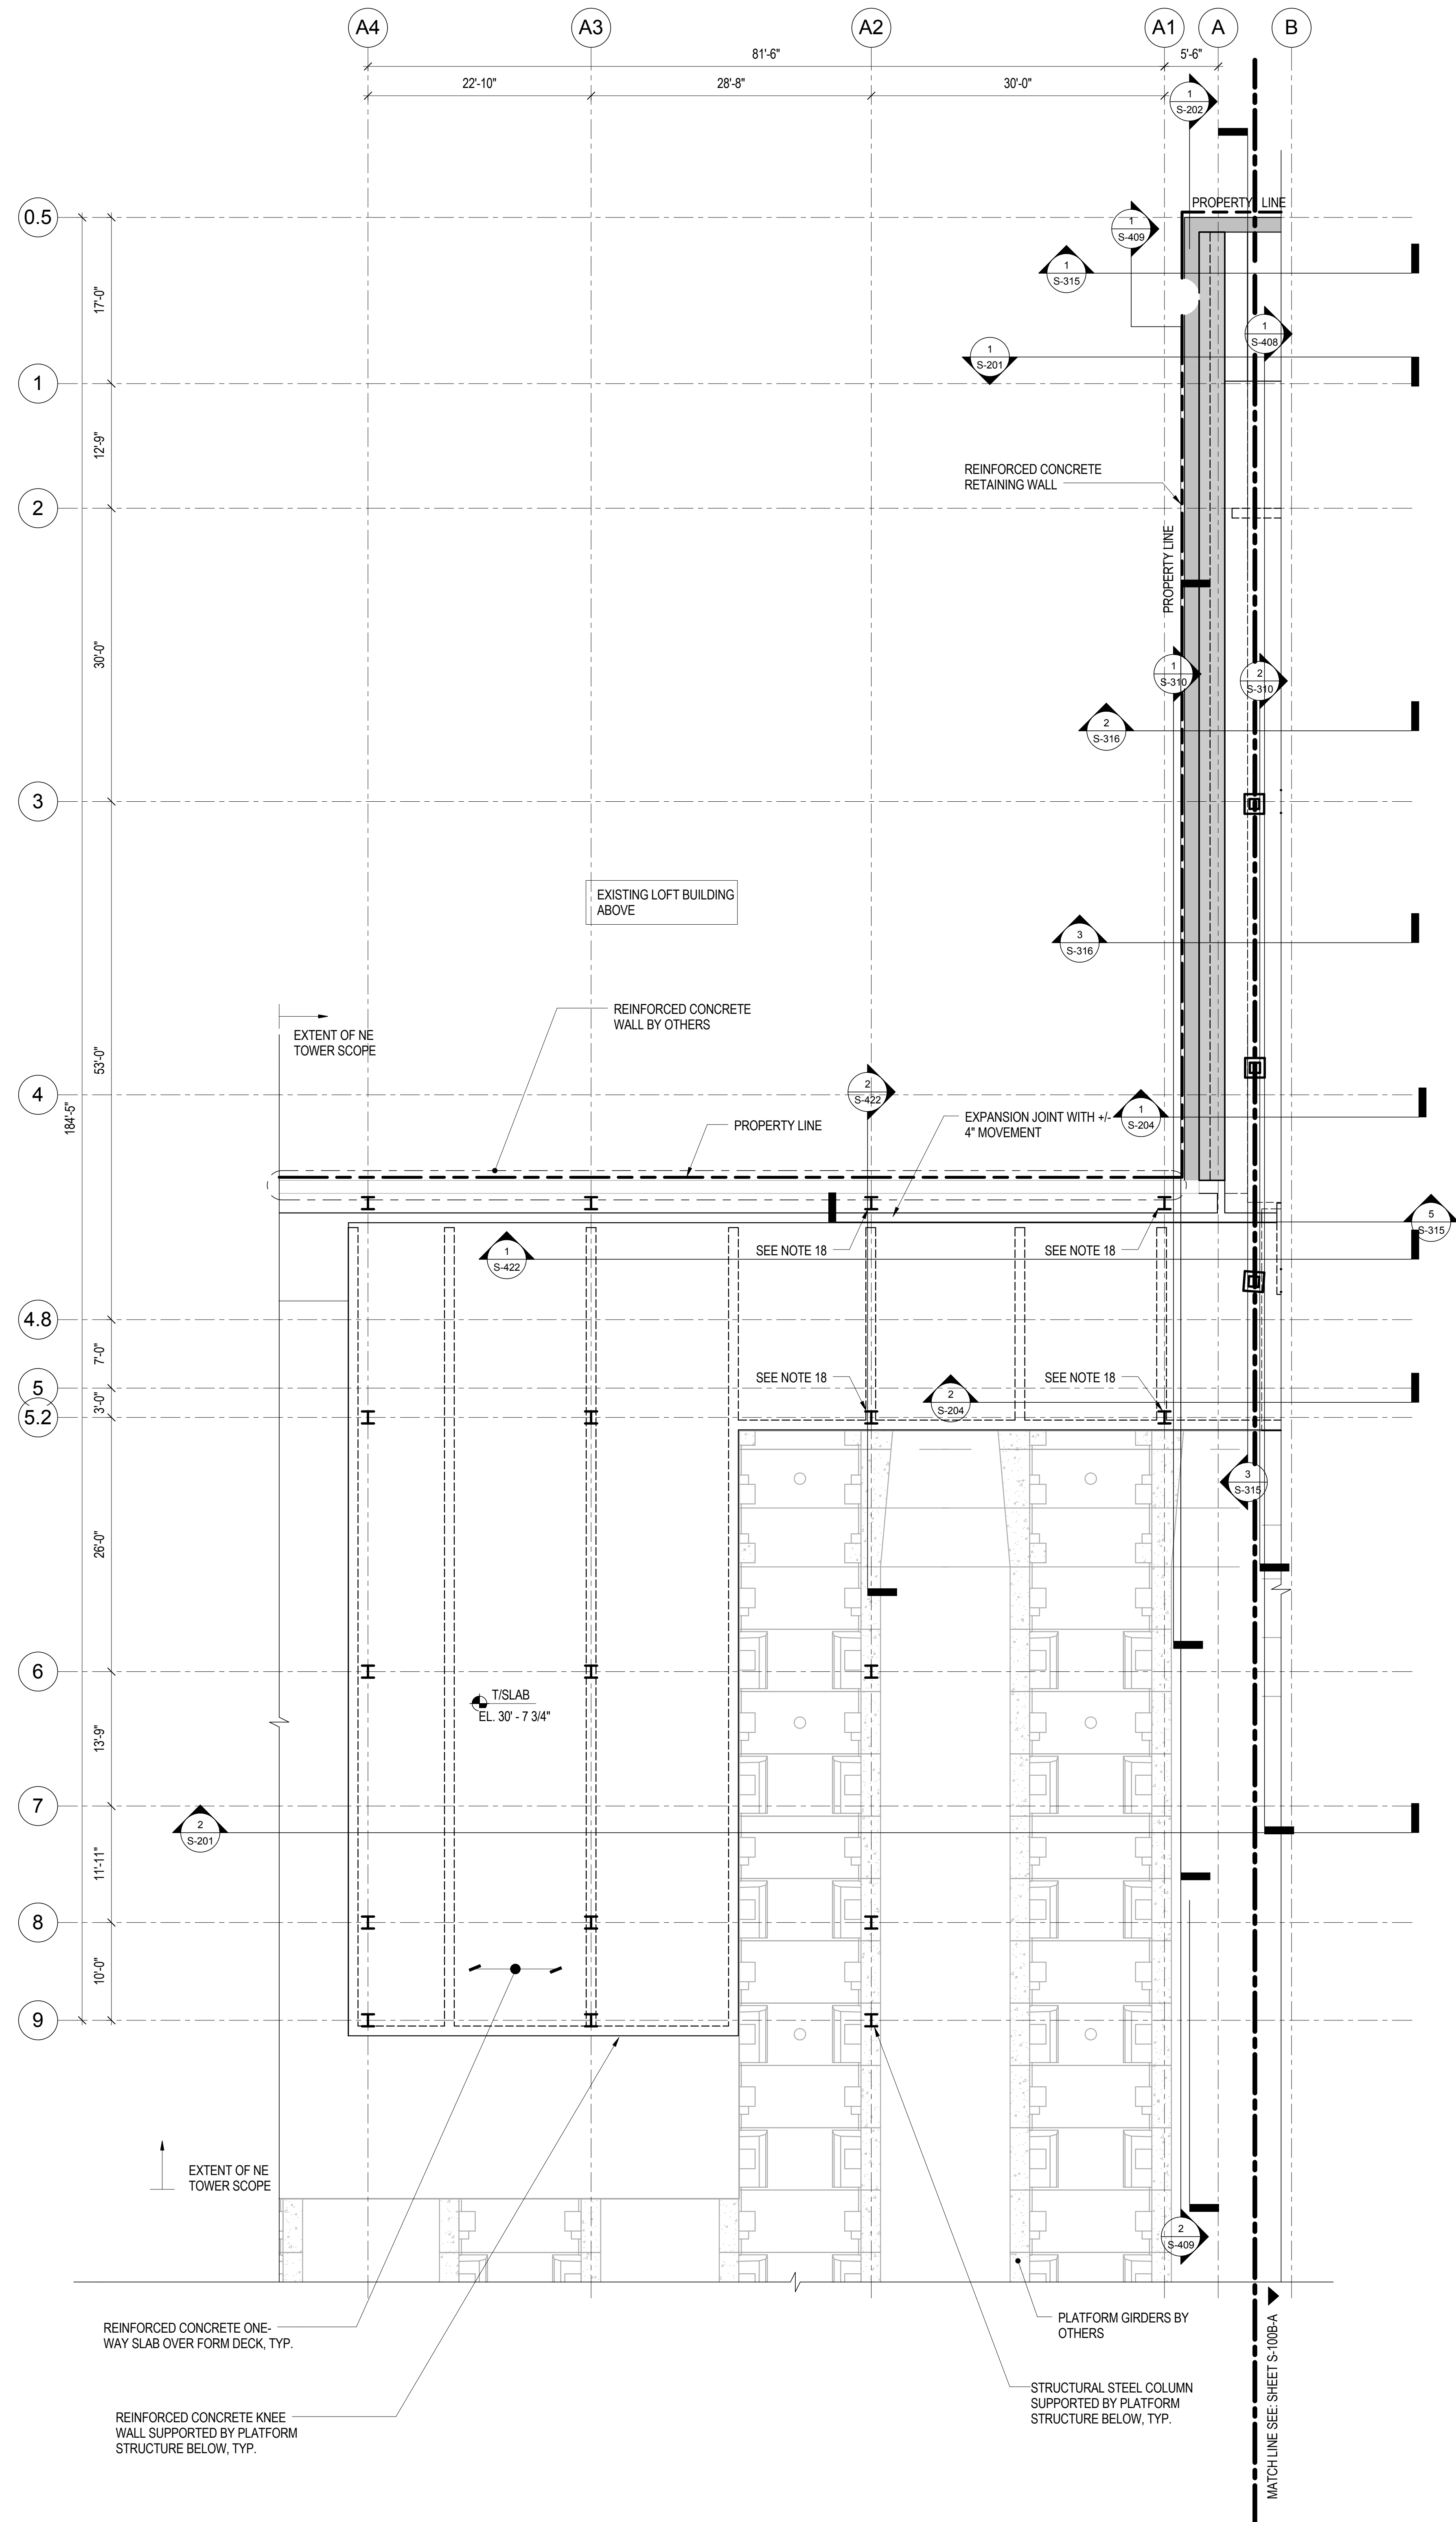
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
B-SCAN Sheet No.:
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Sheet No.:
S-100B-A
Page No.: 15 of 90



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1/8" = 1'-0"



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Field Operations
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Security Consultant
Ducibella, Ventor & Santore
250 State Street #F1, North Haven, CT 06473

Blast Consultant
Weidinger Associates, Inc.
40 Wall Street, New York, NY 10005


Acoustical Consultant
Cerami & Associates
404 Fifth Avenue #8, New York, NY 10016

Vibration Consultant
Wilson, Uhrig & Associates, Inc.
65 Broadway, Suite 401, New York, NY 10006


Code Consultant
Code Consultants Professional Engineers PC
215 West 40th Street, 15th Floor, New York, NY 10018

Facade Maintenance Consultant
Entek Engineering LLC
166 Ames Street, Hackensack, NJ 07601

Wind Tunnel Consultant
Rowan Williams Davies & Irwin Inc.
650 Woodlawn Road West, Guelph
Ontario, Canada N1K 1B8



Key Plan:

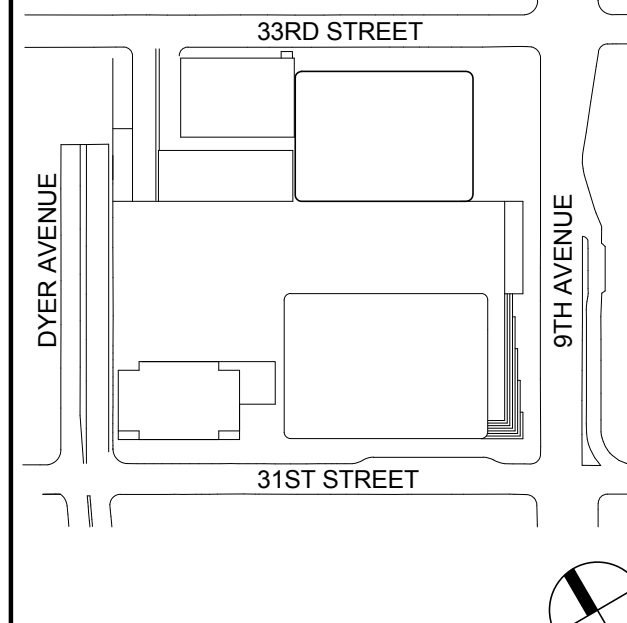

Seal & Signature:

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NOT FOR CONSTRUCTION

No.	Date	Description
6	20 JUN 2014	ISSUED FOR FOUNDATION BID
5	20 JUN 2014	ISSUED FOR FOUNDATION PERMIT
4	20 DEC 2013	ISSUED FOR FOUNDATION PERMIT
3	15 SEP 2013	ISSUED FOR 20% PROGRESS PRICING
2	12 JUL 2013	ISSUED FOR 60% DESIGN DEVELOPMENT
1	18 MAR 2012	ISSUED FOR RECONCILIATION

Sheet Name:
**CELLAR B FLOOR
FRAMING PLAN -
PART B**

Project No.:	B-SCAN Sheet No.:
211157	S-098.00
Date: 20 JUN 2014	Sheet No.:
Scale: 1/8" = 1'-0"	S-100B-B
File No.:	Page No.:
S-100B-B	16 of 90



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375 Ninth Avenue, New York, NY 10001
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Skidmore, Owings & Merrill LLP
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Vertical Transportation
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Geo-Technical Engineering
Mueser Rutledge Consulting Engineers
14 Penn Plaza, 22nd W. 34th Street #610,
New York, NY 10012

Landscape Consultant
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Security Consultant
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250 State Street #1, North Haven, CT 06473

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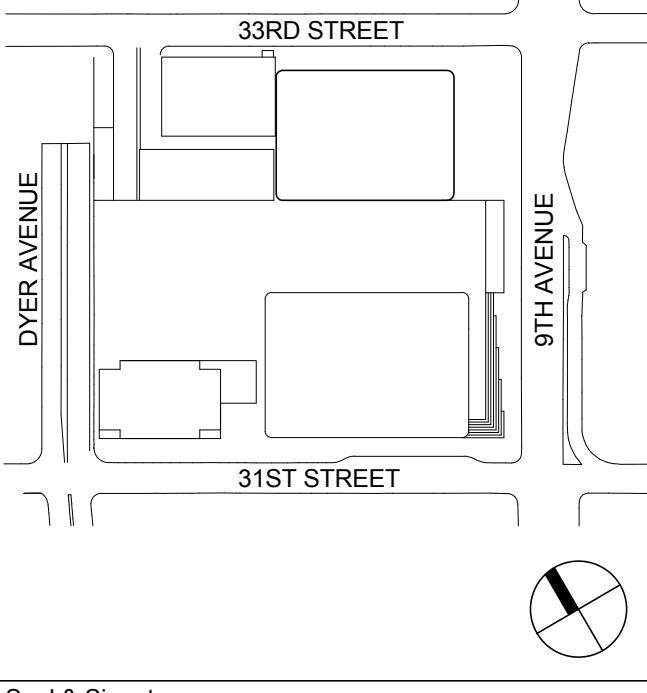
Code Consultant
Code Consultants Professional Engineers PC
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Facade Maintenance Consultant
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166 Ames Street, Hackensack, NJ 07601

Wind Tunnel Consultant
Rowan Williams Davies & Irwin Inc.
680 Woodlawn Road West, Guelph
Ontario, Canada N1K 1B8



Key Plan:
33RD STREET
DYER AVENUE
31ST STREET
9TH AVENUE




Seal & Signature

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6	20 JUN 2014	ISSUED FOR FOUNDATION BID
5	20 JUN 2014	ISSUED FOR FOUNDATION PERMIT
4	20 DEC 2013	ISSUED FOR FOUNDATION PERMIT
3	15 NOV 2013	ISSUED FOR 50% PROGRESS PRICING
2	12 JUL 2013	ISSUED FOR 80% DESIGN DEVELOPMENT
1	18 MAR 2012	ISSUED FOR RECONCILIATION

Sheet Name:
**GROUND FLOOR
FRAMING PLAN -
LOBBY - PART A**

Project No.: 211157	B-SCAN Sheet No.: S-100.00
Date: 20 JUN 2014	Sheet No.: S-101-A
Scale: 1/8" = 1'-0"	Page No.: 17 of 90
File No.: S-101-A	

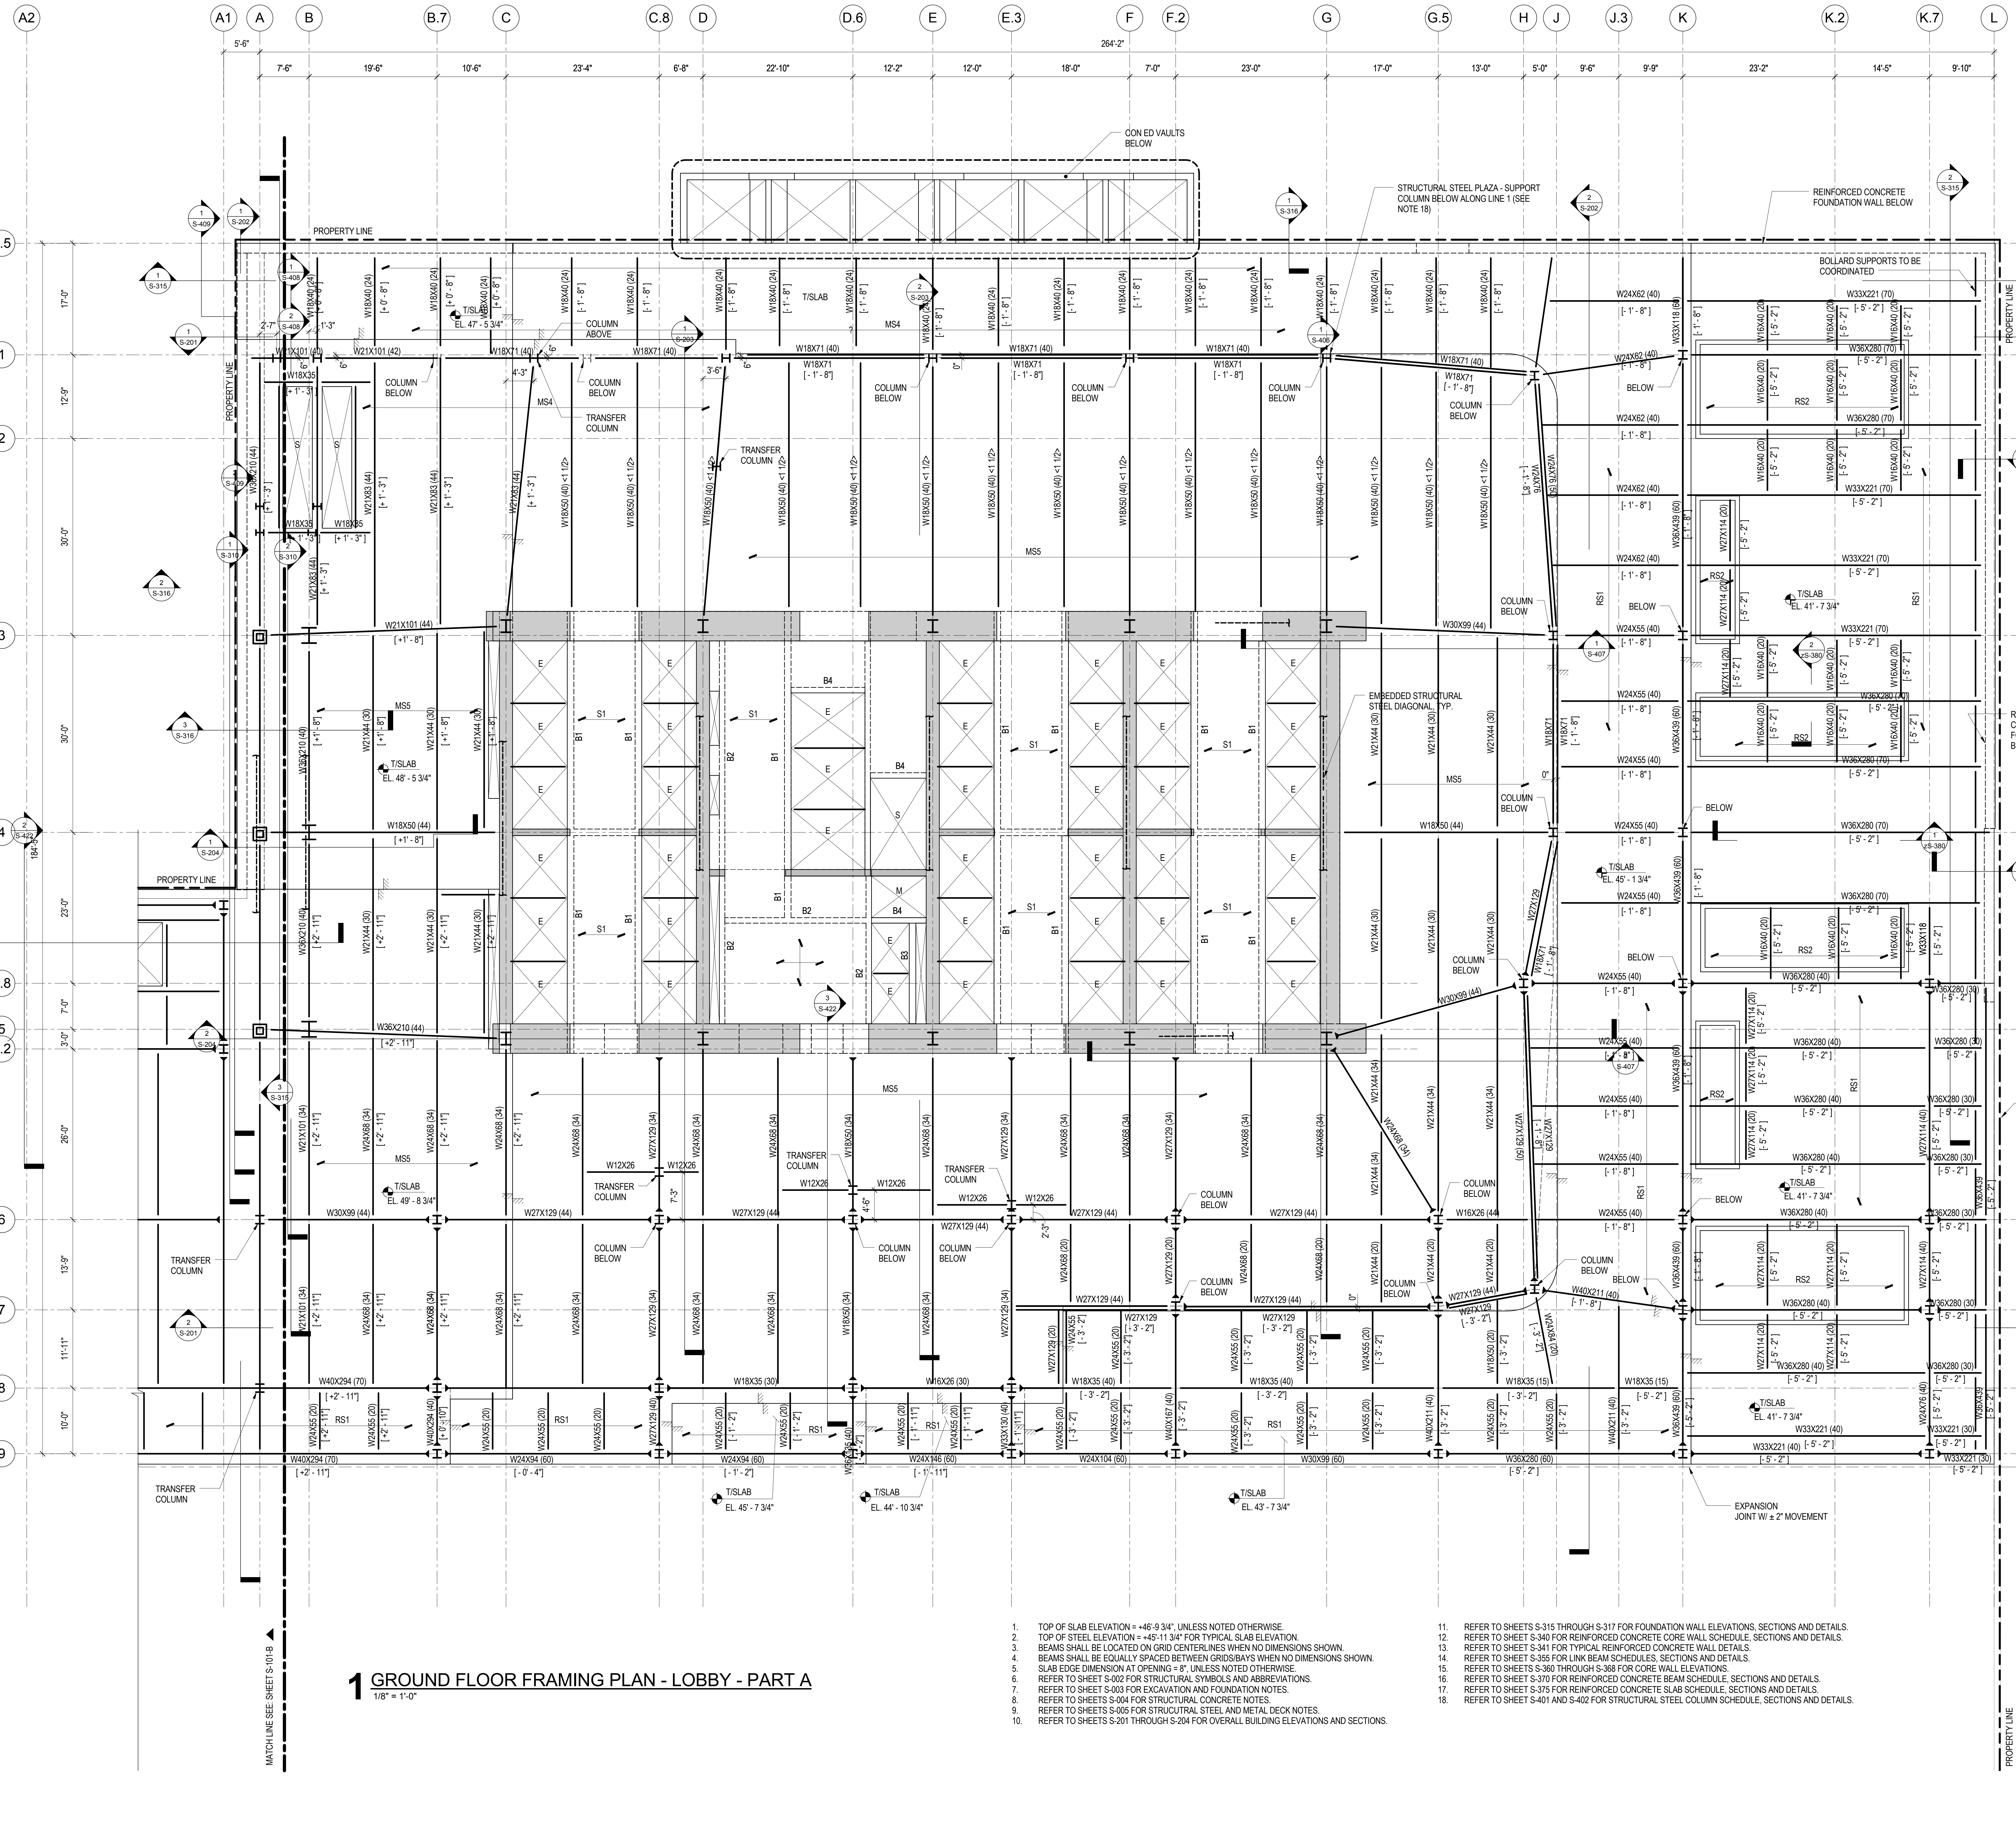

1 GROUND FLOOR FRAMING PLAN - LOBBY - PART A
1/8" = 1'-0"

1. TOP OF SLAB ELEVATION = 48'-5 3/4", UNLESS NOTED OTHERWISE.
2. TOP OF STEEL ELEVATION = 48'-11 3/4" FOR TYPICAL SLAB ELEVATION.
3. BEAMS SHALL BE LOCATED ON GRID CENTERLINES WHEN NO DIMENSIONS SHOWN.
4. BEAMS SHALL BE EQUALLY SPACED BETWEEN GRIDS/BAYS WHEN NO DIMENSIONS SHOWN.
5. SLAB EDGE DIMENSION AT OPENING = 8", UNLESS NOTED OTHERWISE.
6. REFER TO SHEET S-302 FOR STRUCTURAL SYMBOLS AND ABBREVIATIONS.
7. REFER TO SHEET S-303 FOR EXCAVATION AND FOUNDATION NOTES.
8. REFER TO SHEETS S-304 FOR STRUCTURAL CONCRETE NOTES.
9. REFER TO SHEETS S-305 FOR STRUCTURAL STEEL AND METAL DECK NOTES.
10. REFER TO SHEETS S-201 THROUGH S-204 FOR OVERALL BUILDING ELEVATIONS AND SECTIONS.
11. REFER TO SHEETS S-315 THROUGH S-317 FOR FOUNDATION WALL ELEVATIONS, SECTIONS AND DETAILS.
12. REFER TO SHEET S-340 FOR REINFORCED CONCRETE CORE WALL SCHEDULE, SECTIONS AND DETAILS.
13. REFER TO SHEET S-341 FOR TYPICAL REINFORCED CONCRETE WALL DETAILS.
14. REFER TO SHEET S-355 FOR LINK BEAM SCHEDULES, SECTIONS AND DETAILS.
15. REFER TO SHEETS S-360 THROUGH S-368 FOR CORE WALL ELEVATIONS.
16. REFER TO SHEET S-370 FOR REINFORCED CONCRETE BEAM SCHEDULE, SECTIONS AND DETAILS.
17. REFER TO SHEET S-375 FOR REINFORCED CONCRETE SLAB SCHEDULE, SECTIONS AND DETAILS.
18. REFER TO SHEET S-401 AND S-402 FOR STRUCTURAL STEEL COLUMN SCHEDULE, SECTIONS AND DETAILS.



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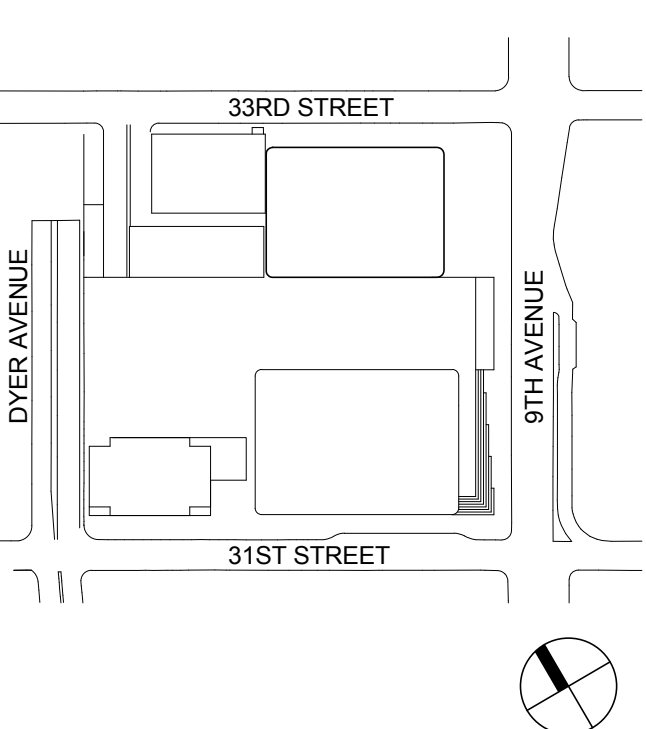
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Key Plan:



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4	20 DEC 2013	ISSUED FOR FOUNDATION PERMIT
3	15 NOV 2013	ISSUED FOR 2D PROGRESS PRICING
2	12 JUL 2013	ISSUED FOR 90% DESIGN DEVELOPMENT
1	18 MAR 2012	ISSUED FOR RECONCILIATION

No. Date Description

Sheet Name

**2ND FLOOR
FRAMING PLAN**

Project No.: 211157

Date: 20 JUN 2014

Scale: 1/8" = 1'-0"

File No.: S-102

B-SCAN Sheet No.: S-102.00

Sheet No.: S-102

Page No.: 19 of 90


2 STAIR LANDING BETWEEN LEVEL 2 & 3

1/8" = 1'-0"


1 2ND FLOOR FRAMING PLAN

1/8" = 1'-0"

1. TOP OF SLAB ELEVATION = 68'-7", UNLESS NOTED OTHERWISE.
2. TOP OF STEEL ELEVATION = 67'-9 1/2" UNLESS NOTED OTHERWISE BY "[X-X]" OR "[X-X]", WHICH DENOTE POSITIVE OR NEGATIVE VERTICAL OFFSET, RESPECTIVELY.
3. BEAMS SHALL BE LOCATED ON GRID CENTERLINES WHEN NO DIMENSIONS SHOWN.
4. BEAMS SHALL BE EQUALLY SPACED BETWEEN GRIDS/BAYS WHEN NO DIMENSIONS SHOWN.
5. SLAB EDGE DIMENSION AT OPENING = 8", UNLESS NOTED OTHERWISE.
6. REFER TO SHEET S-002 FOR STRUCTURAL SYMBOLS AND ABBREVIATIONS.
7. REFER TO SHEET S-003 FOR EXCAVATION AND FOUNDATION NOTES.
8. REFER TO SHEET S-004 FOR STRUCTURAL CONCRETE NOTES.
9. REFER TO SHEETS S-005 FOR STRUCTURAL STEEL AND METAL DECK NOTES.
10. REFER TO SHEETS S-201 THROUGH S-204 FOR OVERALL BUILDING ELEVATIONS AND SECTIONS.
11. REFER TO SHEETS S-301 AND S-302 FOR CORE WALL CONTINUOUS FOOTINGS SECTIONS AND DETAILS.
12. REFER TO SHEET S-303 FOR CAISSON SCHEDULE, SECTIONS AND DETAILS.
13. REFER TO SHEET S-315 FOR SPREAD FOOTING SCHEDULE, SECTIONS AND DETAILS.
14. REFER TO SHEET S-316 FOR GRADE BEAM SCHEDULE, SECTIONS AND DETAILS.
15. REFER TO SHEETS S-320 THROUGH S-322 FOR FOUNDATION WALL ELEVATIONS, SECTIONS AND DETAILS.
16. REFER TO SHEET S-330 FOR SLAB-ON-GRADE SECTIONS AND DETAILS.
17. REFER TO SHEET S-350 FOR REINFORCED CONCRETE CORE WALL SCHEDULE, SECTIONS AND DETAILS.
18. REFER TO SHEET S-351 FOR TYPICAL REINFORCED CONCRETE WALL DETAILS.
19. REFER TO SHEET S-355 FOR LINK BEAM SCHEDULES, SECTIONS AND DETAILS.
20. REFER TO SHEETS S-360 THROUGH S-368 FOR CORE WALL ELEVATIONS.
21. REFER TO SHEET S-370 FOR REINFORCED CONCRETE BEAM SCHEDULE, SECTIONS AND DETAILS.
22. REFER TO SHEET S-375 FOR REINFORCED CONCRETE SLAB SCHEDULE, SECTIONS AND DETAILS.
23. REFER TO SHEET S-401 FOR STRUCTURAL STEEL COLUMN SCHEDULE, SECTIONS AND DETAILS.
24. REFER TO DRAWINGS PREPARED BY ENTITLED FOR ADJACENT PLATFORM STRUCTURE.
25. REFER TO SHEET S-501 FOR METAL DECK SLAB SCHEDULES, SECTIONS & DETAILS.

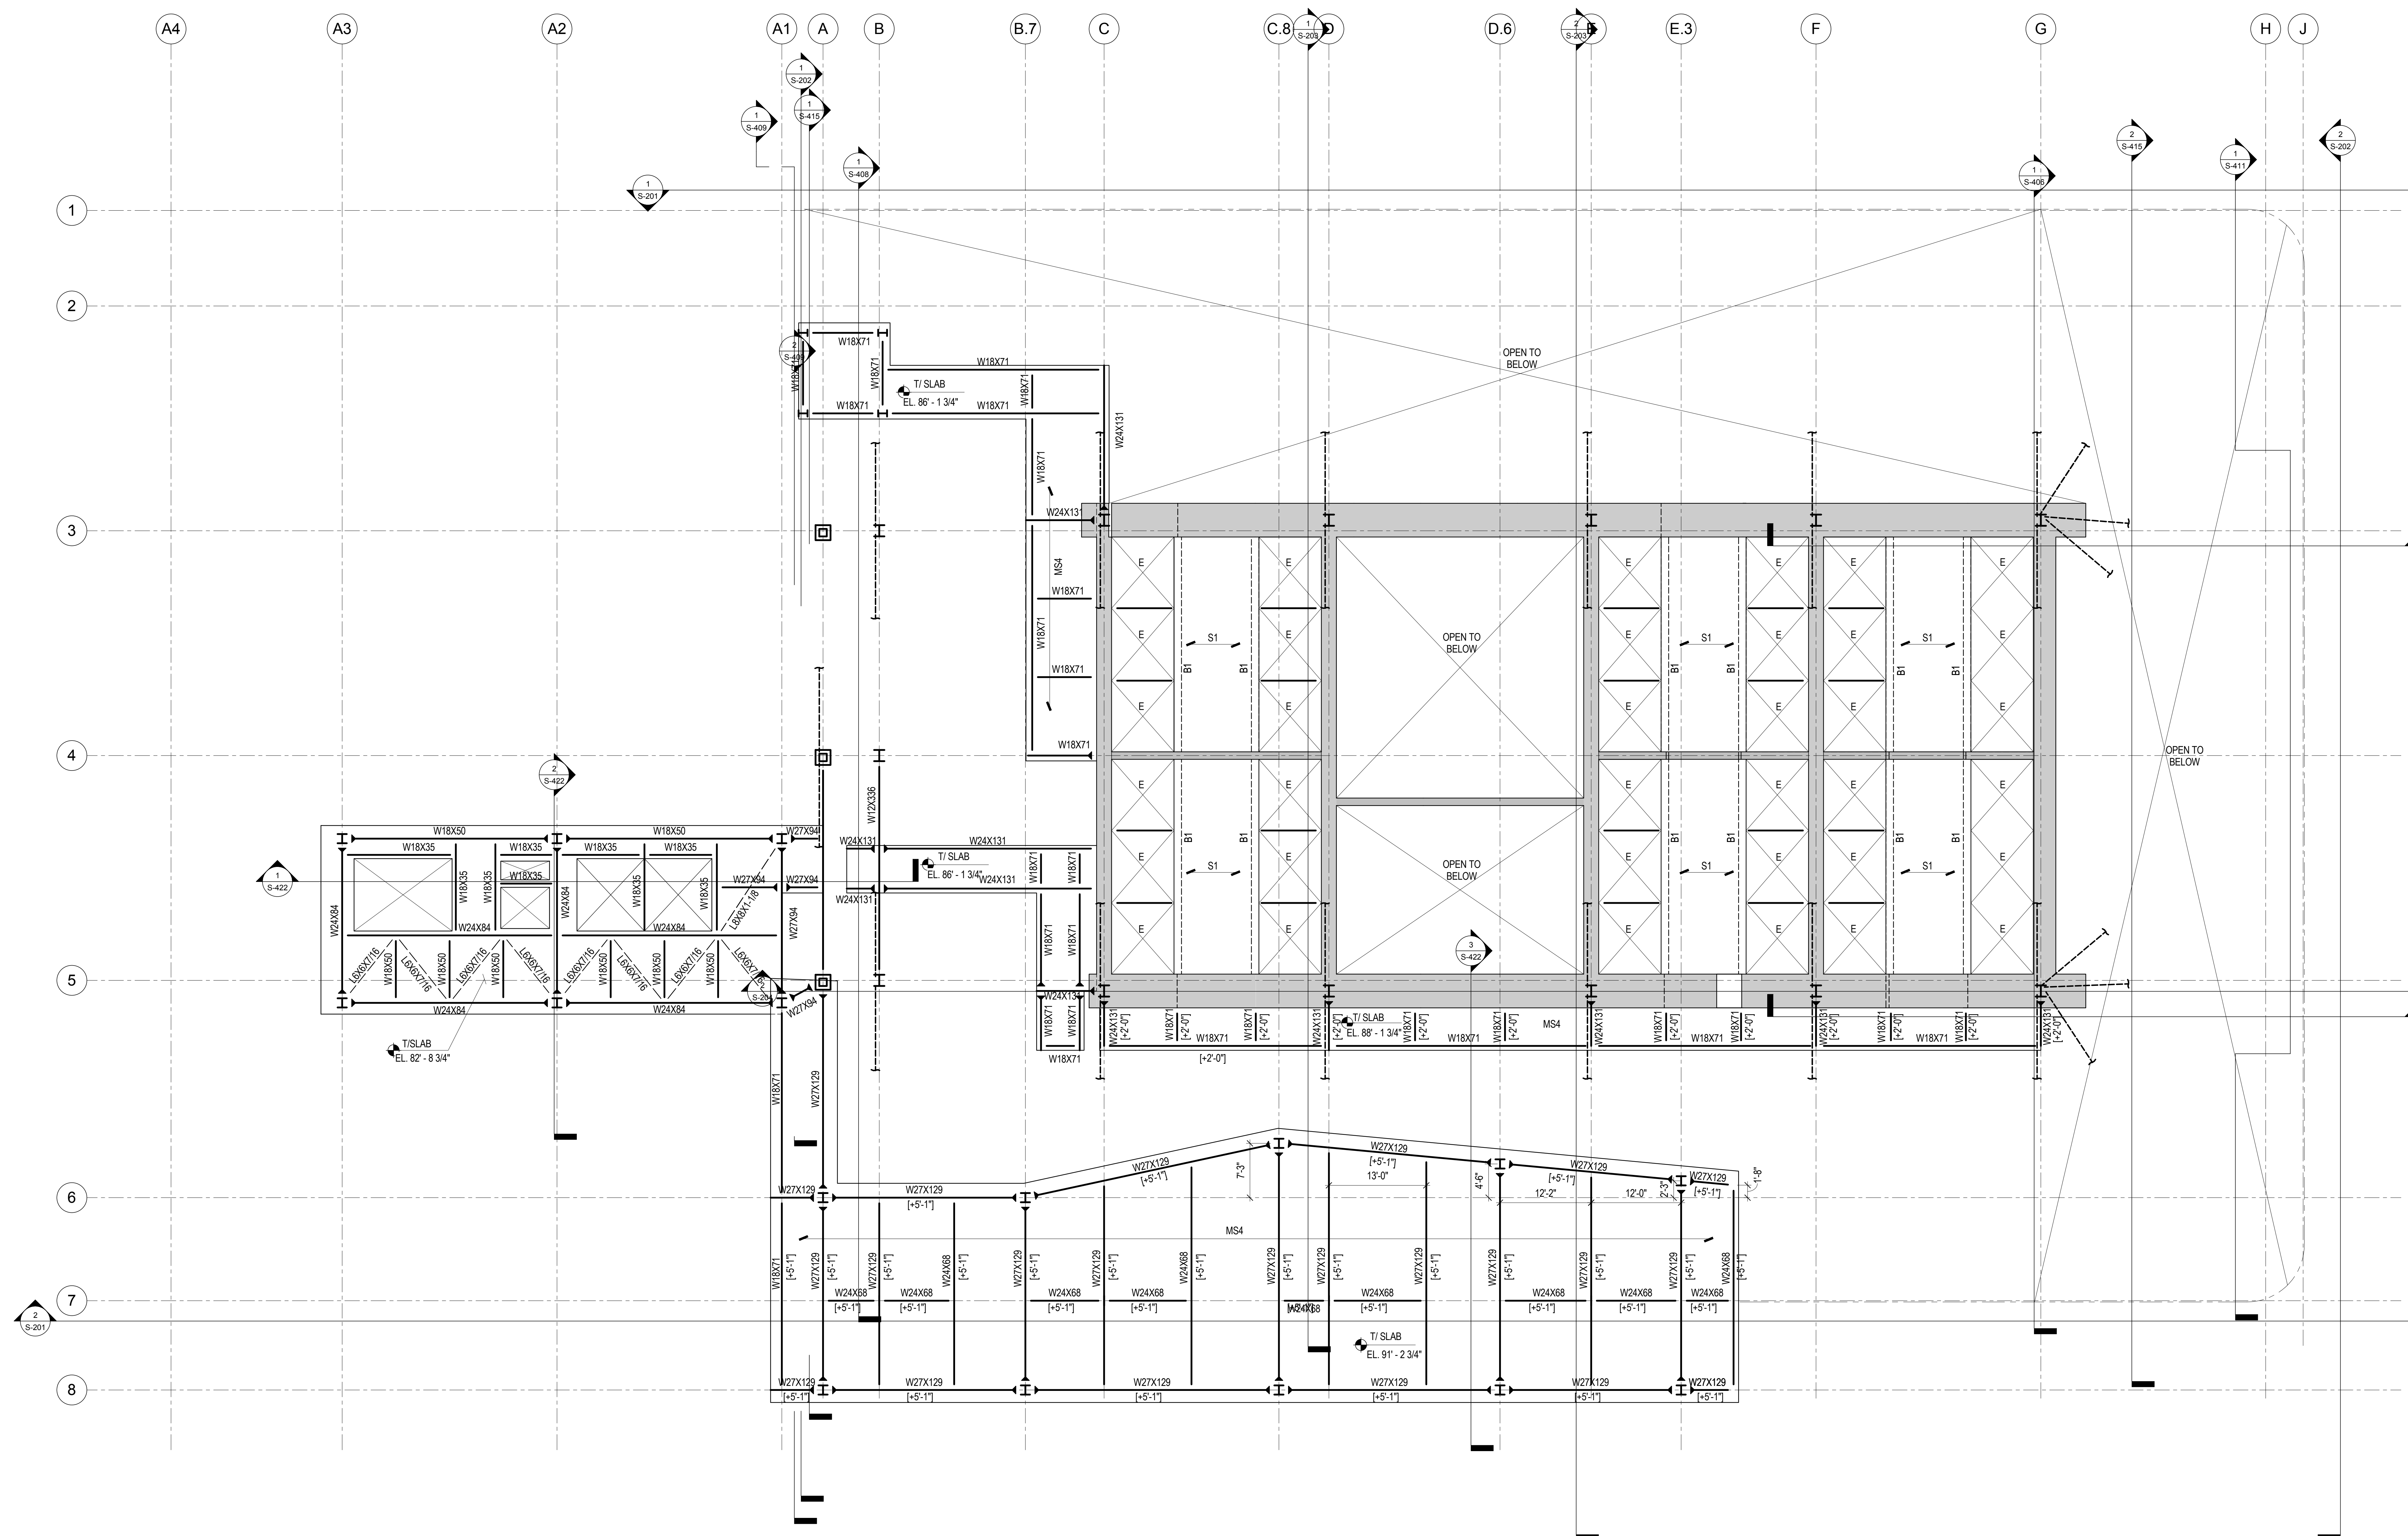

- | | | | |
|-----|---|-----|---|
| 1. | TOP OF SLAB ELEVATION = 84'- 6", UNLESS NOTED OTHERWISE. | 15. | REFER TO SHEETS S-320 THROUGH S-322 FOR FOUNDATION WALL ELEVATIONS, SECTIONS AND DETAILS. |
| 2. | TOP OF STEEL ELEVATION = 84'- 12", UNLESS NOTED OTHERWISE BY [X+X'] OR [X-X'], WHICH DENOTE POSITIVE OR NEGATIVE VERTICAL OFFSET, RESPECTIVELY. | 16. | REFER TO SHEET S-330 FOR SLAB-ON-GRADE SECTIONS AND DETAILS. |
| 3. | BEAMS SHALL BE LOCATED ON GRID CENTERLINES WHEN NO DIMENSIONS SHOWN. BEAMS EQUALLY SPACED BETWEEN GRIDS WHEN NO DIMENSIONS SHOWN. | 17. | REFER TO SHEET S-350 FOR REINFORCED CONCRETE CORE WALL SCHEDULE, SECTIONS AND DETAILS. |
| 4. | SLAB EDGE DIMENSION AT OPENING = 8", UNLESS NOTED OTHERWISE. | 18. | REFER TO SHEET S-361 FOR TYPICAL REINFORCED CONCRETE WALL DETAILS. |
| 5. | REFER TO SHEET S-002 FOR STRUCTURAL SYMBOLS AND ABBREVIATIONS. | 19. | REFER TO SHEET S-365 FOR LINK BEAM SCHEDULES, SECTIONS AND DETAILS. |
| 6. | REFER TO SHEET S-003 FOR EXCAVATION AND FOUNDATION NOTES. | 20. | REFER TO SHEET S-366 THROUGH S-368 FOR CORE WALL ELEVATIONS. |
| 7. | REFER TO SHEETS S-004 FOR STRUCTURAL CONCRETE NOTES. | 21. | REFER TO SHEET S-370 FOR REINFORCED CONCRETE BEAM SCHEDULE, SECTIONS AND DETAILS. |
| 8. | REFER TO SHEETS S-005 FOR STRUCTURAL STEEL DECK NOTES. | 22. | REFER TO SHEET S-375 FOR REINFORCED CONCRETE SLAB SCHEDULE, SECTIONS AND DETAILS. |
| 9. | REFER TO SHEETS S-201 THROUGH S-204 FOR OVERALL BUILDING ELEVATIONS AND SECTIONS. | 23. | REFER TO SHEET S-440 FOR STRUCTURAL STEEL COLUMN SCHEDULE, SECTIONS AND DETAILS. |
| 10. | REFER TO SHEETS S-301 AND S-302 FOR CORE WALL CONTINUOUS FOOTINGS SECTIONS AND DETAILS. | 24. | REFER TO DRAWINGS PREPARED BY ARCHITECT FOR PLATFORM STRUCTURE. |
| 11. | REFER TO SHEET S-305 FOR CAISSON SCHEDULE, SECTIONS AND DETAILS. | 25. | REFER TO SHEET S-501 FOR METAL DECK SLAB SCHEDULES, SECTIONS & DETAILS. |
| 12. | REFER TO SHEET S-315 FOR SPREAD FOOTING SCHEDULE, SECTIONS AND DETAILS. | | |
| 13. | REFER TO SHEET S-316 FOR GRADE BEAM SCHEDULE, SECTIONS AND DETAILS. | | |

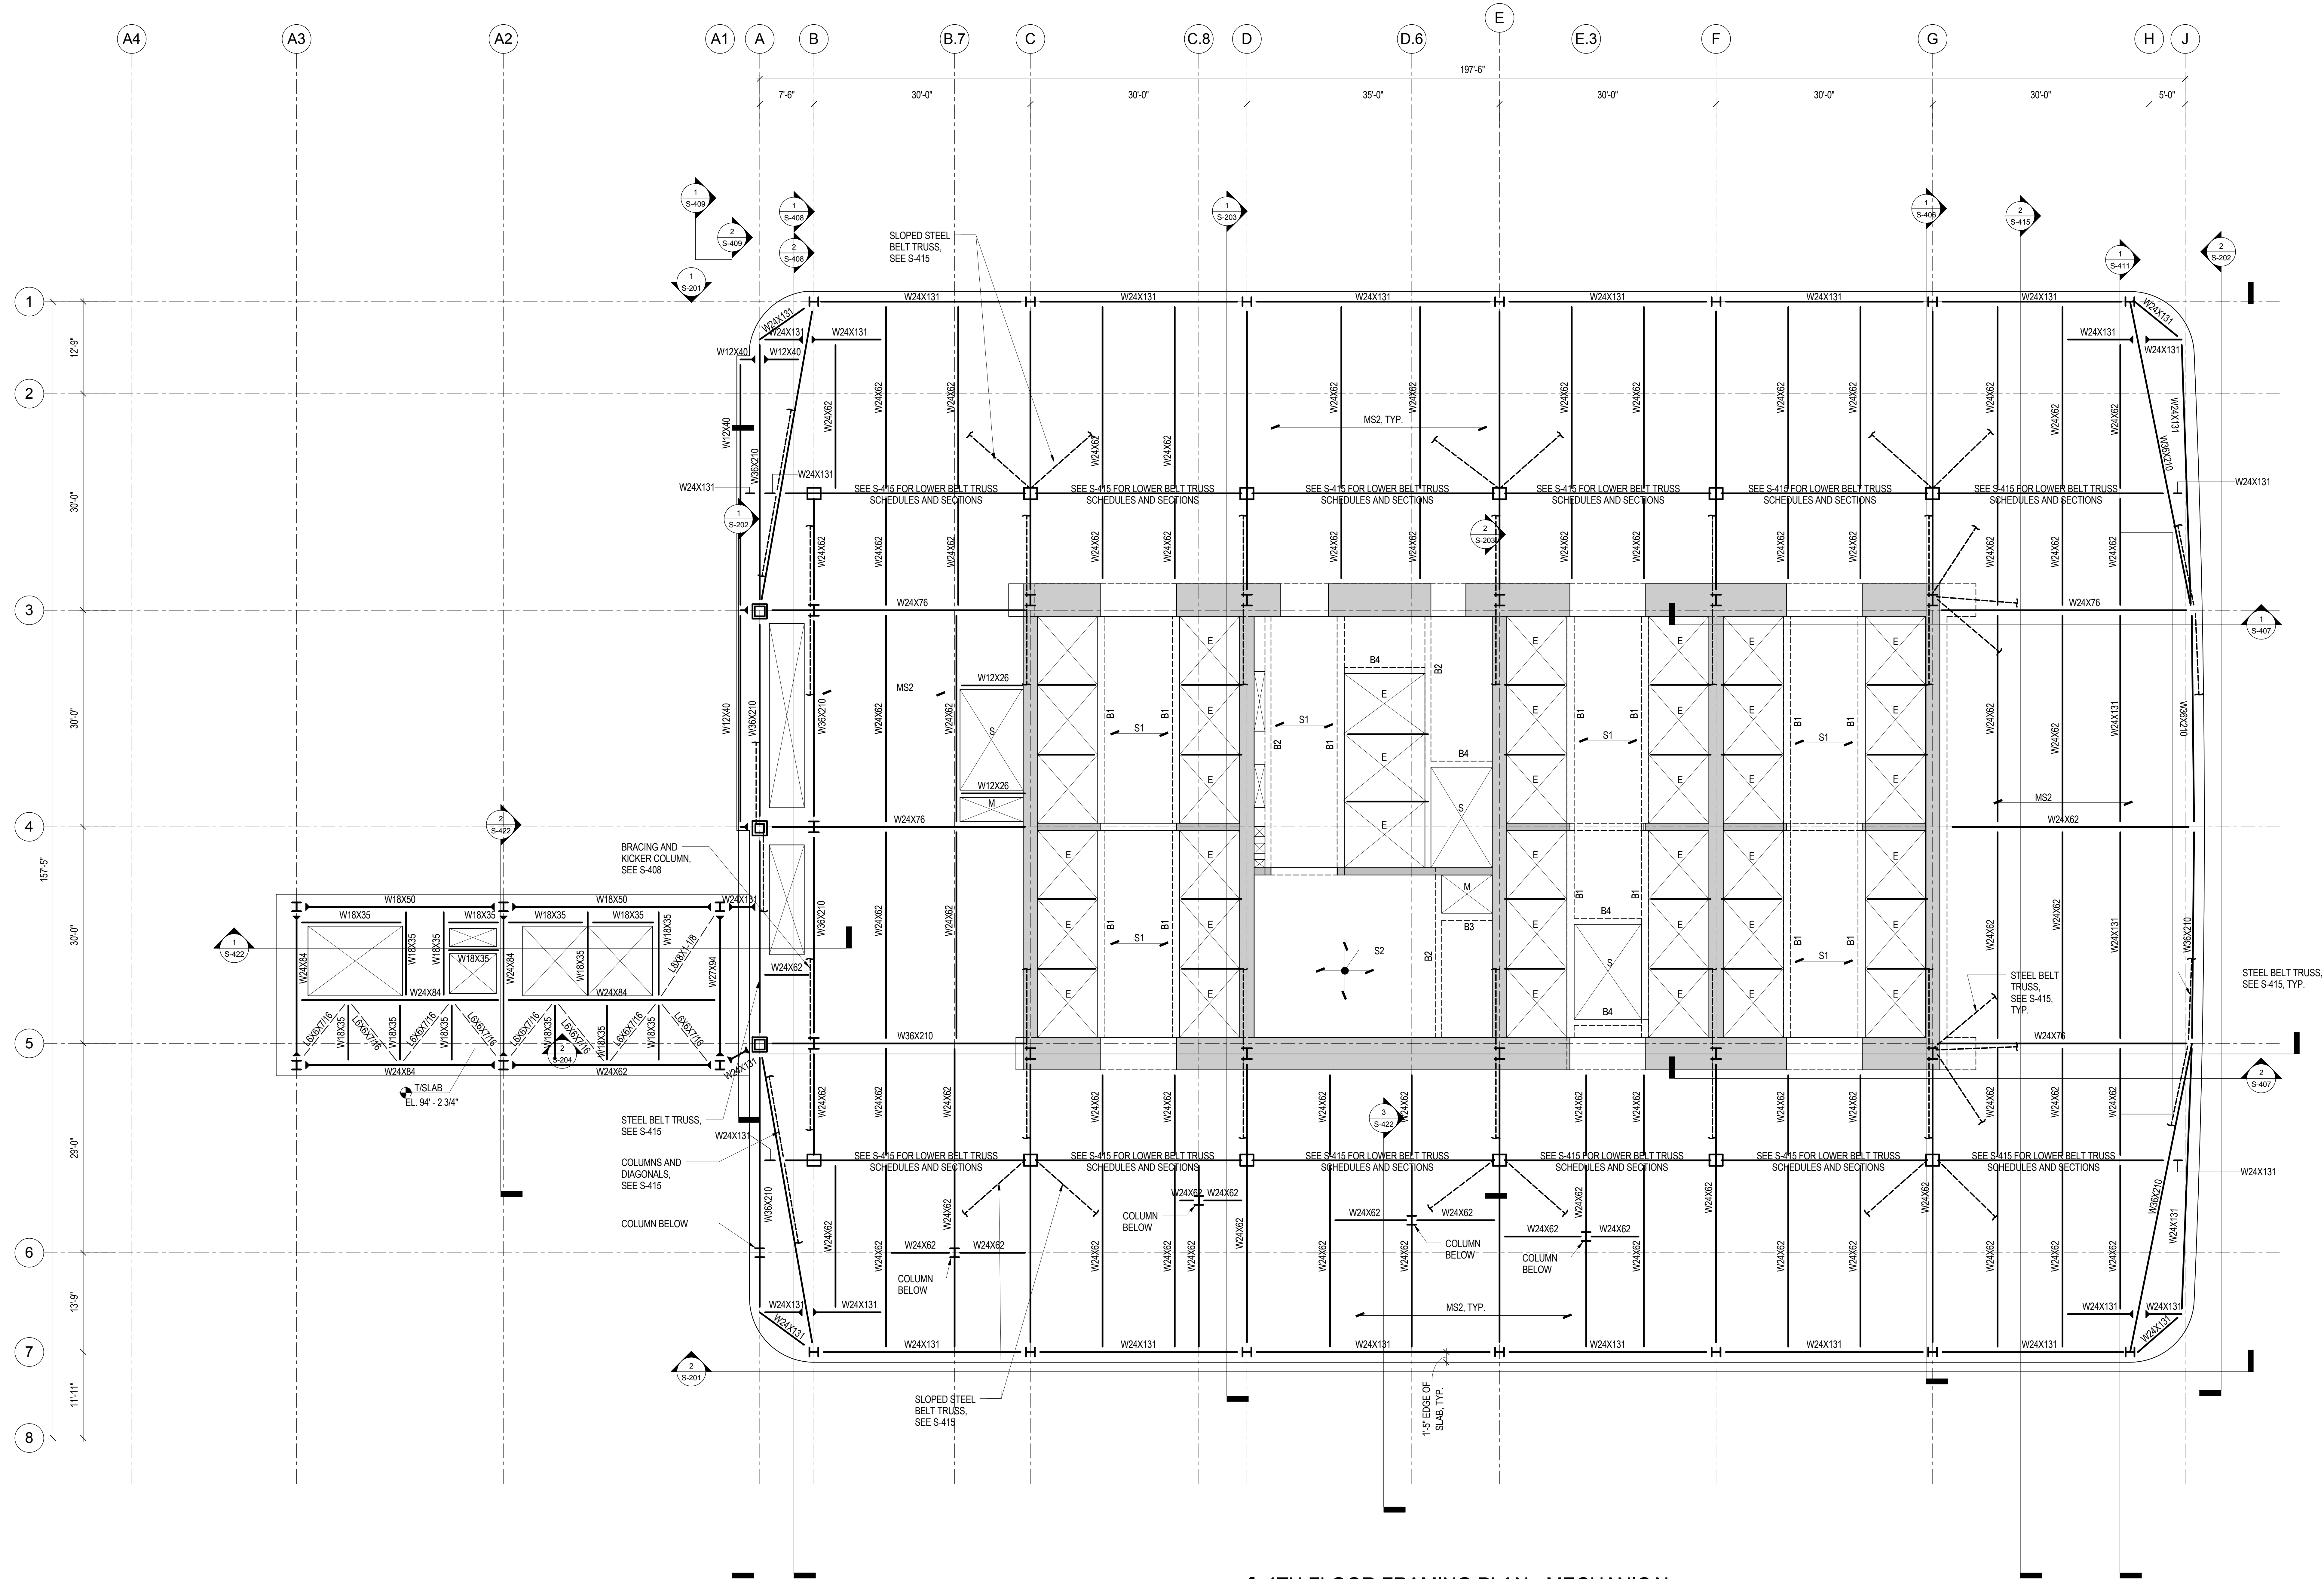

1 4TH FLOOR FRAMING PLAN - MECHANICAL
1/8" = 1'-0"

1. TOP OF SLAB ELEVATION = 97'-0", UNLESS NOTED OTHERWISE.
2. TOP OF STEEL ELEVATION = 96'-1", UNLESS NOTED OTHERWISE BY (+X'-X") OR (X'-X"), WHICH DENOTE POSITIVE OR NEGATIVE VERTICAL OFFSET, RESPECTIVELY.
3. BEAMS SHALL BE LOCATED ON GRID CENTERLINES WHEN NO DIMENSIONS SHOWN.
4. BEAMS SHALL BE EQUALLY SPACED BETWEEN GRID BAYS WHEN NO DIMENSIONS SHOWN.
5. SLAB EDGE DIMENSION AT OPENING = 8", UNLESS NOTED OTHERWISE.
6. REFER TO SHEET S-002 FOR STRUCTURAL SYMBOLS AND ABBREVIATIONS.
7. REFER TO SHEET S-003 FOR EXCAVATION AND FOUNDATION NOTES.
8. REFER TO SHEETS S-004 FOR STRUCTURAL CONCRETE NOTES.
9. REFER TO SHEETS S-005 FOR STRUCTURAL STEEL AND METAL DECK NOTES.
10. REFER TO SHEETS S-201 THROUGH S-204 FOR OVERALL BUILDING ELEVATIONS AND SECTIONS.
11. REFER TO SHEETS S-301 AND S-302 FOR CORE WALL CONTINUOUS FOOTINGS SECTIONS AND DETAILS.
12. REFER TO SHEET S-305 FOR CAISSON SCHEDULE, SECTIONS AND DETAILS.
13. REFER TO SHEET S-315 FOR SPREAD FOOTING SCHEDULE, SECTIONS AND DETAILS.
14. REFER TO SHEET S-316 FOR GRADE BEAM SCHEDULE, SECTIONS AND DETAILS.
15. REFER TO SHEETS S-320 THROUGH S-322 FOR FOUNDATION WALL ELEVATIONS, SECTIONS AND DETAILS.
16. REFER TO SHEET S-330 FOR SLAB-ON-GRADE SECTIONS AND DETAILS.
17. REFER TO SHEET S-350 FOR REINFORCED CONCRETE CORE WALL SCHEDULE, SECTIONS AND DETAILS.
18. REFER TO SHEET S-351 FOR TYPICAL REINFORCED CONCRETE WALL DETAILS.
19. REFER TO SHEET S-355 FOR LINK BEAM SCHEDULES, SECTIONS AND DETAILS.
20. REFER TO SHEETS S-360 THROUGH S-368 FOR CORE WALL ELEVATIONS.
21. REFER TO SHEET S-370 FOR REINFORCED CONCRETE BEAM SCHEDULE, SECTIONS AND DETAILS.
22. REFER TO SHEET S-375 FOR REINFORCED CONCRETE SLAB SCHEDULE, SECTIONS AND DETAILS.
23. REFER TO SHEET S-401 FOR STRUCTURAL STEEL COLUMN SCHEDULE, SECTIONS AND DETAILS.
24. REFER TO DRAWINGS PREPARED BY ENTITLED FOR ADJACENT PLATFORM STRUCTURE.
25. REFER TO SHEET S-501 FOR METAL DECK SLAB SCHEDULES, SECTIONS & DETAILS.

**MANHATTAN WEST:
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Key Plan:

Seal & Signature:

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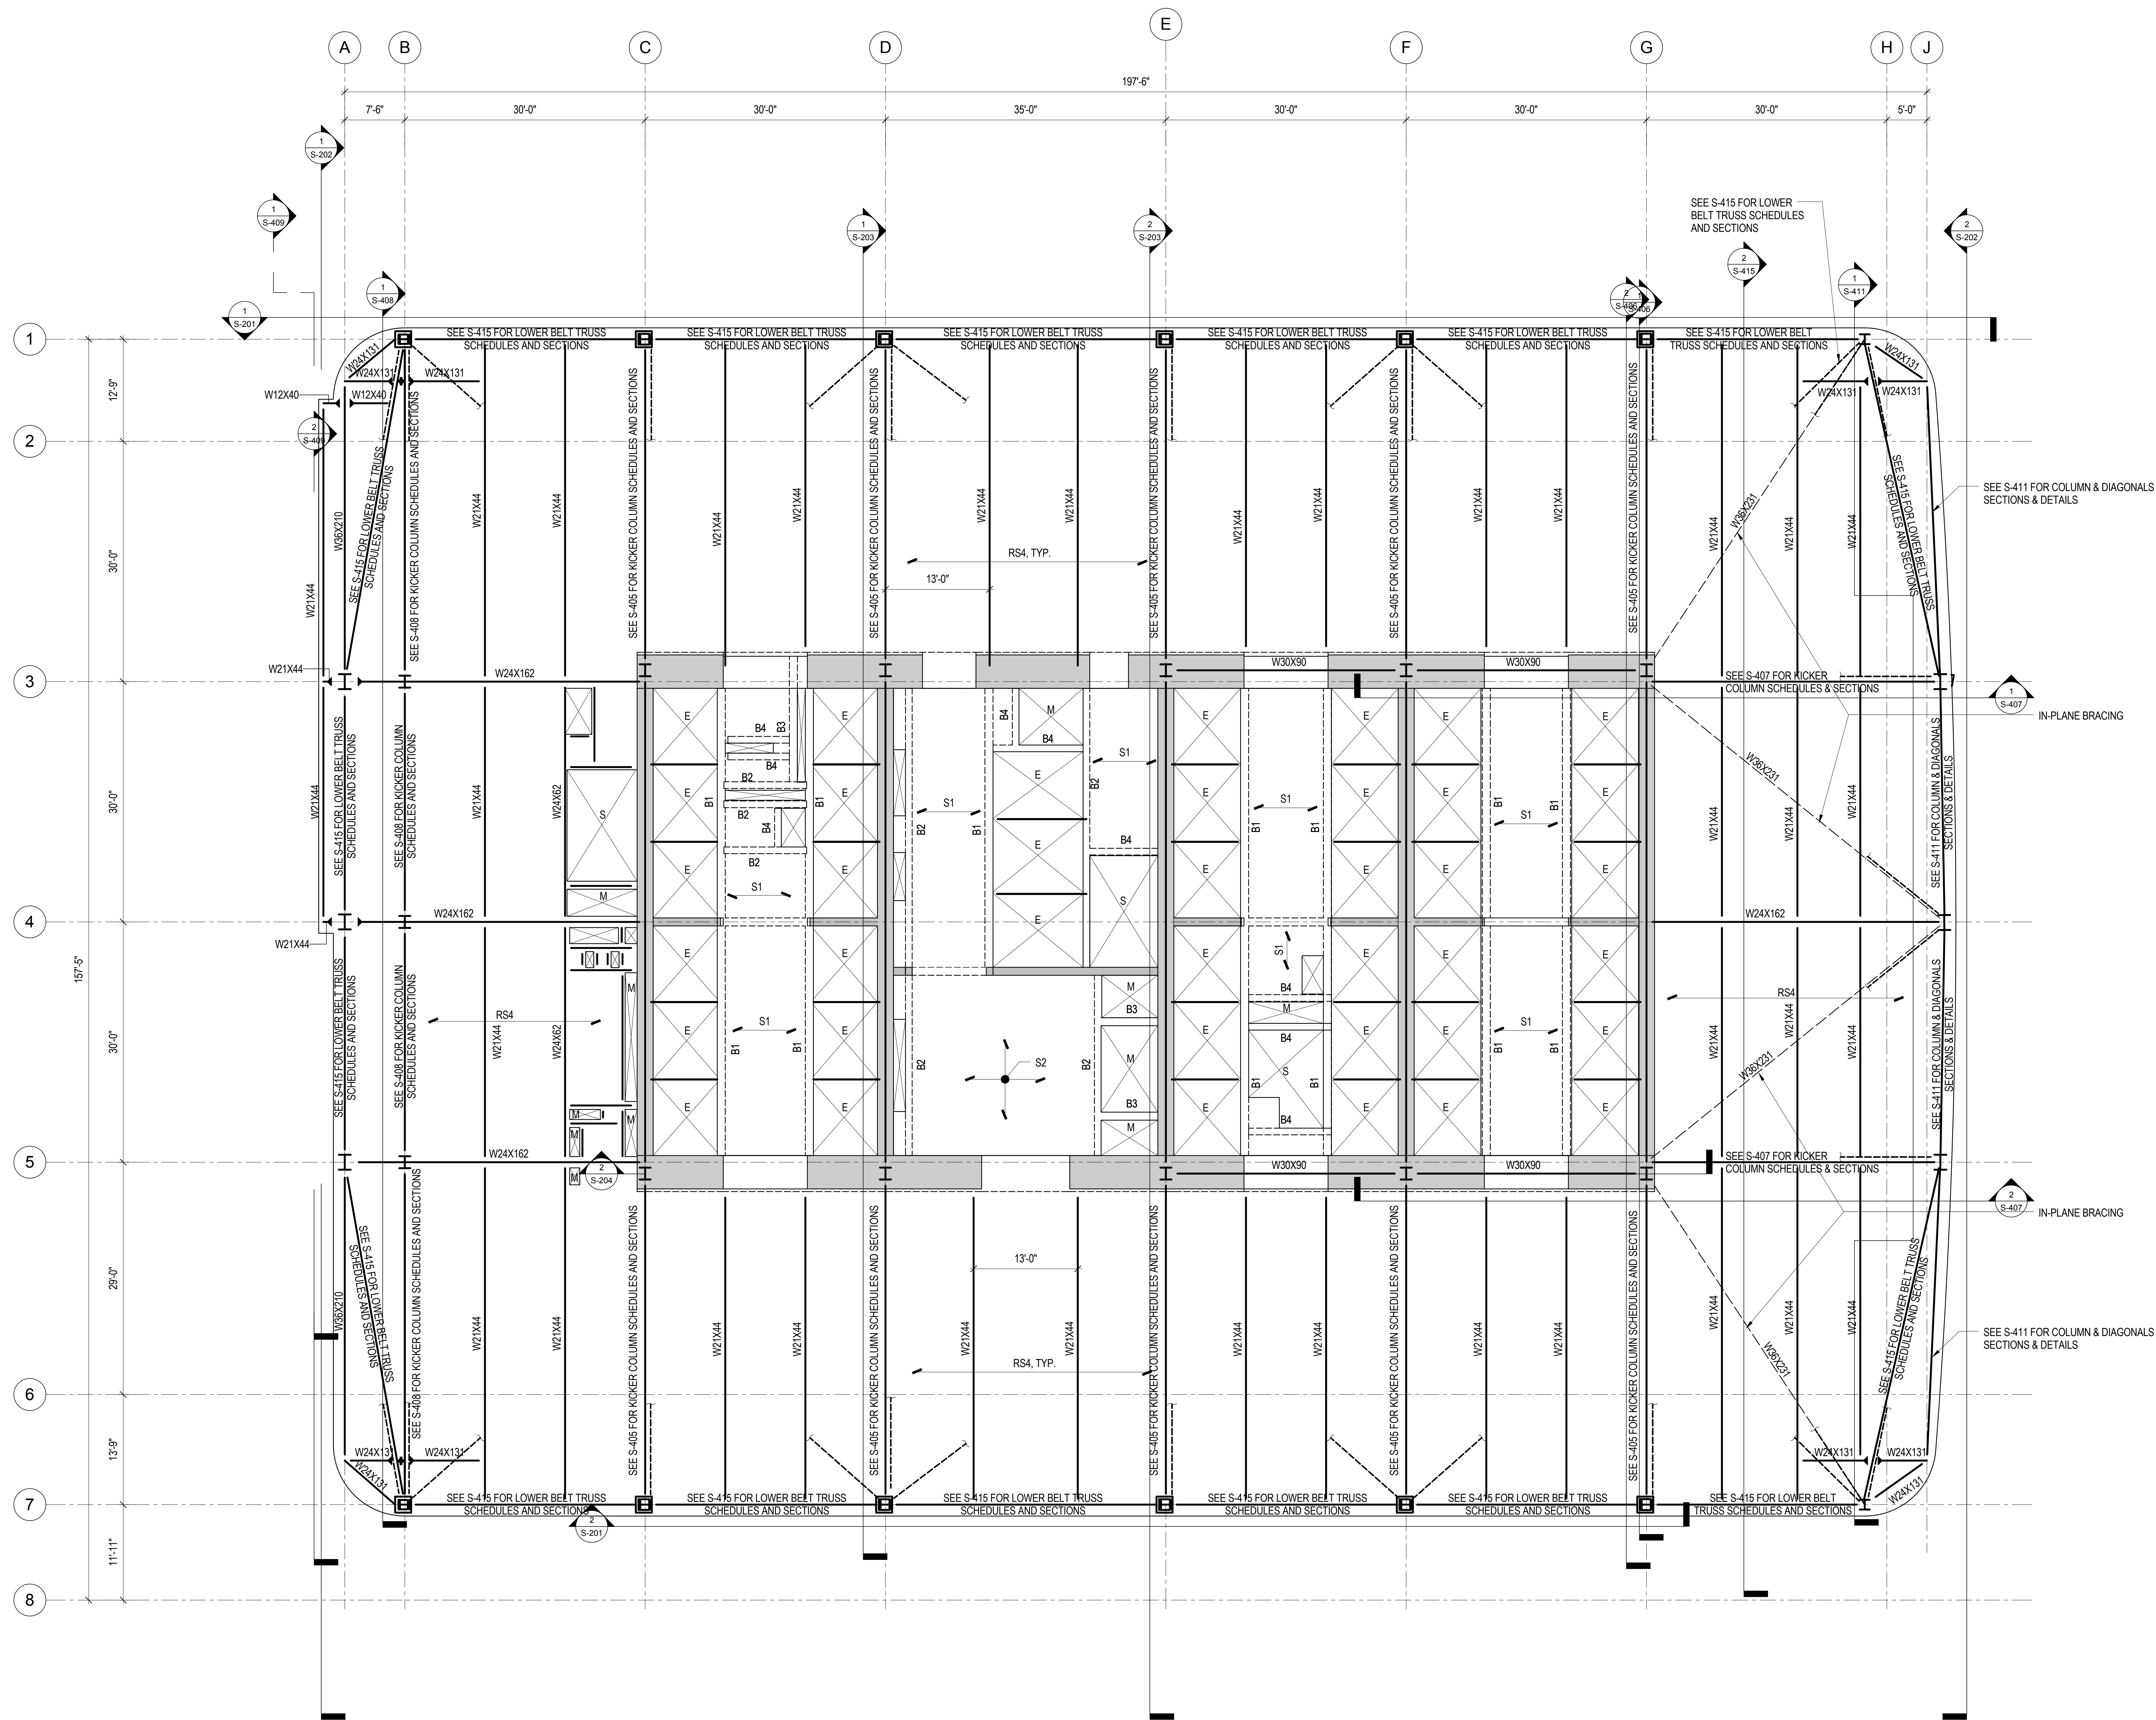
No. _____ Date _____ Description _____
Sheet Name: **4TH FLOOR
FRAMING PLAN -
MECHANICAL**

Project No.:	B-SCAN Sheet No.:
211157	S-104.00

Date:	Sheet No.:
20 JUN 2014	S-104

Scale:	Page No.:
1/8" = 1'-0"	21 of 90

File No.: S-104



1 6TH FLOOR FRAMING PLAN- LOW-RISE
1/8" = 1'-0"

1. TOP OF SLAB ELEVATION = +137'-6", UNLESS NOTED OTHERWISE.
2. TOP OF STEEL ELEVATION = +136'-7", UNLESS NOTED OTHERWISE BY (+X'-X") OR (X'-X") WHICH DENOTE POSITIVE OR NEGATIVE VERTICAL OFFSET, RESPECTIVELY.
3. BEAMS SHALL BE LOCATED ON GRID CENTERLINES WHEN NO DIMENSIONS SHOWN.
4. BEAMS SHALL BE EQUALLY SPACED BETWEEN GRIDSBAYS WHEN NO DIMENSIONS SHOWN.
5. SLAB EDGE DIMENSION AT OPENING = 8", UNLESS NOTED OTHERWISE.
6. REFER TO SHEET S-002 FOR EXCAVATION AND FOUNDATION NOTES.
7. REFER TO SHEETS S-003 FOR STRUCTURAL STEEL AND METAL DECK NOTES.
8. REFER TO SHEETS S-004 FOR STRUCTURAL STEEL AND METAL DECK NOTES.
9. REFER TO SHEETS S-005 FOR STRUCTURAL STEEL AND METAL DECK NOTES.
10. REFER TO SHEETS S-201 THROUGH S-204 FOR OVERALL BUILDING ELEVATIONS AND SECTIONS.
11. REFER TO SHEETS S-301 AND S-302 FOR CORE WALL CONTINUOUS FOOTINGS SECTIONS AND DETAILS.
12. REFER TO SHEET S-305 FOR CAISSON SCHEDULE, SECTIONS AND DETAILS.
13. REFER TO SHEET S-315 FOR SPREAD FOOTING SCHEDULE, SECTIONS AND DETAILS.
14. REFER TO SHEET S-316 FOR GRADE BEAM SCHEDULE, SECTIONS AND DETAILS.
15. REFER TO SHEETS S-320 THROUGH S-322 FOR FOUNDATION WALL ELEVATIONS, SECTIONS AND DETAILS.
16. REFER TO SHEET S-330 FOR SLAB ON-GRADE SECTIONS AND DETAILS.
17. REFER TO SHEET S-350 FOR REINFORCED CONCRETE CORE WALL SCHEDULE, SECTIONS AND DETAILS.
18. REFER TO SHEET S-351 FOR TYPICAL REINFORCED CONCRETE WALL DETAILS.
19. REFER TO SHEET S-355 FOR LINK BEAM SCHEDULES, SECTIONS AND DETAILS.
20. REFER TO SHEETS S-360 THROUGH S-368 FOR CORE WALL ELEVATIONS.
21. REFER TO SHEET S-370 FOR REINFORCED CONCRETE BEAM SCHEDULE, SECTIONS AND DETAILS.
22. REFER TO SHEET S-375 FOR REINFORCED CONCRETE SLAB SCHEDULE, SECTIONS AND DETAILS.
23. REFER TO SHEET S-401 FOR STRUCTURAL STEEL COLUMN SCHEDULE, SECTIONS AND DETAILS.
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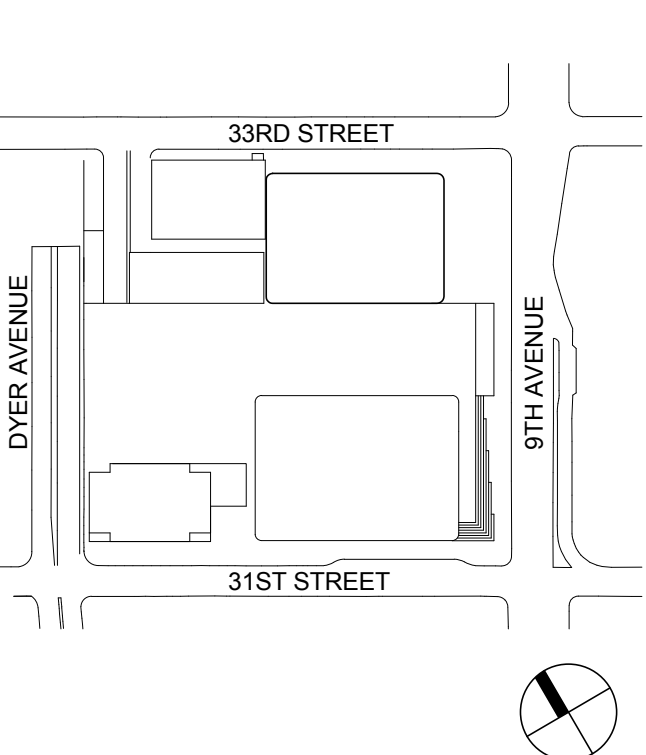
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Key Plan:



Seal & Signature:

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6TH FLOOR
FRAMING PLAN-
LOW-RISE

Project No.: 211157
Date: 20 JUN 2014
Scale: 1/8" = 1'-0"
File No.: S-106

Sheet No.: S-106
Page No.: 23 of 90



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Field Operations
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Security Consultant
Ducibella, Ventor & Santore
250 State Street #F1, North Haven, CT 06473

Blast Consultant
Weidinger Associates, Inc.
40 Wall Street, New York, NY 10005


Acoustical Consultant
Cerami & Associates
404 Fifth Avenue #8, New York, NY 10016

Vibration Consultant
Wilson, Uhrig & Associates, Inc.
65 Broadway, Suite 401, New York, NY 10006

Code Consultant
Code Consultants Professional Engineers PC
215 West 40th Street, 15th Floor, New York, NY 10018

Facade Maintenance Consultant
Entek Engineering LLC
166 Ames Street, Hackensack, NJ 07601

Wind Tunnel Consultant
Rowan Williams Davies & Irwin Inc.
650 Woodlawn Road West, Guelph
Ontario, Canada N1K 1B6

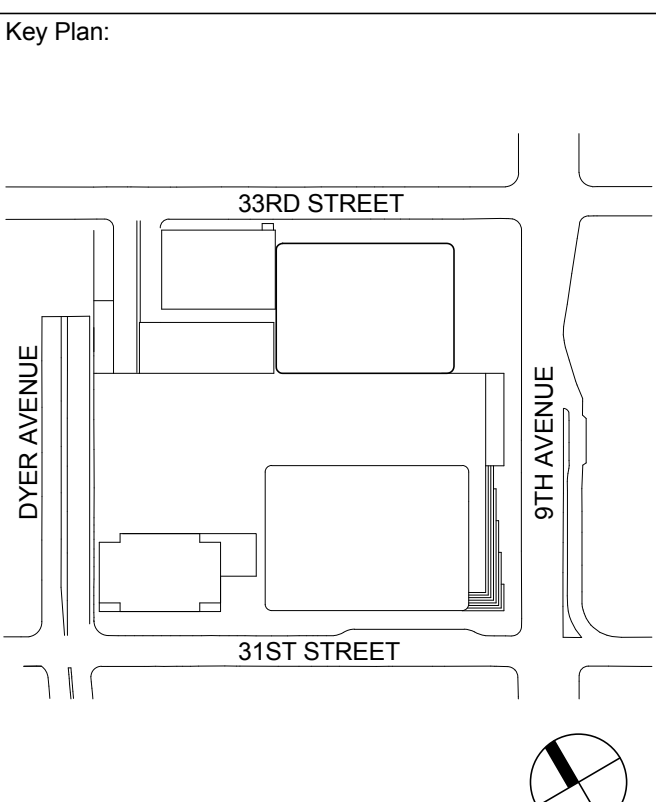

Seal & Signature


PRELIMINARY
NOT FOR CONSTRUCTION

6	20 JUN 2014	ISSUED FOR FOUNDATION BID
5	20 JUN 2014	ISSUED FOR FOUNDATION PERMIT
4	20 DEC 2013	ISSUED FOR FOUNDATION PERMIT
3	15 NOV 2013	ISSUED FOR 50% PROGRESS PRICING
2	12 JUL 2013	ISSUED FOR 90% DESIGN DEVELOPMENT
1	18 MAR 2012	ISSUED FOR RECONCILIATION

No. Date Description
Sheet Name:

16TH FLOOR
FRAMING PLAN -
TYPICAL
LOW-RISE

Project No.: 211157	B-SCAN Sheet No.: S-116.00
Date: 20 JUN 2014	Sheet No.: S-116
Scale: 1/8" = 1'-0"	Page No.: 24 of 90
File No.: S-116	

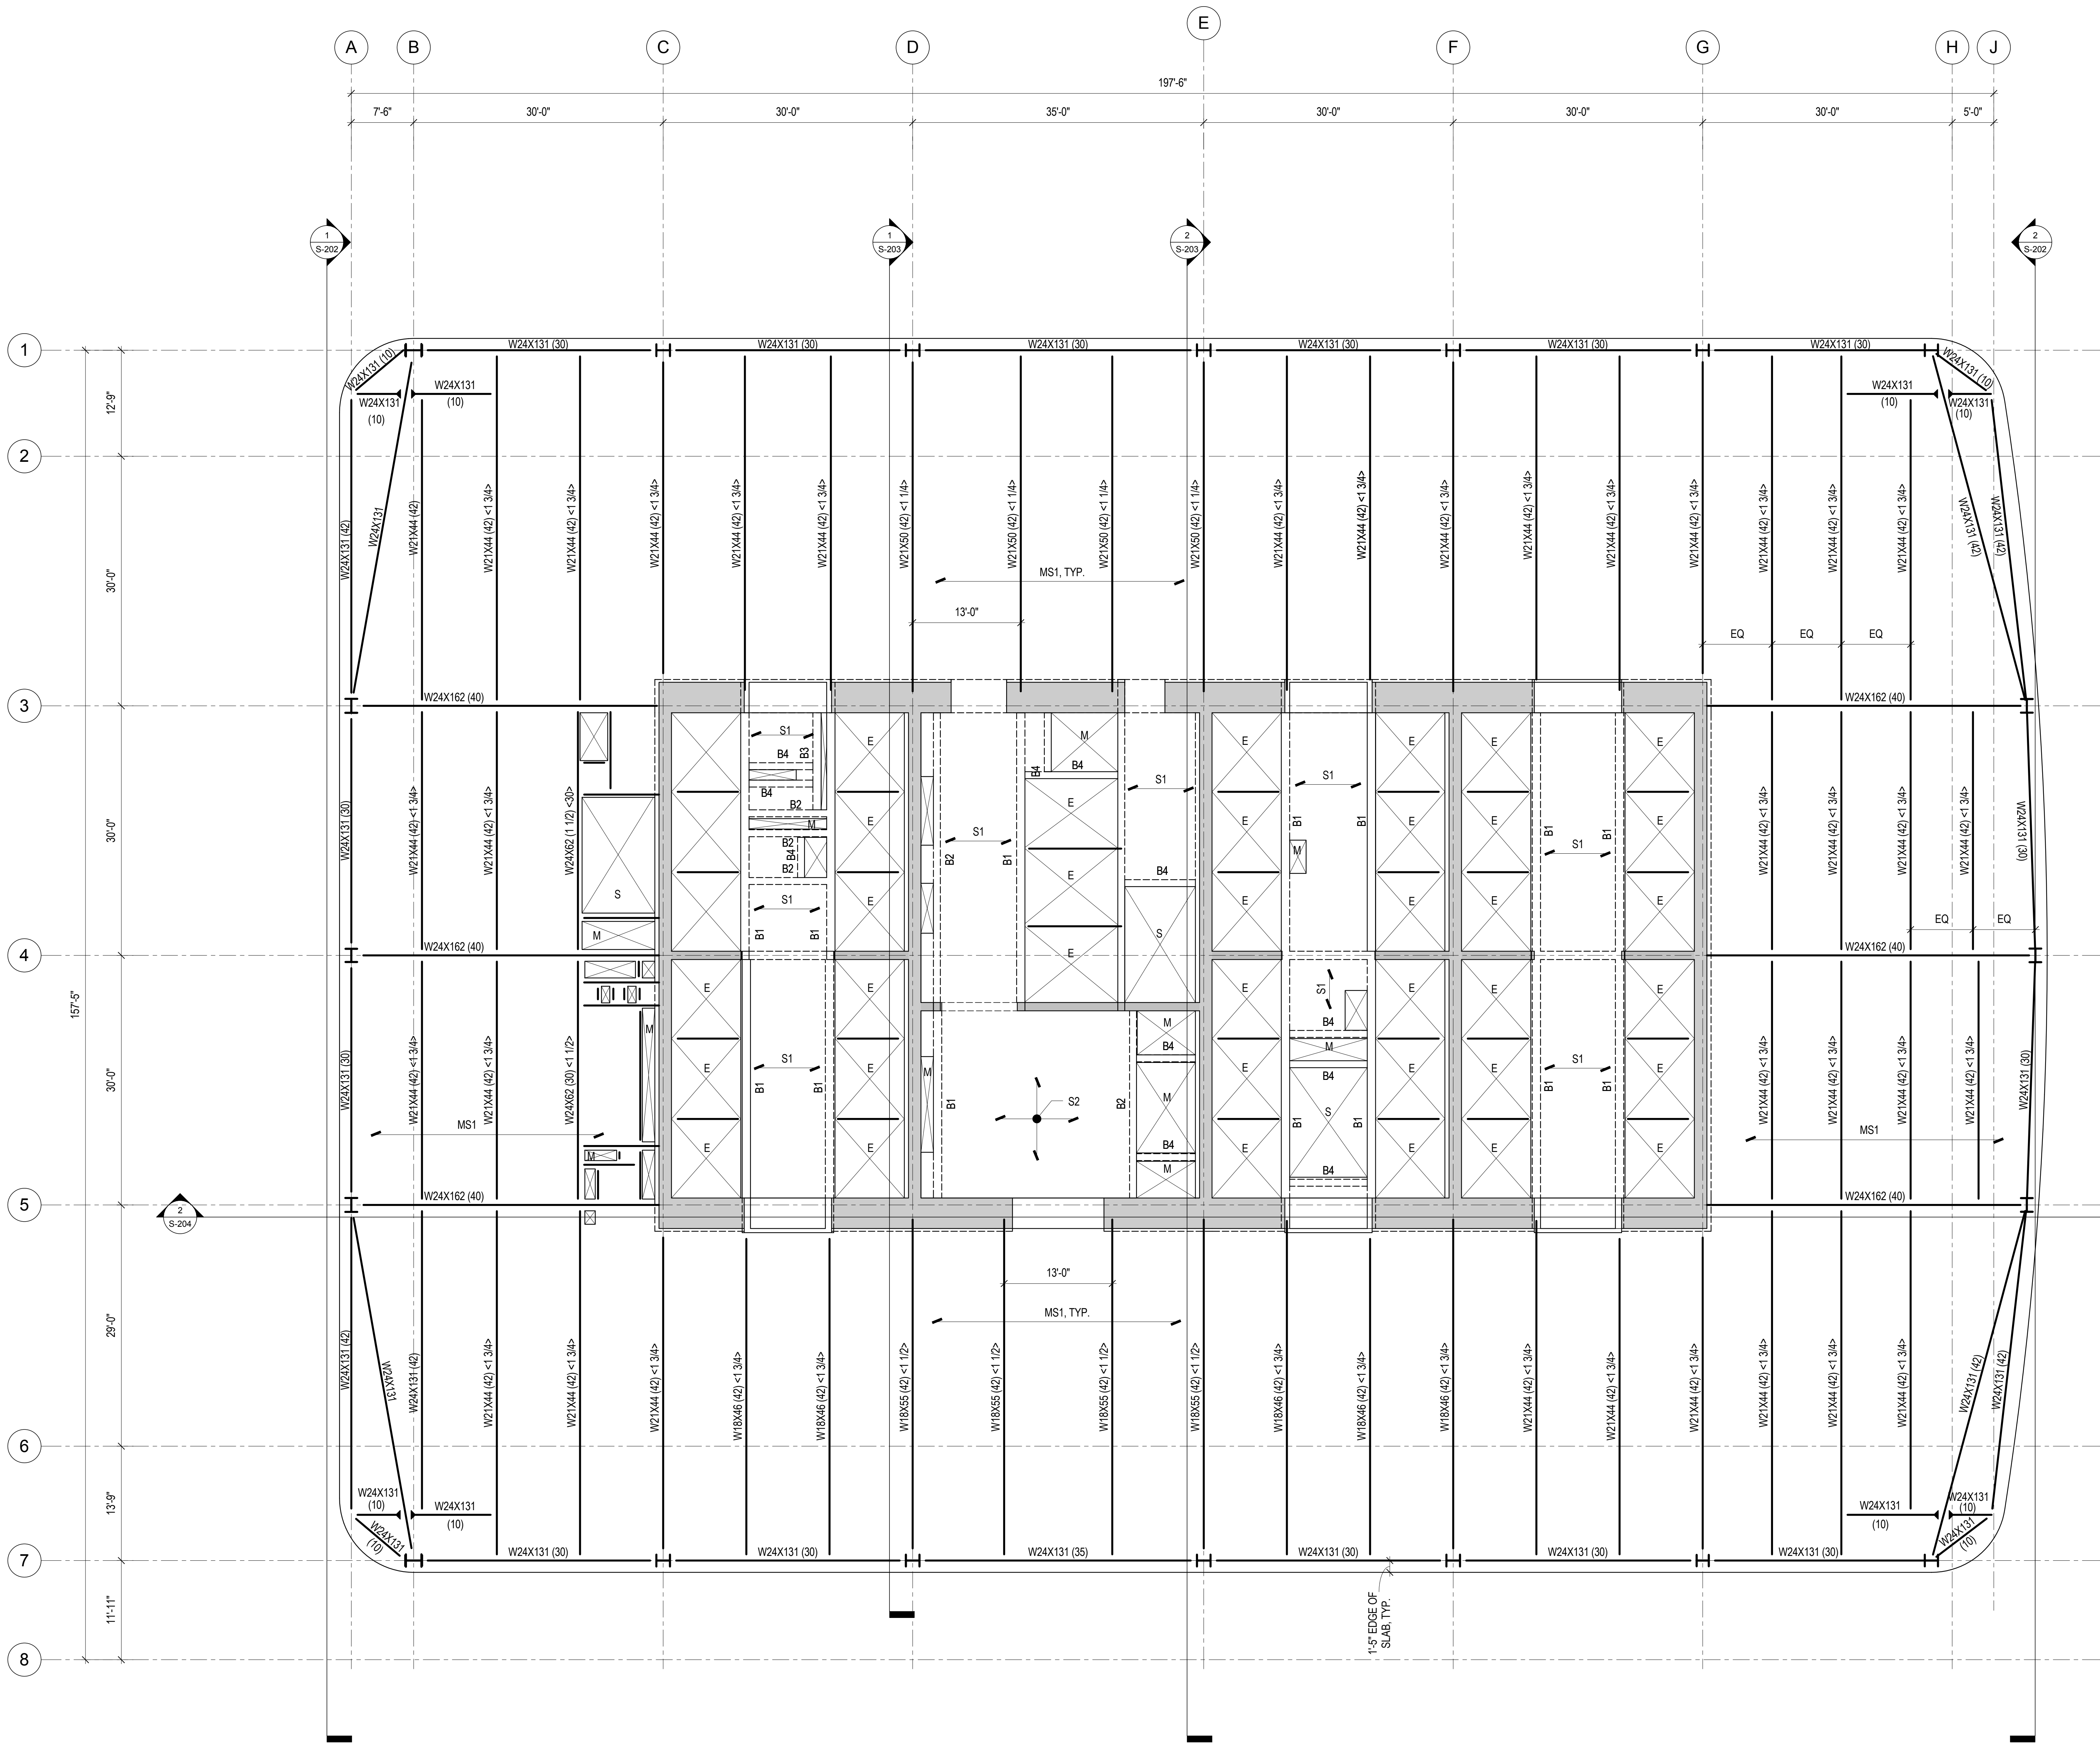



15. REFER TO SHEETS S-320 THROUGH S-322 FOR FOUNDATION WALL ELEVATIONS, SECTIONS AND DETAILS.
16. REFER TO SHEET S-330 FOR SLAB-ON-GRADE SECTIONS AND DETAILS.
17. REFER TO SHEET S-350 FOR REINFORCED CONCRETE CORE WALL SCHEDULE, SECTIONS AND DETAILS.
18. REFER TO SHEET S-351 FOR TYPICAL REINFORCED CONCRETE WALL DETAILS.
19. REFER TO SHEET S-355 FOR LINK BEAM SCHEDULES, SECTIONS AND DETAILS.
20. REFER TO SHEETS S-360 THROUGH S-369 FOR CORE WALL ELEVATIONS.
21. REFER TO SHEET S-370 FOR REINFORCED CONCRETE BEAM SCHEDULE, SECTIONS AND DETAILS.
22. REFER TO SHEET S-375 FOR REINFORCED CONCRETE SLAB SCHEDULE, SECTIONS AND DETAILS.
23. REFER TO SHEET S-380 FOR STAIR AND LIFT SCHEDULES, SECTIONS AND DETAILS.
24. REFER TO DRAWINGS PREPARED BY TENTATIVE FOR ADJACENT PLATFORM STRUCTURE.
25. REFER TO SHEET S-501 FOR METAL DECK SLAB SCHEDULES, SECTIONS & DETAILS.



MANHATTAN WEST:
NORTH TOWER
375 Ninth Avenue, New York, NY 10001
Client

Brookfield
250 Vesey Street, 15th Floor, New York, NY 10021

Architecture/Structural Engineering
SOM
Skidmore, Owings & Merrill LLP
14 Wall Street, New York, NY 10005

Civil Engineering
Philip Habib & Associates
102 Madison Avenue #11, New York, NY 10016
MEP Engineering
Jaros Baum & Bolles
80 Pine Street, New York, NY 10005

Vertical Transportation
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102 East 8th Street, Suite 1, Mill Valley, California 94941

Sustainable Design
Viridian Energy & Environmental
50 Washington Street, Newark, CT 06854
Geo-Technical Engineering
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Code Consultant
Code Consultants Professional Engineers PC
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Wind Tunnel Consultant
Rowan Williams Davies & Irwin Inc.
650 Woodlawn Road West, Guelph
Ontario, Canada N1K 1B6


Professional Engineer
Charles Michael Bell
079322
Professional Engineer

Key Plan:
33RD STREET
DYER AVENUE
31ST STREET
9TH AVENUE

Seal & Signature:
PRELIMINARY
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Project No.: 211157
Date: 20 JUN 2014
Scale: 1/8" = 1'-0"
File No.: S-137

B-S-CAN Sheet No.: S-137.00
Sheet No.: S-137
Page No.: 26 of 90

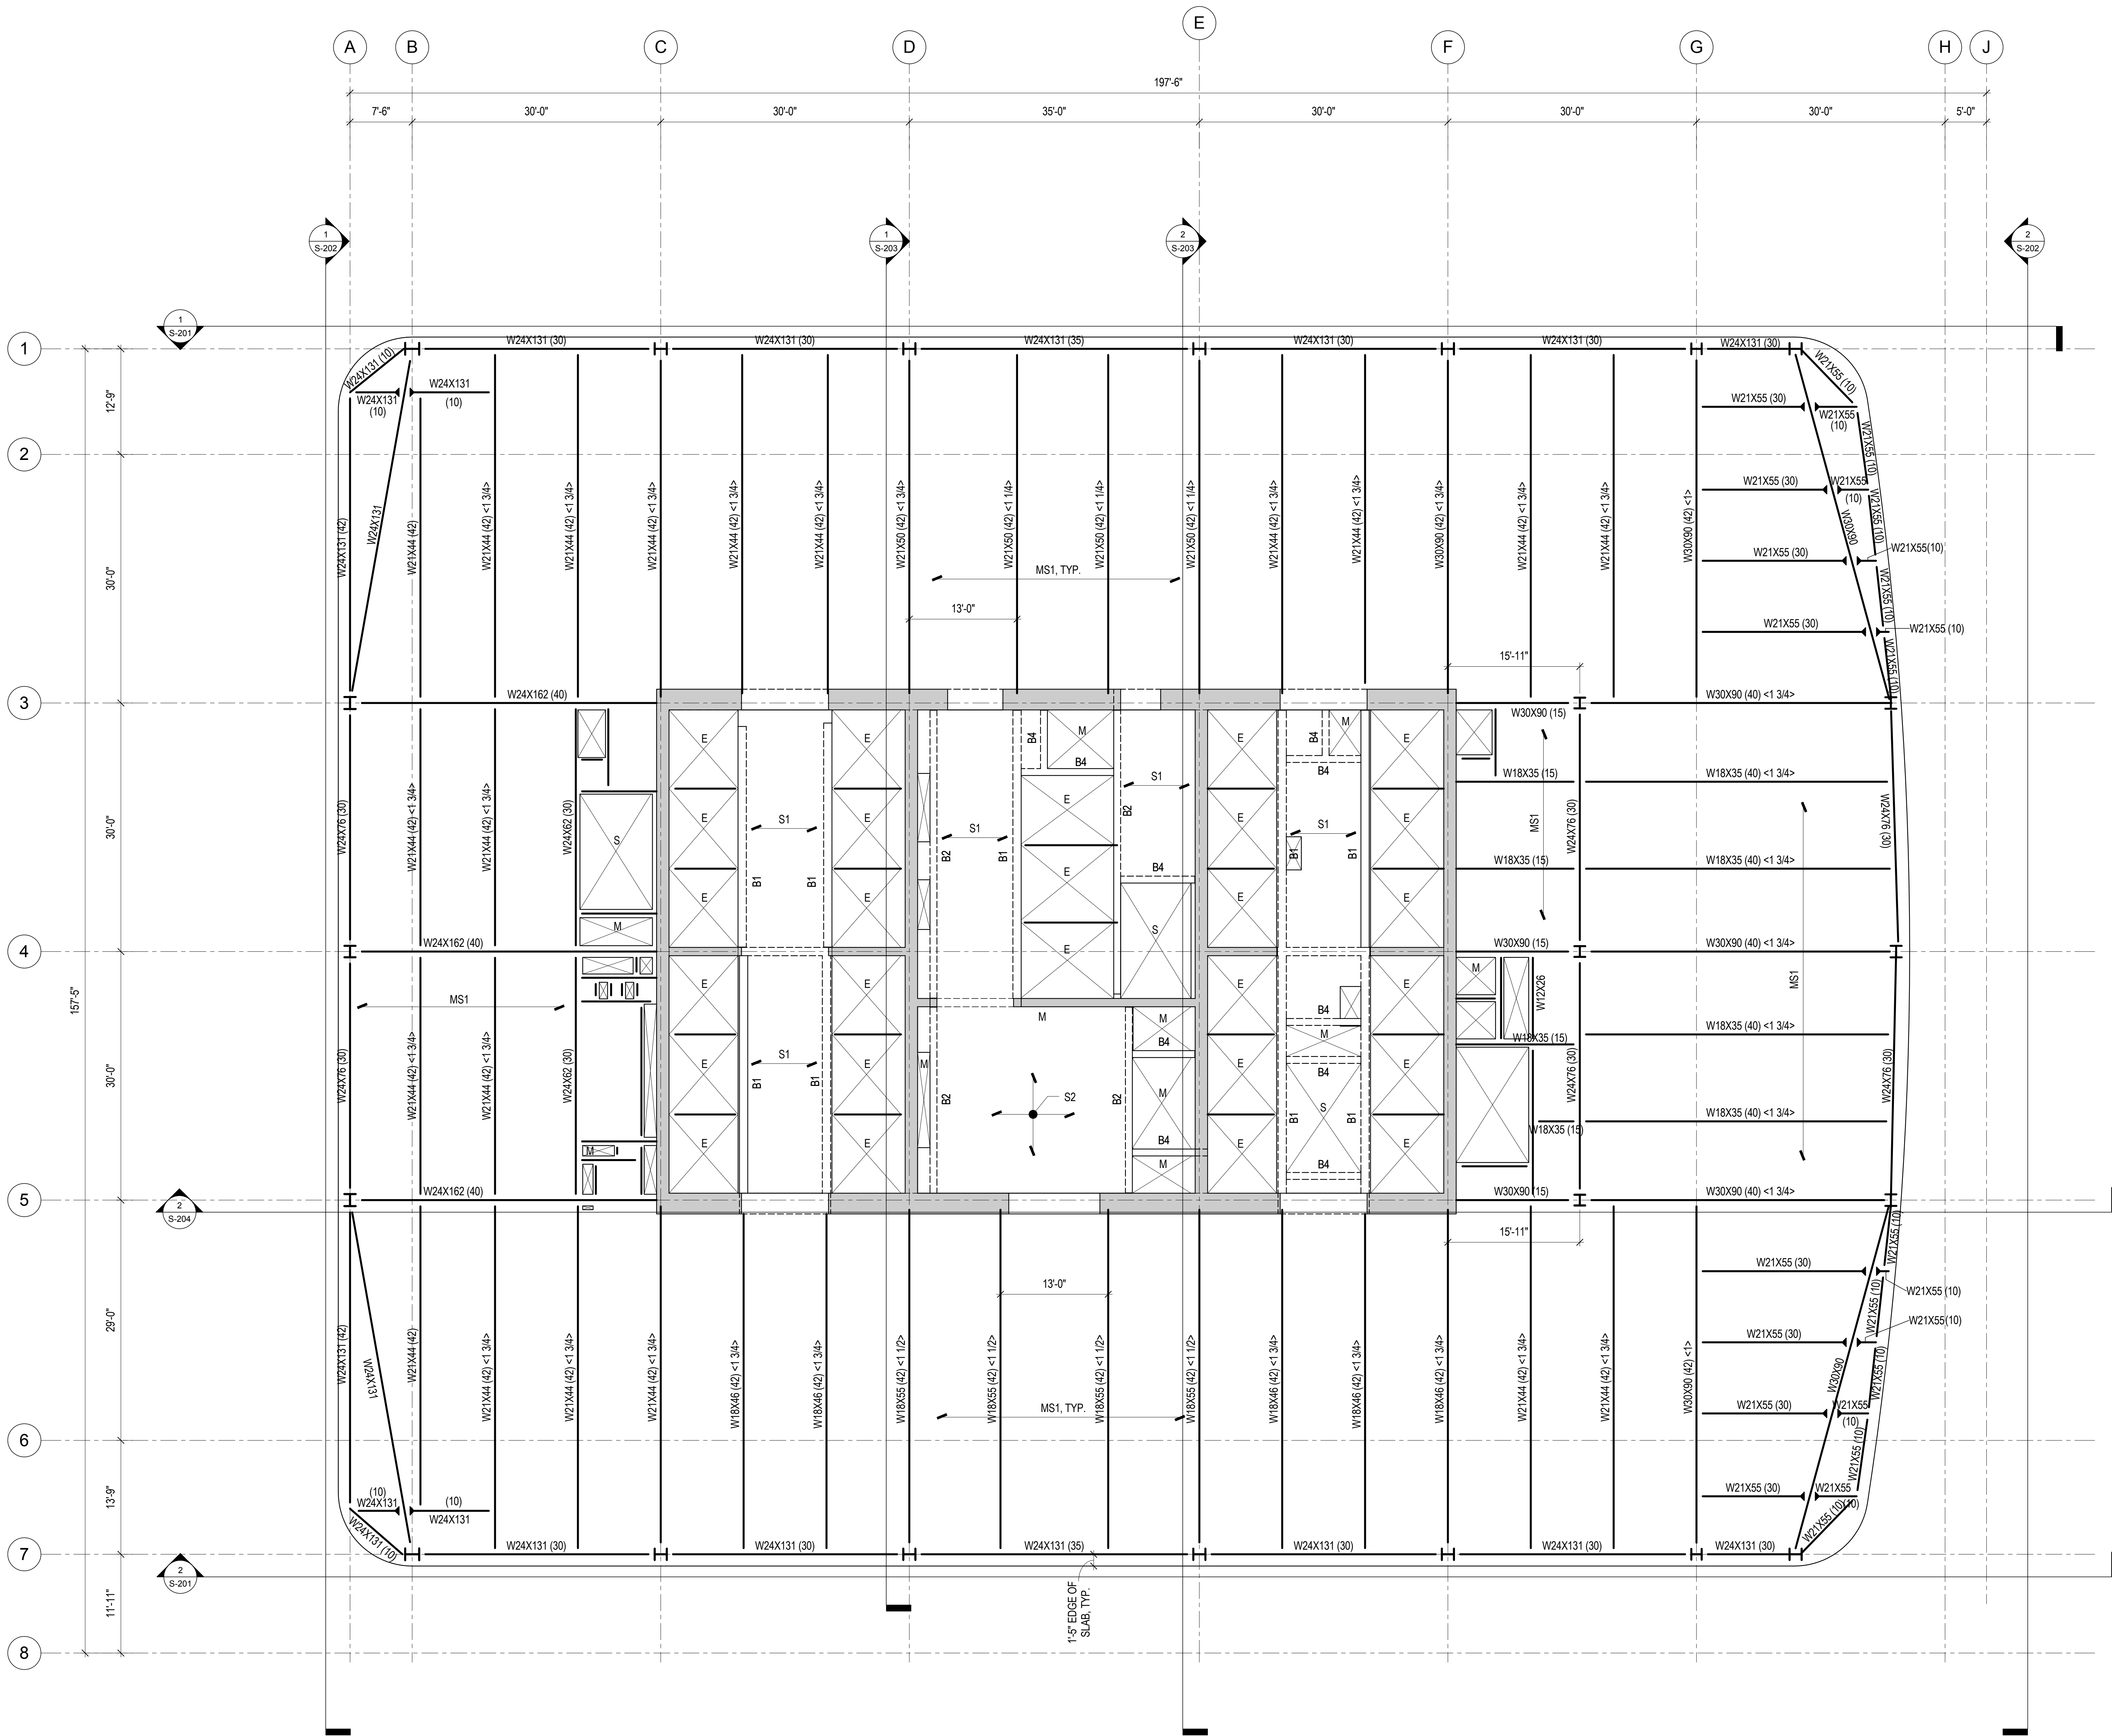

1 37TH FLOOR FRAMING PLAN - TYPICAL MID-RISE
1/8" = 1'-0"

1. TOP OF SLAB ELEVATION = 556'-0", UNLESS NOTED OTHERWISE.
2. TOP OF STEEL ELEVATION = 556'-6 1/2" UNLESS NOTED OTHERWISE BY {X'-X"} OR {X'-X"}, WHICH DENOTE POSITIVE OR NEGATIVE VERTICAL OFFSET, RESPECTIVELY.
3. BEAMS SHALL BE LOCATED ON GRID CENTERLINES WHEN NO DIMENSIONS SHOWN.
4. BEAMS SHALL BE EQUALLY SPACED BETWEEN GRIDS/BAYS WHEN NO DIMENSIONS SHOWN.
5. SLAB EDGE DIMENSION AT OPENING = 8", UNLESS NOTED OTHERWISE.
6. REFER TO SHEET S-002 FOR EXCAVATION AND FOUNDATION NOTES.
7. REFER TO SHEET S-003 FOR STRUCTURAL STEEL AND METAL DECK NOTES.
8. REFER TO SHEET S-004 FOR STRUCTURAL STEEL AND METAL DECK NOTES.
9. REFER TO SHEET S-005 FOR STRUCTURAL STEEL AND METAL DECK NOTES.
10. REFER TO SHEET S-006 FOR STRUCTURAL STEEL AND METAL DECK NOTES.
11. REFER TO SHEET S-007 FOR STRUCTURAL STEEL AND METAL DECK NOTES.
12. REFER TO SHEET S-008 FOR STRUCTURAL STEEL AND METAL DECK NOTES.
13. REFER TO SHEET S-009 FOR STRUCTURAL STEEL AND METAL DECK NOTES.
14. REFER TO SHEET S-010 FOR STRUCTURAL STEEL AND METAL DECK NOTES.
15. REFER TO SHEETS S-320 THROUGH S-322 FOR FOUNDATION WALL ELEVATIONS, SECTIONS AND DETAILS.
16. REFER TO SHEET S-330 FOR SLAB-ON-GRADE SECTIONS AND DETAILS.
17. REFER TO SHEET S-350 FOR REINFORCED CONCRETE CORE WALL SCHEDULE, SECTIONS AND DETAILS.
18. REFER TO SHEET S-351 FOR TYPICAL REINFORCED CONCRETE WALL DETAILS.
19. REFER TO SHEET S-355 FOR LINK BEAM SCHEDULES, SECTIONS AND DETAILS.
20. REFER TO SHEETS S-360 THROUGH S-368 FOR CORE WALL ELEVATIONS.
21. REFER TO SHEET S-370 FOR REINFORCED CONCRETE BEAM SCHEDULE, SECTIONS AND DETAILS.
22. REFER TO SHEET S-375 FOR REINFORCED CONCRETE SLAB SCHEDULE, SECTIONS AND DETAILS.
23. REFER TO SHEET S-401 FOR STRUCTURAL STEEL COLUMN SCHEDULE, SECTIONS AND DETAILS.
24. REFER TO DRAWINGS PREPARED BY ENTITLED FOR ADJACENT PLATFORM STRUCTURE.
25. REFER TO SHEET S-501 FOR METAL DECK SLAB SCHEDULES, SECTIONS & DETAILS.



- 53RD FLOOR
FRAMING PLAN -
HIGH-RISE



- [illegible]



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375 Ninth Avenue, New York, NY 10001

Client
Brookfield

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Vibration Consultant
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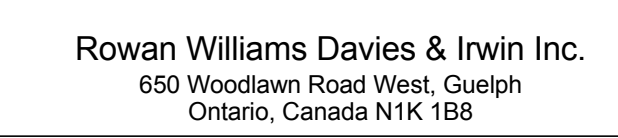
Code Consultant
Code Consultants Professional Engineers PC
215 West 40th Street, 15th Floor, New York, NY 10018

Facade Maintenance Consultant
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166 Ames Street, Hackensack, NJ 07601

Wind Tunnel Consultant
Rowan Williams Davies & Irwin Inc.
650 Woodlawn Road West, Guelph
Ontario, Canada N1K 1B6

Professional Engineer
Charles Michael Bell
079322

Key Plan:



Seal & Signature:


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Date: 20 JUN 2014
Scale: 1/8" = 1'-0"
File No.: S-168

Sheet Name: 68TH FLOOR FRAMING PLAN - MECHANICAL


Project No.: 211557
Date: 20 JUN 2014
Scale: 1/8" = 1'-0"
File No.: S-168

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Page No.: 29 of 90

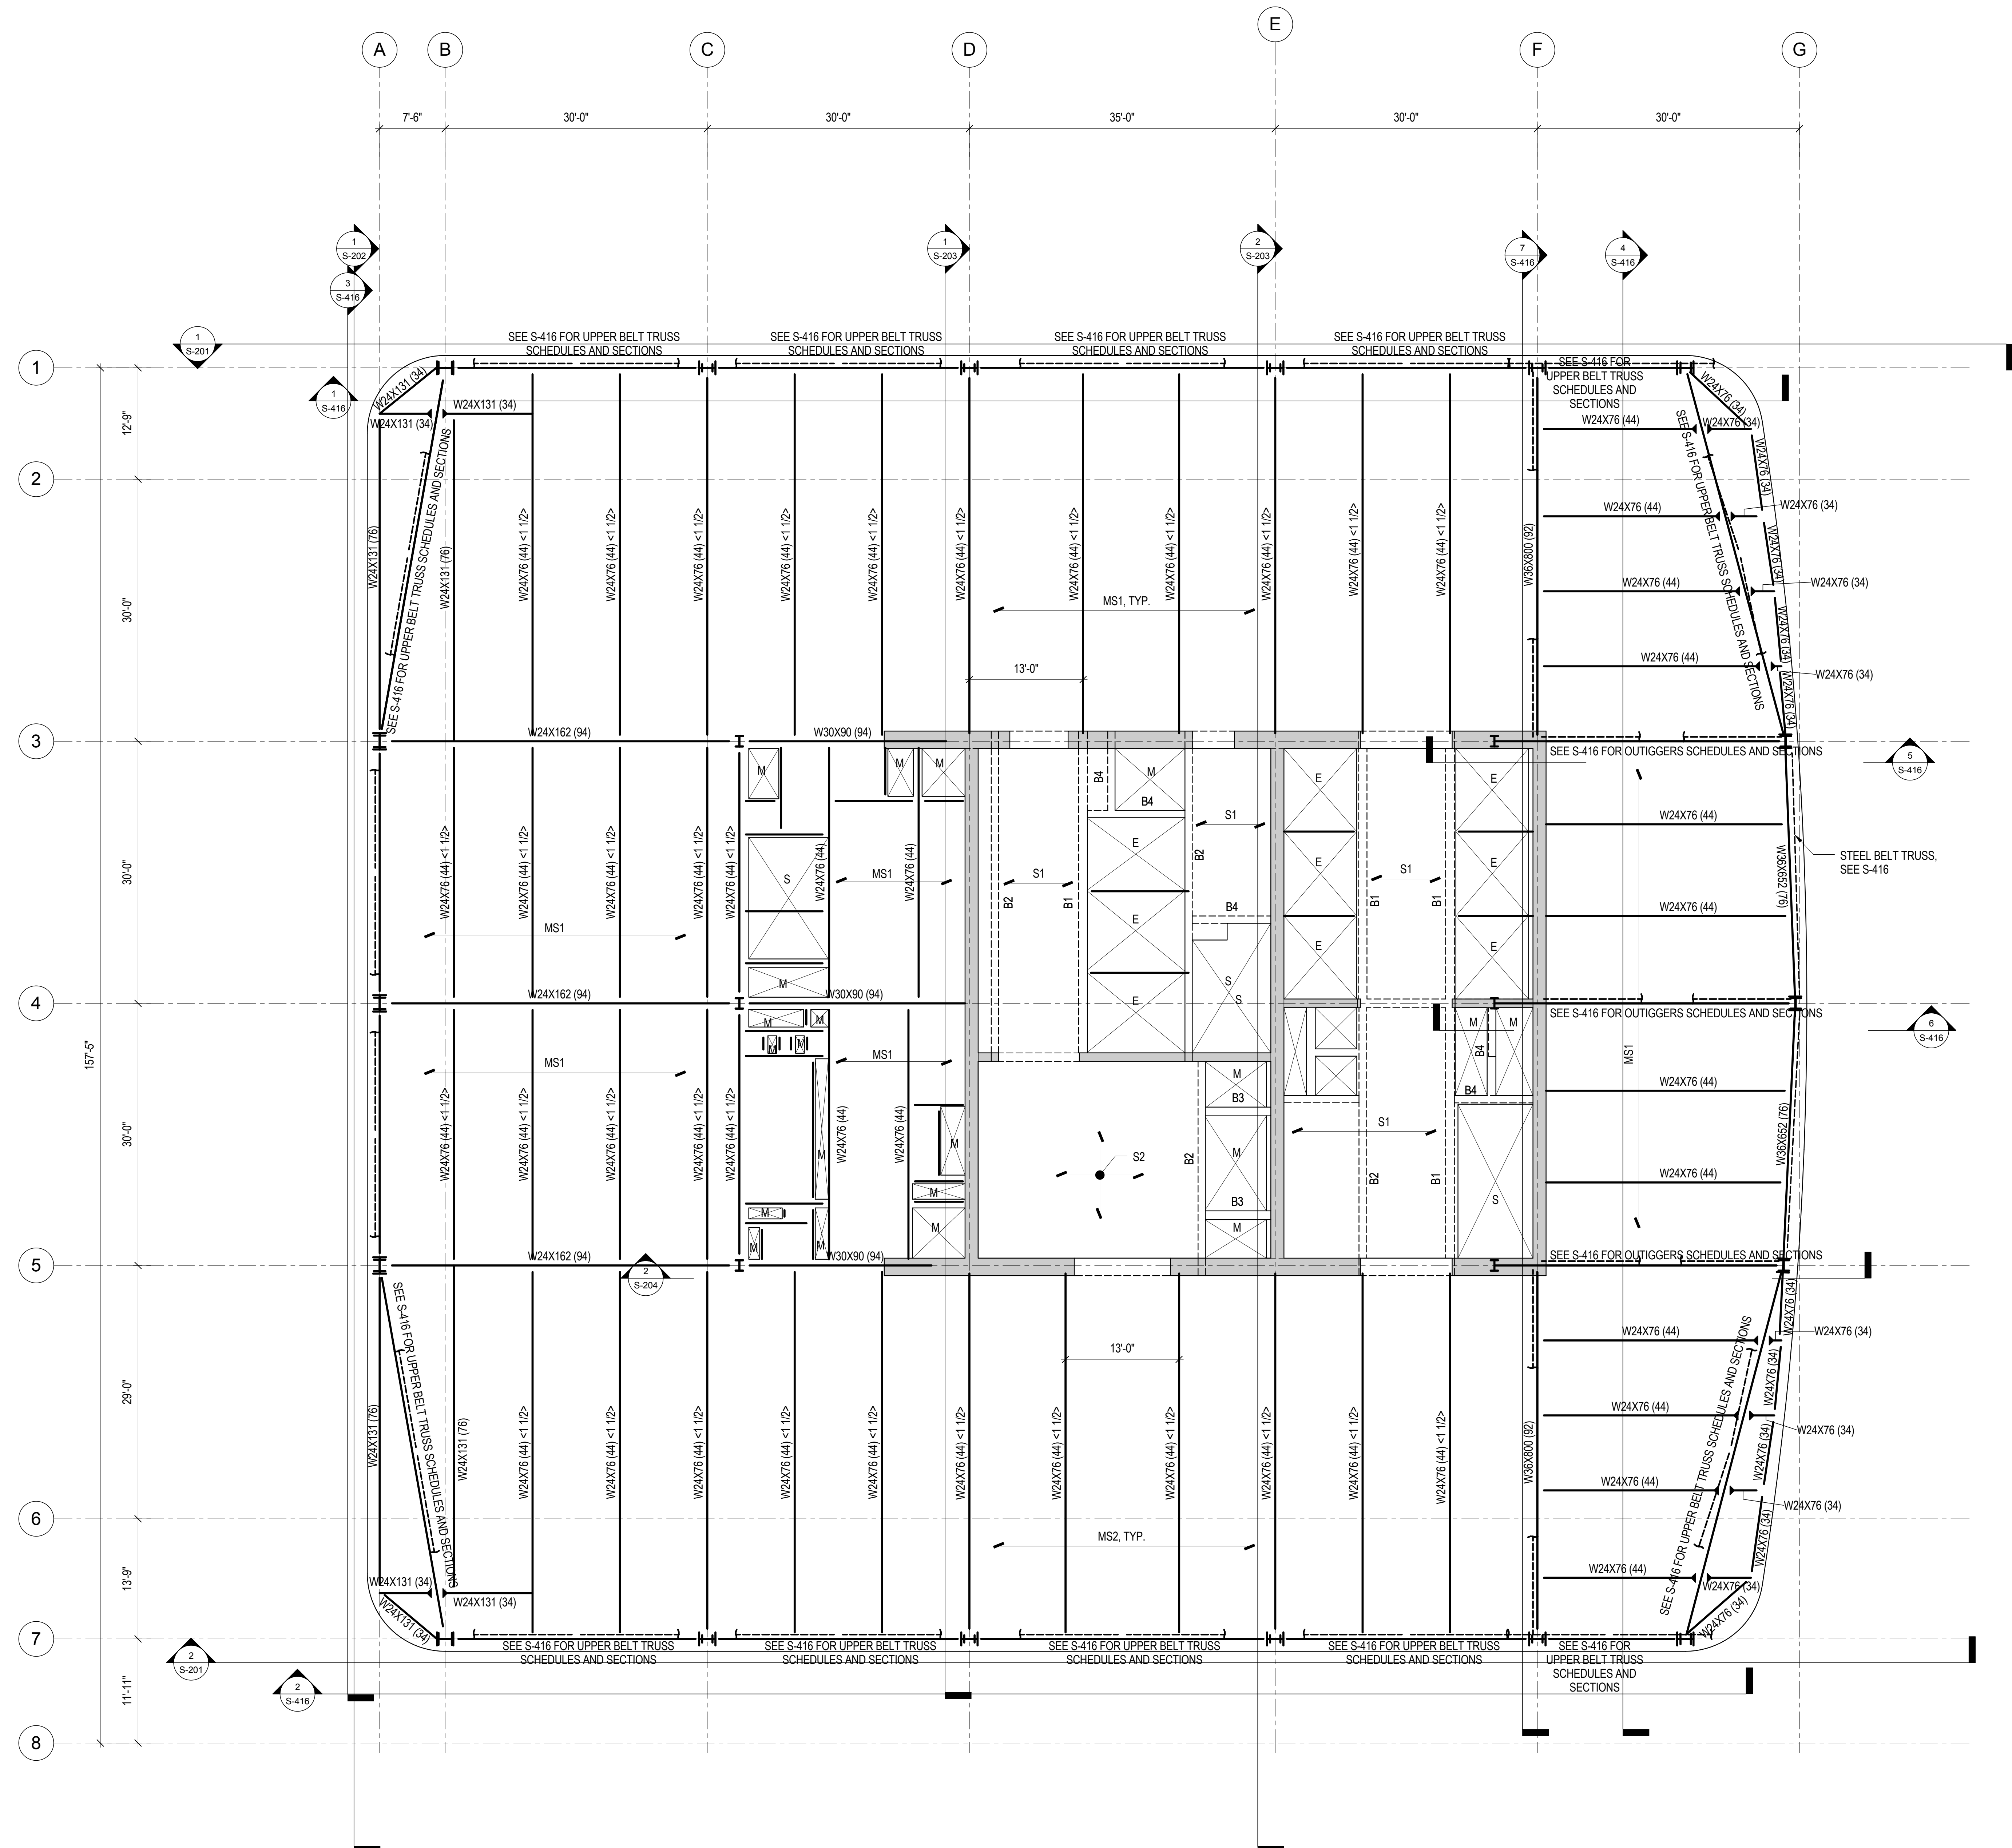

1 68TH FLOOR FRAMING PLAN - MECHANICAL
1/8" = 1'-0"

1. TOP OF SLAB ELEVATION = 842'-6", UNLESS NOTED OTHERWISE.
2. TOP OF STEEL ELEVATION = 848'-7", UNLESS NOTED OTHERWISE BY (+X'-X") OR (-X'-X"), WHICH DENOTE POSITIVE OR NEGATIVE VERTICAL OFFSET, RESPECTIVELY.
3. BEAMS SHALL BE LOCATED ON GRID CENTERLINES WHEN NO DIMENSIONS SHOWN.
4. BEAMS SHALL BE EQUALLY SPACED BETWEEN GRIDS/BAYS WHEN NO DIMENSIONS SHOWN.
5. SLAB EDGE DIMENSION AT OPENING = 8", UNLESS NOTED OTHERWISE.
6. REFER TO SHEET S-002 FOR STRUCTURAL SYMBOLS AND ABBREVIATIONS.
7. REFER TO SHEET S-003 FOR EXCAVATION AND FOUNDATION NOTES.
8. REFER TO SHEET S-004 FOR STRUCTURAL CONCRETE NOTES.
9. REFER TO SHEET S-005 FOR STRUCTURAL STEEL AND METAL DECK NOTES.
10. REFER TO SHEETS S-201 THROUGH S-204 FOR OVERALL BUILDING ELEVATIONS AND SECTIONS.
11. REFER TO SHEETS S-301 AND S-302 FOR CORE WALL CONTINUOUS FOOTINGS SECTIONS AND DETAILS.
12. REFER TO SHEET S-305 FOR CAISSON SCHEDULE, SECTIONS AND DETAILS.
13. REFER TO SHEET S-315 FOR SPREAD FOOTING SCHEDULE, SECTIONS AND DETAILS.
14. REFER TO SHEET S-316 FOR GRADE BEAM SCHEDULE, SECTIONS AND DETAILS.
15. REFER TO SHEETS S-320 THROUGH S-322 FOR FOUNDATION WALL ELEVATIONS, SECTIONS AND DETAILS.
16. REFER TO SHEET S-330 FOR SLAB-ON-GRADE SECTIONS AND DETAILS.
17. REFER TO SHEET S-350 FOR REINFORCED CONCRETE CORE WALL SCHEDULE, SECTIONS AND DETAILS.
18. REFER TO SHEET S-351 FOR TYPICAL REINFORCED CONCRETE WALL DETAILS.
19. REFER TO SHEET S-355 FOR LINK BEAM SCHEDULES, SECTIONS AND DETAILS.
20. REFER TO SHEETS S-360 THROUGH S-368 FOR CORE WALL ELEVATIONS.
21. REFER TO SHEET S-370 FOR REINFORCED CONCRETE BEAM SCHEDULE, SECTIONS AND DETAILS.
22. REFER TO SHEET S-375 FOR REINFORCED CONCRETE SLAB SCHEDULE, SECTIONS AND DETAILS.
23. REFER TO SHEET S-401 FOR STRUCTURAL STEEL COLUMN SCHEDULE, SECTIONS AND DETAILS.
24. REFER TO DRAWINGS PREPARED BY ENTITLED FOR ADJACENT PLATFORM STRUCTURE.
25. REFER TO SHEET S-501 FOR METAL DECK SLAB SCHEDULES, SECTIONS & DETAILS.

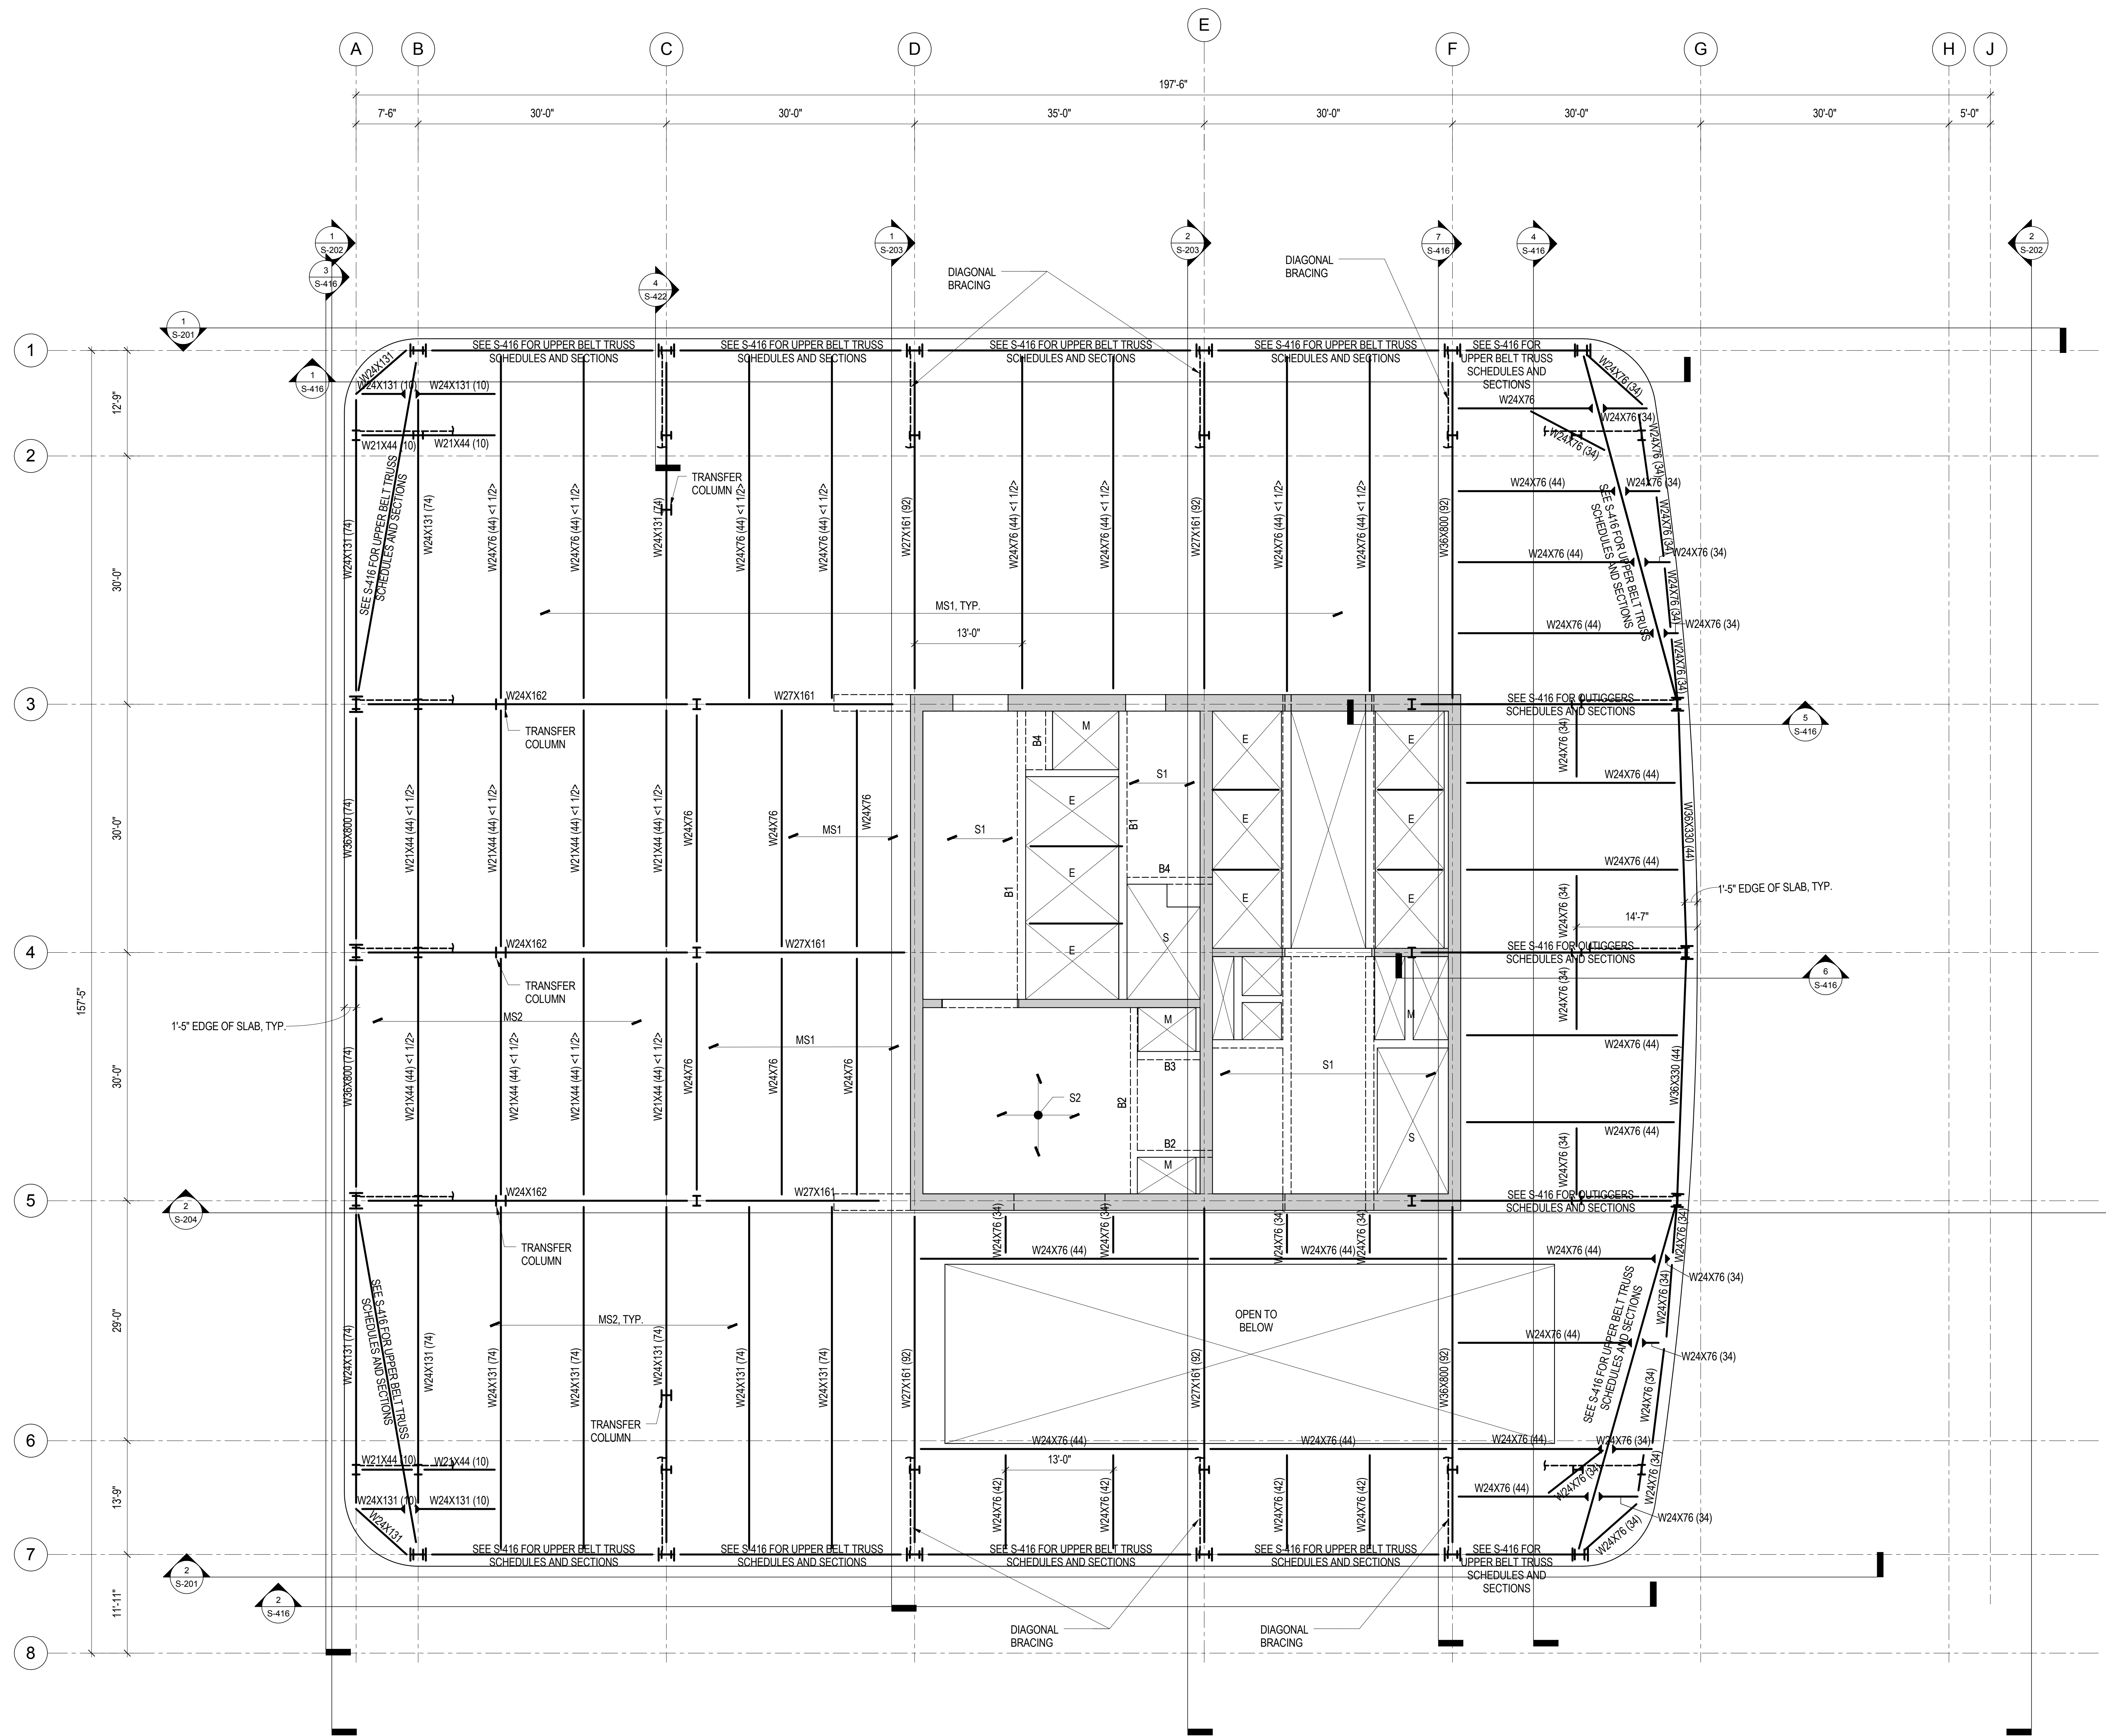

1 69TH FLOOR FRAMING PLAN - MECHANICAL MEZZANINE
1/8" = 1'-0"

1. TOP OF SLAB ELEVATION = 969'-10" UNLESS NOTED OTHERWISE.
2. TOP OF STEEL ELEVATION = 969' - 11" UNLESS NOTED OTHERWISE BY (+X'-X") OR (X'-X") WHICH DENOTE POSITIVE OR NEGATIVE VERTICAL OFFSET, RESPECTIVELY.
3. BEAMS SHALL BE LOCATED ON GRID CENTERLINES WHEN NO DIMENSIONS SHOWN.
4. BEAMS SHALL BE EQUALLY SPACED BETWEEN GRIDS/BAYS WHEN NO DIMENSIONS SHOWN.
5. SLAB EDGE DIMENSION AT OPENING = 8" UNLESS NOTED OTHERWISE.
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8. REFER TO SHEET S-004 FOR CAISSON SCHEDULE, SECTIONS AND DETAILS.
9. REFER TO SHEET S-005 FOR SPREAD FOOTING SCHEDULE, SECTIONS AND DETAILS.
10. REFER TO SHEET S-006 FOR GRADE BEAM SCHEDULE, SECTIONS AND DETAILS.
11. REFER TO SHEETS S-301 THROUGH S-304 FOR OVERALL BUILDING ELEVATIONS AND SECTIONS.
12. REFER TO SHEETS S-301 AND S-302 FOR CORE WALL CONTINUOUS FOOTINGS SECTIONS AND DETAILS.
13. REFER TO SHEET S-305 FOR CAISSON SCHEDULE, SECTIONS AND DETAILS.
14. REFER TO SHEET S-316 FOR GRADE BEAM SCHEDULE, SECTIONS AND DETAILS.
15. REFER TO SHEETS S-320 THROUGH S-322 FOR FOUNDATION WALL ELEVATIONS, SECTIONS AND DETAILS.
16. REFER TO SHEET S-330 FOR SLAB-ON-GRADE SECTIONS AND DETAILS.
17. REFER TO SHEET S-350 FOR REINFORCED CONCRETE CORE WALL SCHEDULE, SECTIONS AND DETAILS.
18. REFER TO SHEET S-351 FOR TYPICAL REINFORCED CONCRETE WALL DETAILS.
19. REFER TO SHEET S-355 FOR LINK BEAM SCHEDULES, SECTIONS AND DETAILS.
20. REFER TO SHEETS S-360 THROUGH S-368 FOR CORE WALL ELEVATIONS.
21. REFER TO SHEET S-370 FOR REINFORCED CONCRETE BEAM SCHEDULE, SECTIONS AND DETAILS.
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**MANHATTAN WEST:
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Client

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Skidmore, Owings & Merrill LLP
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Civil Engineering

Philip Habib & Associates
102 Madison Avenue #11, New York, NY 10016
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166 Ames Street, Hackensack, NJ 07601
Wind Tunnel Consultant

Rowan Williams Davies & Irwin Inc.
650 Woodlawn Road West, Guelph
Ontario, Canada N1K 1B6

Key Plan:

Seal & Signature:

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3	15 NOV 2013	ISSUED FOR 20% PROGRESS PRICING
2	12 JUL 2013	ISSUED FOR 60% DESIGN DEVELOPMENT
1	18 MAR 2012	ISSUED FOR RECONCILIATION

Project No.: 211157
Date: 20 JUN 2014
Scale: 1/8" = 1'-0"
File No.: S-169

B-SCAN Sheet No.: **S-169.00**
Sheet No.: **S-169**
Page No.: 30 of 90



- # ROOF FRAMING PLAN - MECHANICAL PENTHOUSE



MANHATTAN WEST:
NORTH TOWER
375 Ninth Avenue, New York, NY 10001

Client
Brookfield
Brookfield Place
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Architecture/Structural Engineering
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Code Consultants Professional Engineers PC
215 West 40th Street, 15th Floor, New York, NY 10018

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166 Ames Street, Hackensack, NJ 07601

Wind Tunnel Consultant
Rowan Williams Davies & Irwin Inc.
650 Woodlawn Road West, Guelph
Ontario, Canada N1K 1B6


Professional Engineer Seal
CHARLES MICHAEL BELL
079322
Professional Engineer

Key Plan:
Map showing the location of the building on the corner of 31st Street and 9th Avenue, adjacent to 33rd Street and Dyer Avenue.

Seal & Signature:
PRELIMINARY
NOT FOR CONSTRUCTION

Project No.: 21157
Date: 20 JUN 2014
Scale: 1/8" = 1'-0"
File No.: S-171



B-SCAN Sheet No.: S-171.00
Sheet No.: S-171
Page No.: 32 of 90

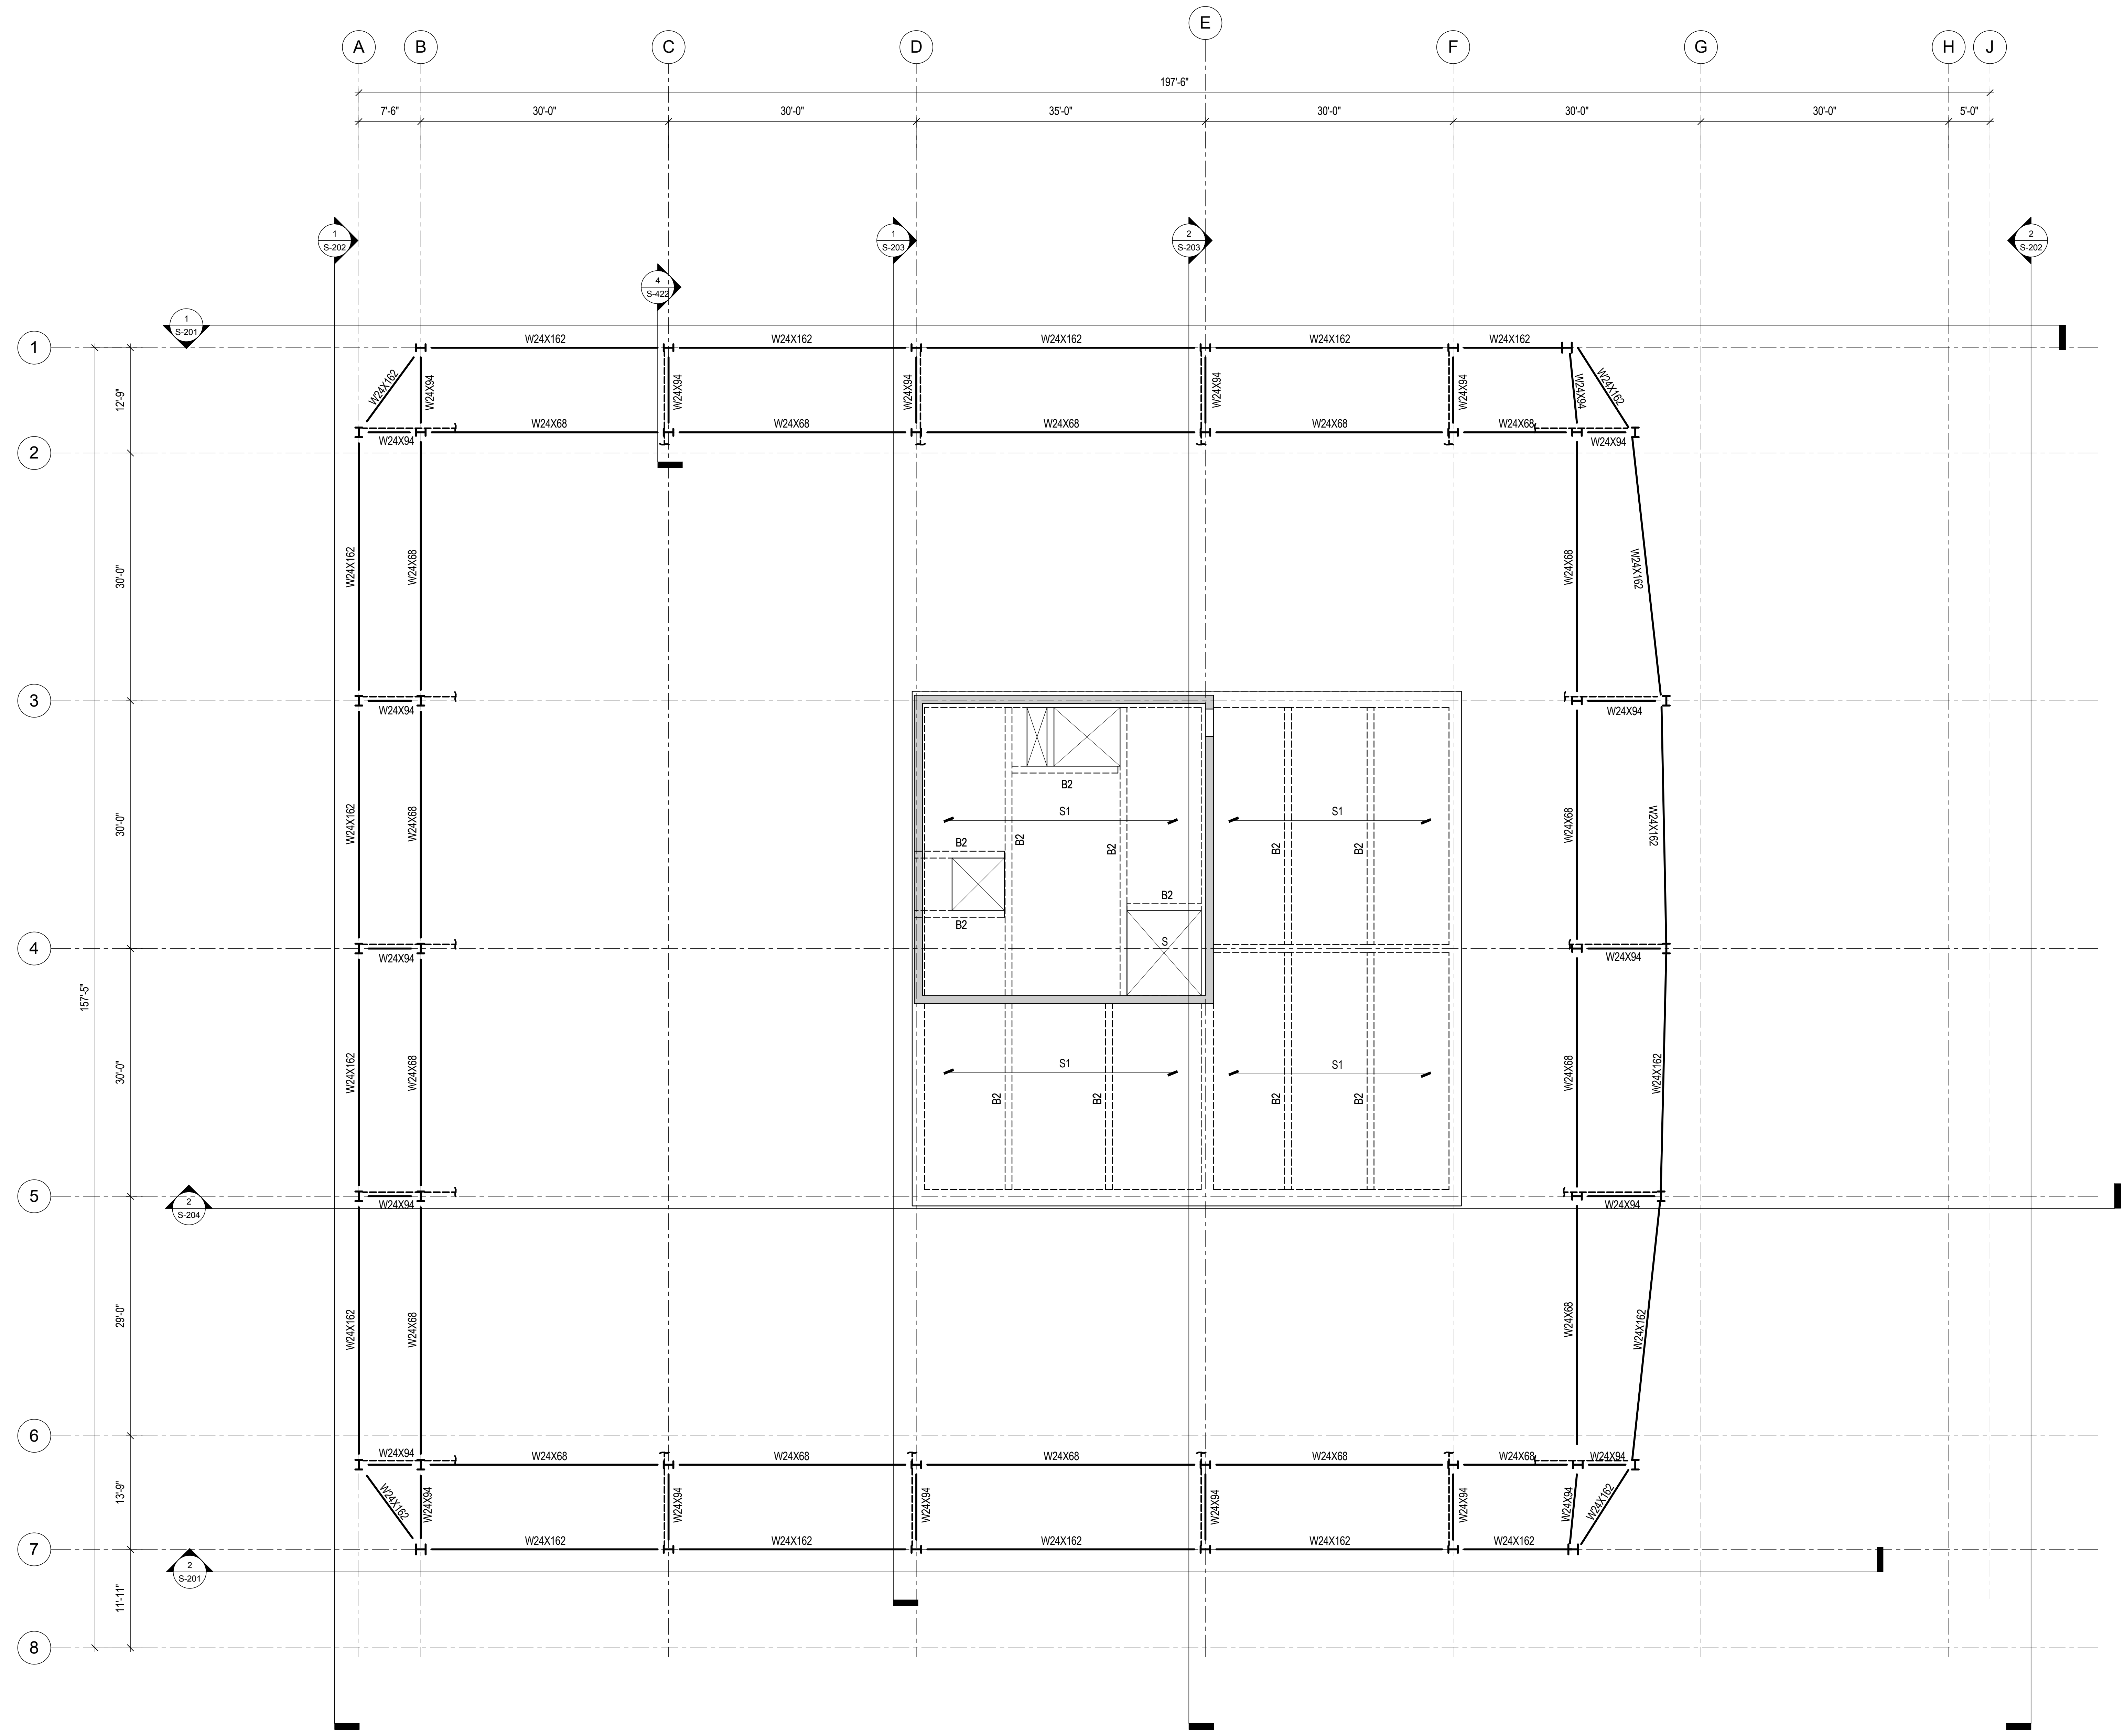

1 ROOF FRAMING PLAN

1/8" = 1'-0"

1. TOP OF SLAB ELEVATION = 996'-0", UNLESS NOTED OTHERWISE.
2. BEAMS SHALL BE LOCATED ON GRID CENTERLINES WHEN NO DIMENSIONS SHOWN.
3. BEAMS SHALL BE EQUALLY SPACED BETWEEN GRIDLINES WHEN NO DIMENSIONS SHOWN.
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8. REFER TO SHEETS S-005 FOR STRUCTURAL STEEL AND METAL DECK NOTES.
9. REFER TO SHEETS S-201 THROUGH S-204 FOR OVERALL BUILDING ELEVATIONS AND SECTIONS.
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Key Plan:

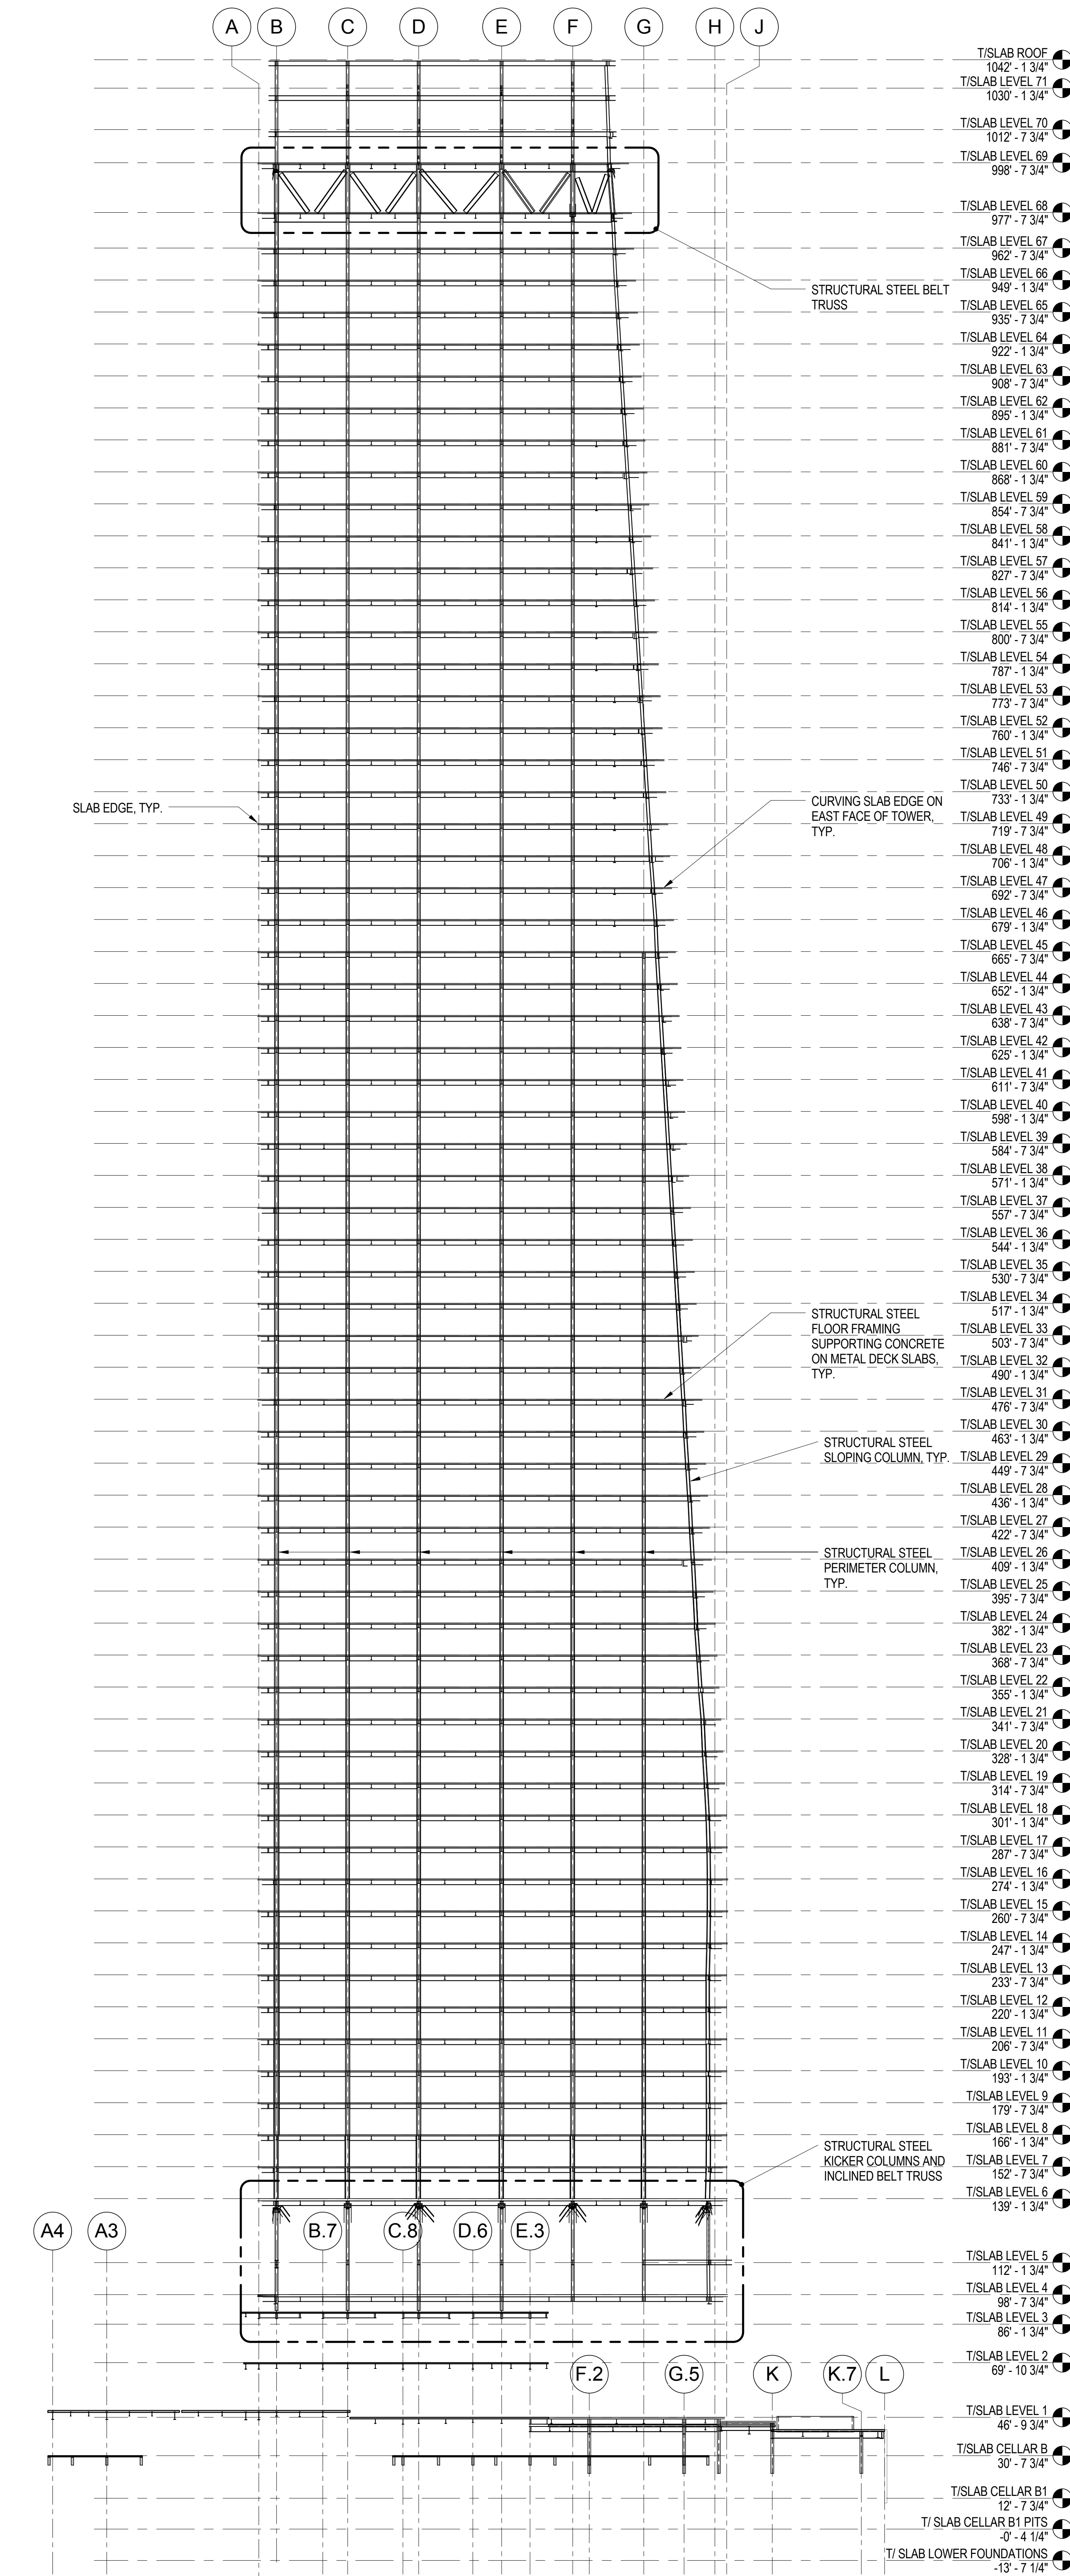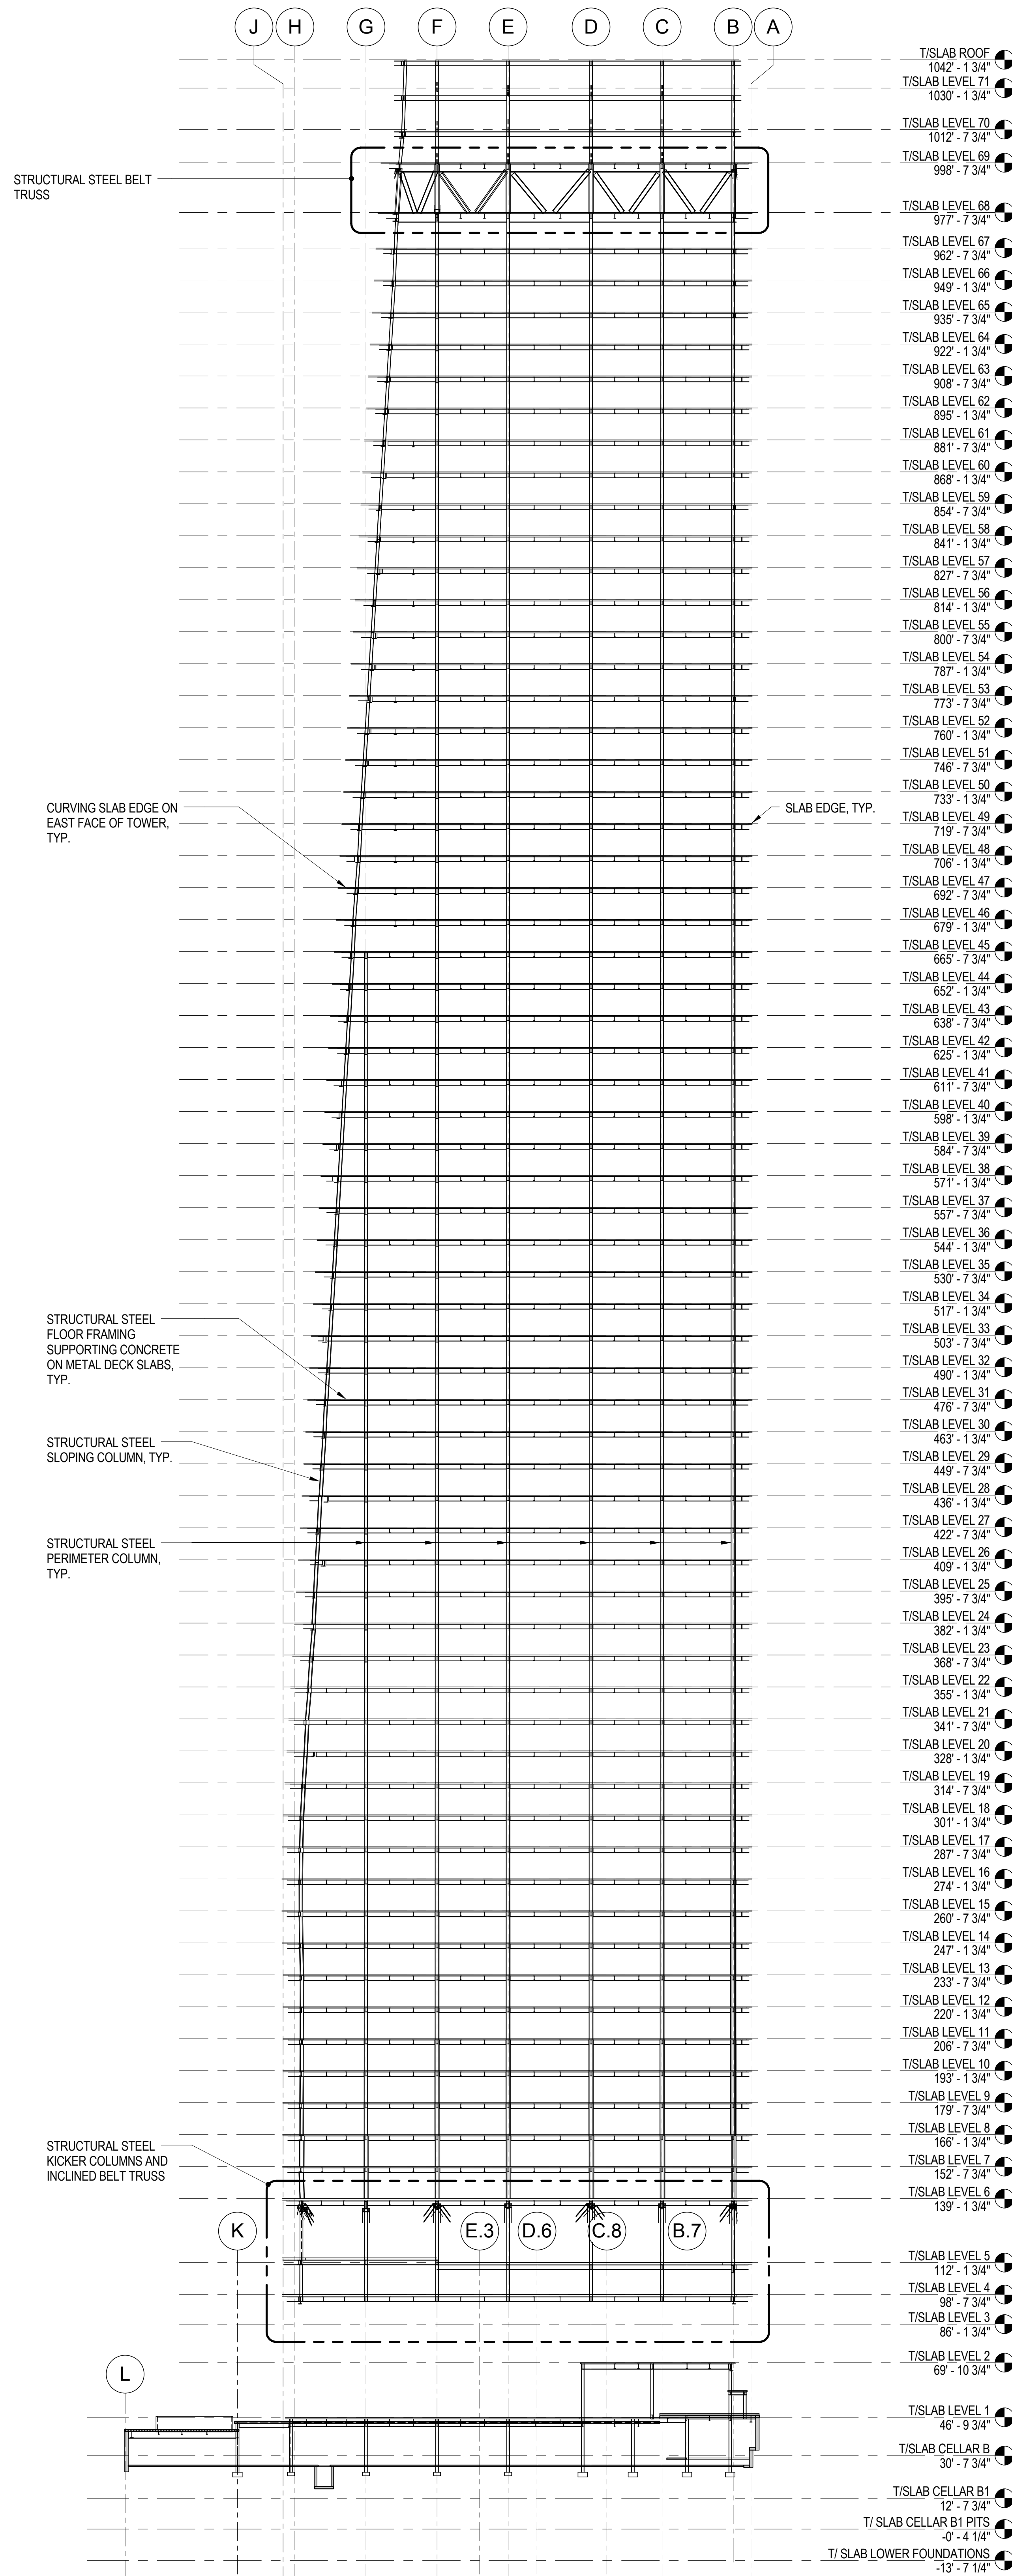Seal & Signature:

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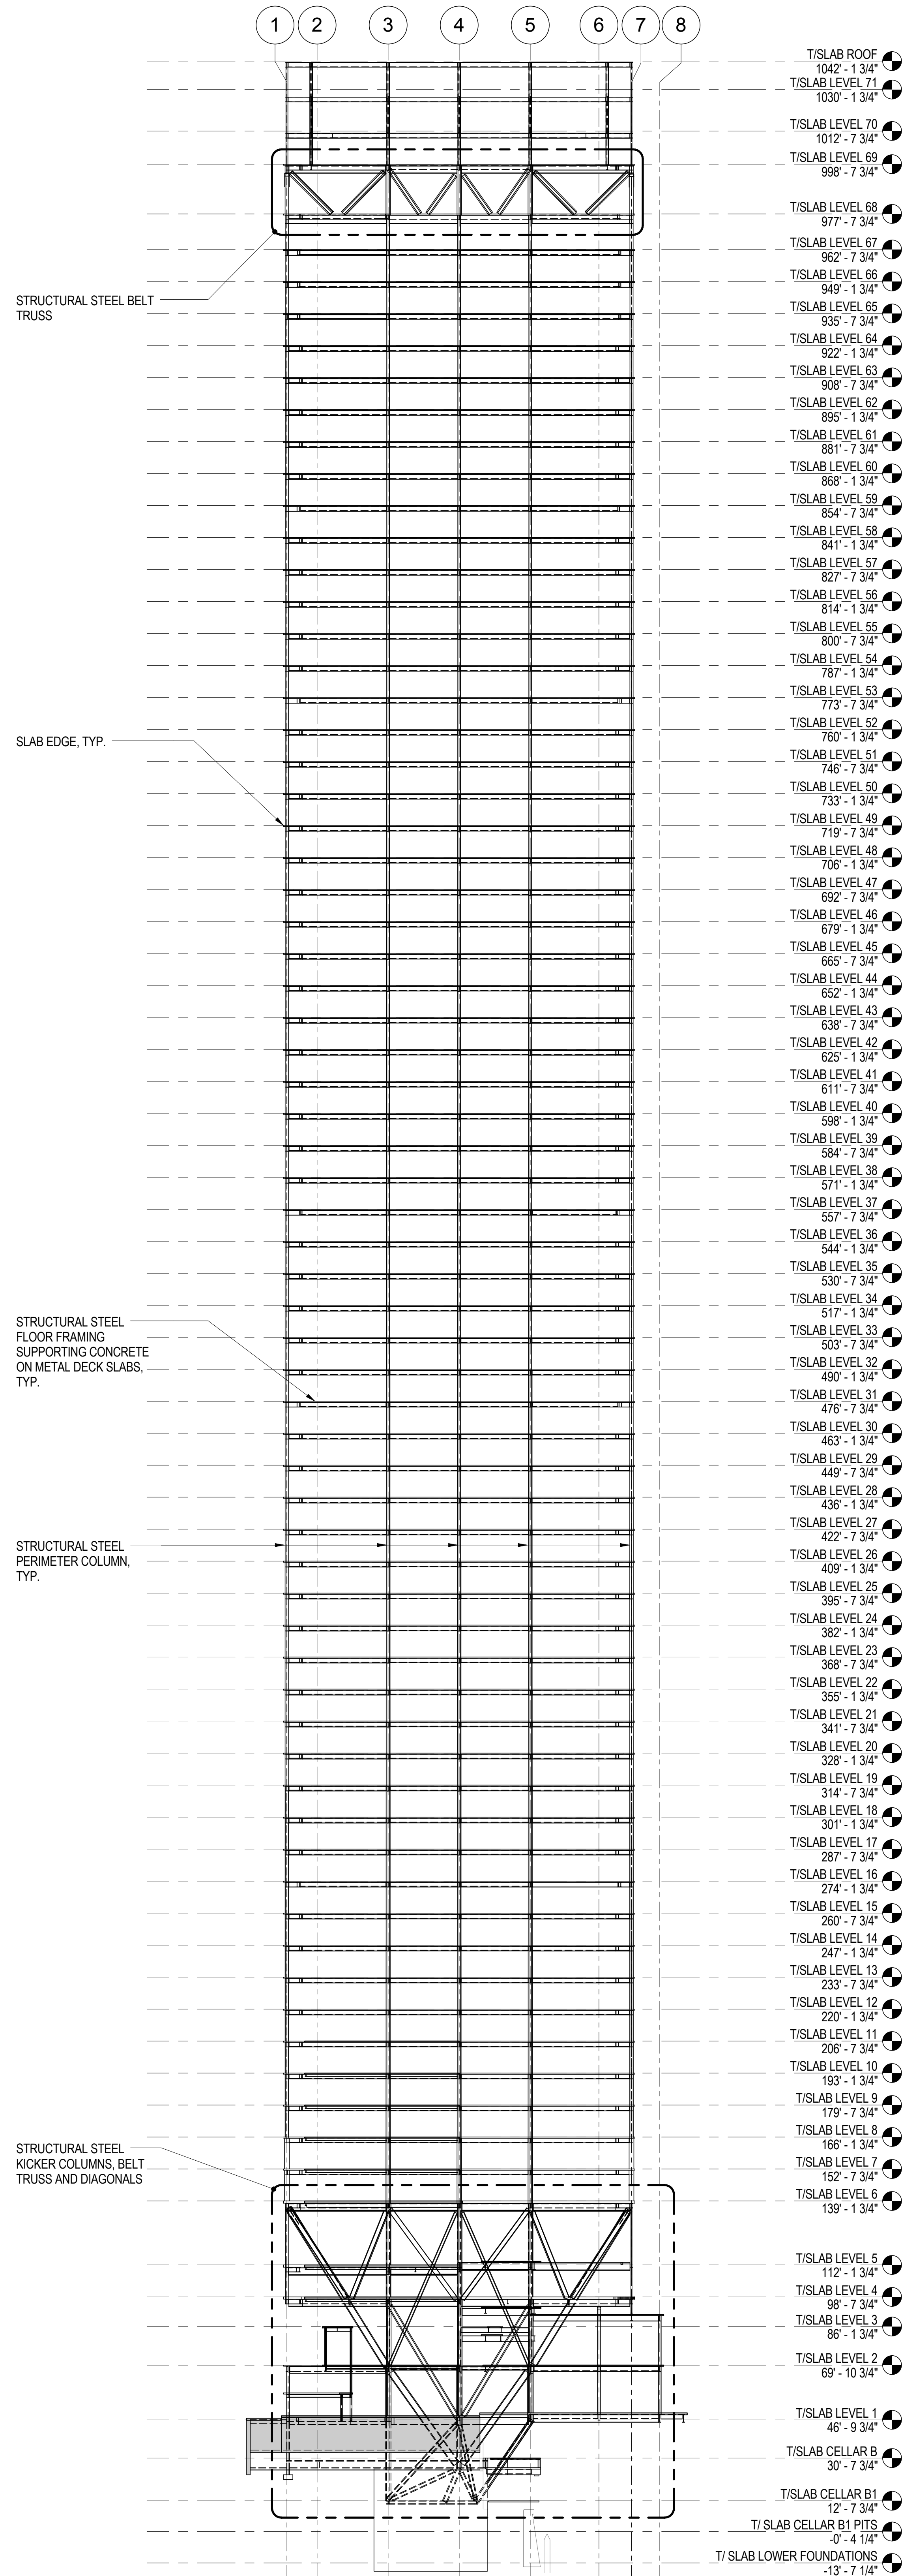
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Project No.:	B-SCAN Sheet No.:
211157	S-201.00


Date:	Sheet No.:
20 JUN 2014	S-201

Scale:	Page No.:
1/32" = 1'-0"	33 of 90

File No: S-201



1 TOWER ELEVATION WEST (LOOKING EAST)
1/32" = 1'-0"

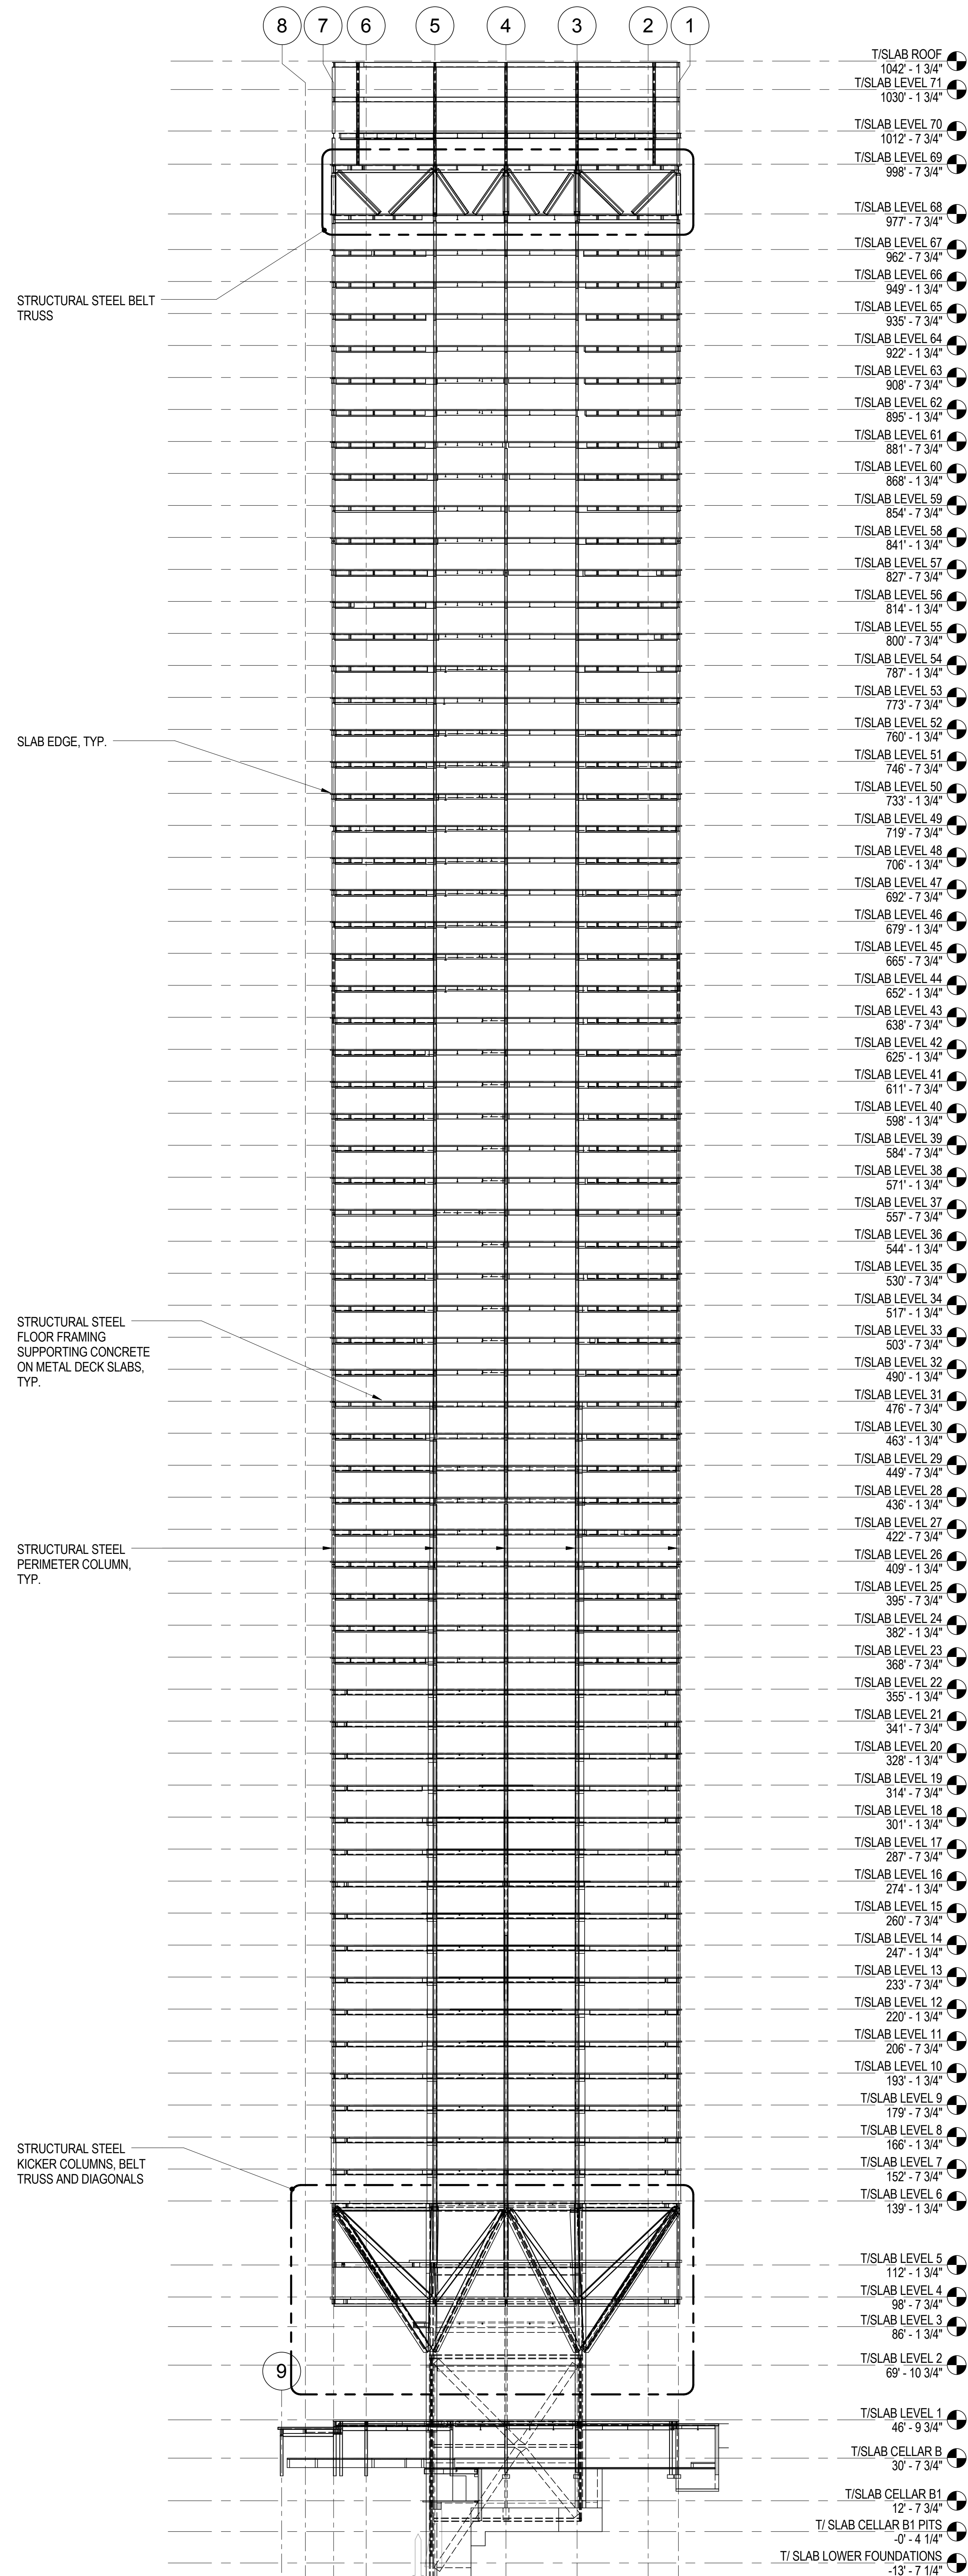

2 TOWER ELEVATION EAST (LOOKING WEST)
1/32" = 1'-0"

MANHATTAN WEST:
NORTH TOWER
375 Ninth Avenue, New York, NY 10001
Client

Brookfield
Brookfield Place
250 Vesey Street, 15th Floor, New York, NY 10021

Architecture/Structural Engineering

SOM
Skidmore, Owings & Merrill LLP
14 Wall Street, New York, NY 10005

Civil Engineering
Philip Habib & Associates
102 Madison Avenue #11, New York, NY 10016

MEP Engineering
Jaros Baum & Bolles
80 Pine Street, New York, NY 10005

Vertical Transportation
Edgett Williams Consulting Group, Inc.
102 East Bluffside Ave., Suite 1, Mill Valley, California 94941

Sustainable Design
Viridian Energy & Environmental
50 Washington Street, Newark, CT 06854

Geo-Technical Engineering
Mueser Rutledge Consulting Engineers
14 Penn Plaza, 225 W. 34th Street #610,
New York, NY 10122

Field Operations
475 10th Avenue, New York, NY 10018

Security Consultant
Ducibella, Vantor & Santore
250 State Street #F1, North Haven, CT 06473

Blast Consultant
Weidinger Associates, Inc.
40 Wall Street, New York, NY 10005

Acoustical Consultant
Cerami & Associates
404 Fifth Avenue #8, New York, NY 10016

Vibration Consultant
Wilson, Uhrig & Associates, Inc.
65 Broadway, Suite 401, New York, NY 10006

Code Consultant
Code Consultants Professional Engineers PC
215 West 40th Street, 15th Floor, New York, NY 10018

Facade Maintenance Consultant
Entek Engineering LLC
166 Ames Street, Hackensack, NJ 07601

Wind Tunnel Consultant
Rowan Williams Davies & Irwin Inc.
680 Woodlawn Road West, Guelph
Ontario, Canada N1K 1B8

Key Plan:

Seal & Signature:

PRELIMINARY
NOT FOR CONSTRUCTION

No.	Date	Description
6	20 JUN 2014	ISSUED FOR FOUNDATION BID
5	20 JUN 2014	ISSUED FOR FOUNDATION PERMIT
4	20 DEC 2013	ISSUED FOR FOUNDATION PERMIT
3	15 NOV 2013	ISSUED FOR 2D PROGRESS PRICING
2	12 JUL 2013	ISSUED FOR 90% DESIGN DEVELOPMENT
1	16 MAR 2012	ISSUED FOR RECONCILIATION

No. _____ Date _____ Description _____

Sheet Name: **TOWER ELEVATIONS**

Project No.:	B-SCAN Sheet No.:
211157	S-202.00

Date:	Sheet No.:
20 JUN 2014	S-202

Scale:	Page No.:
1/32" = 1'-0"	34 of 90



**MANHATTAN WEST:
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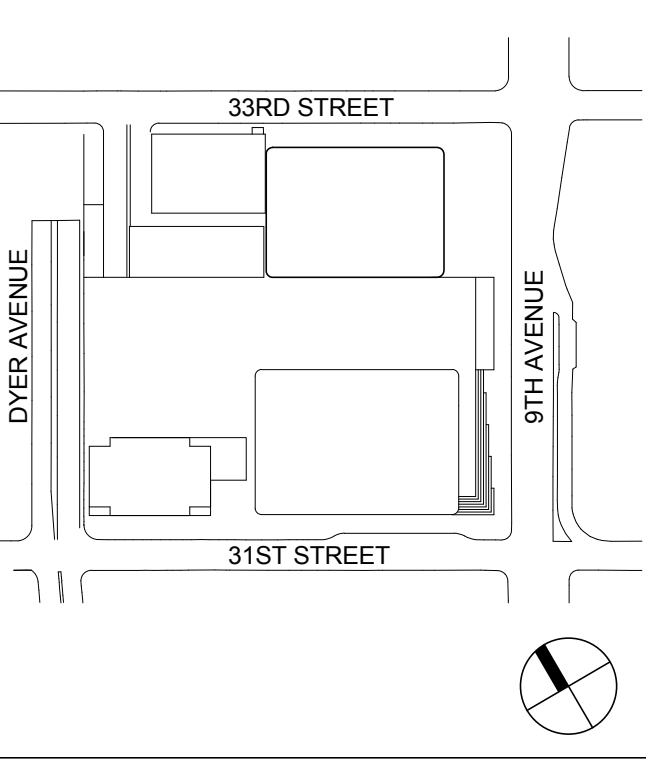
Facade Maintenance Consultant
Entek Engineering LLC
166 Ames Street, Hackensack, NJ 07601

Wind Tunnel Consultant
Rowan Williams Davies & Irwin Inc.
680 Woodlawn Road West, Guelph
Ontario, Canada N1K 1B8

Key Plan:
Key Plan showing the location of the tower sections on the site plan.



Seal & Signature:
Signature of the Professional Engineer.




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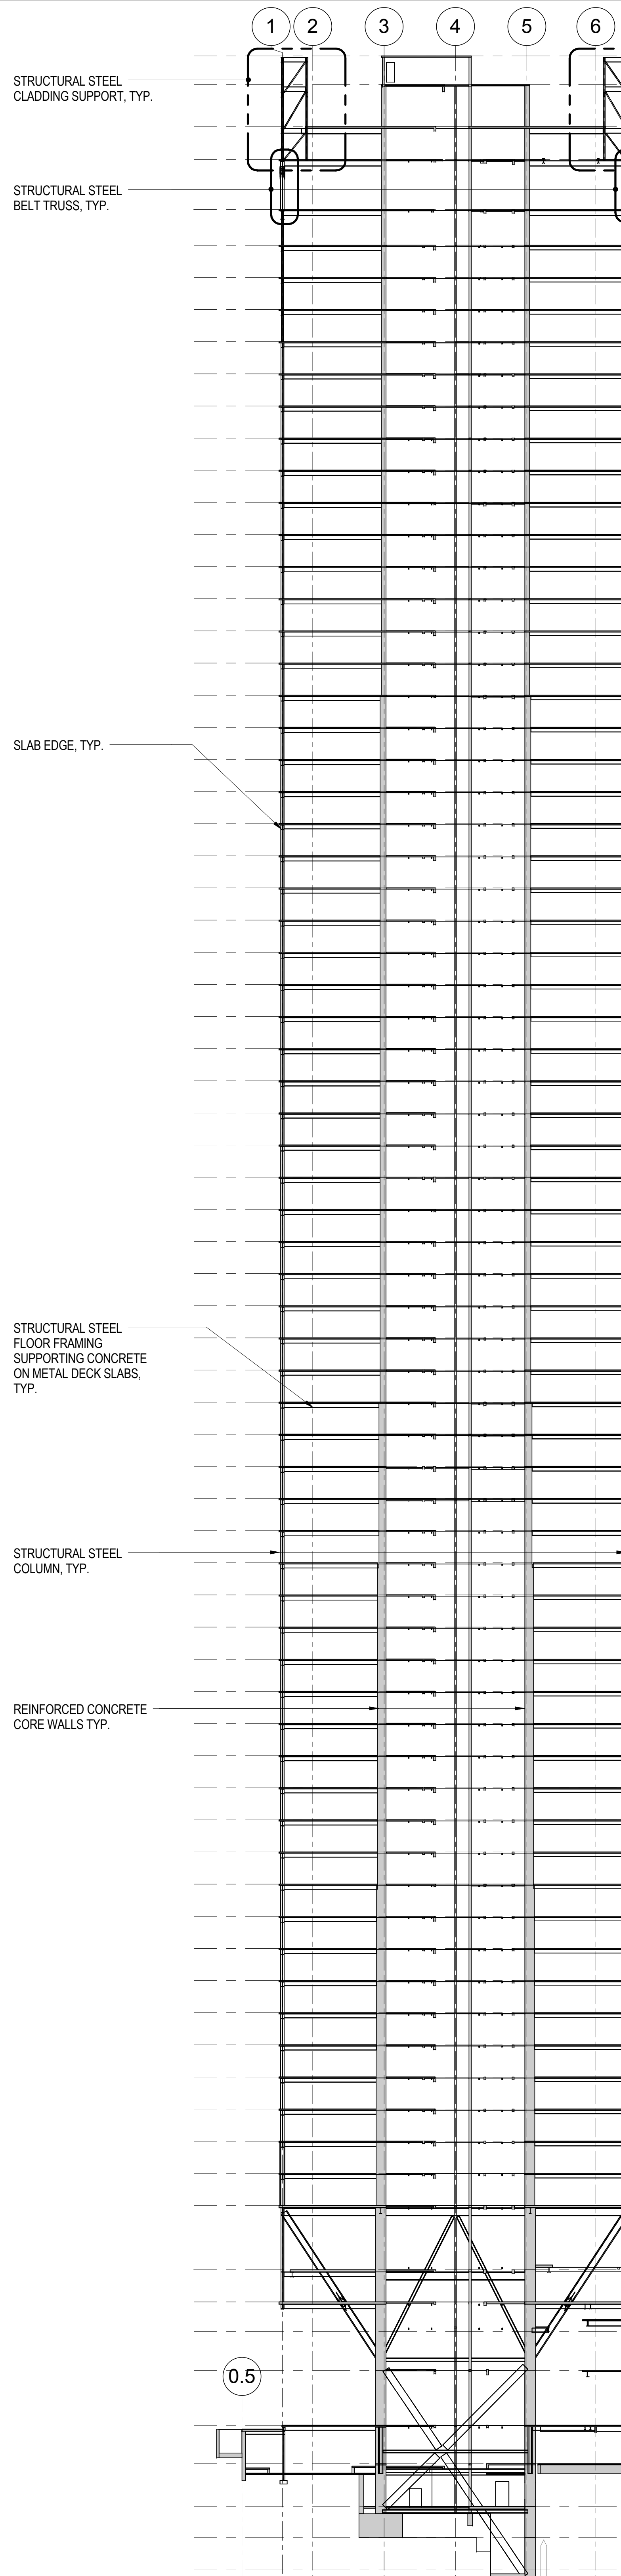
No.	Date	Description
6	20 JUN 2014	ISSUED FOR FOUNDATION BID
5	20 JUN 2014	ISSUED FOR FOUNDATION PERMIT
4	20 DEC 2013	ISSUED FOR FOUNDATION PERMIT
3	15 NOV 2013	ISSUED FOR 50% DESIGN PERMIT
2	12 JUL 2013	ISSUED FOR 60% DESIGN DEVELOPMENT
1	19 MAR 2013	ISSUED FOR RECONCILIATION

Project No.: 211157
Date: 20 JUN 2014
Scale: 1/32" = 1'-0"
File No: S-203


Sheet No.: S-203
Page No.: 35 of 90

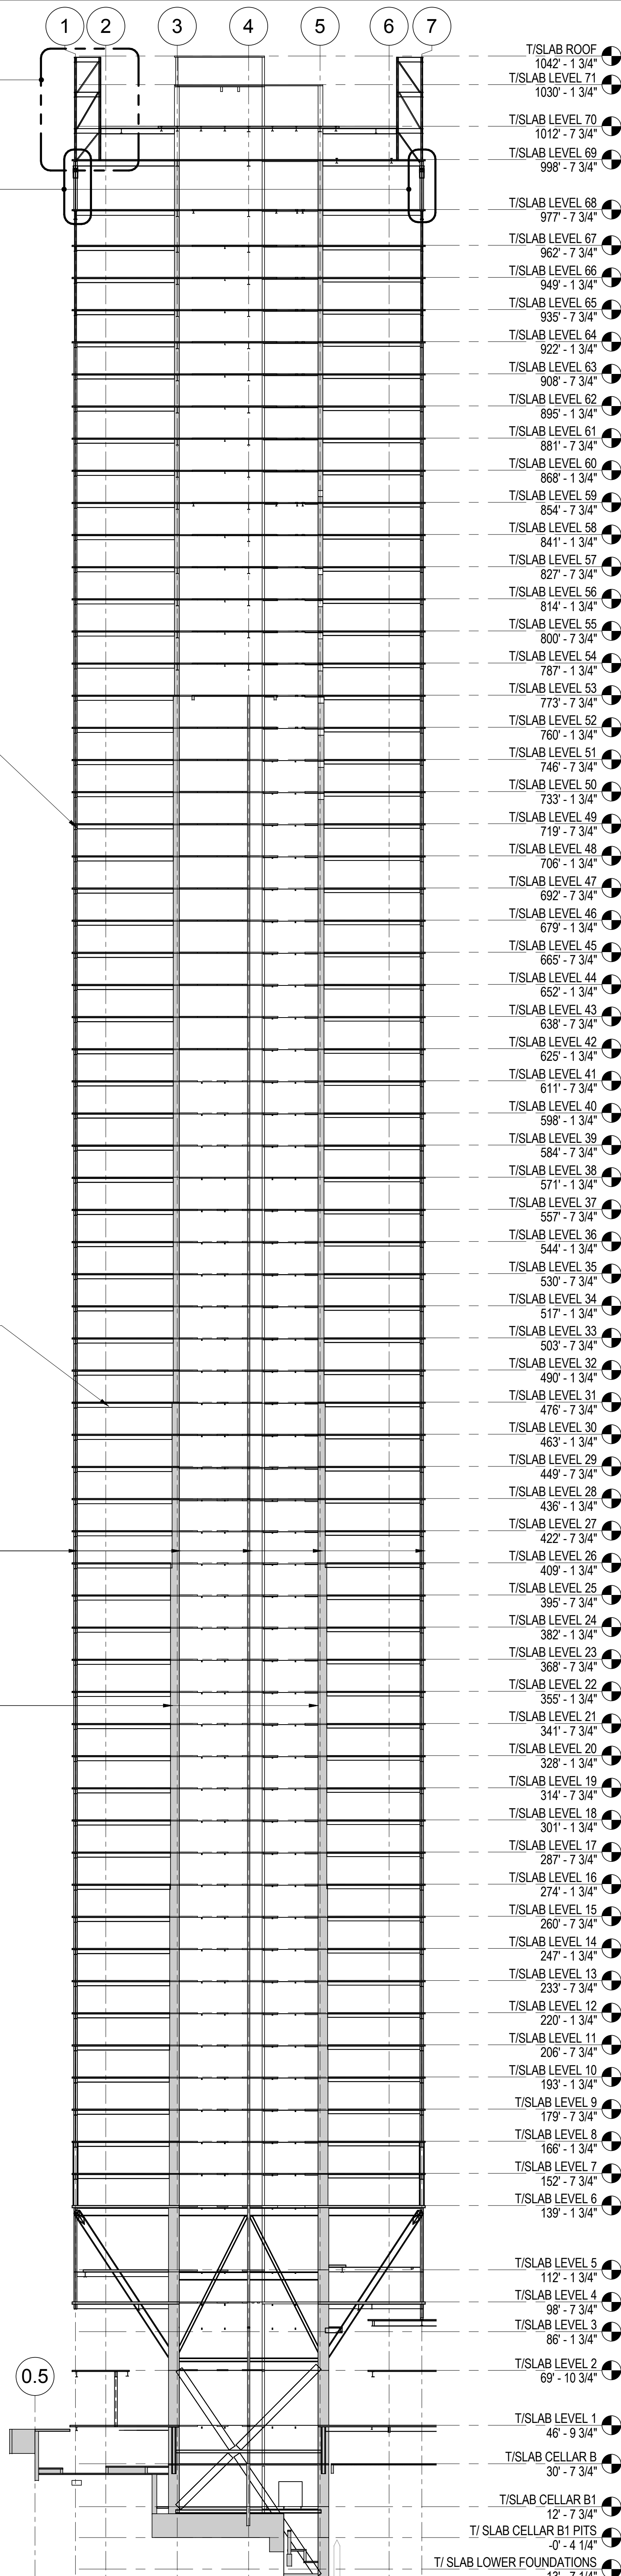



1 TOWER SECTION AT GRID D (LOOKING EAST)
1/32" = 1'-0"



2 TOWER SECTION AT GRID E (LOOKING EAST)
1/32" = 1'-0"

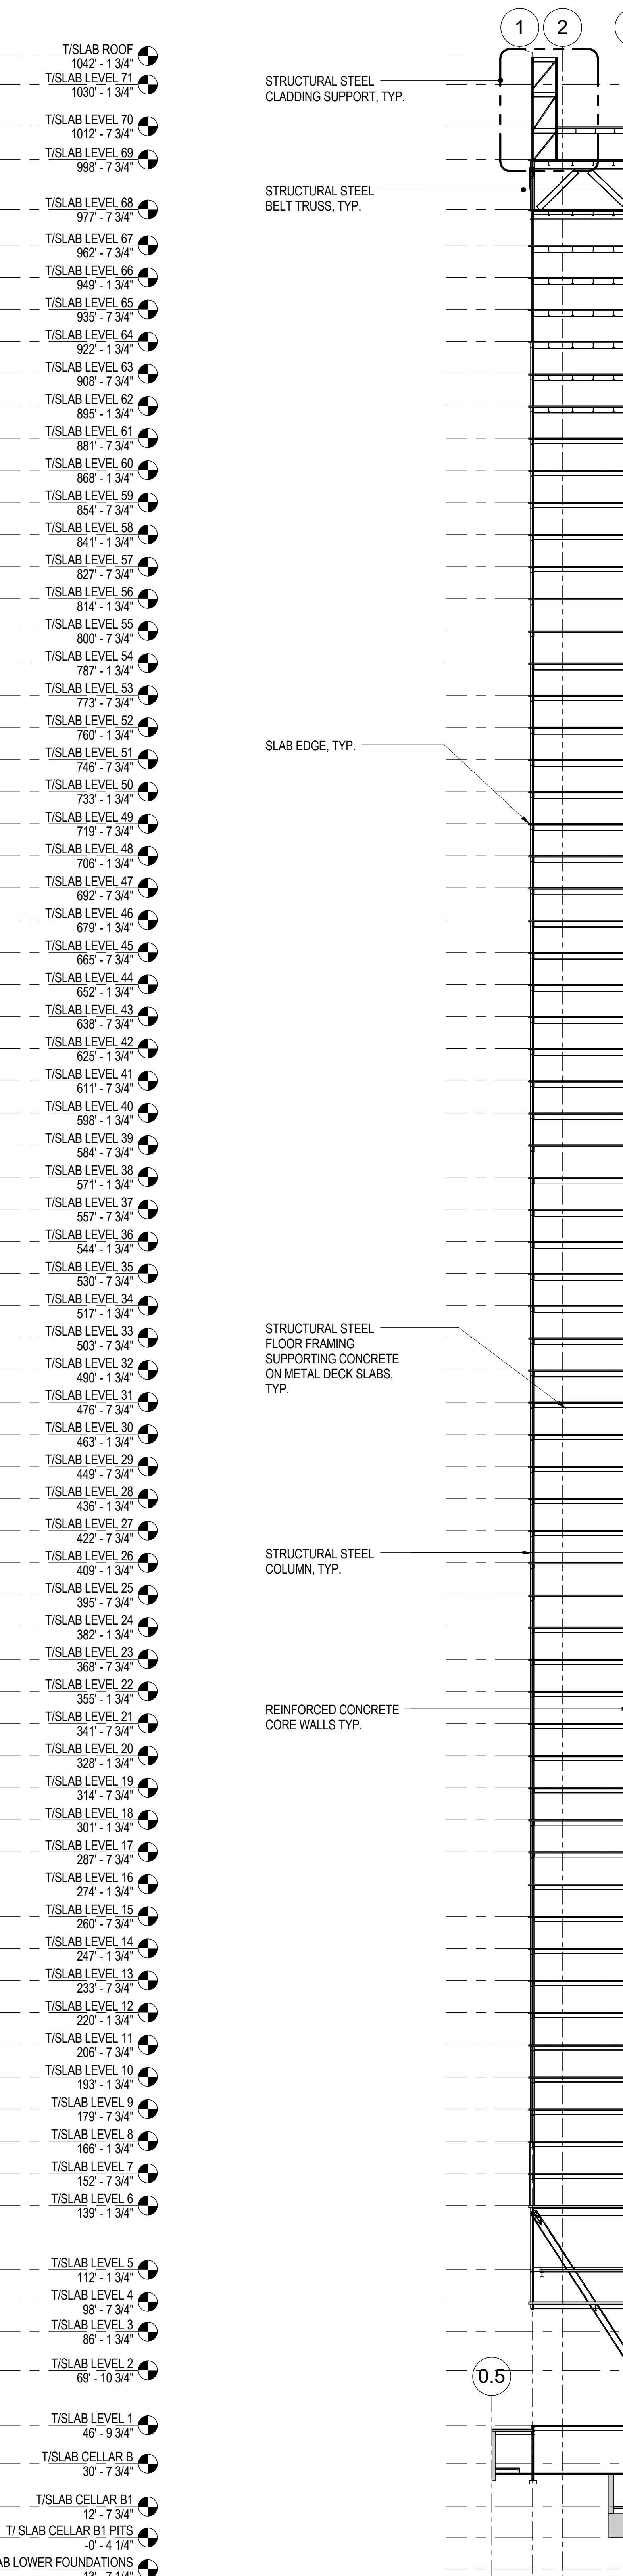

3 TOWER SECTION AT GRID F (LOOKING EAST)
1/32" = 1'-0"

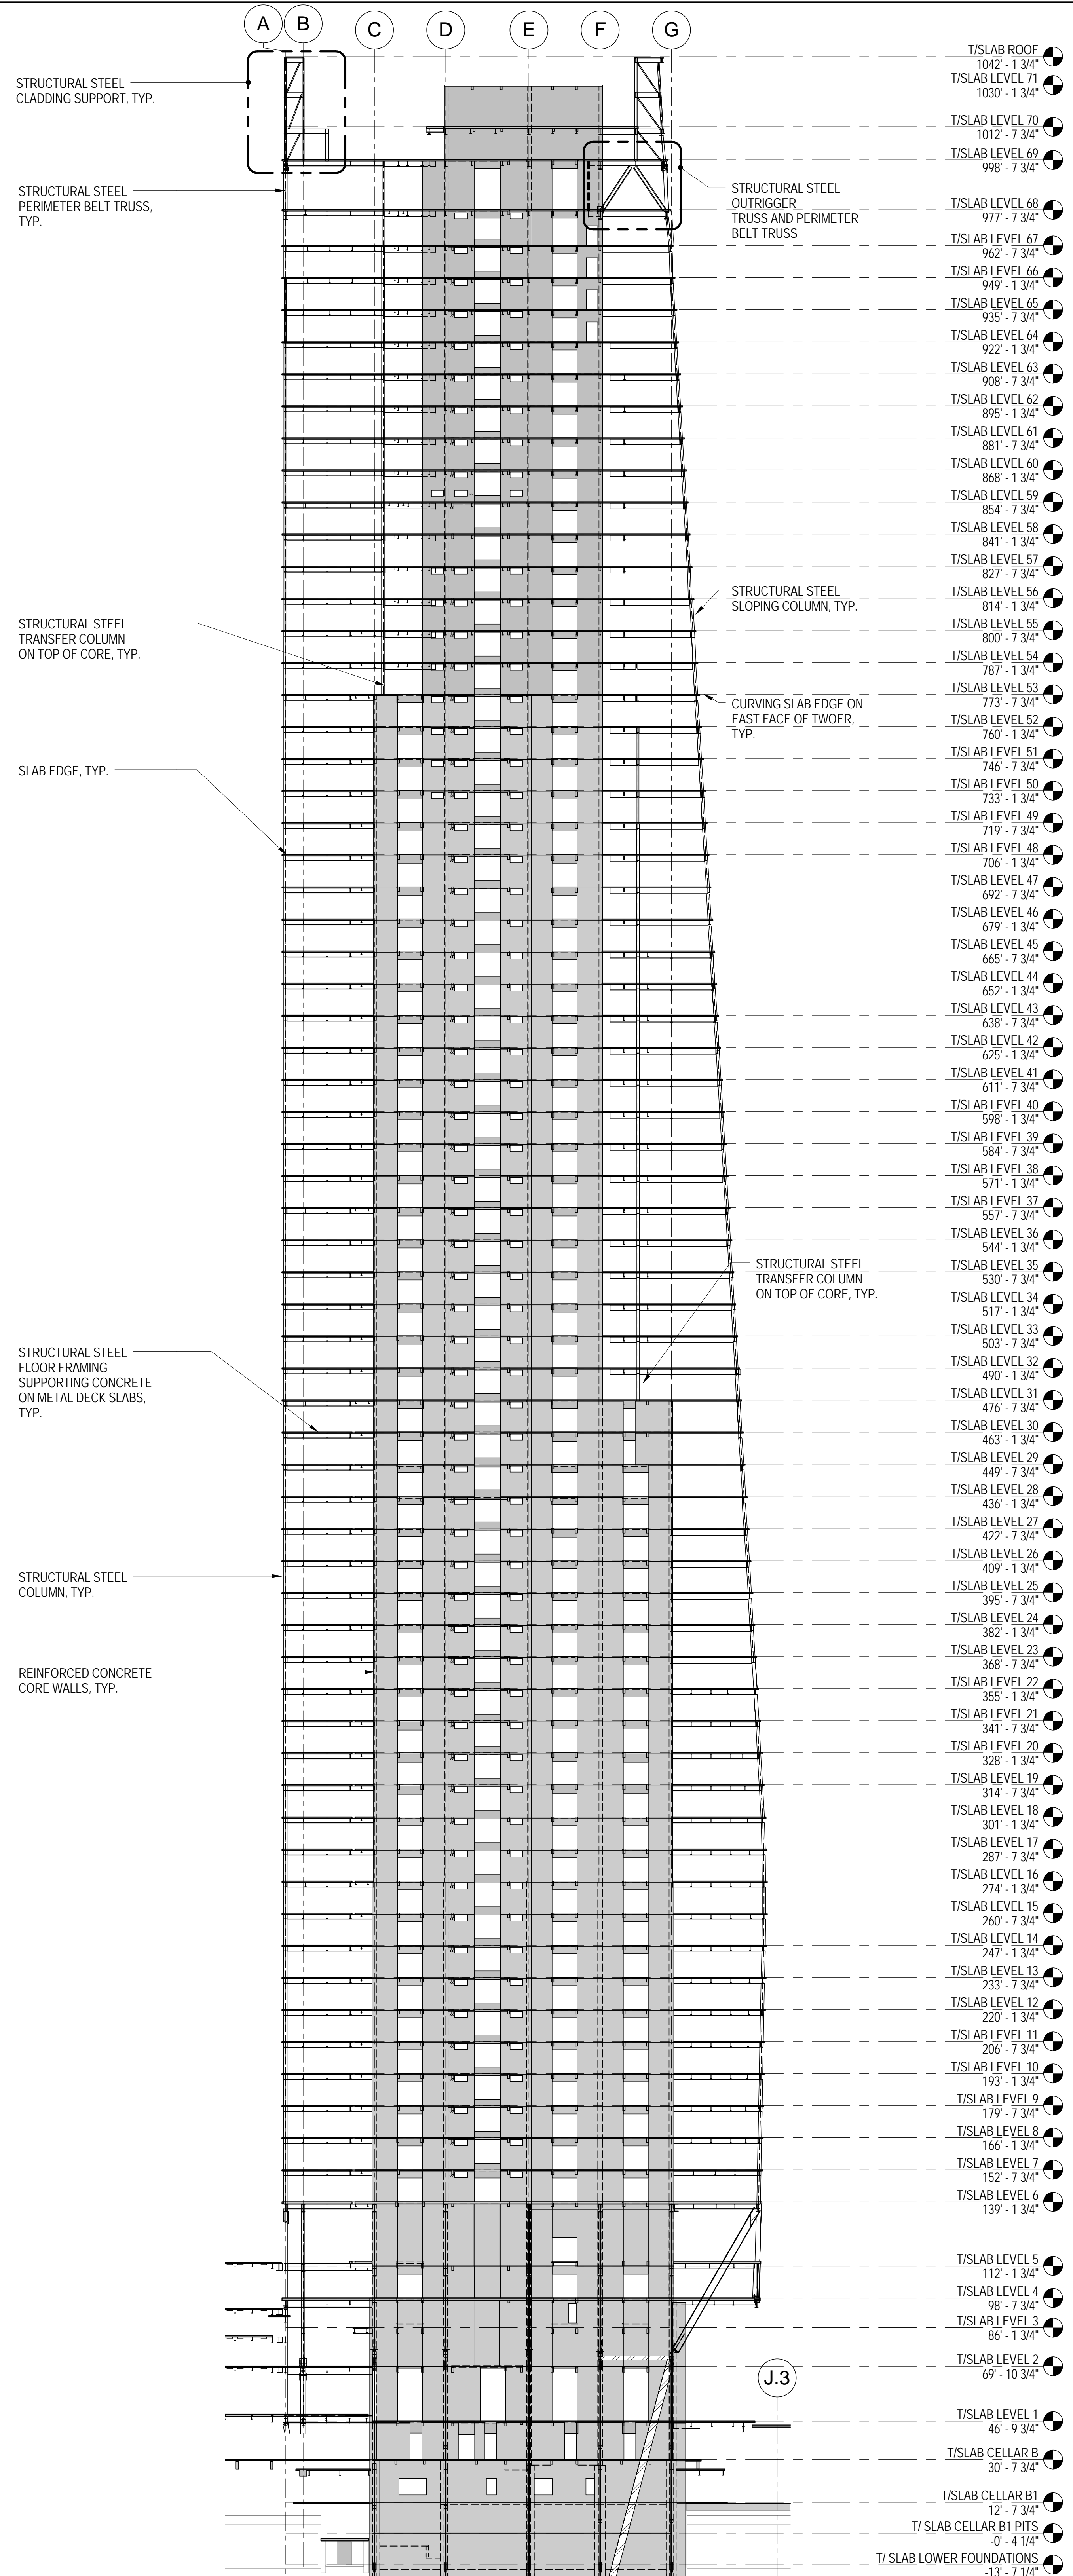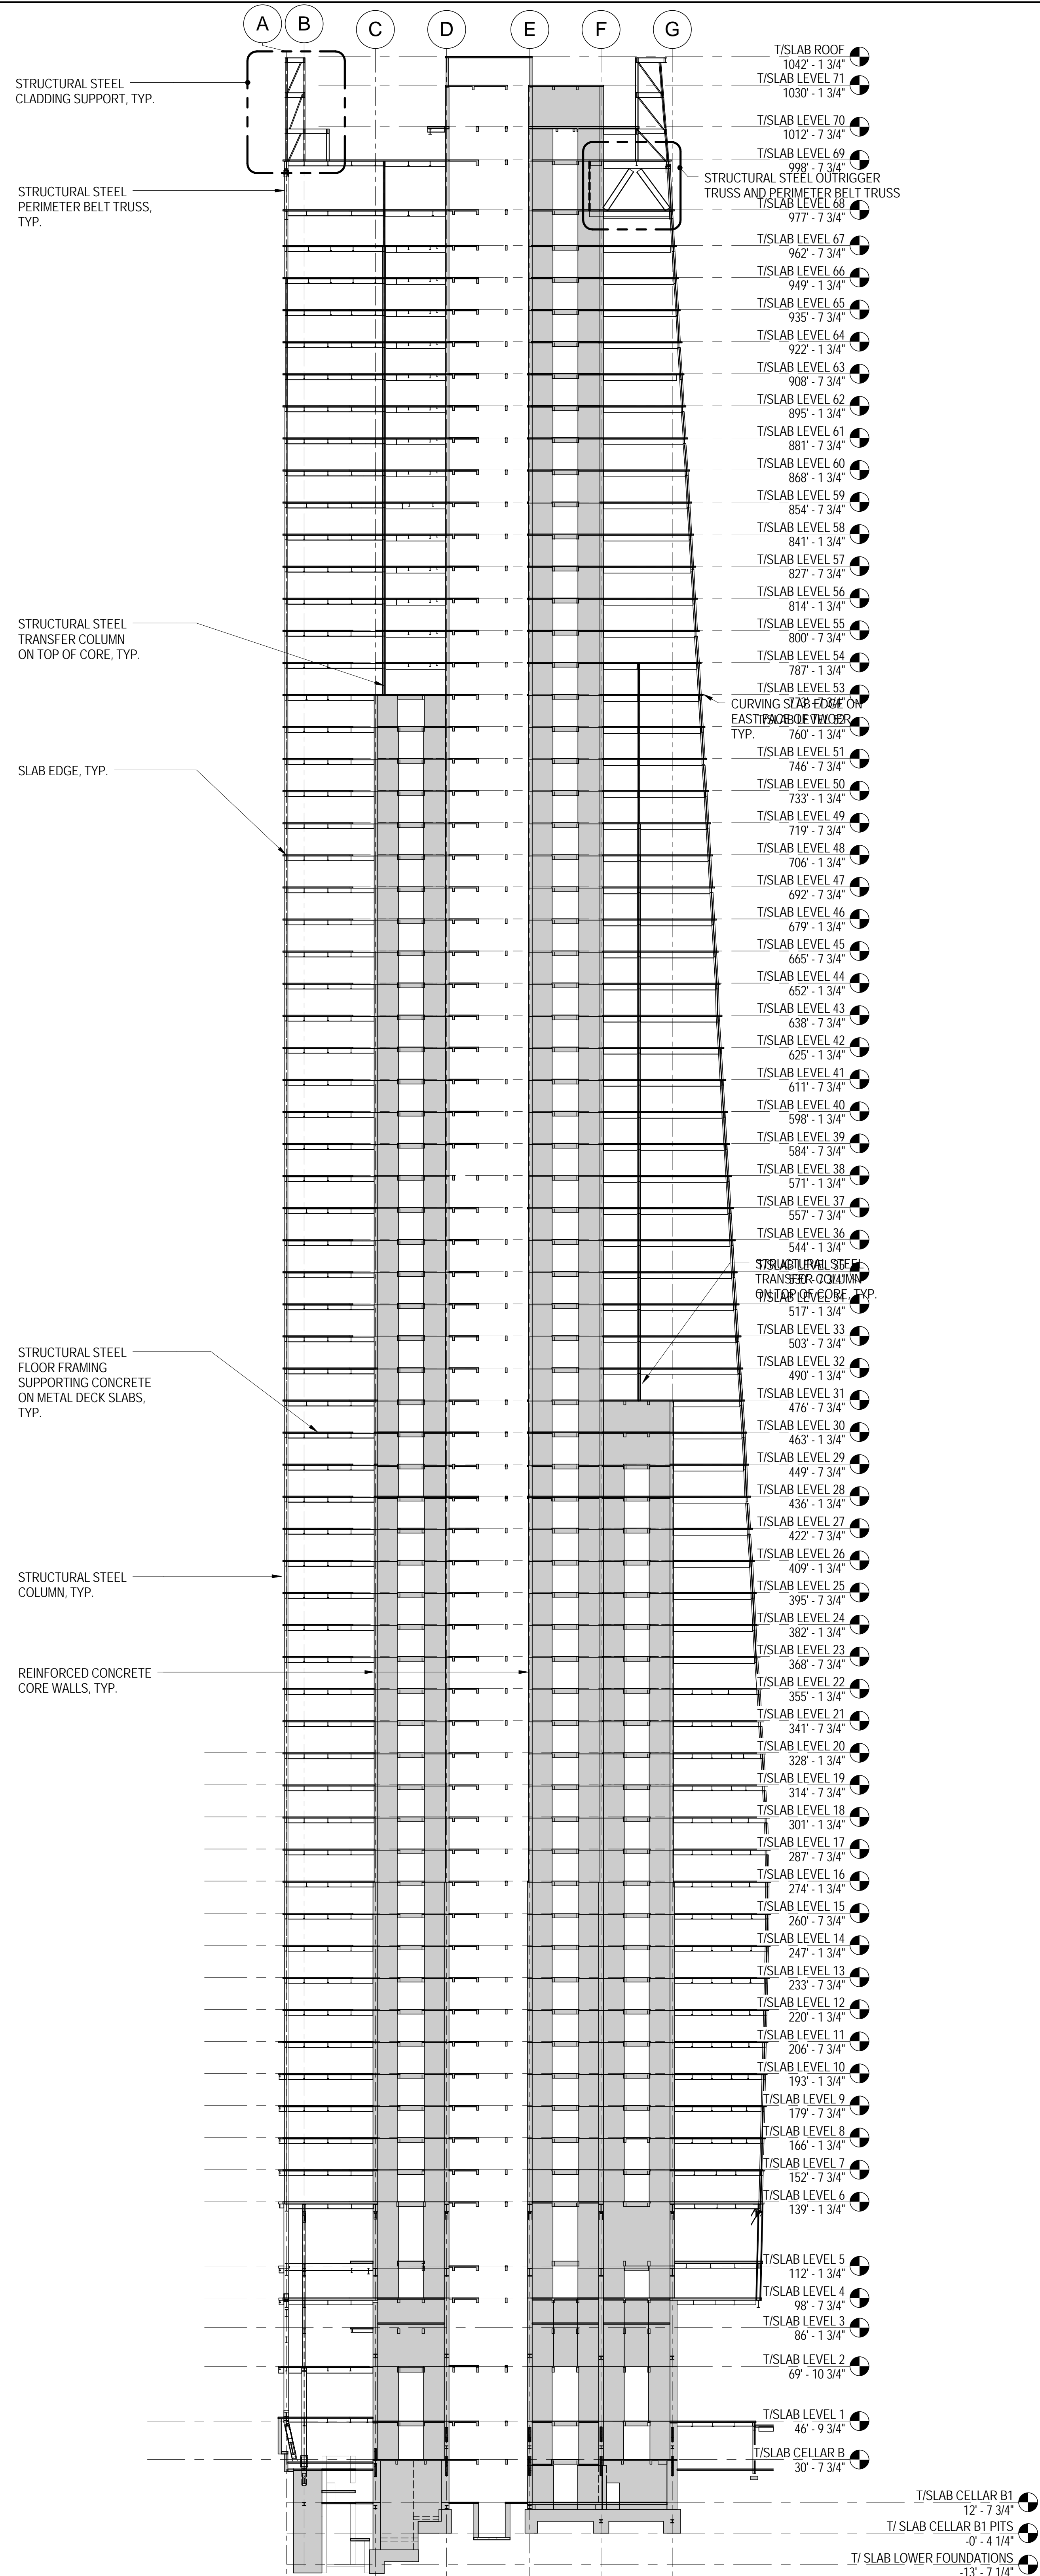

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680 Woodlawn Road West, Guelph
Ontario, Canada N1K 1B8

Key Plan:

Seal & Signature:

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3	15 NOV 2013	ISSUED FOR 20% PROGRESS PRICING
2	12 JUL 2013	ISSUED FOR 90% DESIGN DEVELOPMENT
1	19 MAR 2013	ISSUED FOR RECONCILIATION


No. _____ Date _____ Description _____
Sheet Name: **TOWER SECTIONS**

Project No.:	B-SCAN Sheet No.:
211157	S-204.00


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20 JUN 2014	S-204

Scale:	Page No.:
1/32" = 1'-0"	36 of 90


File No.:	Page No.:
S-204	36 of 90

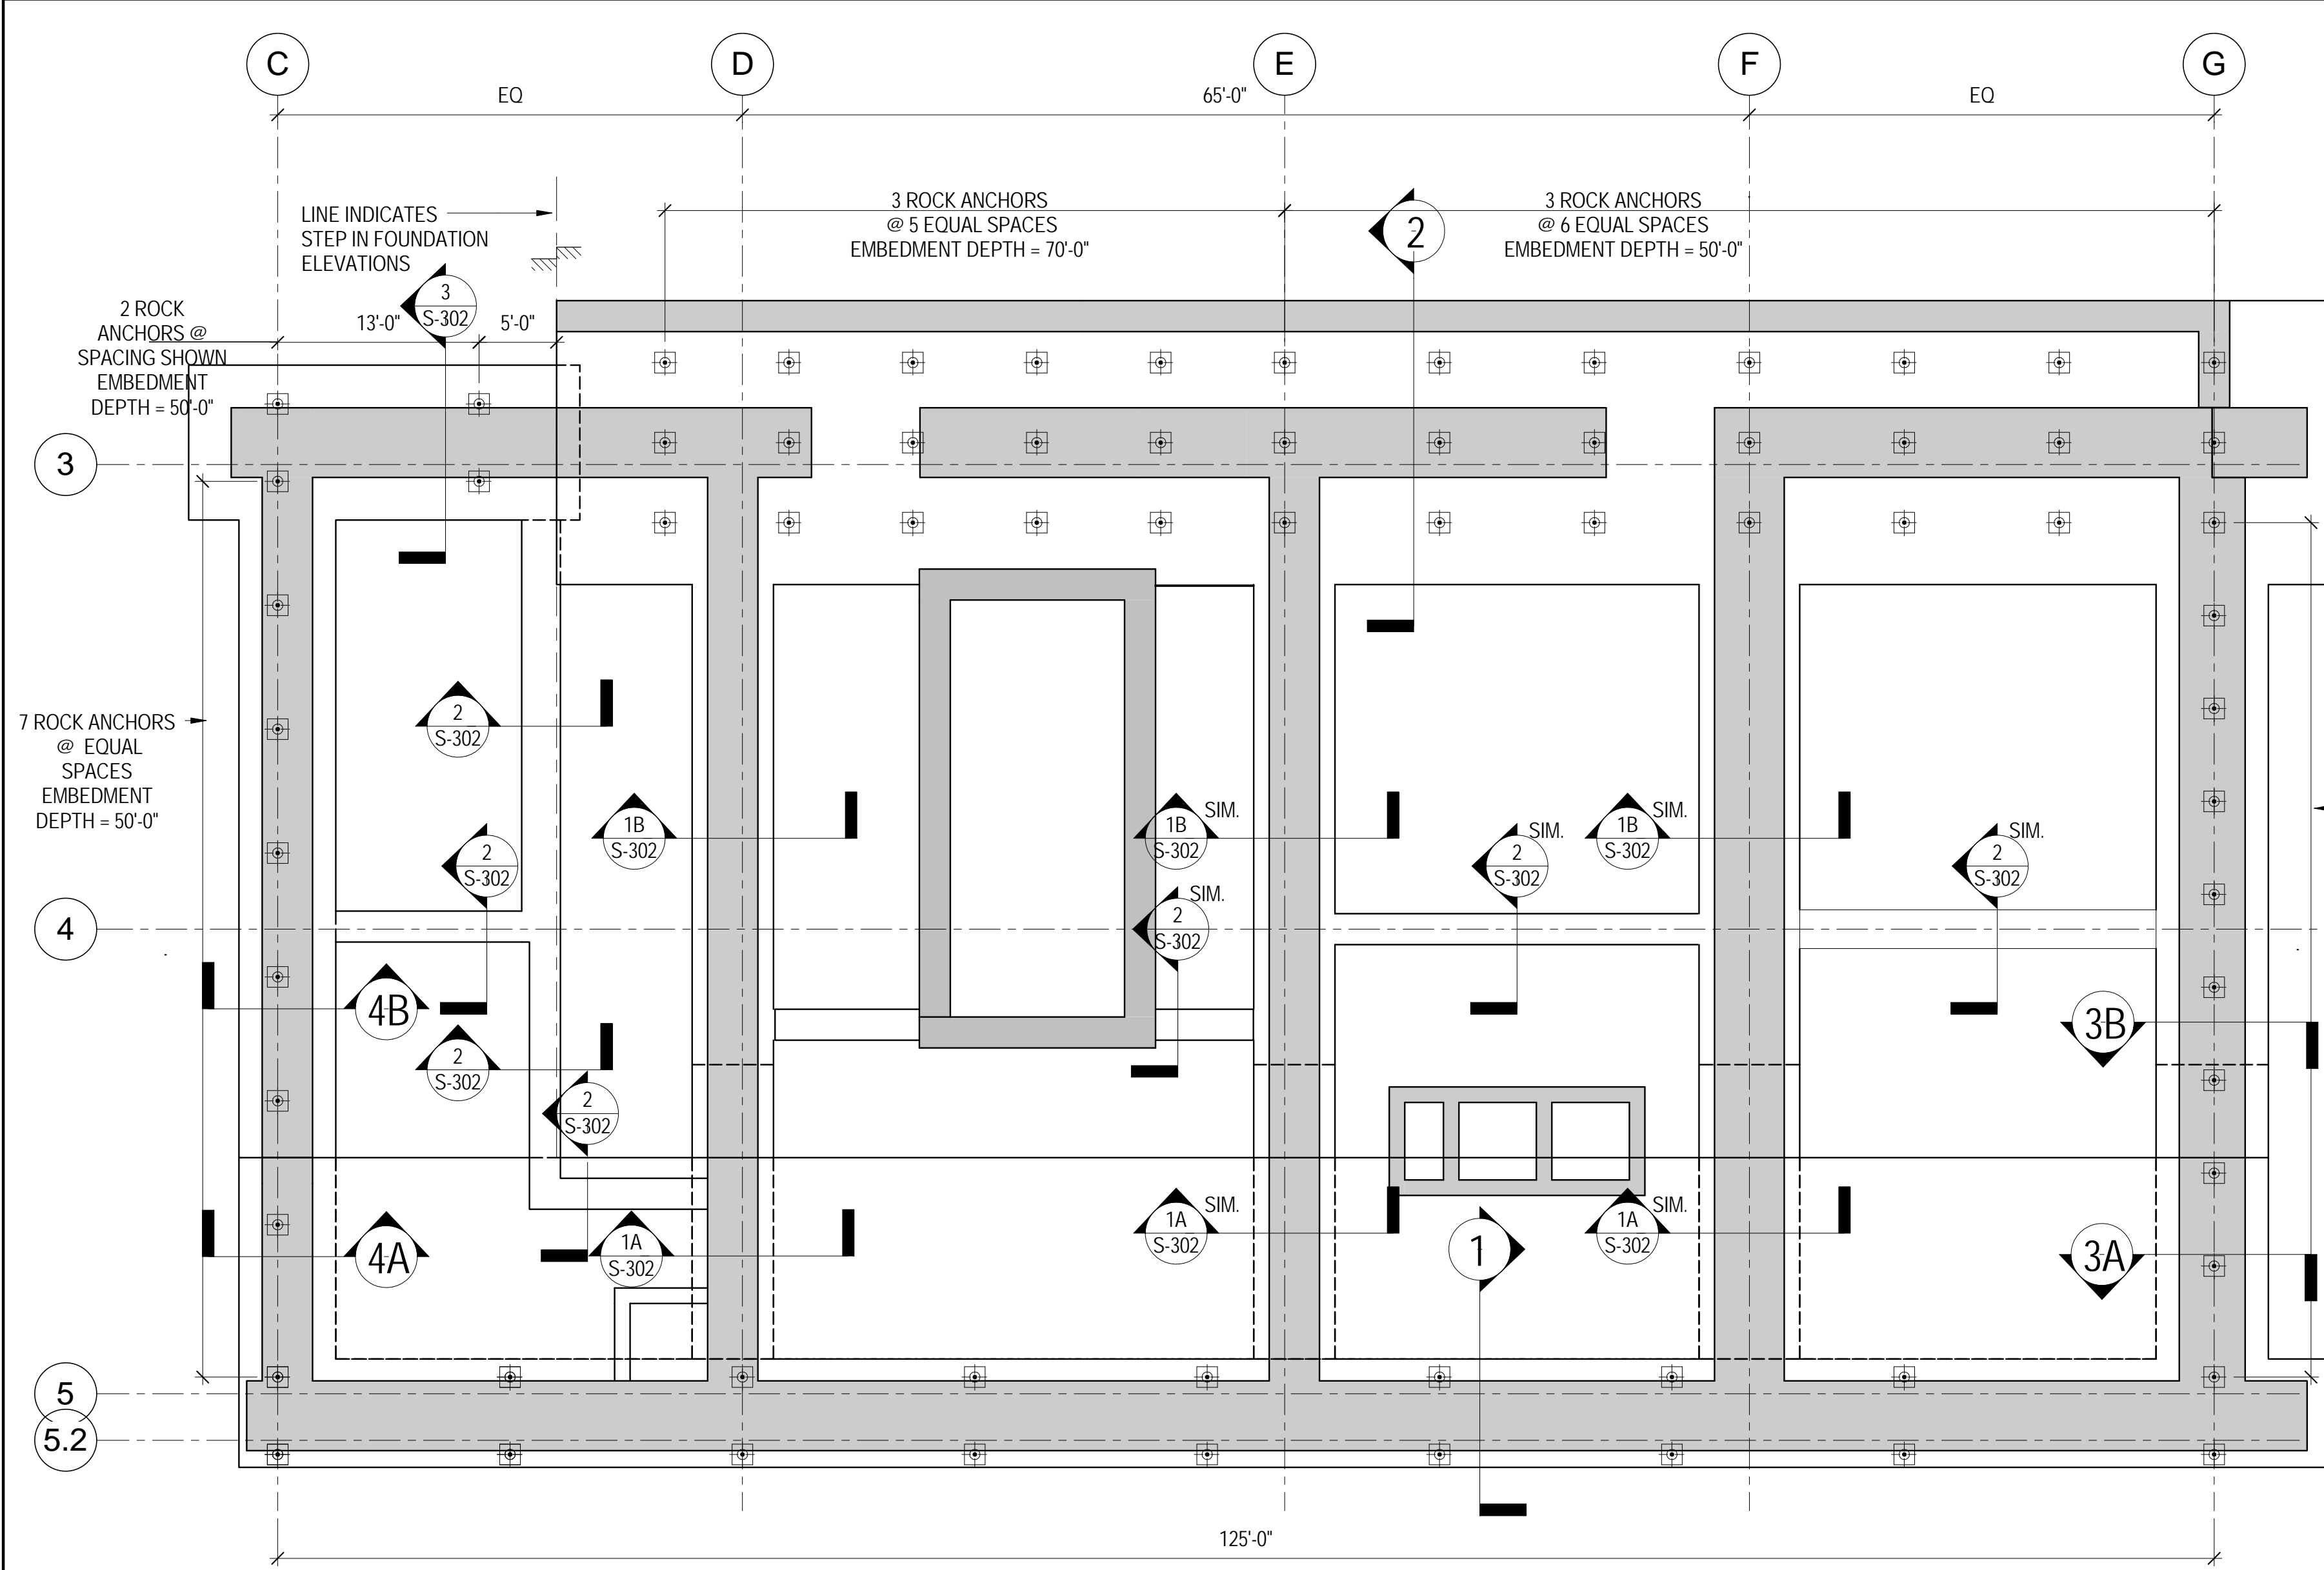


A KEY PLAN - TOWER CONCRETE CORE FOUNDATION
NOT TO SCALE

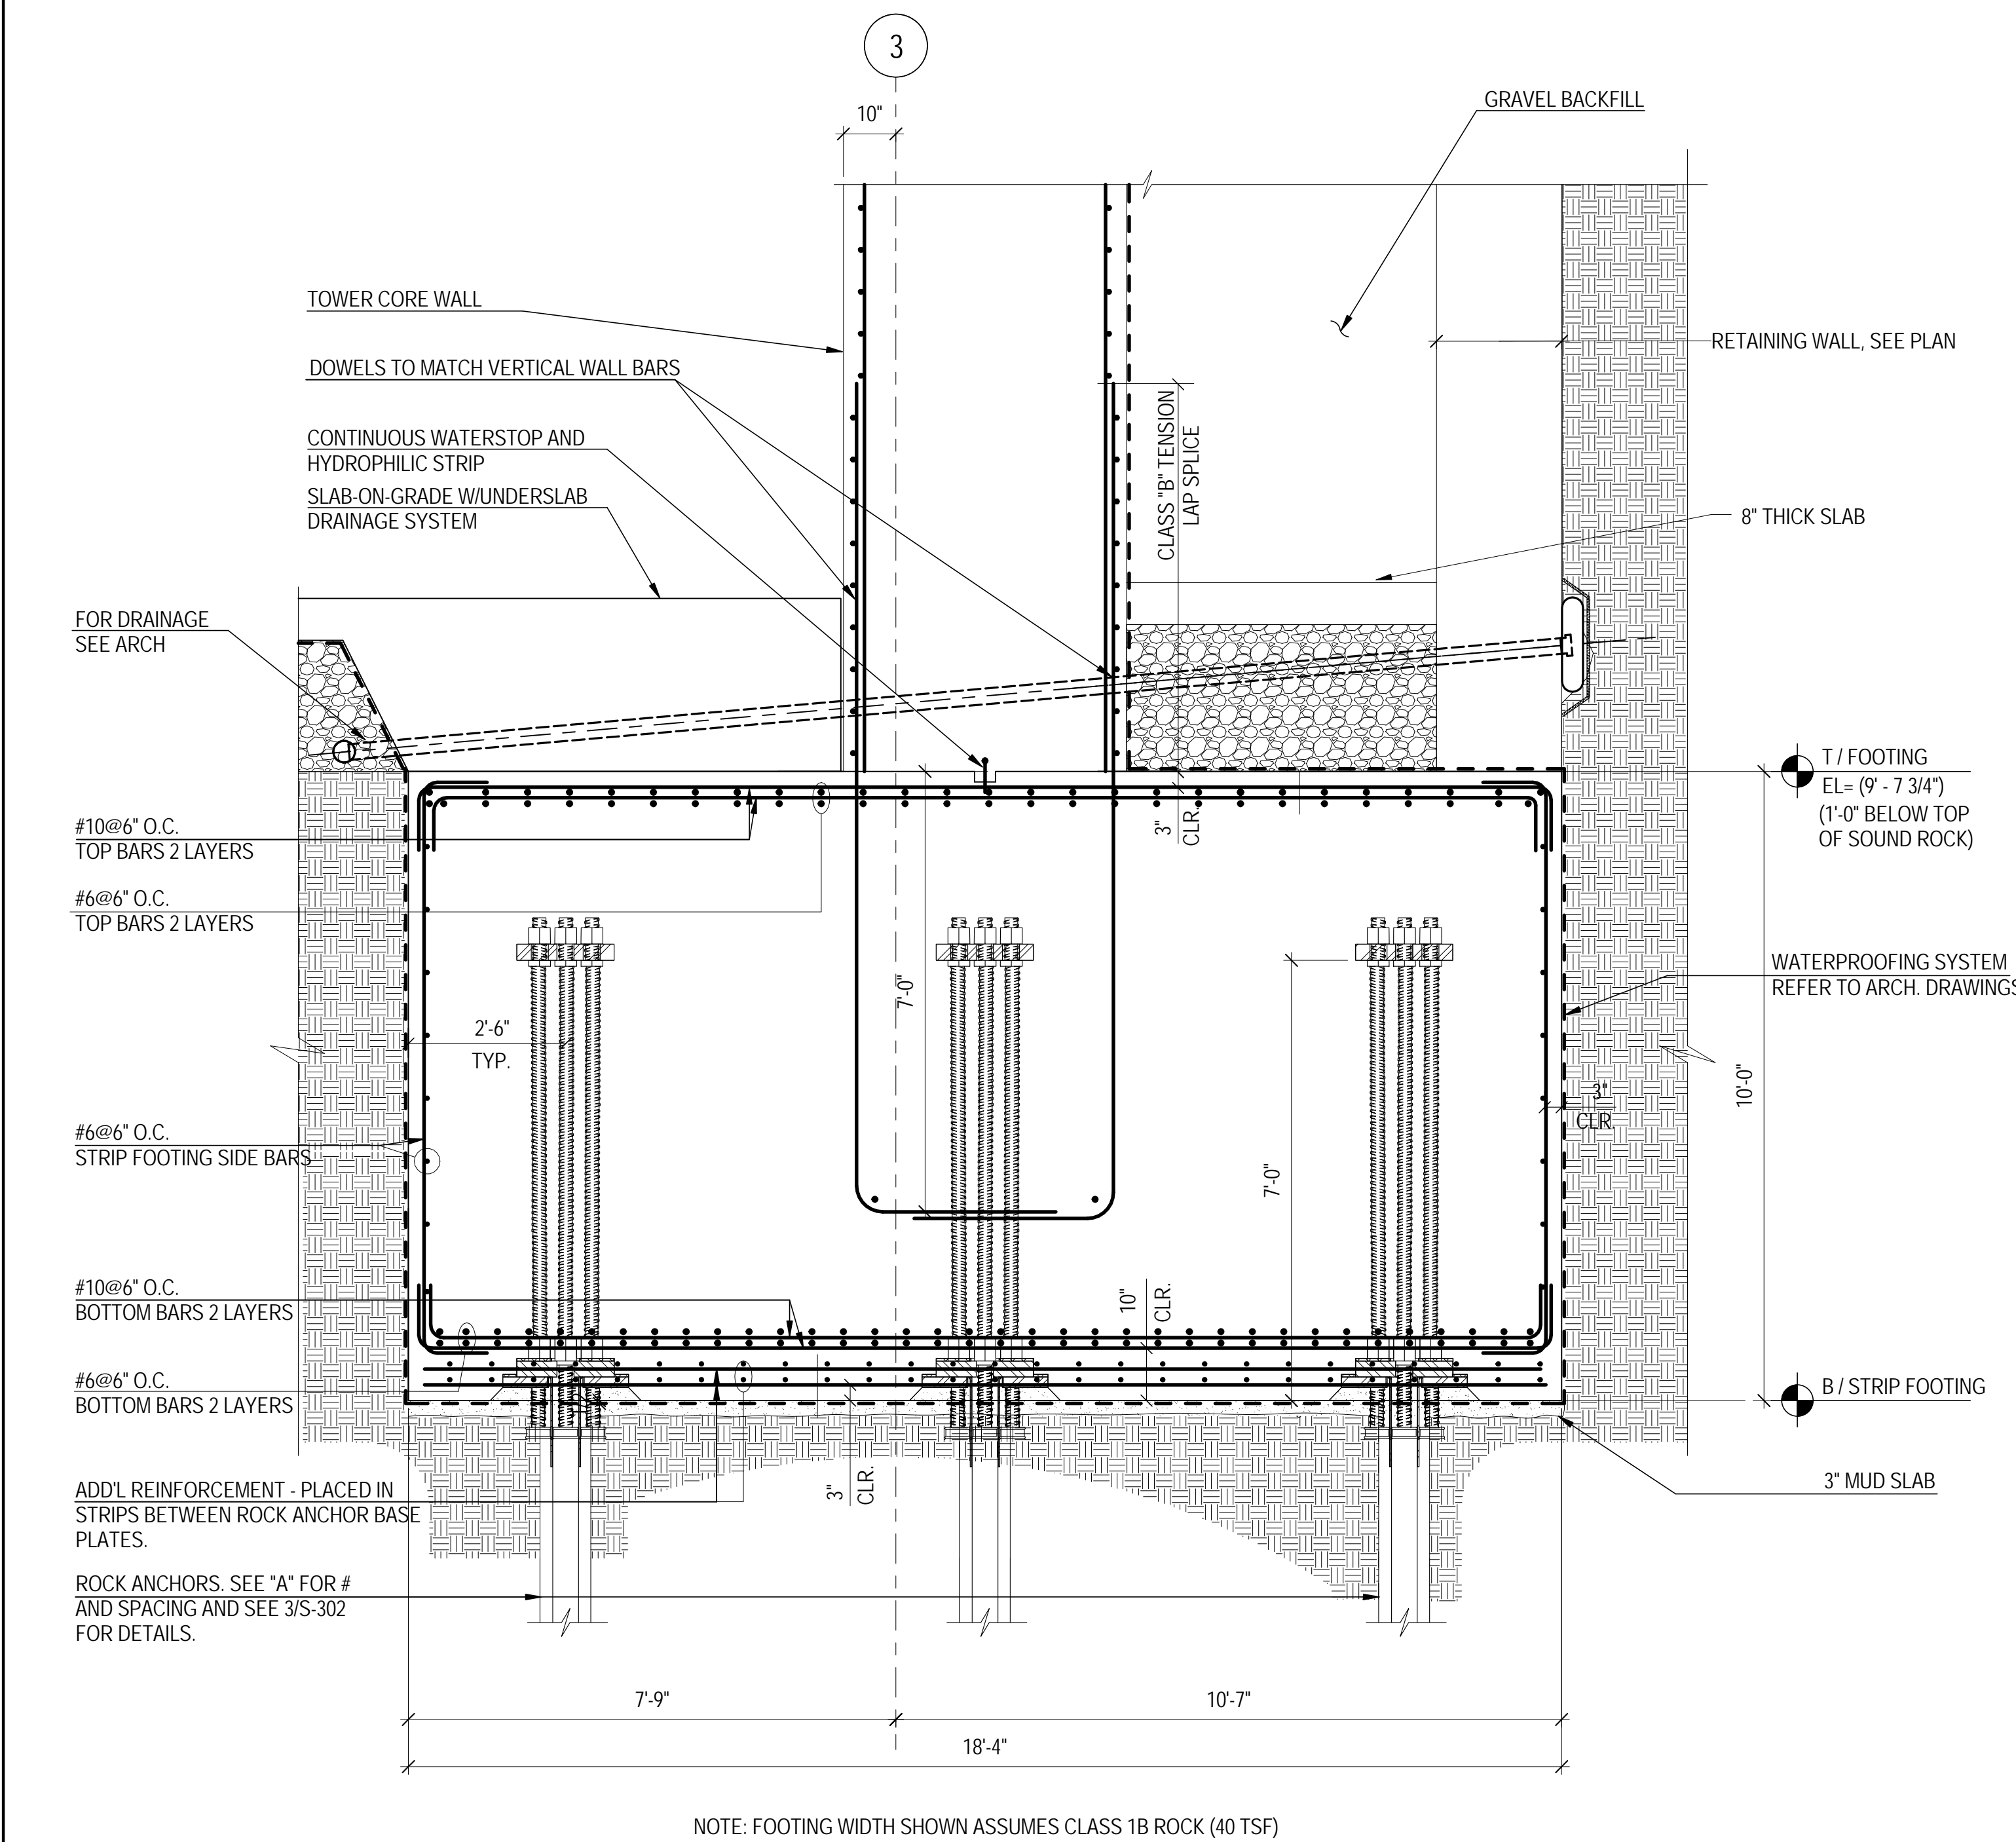


2 SECTION THRU NORTH CORE WALL CONTINUOUS FOOTING ON ROCK W/ ROCK ANCHORS
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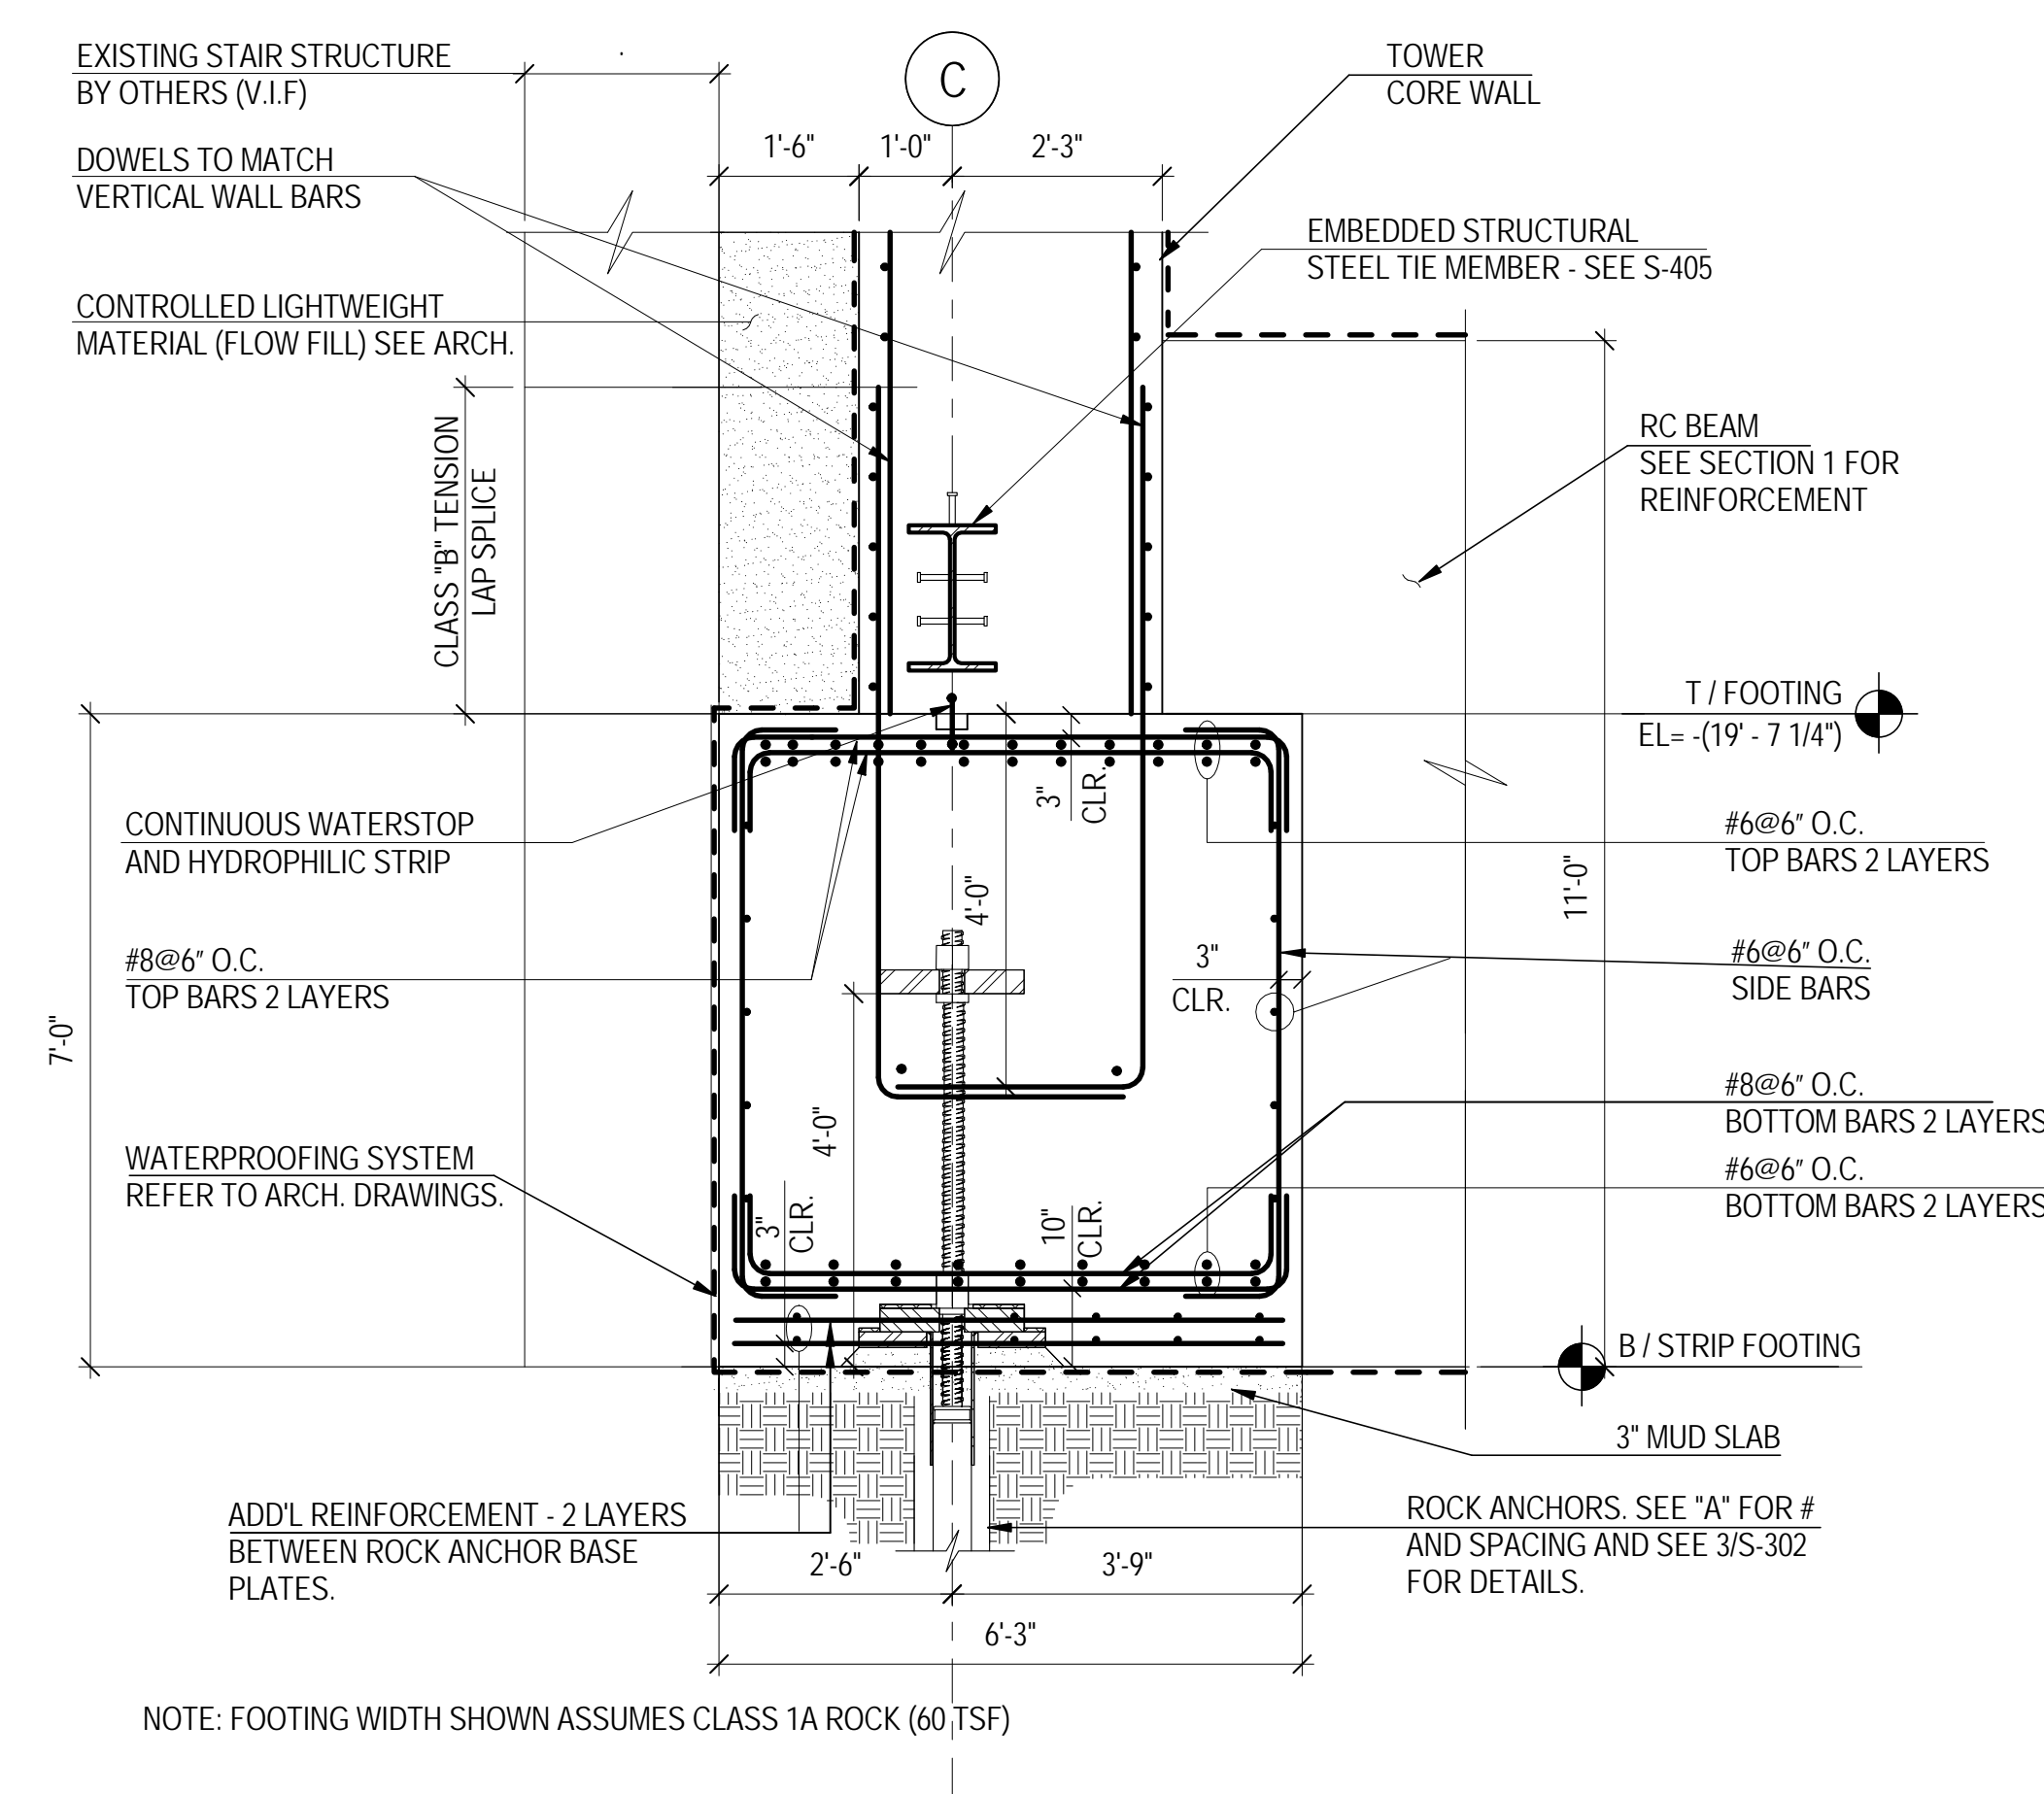
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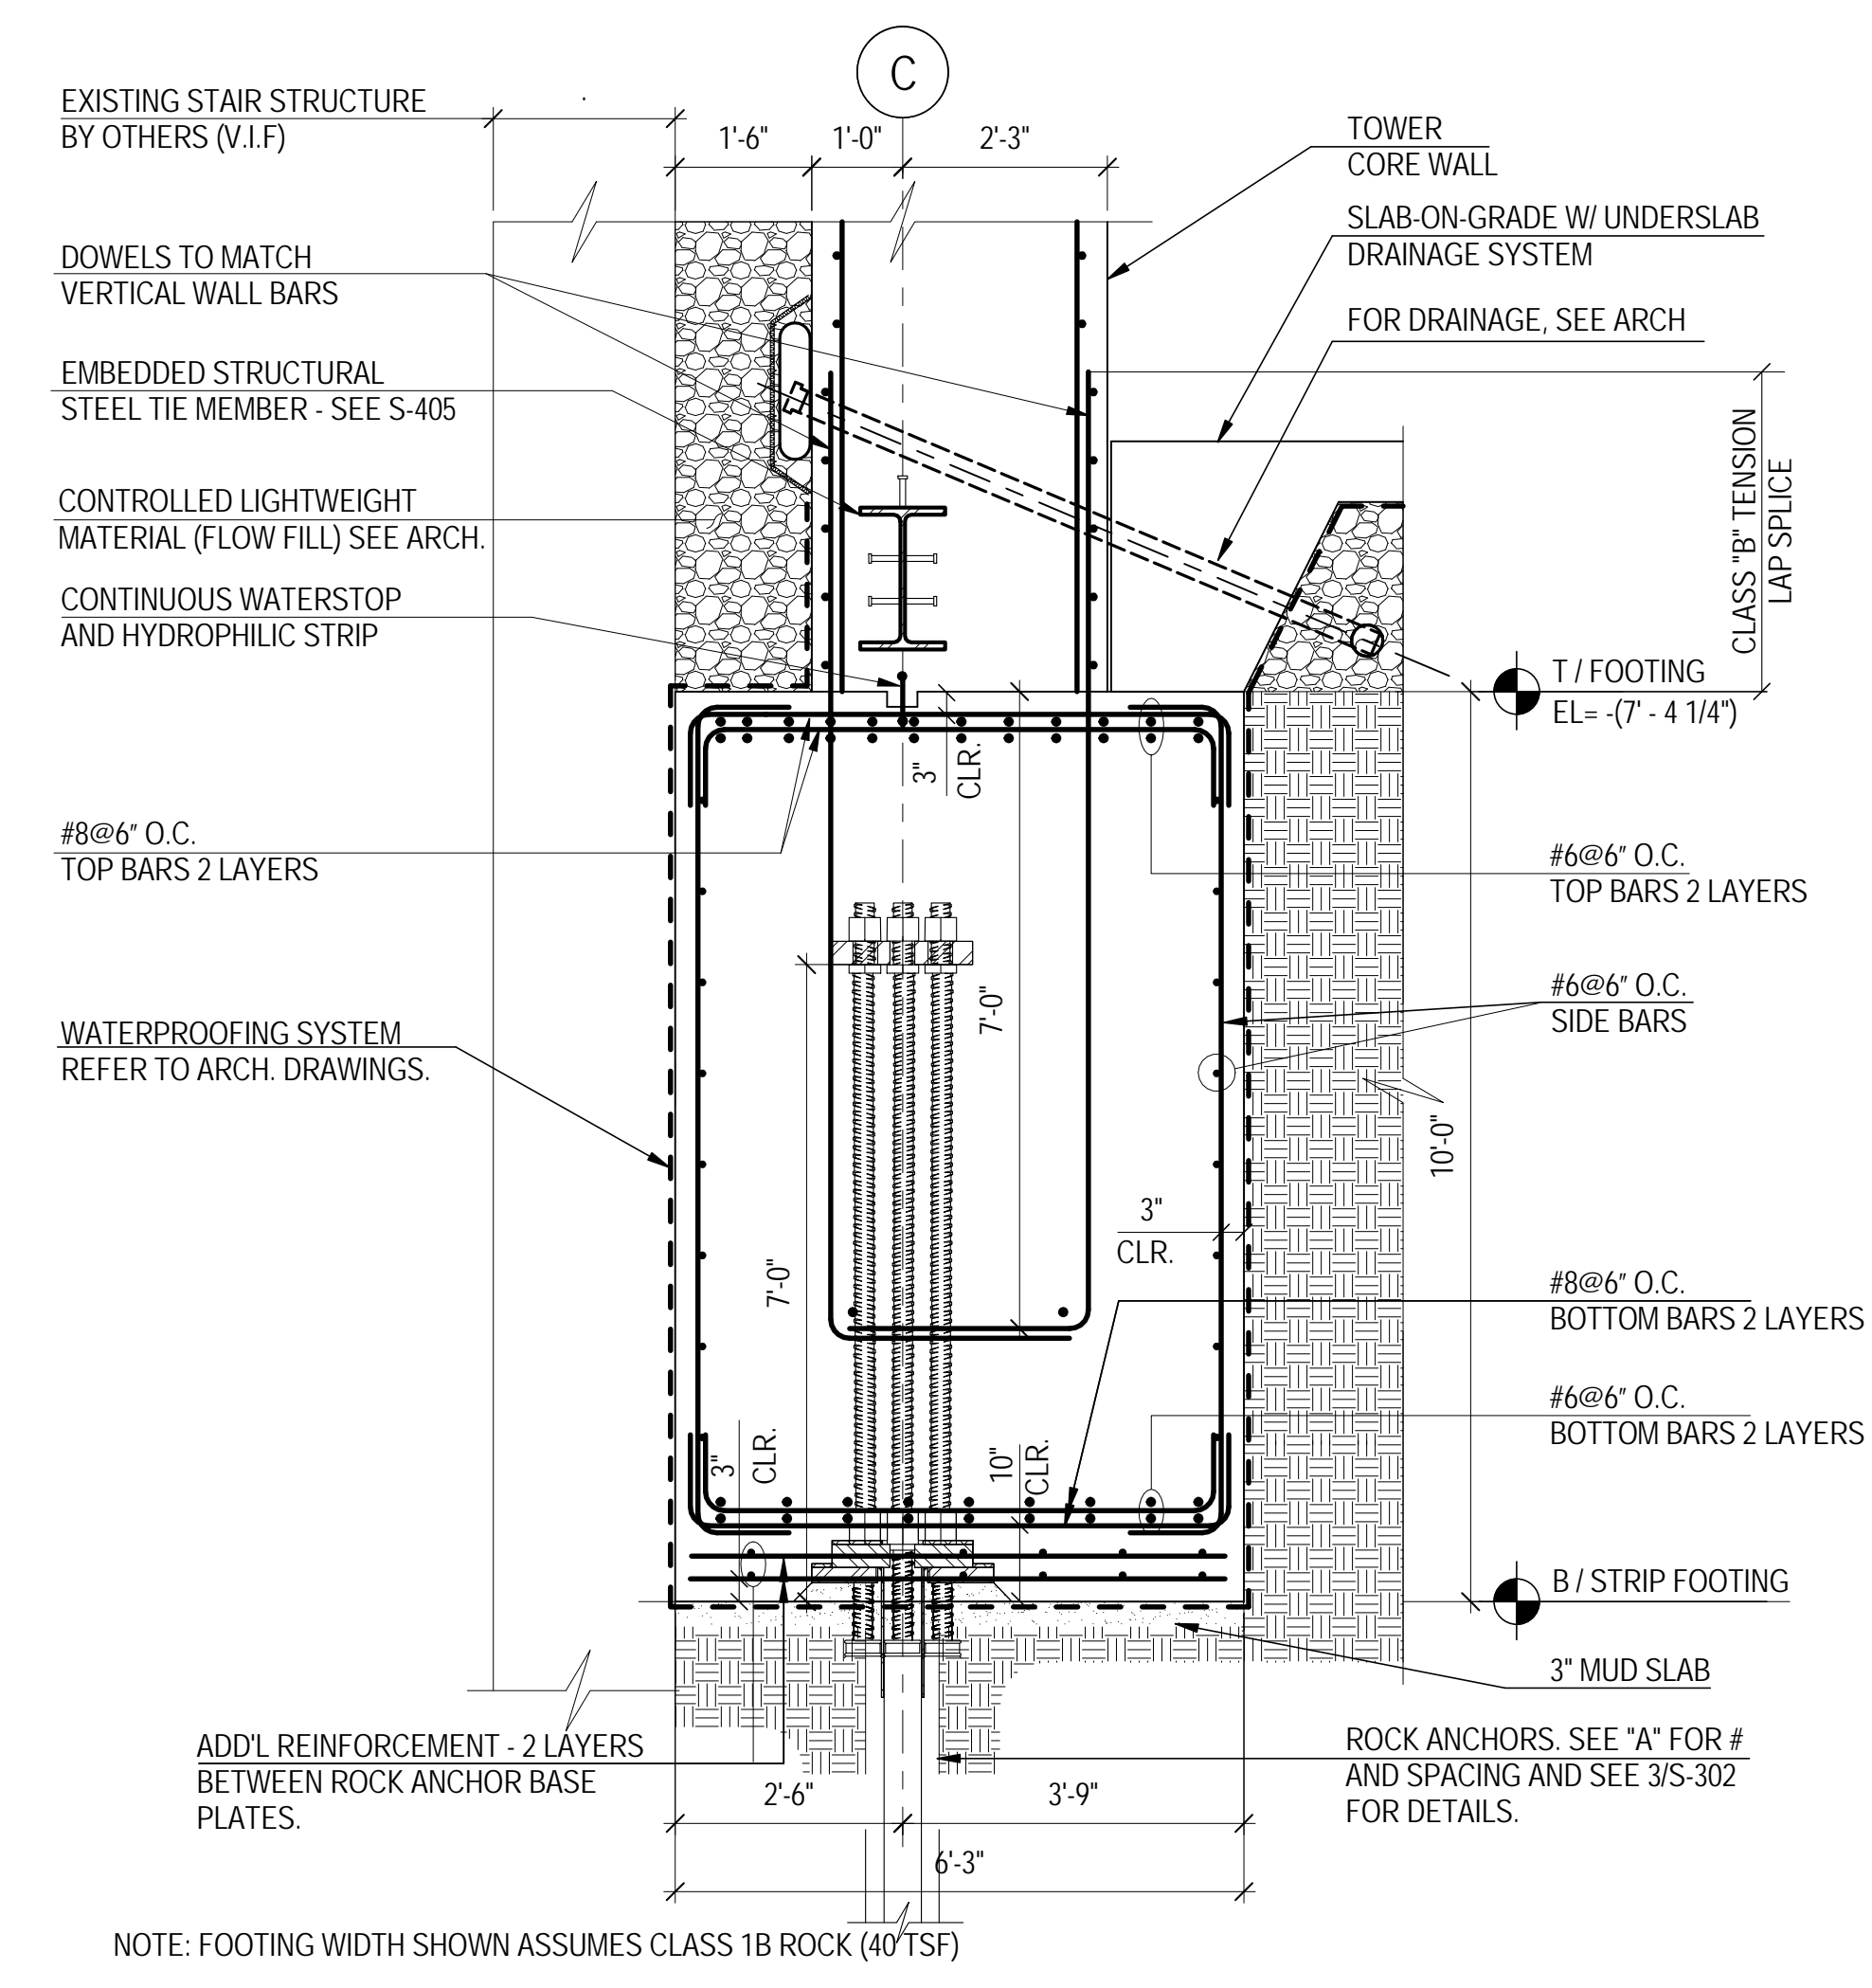
3A LOWER - SECTION THRU EAST EXTERIOR WALL CONT. FOOTING ON ROCK W/ ROCK ANCHORS
NOT TO SCALE

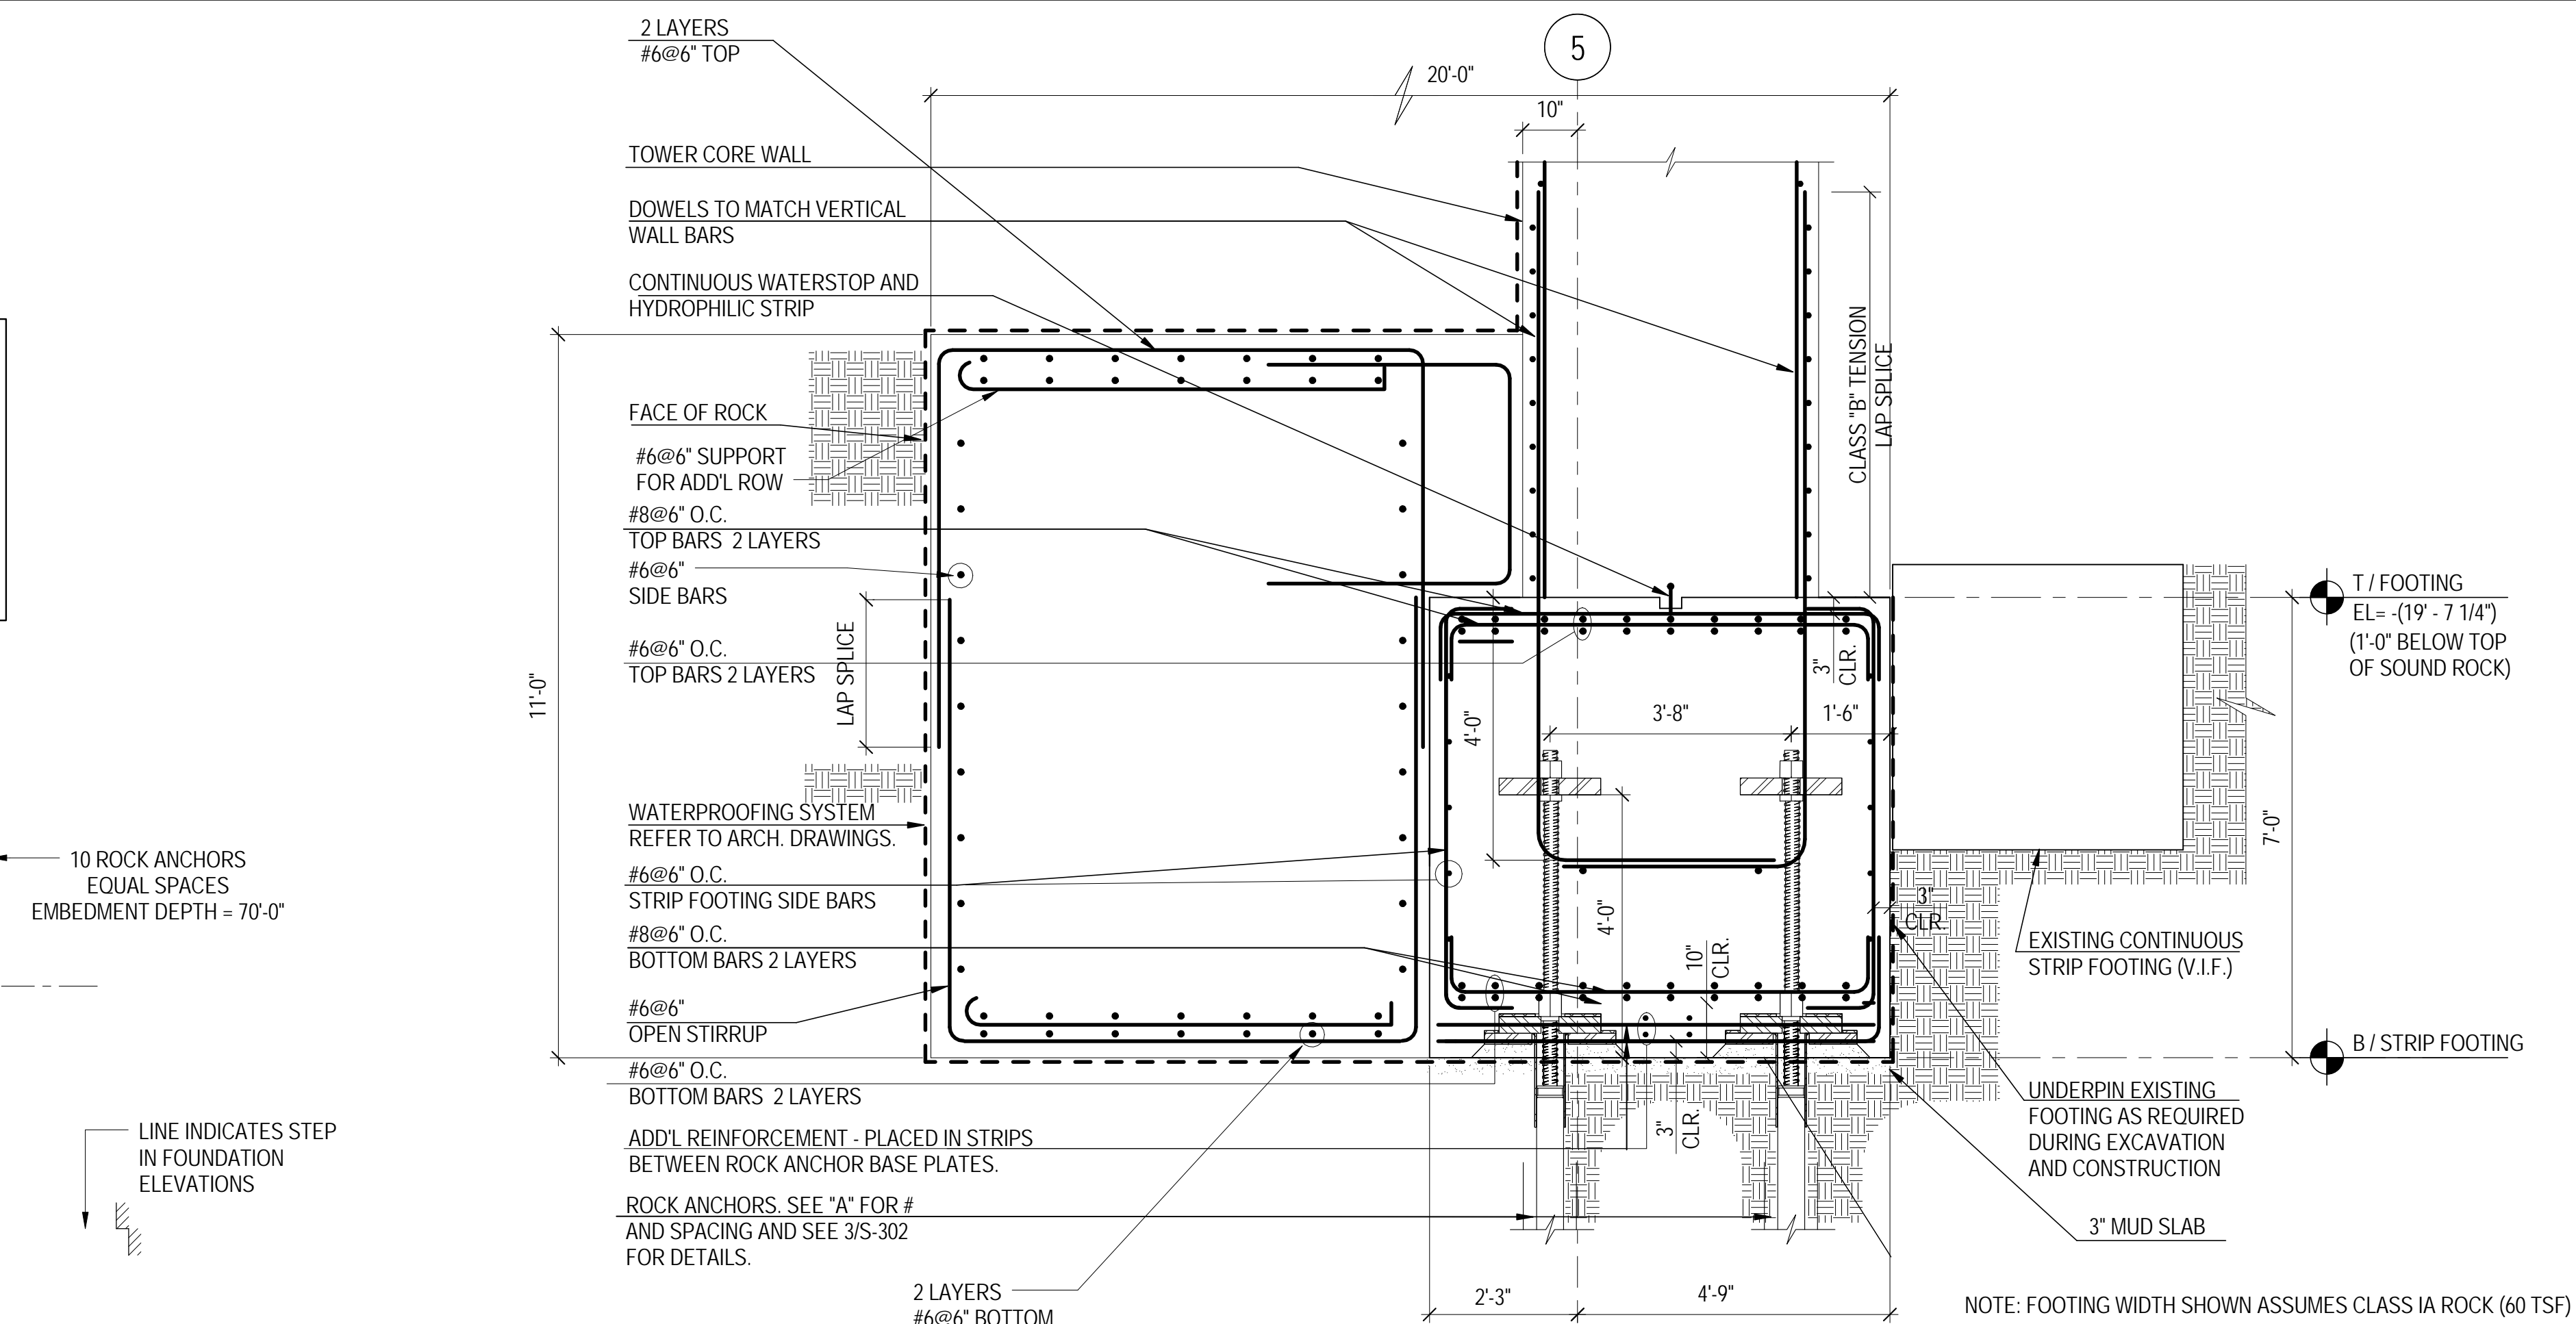


3B UPPER - SECTION THRU EAST EXTERIOR WALL CONT. FOOTING ON ROCK W/ ROCK ANCHORS
NOT TO SCALE

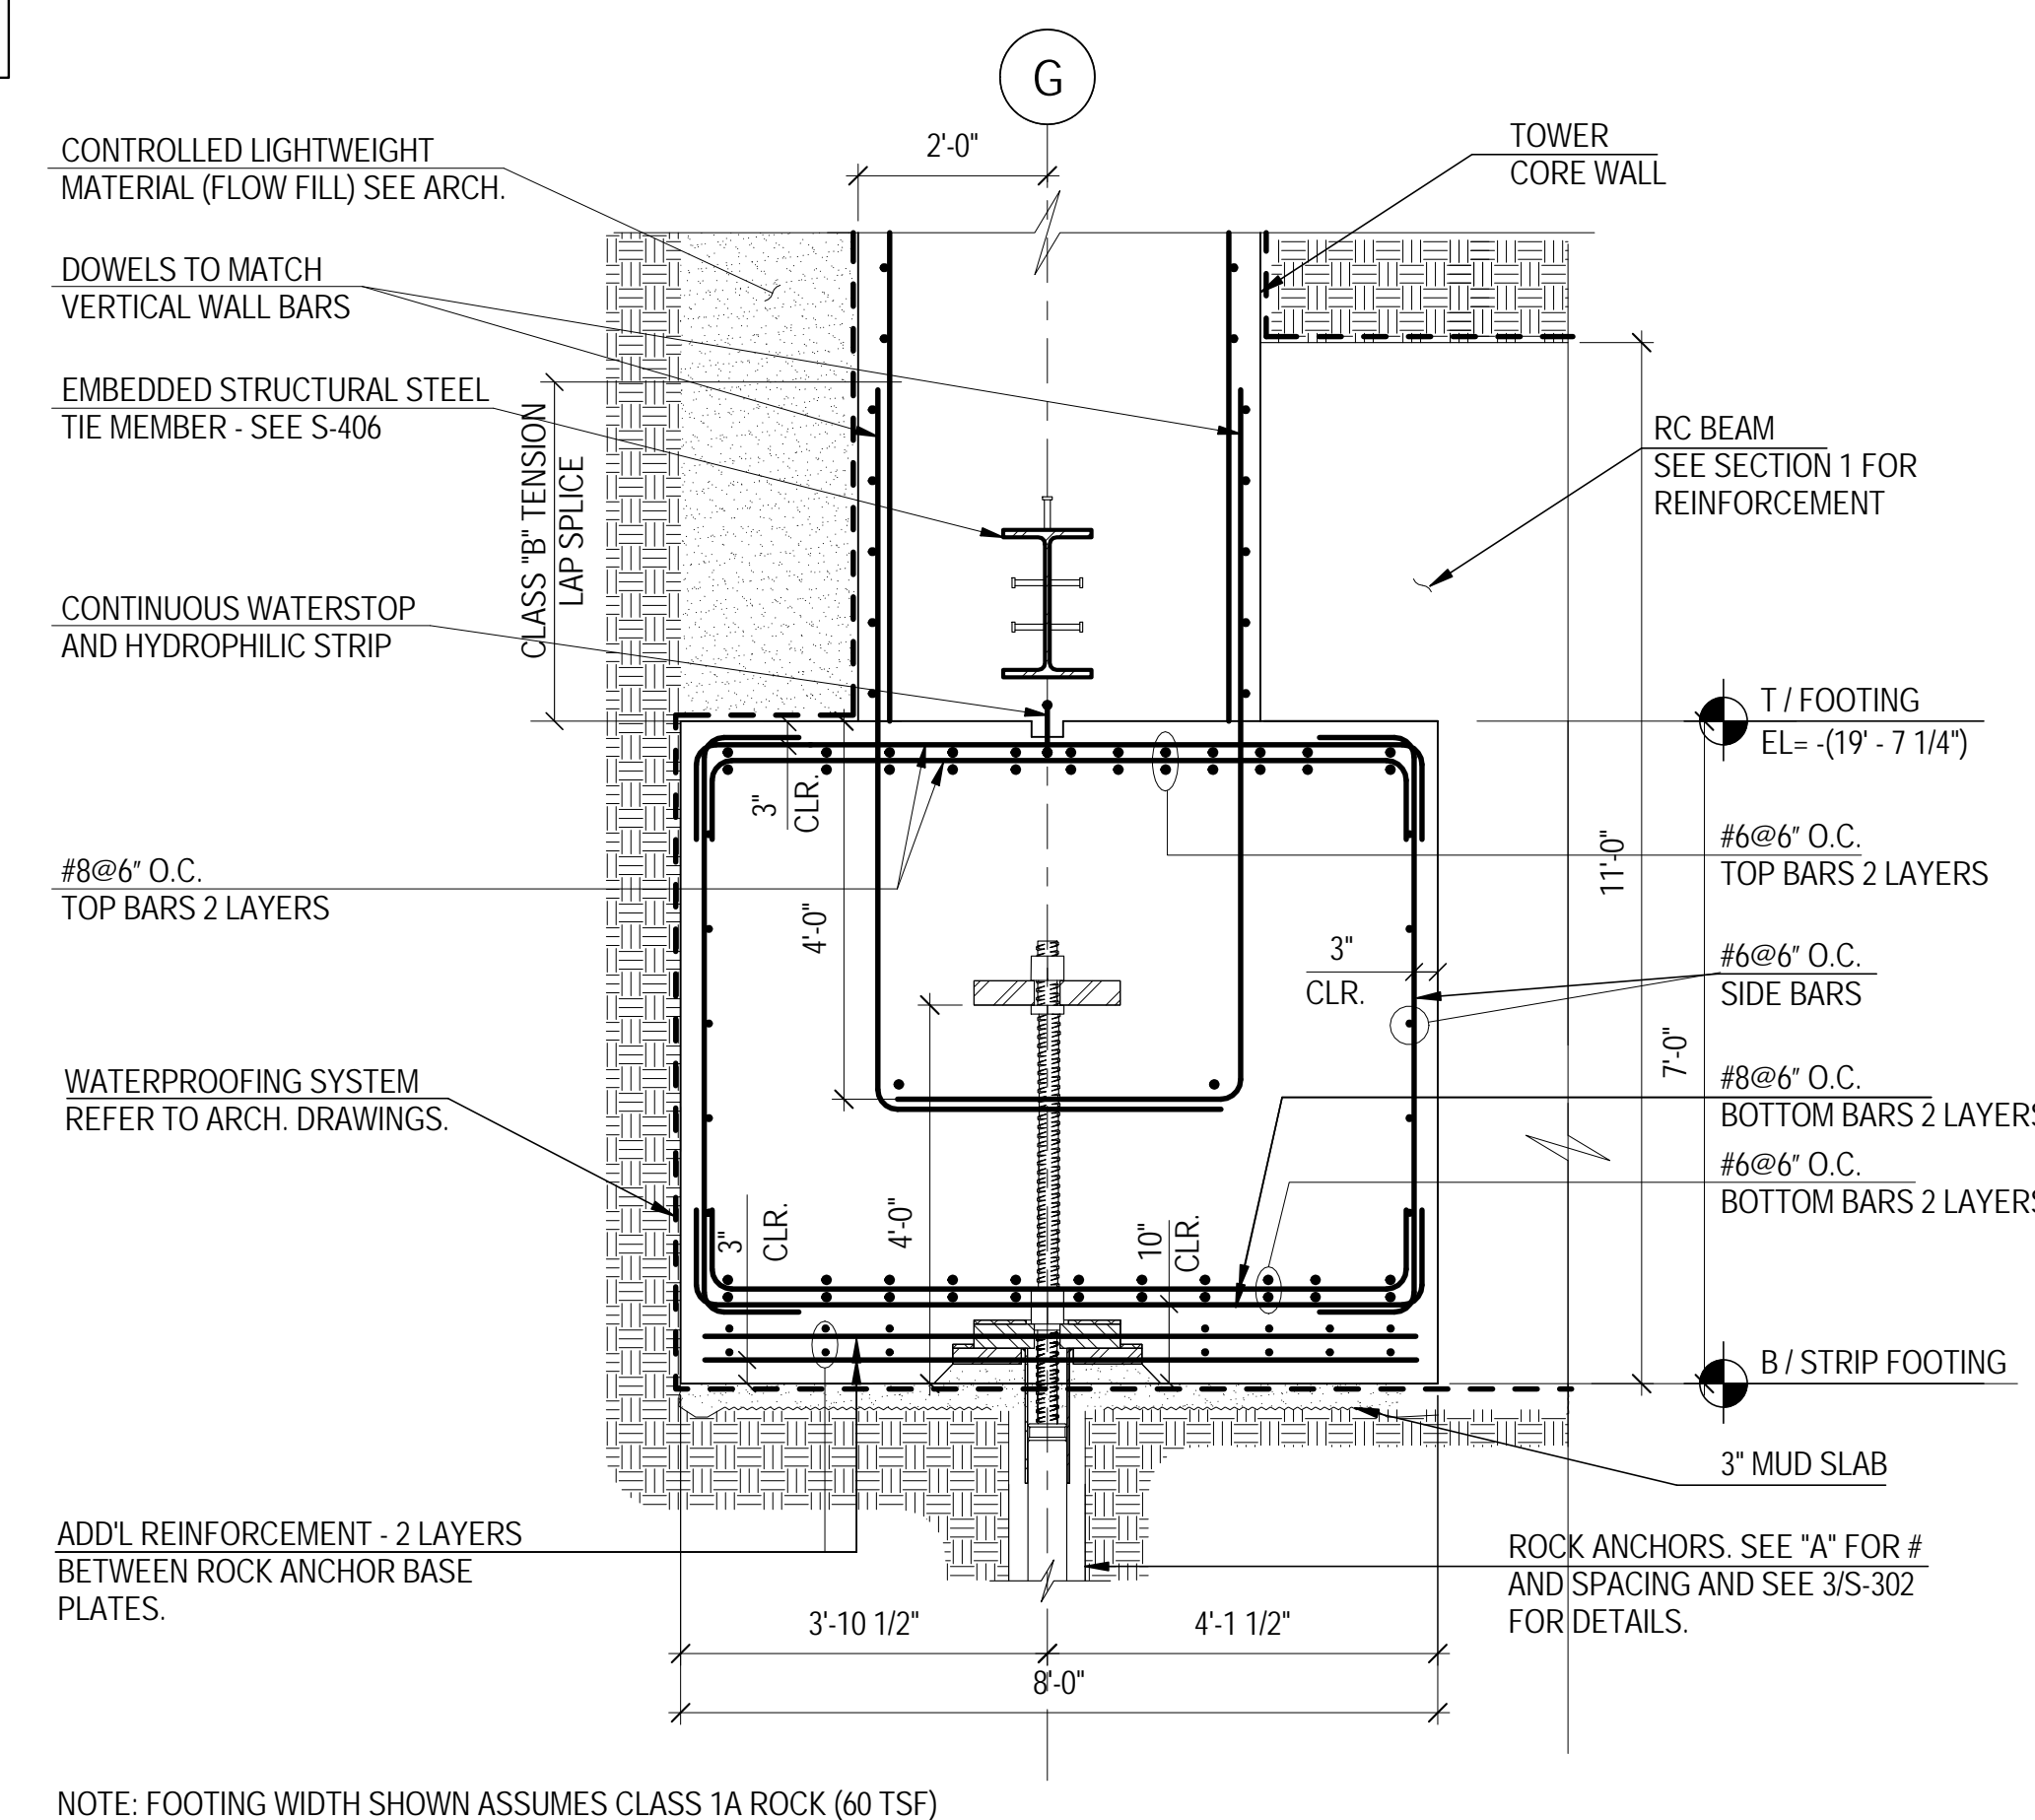

4A LOWER - SECTION THRU WEST EXTERIOR WALL CONT. FOOTING ON ROCK W/ ROCK ANCHORS
NOT TO SCALE

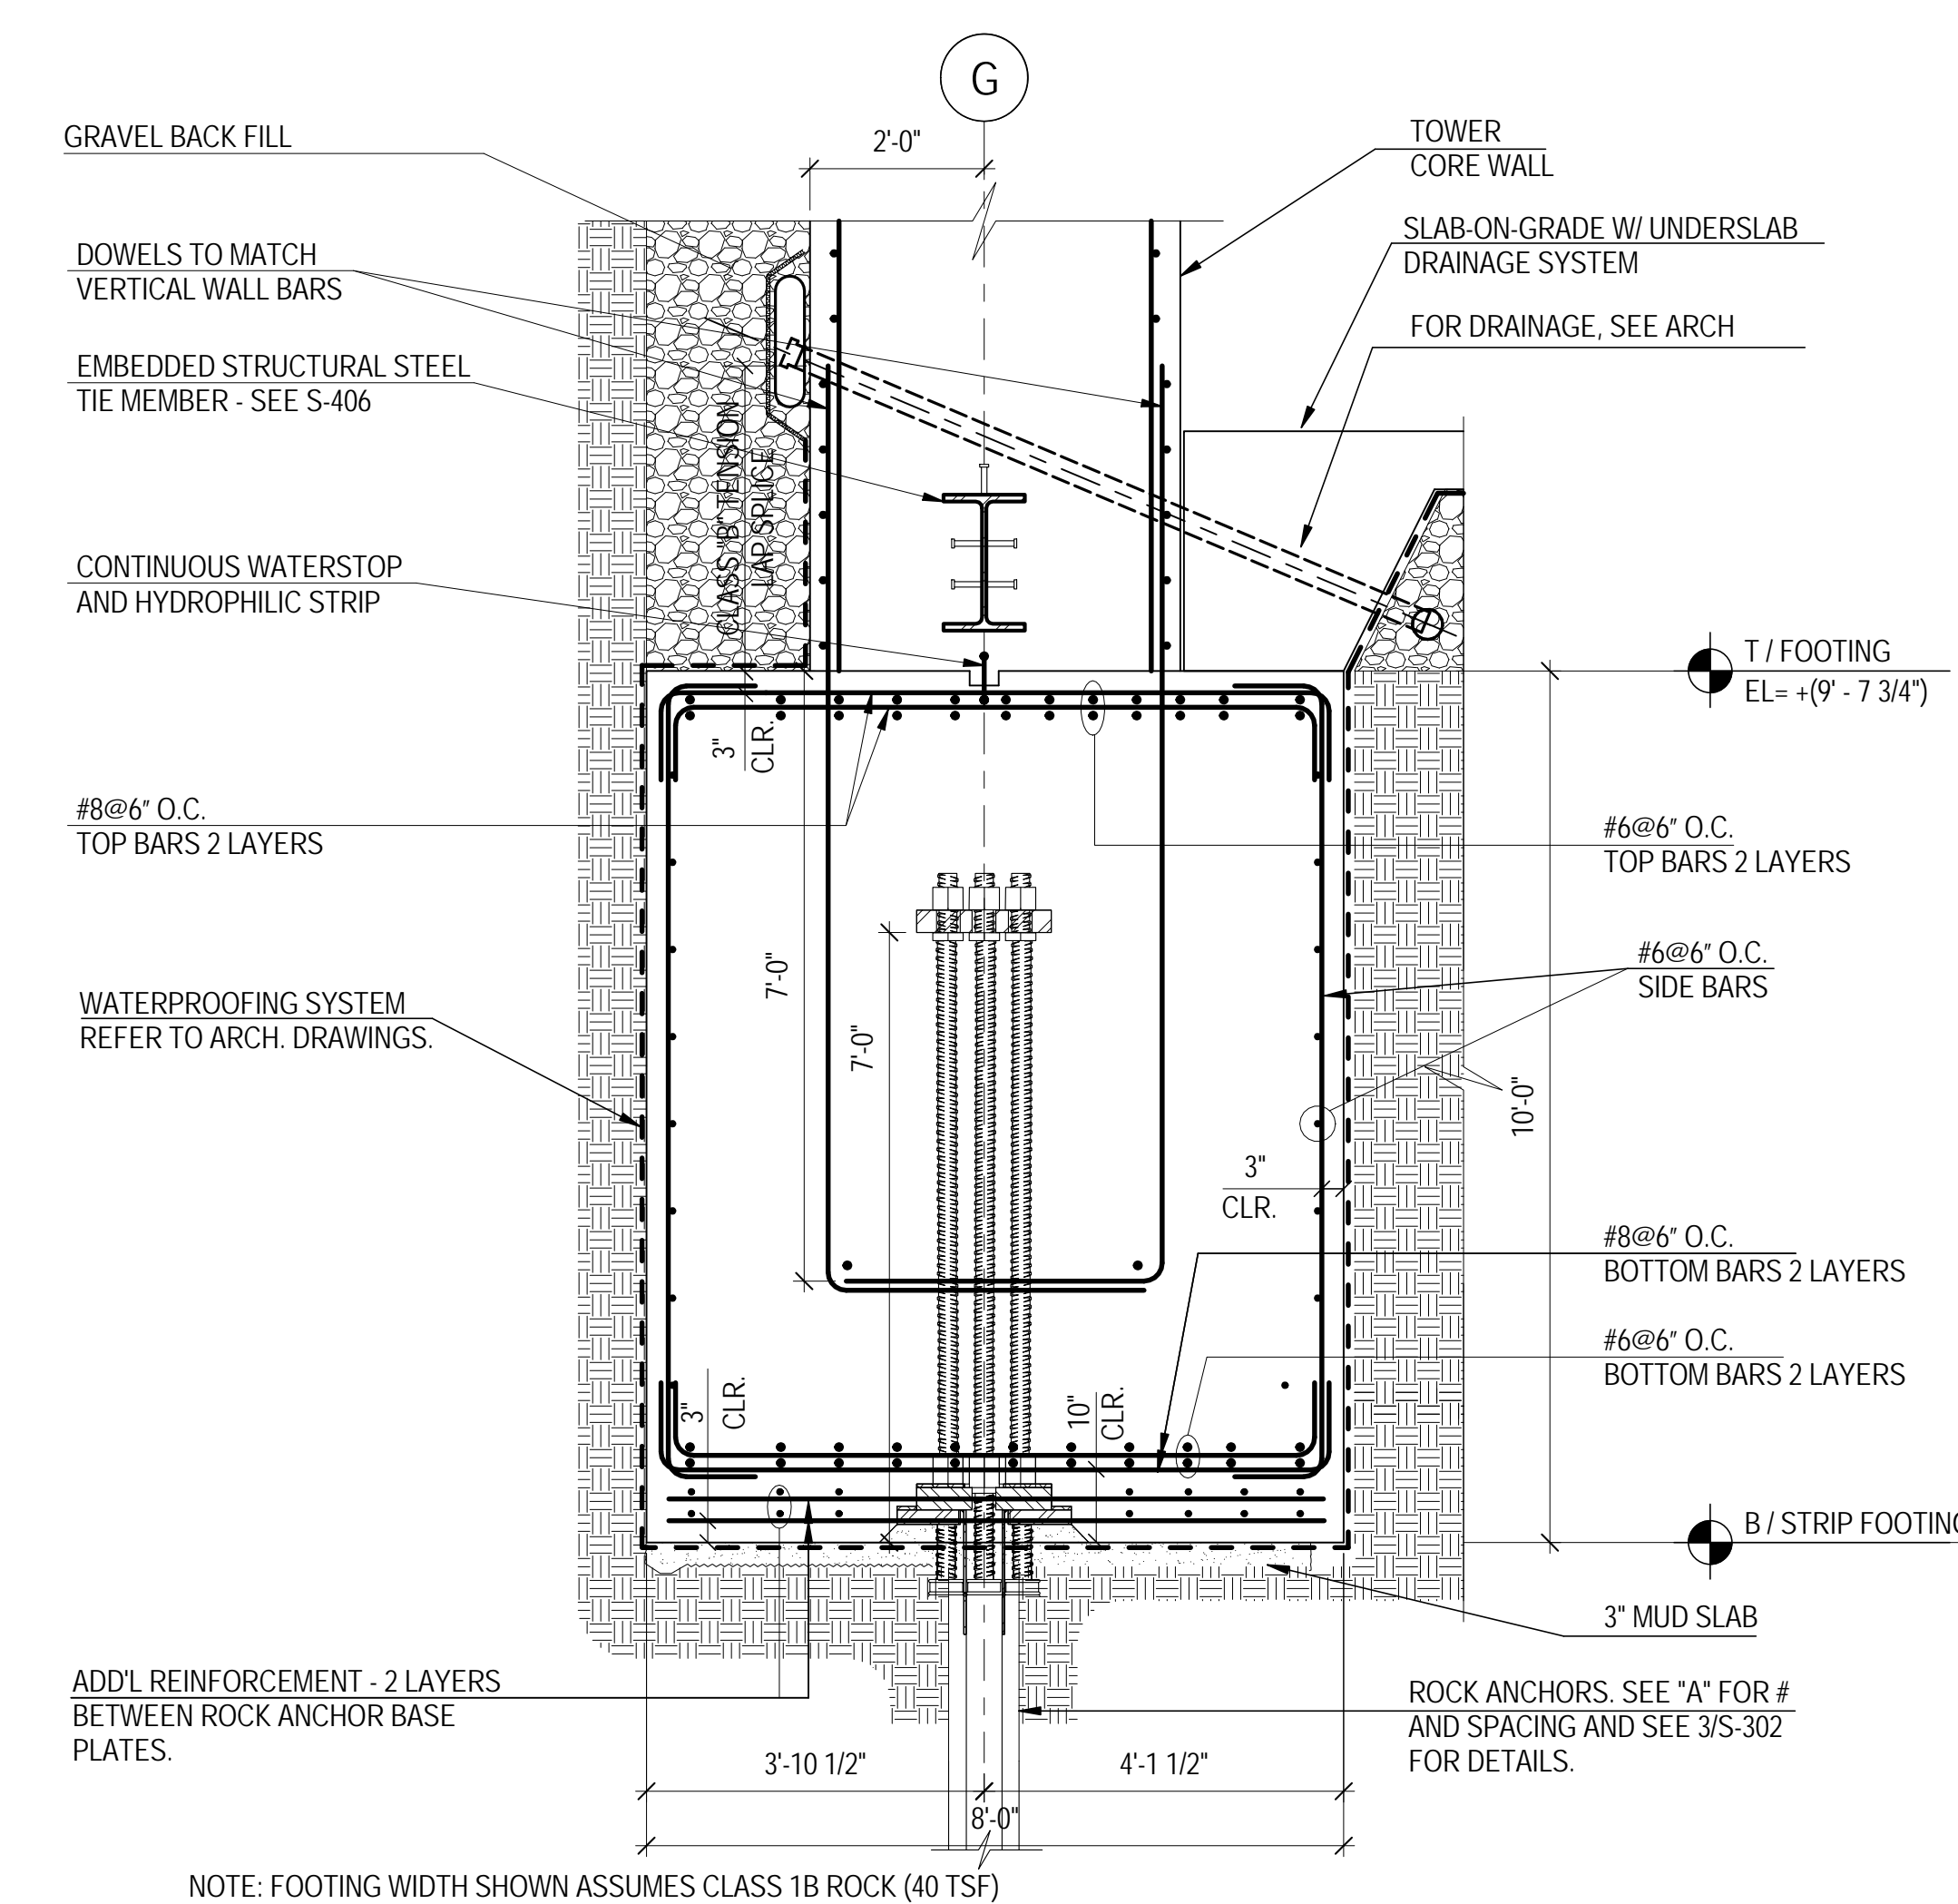

4B UPPER - SECTION THRU WEST EXTERIOR WALL CONT. FOOTING ON ROCK W/ ROCK ANCHORS
NOT TO SCALE



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
Acoustical Consultant
Cerami & Associates
404 Fifth Avenue #8, New York, NY 10016

Vibration Consultant
Wilson, Uhrig & Associates, Inc.
65 Broadway, Suite 401, New York, NY 10006


Code Consultants
Code Consultants Professional Engineers PC
215 West 40th Street, 15th Floor, New York, NY 10018

Facade Maintenance Consultant
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166 Ames Street, Hackensack, NJ 07601

Wind Tunnel Consultant
Rowan Williams Davies & Irwin Inc.
650 Woodlawn Road West, Guelph
Ontario, Canada N1K 1B8



Key Plan:

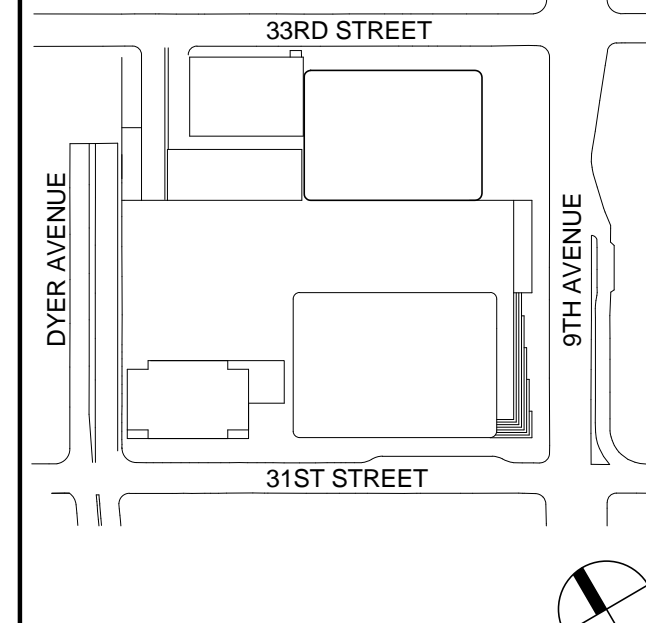

Seal & Signature:

**PRELIMINARY
NOT FOR CONSTRUCTION**

Rev.	Date	Description
1	18 MAR 2012	ISSUED FOR RECONCILIATION
2	12 JUL 2013	ISSUED FOR 90% DESIGN DEVELOPMENT
3	15 NOV 2013	ISSUED FOR 20% PROGRESS PRICING
4	20 DEC 2013	ISSUED FOR FOUNDATION PERMIT
5	20 JUN 2014	ISSUED FOR FOUNDATION PERMIT
6	20 JUN 2014	ISSUED FOR FOUNDATION BID

Project No.: 211157

Date: 20 JUN 2014

Scale: As indicated

File No: S-301

B-SCAN Sheet No.: S-301.00

Sheet No.: S-301

Page No.: 37 of 90



MANHATTAN WEST:
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375 Ninth Avenue, New York, NY 10001
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102 East 8th Street, Suite 1, Mill Valley, California 94941

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14 Penn Plaza, 22nd W, 34th Street #610,
New York, NY 10122

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250 State Street #F1, North Haven, CT 06473

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65 Broadway, Suite 401, New York, NY 10006

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Code Consultants Professional Engineers PC
215 West 40th Street, 15th Floor, New York, NY 10018

Facade Maintenance Consultant


Entek Engineering LLC
166 Ames Street, Hackensack, NJ 07601

Wind Tunnel Consultant

Rowan Williams Davies & Irwin Inc.
680 Woodlawn Road West, Guelph
Ontario, Canada N1K 1B8



Key Plan:

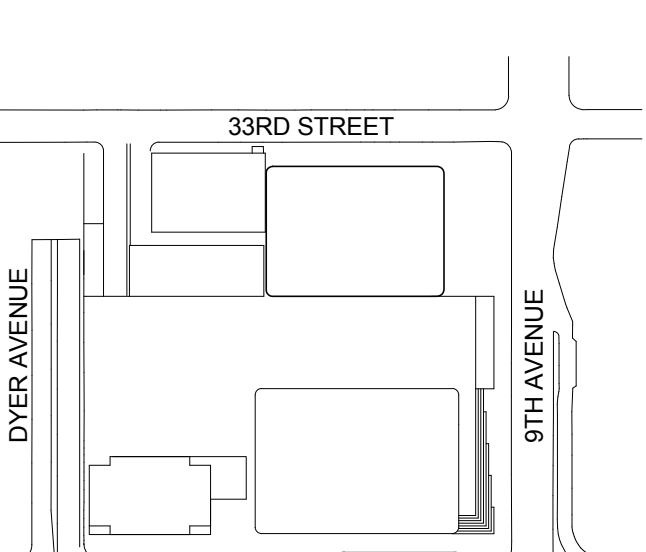

Seal & Signature:

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1	18 MAR 2012	ISSUED FOR RECONCILIATION

No. Date Description

Sheet Name

**CORE WALL
CONT. FOOTINGS
SECTIONS &
DETAILS**

Project No.: 211157

Date: 20 JUN 2014


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File No.: S-302

Page No.: 38 of 90

B-SCAN Sheet No.: S-302.00

Sheet No.: S-302

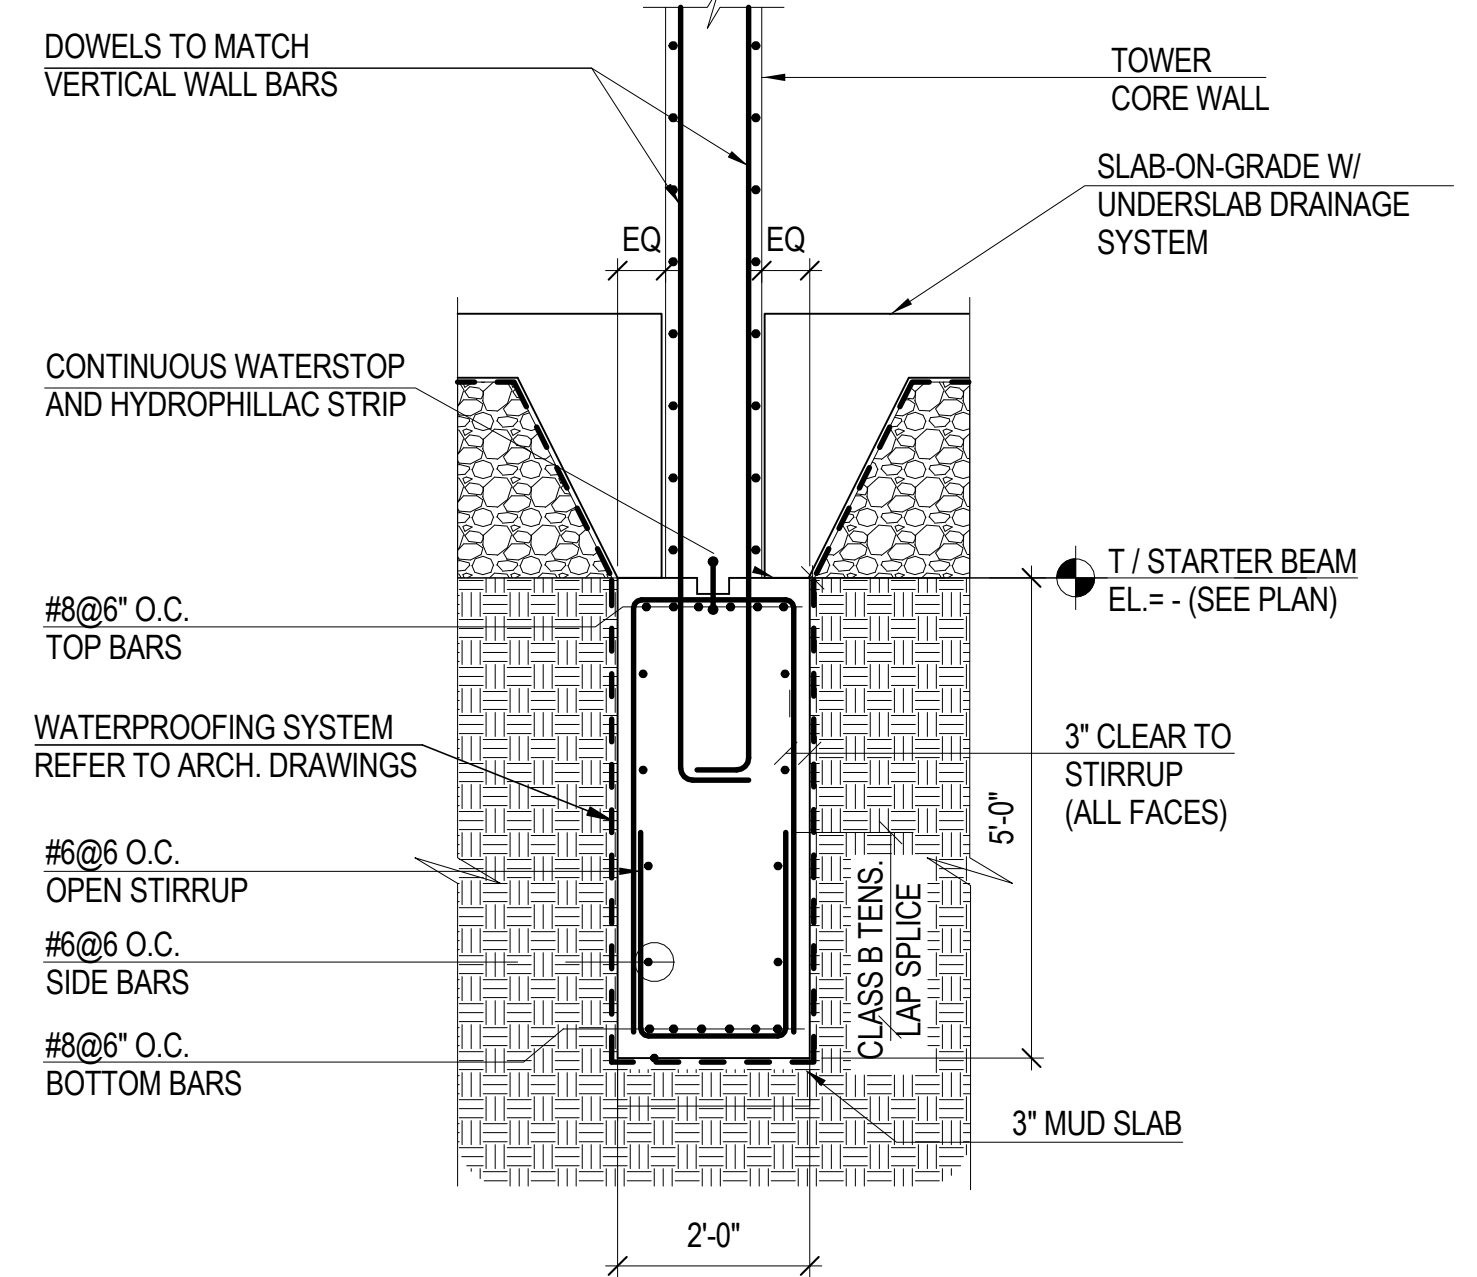

NOTE:
1. FOOTING WIDTH ASSUMES CLASS 1B ROCK (40 TSF) AT HIGHER FOUNDATION ELEVATION.
2. FOOTING WIDTH ASSUMES CLASS 1A ROCK (60 TSF) AT LOWER FOUNDATION ELEVATION.

2 SECTION THRU CONTINUOUS FOOTING UNDER E-W WEB WALLS NOT TO SCALE

INSTALLATION PROCEDURE

1. DETERMINE ANCHOR LOCATION AS INDICATED ON CONTRACT DRAWINGS.
2. DRILL 14\"/>
3. CLEAN DRILL HOLE OF ALL DRILL CUTTINGS AND DEBRIS.
4. INSERT A GROUT PIPE AND PREFABRICATED ANCHOR TO THE BOTTOM OF THE ANCHOR HOLE AND PUMP FULL OF CEMENT GROUT DISPLACING ANY STANDING WATER.
5. AFTER GROUT REACHES SPECIFIED STRENGTH, (3 DAYS FOR PORTLAND CEMENT TYPE III OR 7 DAYS FOR PORTLAND TYPE I OR II) LOAD ANCHORS USING CALIBRATED JACKS.
6. AFTER SUCCESSFUL TESTING, LOCK OFF ANCHOR AT 680 KIP, USING EXTERNAL WRENCH AND RELEASE PRESSURE FROM JACK.
7. INSTALL UPPER PLATE & NUTS AND POUR FOOTING CONCRETE.

GENERAL NOTES



1. ROCK ANCHORS SHALL BE IN CONFORMANCE WITH PTI (POST TENSIONING INSTITUTE) LATEST RECOMMENDATIONS ON ROCK & SOIL ANCHORS.
2. ALL ANCHORS SHALL BE 3\"/>
3. THE THREADED BAR SHALL BE PROVIDED WITH SHOP-FABRICATED DOUBLE CORROSION PROTECTION. THE ANCHOR BARS SHALL BE ENCAPSULATED WITH HIGH STRENGTH PVC CORRUGATED SHEATHING (COMPRESSIVE STRENGTH=7000 psi) AND PRE-GROUTED.
4. PLATES SHALL CONFORM TO ASTM A-36.
5. ANCHOR NUTS & COUPLERS SHALL BE CAPABLE OF DEVELOPING 100% OF THE ULTIMATE STRENGTH OF THREADBAR.
6. CARE MUST BE TAKEN NOT TO DAMAGE THE THREADED BAR TENDONS. KEEP THREADBARS FREE OF DIRT OR OTHER DELETERIOUS SUBSTANCES.
7. DO NOT WELD IN THE VICINITY OF THE HIGH STRENGTH BARS.
8. DO NOT USE ANCHORS AS A GROUND FOR WELDING.
9. THE FIRST THREE ANCHORS INSTALLED, AND 10% OF THE REMAINING ANCHORS SHALL BE PERFORMANCE TESTED. ALL OTHER ANCHORS SHALL BE PROOF TESTED USING A CALIBRATED CENTER HOLE JACK.
10. PERFORMANCE TEST SHALL BE CONDUCTED BY CYCLICALLY AND INCREMENTALLY LOADING AND UNLOADING THE ANCHOR AS NOTED BELOW:

AL, 25P	50P	P=615 KIPS
AL, 25P, 50P	75P	
AL, 25P, 50P, 75P	1,00P	
AL, 25P, 50P, 75P, 1,00P	1,20P	
AL, 25P, 50P, 75P, 1,00P, 1,20P	1,33P	


HOLD 1.33P FOR CREEP TEST. RECORD MOVEMENTS USING A DIAL INDICATOR CAPABLE OF READING INCREMENTS OF .001\"/>

HOLD 1.33P FOR CREEP TEST AS ABOVE.


ANCHOR DESIGN LOAD = 1845 KIPS
ANCHOR LOCK-OFF LOAD = 1845 KIPS

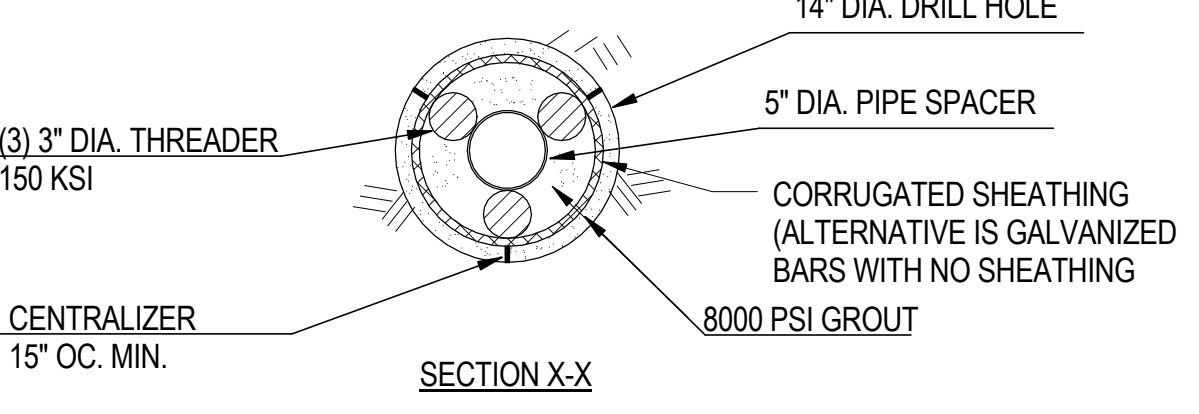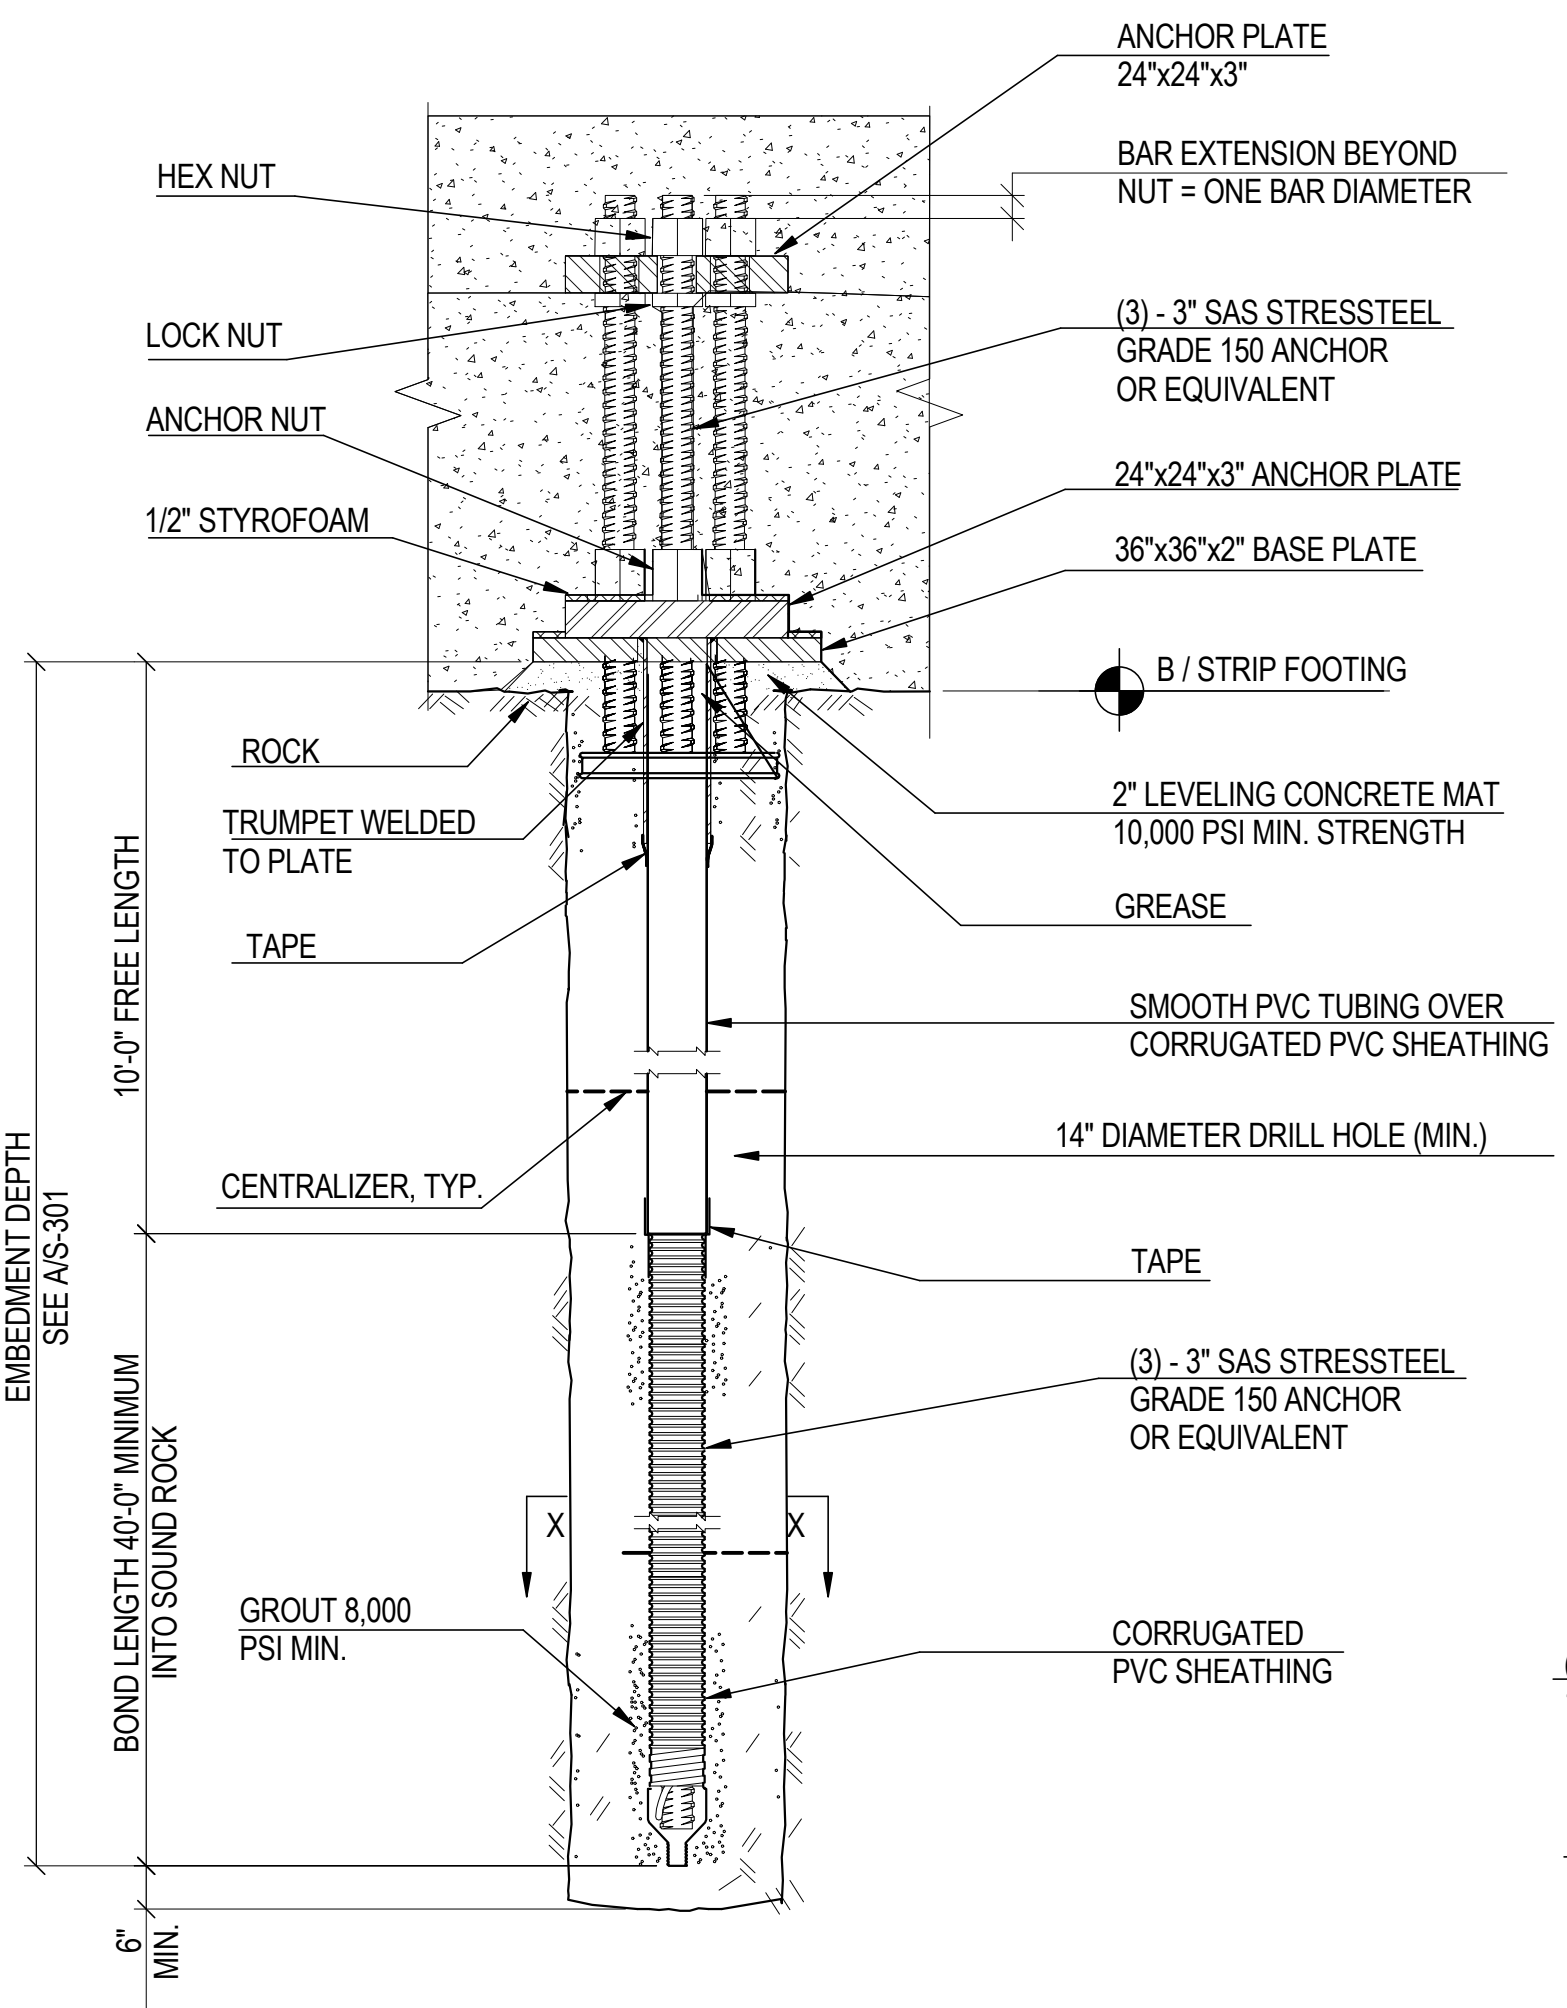

4 TYPICAL FOUNDATION ROCK ANCHOR DETAIL 1\"/>

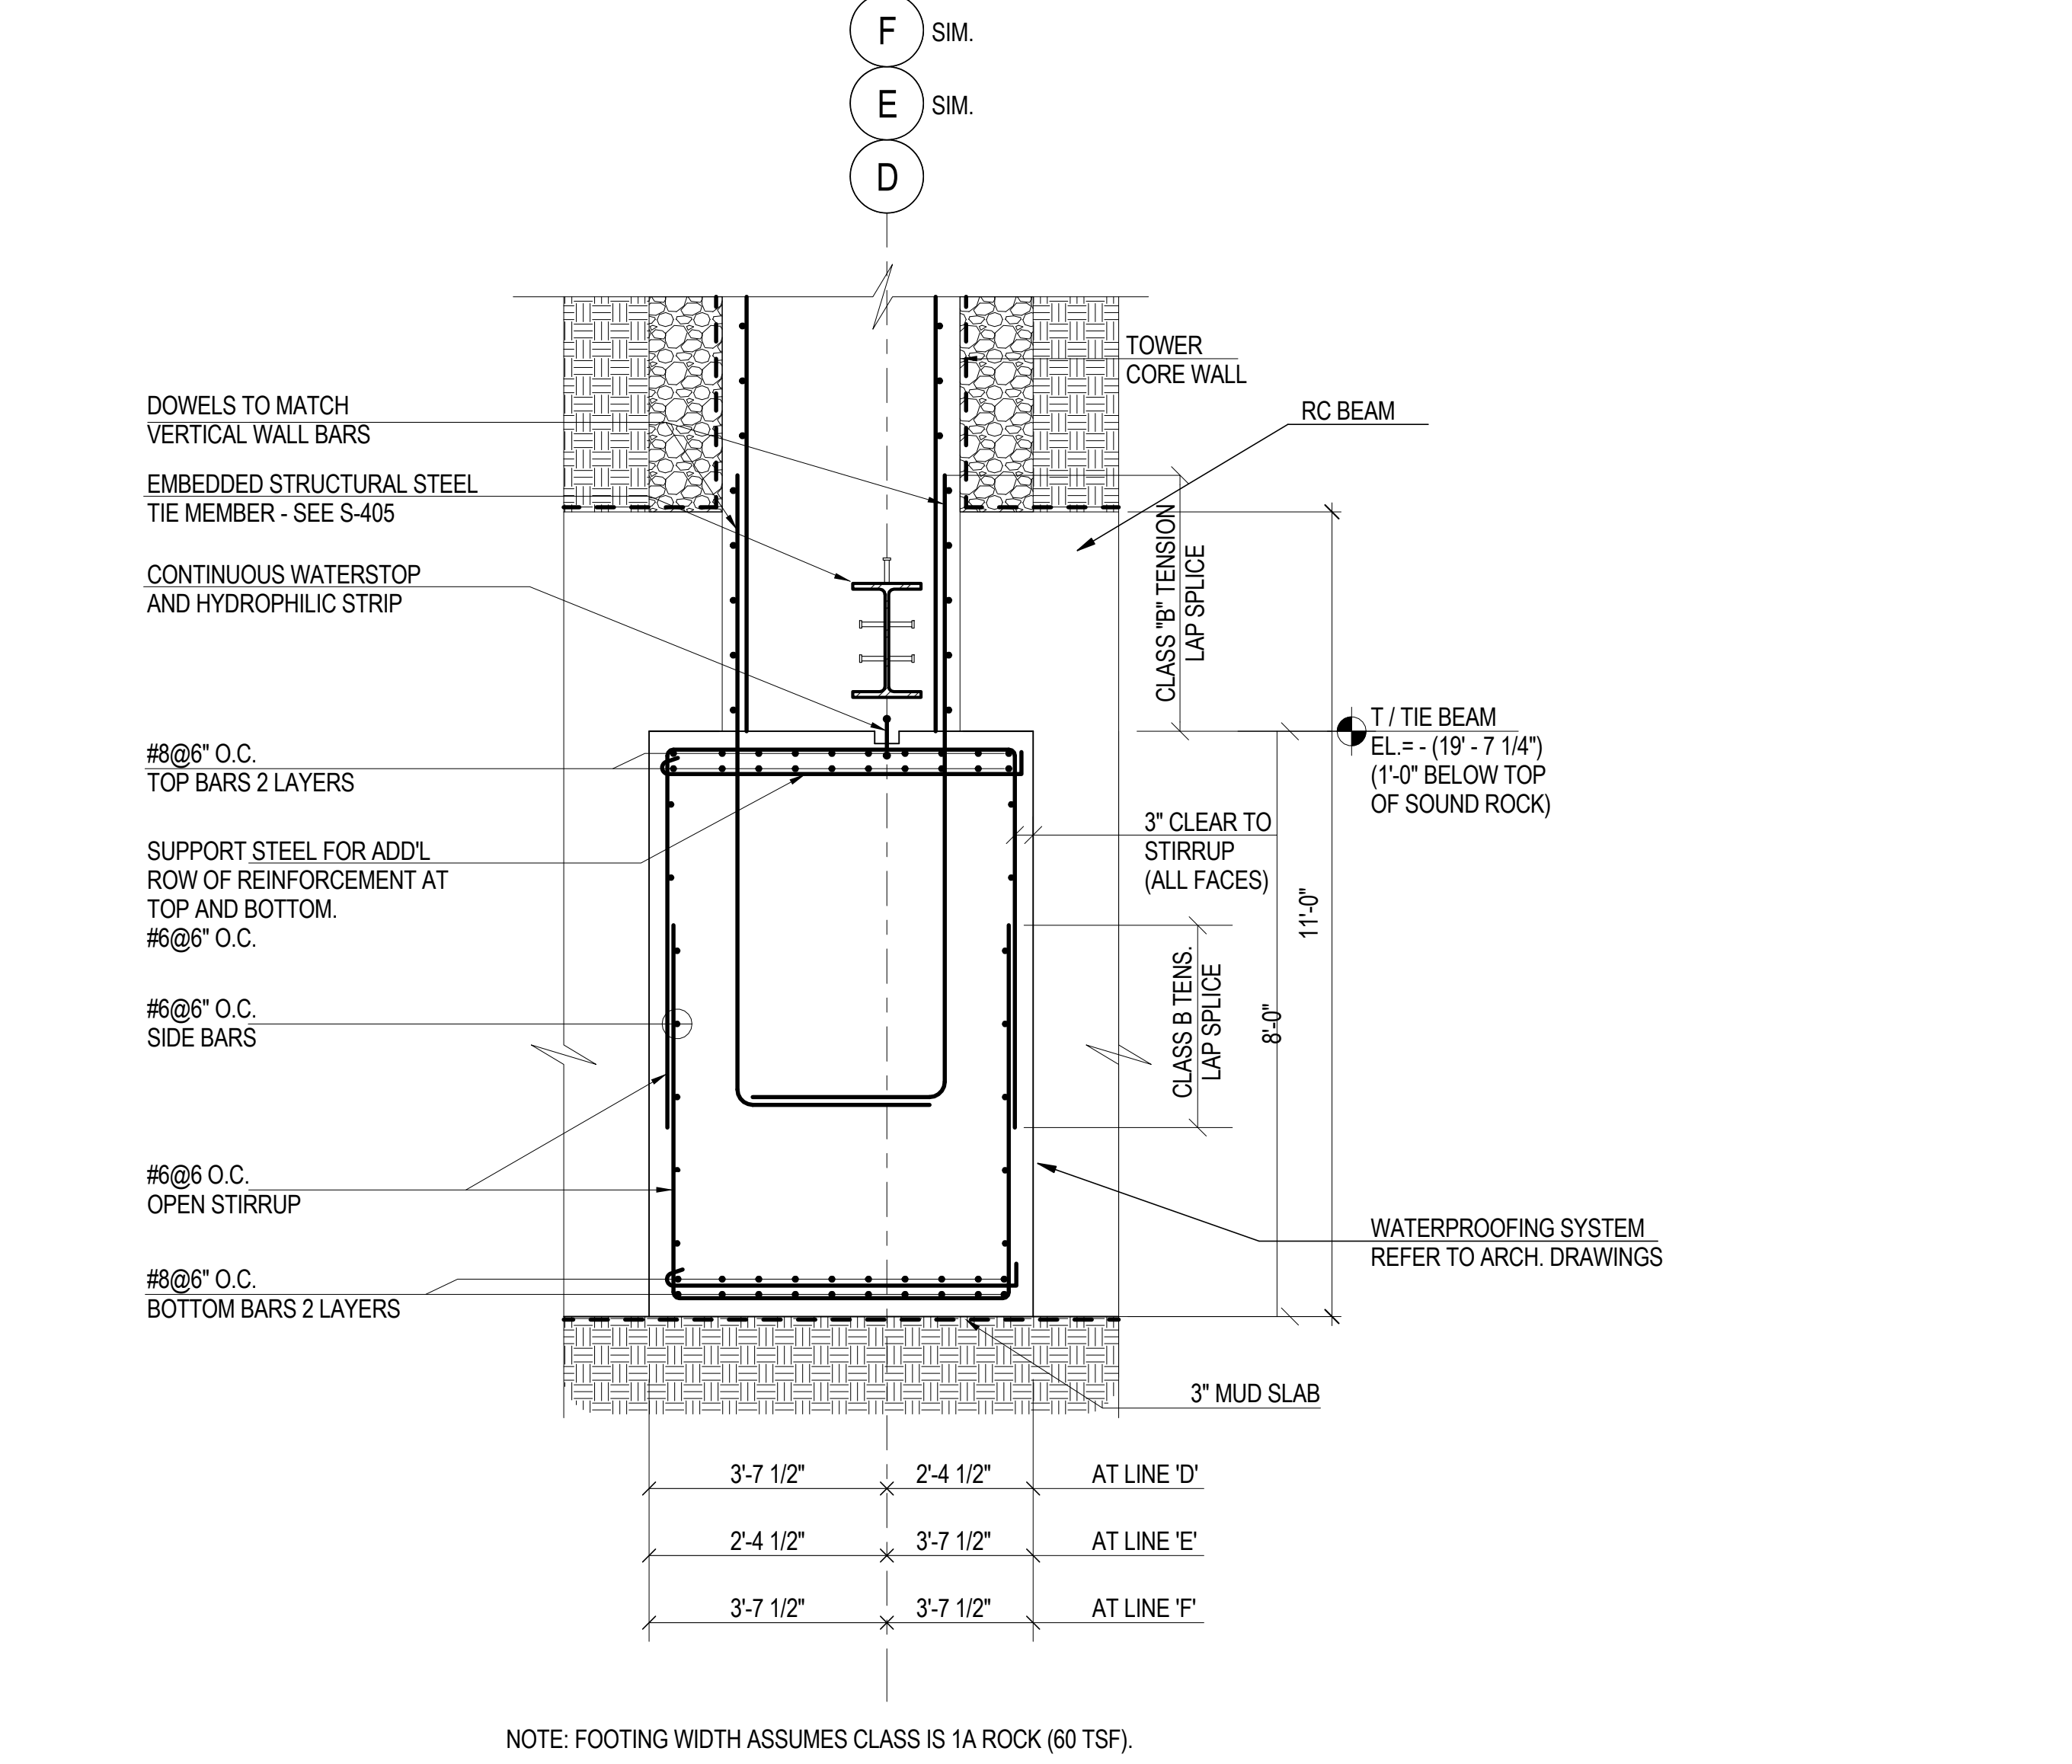


NOTE: FOOTING WIDTH ASSUMES CLASS IS 1A ROCK (60 TSF).

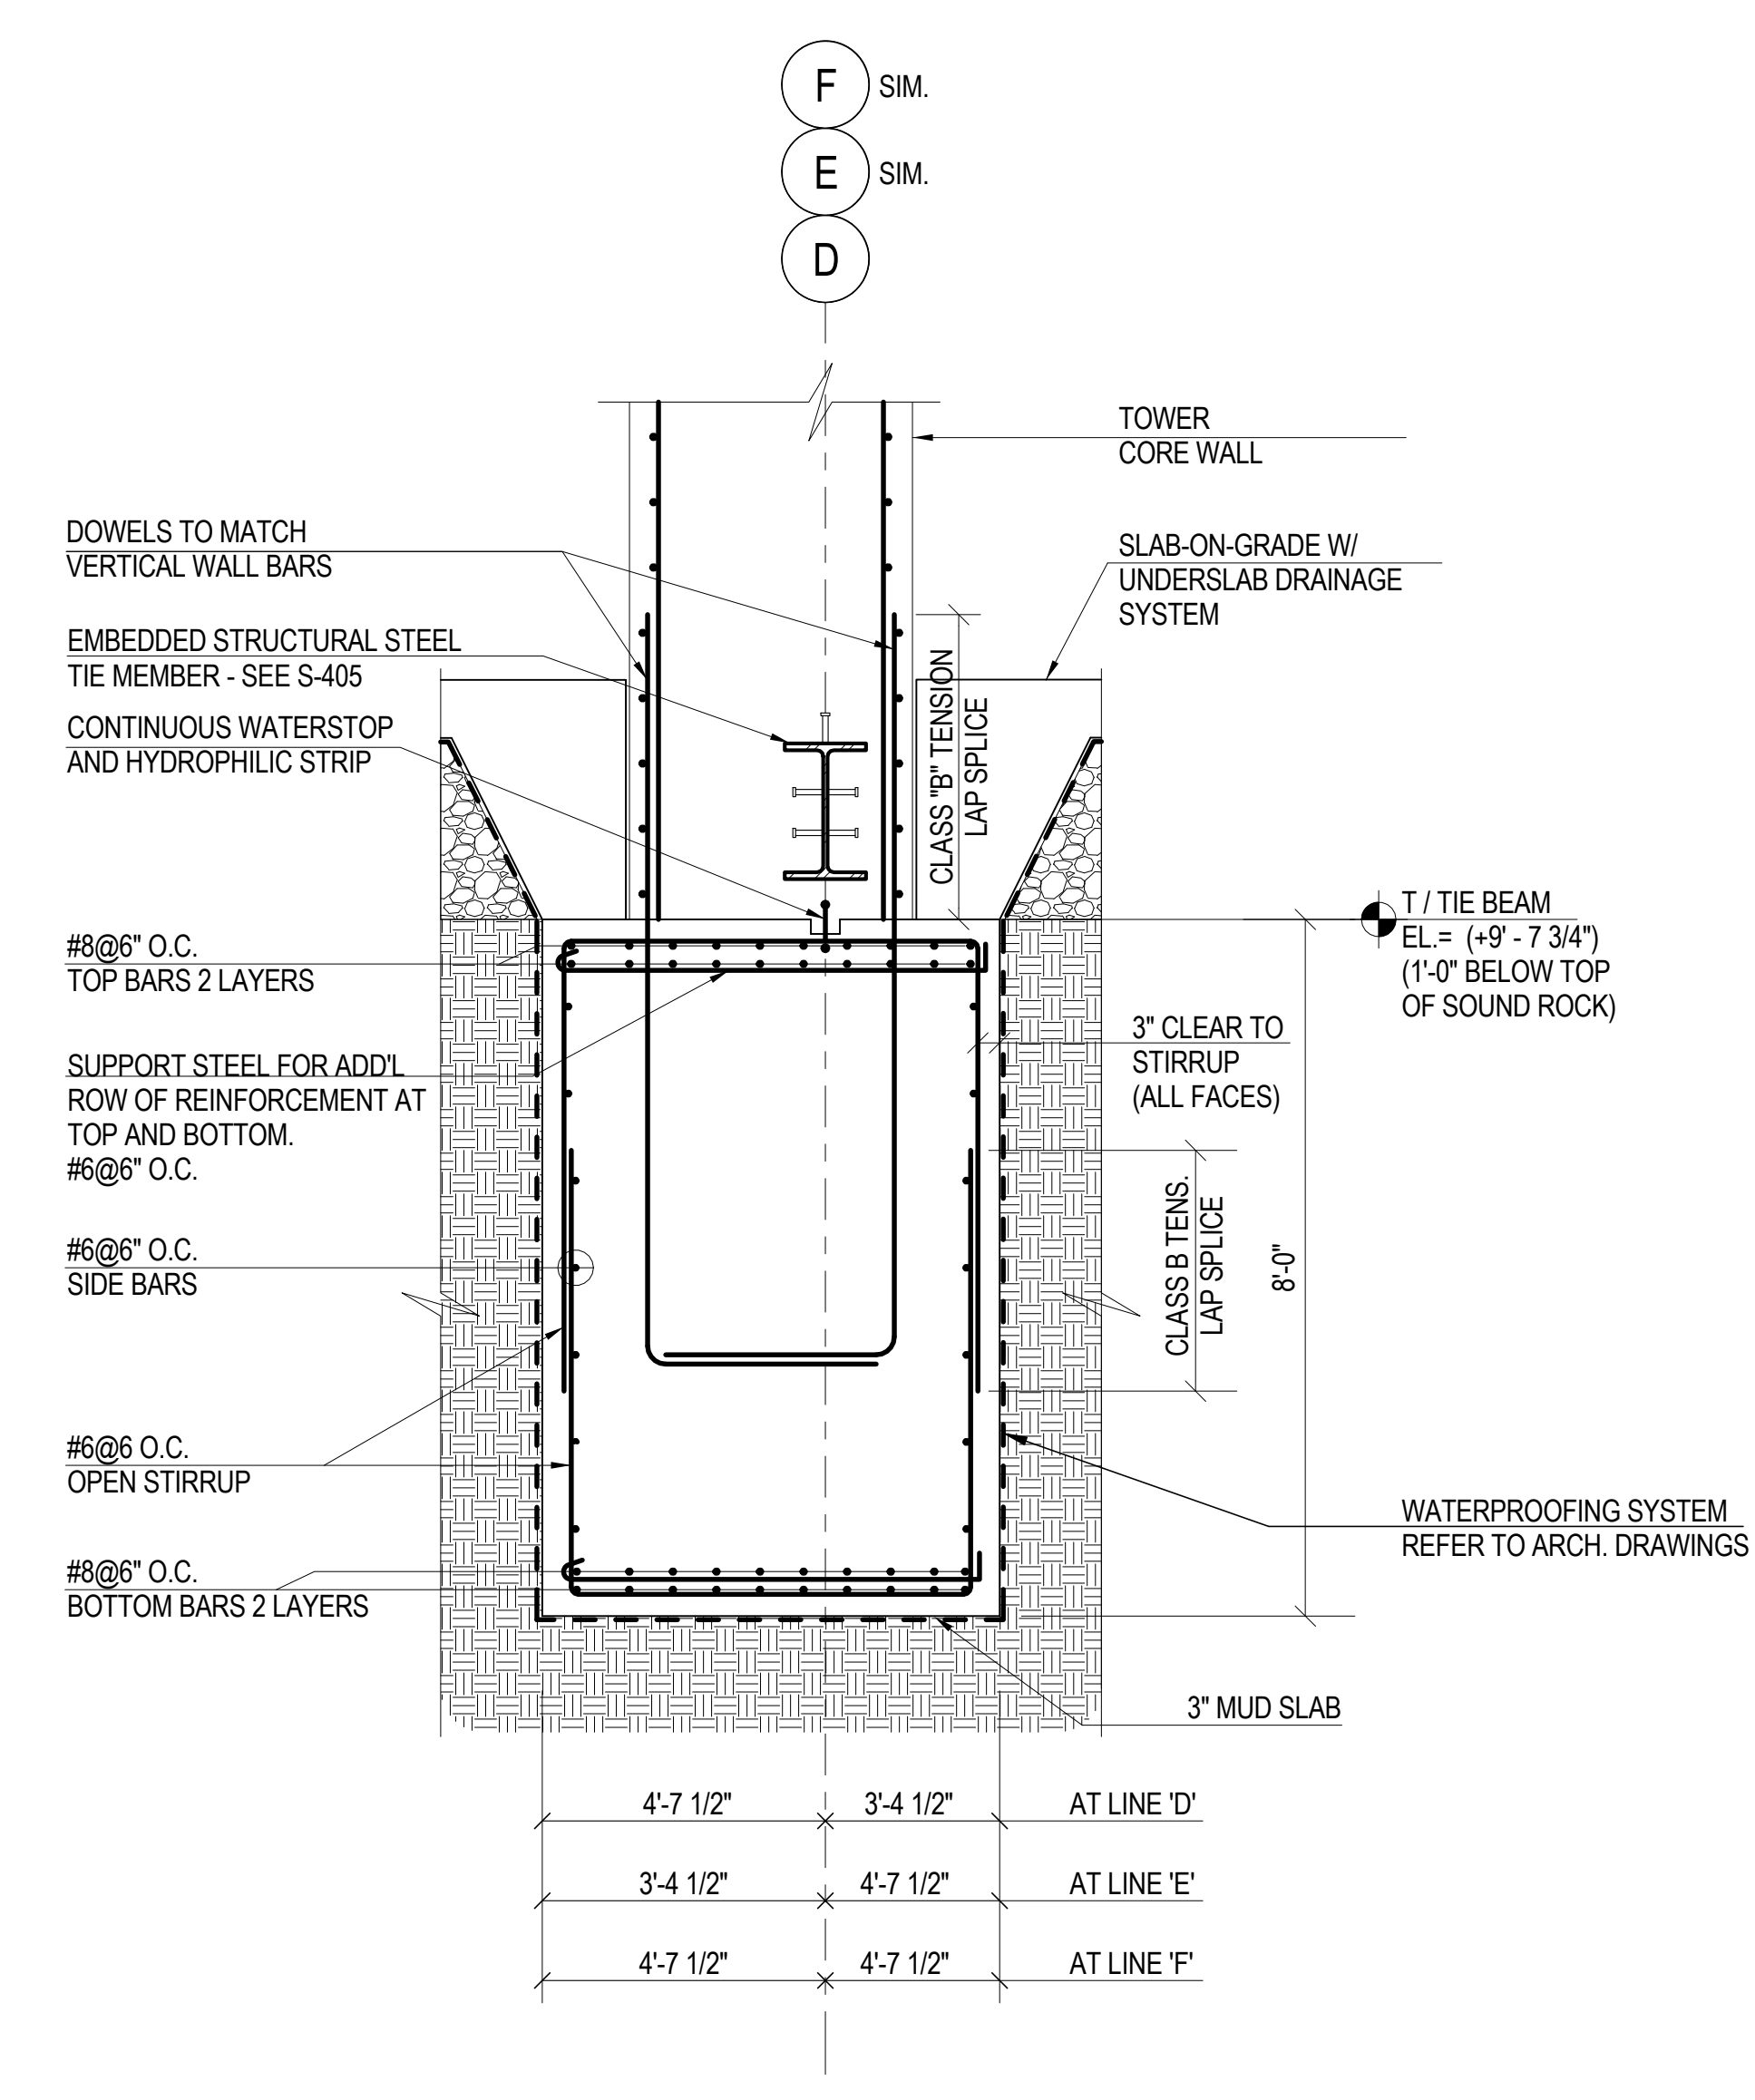

NOTE: FOOTING WIDTH ASSUMES CLASS IS 1B ROCK (40 TSF).

1A SECTION THRU CONTINUOUS FOOTING UNDER N-S WEB WALLS (LOWER) 1/2\"/>

1B SECTION THRU CONTINUOUS FOOTING UNDER N-S WEB WALLS (UPPER) 1/2\"/>

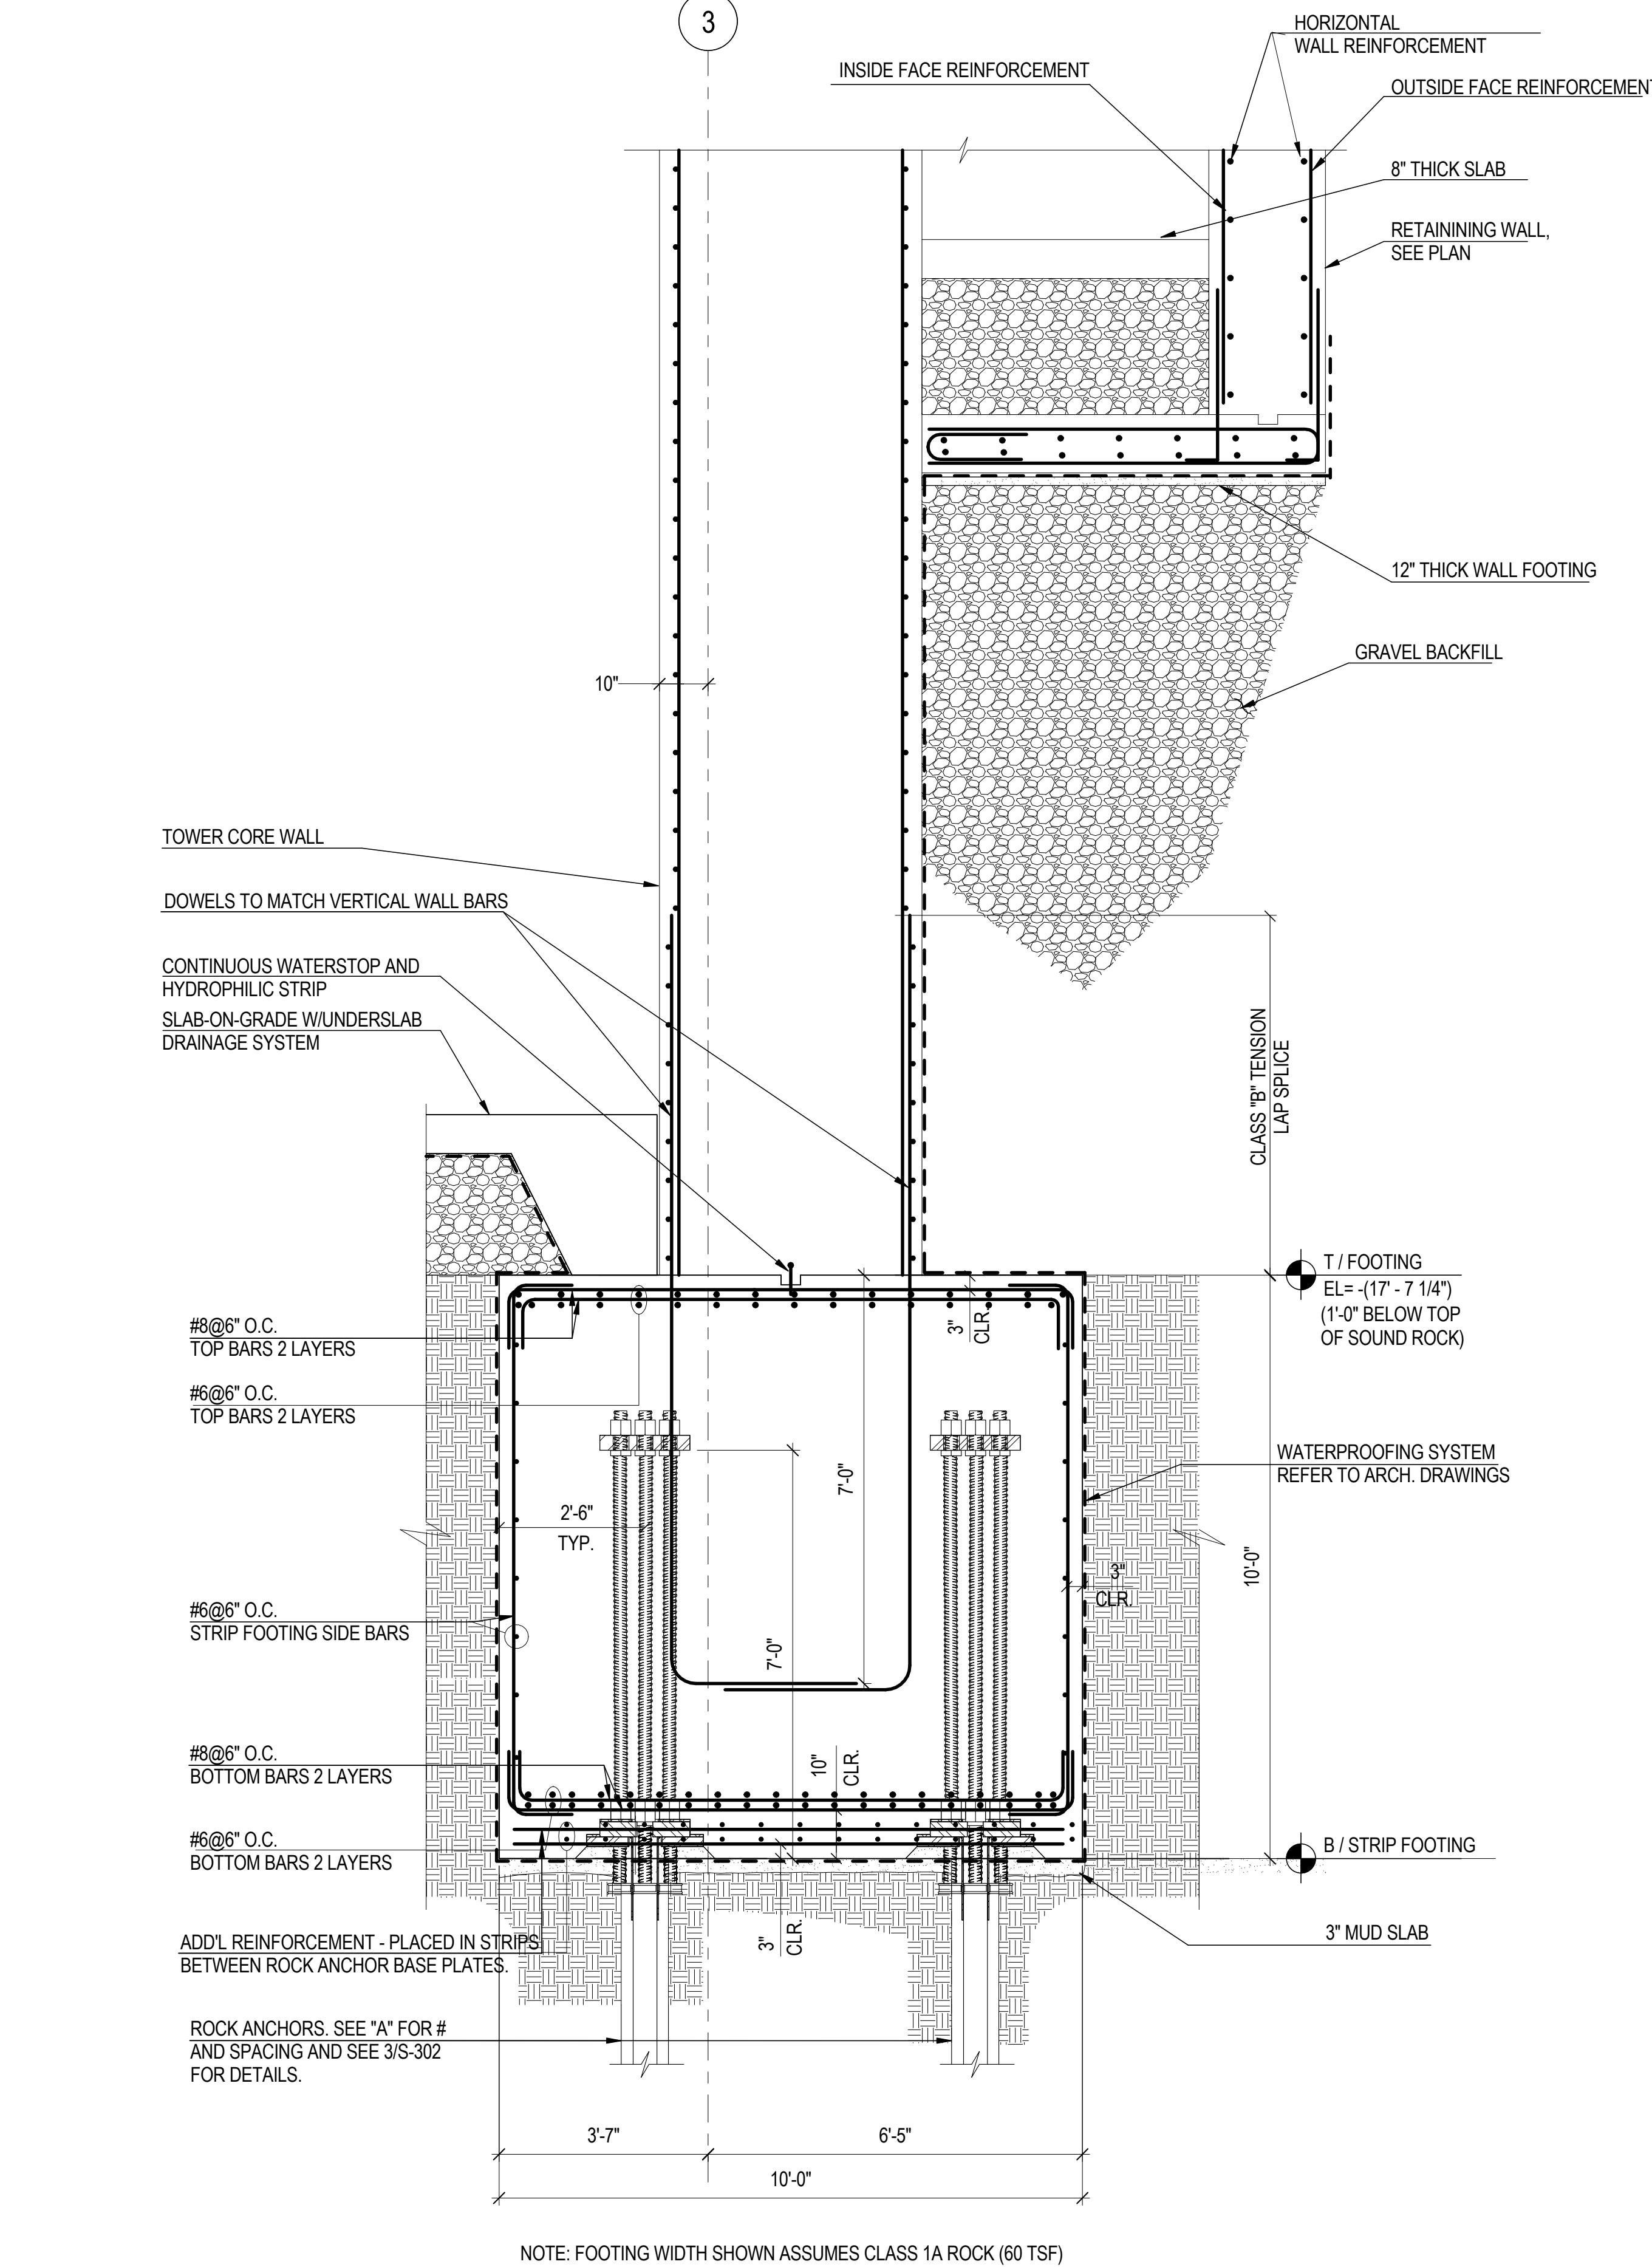

NOTE: FOOTING WIDTH SHOWN ASSUMES CLASS 1A ROCK (60 TSF)

3 SECTION THRU NORTH CORE WALL CONTINUOUS FOOTING ON ROCK W/ ROCK ANCHORS (2) 1/2\"/>



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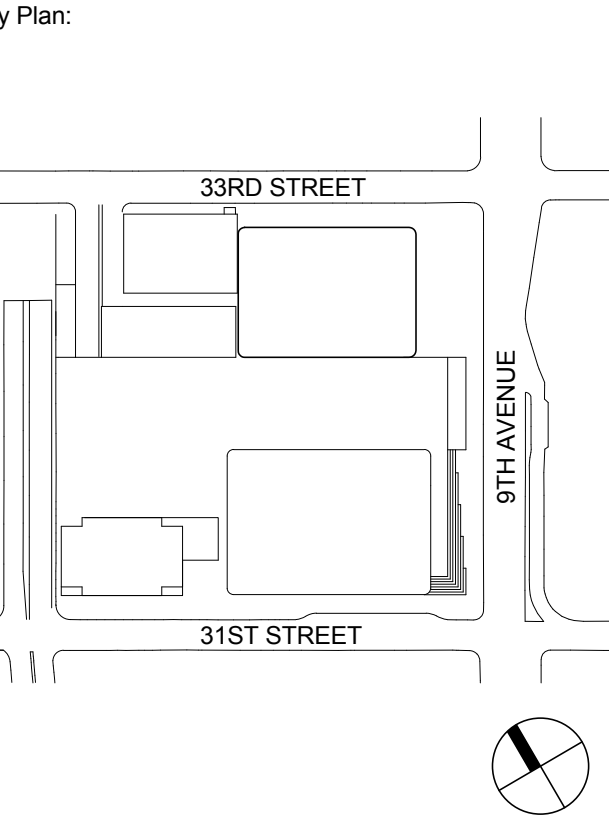
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1	18 MAR 2012	ISSUED FOR RECONCILIATION

No. Date Description

Sheet Name:

**WEST
PERIMETER
COLUMN
FOUNDATION
SECTIONS &
DETAILS**


Project No.: 211157

Date: 20 JUN 2014


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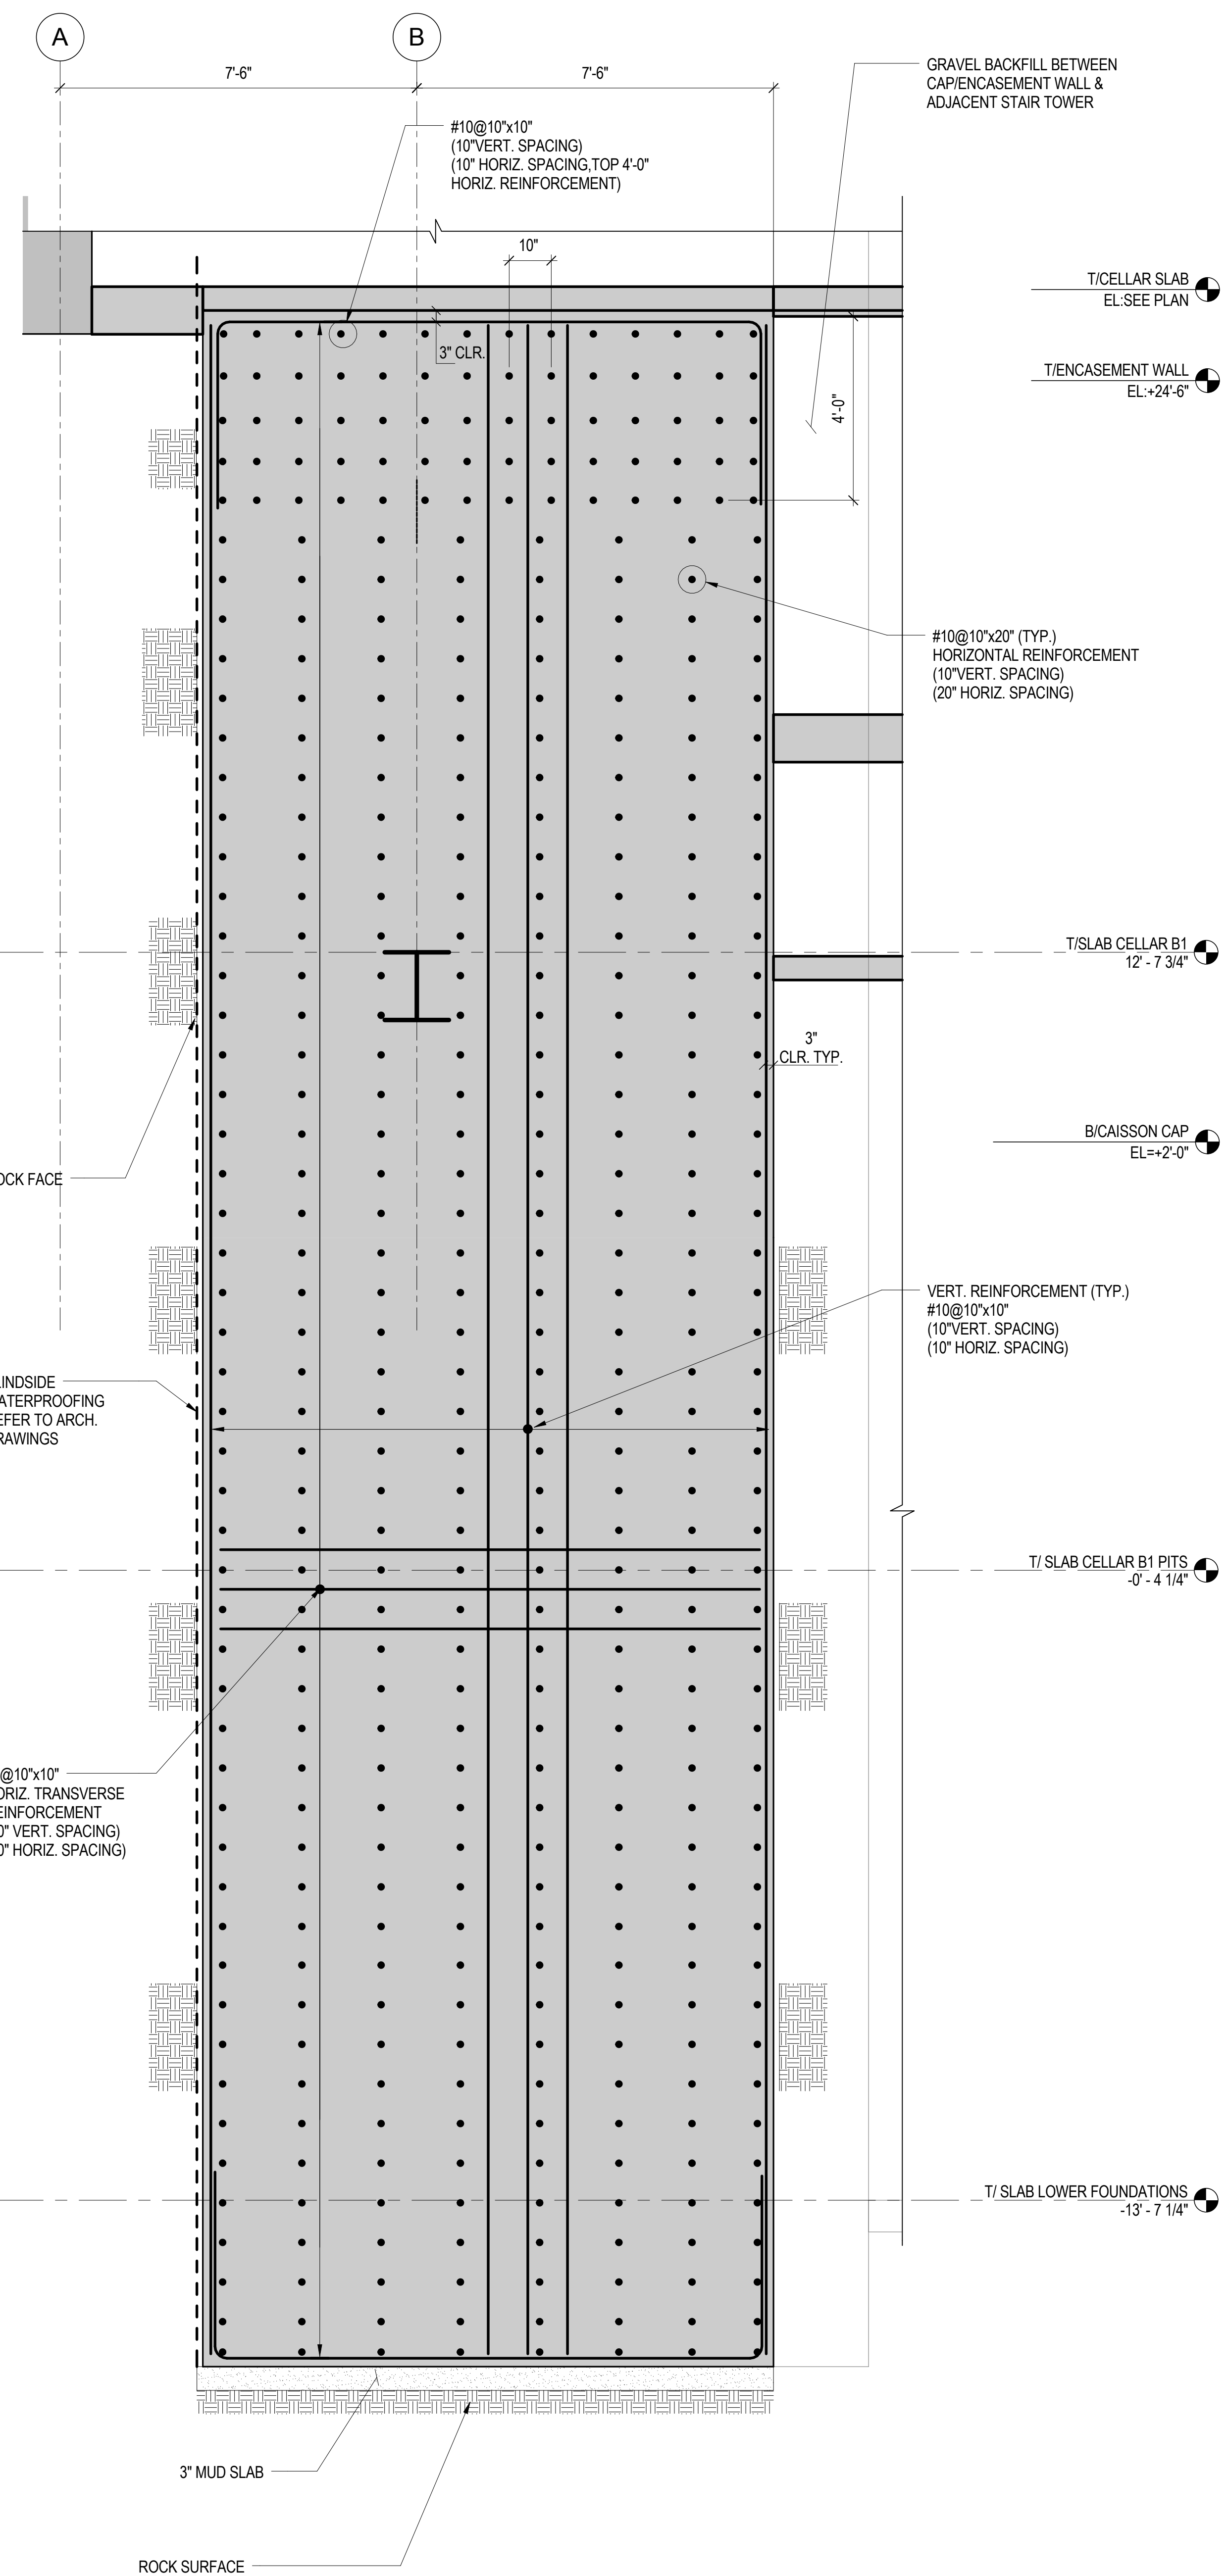
Page No.: 40 of 90



1 FOUNDATION SECTION AT GRIDLINE A
3/16" = 1'-0"

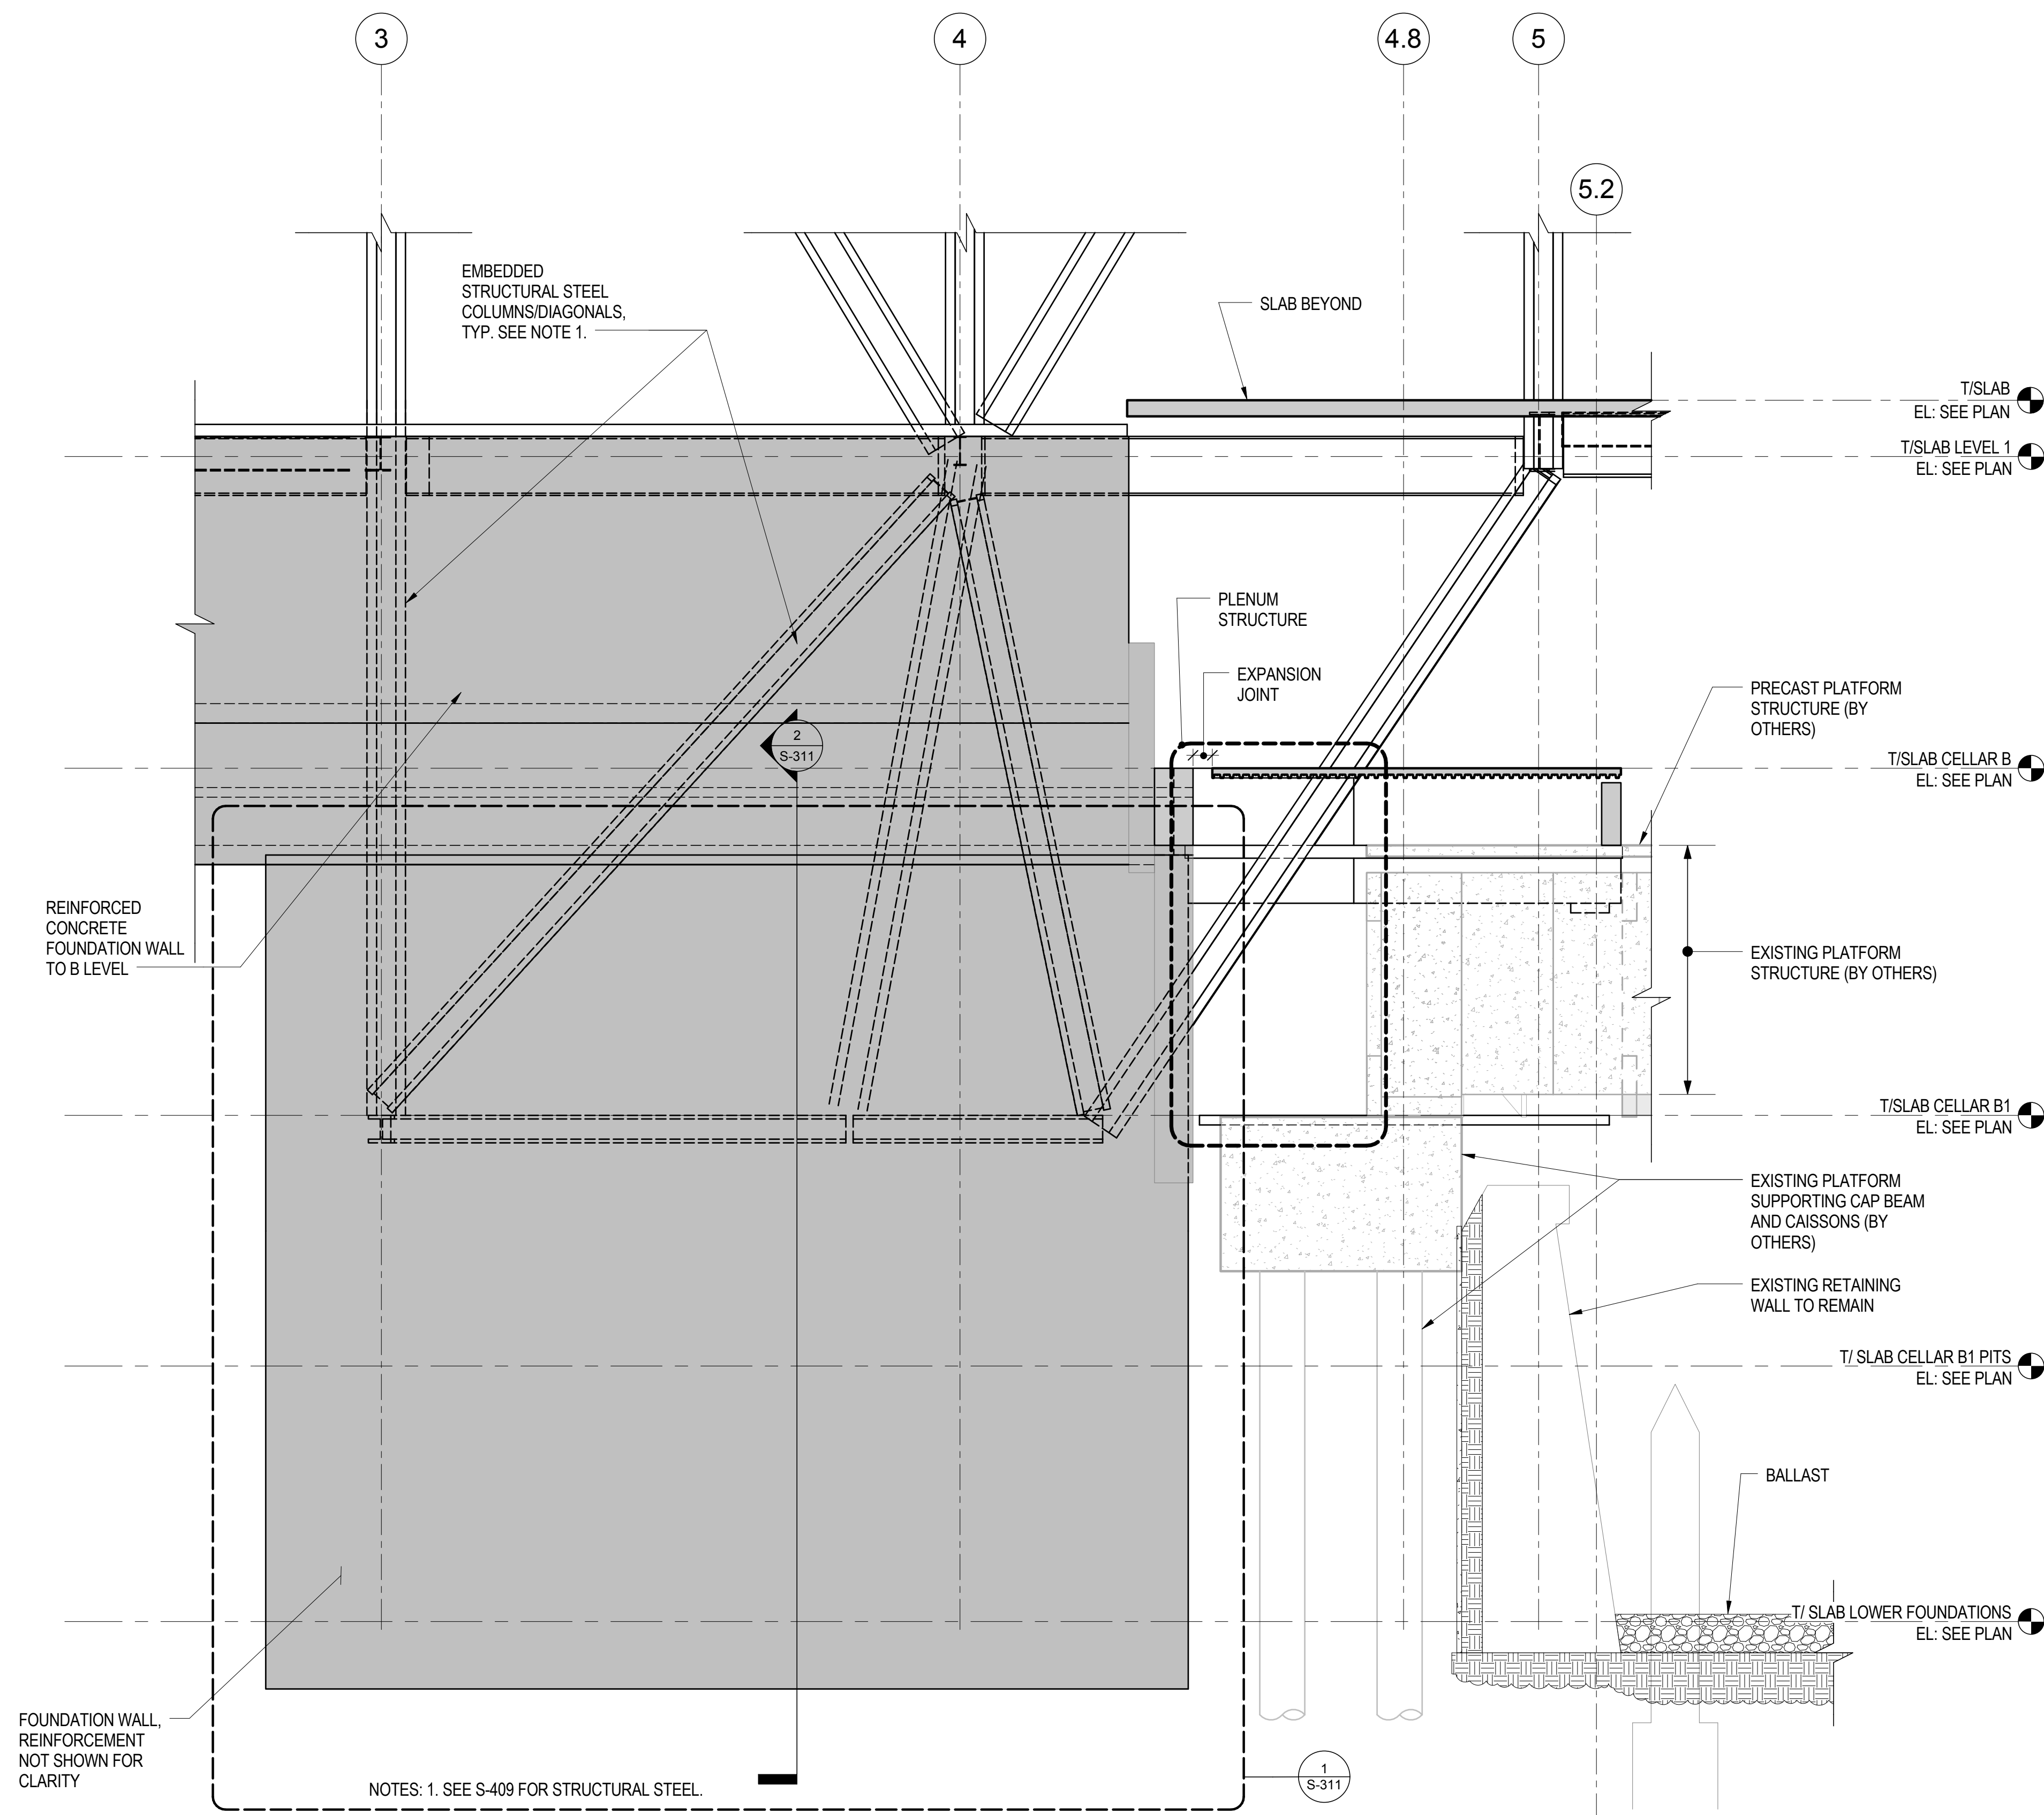


2 FOUNDATION SECTION AT GRIDLINE B
3/16" = 1'-0"

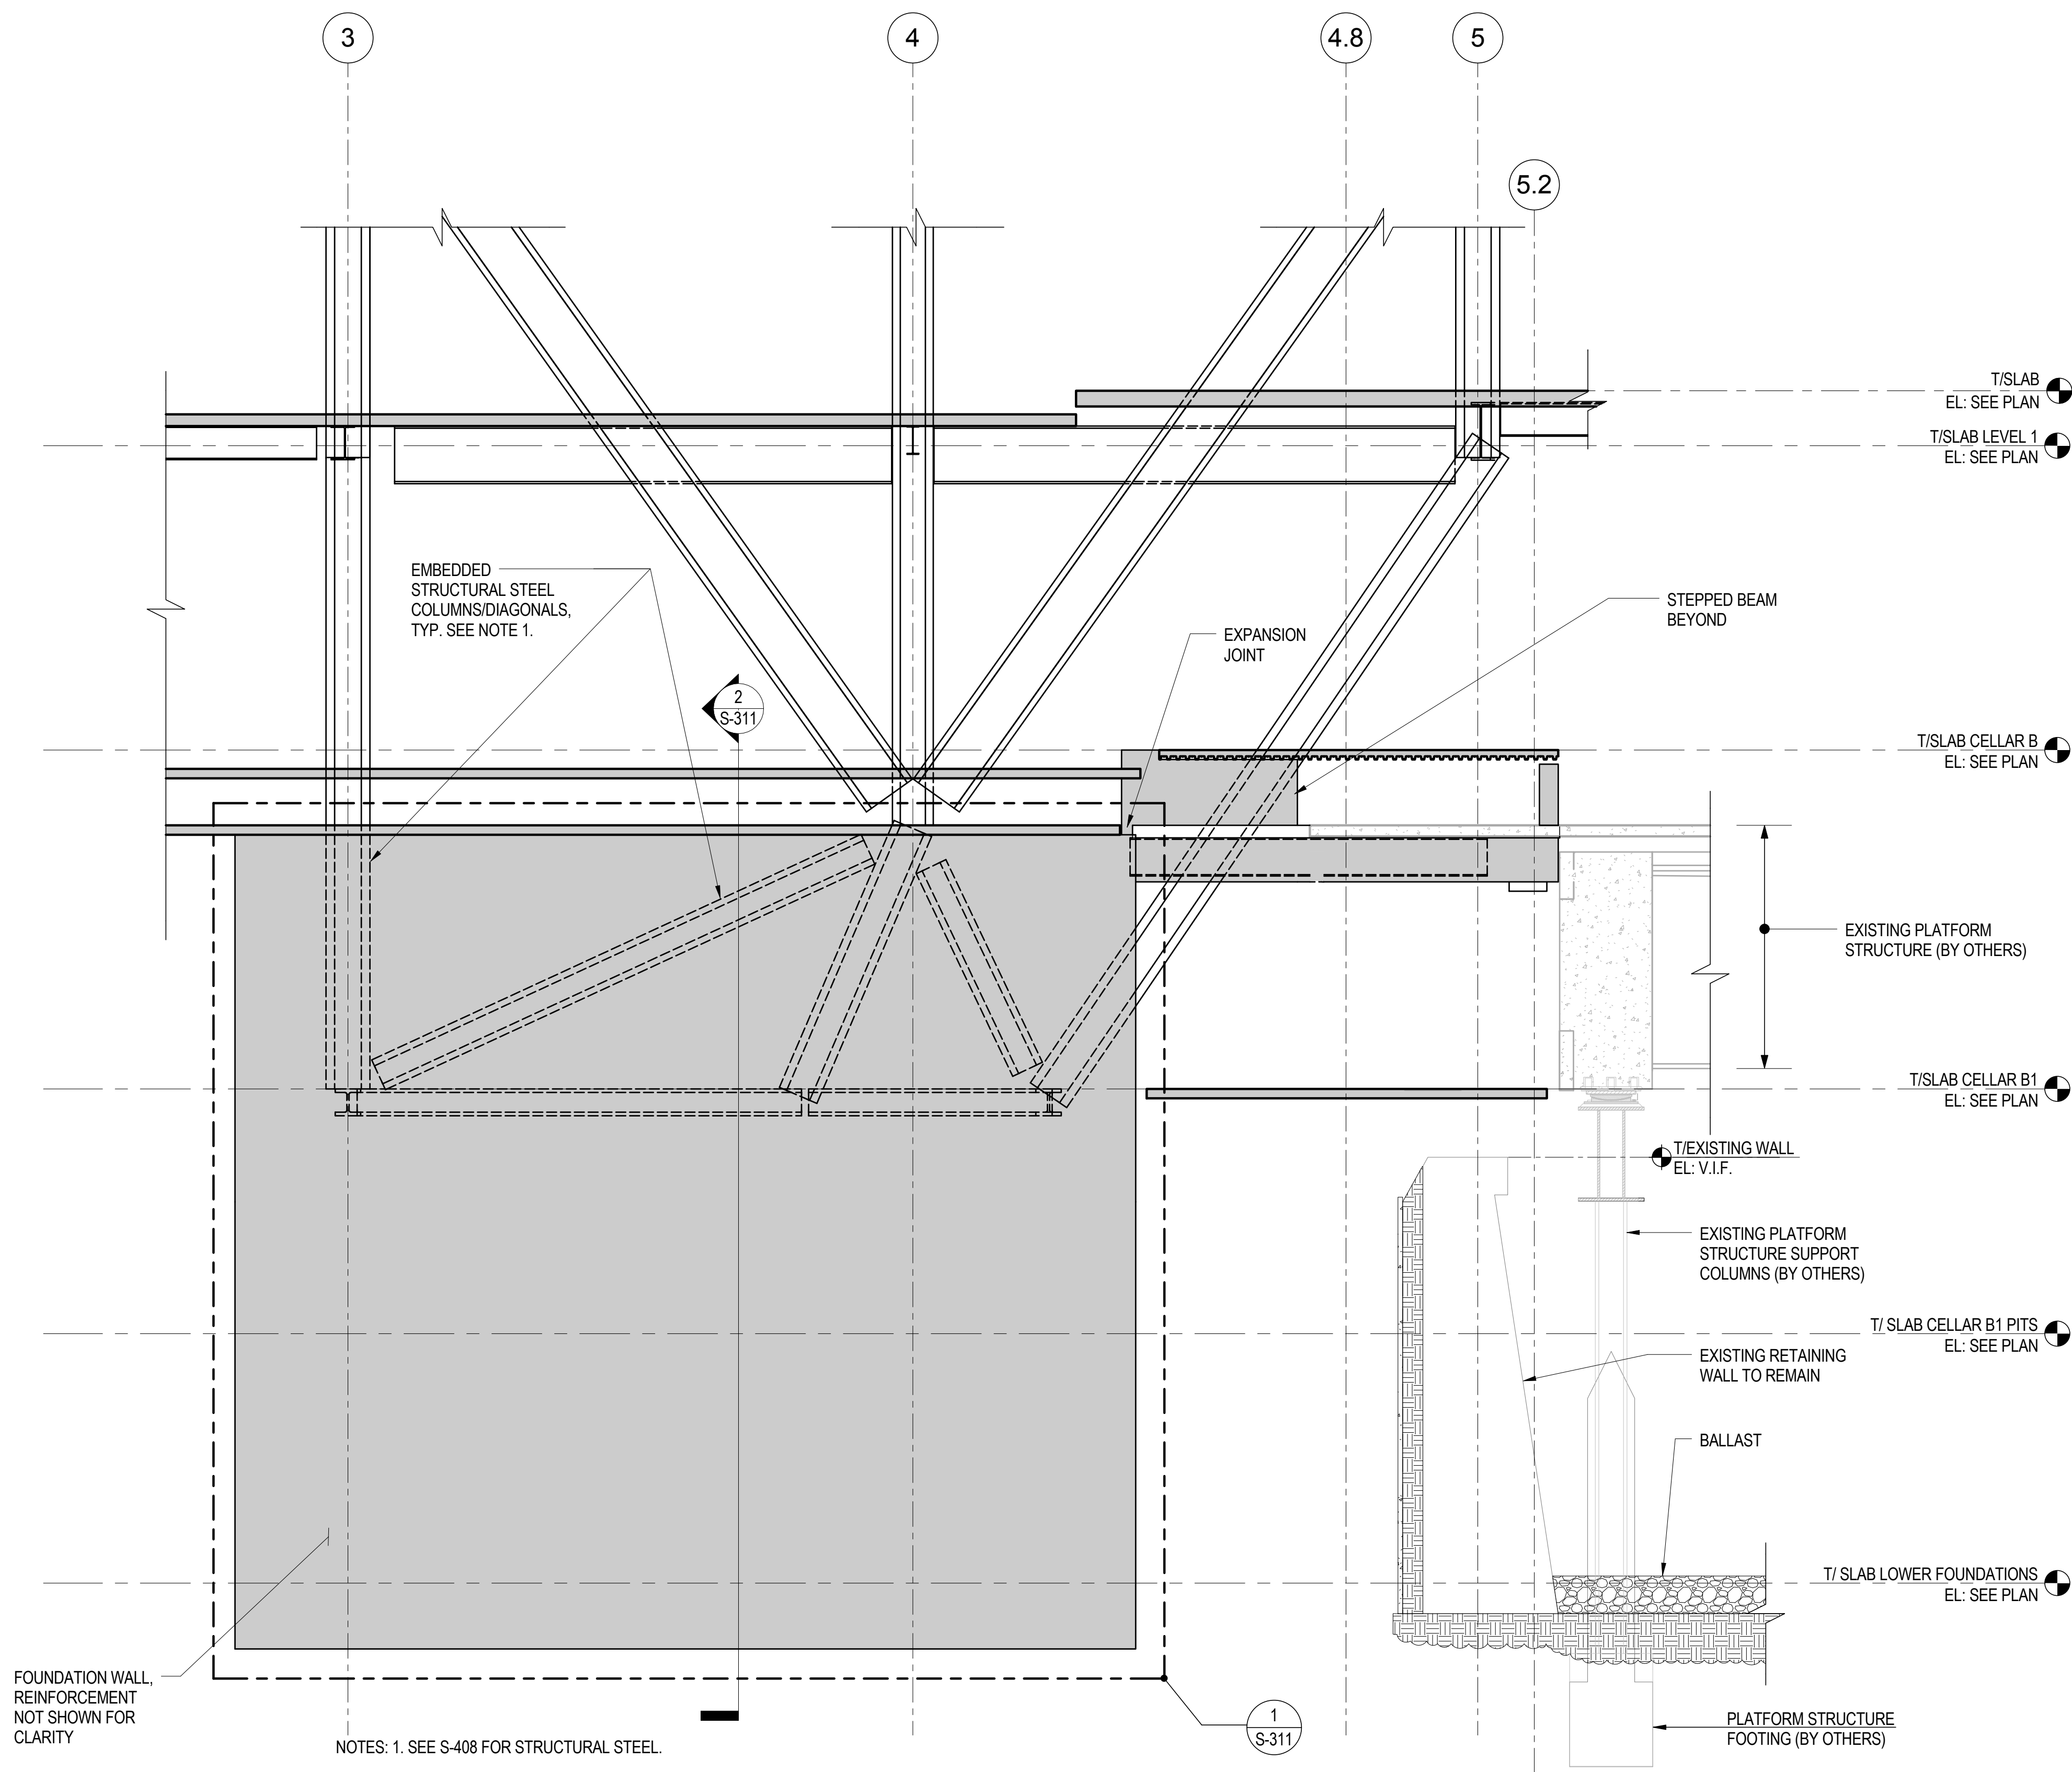

2 TRANSVERSE SECTION AT FOUNDATION WALL FOR COLUMNS/DIAGONALS ALONG LINES 'A' AND 'B'

NOT TO SCALE

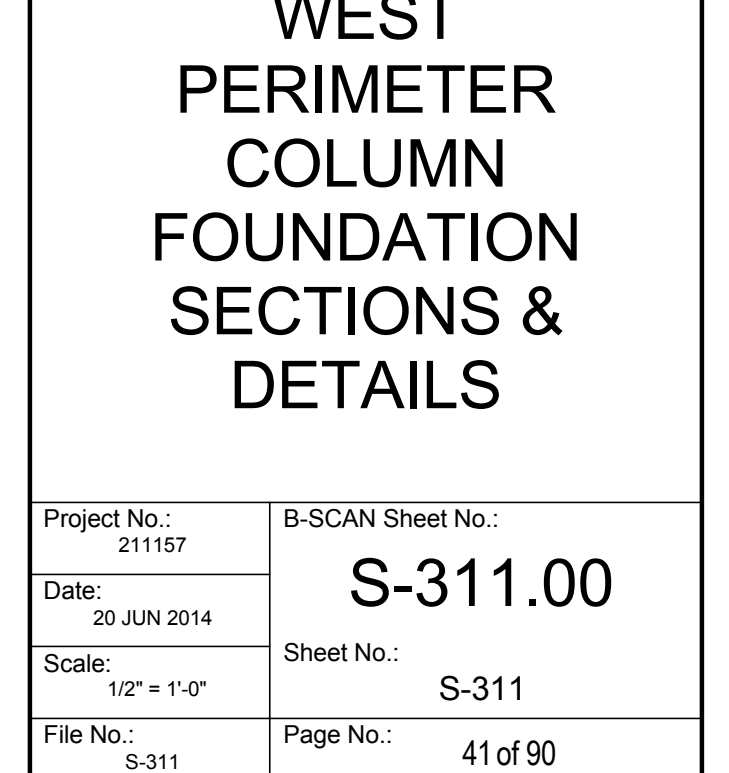



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375 Ninth Avenue, New York, NY 10001
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50 Washington Street, Newark, CT 06854

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Landscape Consultant
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Security Consultant
Ducibella, Vantor & Santore
250 State Street #1, North Haven, CT 06473

Blast Consultant
Weidinger Associates, Inc.
40 Wall Street, New York, NY 10005


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Vibration Consultant
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650 Woodlawn Road West, Guelph
Ontario, Canada N1K 1B6



Seal & Signature:


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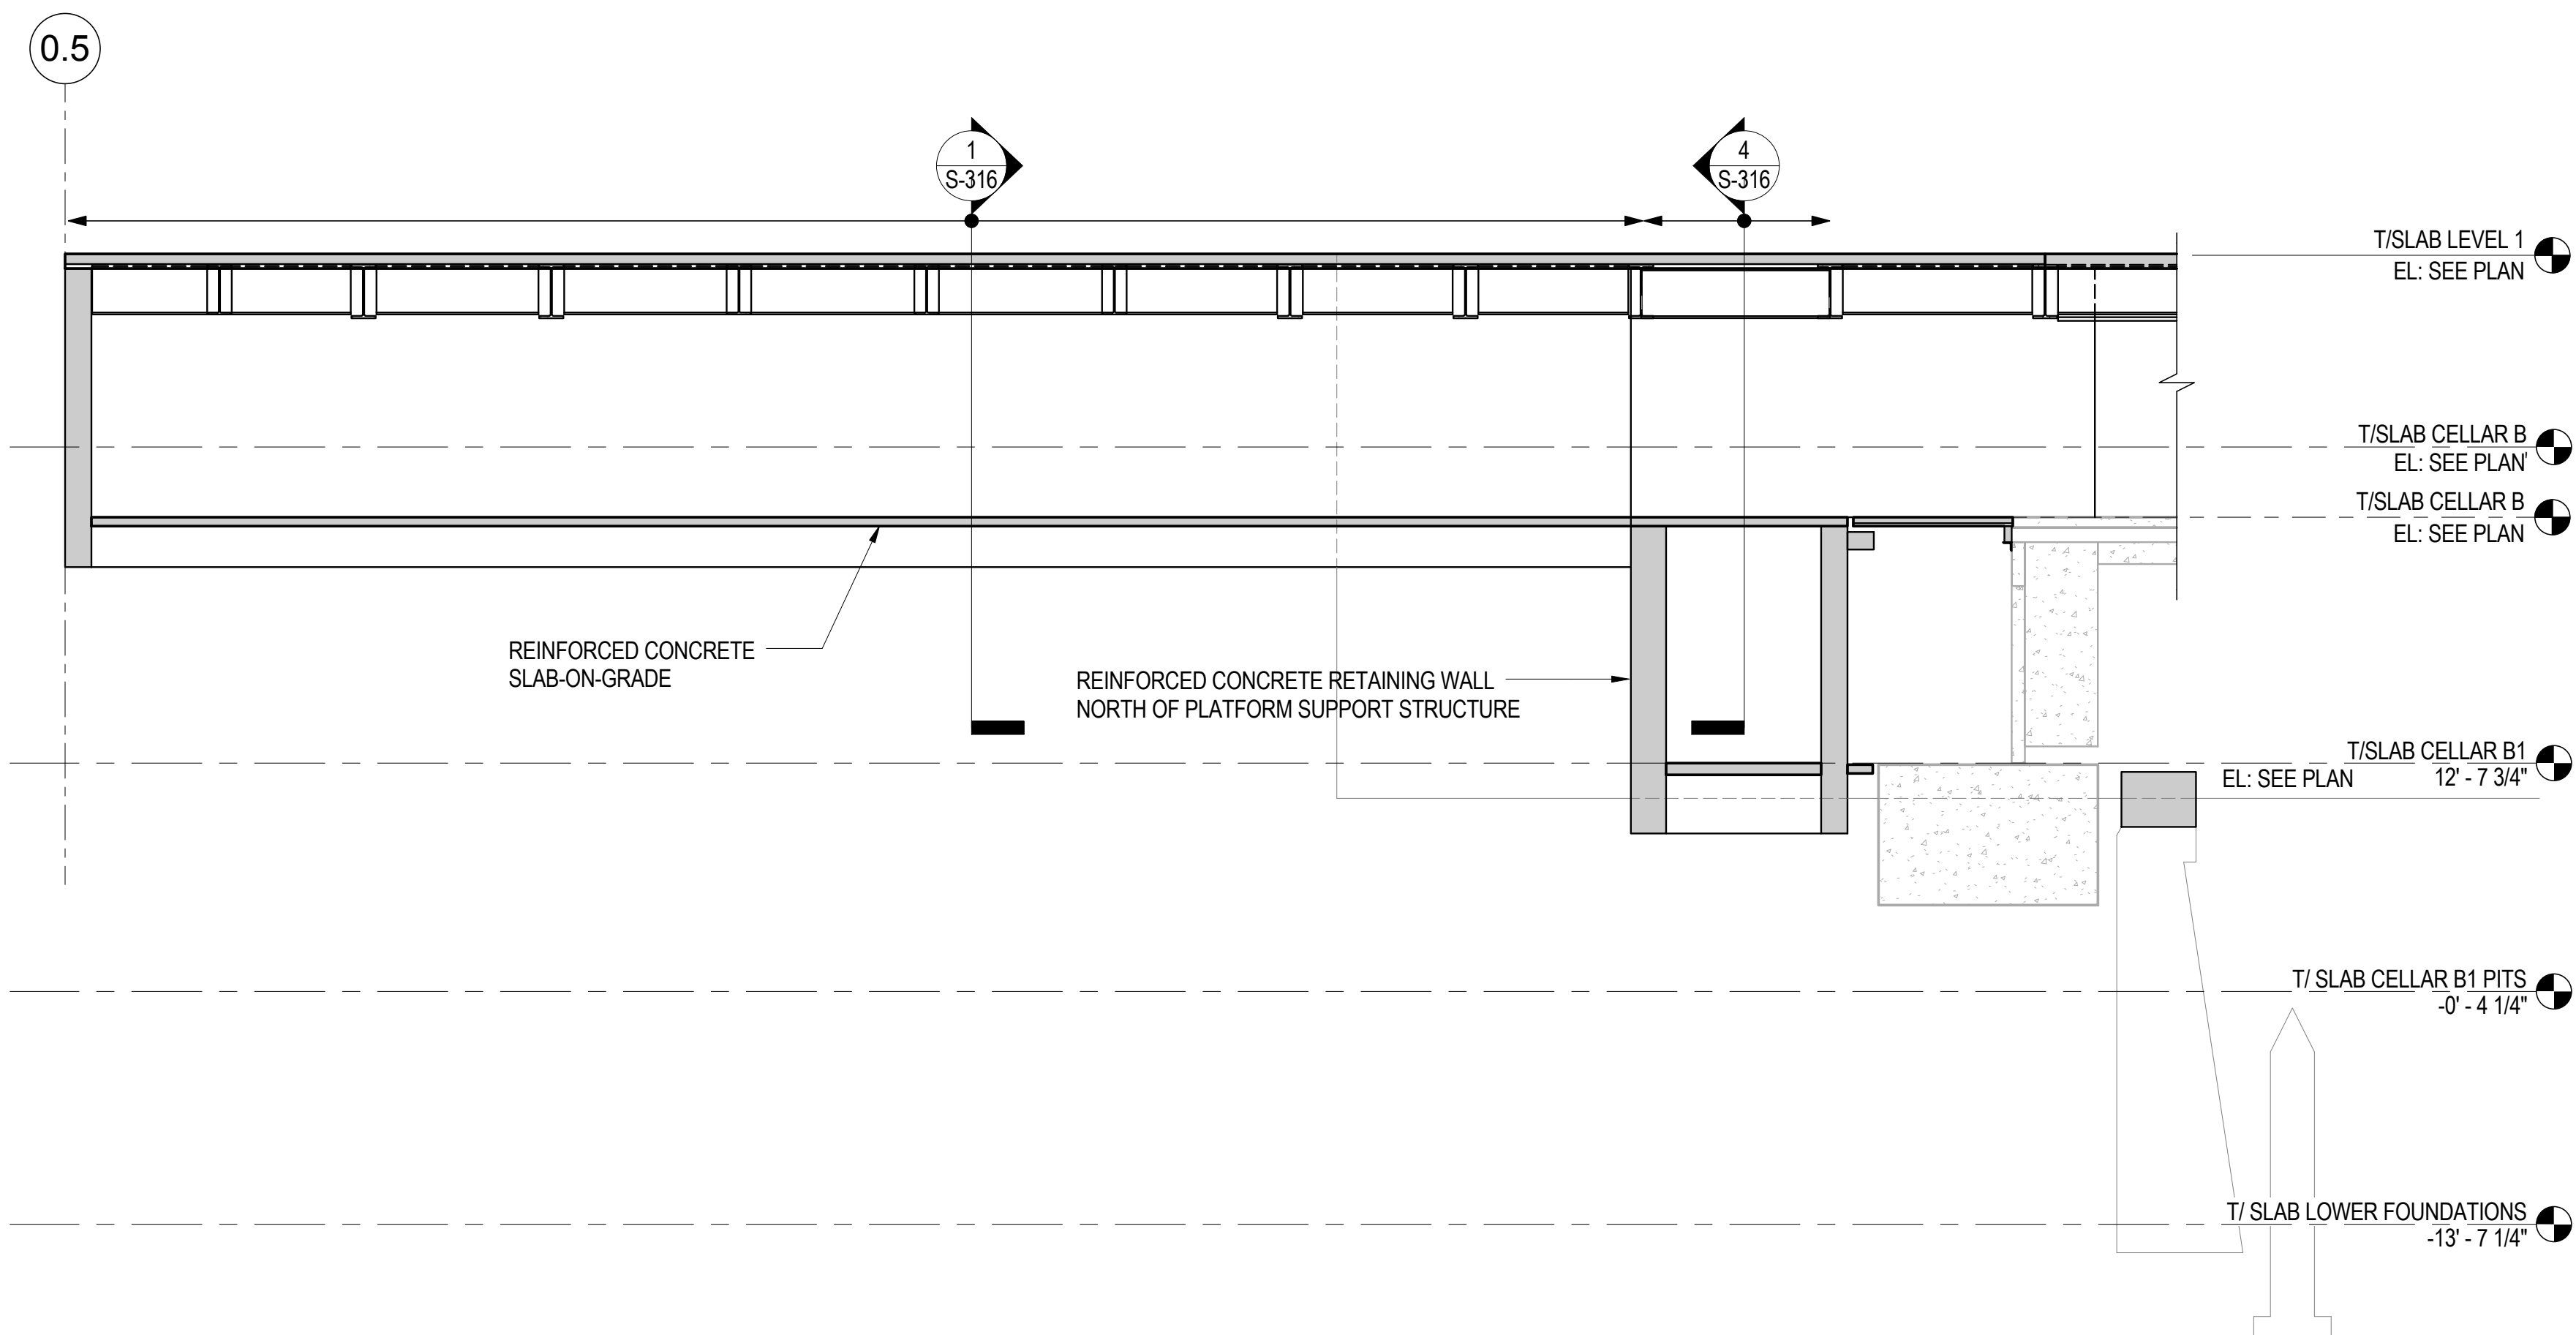
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**FOUNDATION
WALL
ELEVATIONS**


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Date:	20 JUN 2014	Sheet No.:	S-315
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File No.:	S-315		

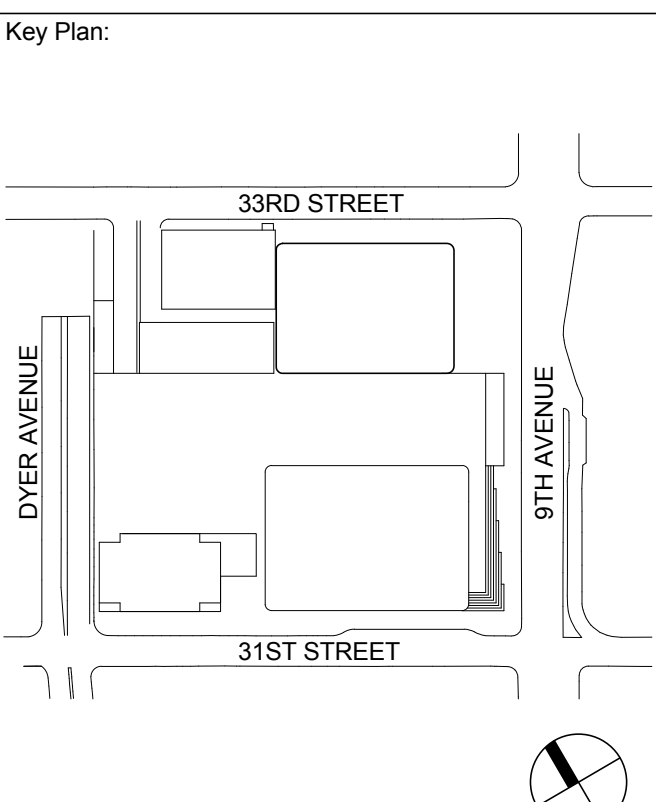


1 ELEVATION OF FOUNDATION WALL ALONG LINE 0.5 - LOOKING NORTH
1/8" = 1'-0"

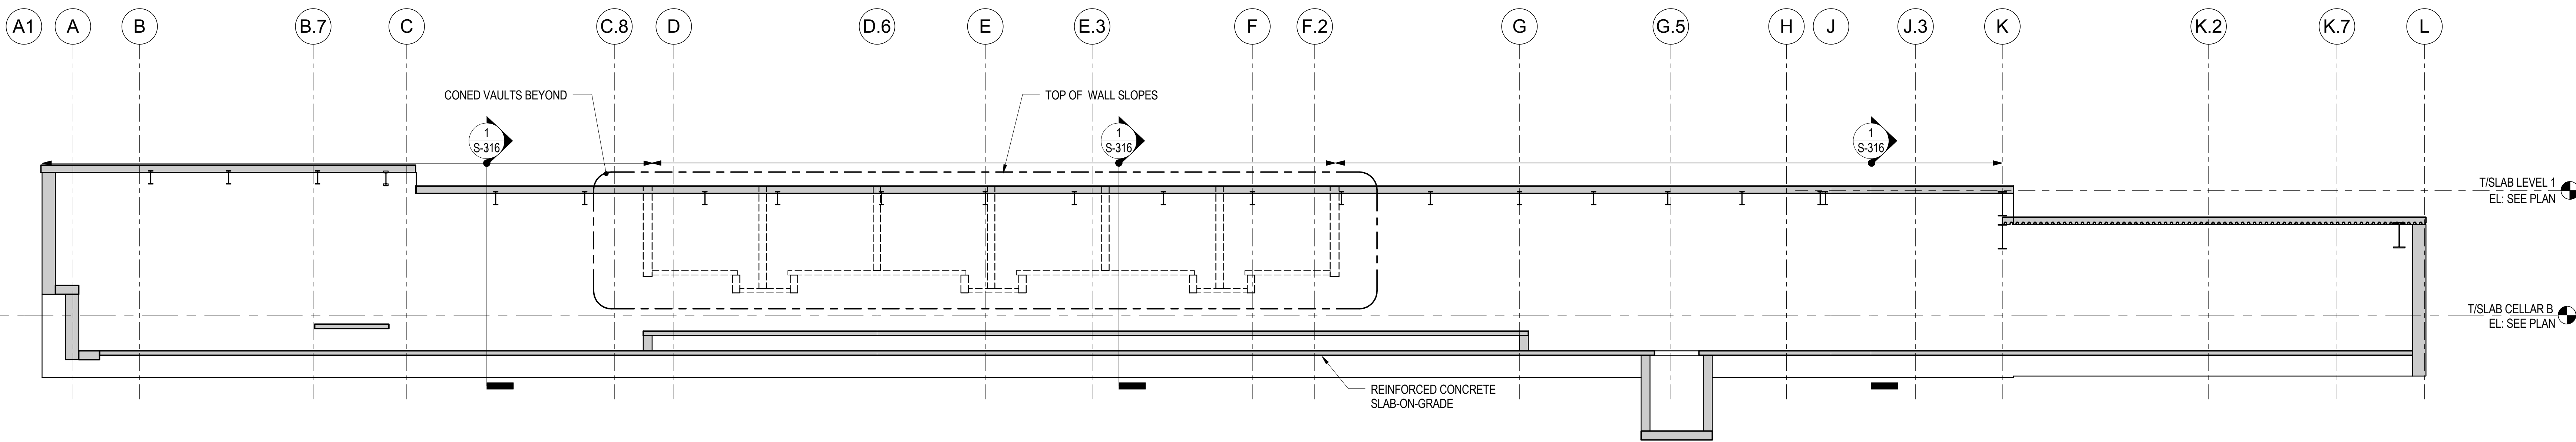


2 ELEVATION OF FOUNDATION WALL ALONG LINE L - LOOKING EAST
1/8" = 1'-0"

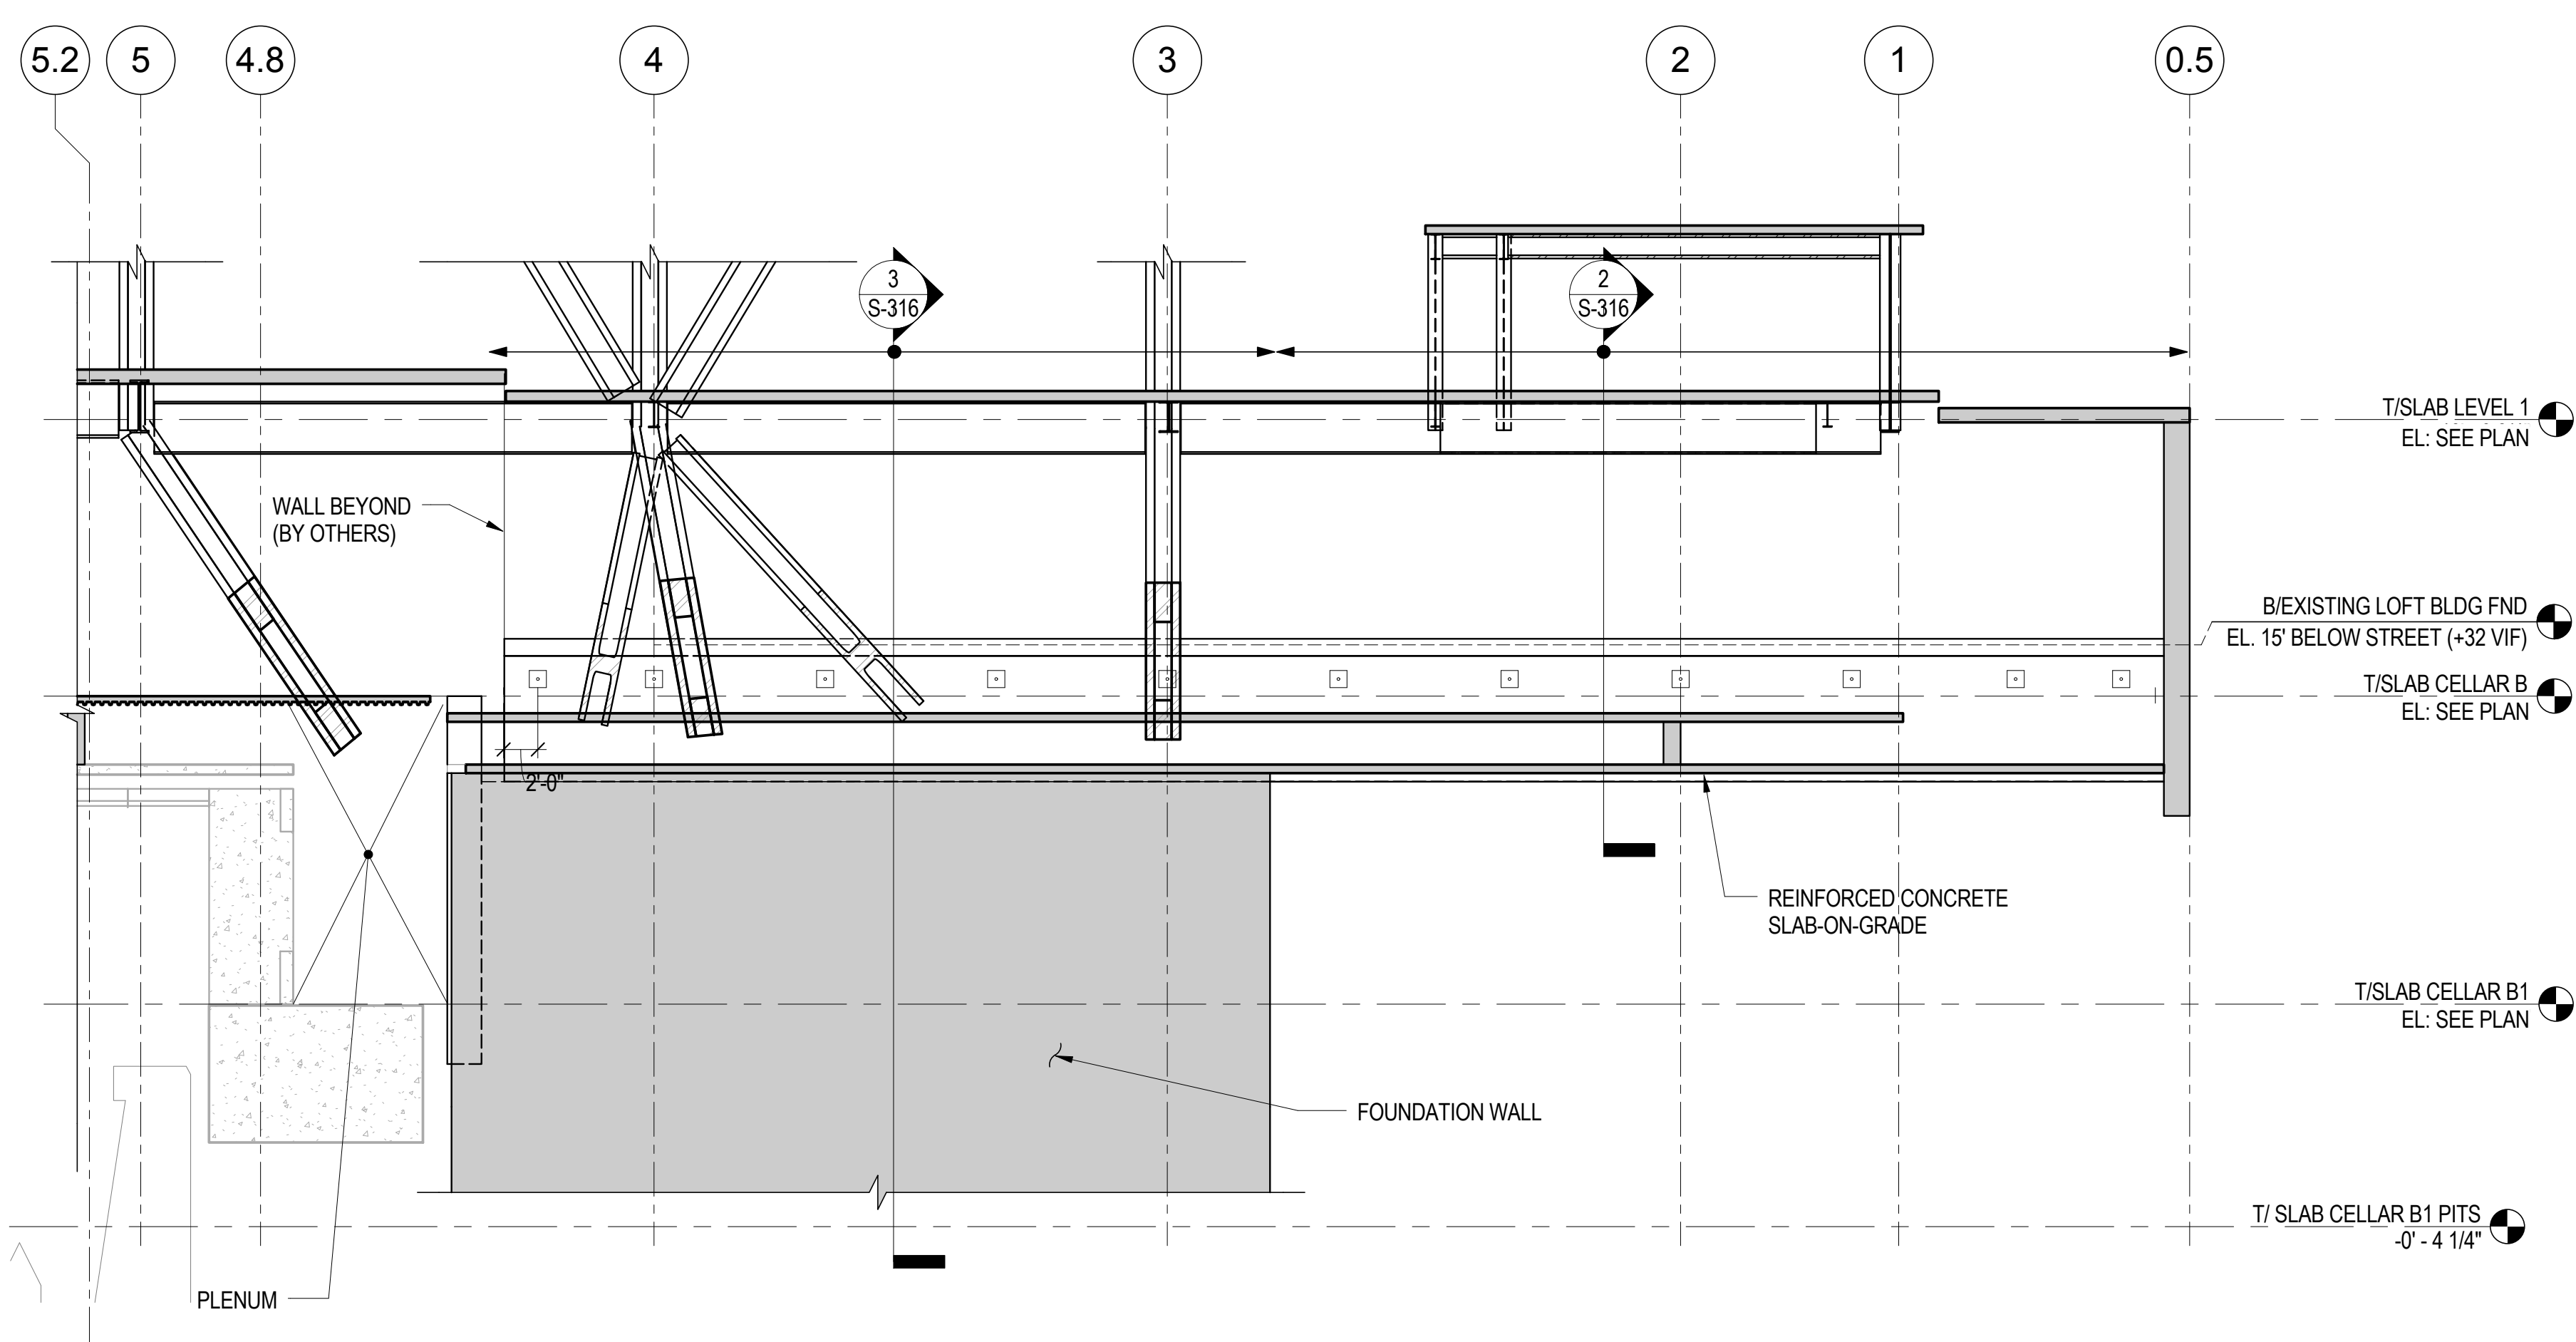

3 ELEVATION OF FOUNDATION WALL ALONG LINE A - LOOKING WEST
1/8" = 1'-0"


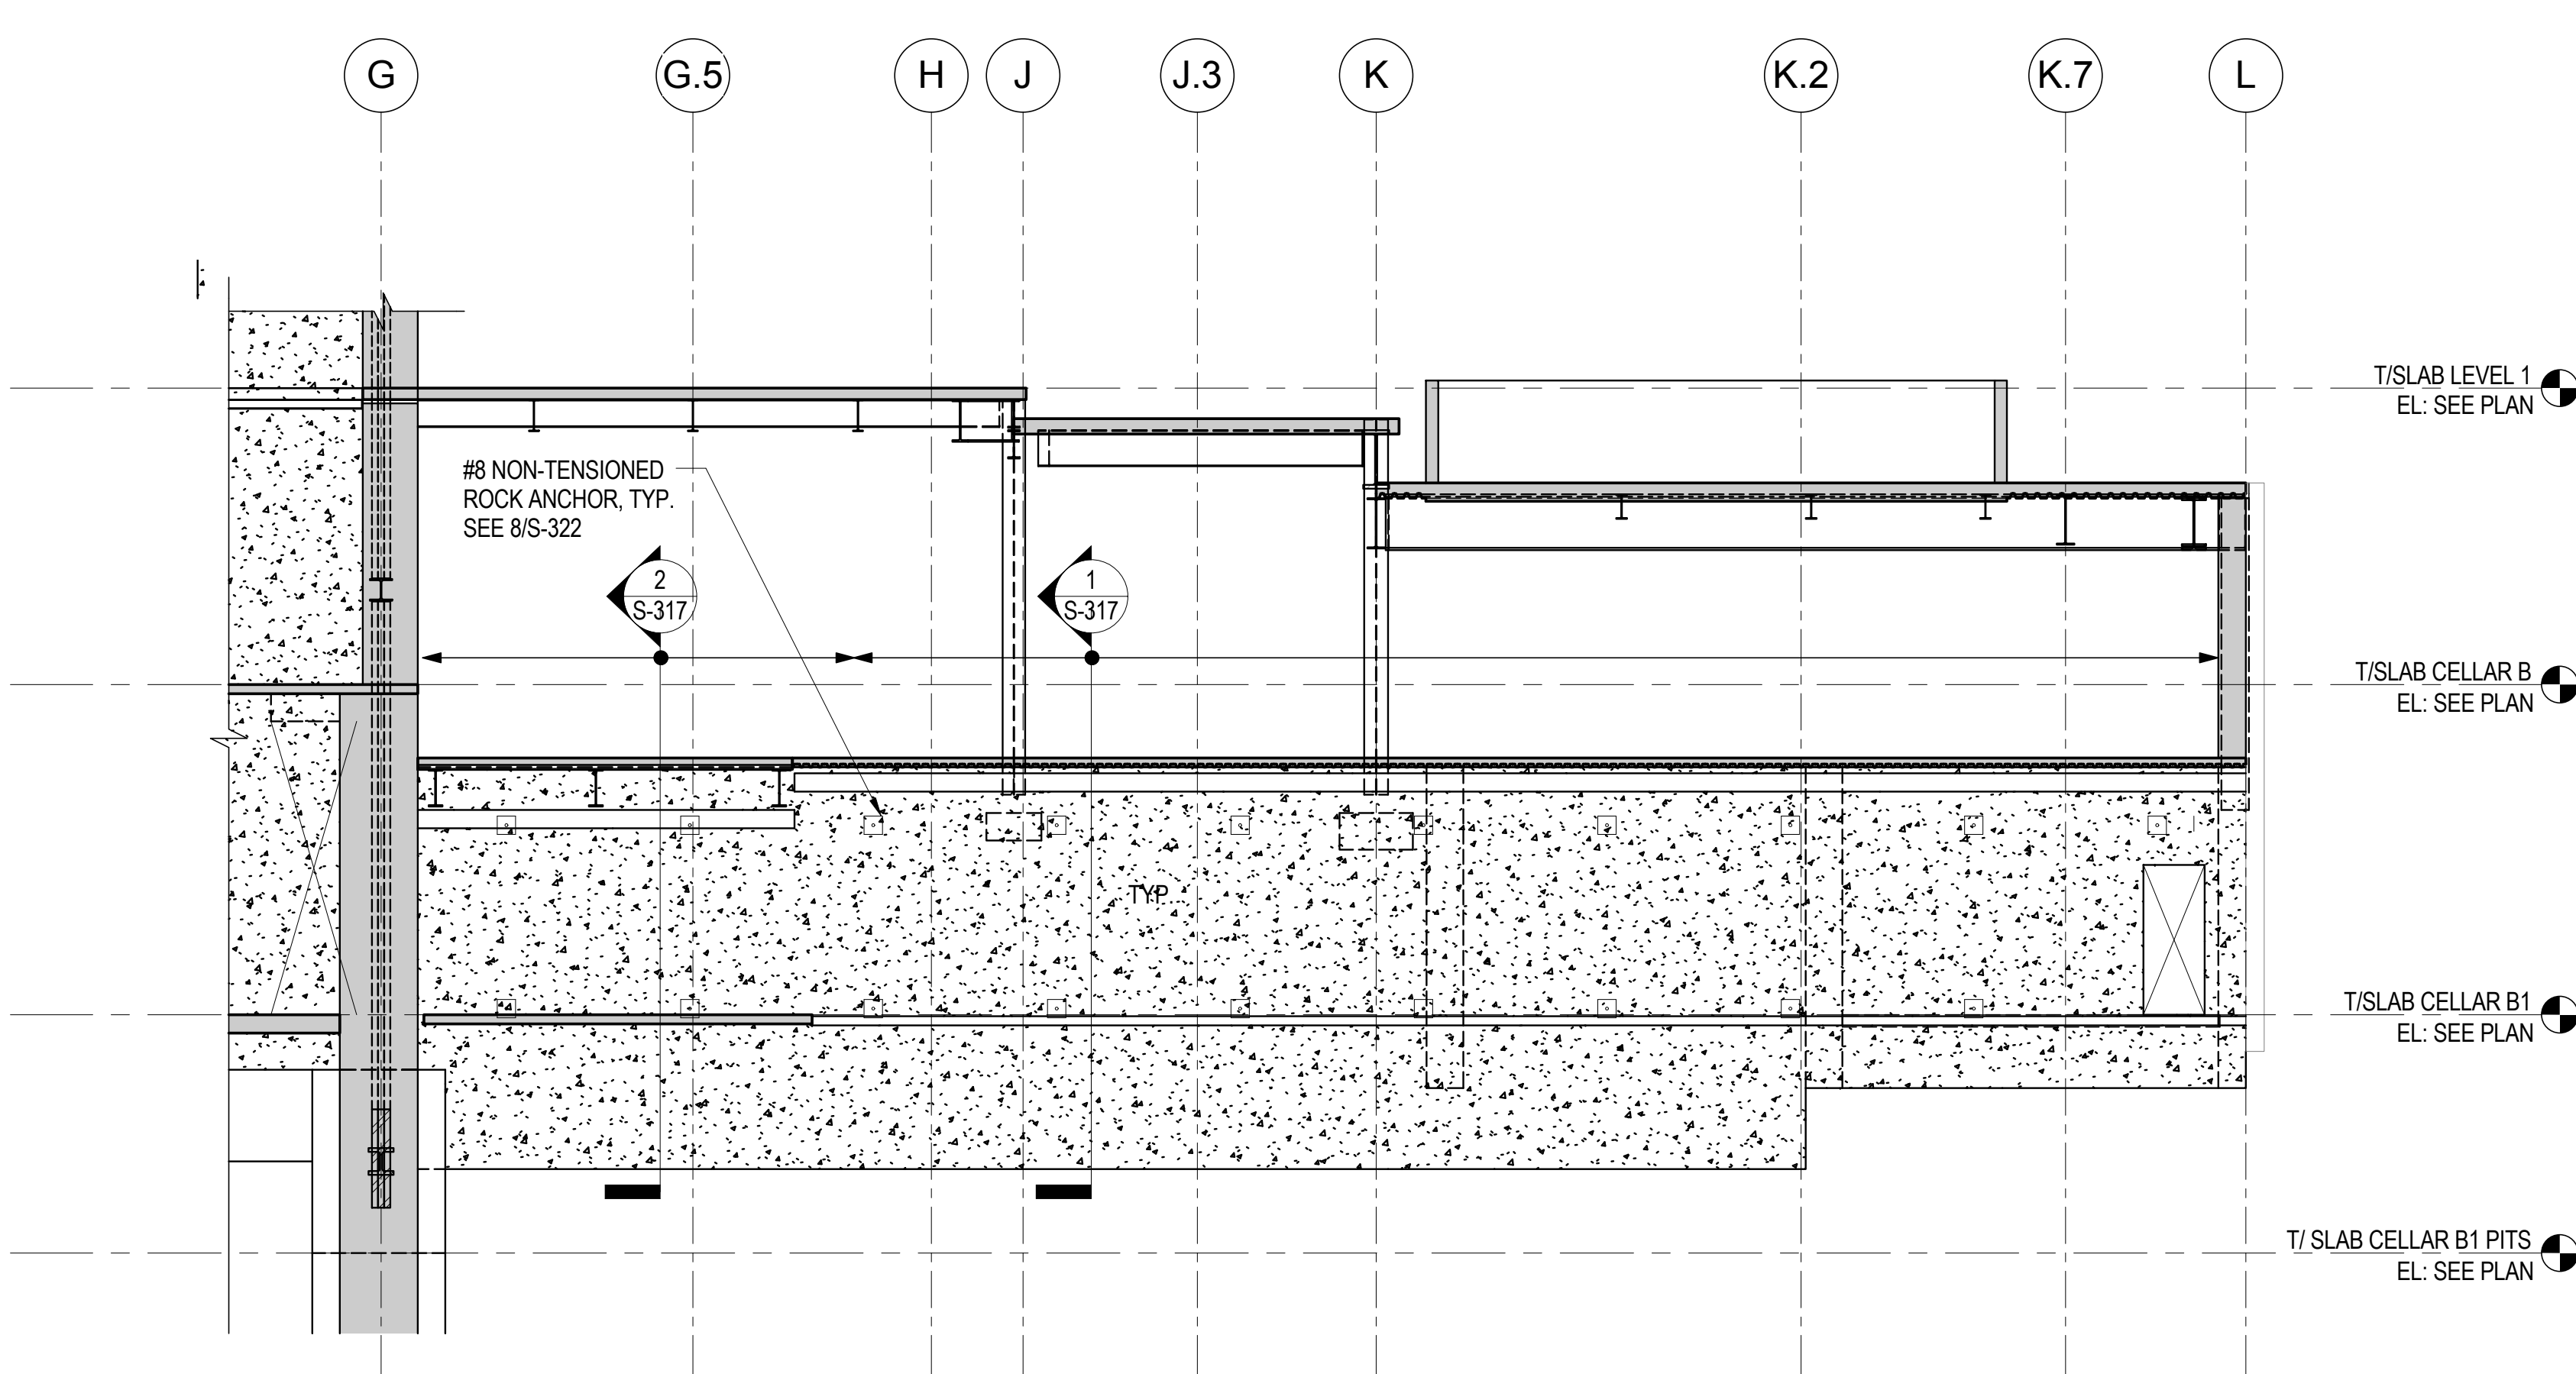



4 ELEVATION OF RETAINING WALL EAST OF TOWER CORE BETWEEN LINES 4 & 5 - LOOKING NORTH
1/8" = 1'-0"

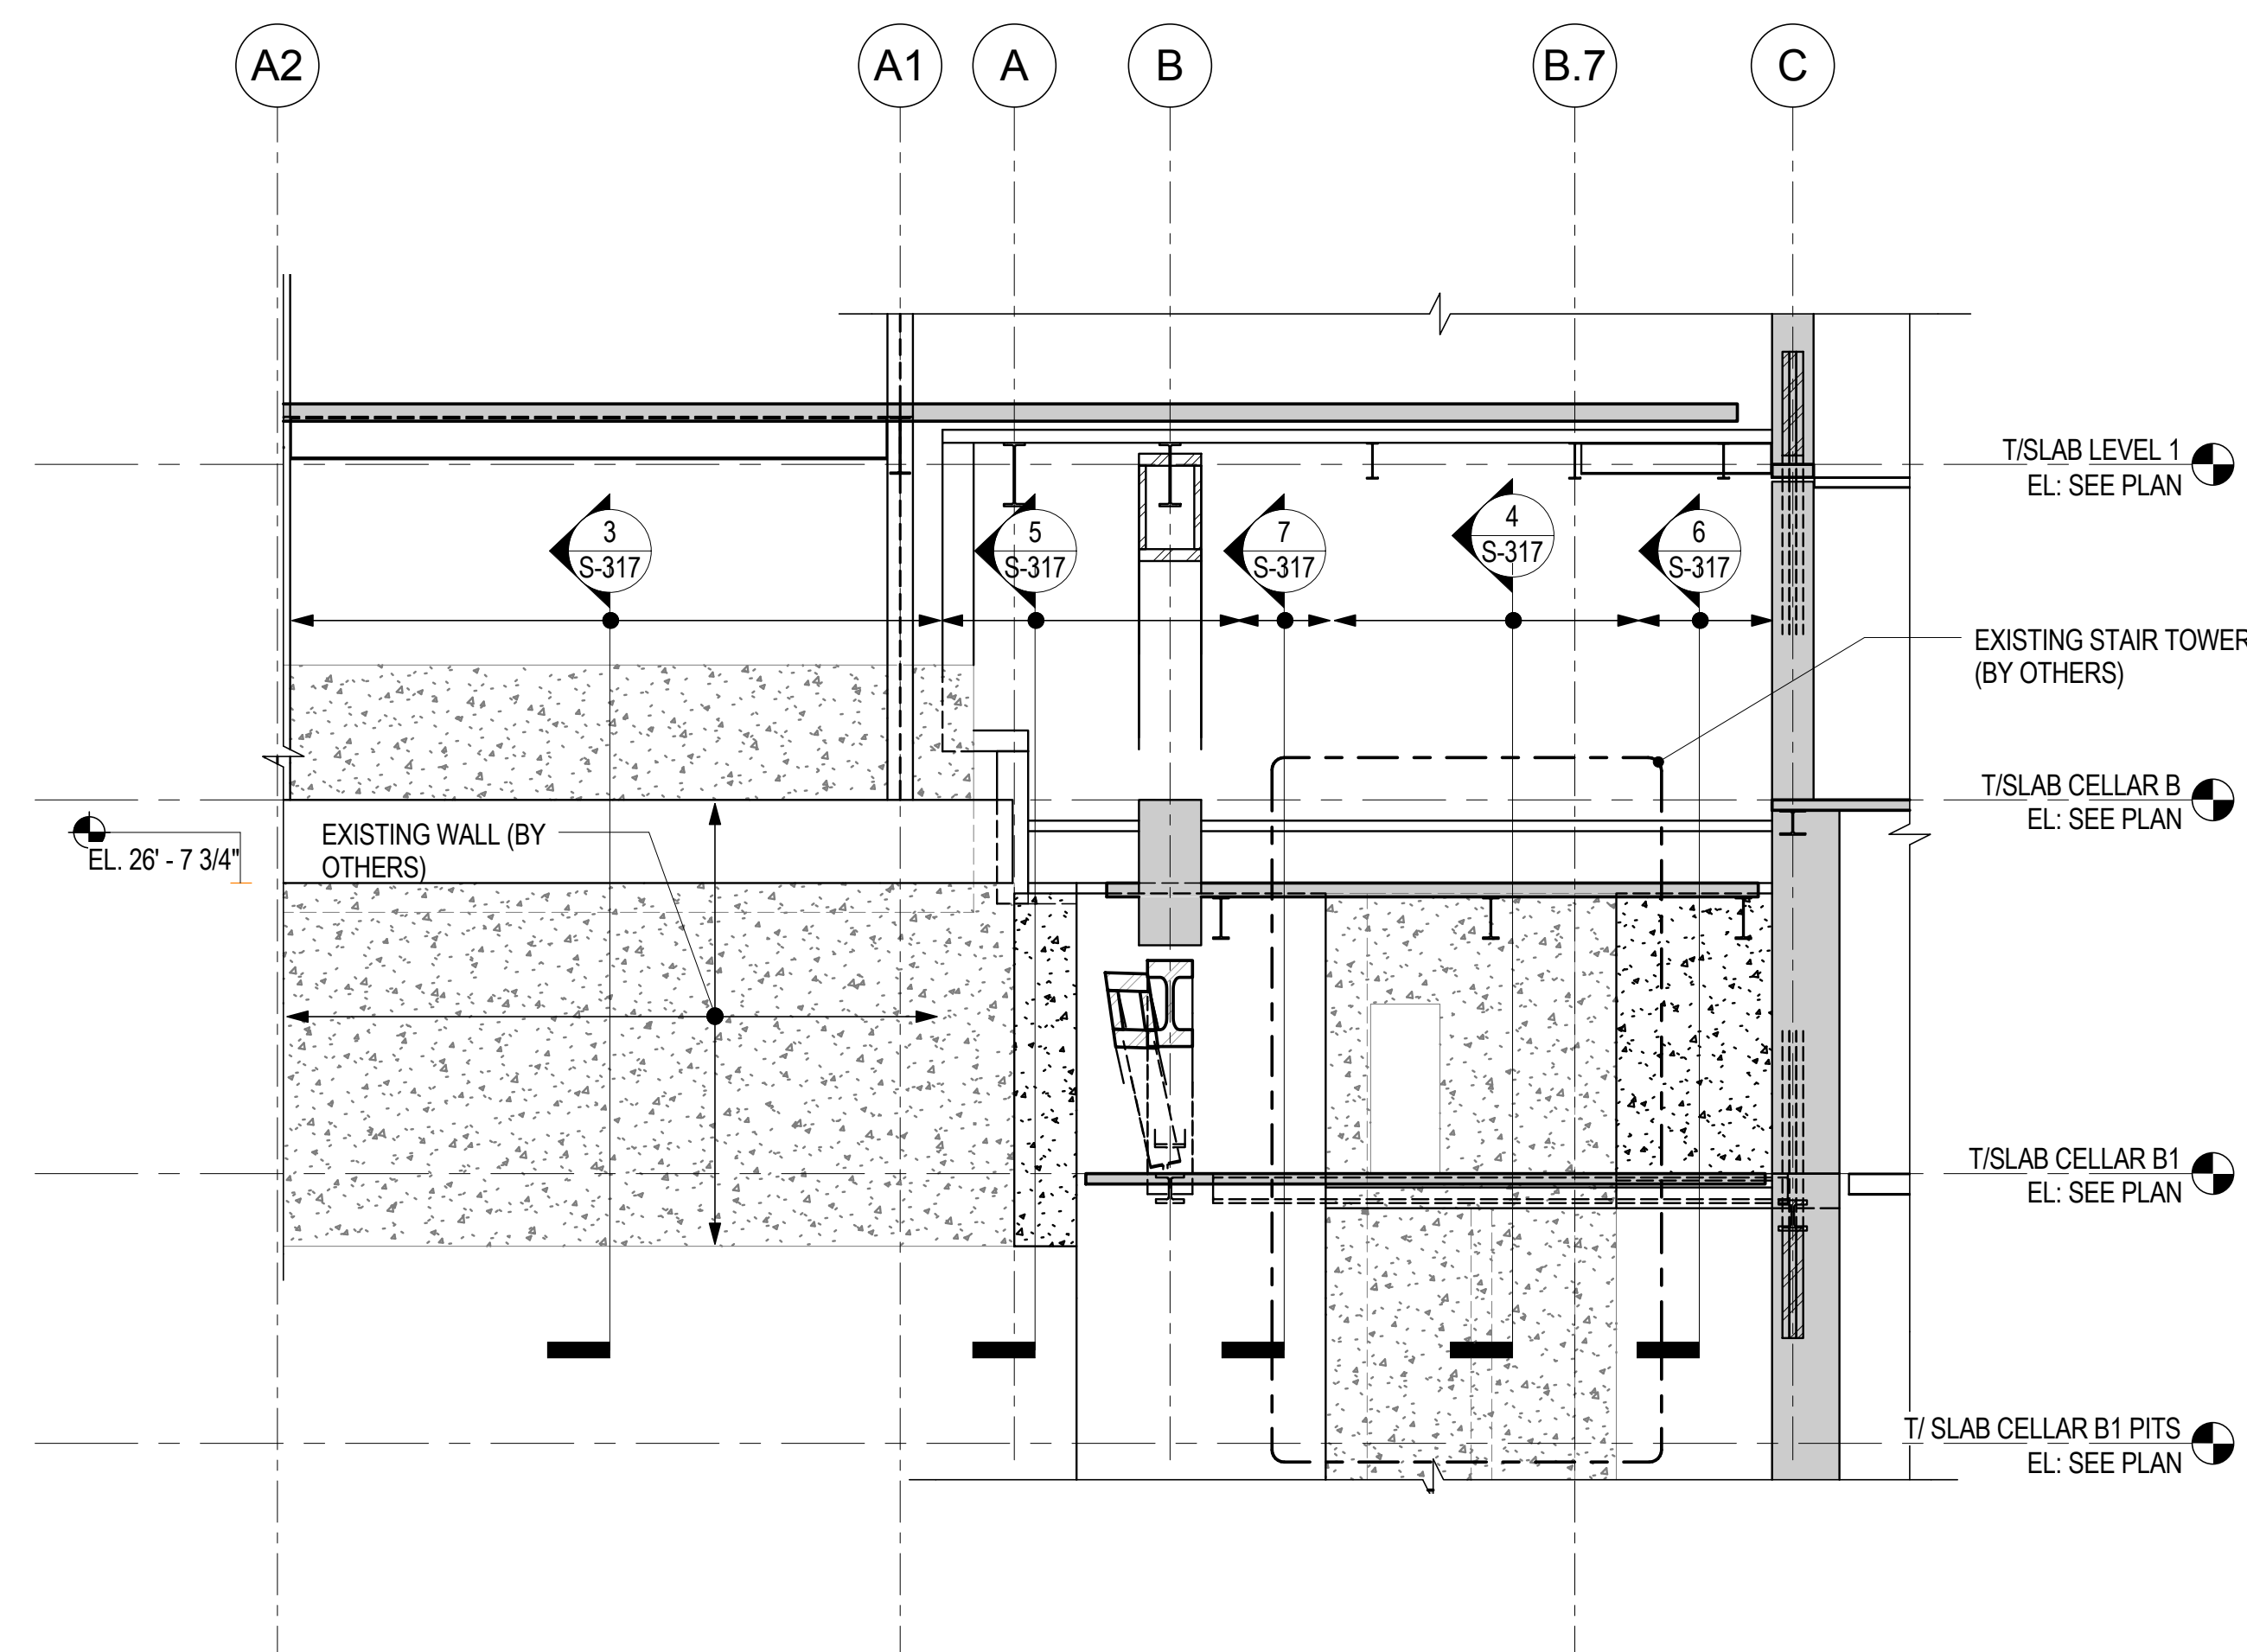


5 ELEVATION OF RETAINING WALL WEST OF TOWER CORE BETWEEN LINES 4 & 5 - LOOKING NORTH
1/8" = 1'-0"

NOTE: REFER TO SUPPORT OF EXCAVATION (S.O.E) DRAWINGS FOR ROCK BOLTS FOR BOTH TEMPORARY AND PERMANENT CONDITIONS AT ALL FOUNDATION/RETAINING WALLS

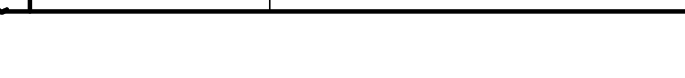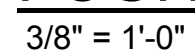

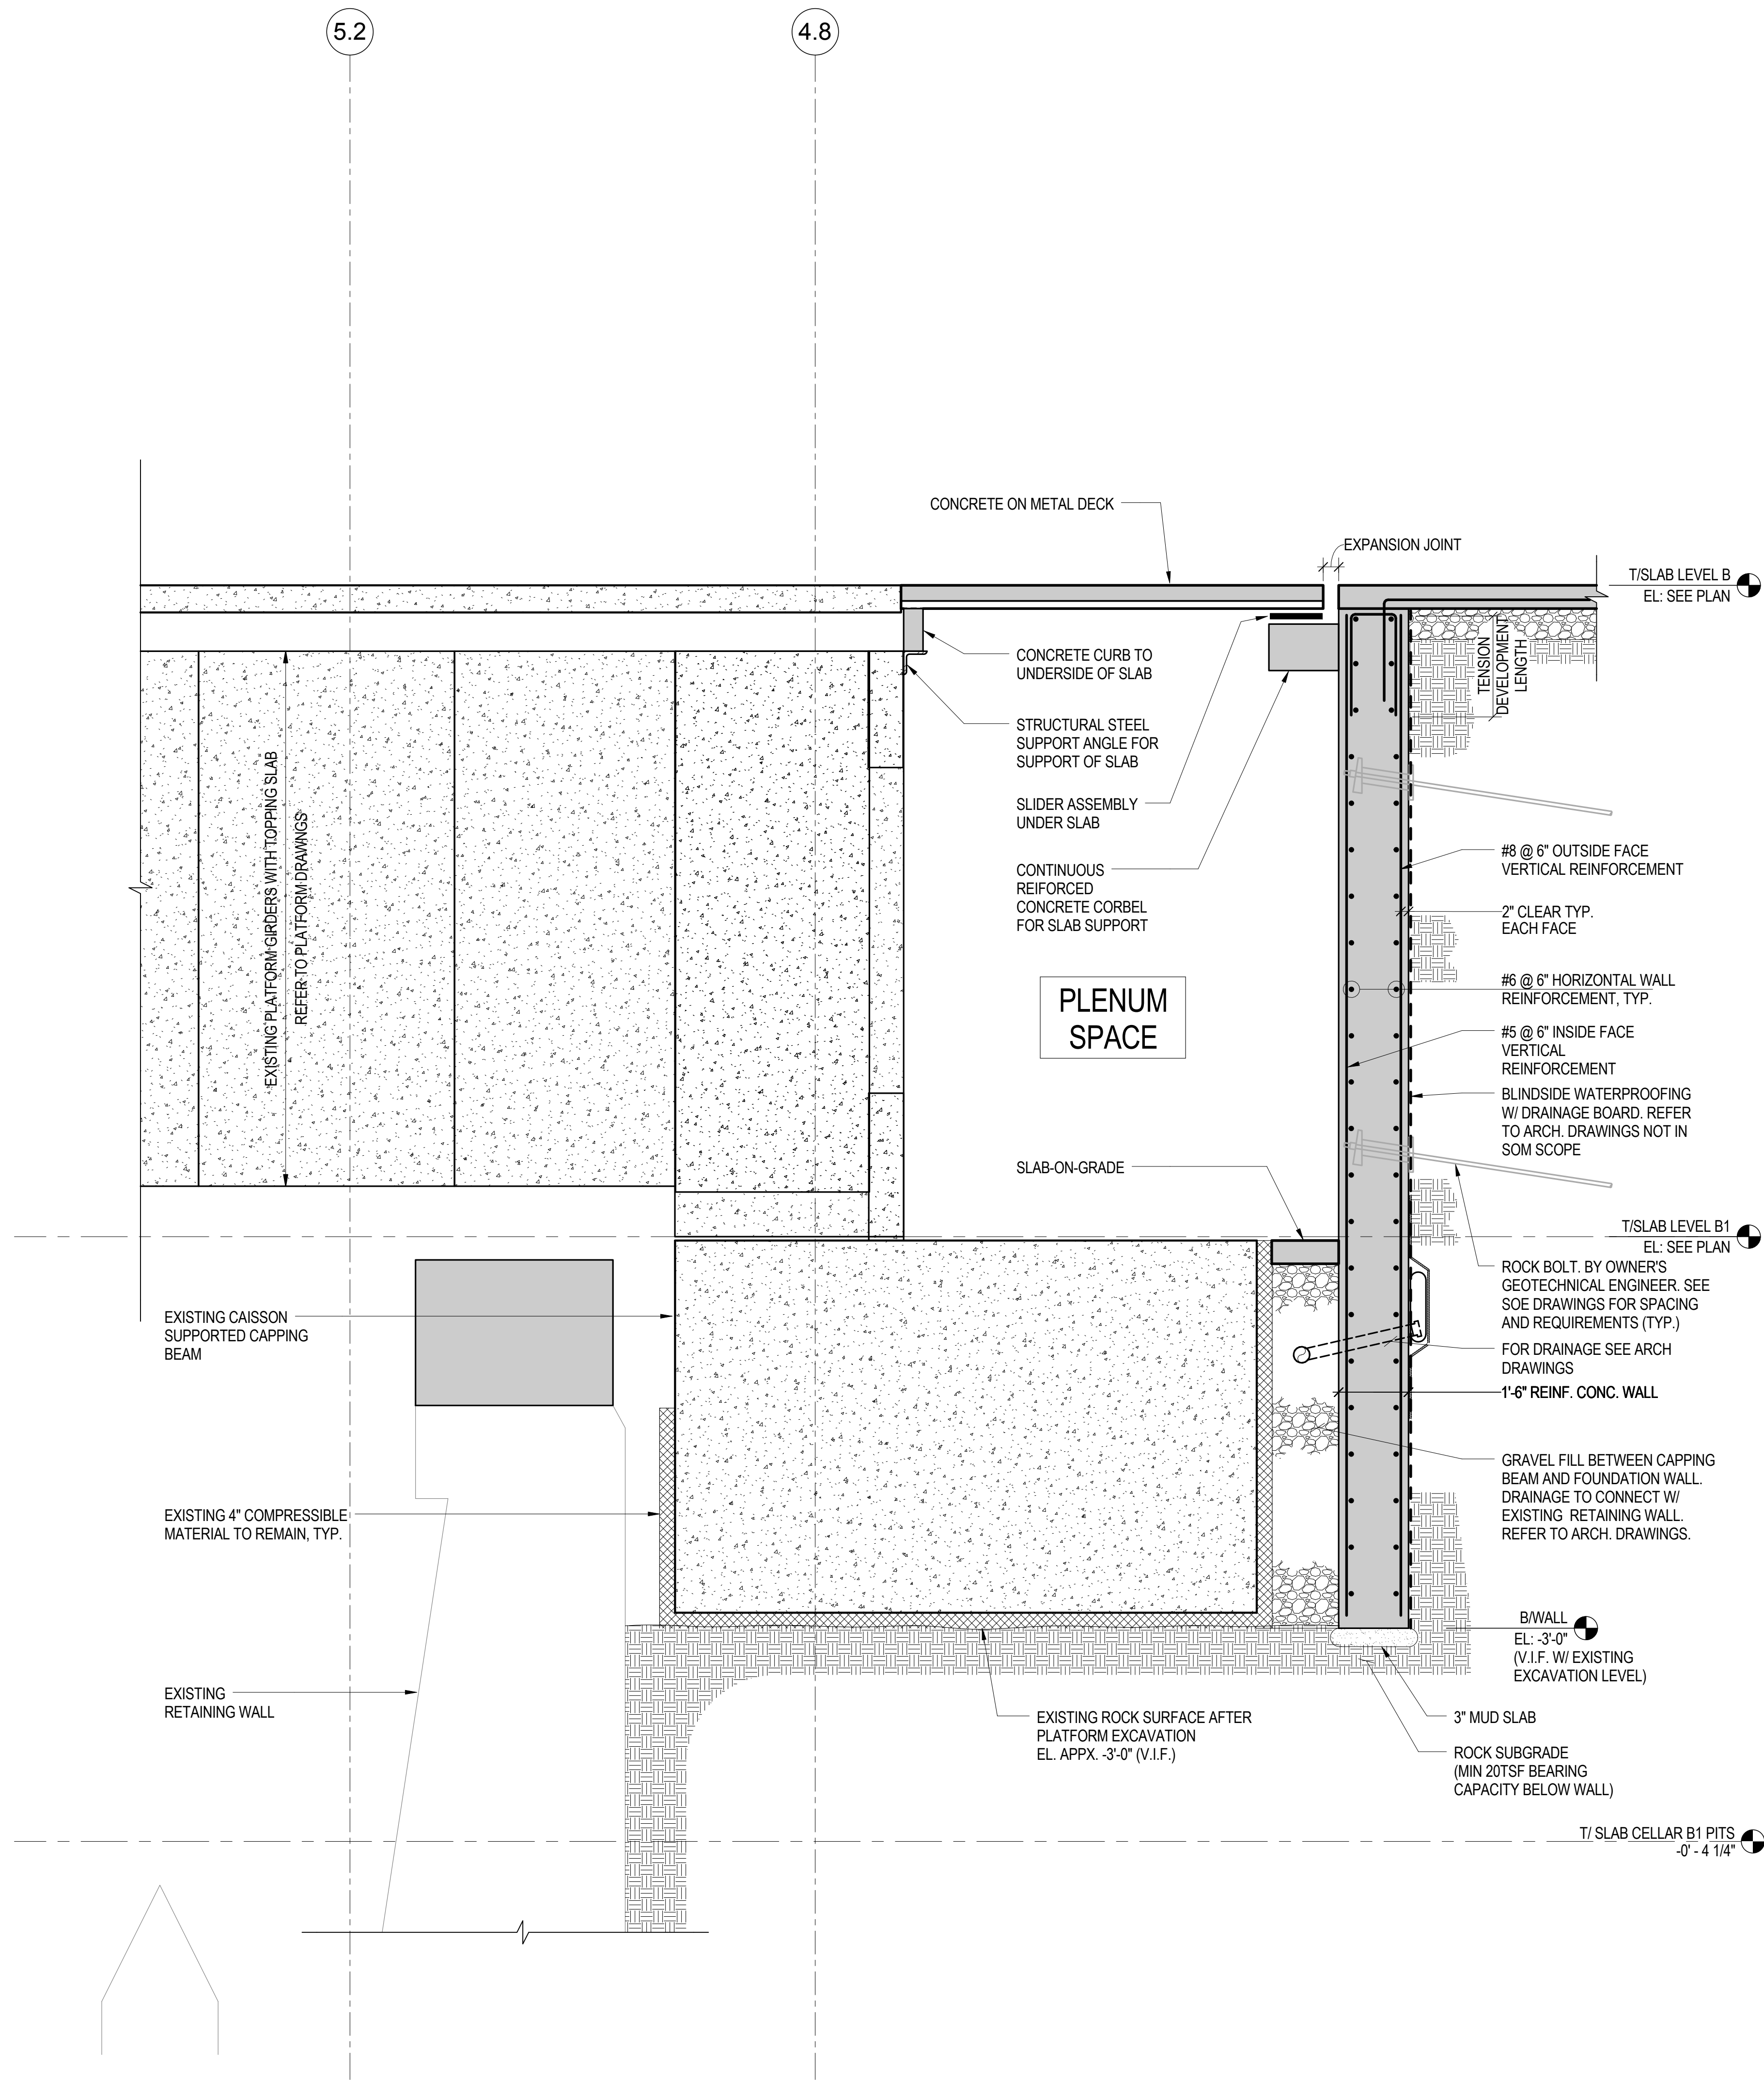


1 SECTION AT RETAINING WALL NORTH OF PLATFORM
NOT TO SCALE

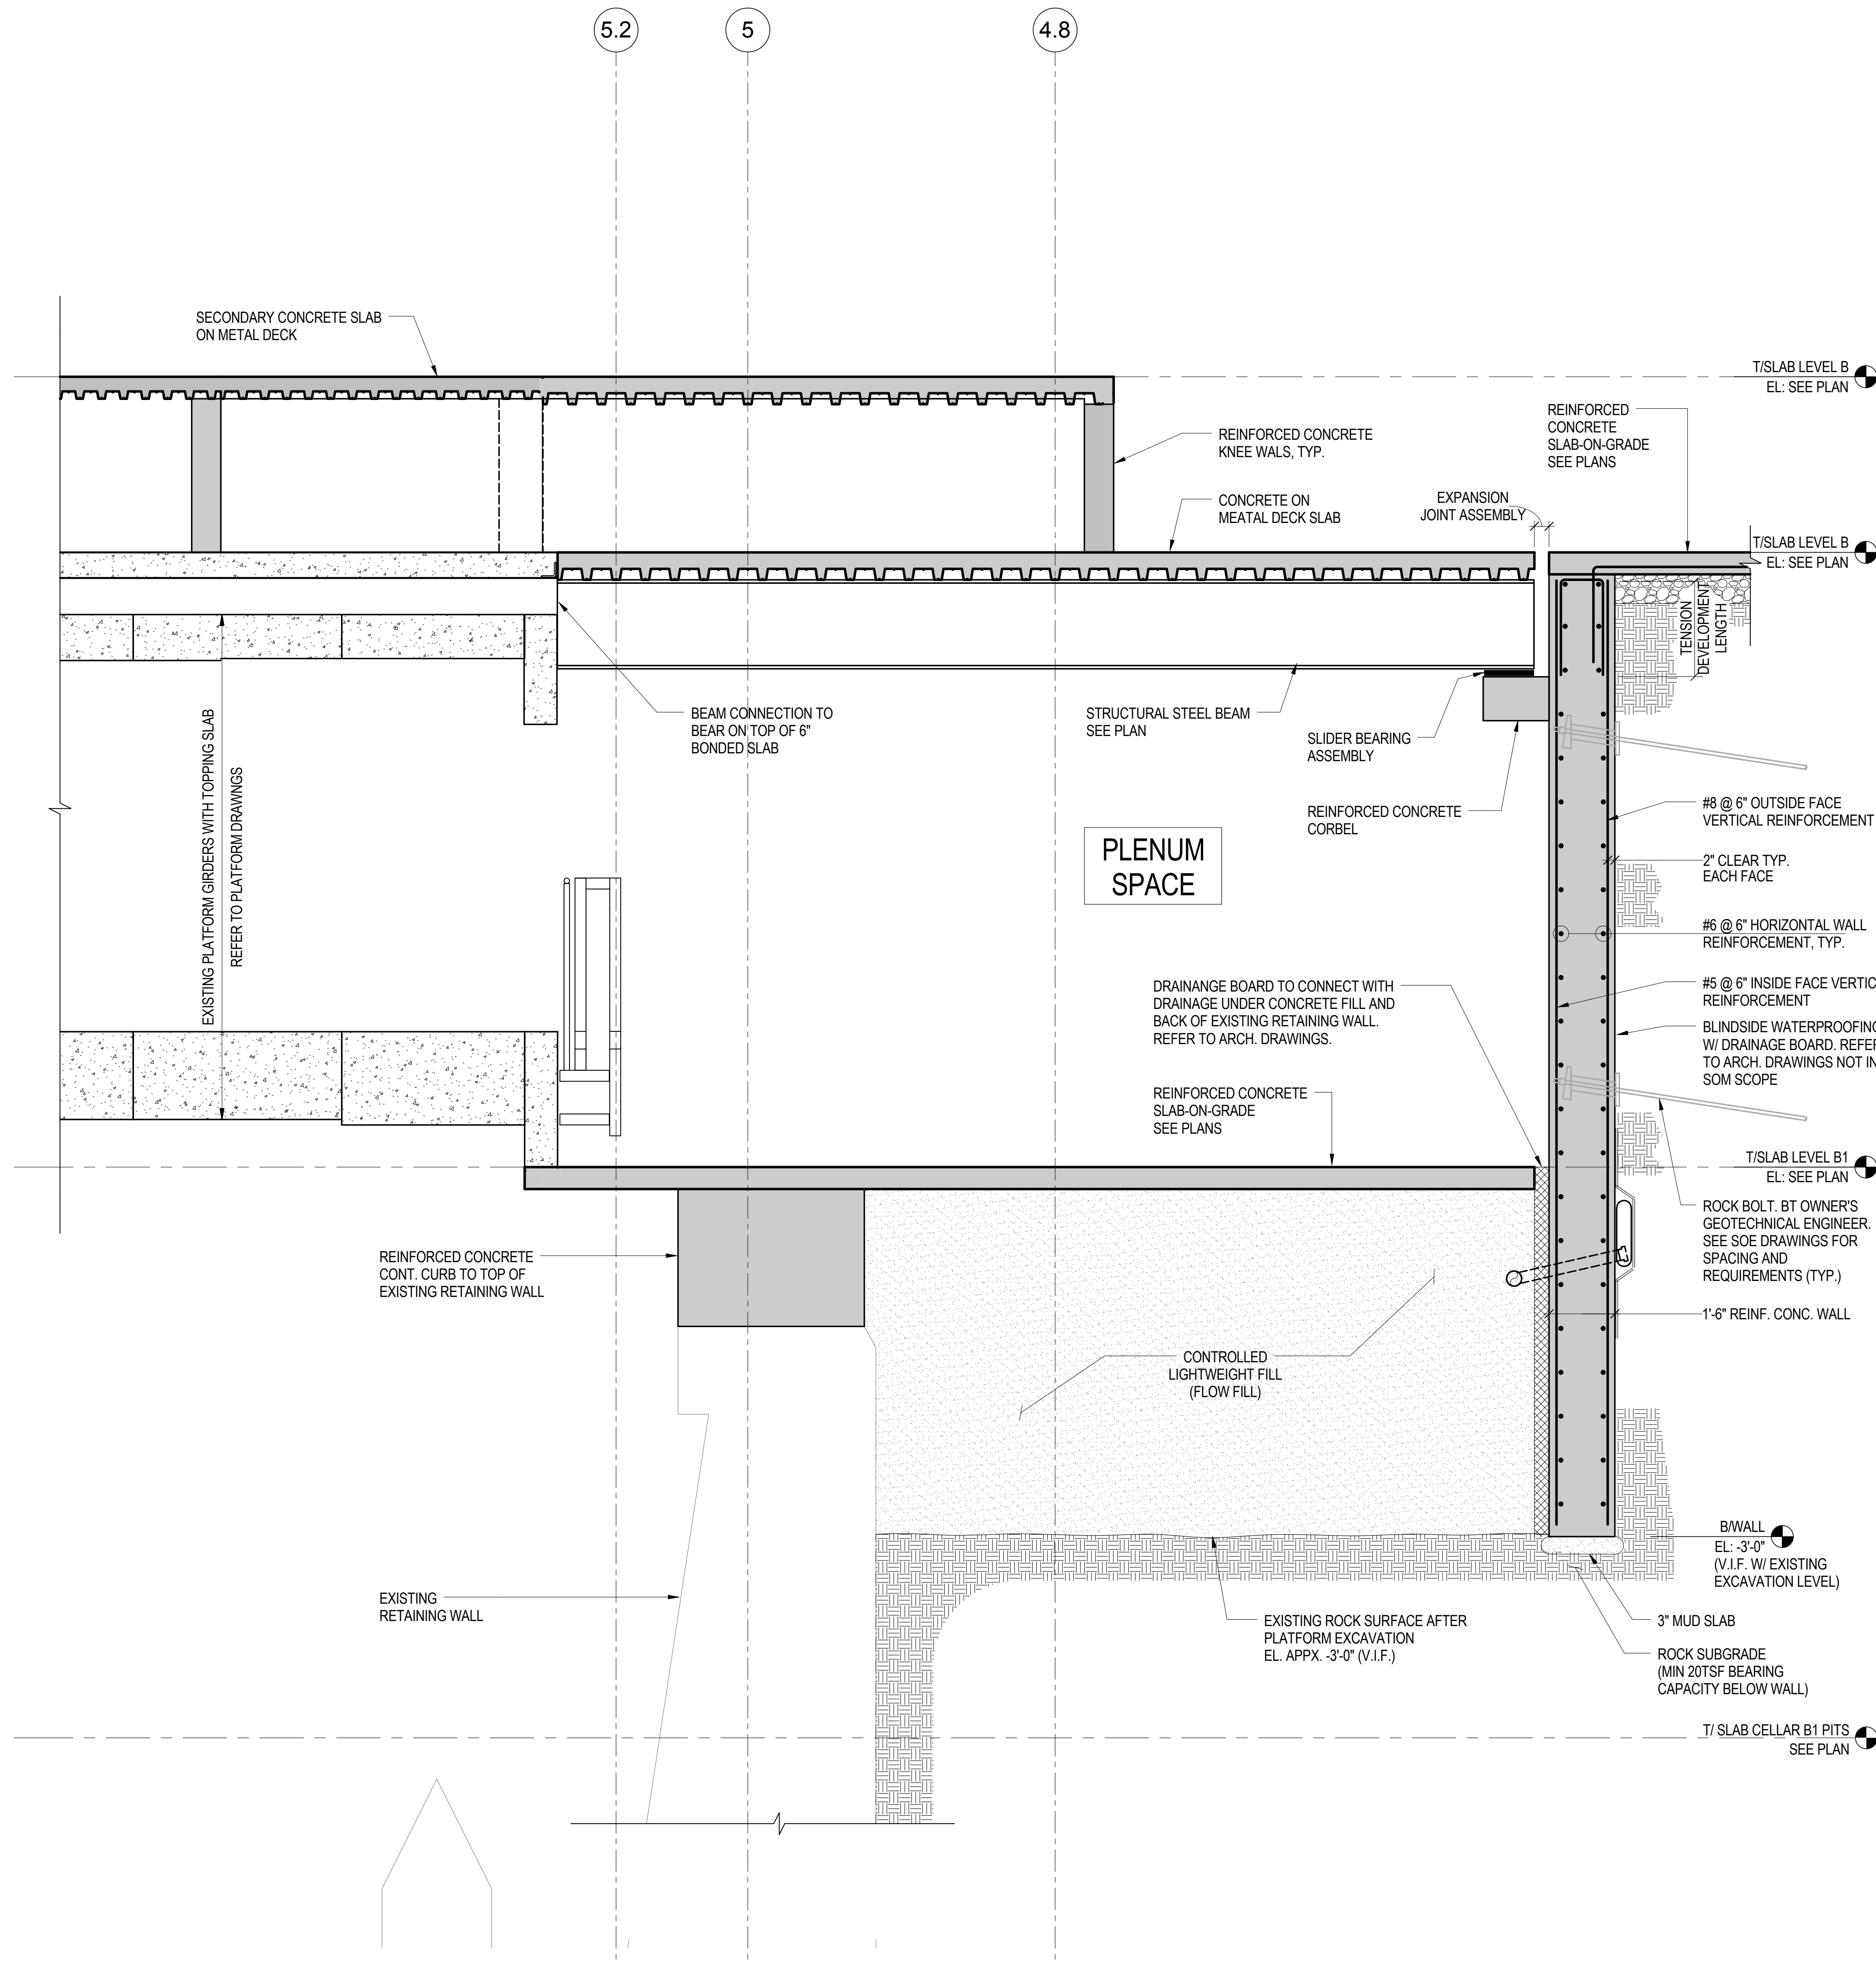


2 SECTION AT RETAINING WALL NORTH OF PLATFORM ADJACENT TO TOWER CORE
NOT TO SCALE




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Key Plan:



Seal & Signature:

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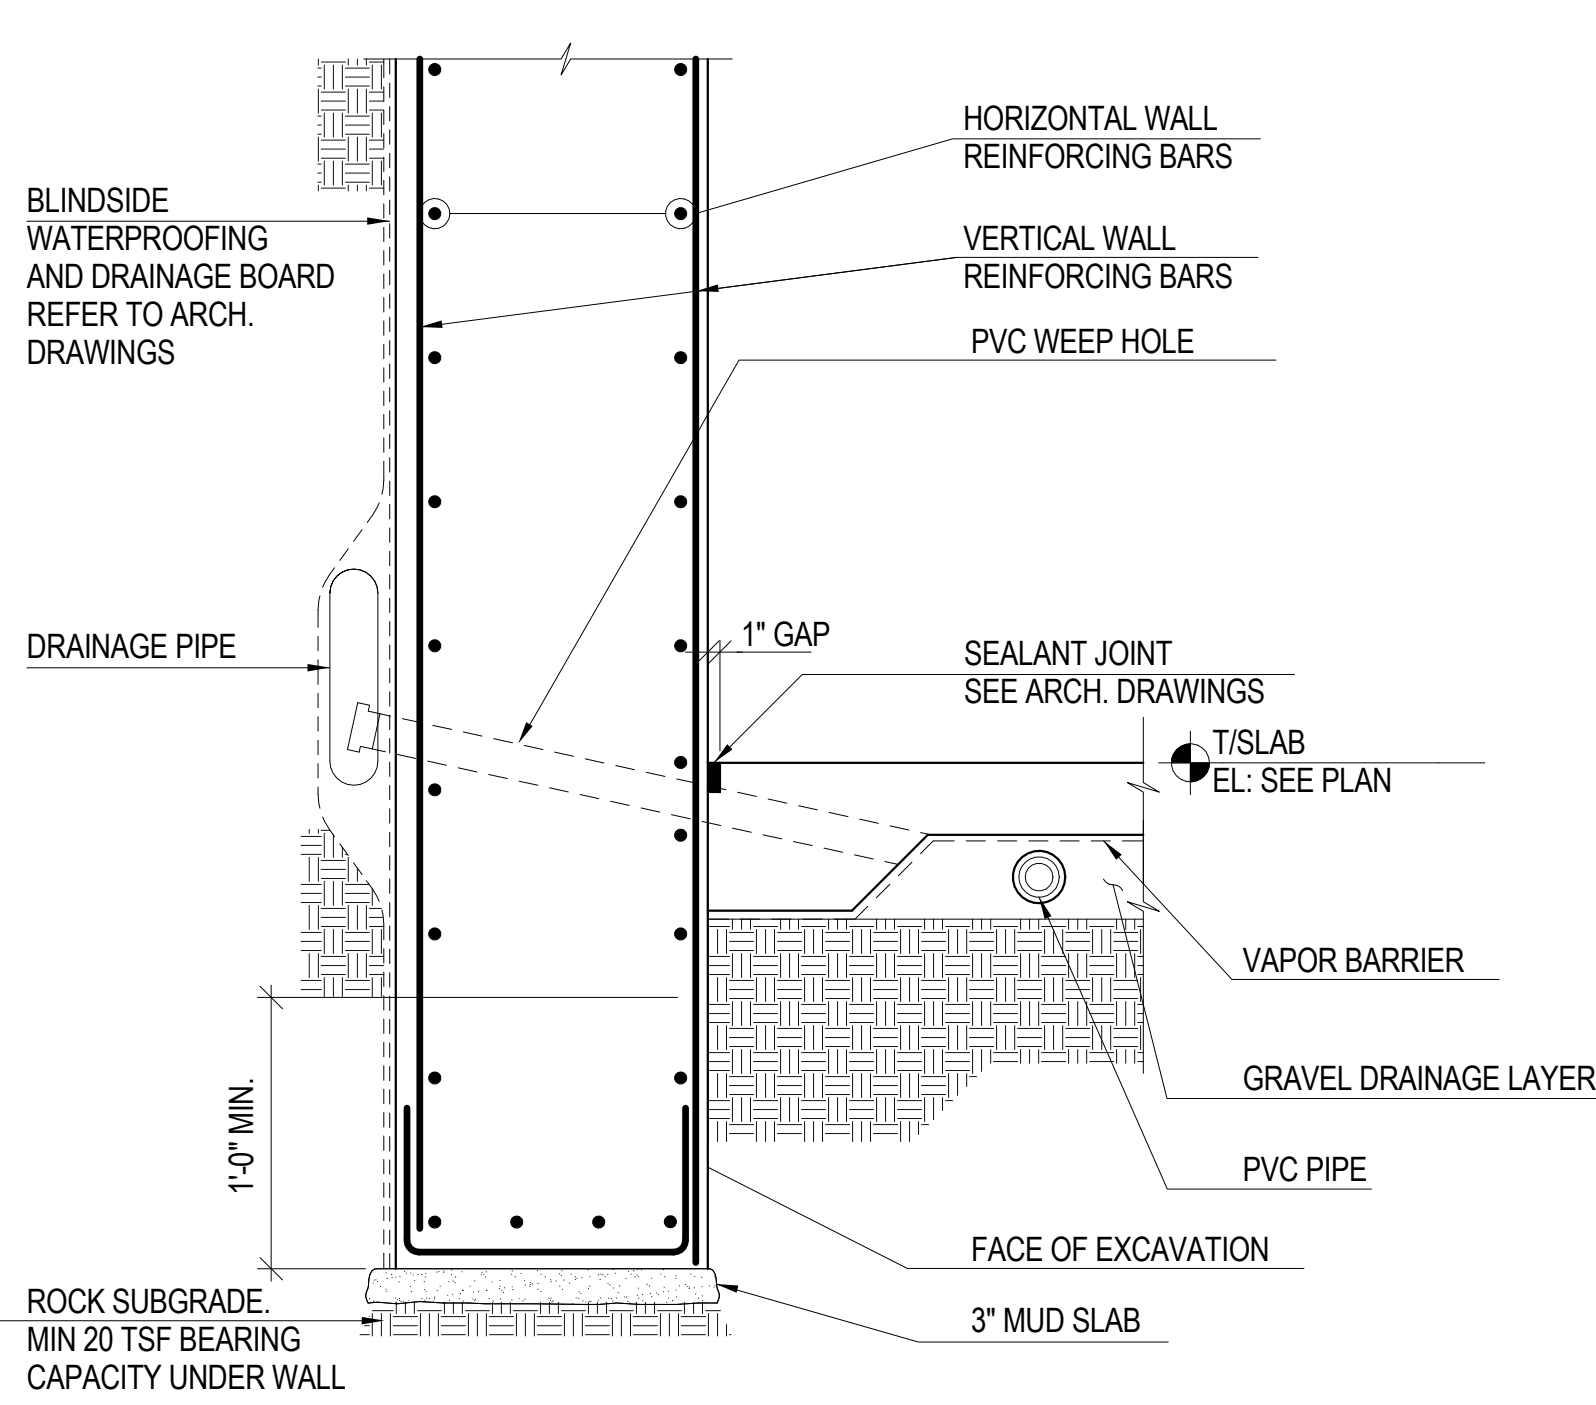
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**FOUNDATION
WALL SECTIONS
& DETAILS**

Project No.:	B-SCAN Sheet No.:
211157	S-317.00

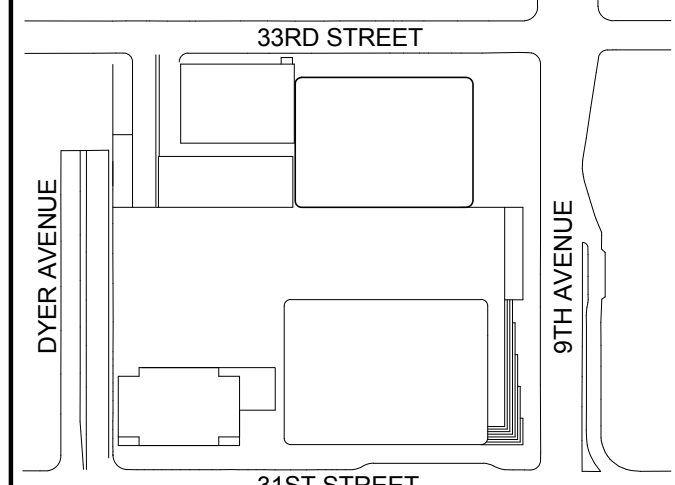Date:	Sheet No.:
20 JUN 2014	S-317


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1/2" = 1'-0"	44 of 90

File No.:	Page No.:
S-317	44 of 90




NOTE: REFER TO THE DRAWING U-001 FOR DETAILS OF THE UNDERDRAIN SYSTEM.


1 TYPICAL FOUNDATION WALL DETAIL AT BASE
SCALE: 3/4" = 1'-0"

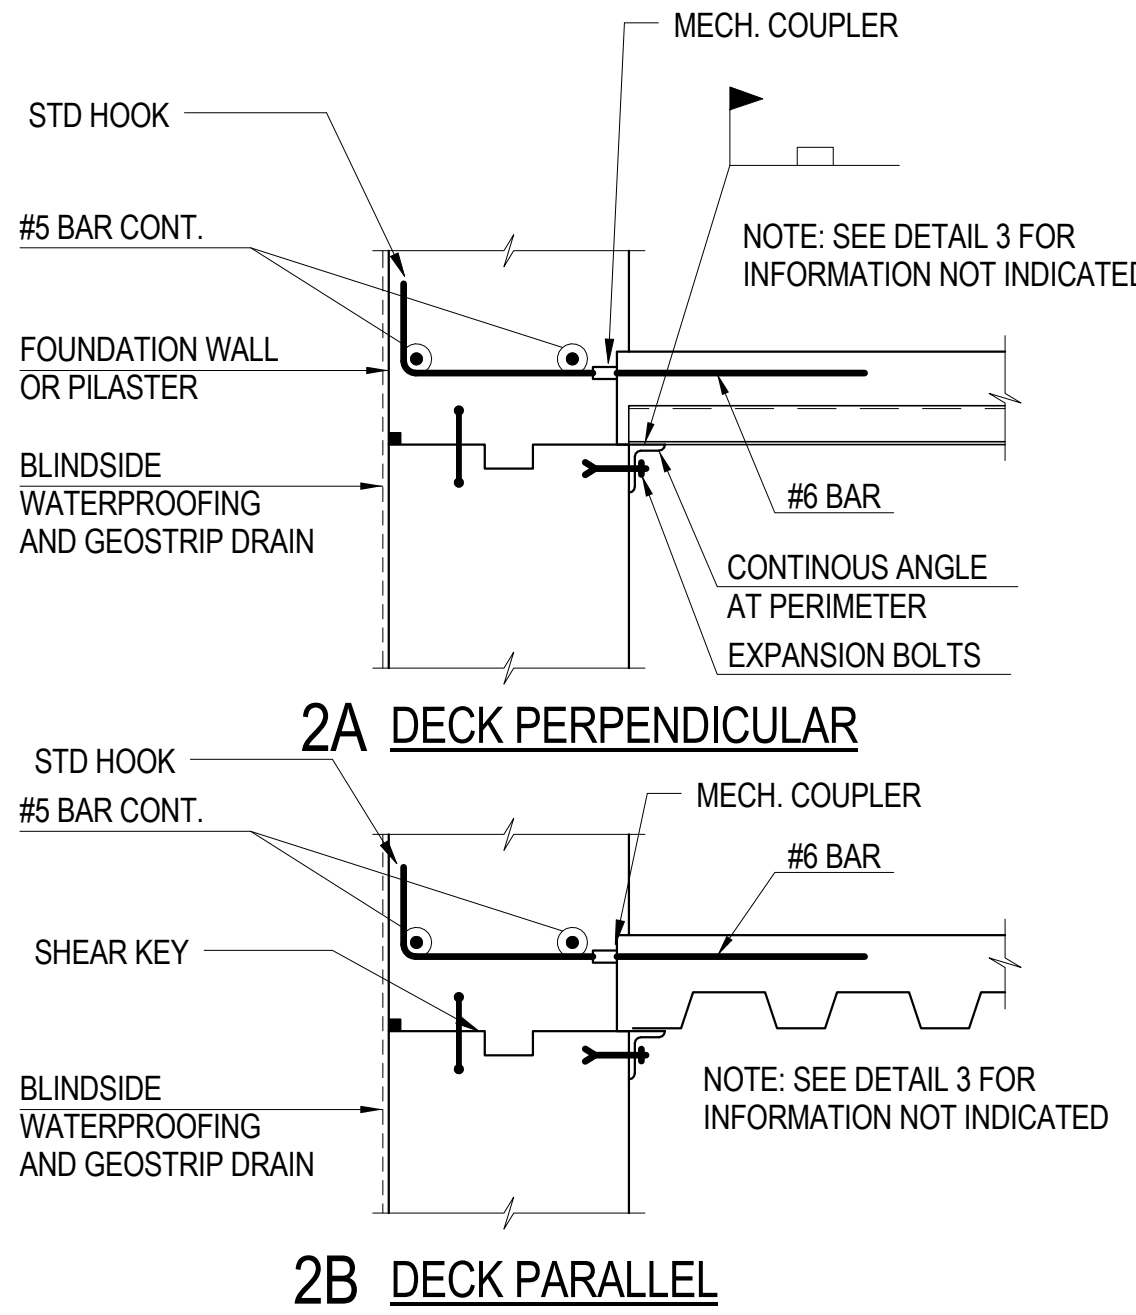


2 TYPICAL METAL DECK TO FOUNDATION WALL DETAILS
SCALE: 3/4" = 1'-0"

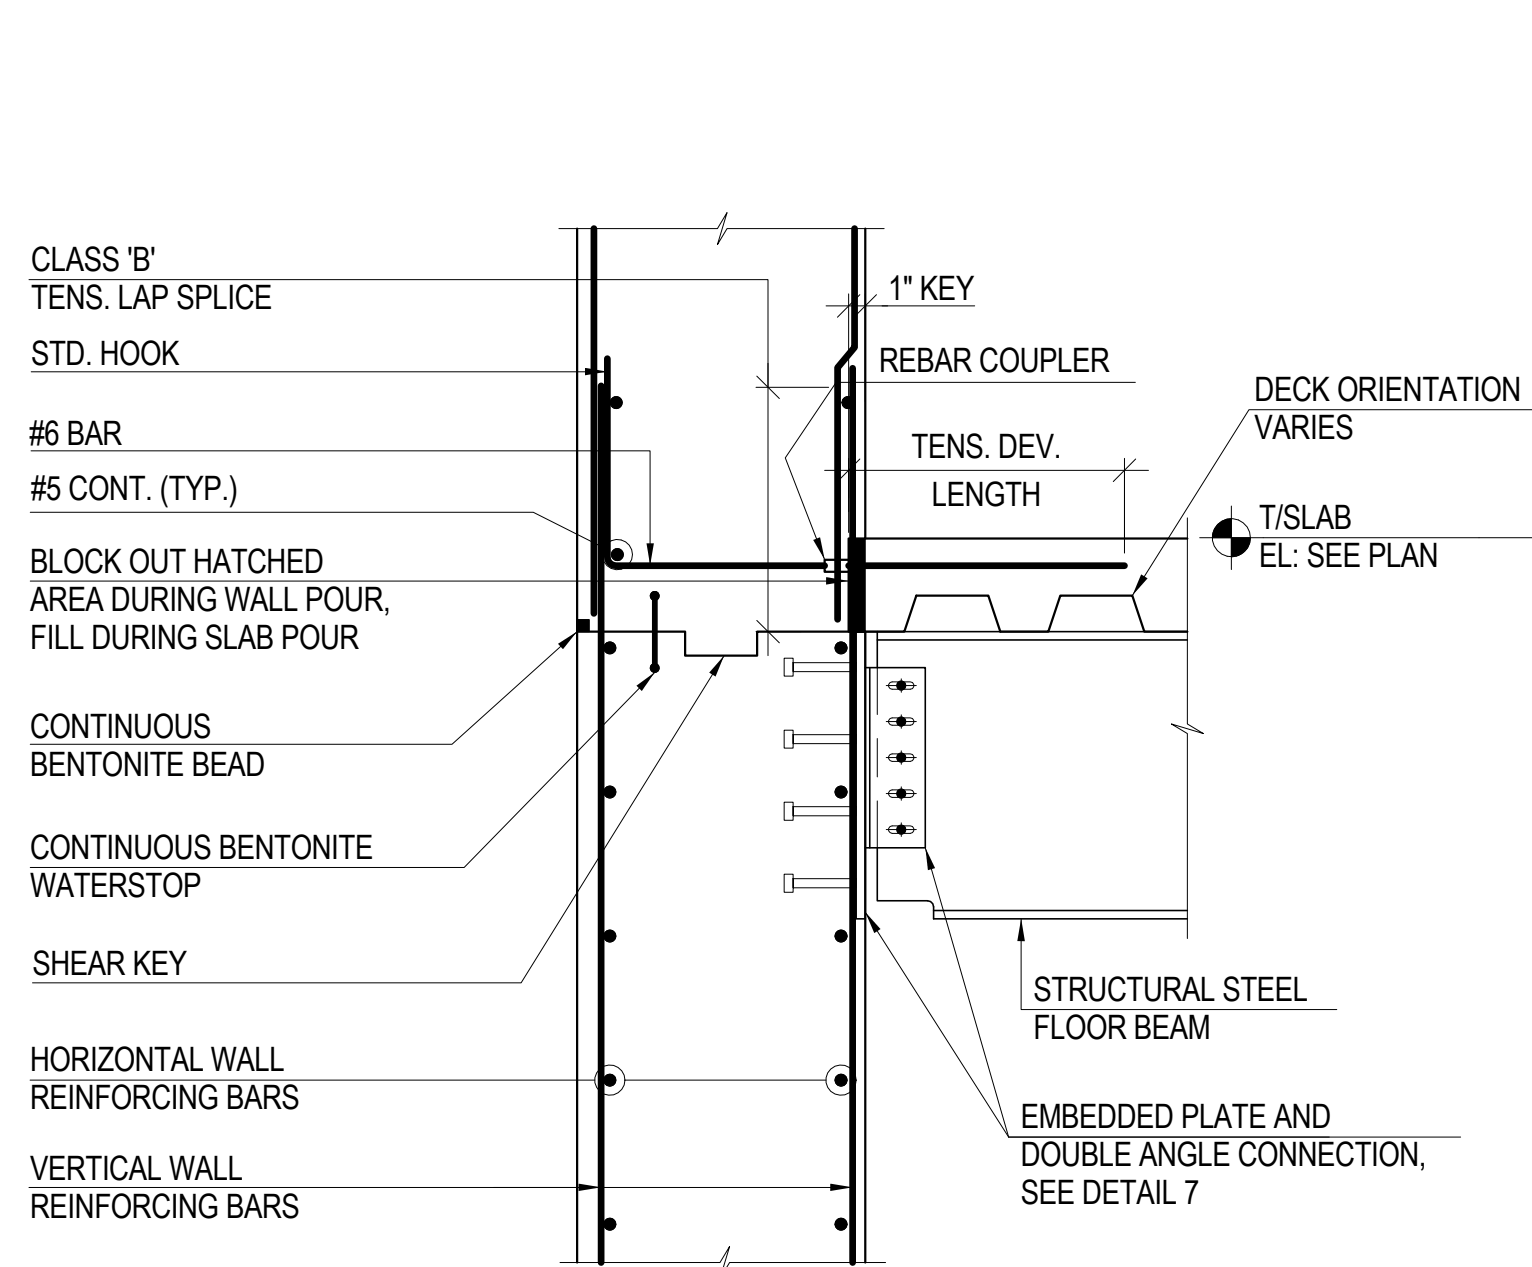


3 TYPICAL BEAM TO FOUNDATION WALL DETAIL
SCALE: 3/4" = 1'-0"

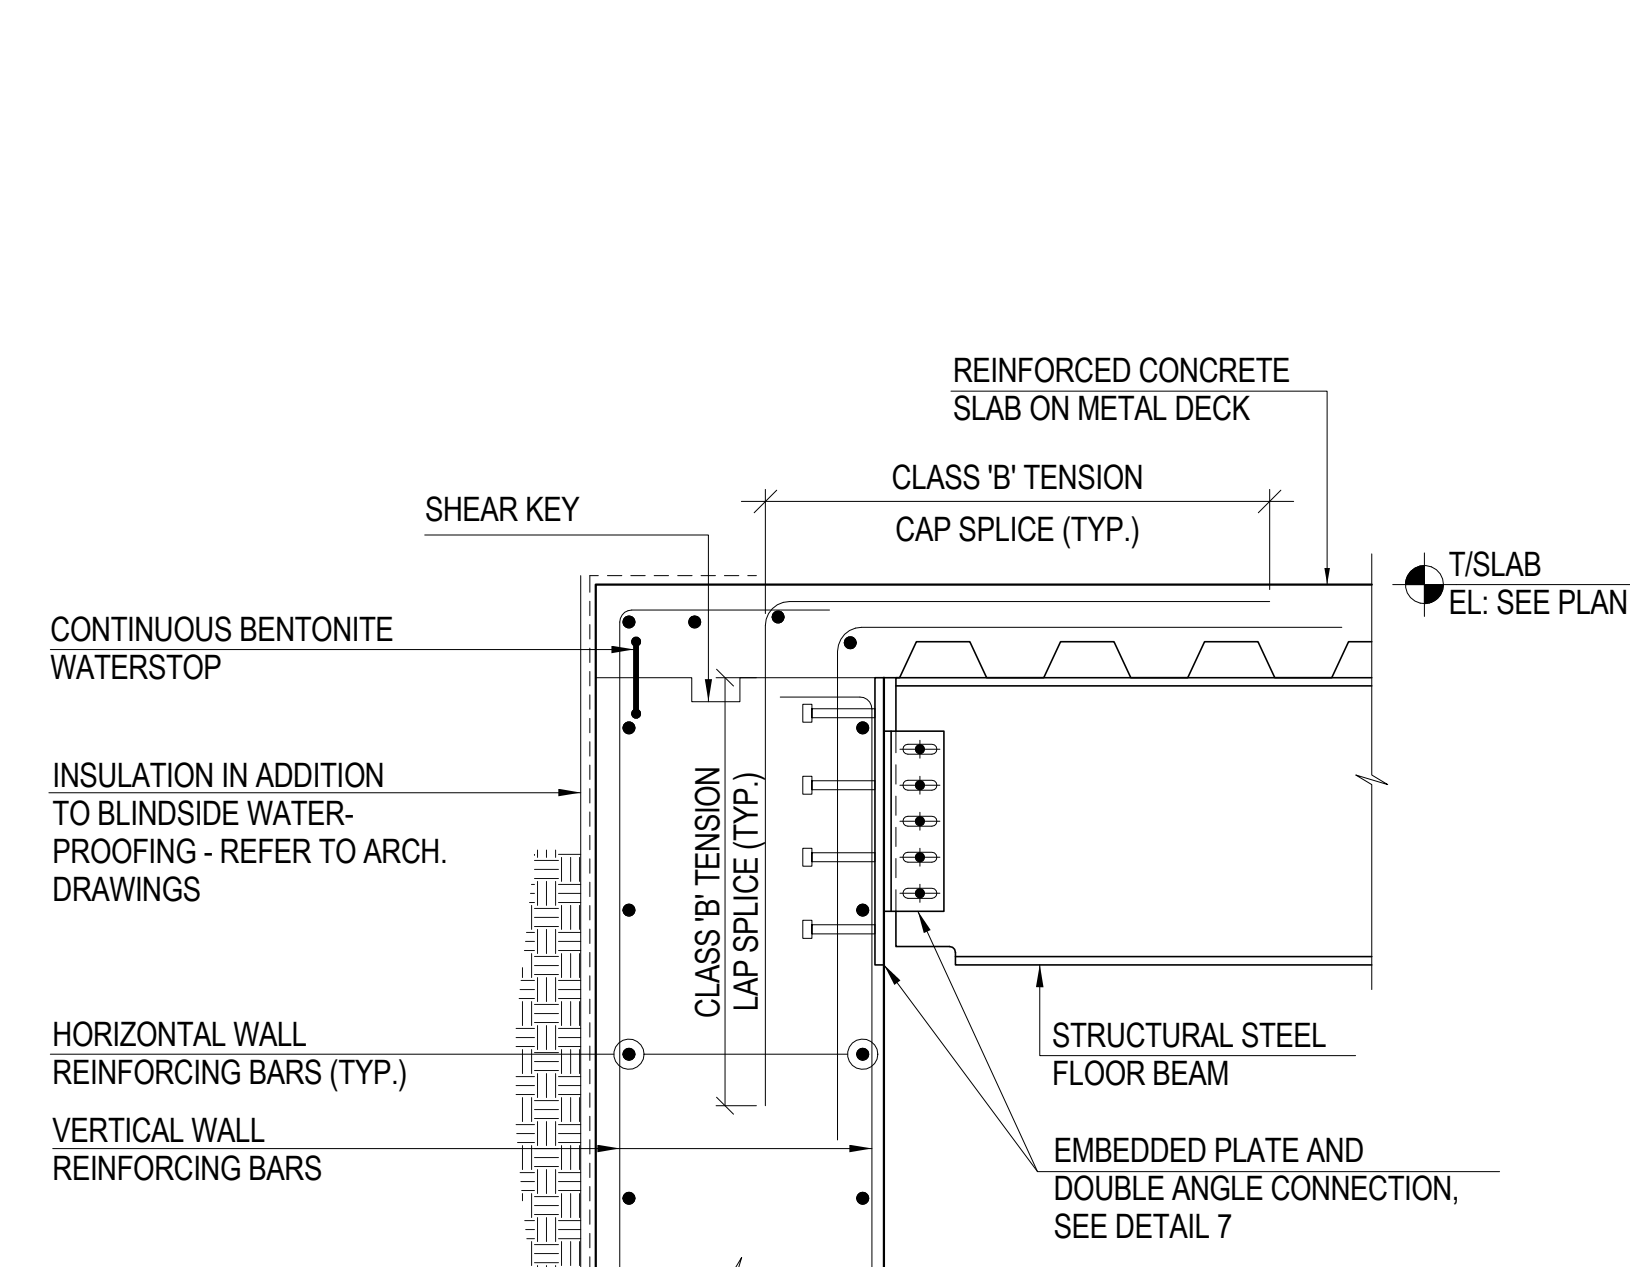


4 TYPICAL FOUNDATION WALL DETAIL AT TOP
SCALE: 3/4" = 1'-0"

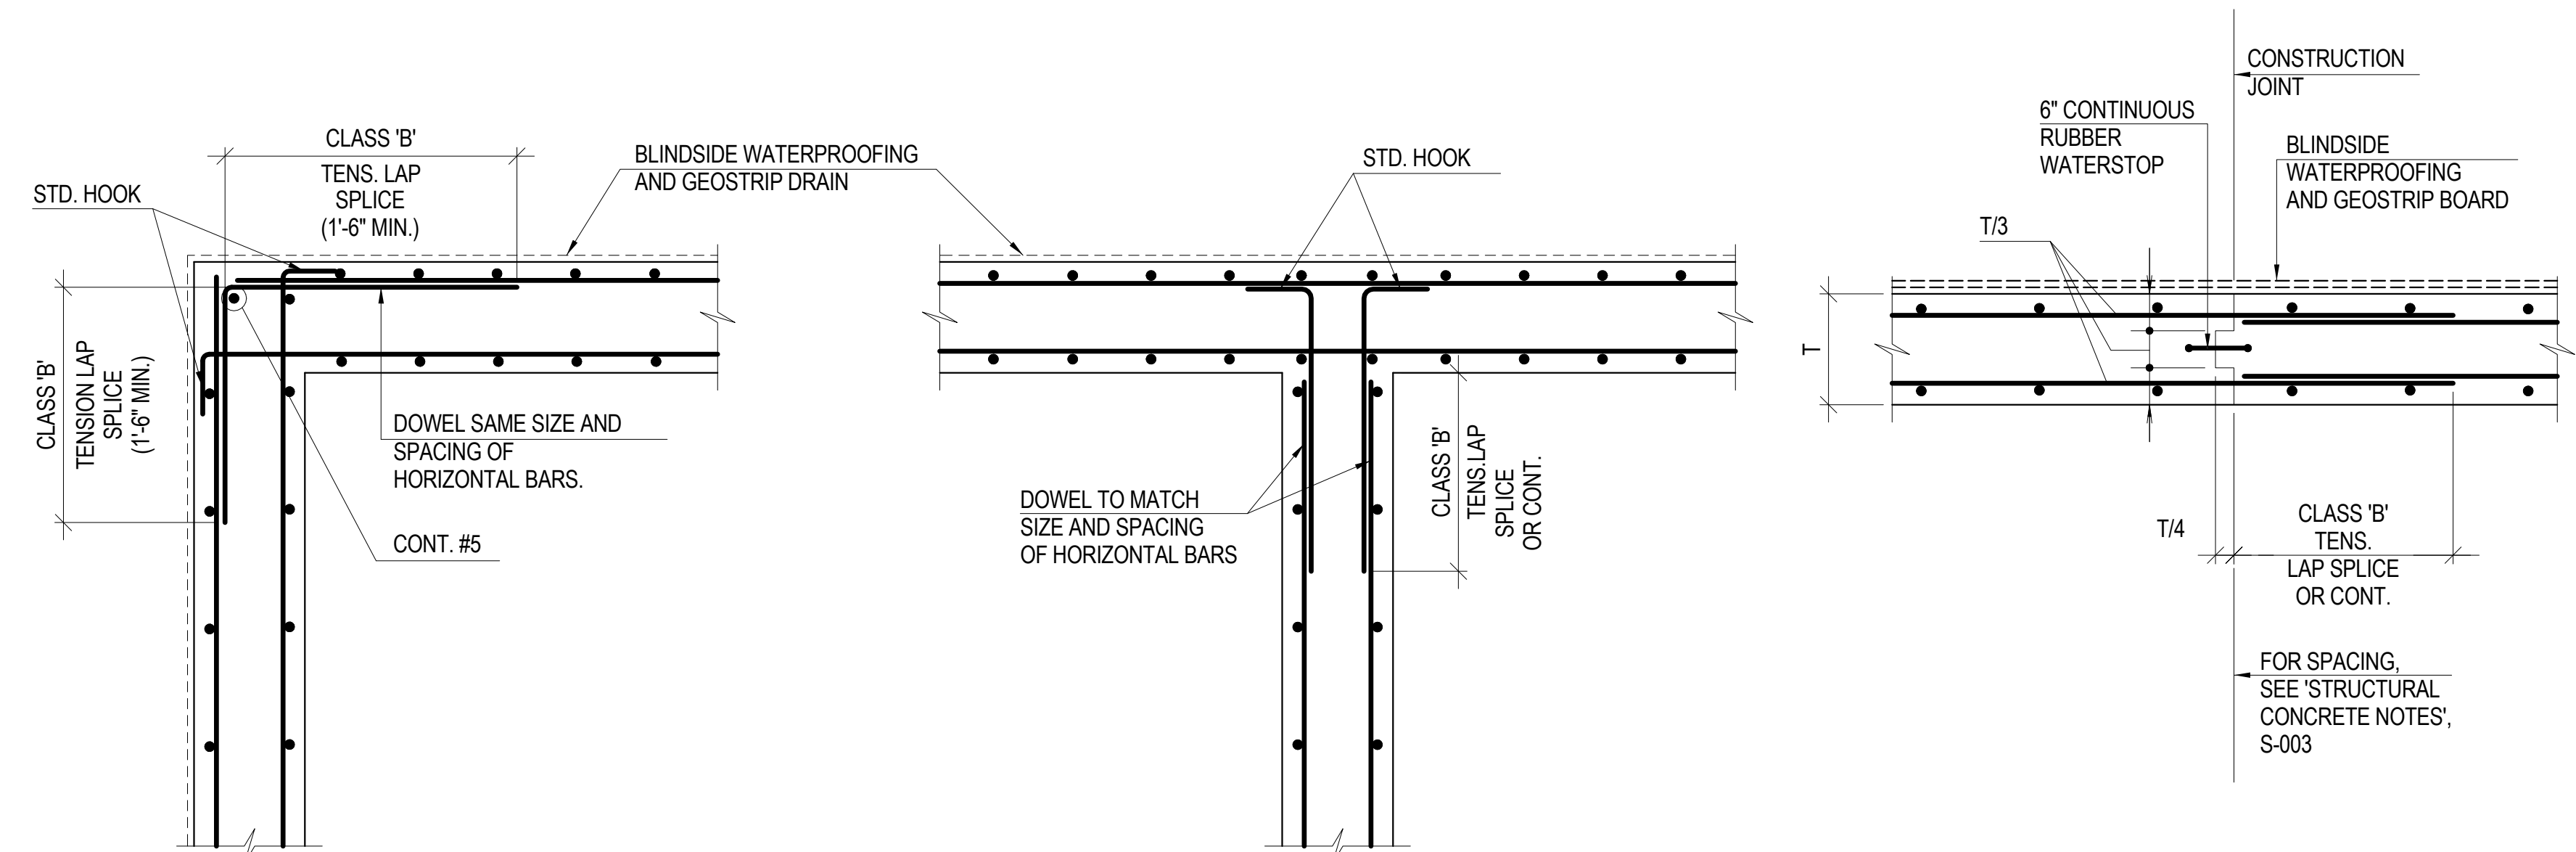

5 TYPICAL FOUNDATION WALL DETAILS
SCALE: 3/4" = 1'-0"

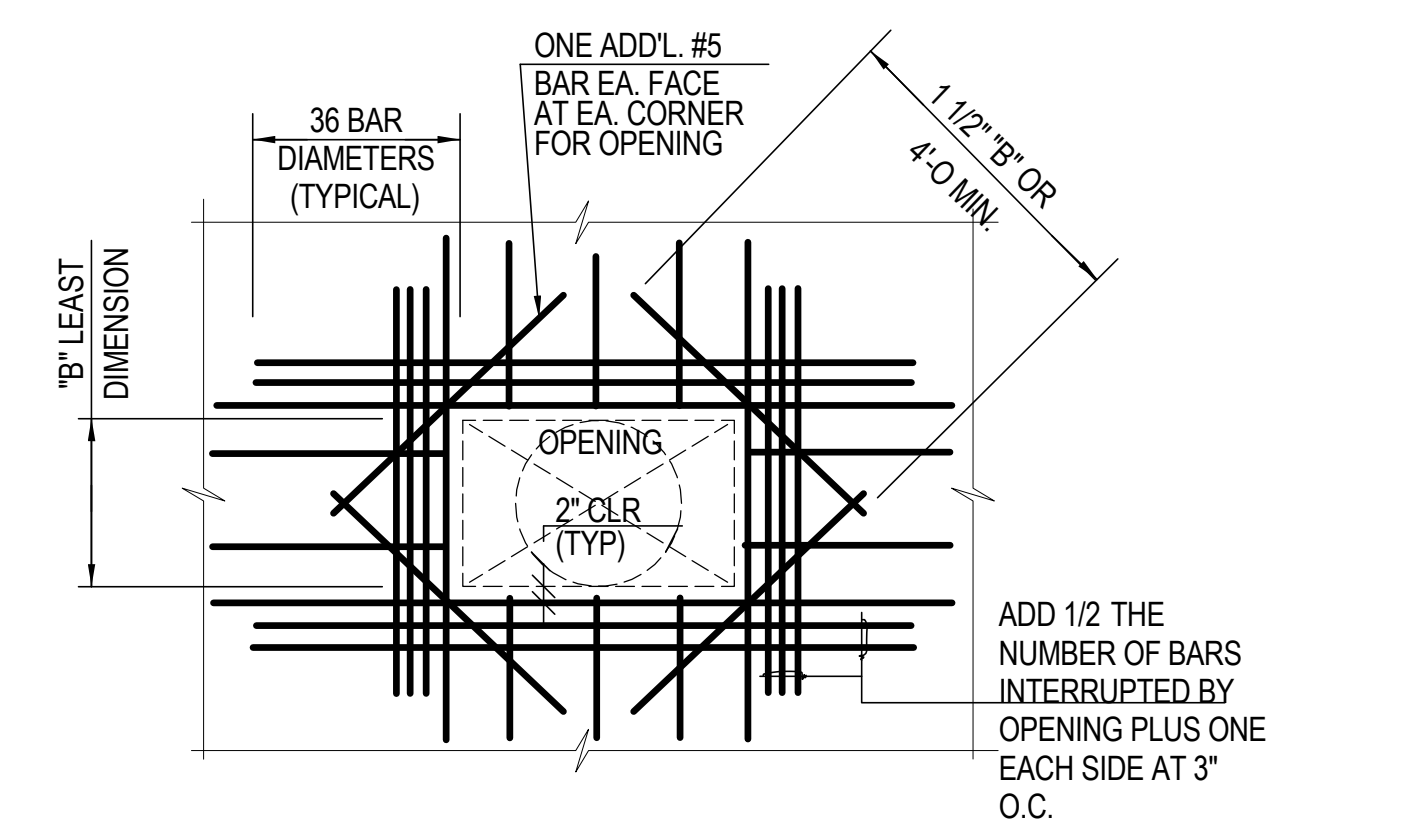


6A TYPICAL RECTANGULAR WALL OPENING

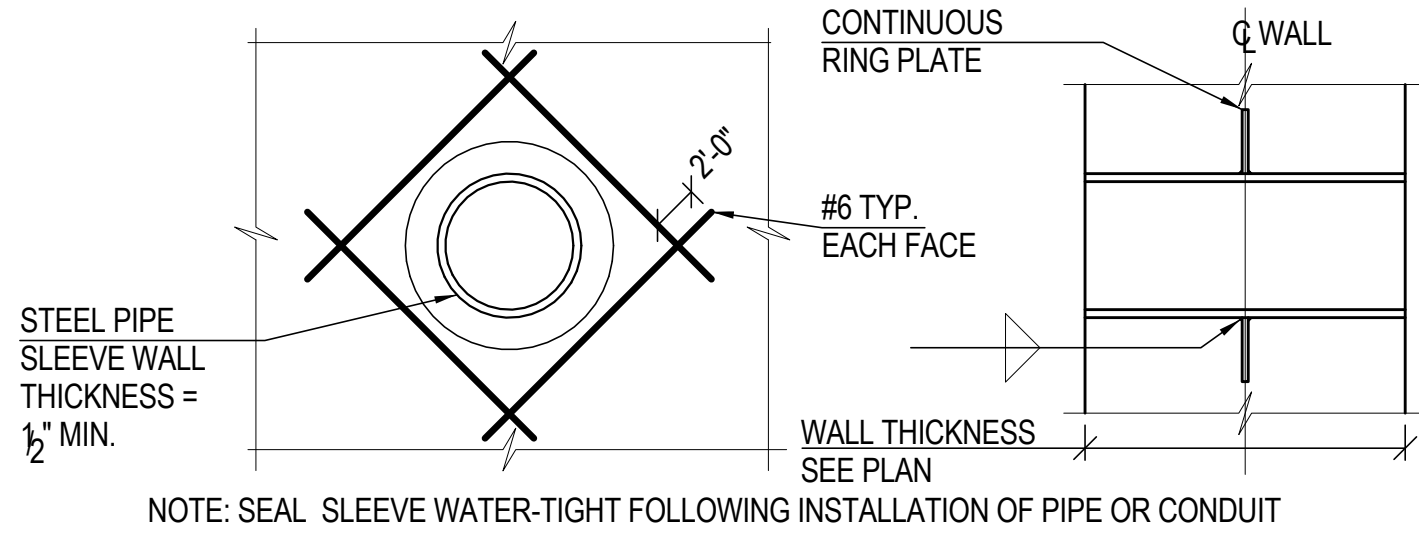

6B TYPICAL SLEEVE WALL OPENING (10" DIA. MAX.)


6 TYPICAL OPENING DETAILS
NOT TO SCALE

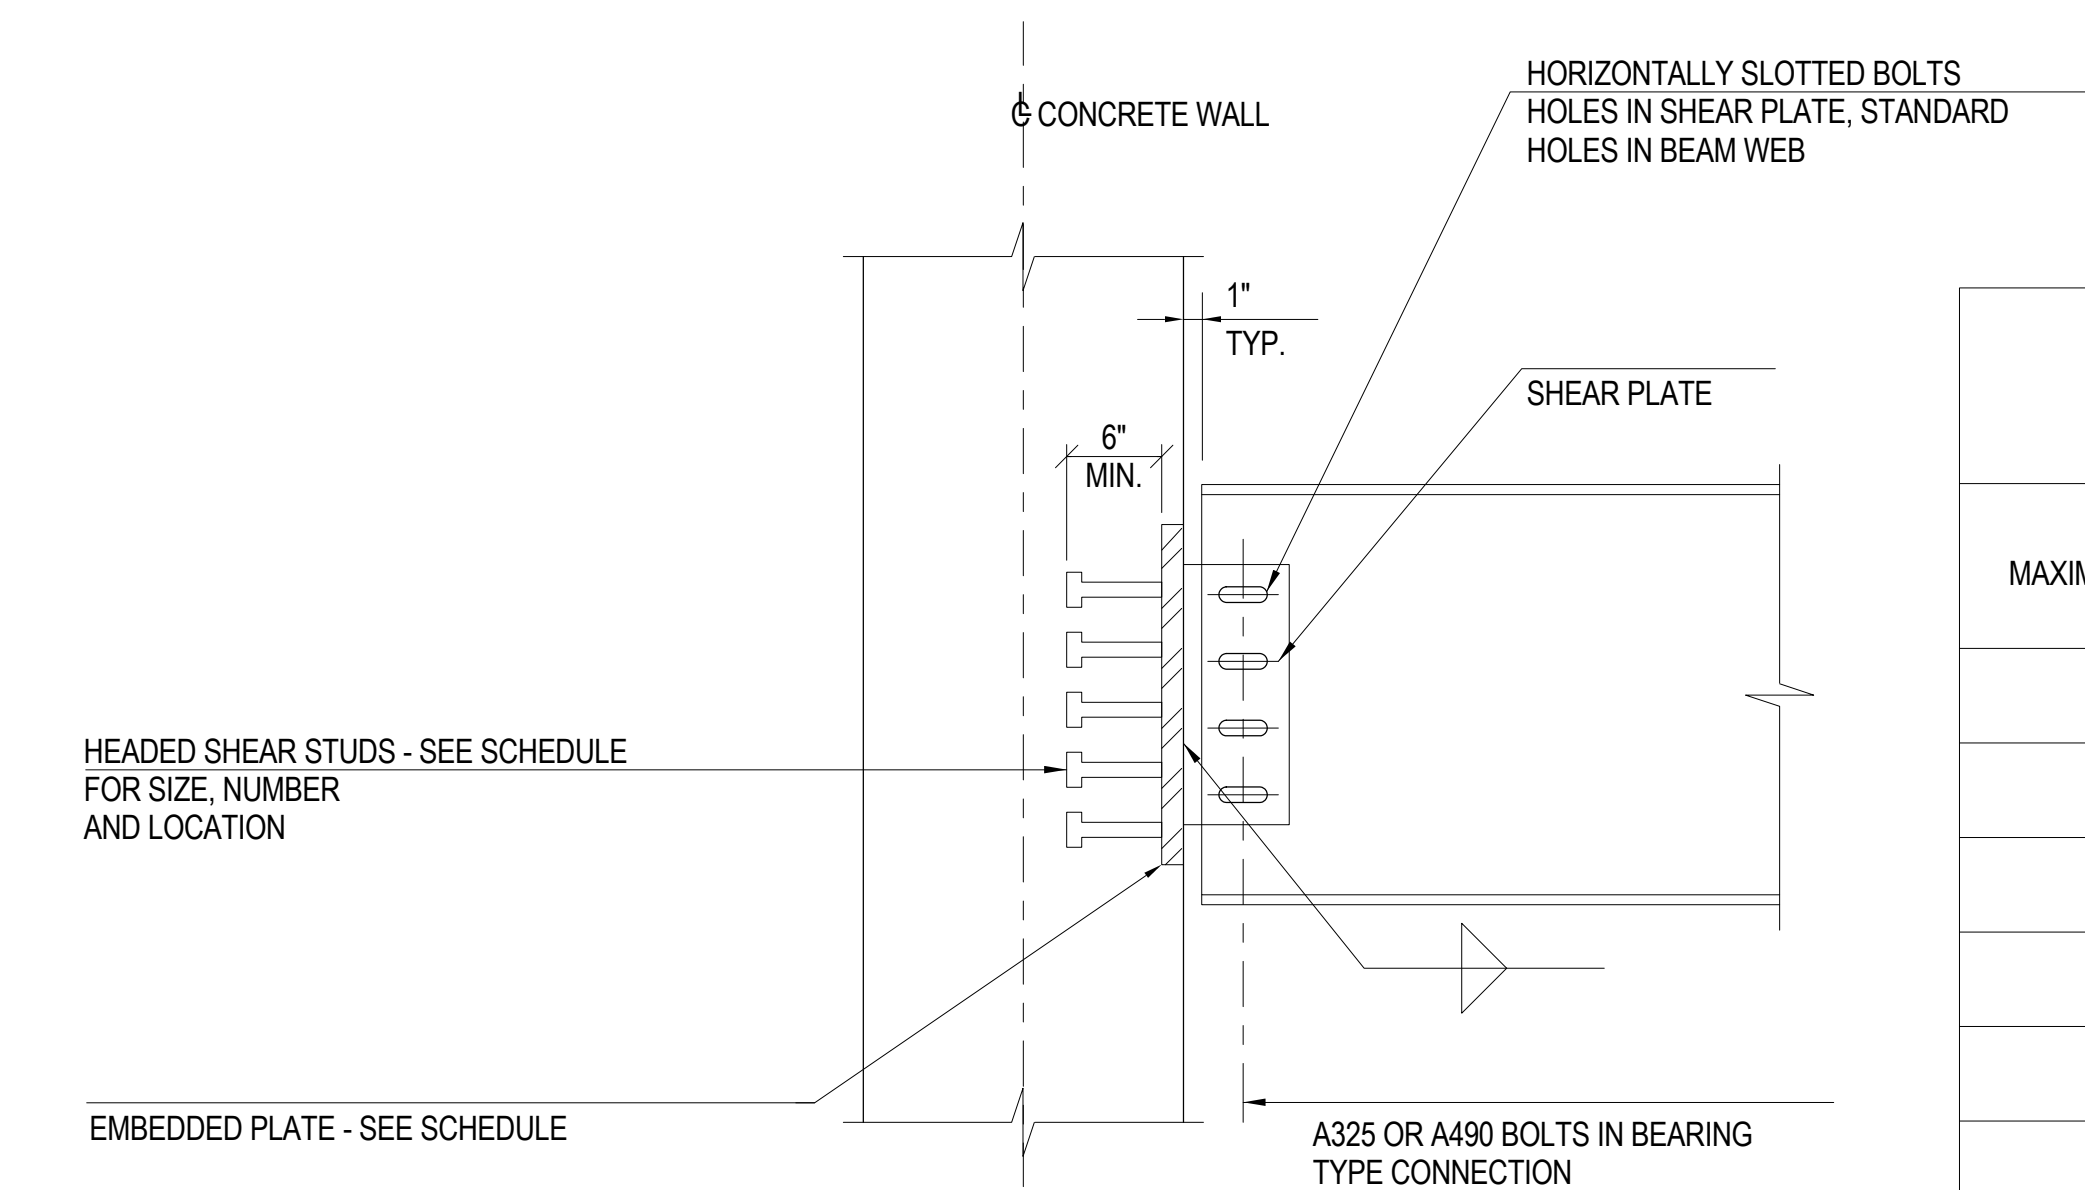


NOTE: WELDS, SHEAR PLATE AND BOLTS TO DEVELOP 100% OF SCHEDULED BEAM REACTION.

- NOTES:
1. BOLTS, WELDS AND ANGLES TO DEVELOP REACTIONS LISTED ON THE PLANS
 2. ALL SHEAR STUD CONNECTORS, ANGLES & WELDS SHALL MEET THE REQUIREMENTS OF THE AISC SPECIFICATION
 3. ALL SHEAR STUDS SHALL BE TYPE B ASTM A108
 4. ALL SHEAR STUD WELDS SHALL DEVELOP THE ULTIMATE STRENGTH OF THE STUD

EMBEDDED PLATE SCHEDULE					F _y PLATE = 50ksi F _y STUDS = 60 ksi
MAXIMUM BEAM SIZE	MAXIMUM CAPACITY (kips)	NUMBER OF SHEAR STUDS	EMBEDDED PLATE SIZE T _x W _x D	MIN SHEAR PLATE DEPTH (in)	PLATE TYPE
W12					
W14-W18					
W21-W24					
W27-W30					
W33-W36					

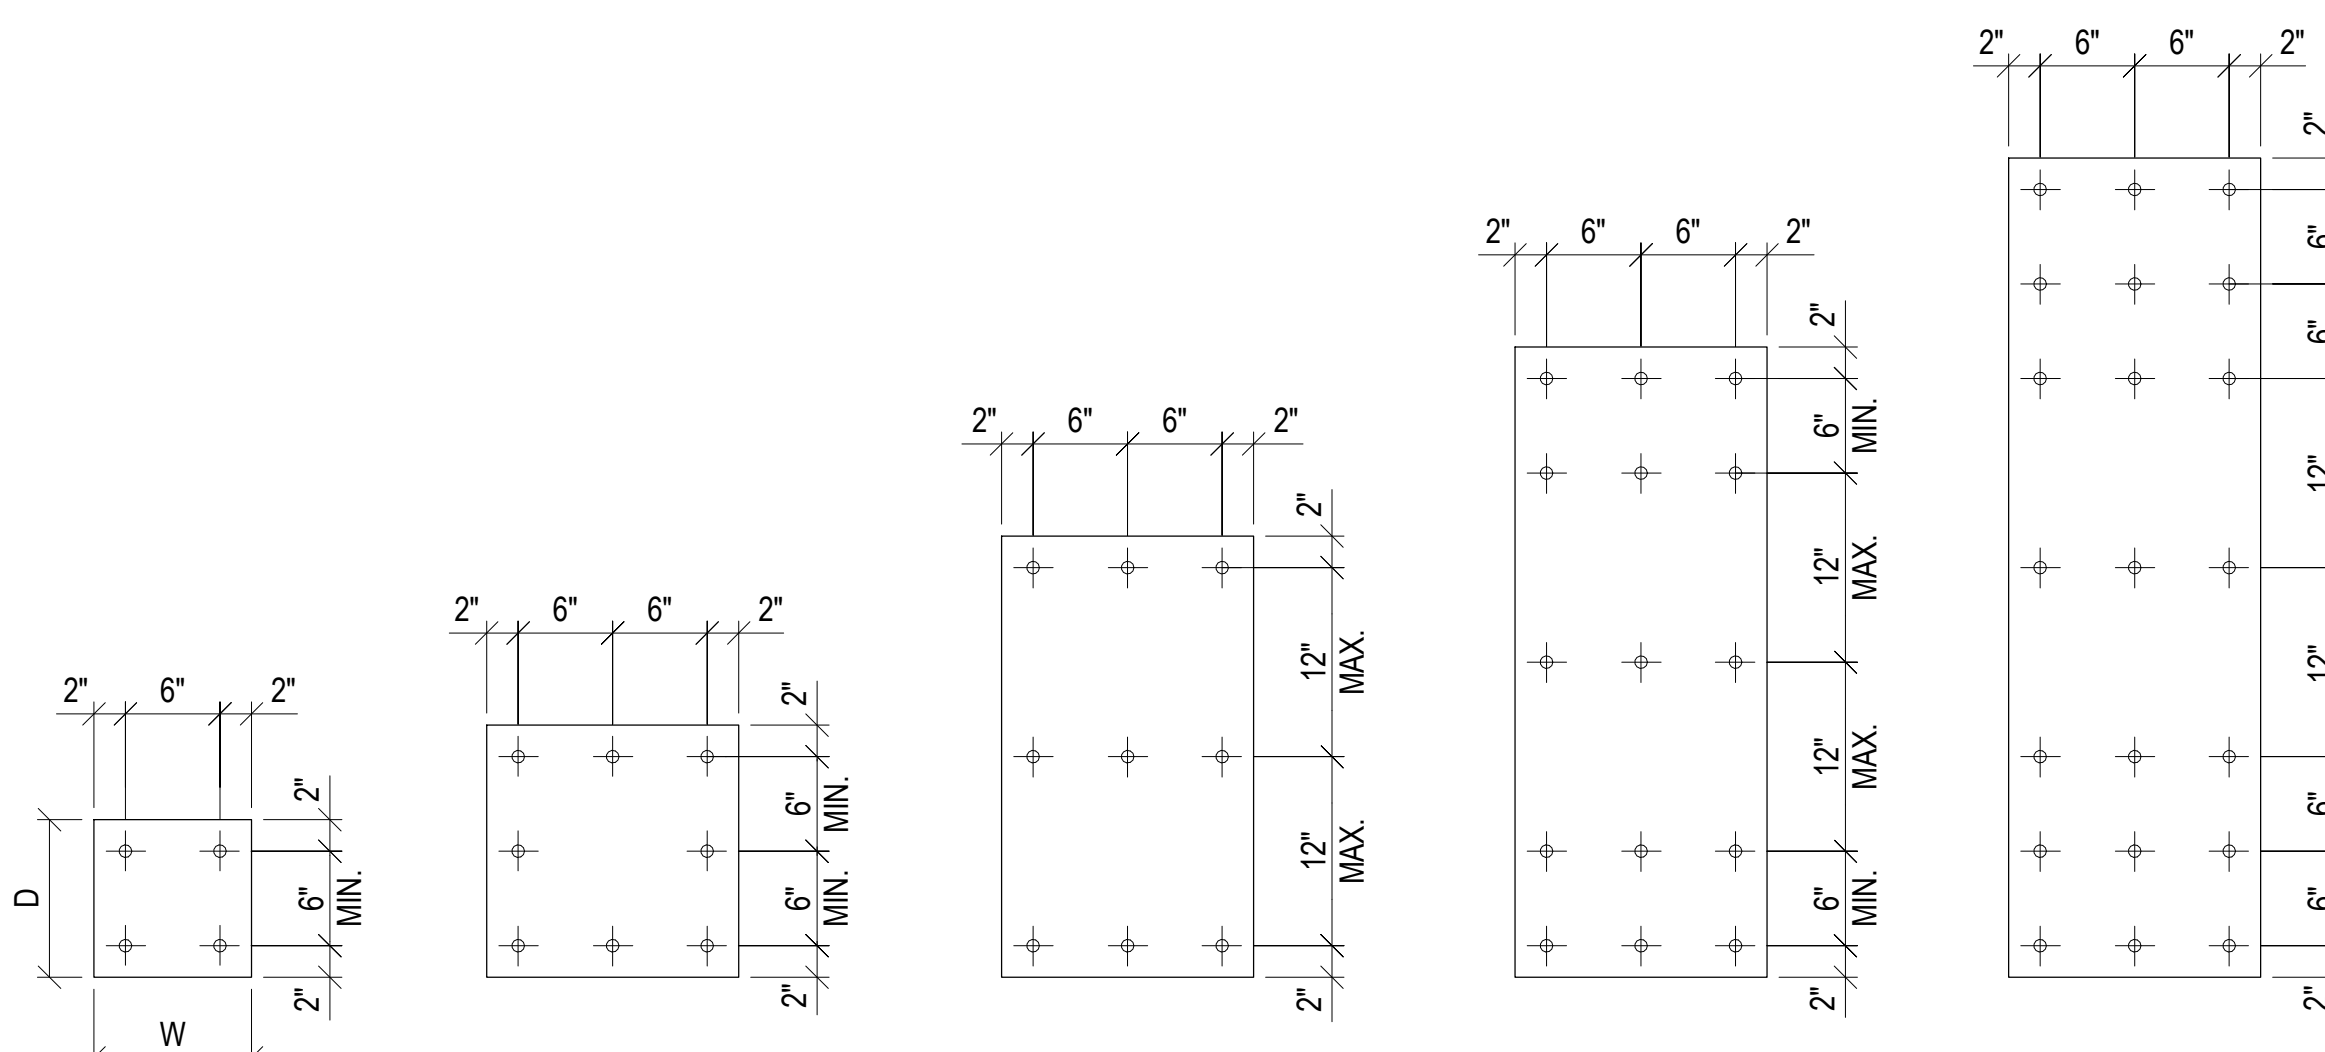

7 EMBEDDED PLATE DETAIL
NOT TO SCALE

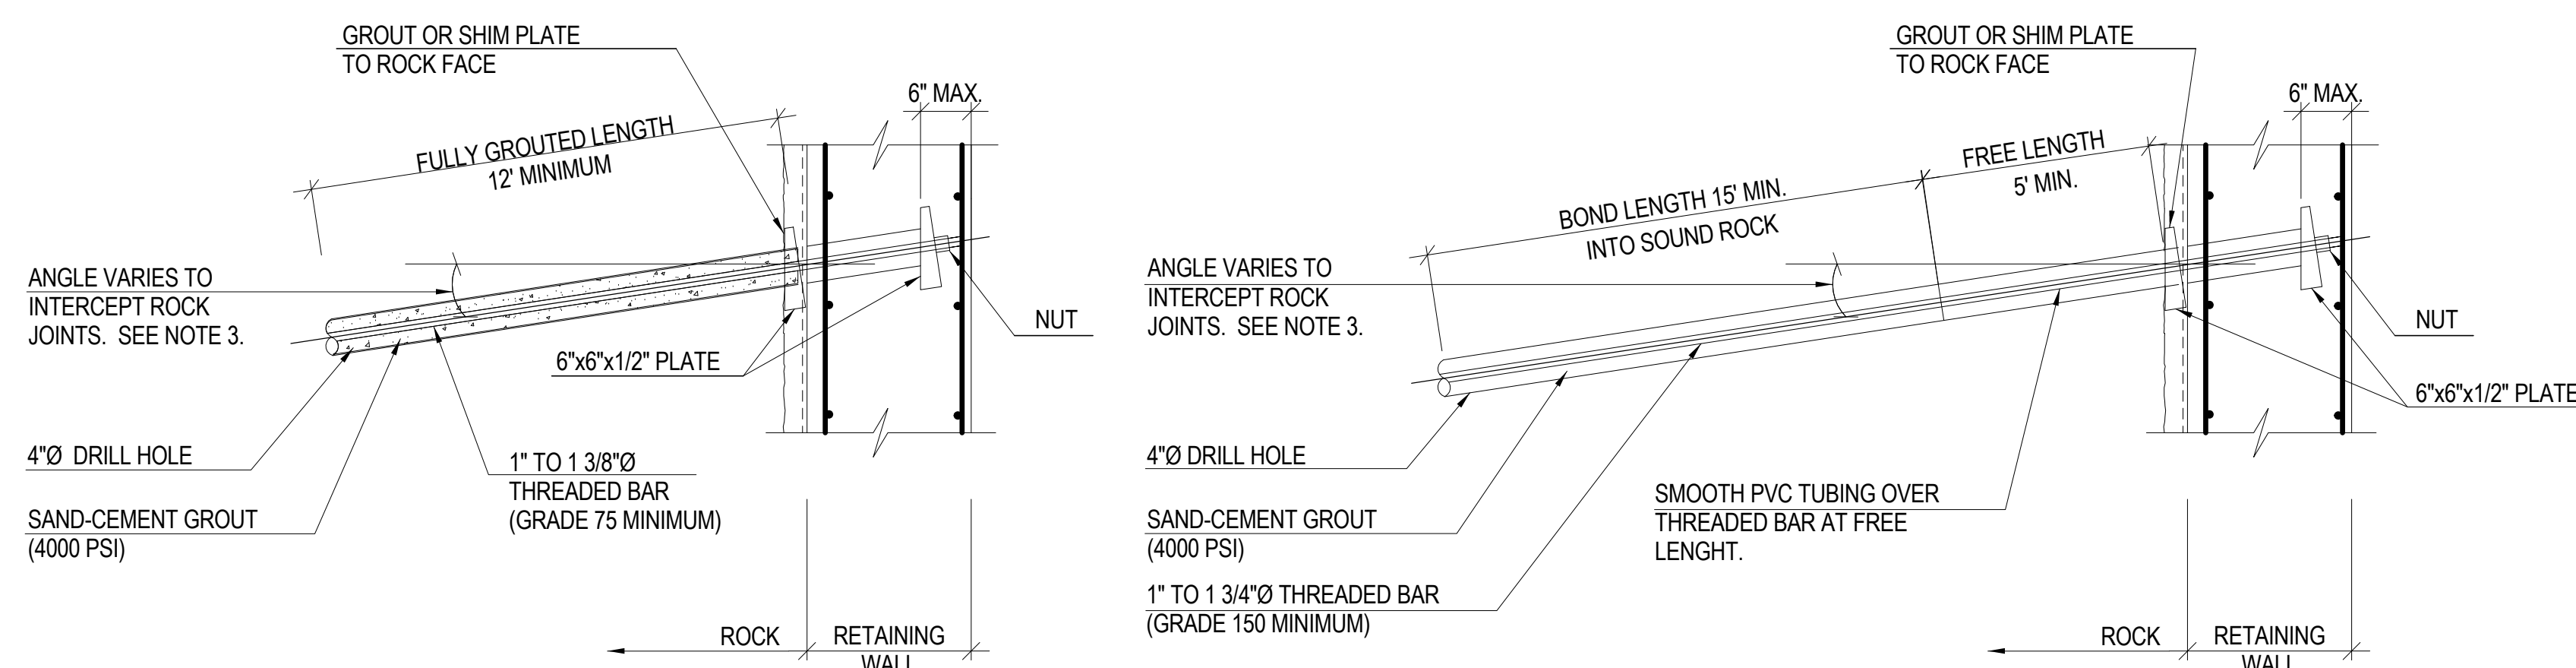

NON - TENSIONED ROCK ANCHORS

POST - TENSIONED ROCK ANCHORS

- NOTES:
1. DETAILS TO BE CONFIRMED WITH MUESER RUTLEDGE CONSULTING ENGINEERS (MRCE).
 2. ANCHORS CAN BE ALSO USED FOR TEMPORARY SUPPORT OF EXCAVATION.
 3. DURING EXCAVATION, THE BOLT CAPACITY, ANGLE AND LENGTH SHOULD BE VERIFIED BY FOUNDATION CONTRACTOR BASED ON THE JOINTING PATTERN OBSERVED. SUPPLEMENTAL BOLTS MAY BE REQUIRED IF UNFAVORABLE JOINTING PATTERNS ARE ENCOUNTERED AND WHEN EXISTING BUILDING LOADS ARE SUPERIMPOSED.
 4. ROCK BOLT TO BE ANGLED DOWNWARD A MINIMUM OF 5° FROM HORIZONTAL. BOLTS WITHIN 5' OF THE TOP OF BEDROCK SHALL BE ANGLED DOWNWARD A MINIMUM OF 30° FROM HORIZONTAL TO ENGAGE AN ADEQUATE BLOCK OF BEDROCK. BOLT ANGLE WILL VARY DEPENDING ON THE DIP AND DIRECTION OF THE ROCK JOINTS.
 5. ALL BOLTS SHOULD BE GALVANIZED FOR CORROSION PROTECTION.
 6. ANCHOR NUTS AND COUPLERS SHALL BE CAPABLE OF DEVELOPING 100% OF THE ULTIMATE STRENGTH OF THREADED BAR.
 7. POST-TENSIONED ANCHORS SHALL BE IN CONFORMANCE WITH PTI (POST TENSIONING INSTITUTE) LATEST RECOMMENDATIONS ON ROCK AND SOIL ANCHORS.
 8. POST-TENSIONED ANCHOR LOCK-OFF LOAD SHOULD NOT EXCEED 70% OF THE GUARANTEED ULTIMATE STRENGTH OF THE THREADED BAR.

8 TYPICAL PERMANENT ROCK ANCHOR DETAIL
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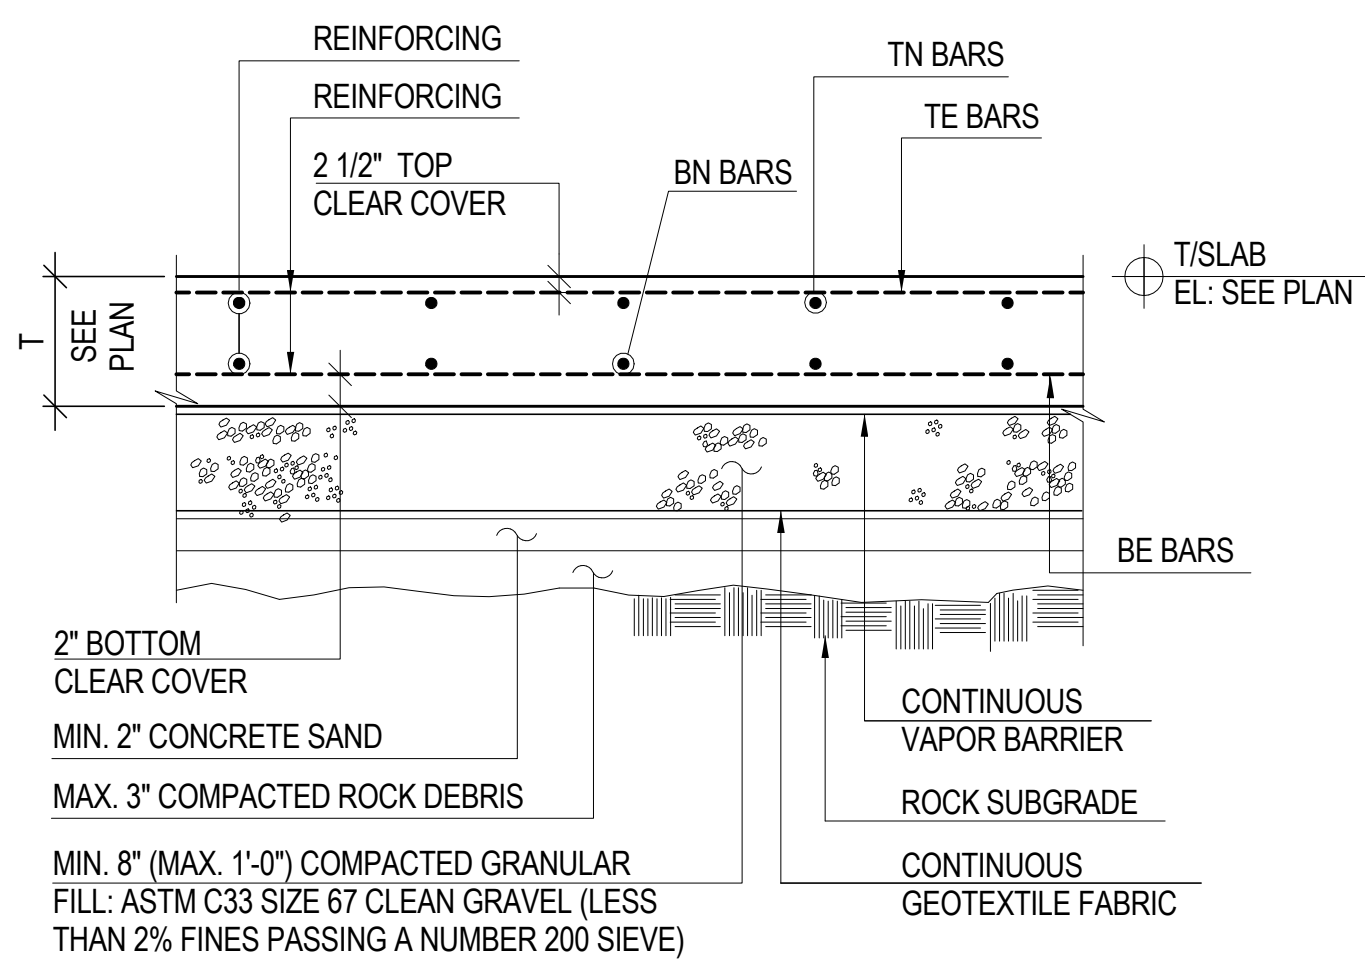
Key Plan:

Seal & Signature:

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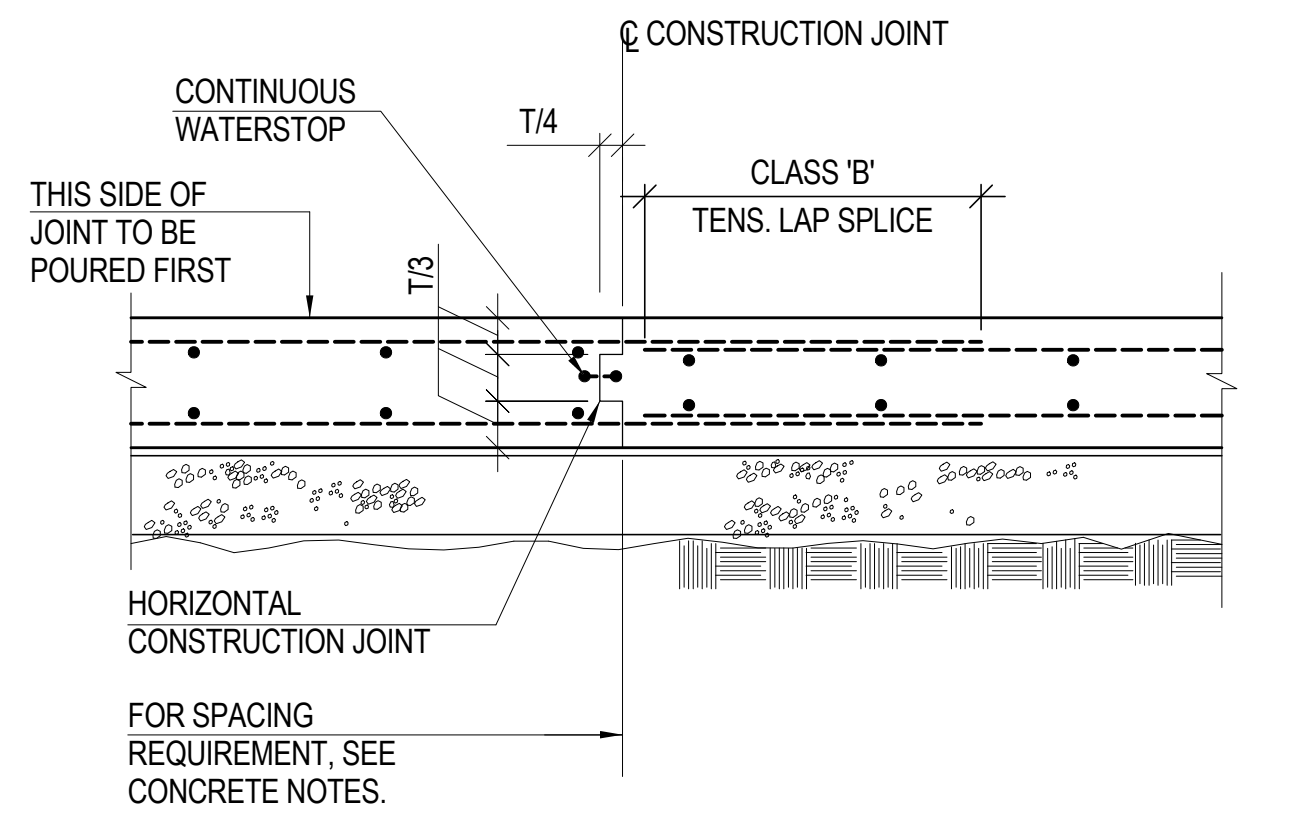
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B-SCAN Sheet No.: S-318.00
Date: 20 JUN 2014
Scale: As indicated
File No.: S-318
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NOTE: REFER TO THE DRAWING U-001 FOR DETAILS OF THE UNDERDRAIN SYSTEM.

1 TYPICAL SLAB-ON-GRADE DETAIL - REBAR


NOT TO SCALE



NOTES: 1. REFER TO DETAIL 1 FOR ADDITIONAL INFORMATION NOT INDICATED.
2. REFER TO THE DRAWING U-001 FOR DETAILS OF THE UNDERDRAIN SYSTEM.

2 TYPICAL SLAB-ON-GRADE CONSTRUCTION JOINT - REBAR


NOT TO SCALE

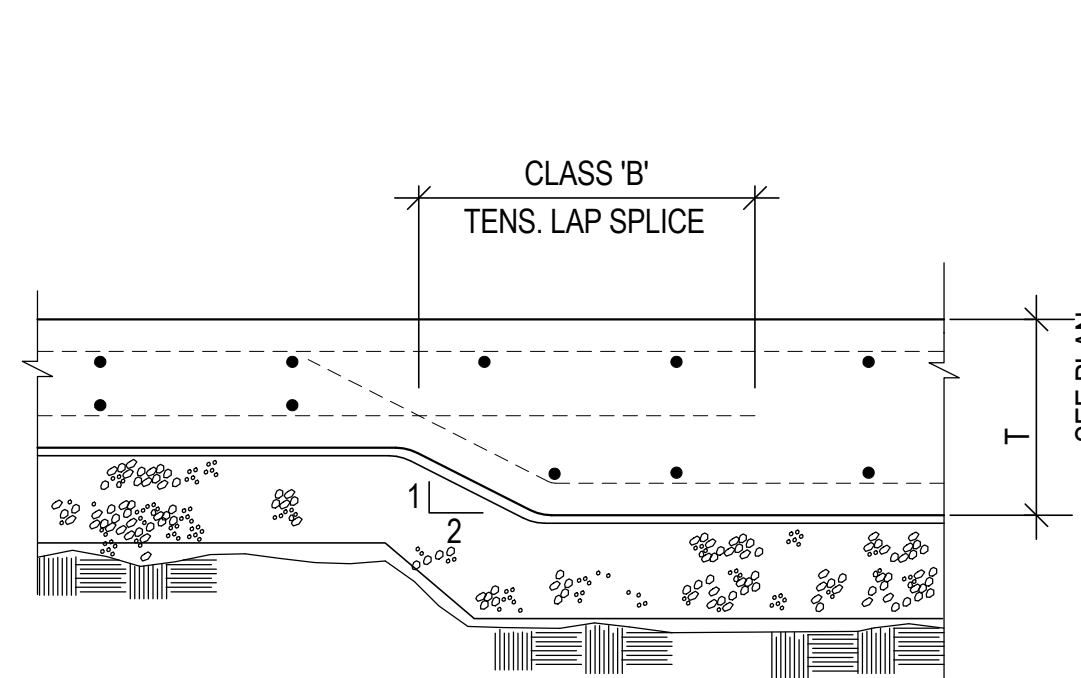

NOTES: 1. REFER TO DETAIL 1 FOR ADDITIONAL INFORMATION NOT INDICATED.
2. REFER TO THE DRAWING U-001 FOR DETAILS OF THE UNDERDRAIN SYSTEM.

3 TYPICAL SLAB-ON-GRADE CHANGE IN THICKNESS - REBAR


NOT TO SCALE

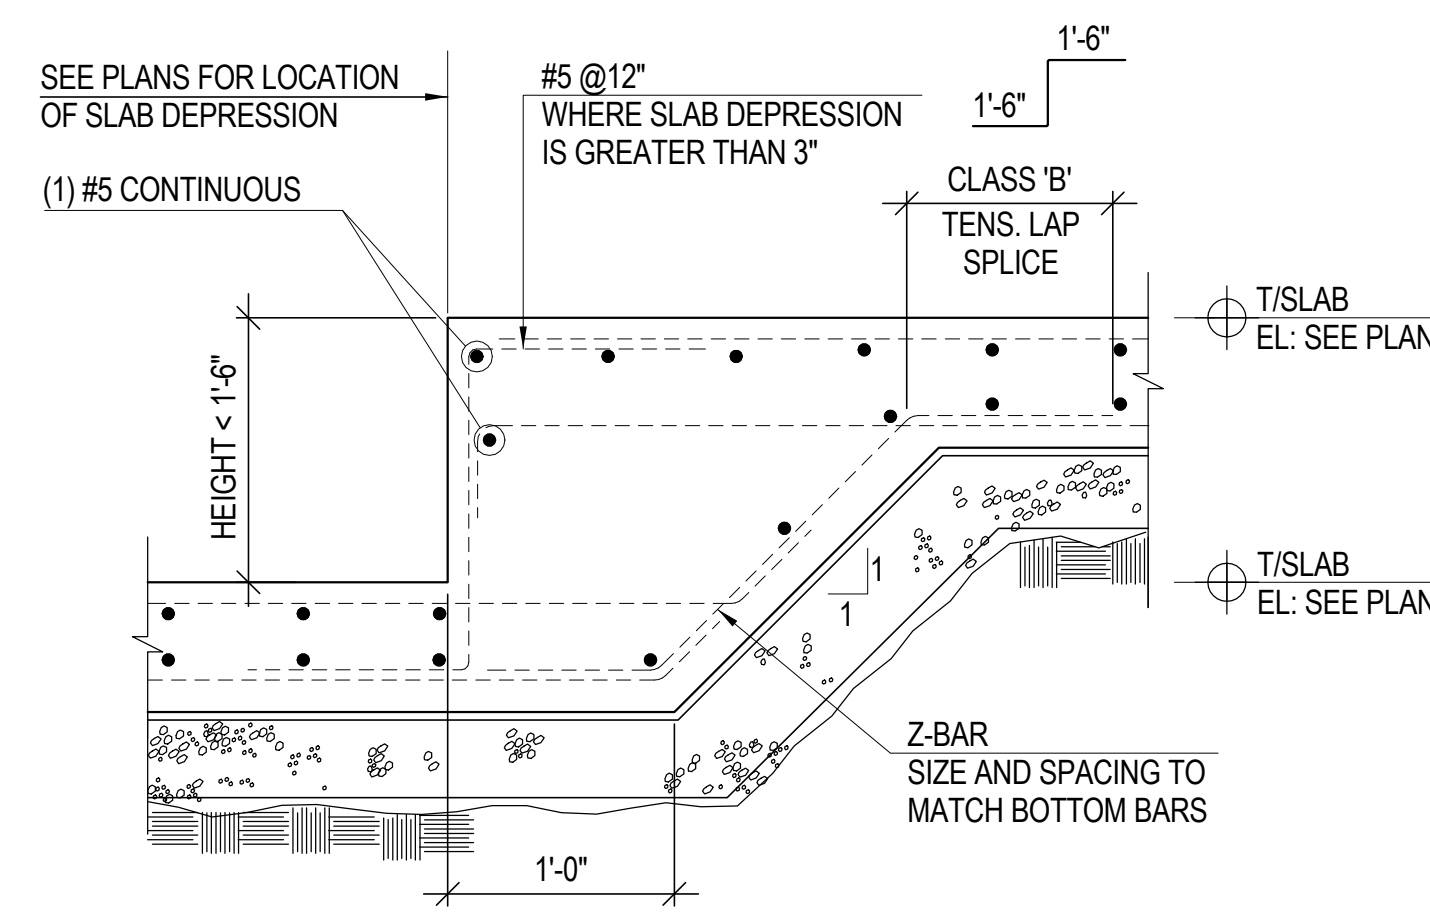

NOTES: 1. REFER TO DETAIL 1 FOR ADDITIONAL INFORMATION NOT INDICATED.
2. REFER TO THE DRAWING U-001 FOR DETAILS OF THE UNDERDRAIN SYSTEM.

4 TYPICAL SLAB-ON-GRADE DEPRESSION (HEIGHT LESS THAN 1'-6")-REBAR


NOT TO SCALE

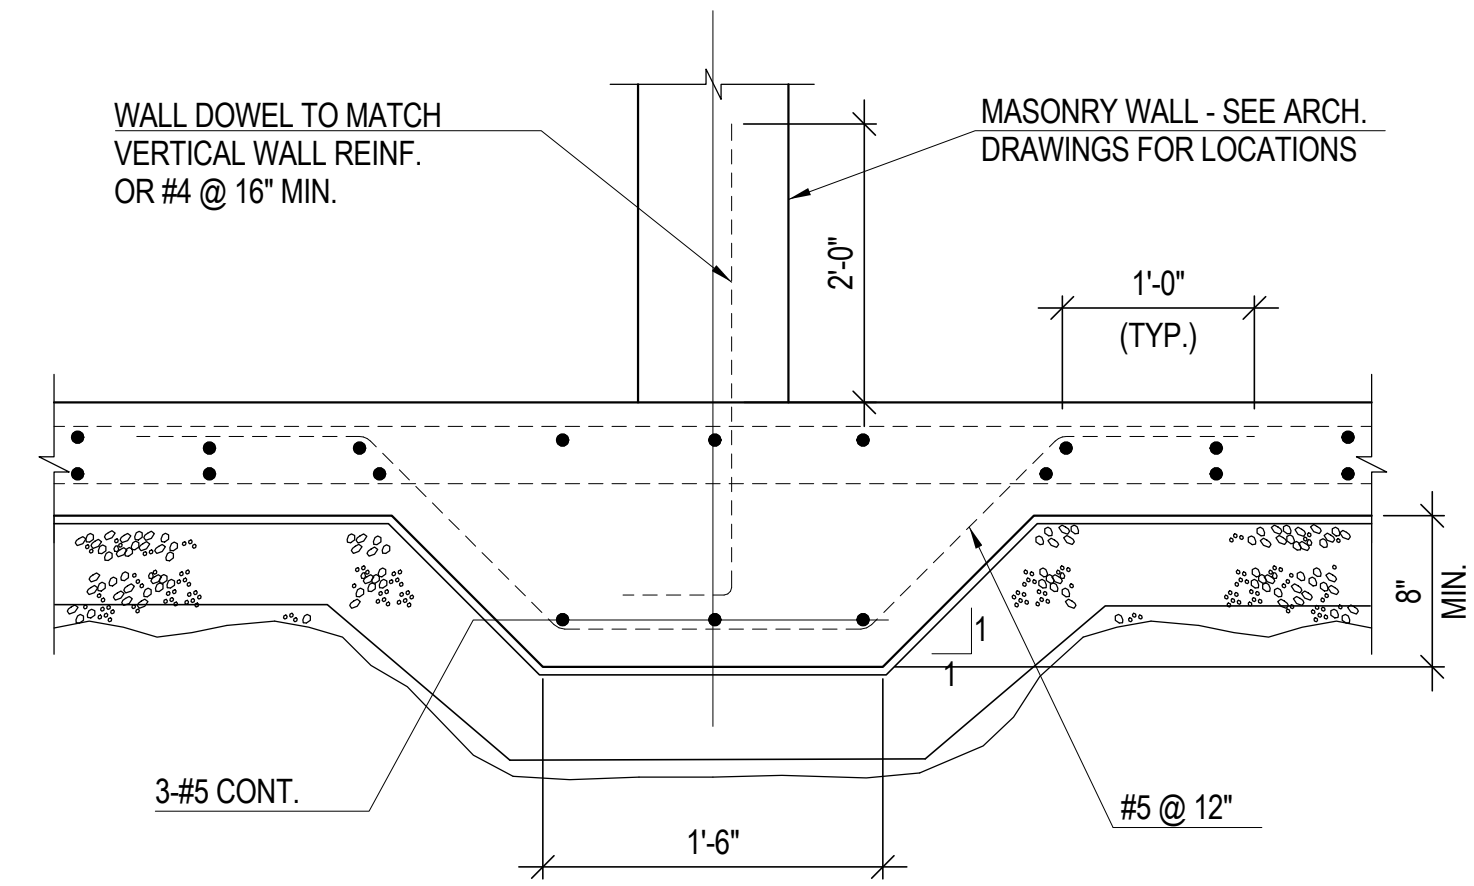

NOTES: 1. REFER TO DETAIL 1 FOR ADDITIONAL INFORMATION NOT INDICATED.
2. REFER TO THE DRAWING U-001 FOR DETAILS OF THE UNDERDRAIN SYSTEM.

5 TYPICAL SLAB-ON-GRADE AT MASONRY WALL - REBAR


NOT TO SCALE

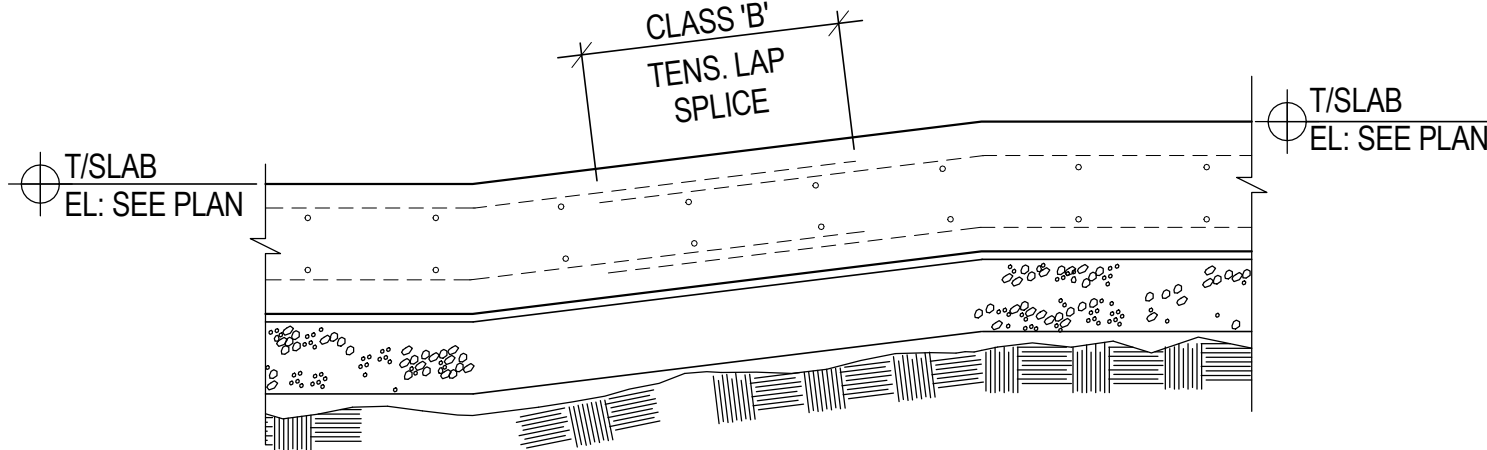

NOTES: 1. REFER TO DETAIL 1 FOR ADDITIONAL INFORMATION NOT INDICATED.
2. REFER TO THE DRAWING U-001 FOR DETAILS OF THE UNDERDRAIN SYSTEM.

6 TYPICAL SLAB-ON-GRADE RAMP DETAIL - REBAR


NOT TO SCALE

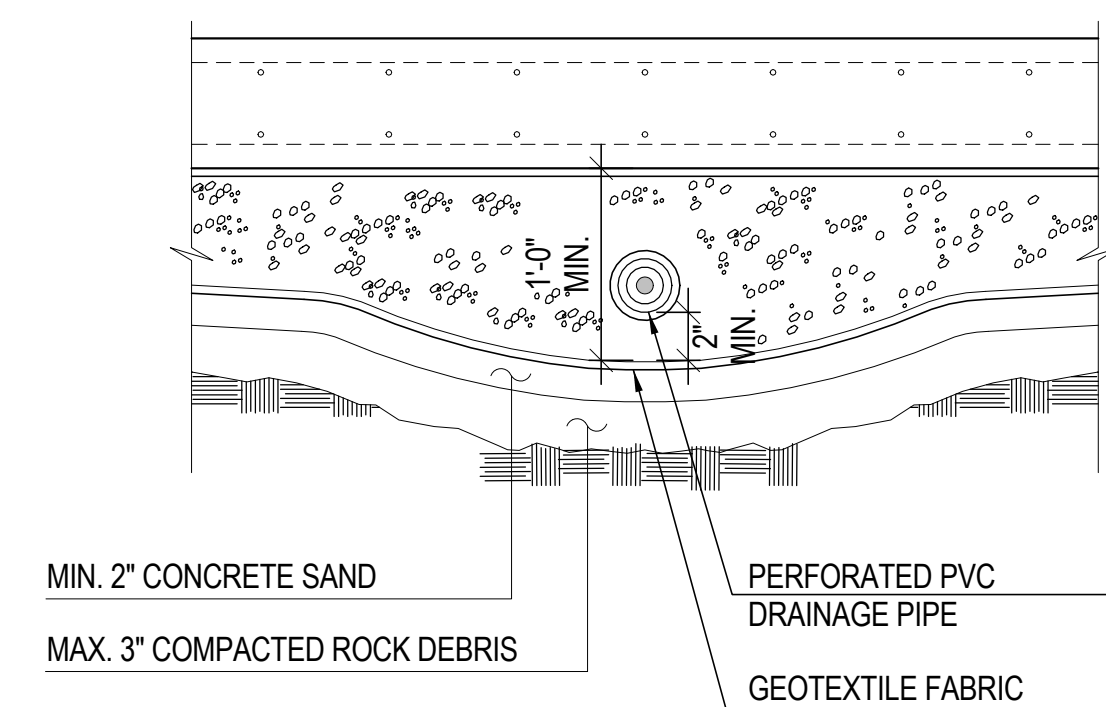

NOTES: 1. REFER TO DETAIL 1 FOR ADDITIONAL INFORMATION NOT INDICATED.
2. REFER TO PLUMBING DRAWINGS FOR LOCATIONS OF UNDER DRAIN CONNECTIONS TO SUMP PUMPS.
3. REFER TO THE DRAWING U-001 FOR DETAILS OF THE UNDERDRAIN SYSTEM.

7 TYPICAL SLAB-ON-GRADE UNDERDRAIN DETAIL - REBAR


NOT TO SCALE

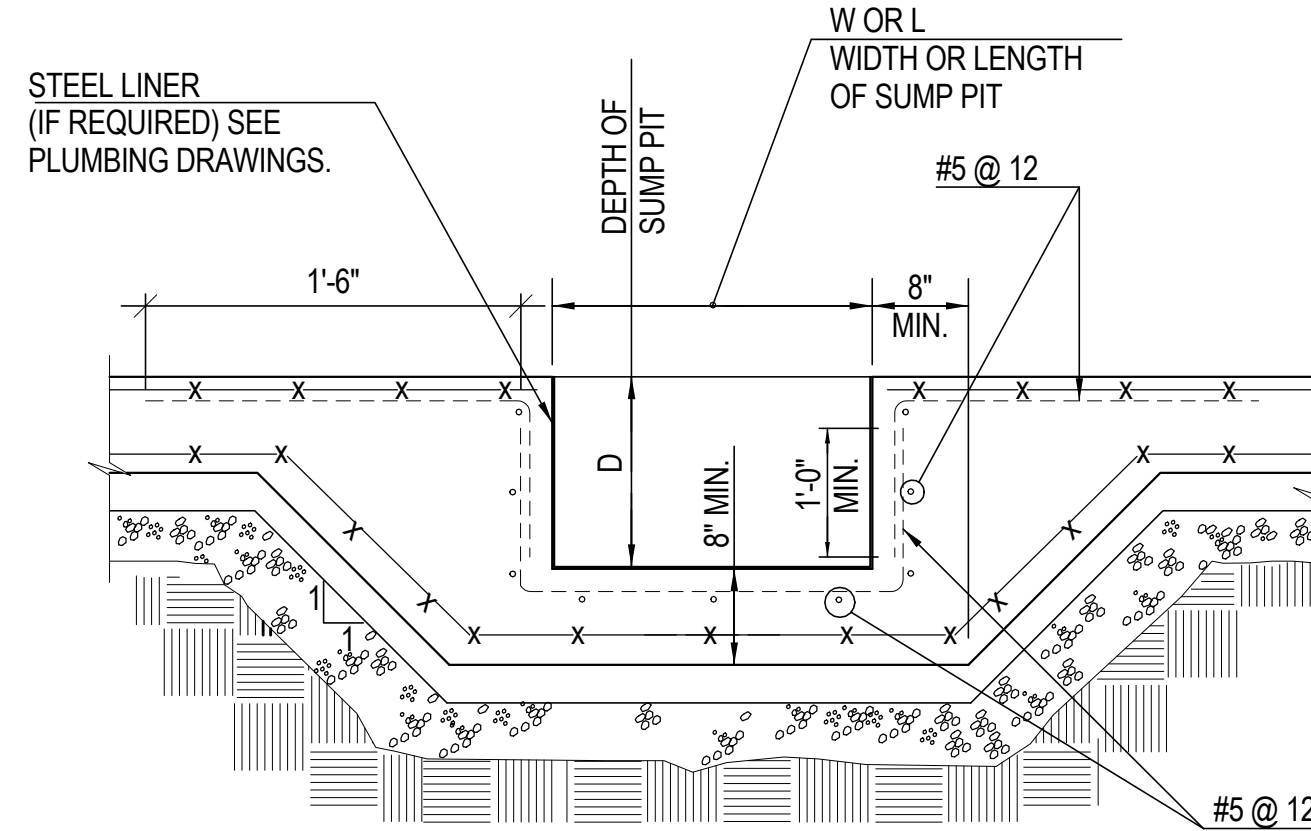

NOTES: 1. REFER TO DETAIL 2 FOR ADDITIONAL INFORMATION NOT INDICATED.
2. SEE ARCHITECTURAL DRAWINGS FOR SIZE AND LOCATION.
3. REFER TO THE DRAWING U-001 FOR DETAILS OF THE UNDERDRAIN SYSTEM.

8 TYPICAL SLAB-ON-GRADE TRENCH DETAIL - WWF

NOT TO SCALE

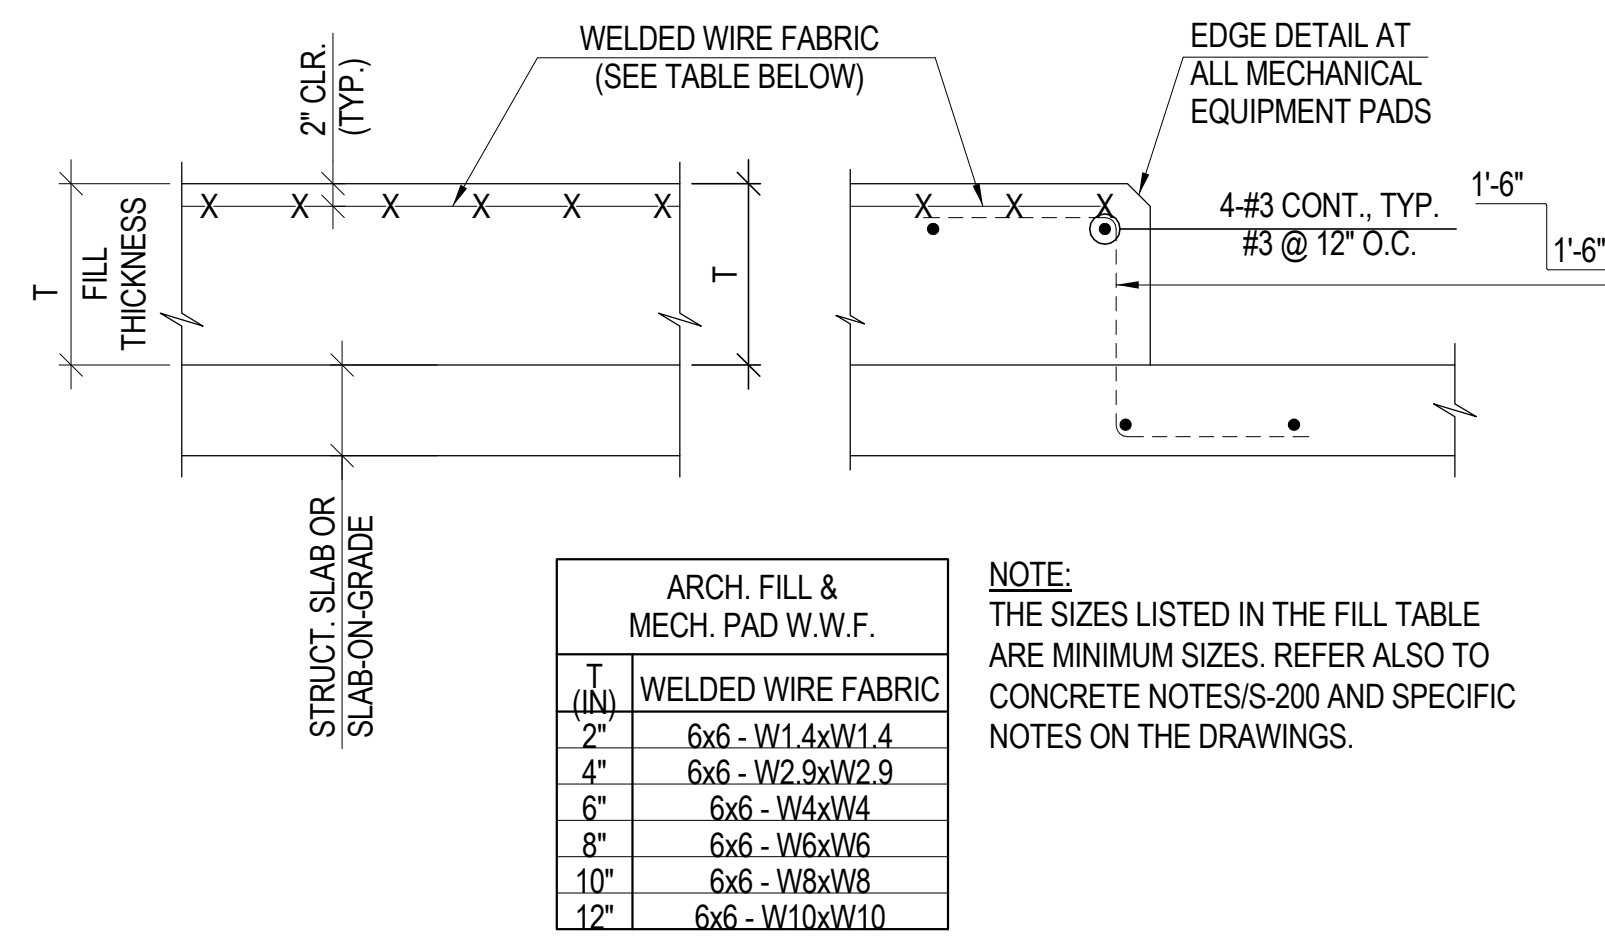


NOTE: THE SIZES LISTED IN THE FILL TABLE ARE MINIMUM SIZES. REFER ALSO TO CONCRETE NOTES S-200 AND SPECIFIC NOTES ON THE DRAWINGS.

NOTE: 1. SEE ARCH., MECH., ELEC., AND PLUMBING DRAWINGS FOR PAD SIZES AND LOCATIONS.

9 TYPICAL CONCRETE PAD/ ARCH. FILL DETAIL - WWF


1" = 1'-0"

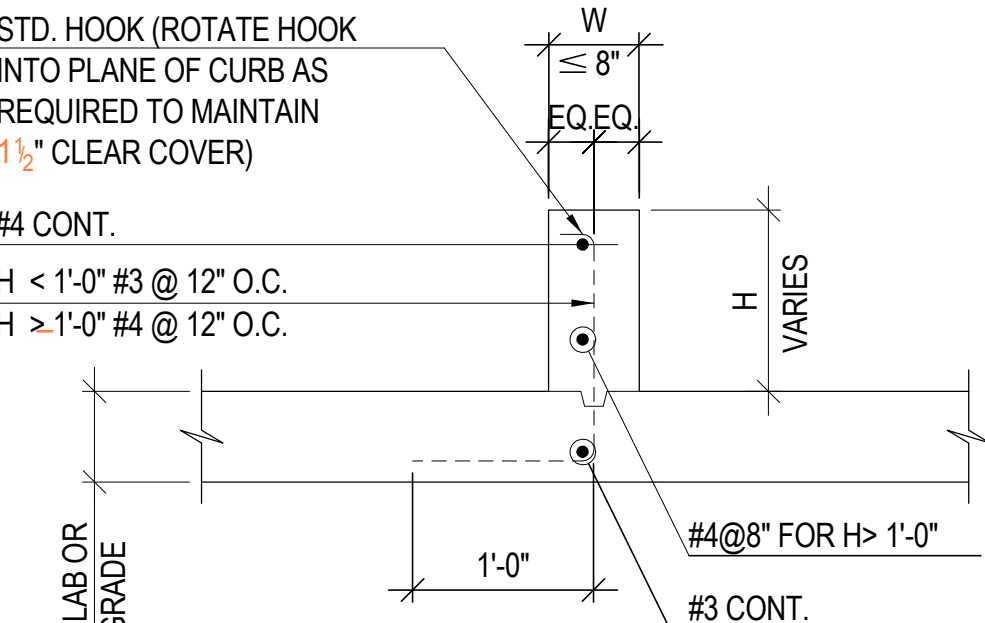


NOTE: 1. SEE ARCH., MECH., ELEC., AND PLUMBING DRAWINGS FOR CURB SIZE AND LOCATION.

10 TYPICAL CURB DETAILS - WWF

1" = 1'-0"

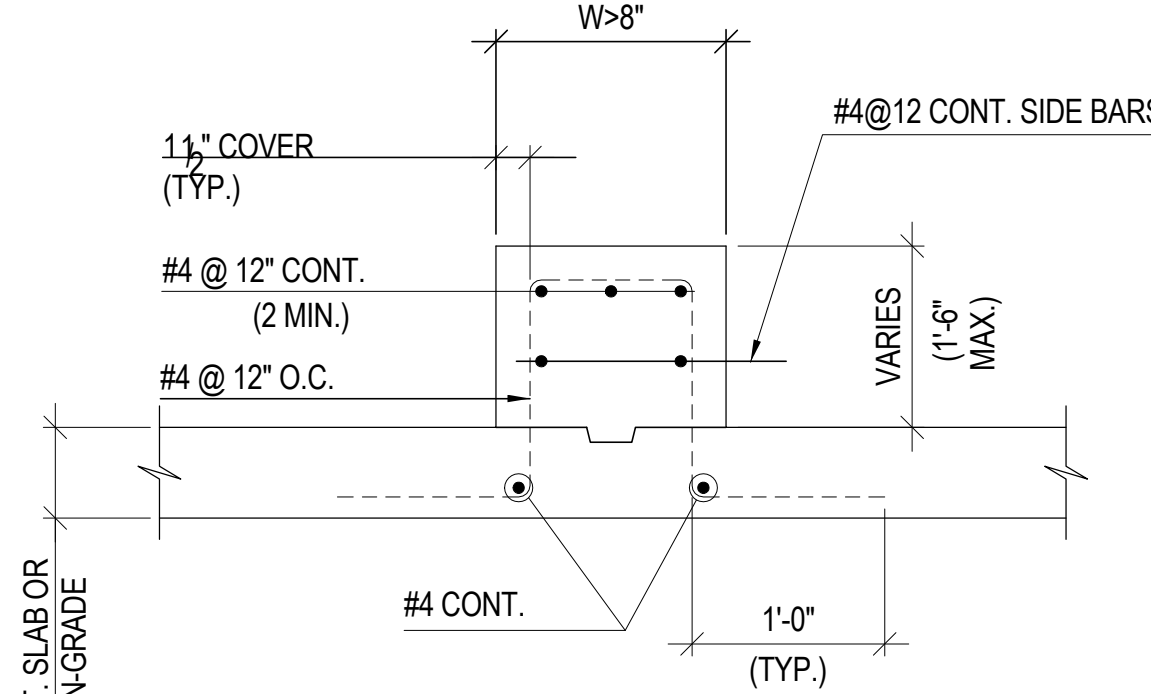

18A SECTION

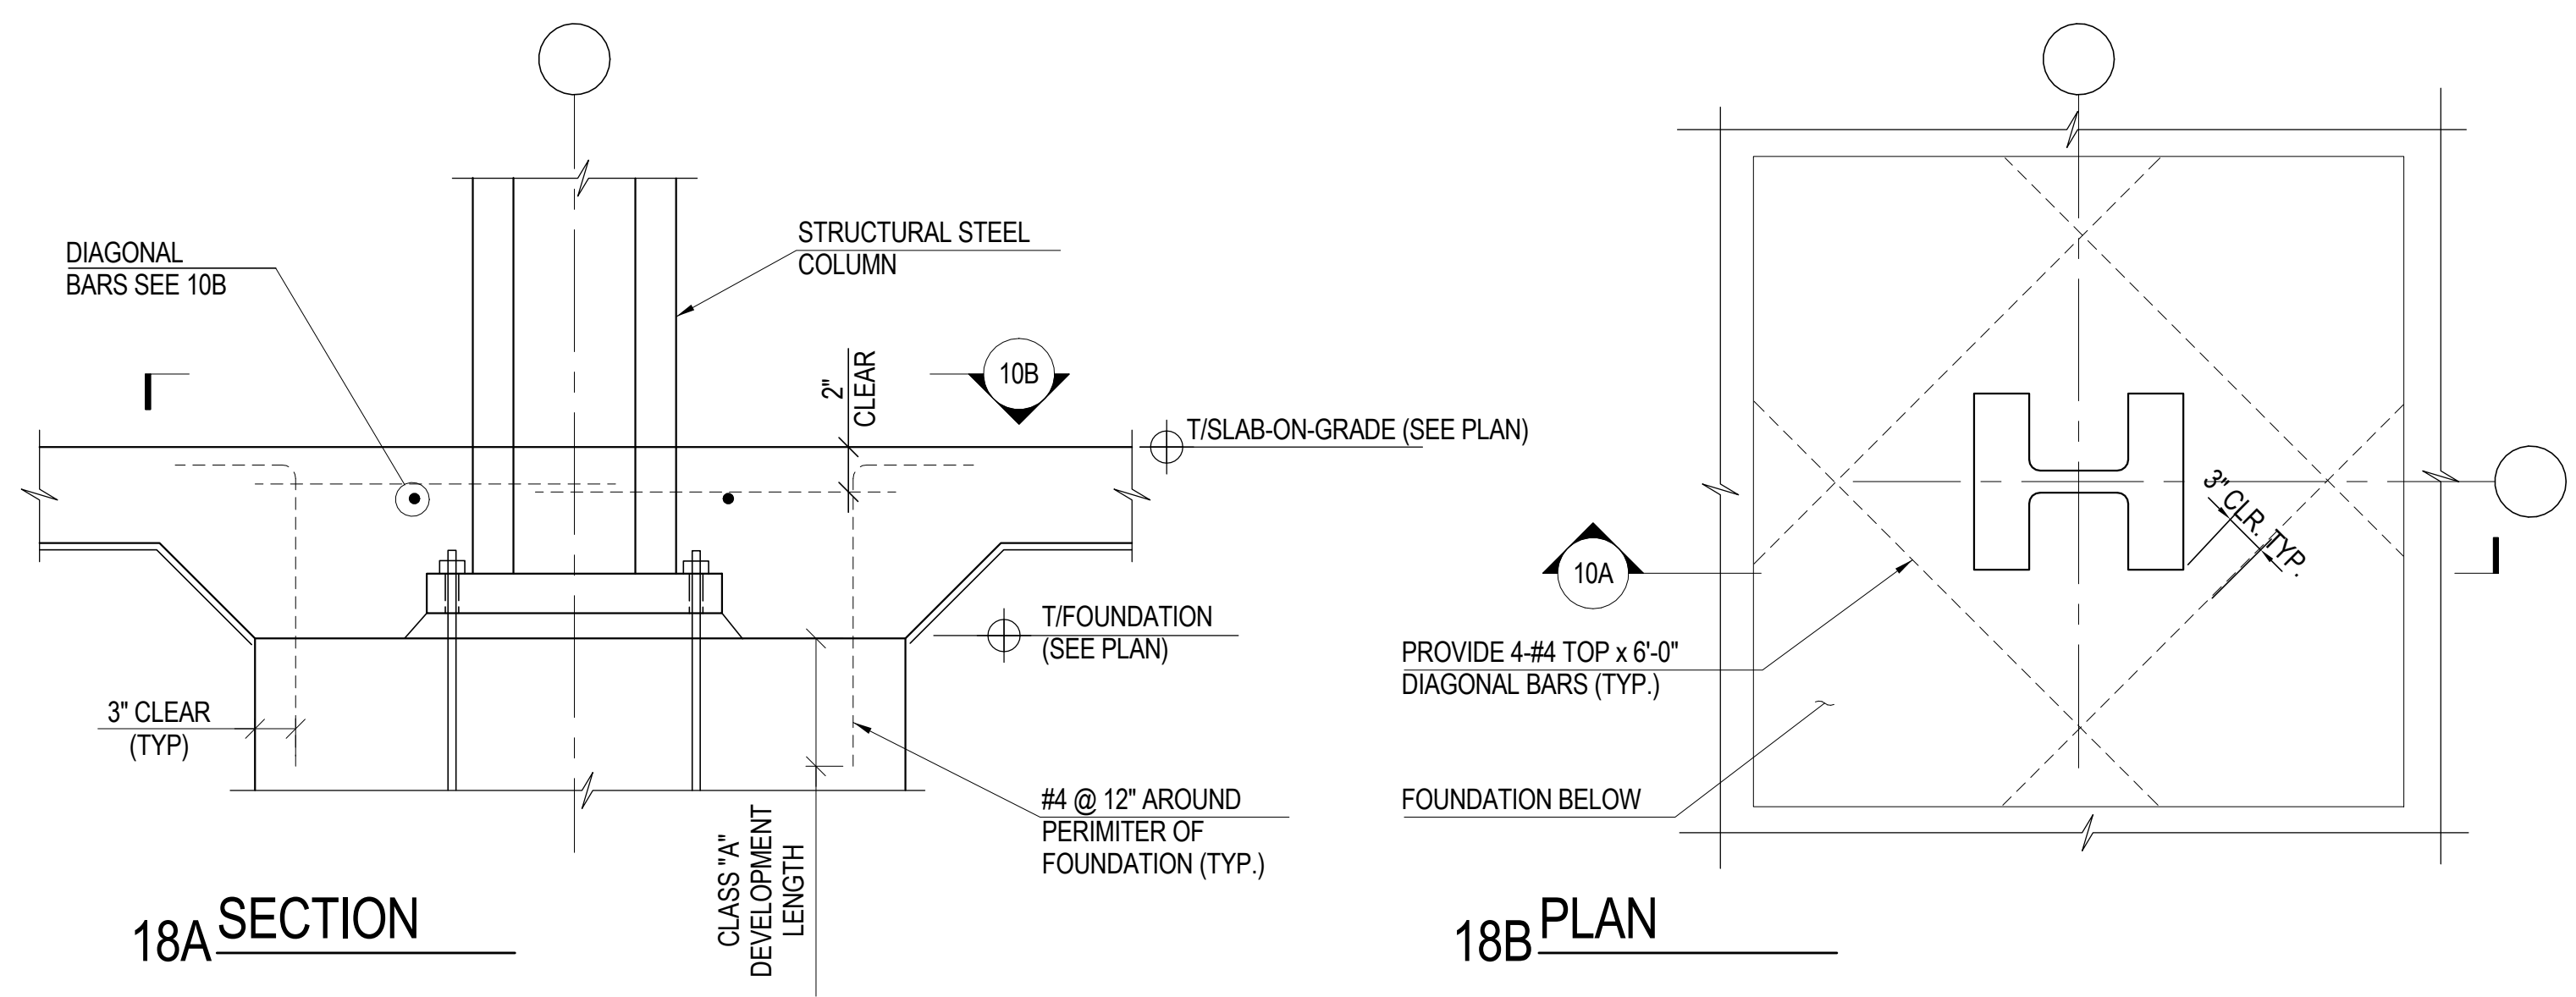

18B PLAN

11 TYPICAL ADDITIONAL SLAB REINFORCEMENT AT COLUMN

1" = 1'-0"



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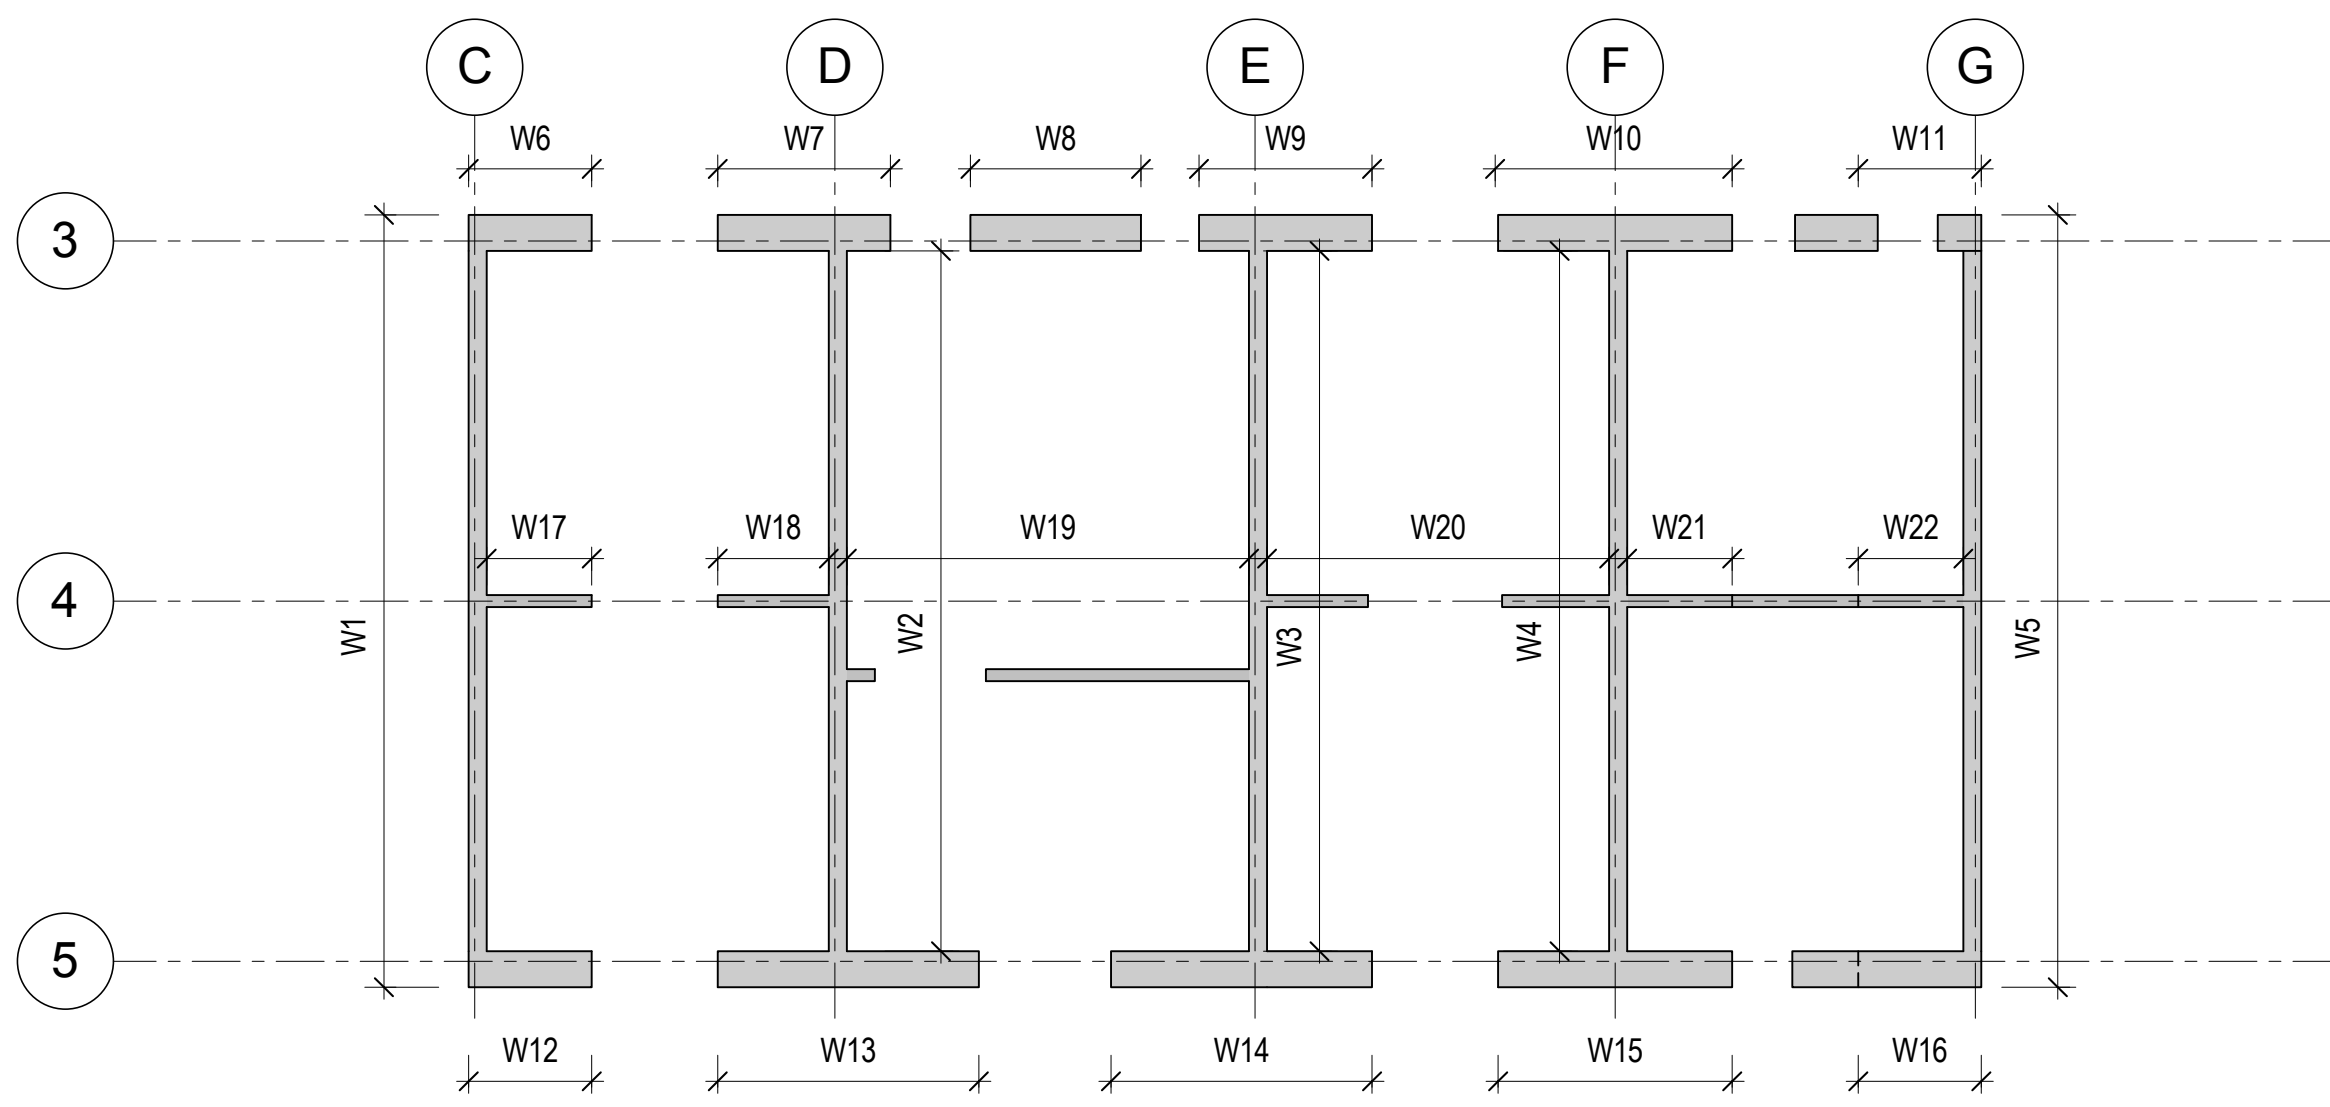
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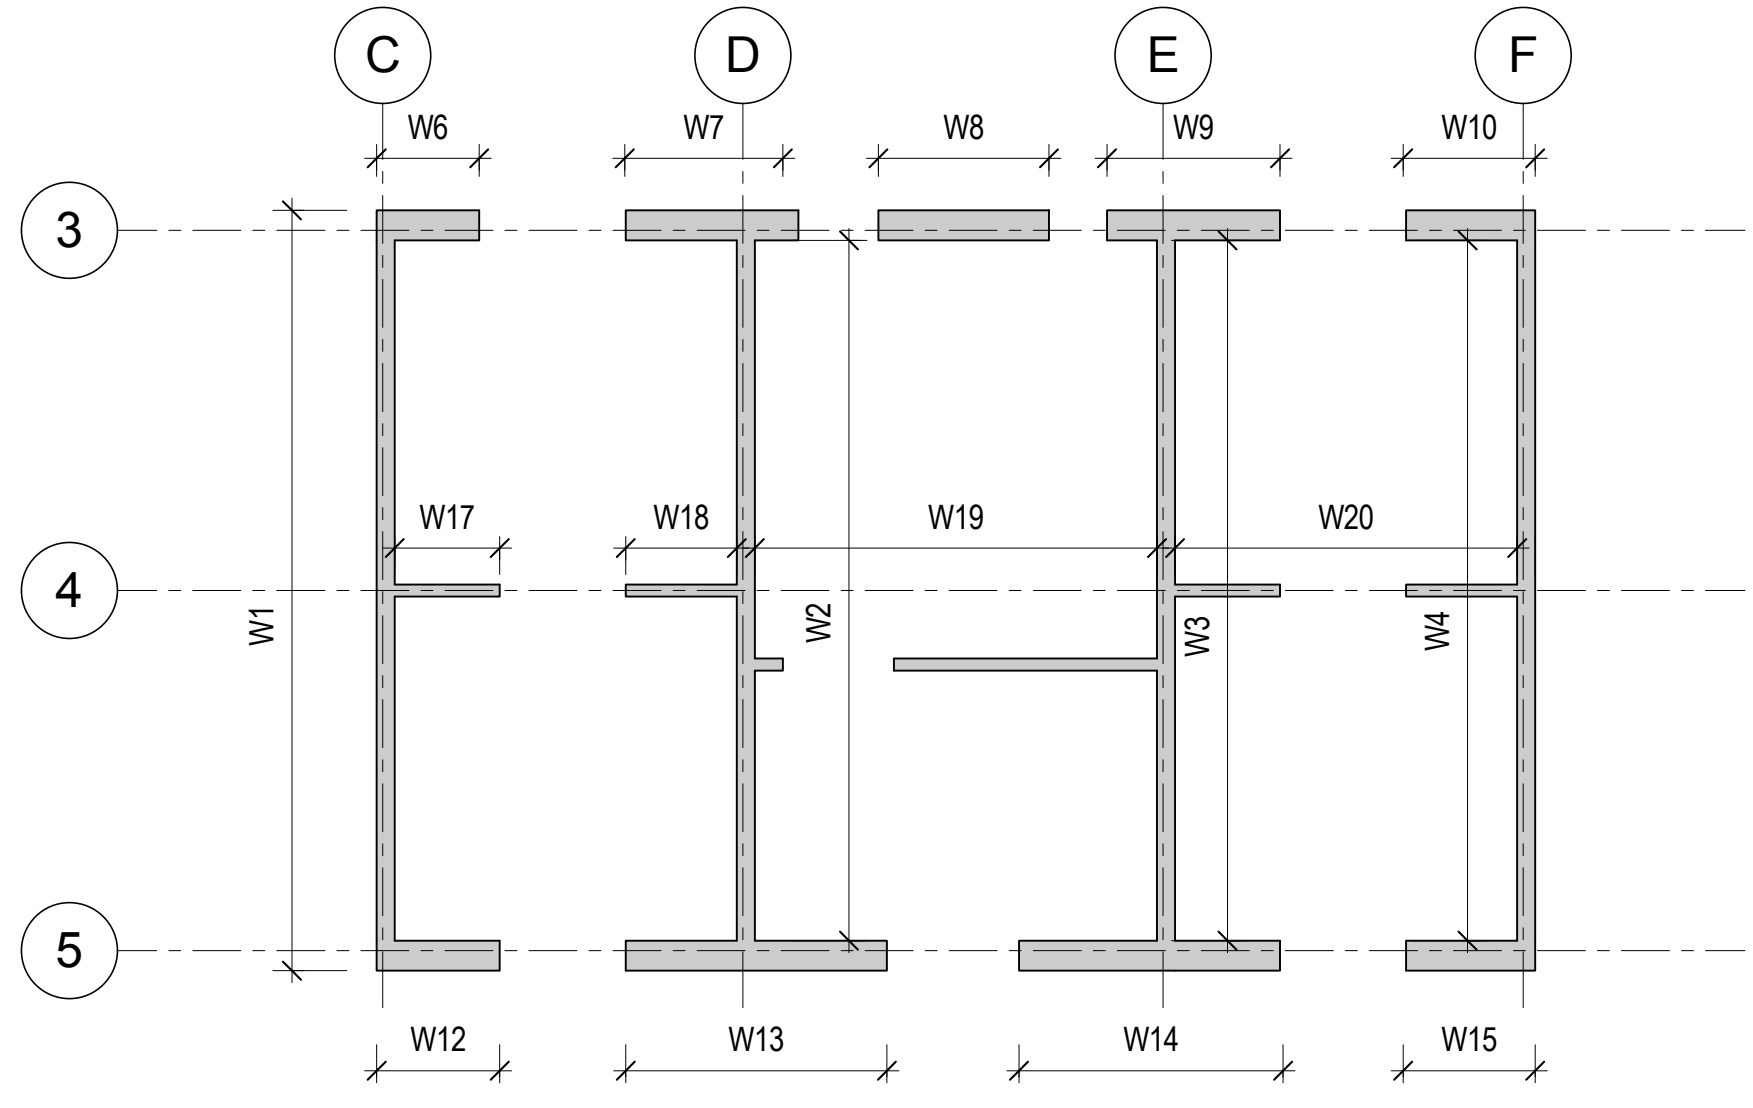
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Project No.: 211157
Date: 20 JUN 2014
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S-325.00
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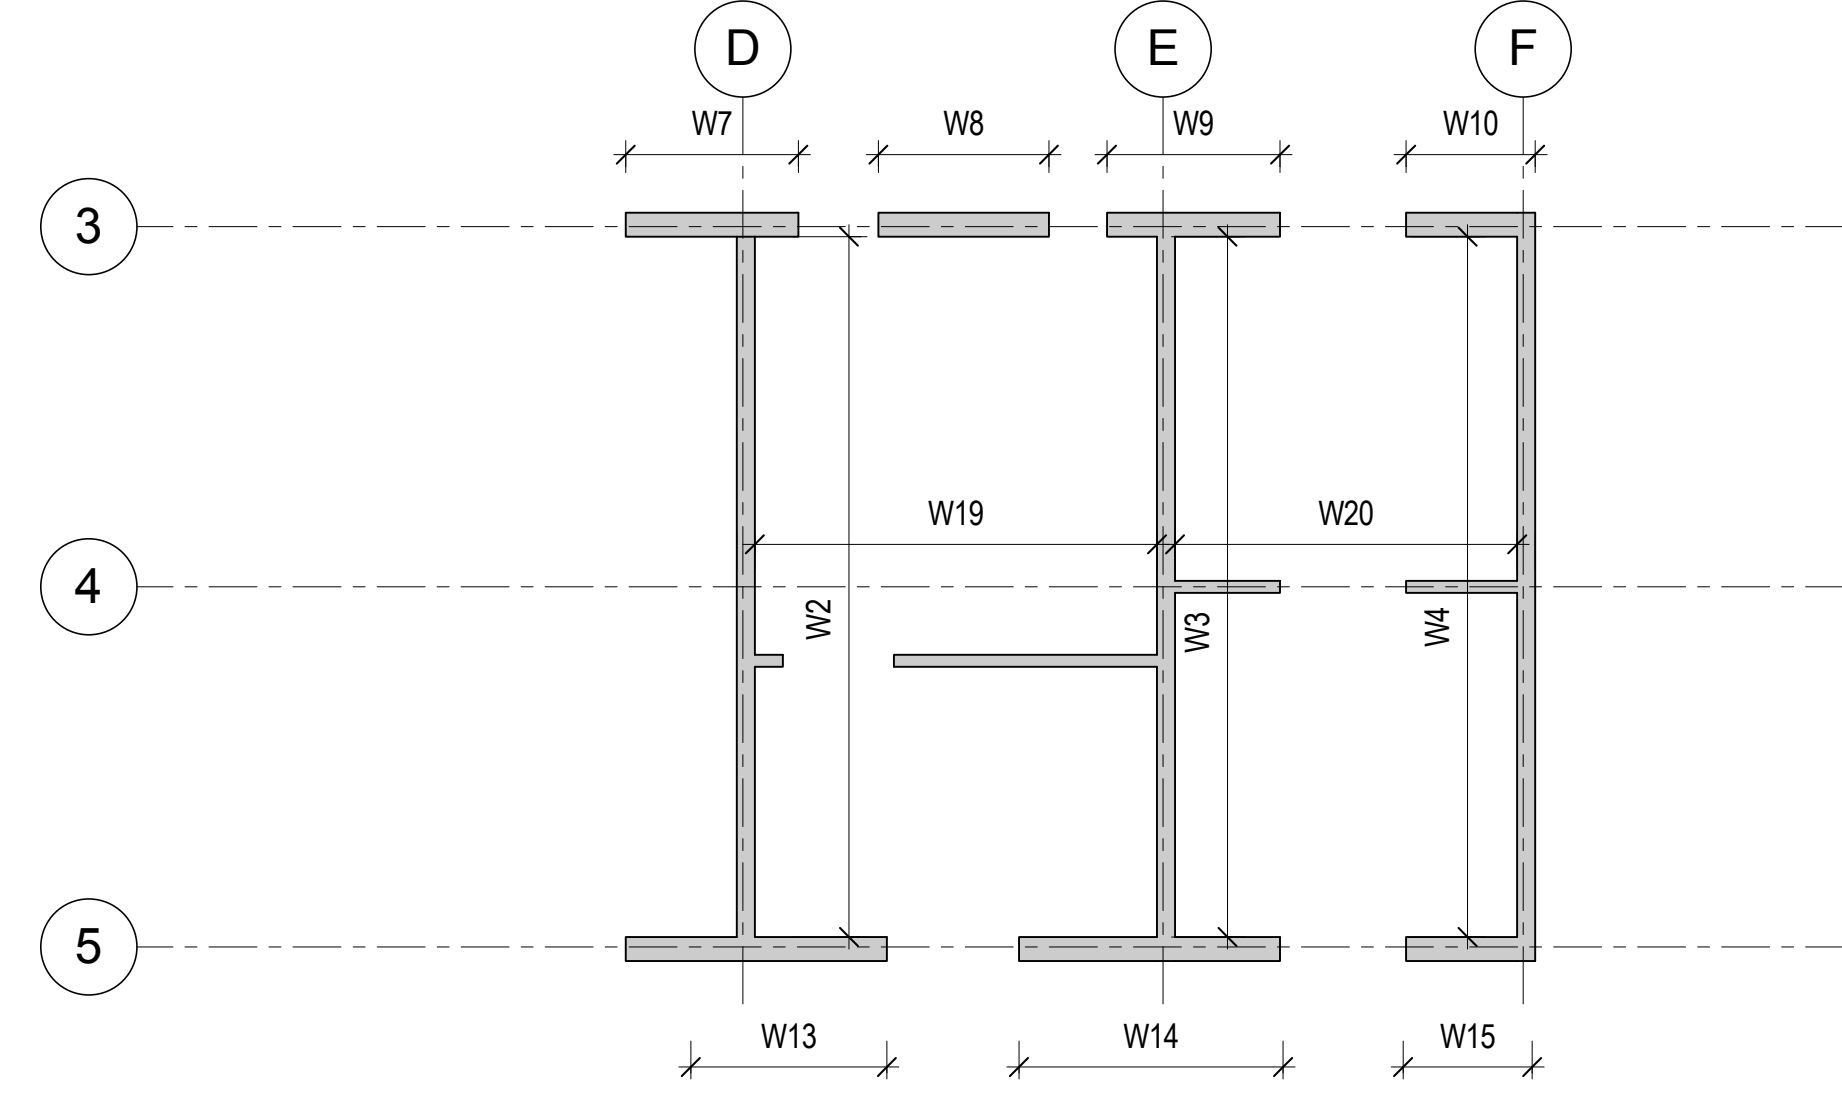
REINFORCED CONCRETE CORE WALL SCHEDULE FOR NORTH TOWER																						CONCRETE: AS NOTED REINFORCEMENT: ASTM A615 GR. 60		REINFORCEMENT
WALL MARK	CONCRETE (PSI)	WALL 1	WALL 2	WALL 3	WALL 4	WALL 5	WALL 6	WALL 7	WALL 8	WALL 9	WALL 10	WALL 11	WALL 12	WALL 13	WALL 14	WALL 15	WALL 16	WALL 17	WALL 18	WALL 19	WALL 20	WALL 21	WALL 22	
LEVEL		WALL THICKNESS TW (IN)	WALL THICKNESS TW (IN)	ROOF LEVEL	8000	-	18	18	-	-	-	24	24	24	24	-	-	-	-	-	-	-	12	12	-	12	-	SEE 1/S-354
LEVEL 70 - ROOF	8000	-	18	18	18	-	-	24	24	24	24	-	-	24	24	24	-	-	12	12	12	12	-	SEE 2/S-353
LEVEL 69 - 70	8000	-	18	18	18	-	-	24	24	24	24	-	-	24	24	24	-	-	12	12	12	12	-	SEE 1/S-353
LEVEL 68 - 69	8000	-	18	18	18	-	-	24	24	24	24	-	-	24	24	24	-	-	12	12	12	12	-	SEE 2/S-352
LEVEL 63 - 68	8000	-	18	18	18	-	-	24	24	24	24	-	-	24	24	24	-	-	12	12	12	12	-	SEE 1/S-352
LEVEL 58 - 63	8000	-	18	18	18	-	-	24	24	24	24	-	-	24	24	24	-	-	12	12	12	12	-	SEE 2/S-351
LEVEL 53 - 58	8000	-	18	18	18	-	-	24	24	24	24	-	-	24	24	24	-	-	12	12	12	12	-	SEE 1/S-351
LEVEL 47 - 53	8000	18	18	18	18	-	30	30	30	30	30	-	30	30	30	30	-	12	12	12	12	12	-	SEE 2/S-350
LEVEL 42 - 47	8000	18	18	18	18	-	30	30	30	30	30	-	30	30	30	30	-	12	12	12	12	12	-	SEE 1/S-350
LEVEL 36 - 42	8000	18	18	18	18	-	30	30	30	30	30	-	30	30	30	30	-	12	12	12	12	12	-	SEE 2/S-349
LEVEL 31 - 36	8000	18	18	18	18	-	30	30	30	30	30	-	30	30	30	30	-	12	12	12	12	12	-	SEE 1/S-349
LEVEL 28 - 31	8000	18	18	18	18	18	36	36	36	36	36	36	36	36	36	36	36	12	12	12	12	12	12	SEE 2/S-348
LEVEL 26 - 28	8000	18	18	18	18	18	36	36	36	36	36	36	36	36	36	36	36	12	12	12	12	12	12	SEE 1/S-348
LEVEL 16 - 26	8000	18	18	18	18	18	44	44	44	44	44	44	44	44	44	44	44	12	12	12	12	12	12	SEE 2/S-347
LEVEL 11 - 16	10000	24	24	24	24	24	48	48	48	48	48	48	48	48	48	48	48	12	12	12	12	12	12	SEE 1/S-347
LEVEL 6 - 11	10000	24	24	24	24	24	50	50	50	50	50	50	50	50	50	50	50	12	12	12	12	12	12	SEE 2/S-346
LEVEL 5 - 6	10000	39	39	39	39	39	54	54	54	54	54	54	54	54	54	54	54	12	12	12	12	12	12	SEE 1/S-346
LEVEL 4 - 5	10000	39	39	39	39	39	54	54	54	54	54	54	54	54	54	54	54	12	12	12	12	12	12	SEE 2/S-345
LEVEL 3 - 4	10000	39	39	39	39	39	54	54	54	54	54	54	54	54	54	54	54	12	12	12	12	12	12	SEE 1/S-345
LEVEL 2 - 3	10000	39	39	39	39	39	54	54	54	54	54	54	54	54	54	54	54	12	12	12	12	12	12	SEE 2/S-344
LEVEL 1 - 2	10000	39	39	39	39	39	54	54	54	54	54	54	54	54	54	54	54	12	12	12	12	12	12	SEE 1/S-344
LEVEL B - 1	10000	39	39	39	39	39	54	54	54	54	54	54	54	54	54	54	54	12	12	12	12	12	12	SEE 2/S-343
LEVEL B1 - B	10000	39	39	39	39	39	54	54	54	54	54	54	54	54	54	54	54	12	12	12	12	12	12	SEE 1/S-343
LEVEL B2 - B1	10000	39	39	39	39	39	54	54	54	54	54	54	54	54	54	54	54	12	12	12	12	12	12	SEE 2/S-342
LEVEL B3 - B2	10000	39	39	39	39	39	54	54	54	54	54	54	54	54	54	54	54	12	12	12	12	12	12	SEE 1/S-342
DOWELS	-	#8 @ 6	#8 @ 6	#8 @ 6	#8 @ 6	#8 @ 6	#8 @ 6	#8 @ 6	#8 @ 6	#8 @ 6	#8 @ 6	#8 @ 6	#8 @ 6	#8 @ 6	#8 @ 6	#8 @ 6	#8 @ 6	#8 @ 6	#8 @ 6	#8 @ 6	#8 @ 6	#8 @ 6	#8 @ 6	




A KEY PLAN A - UP TO LEVEL 31
1/16" = 1'-0"




B KEY PLAN B - LEVEL 31 TO LEVEL 53
1/16" = 1'-0"




C KEY PLAN C - LEVEL 53 TO ROOF
1/16" = 1'-0"

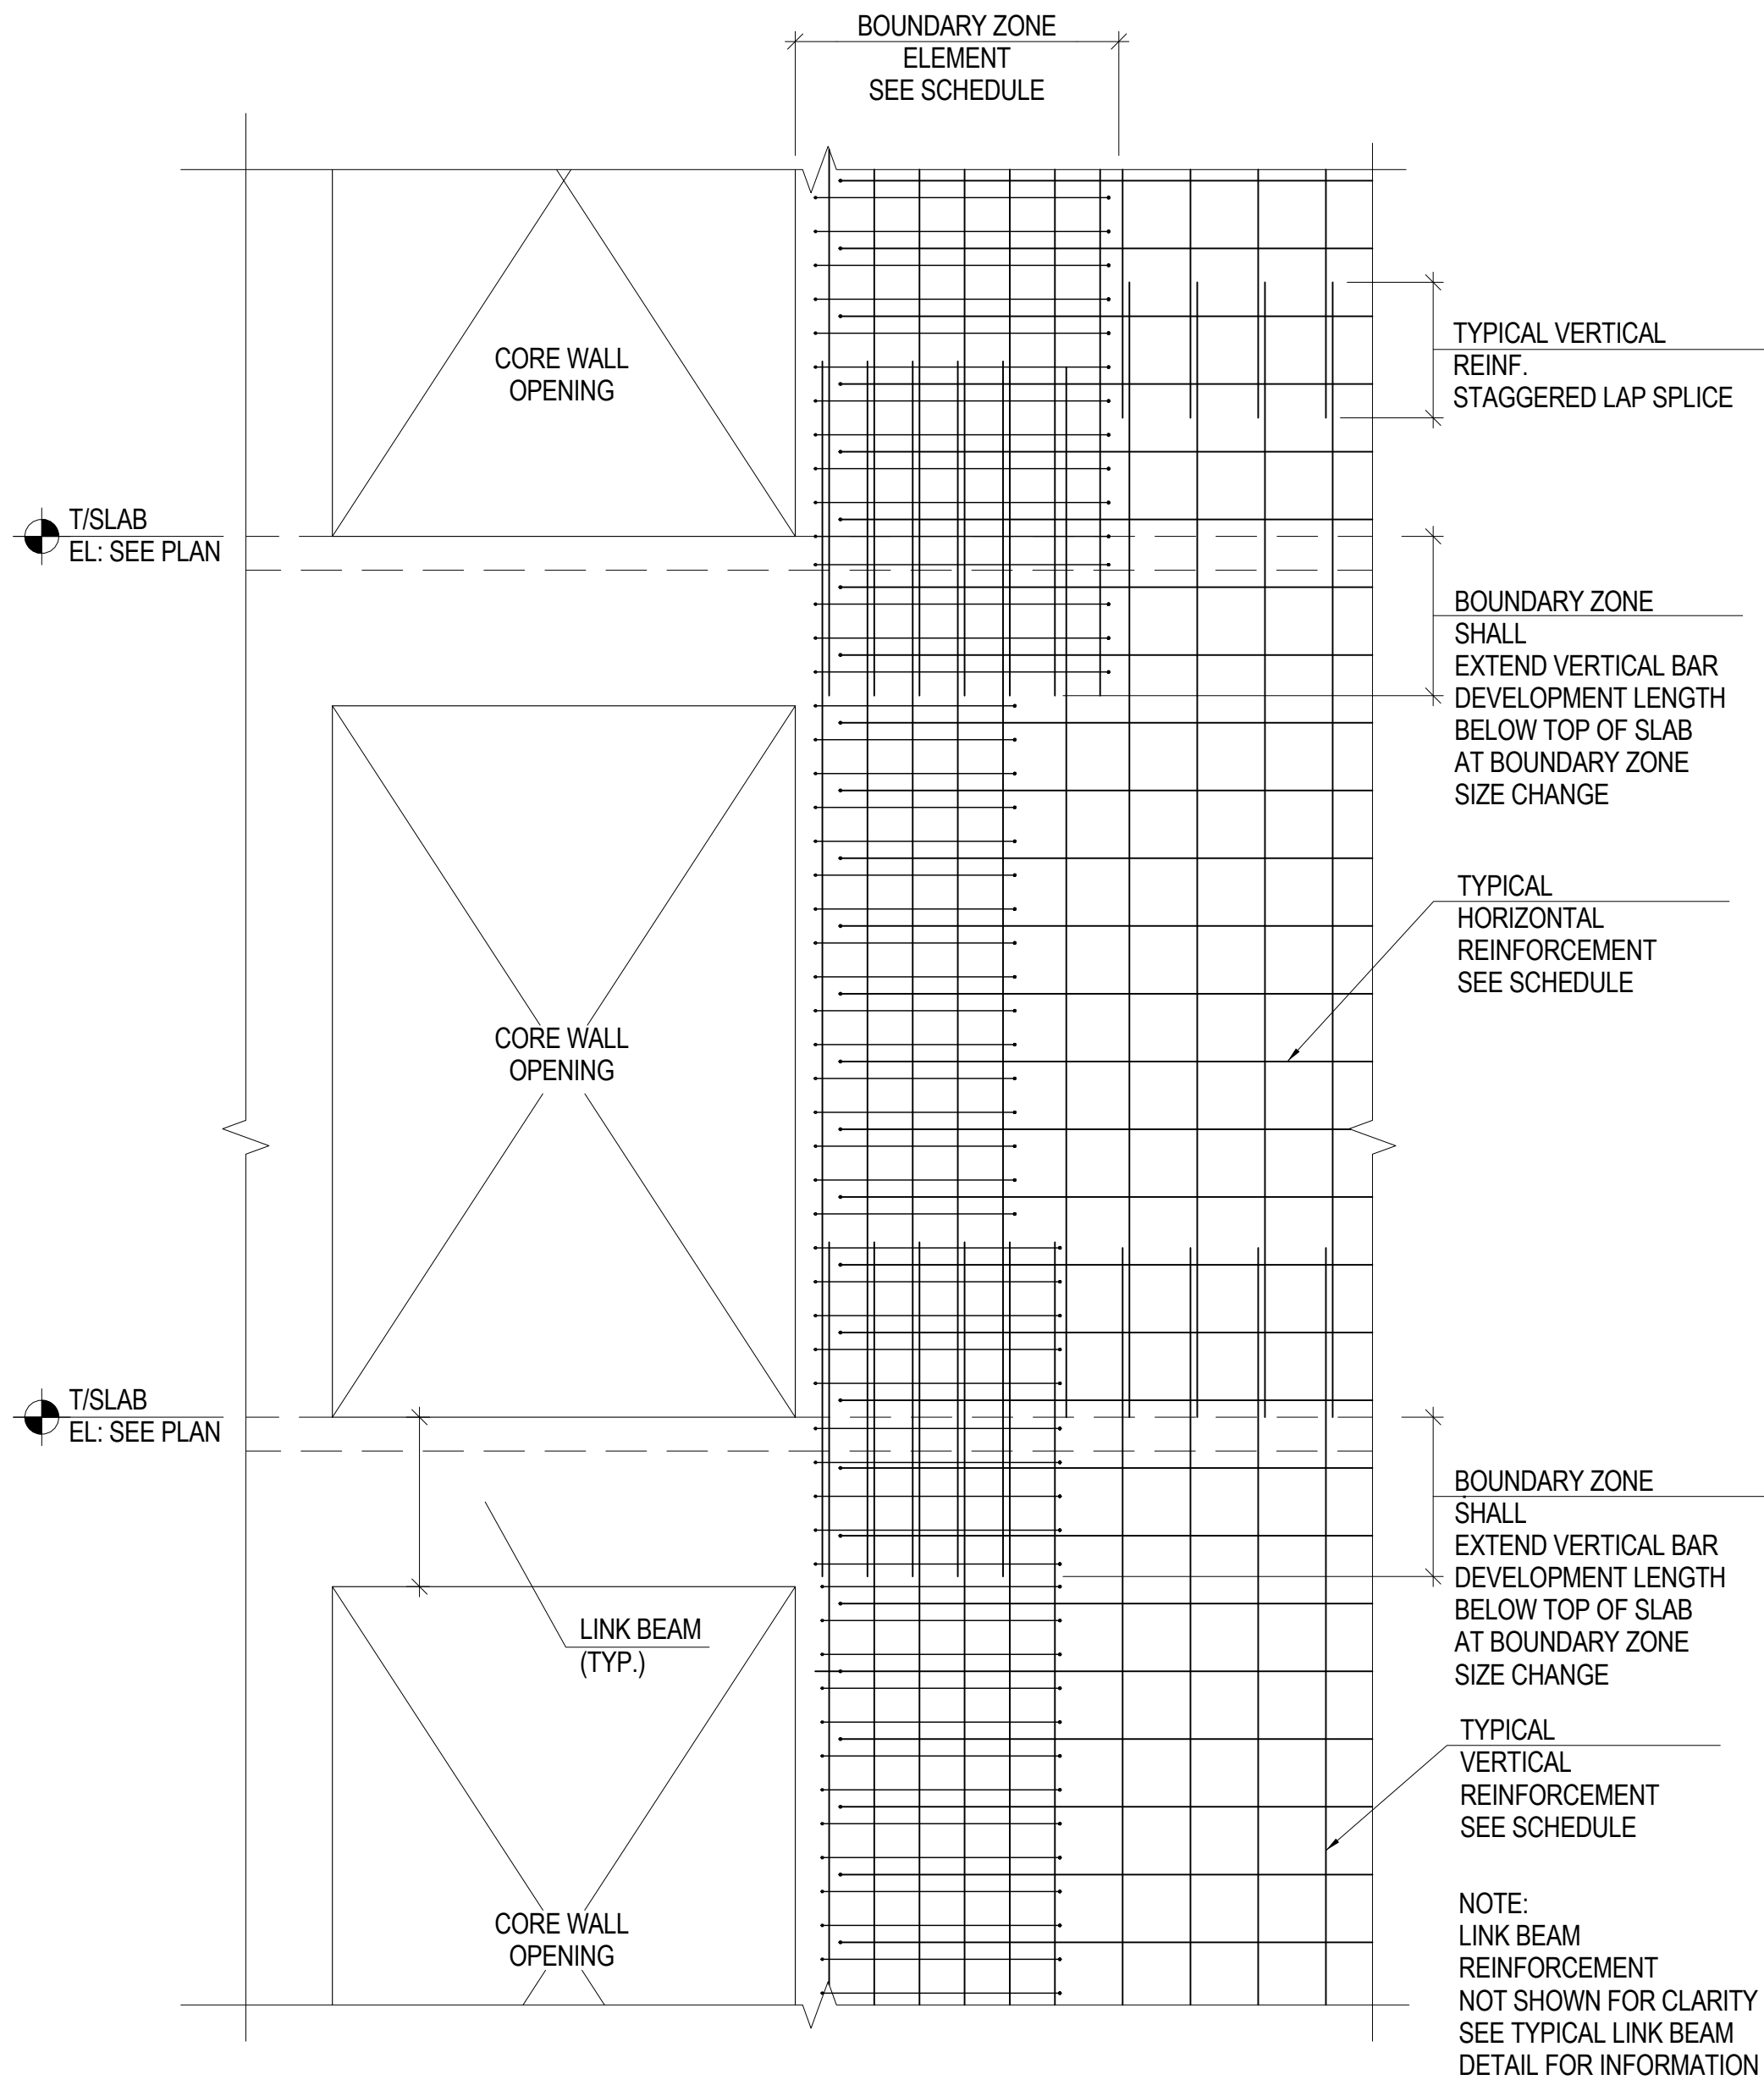


1 TYPICAL SHEAR WALL TIE REINFORCEMENT
1/2" = 1'-0"

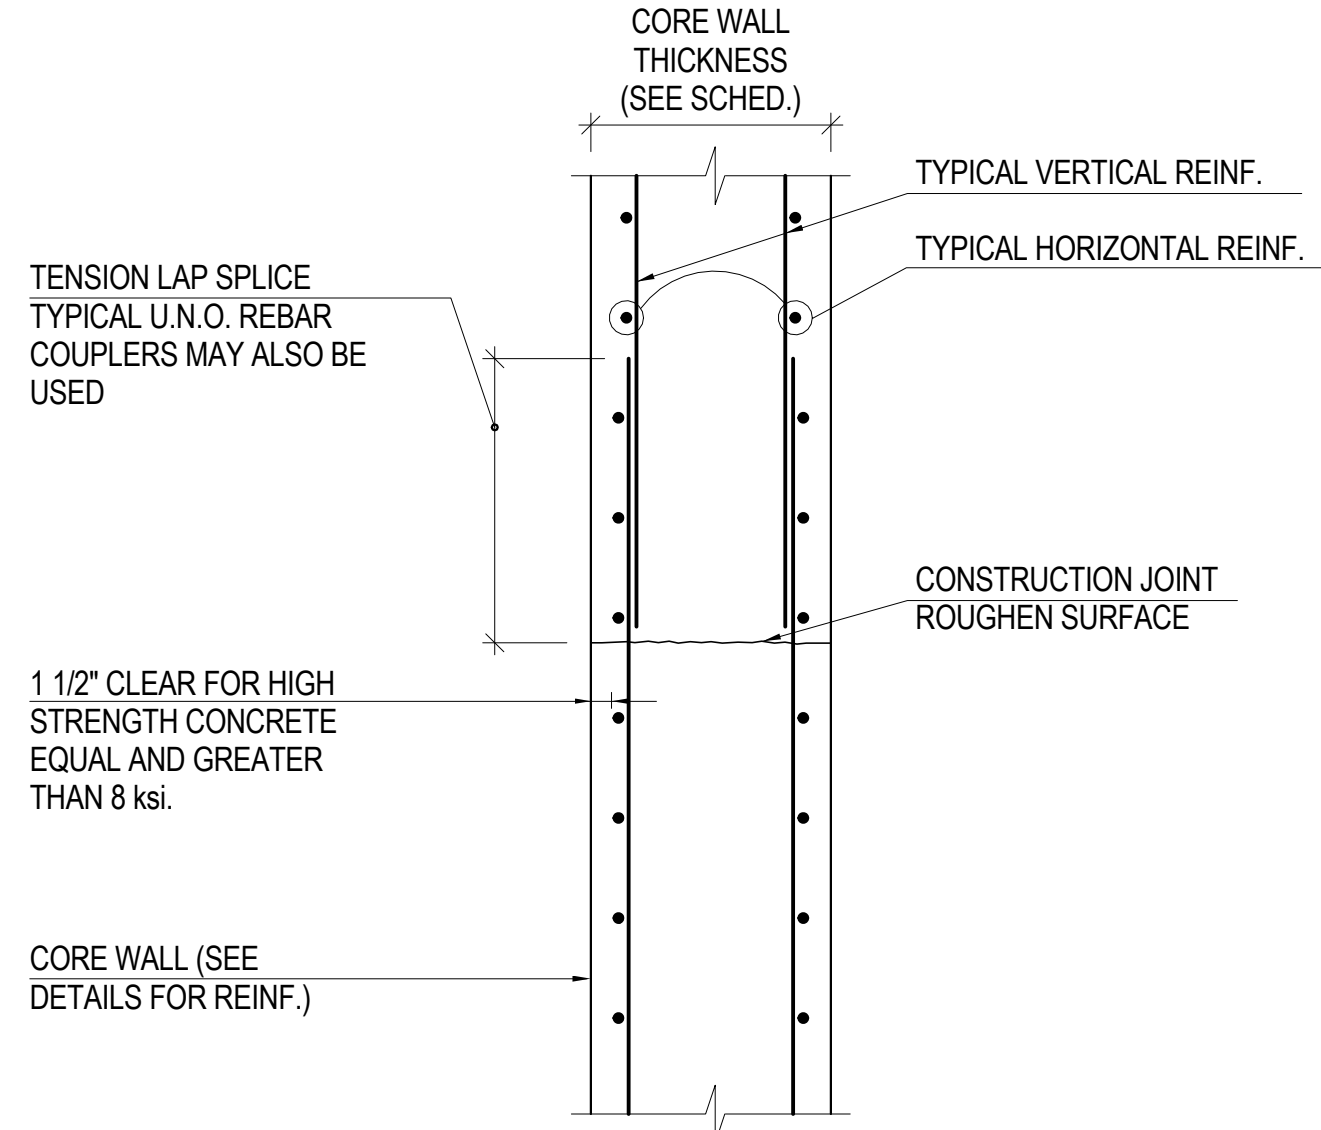

2 TYPICAL CORE WALL SPLICE
1" = 1'-0"

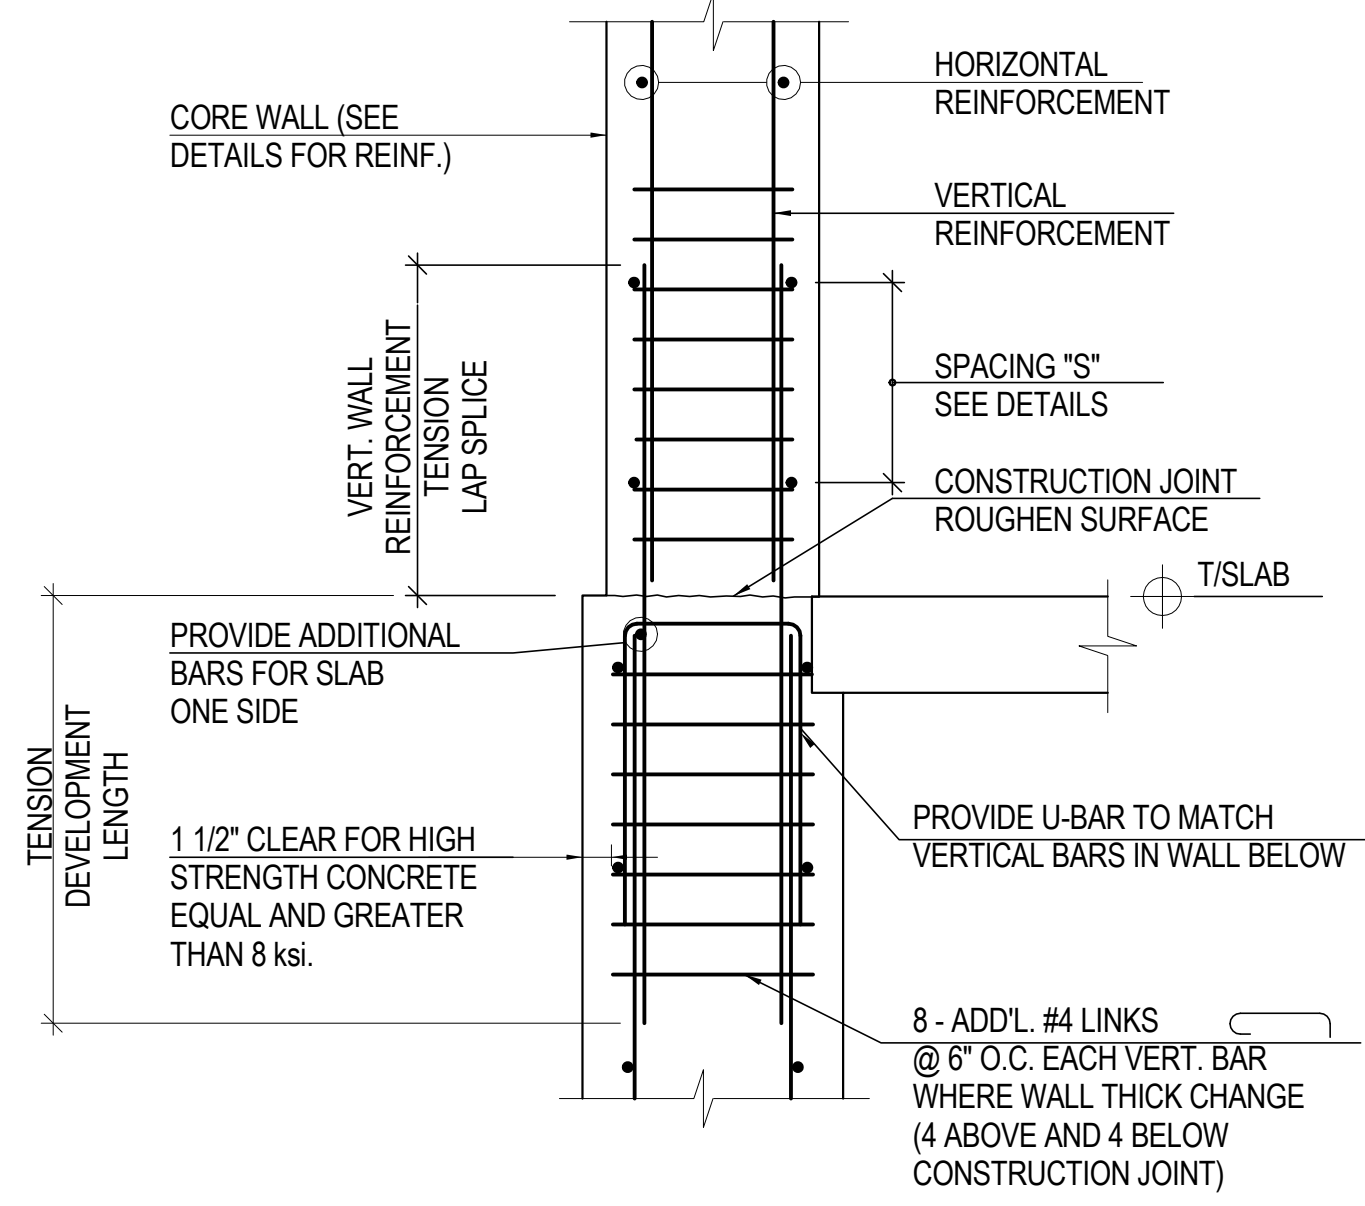

3 TYPICAL CORE WALL SPLICE WITH WALL THICKNESS CHANGE
NOT TO SCALE

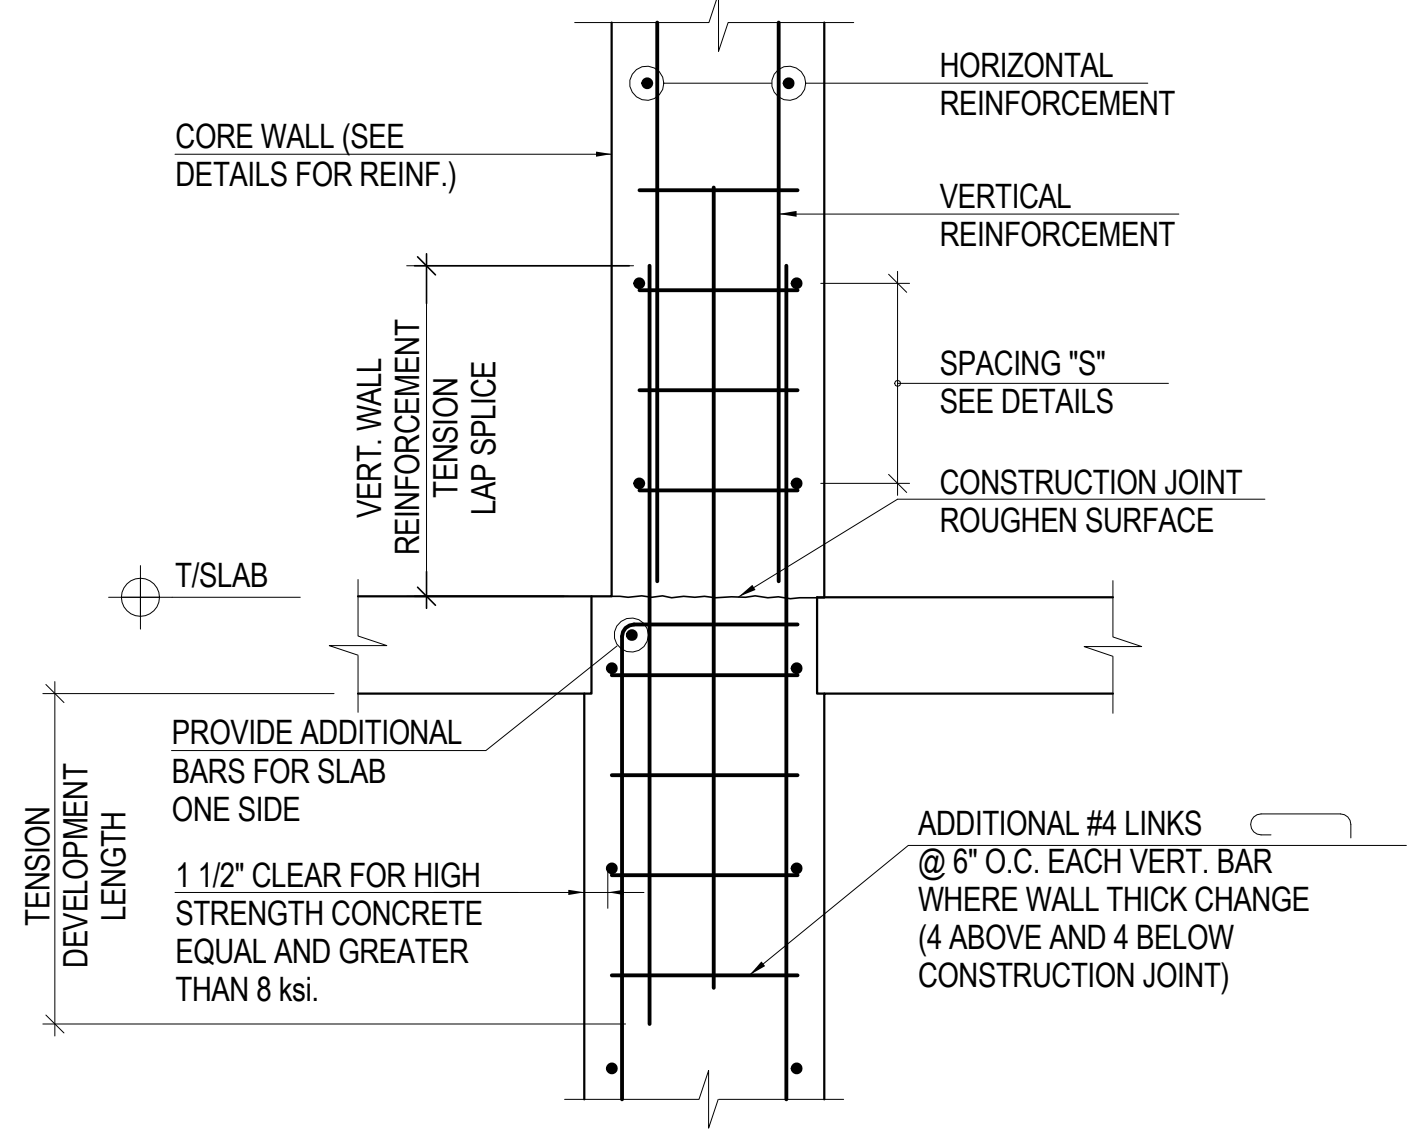

4 TYPICAL CORE WALL SPLICE WITH WALL THICKNESS
NOT TO SCALE


**MANHATTAN WEST:
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375 Ninth Avenue, New York, NY 10001
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Wind Tunnel Consultant
Rowan Williams Davies & Irwin Inc.
680 Woodlawn Road West, Guelph
Ontario, Canada N1K 1B8


REINFORCED CONCRETE CORE WALL SCHEDULE, SECTIONS & DETAILS

Project No.: 211157
Date: 20 JUN 2014
Scale: As indicated
File No: S-340
B-SCAN Sheet No.: S-340.00
Sheet No.: S-340
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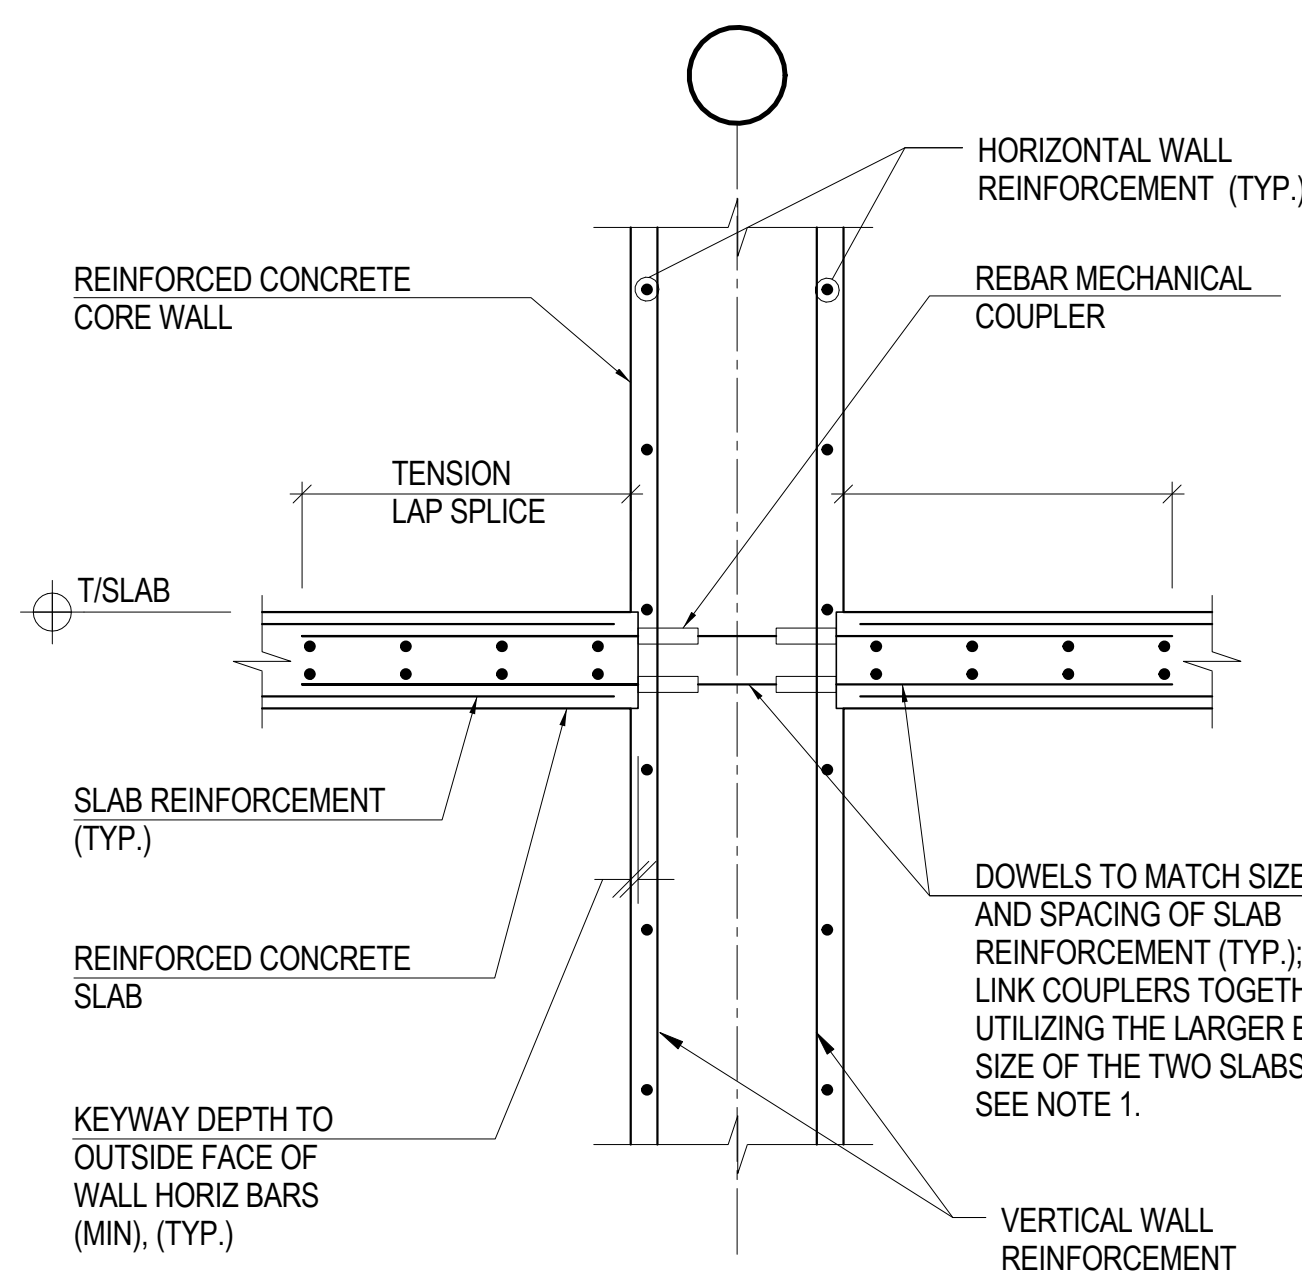
- NOTE:
1. 'RS' SLABS TO HAVE REBAR IN LIEU OF W.W.F. REFER TO PLANS AND S-301.
 2. AT CONDITIONS WHERE A R/C SLAB EXISTS ON THE OTHER SIDE OF THE CORE WALL, THIS DETAIL TO BE USED IN CONJUNCTION WITH DETAIL 2.

1 TYPICAL METAL DECK SLAB CONNECTION DETAIL: ONE-SIDED
NOT TO SCALE

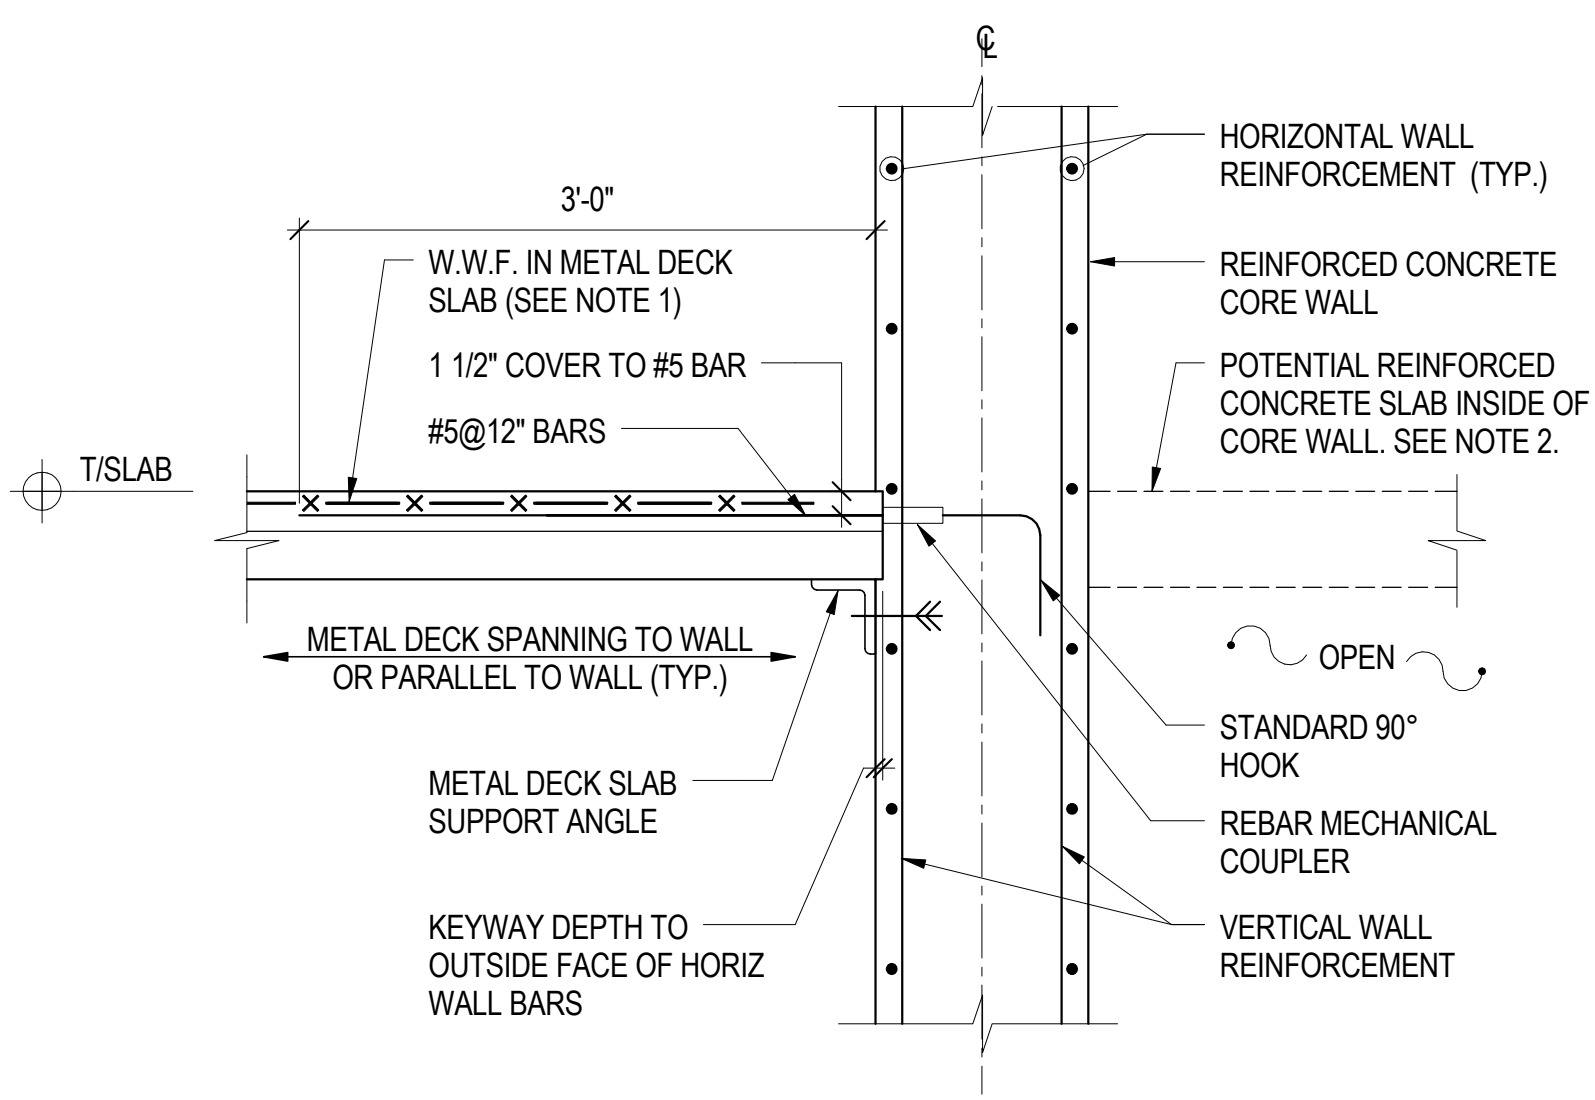


- NOTE:
1. AT ONE WAY SLABS SPANNING PARALLEL TO CORE WALL, PROVIDE EQUIVALENT OF #5@12" AT MID-DEPTH OF SLAB EXTENDING 4'-0" OUT FROM FACE OF WALL. COORDINATE SIZE AND SPACING OF THIS REINFORCEMENT WITH CORE WALL REINFORCEMENT SPACING.
 2. AT CONDITIONS WHERE A METAL DECK SLAB EXISTS ON THE OTHER SIDE OF THE CORE WALL, THIS DETAIL TO BE USED IN CONJUNCTION WITH DETAIL 1.

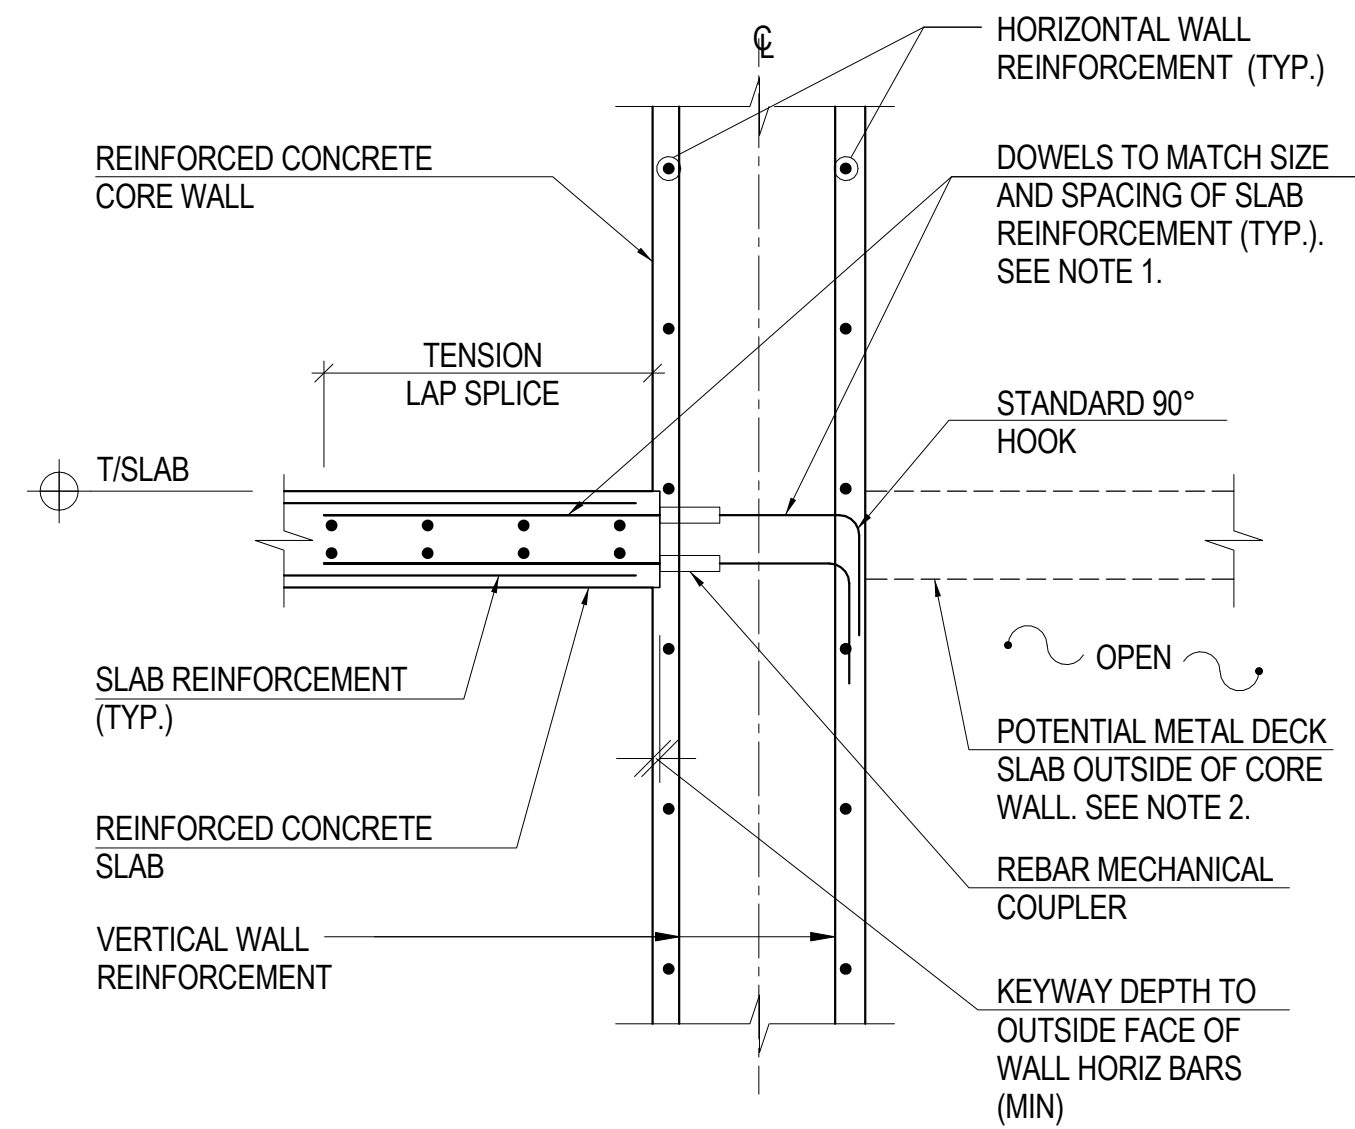2 TYPICAL R/C SLAB CONNECTION DETAIL: ONE-SIDED
NOT TO SCALE




- NOTE:
1. AT ONE WAY SLABS SPANNING PARALLEL TO CORE WALL, PROVIDE EQUIVALENT OF #5@12" AT MID-DEPTH OF SLAB EXTENDING 4'-0" OUT FROM FACE OF WALL. COORDINATE SIZE AND SPACING OF THIS REINFORCEMENT WITH CORE WALL REINFORCEMENT SPACING.


3 TYPICAL R/C SLAB CONNECTION DETAIL: TWO-SIDED
NOT TO SCALE

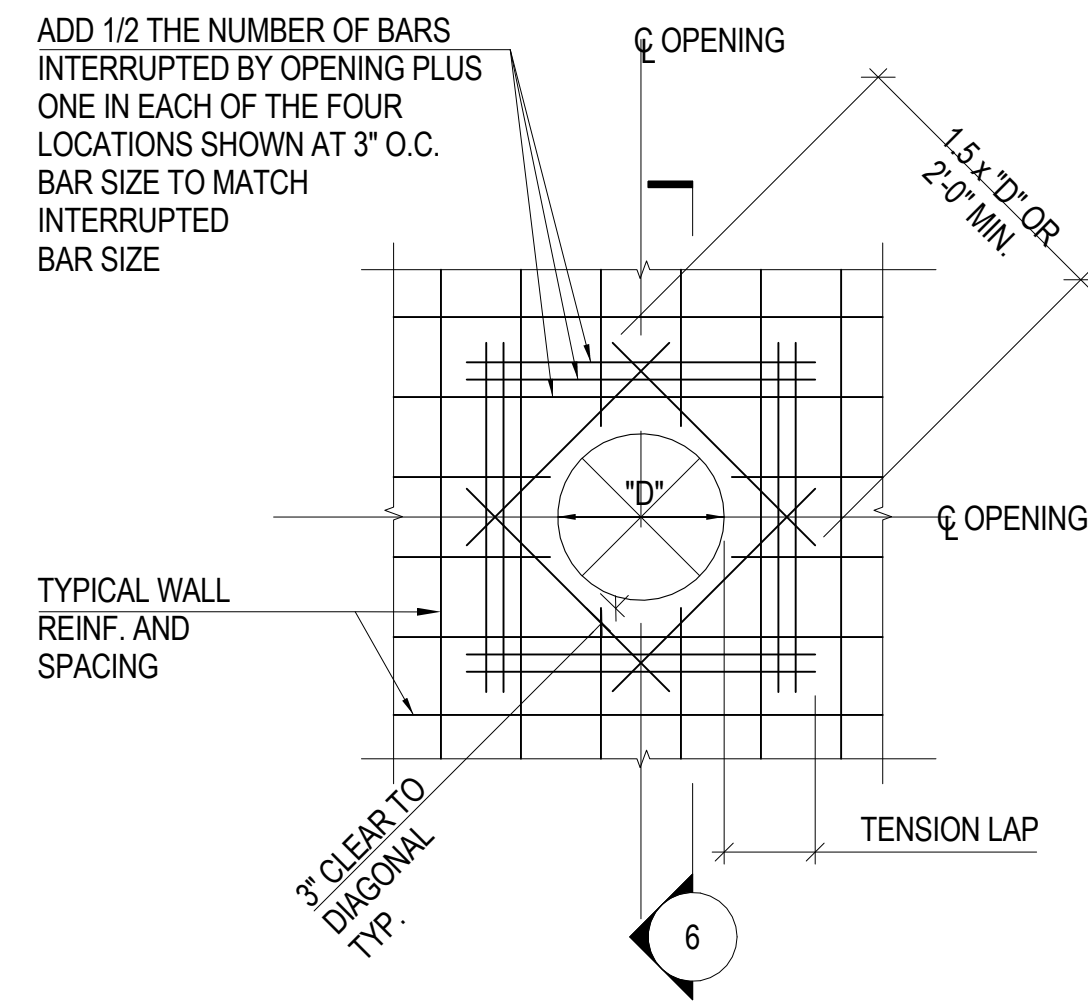


4 TYPICAL RECTANGULAR CORE WALL OPENING DETAIL
NOT TO SCALE

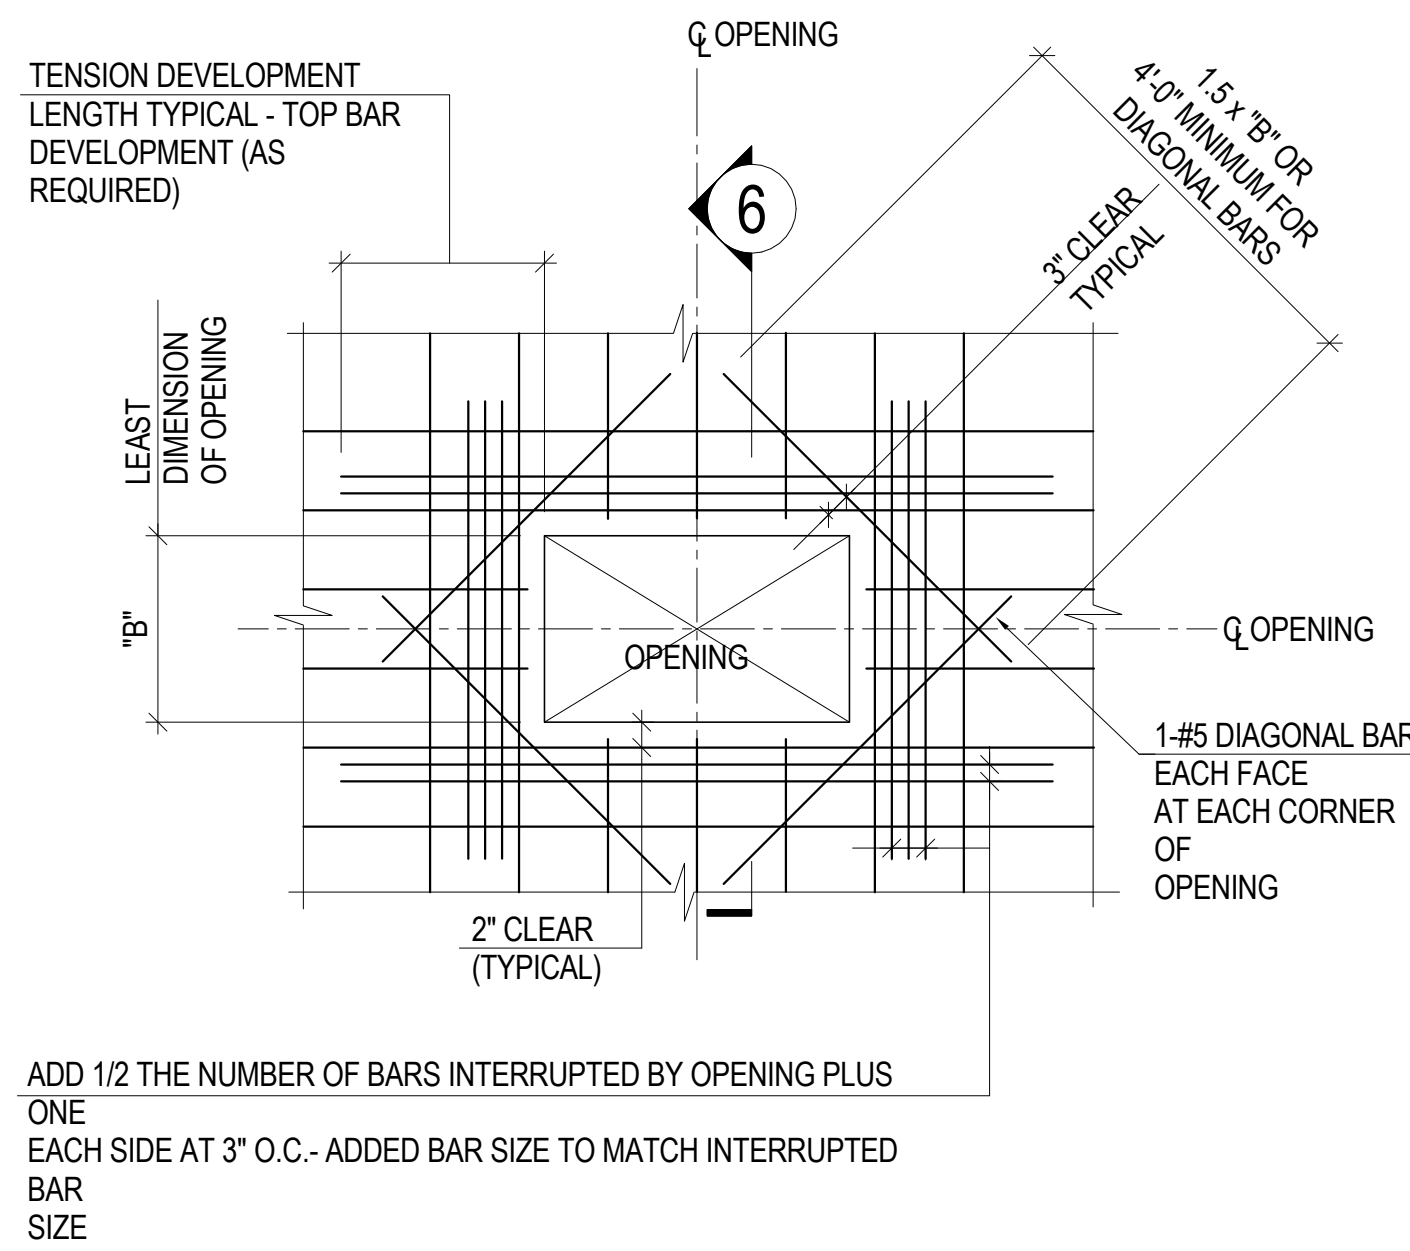

5 TYPICAL RECTANGULAR CORE WALL OPENING DETAIL
NOT TO SCALE

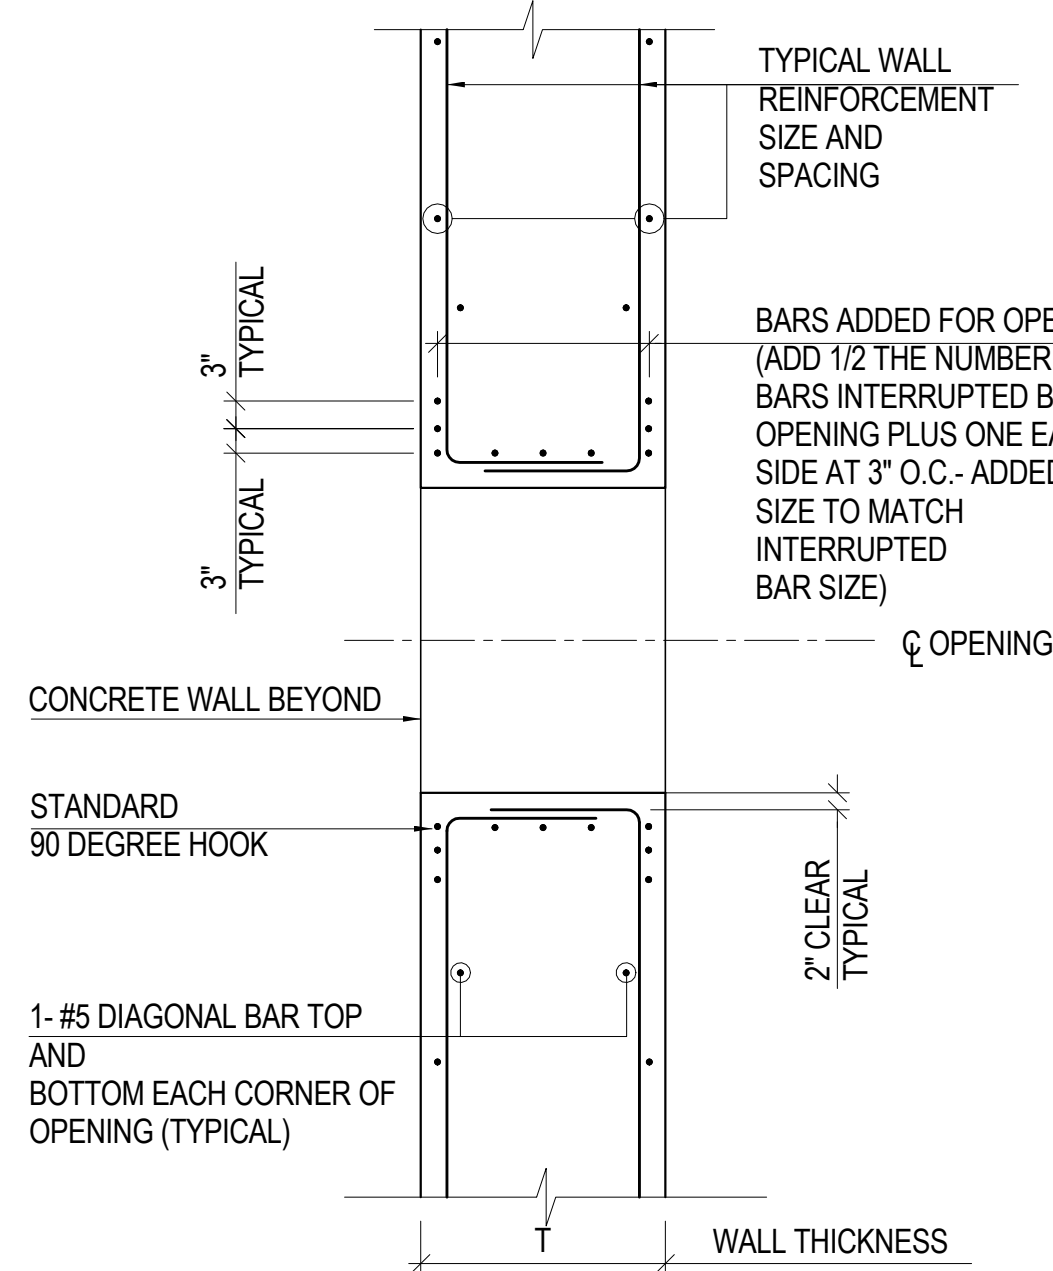


6 TYPICAL RECTANGULAR/CIRCULAR CORE WALL OPENING DETAIL
NOT TO SCALE

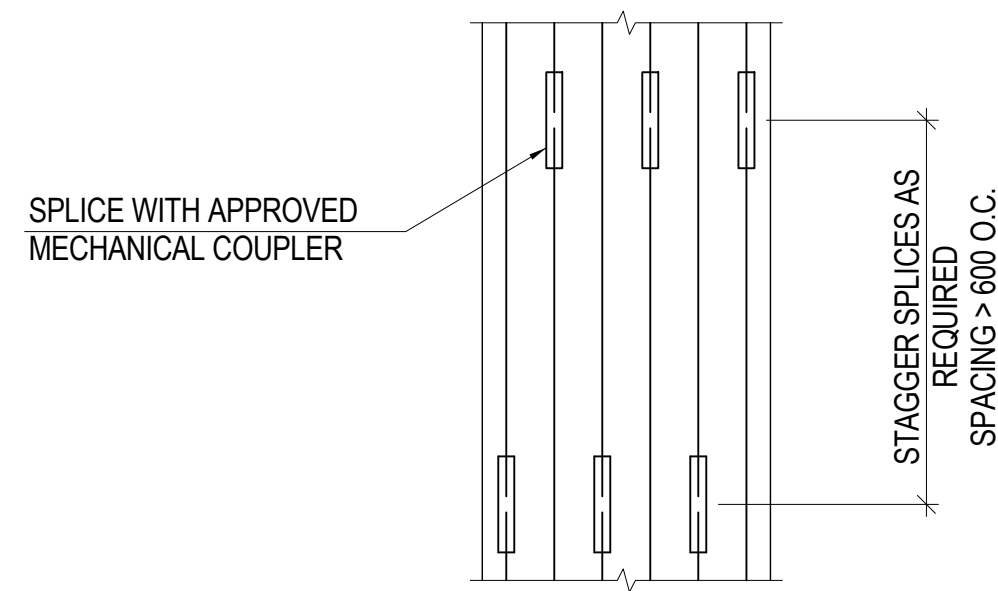


- NOTE:
- TIE REINFORCEMENT NOT SHOWN FOR CLARITY. REDISTRIBUTE STIRRUP VERTICAL SPACING FOR NOT TO BE PLACED AT CONNECTOR LOCATION.


7 ALTERNATE REBAR SPLICE DETAIL
NOT TO SCALE

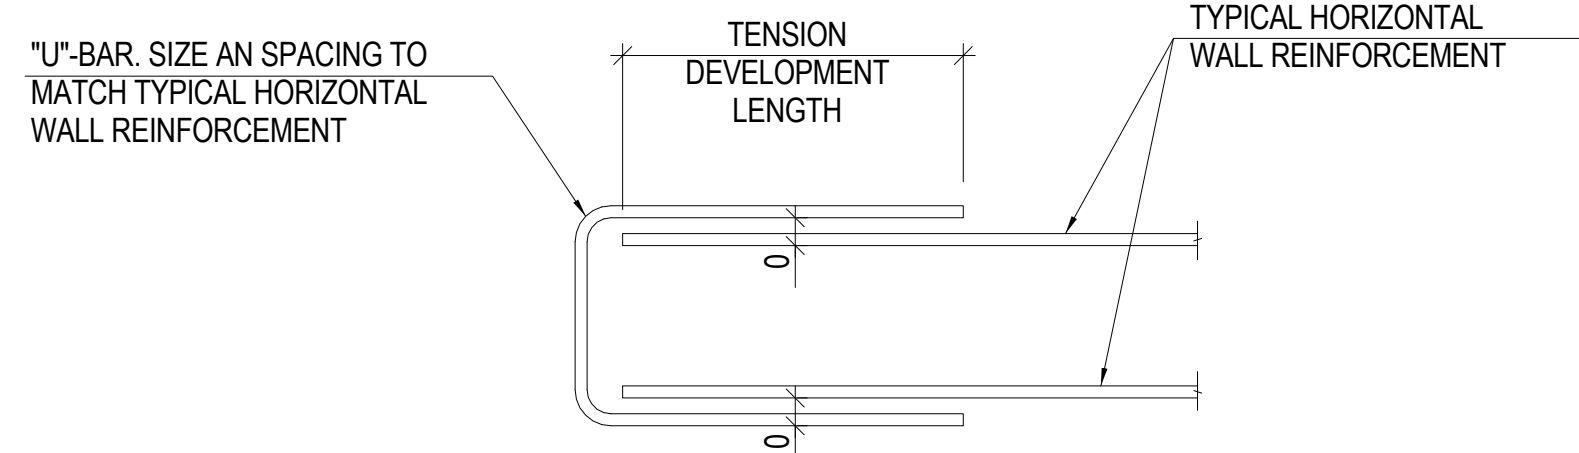


8 ALTERNATE REBAR SPLICE DETAIL
NOT TO SCALE

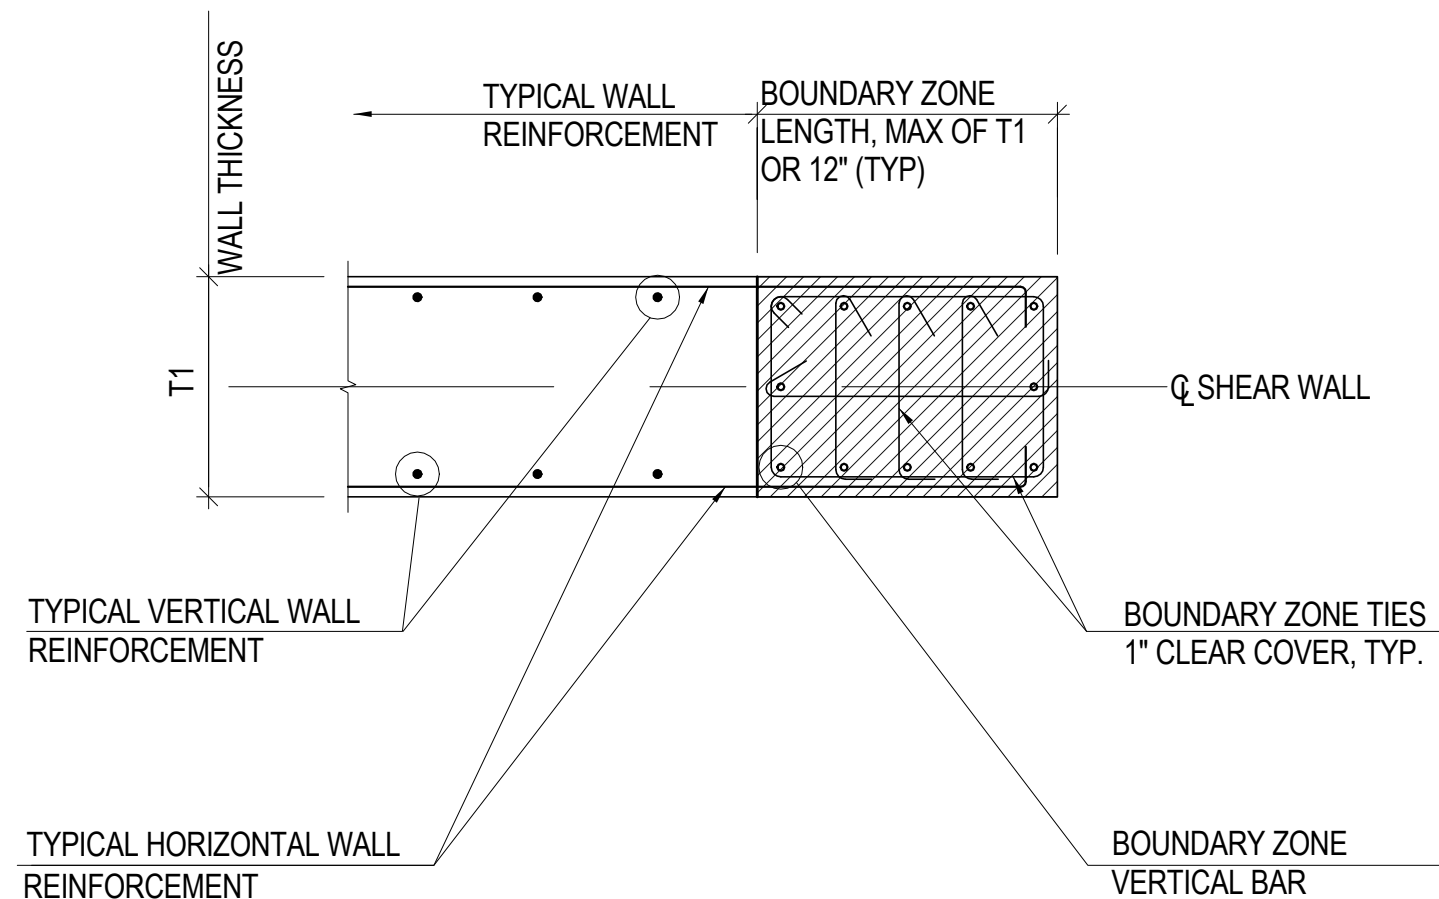

9 TYPICAL SHEAR WALL BOUNDARY ELEMENT END DETAIL
NOT TO SCALE

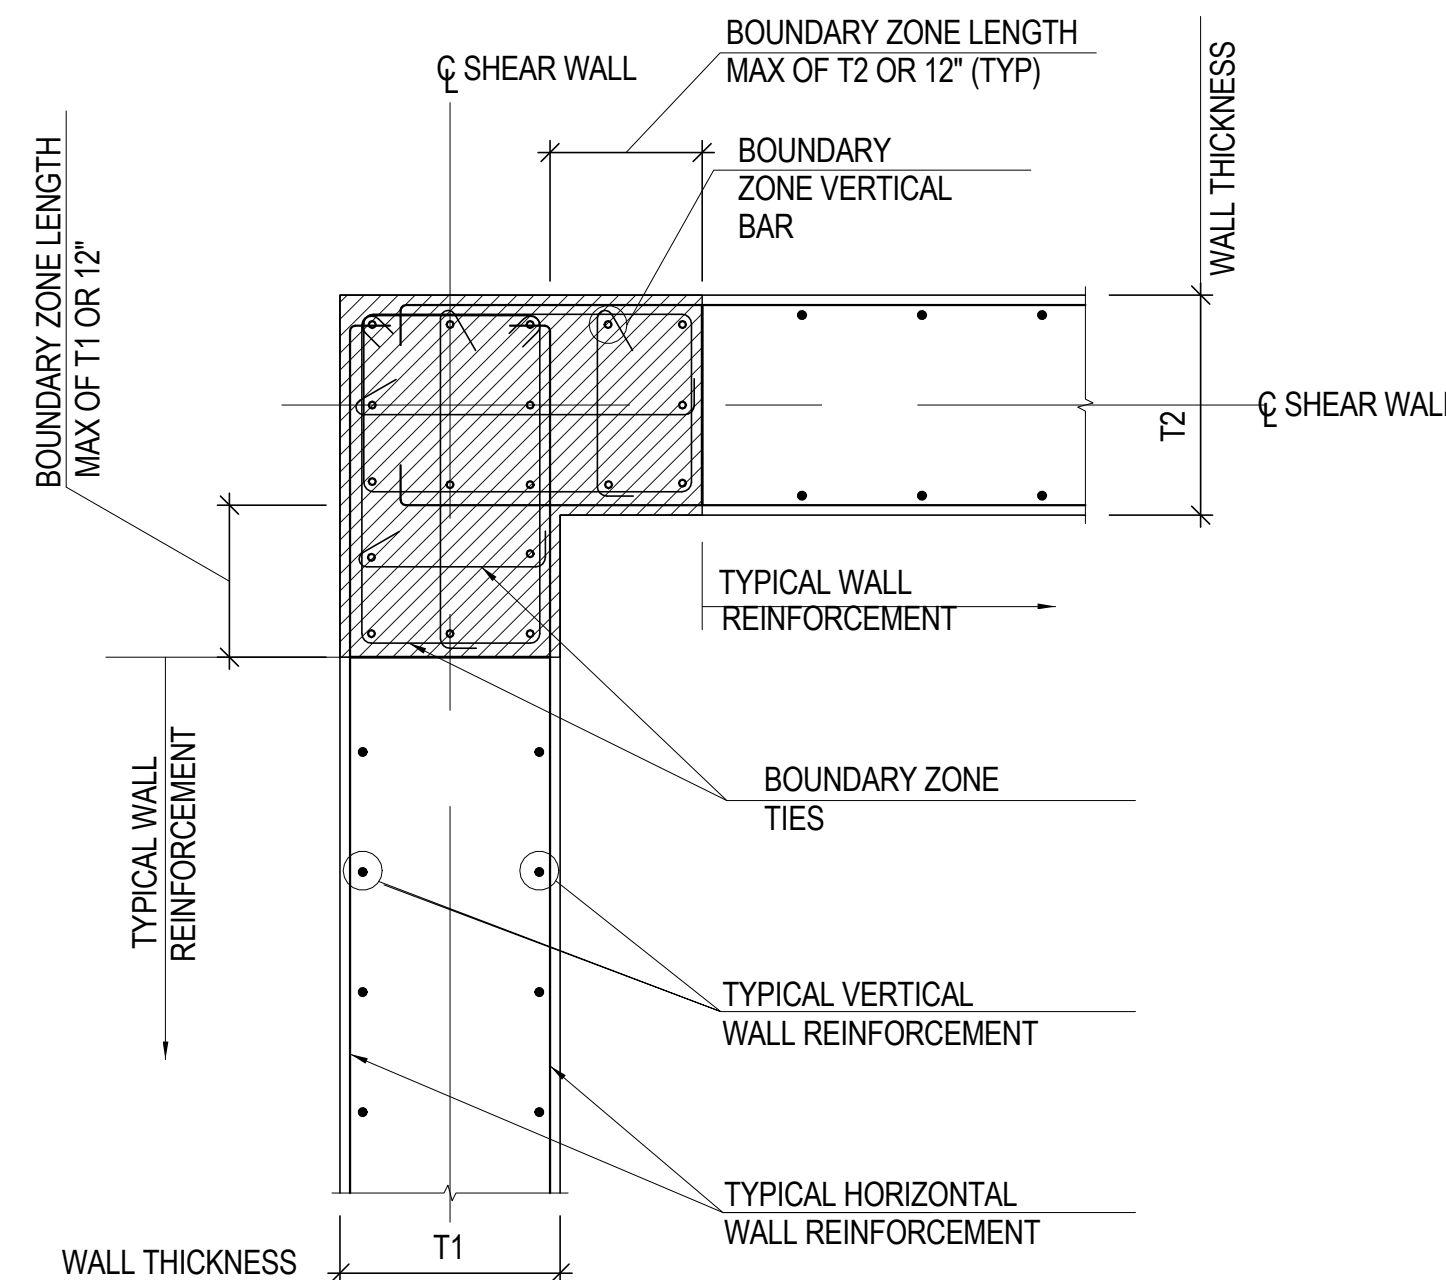

10 TYPICAL SHEAR WALL BOUNDARY ELEMENT CORNER DETAIL
NOT TO SCALE

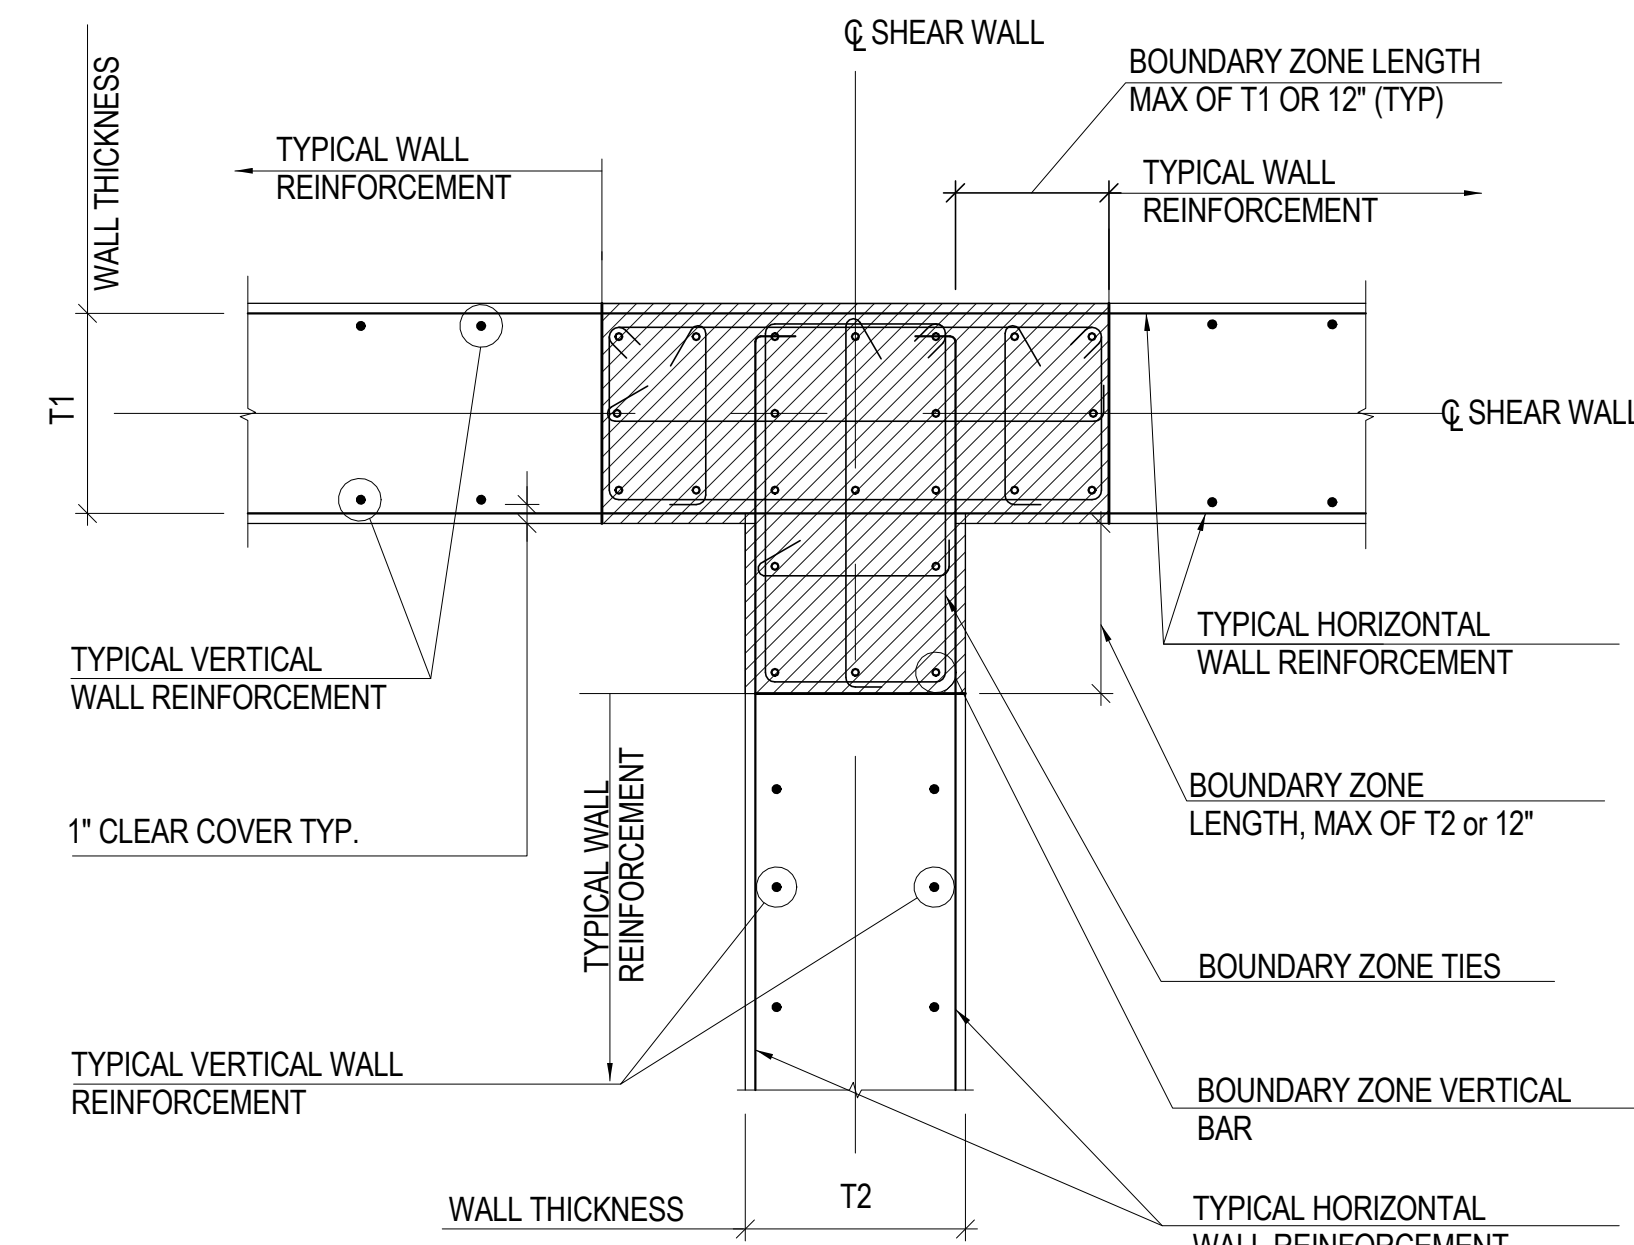

11 TYPICAL SHEAR WALL BOUNDARY ELEMENT INTERSECTION DETAIL
NOT TO SCALE

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Facade Maintenance Consultant

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166 Ames Street, Hackensack, NJ 07601
Wind Tunnel Consultant

Rowan Williams Davies & Irwin Inc.
680 Woodlawn Road West, Guelph
Ontario, Canada N1K 1B8

Key Plan:

Seal & Signature:

PRELIMINARY
NOT FOR CONSTRUCTION

No.	Date	Description
6	20 JUN 2014	ISSUED FOR FOUNDATION BID
5	20 JUN 2014	ISSUED FOR FOUNDATION PERMIT
4	20 DEC 2013	ISSUED FOR FOUNDATION PERMIT
3	15 NOV 2013	ISSUED FOR 50% PROGRESS PRICING
2	12 JUL 2013	ISSUED FOR 90% DESIGN DEVELOPMENT
1	19 MAR 2012	ISSUED FOR RECONCILIATION

Sheet Name:

**TYPICAL
REINFORCED
CONCRETE WALL
DETAILS**

Project No.:	B-SCAN Sheet No.:
211157	S-341.00

Date:	Scale:	File No.:
20 JUN 2014	As indicated	S-341

Page No.:	Page No.:
48 of 90	48 of 90



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New York, NY 10122

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Field Operations
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Rowan Williams Davies & Irwin Inc.
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Ontario, Canada N1K 1B6


Professional Engineer Seal
Charles Michael Bell
079322
Professional Engineer

Key Plan:
Map showing project location at the intersection of 31st Street and 33rd Street, bounded by Dyer Avenue and 9th Avenue.


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NOT FOR CONSTRUCTION

Project No.: 211157
Date: 21 JUN 2014
Scale: 3/16" = 1'-0"
File No.: S-342


Sheet No.: S-342.00
Sheet Name: CORE WALL REINFORCEMENT LAYOUT
Page No.: 49 of 90

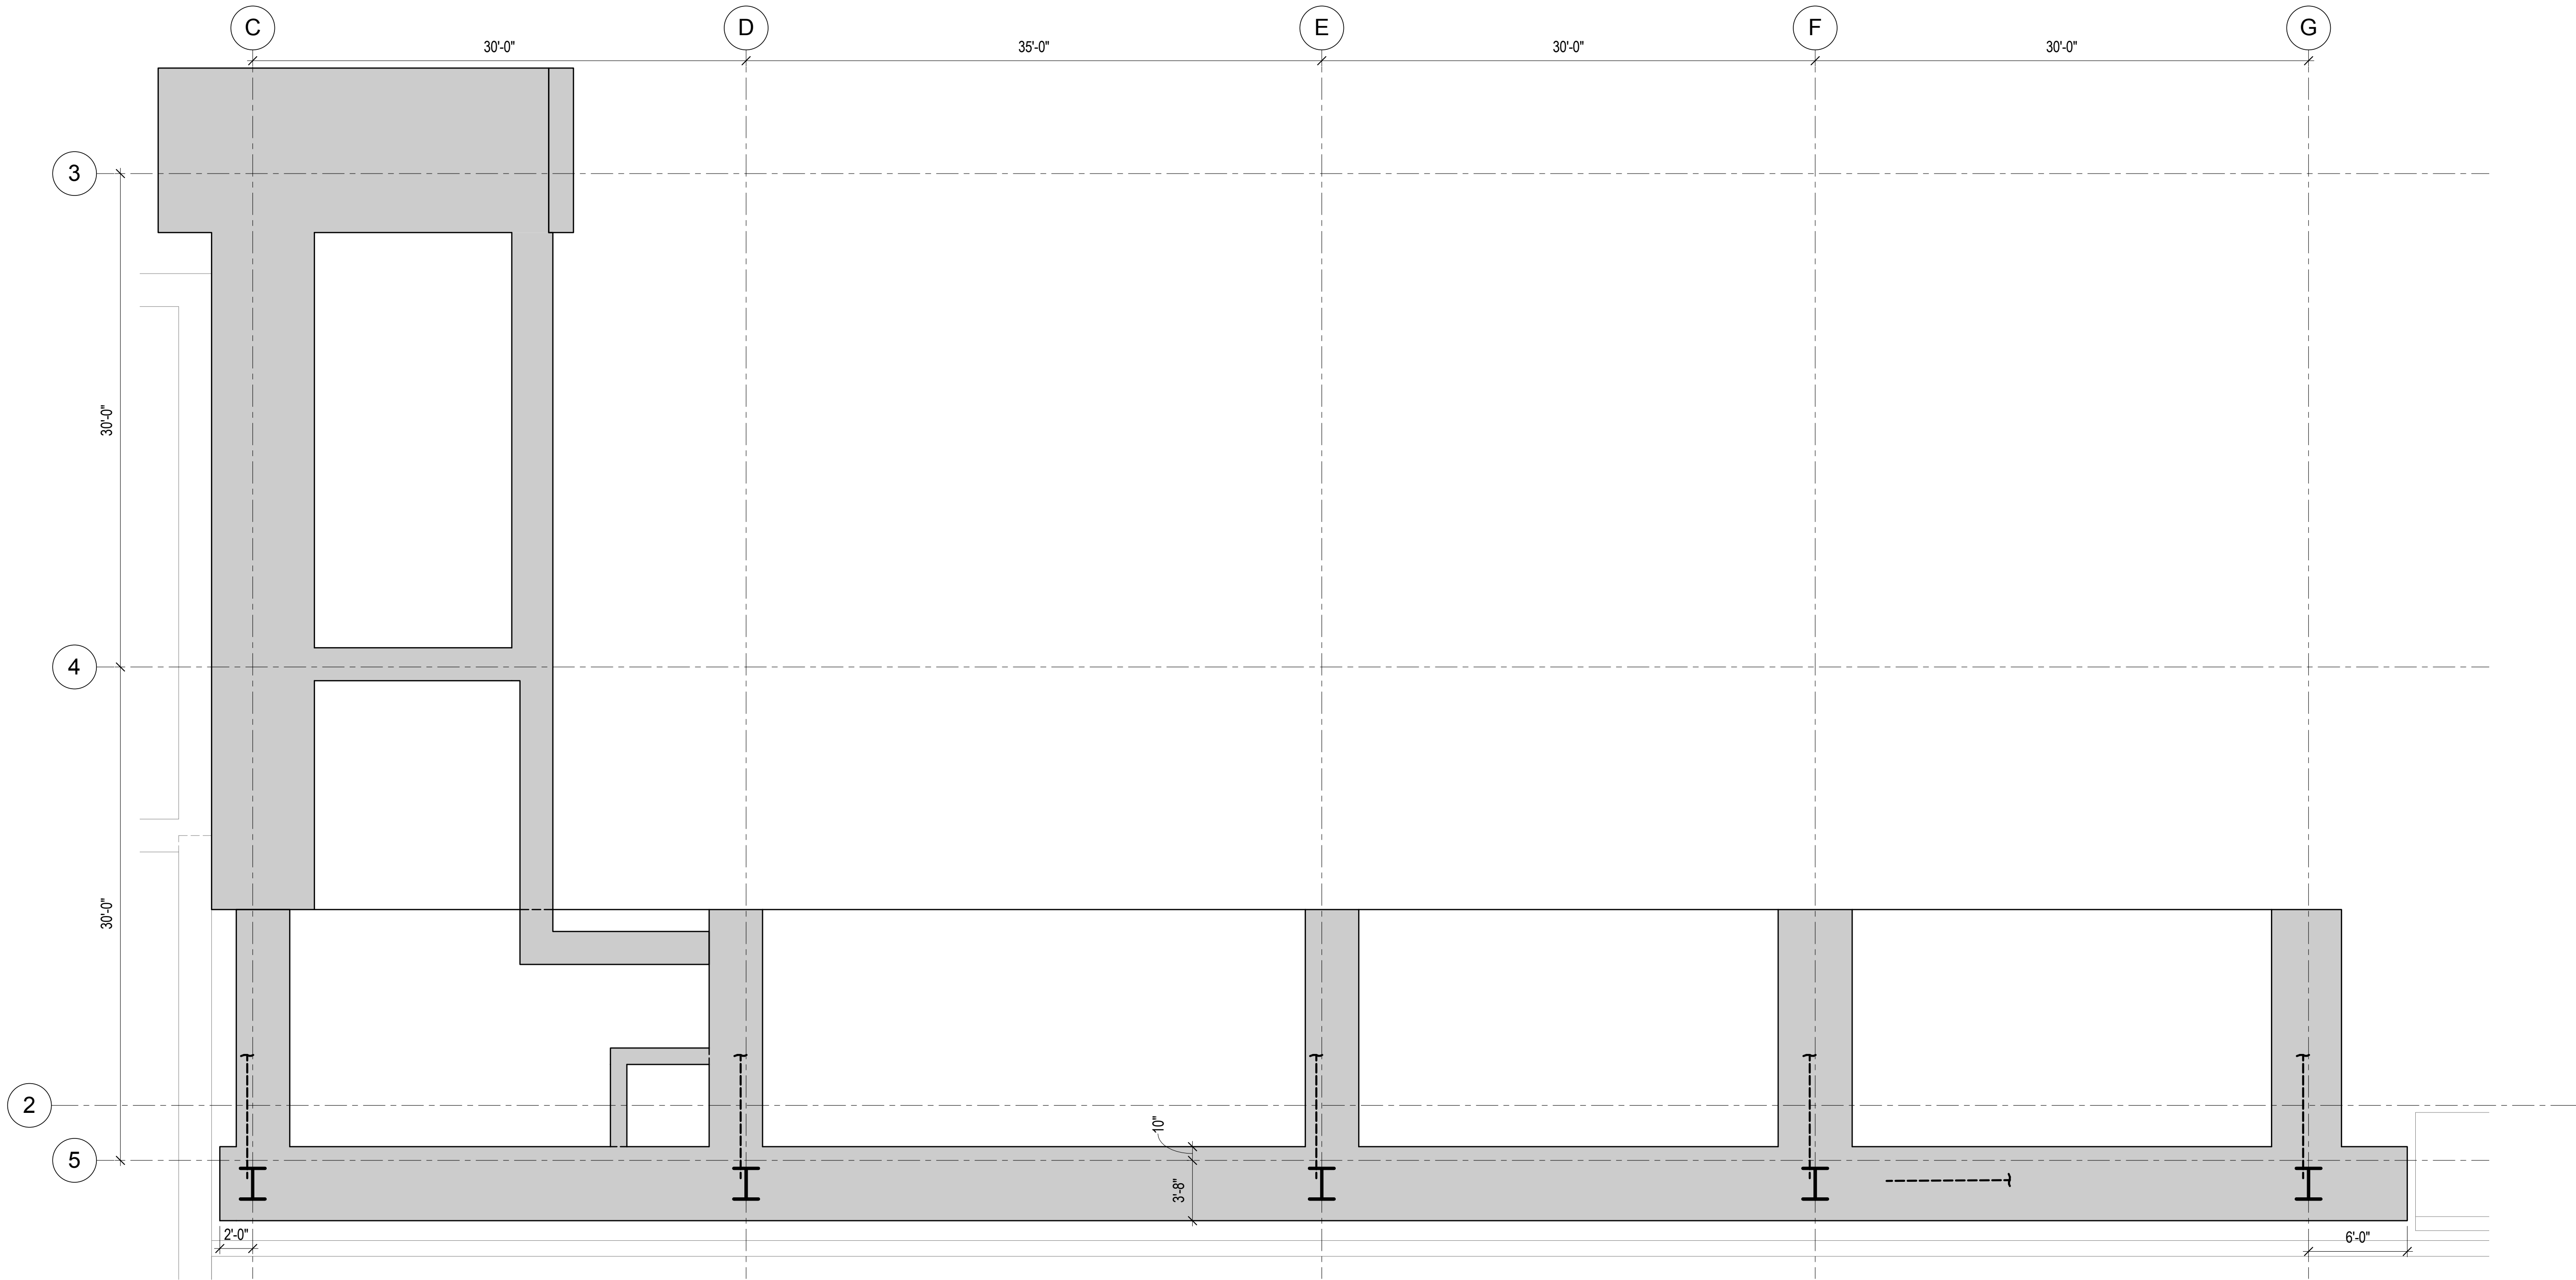


1 REINFORCEMENT LAYOUT - LEVEL B3 TO LEVEL B2
3/16" = 1'-0"

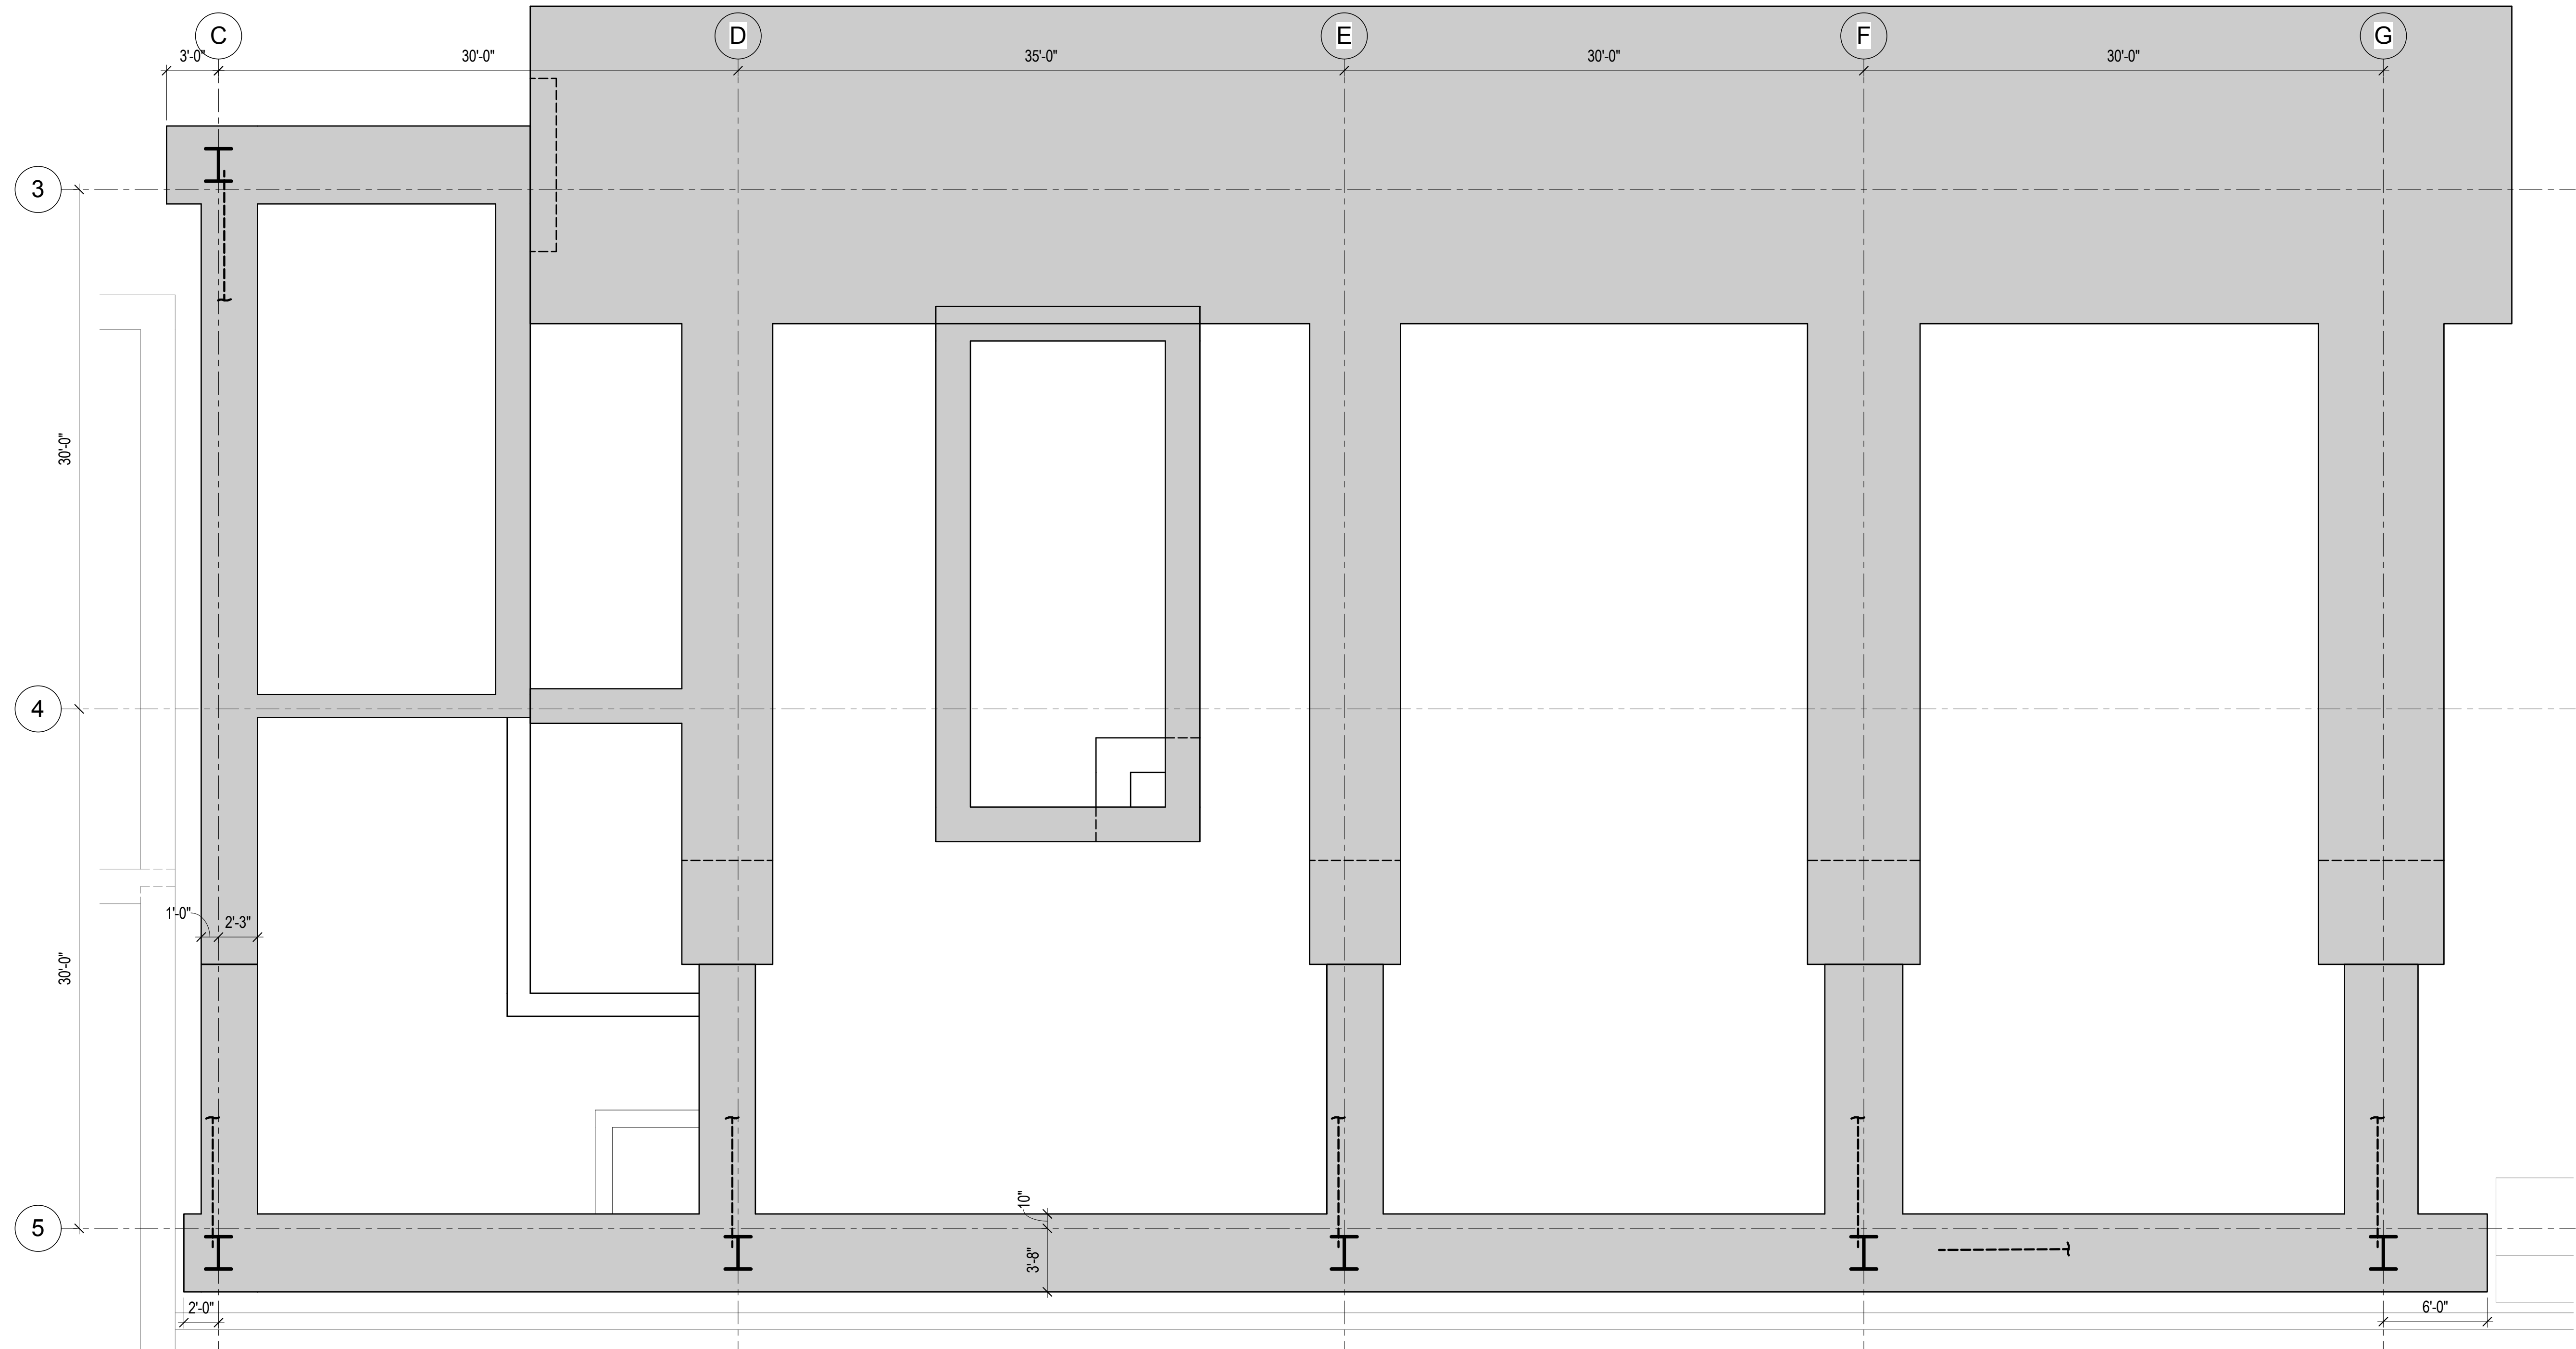


2 REINFORCING LAYOUT - LEVEL B2 TO LEVEL B1
3/16" = 1'-0"

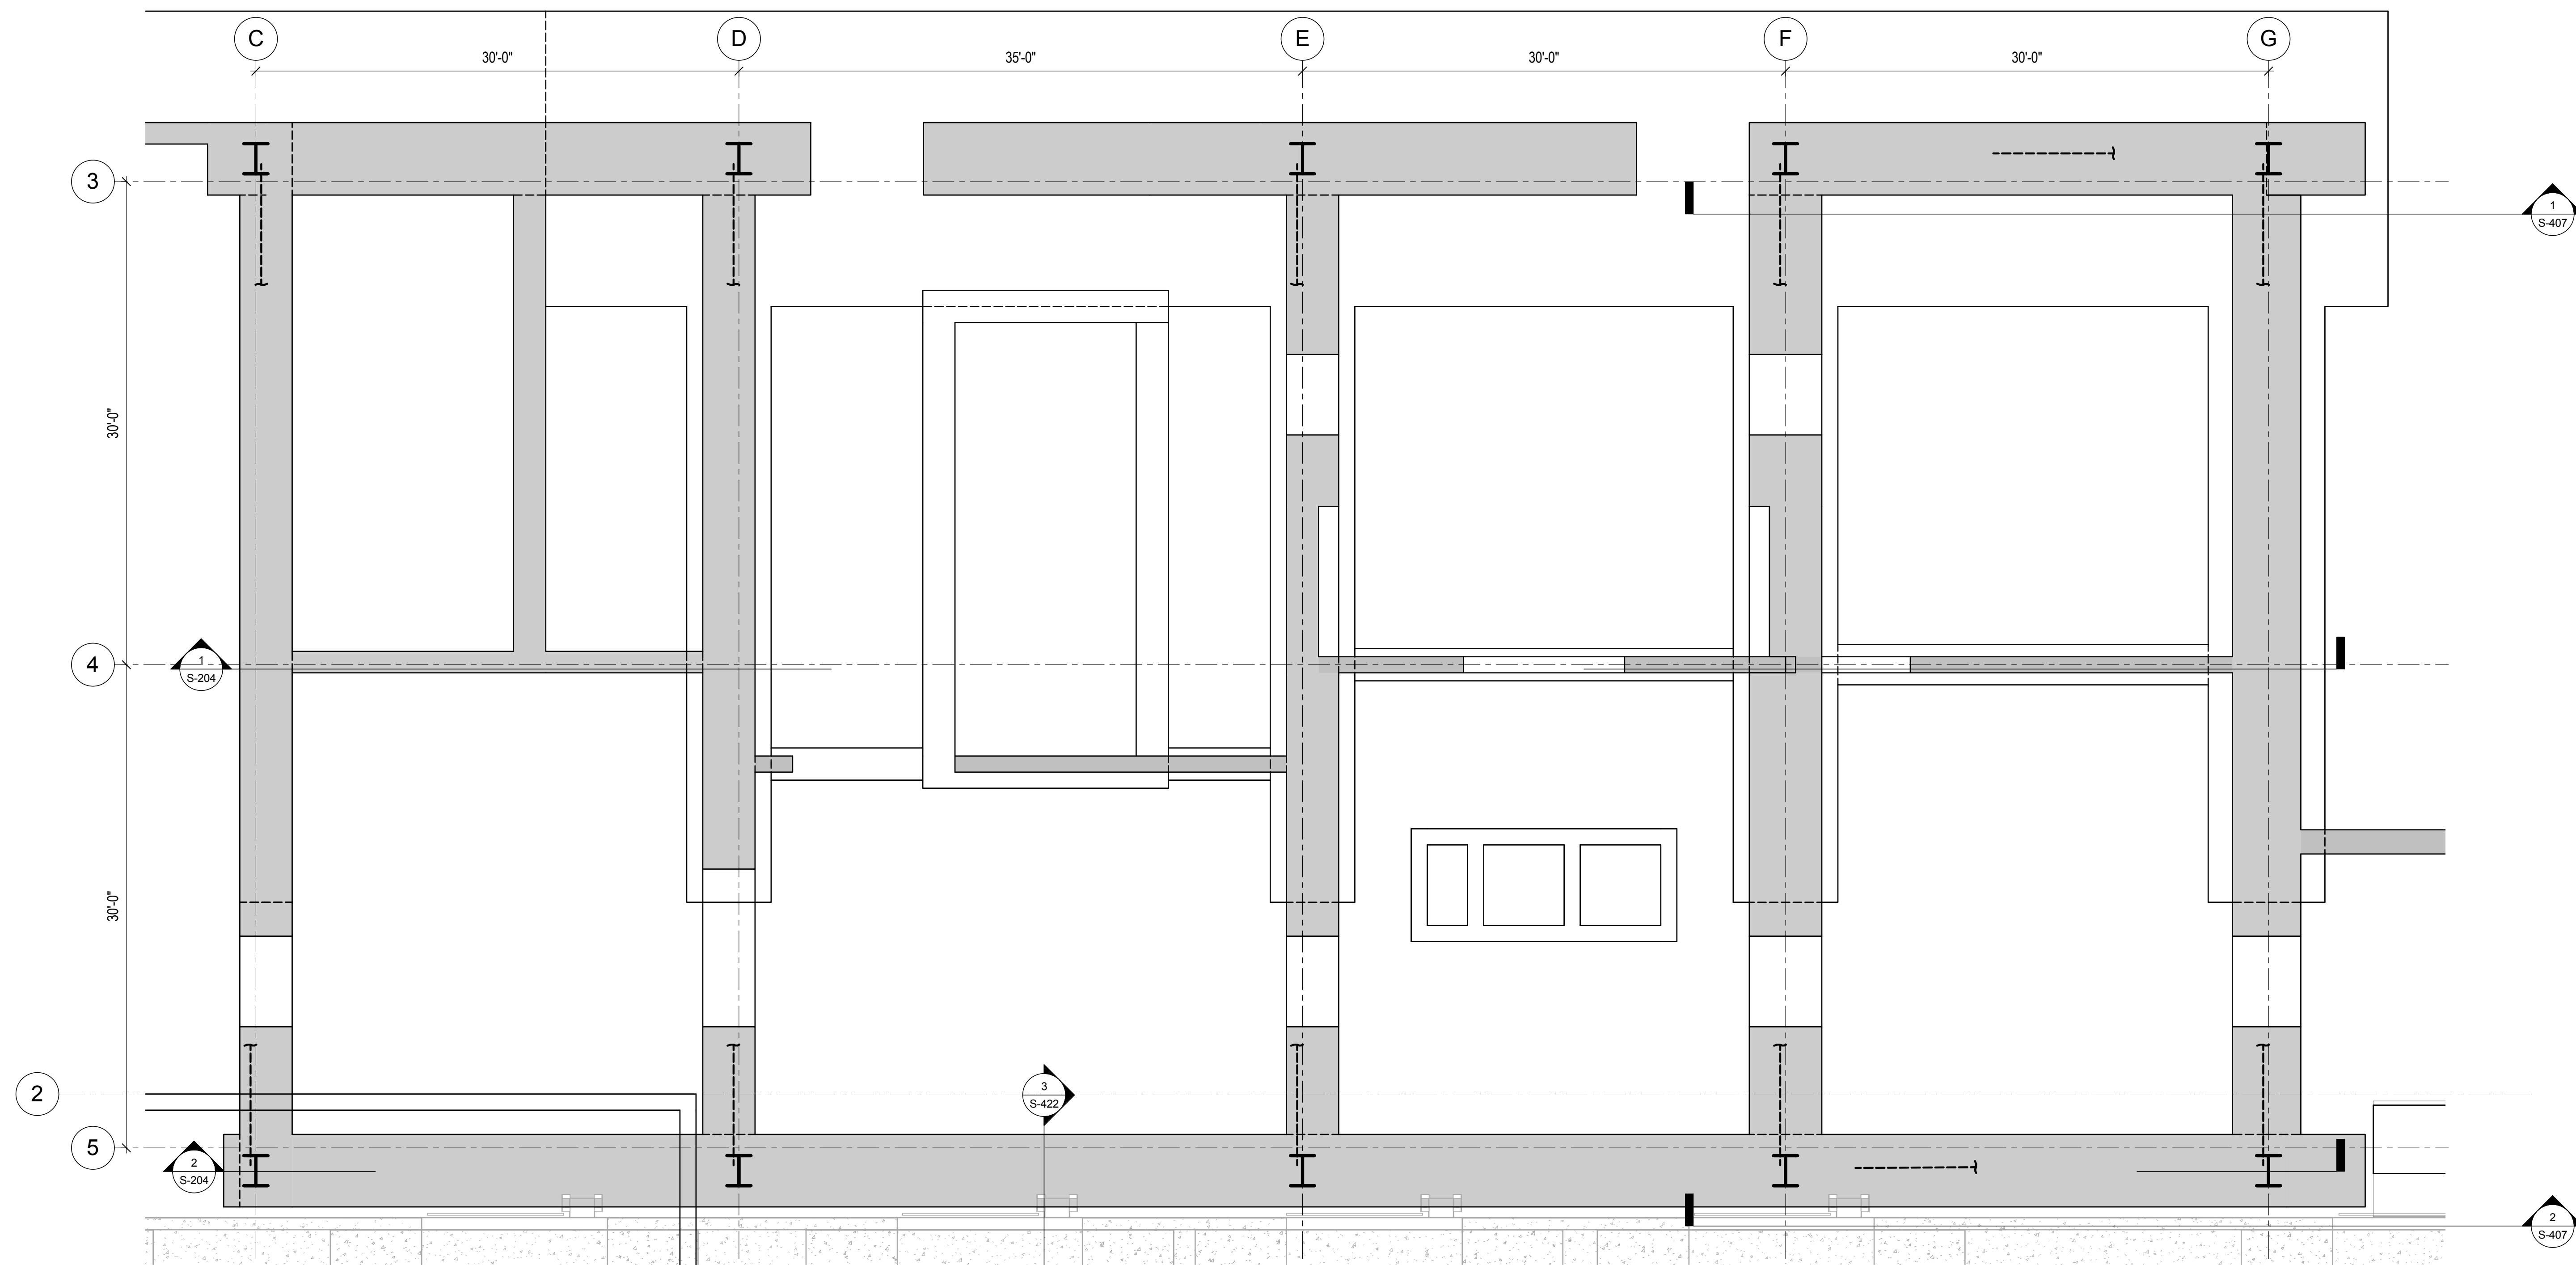

1 REINFORCEMENT LAYOUT - LEVEL B1 TO LEVEL B
3/16" = 1'-0"

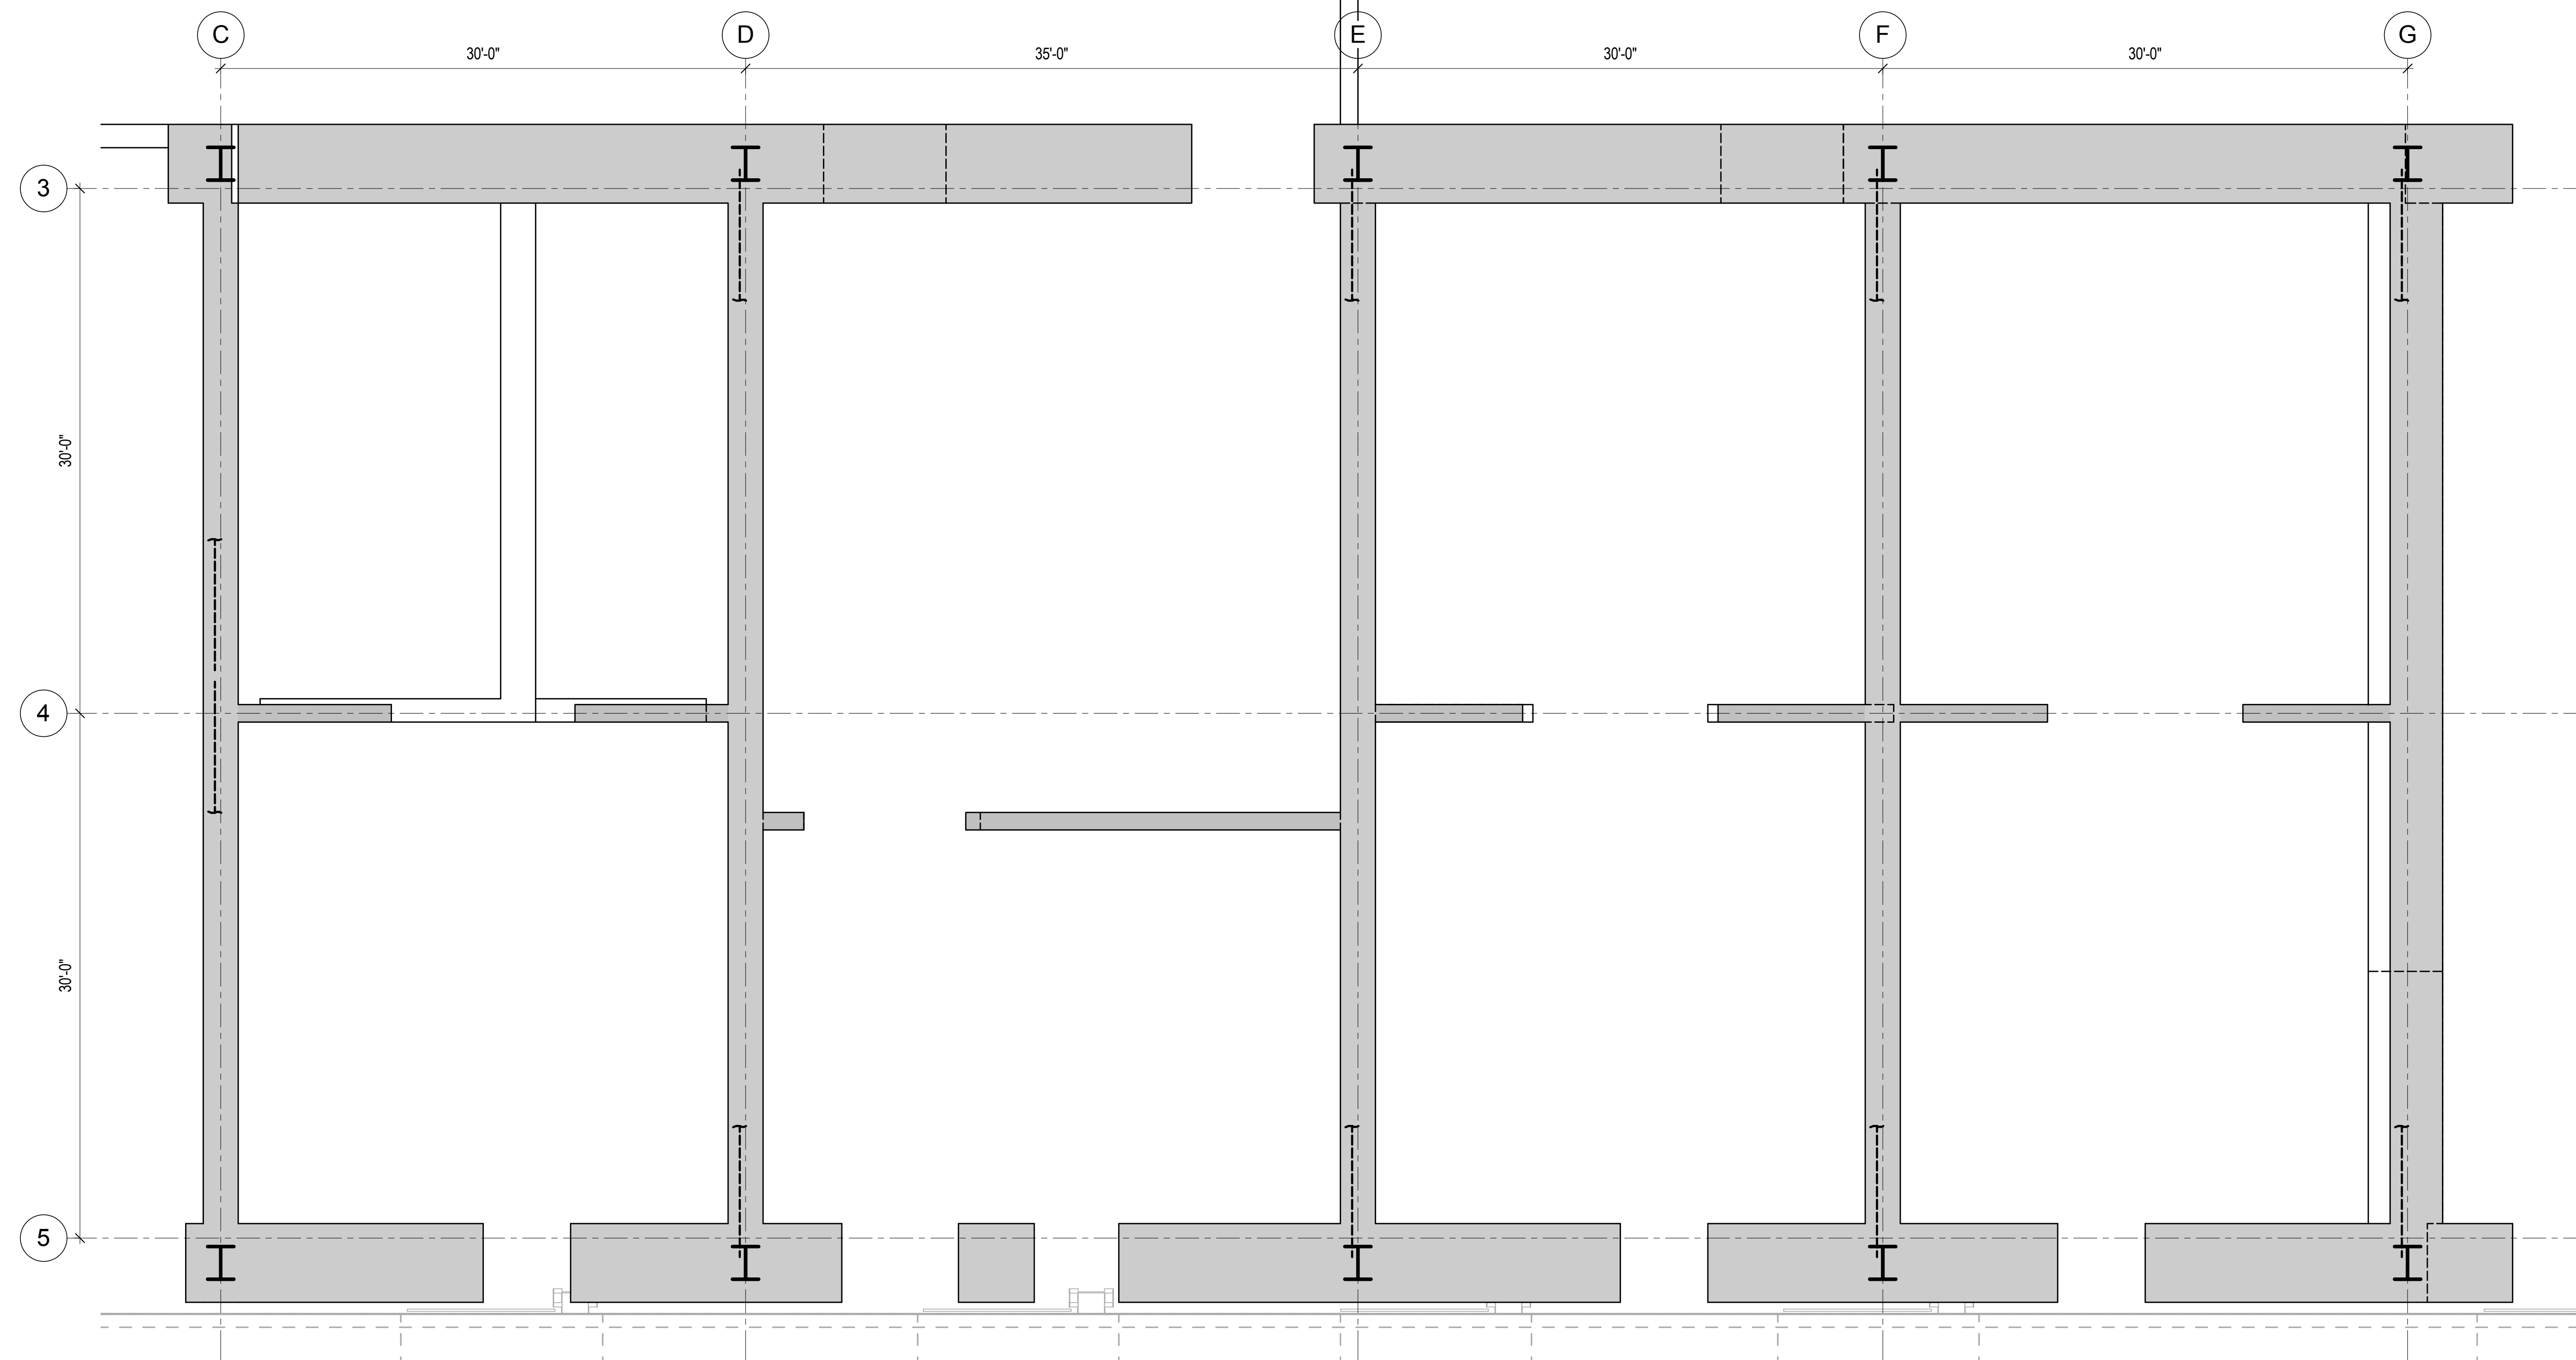

2 REINFORCEMENT LAYOUT - LEVEL B TO LEVEL 1
3/16" = 1'-0"

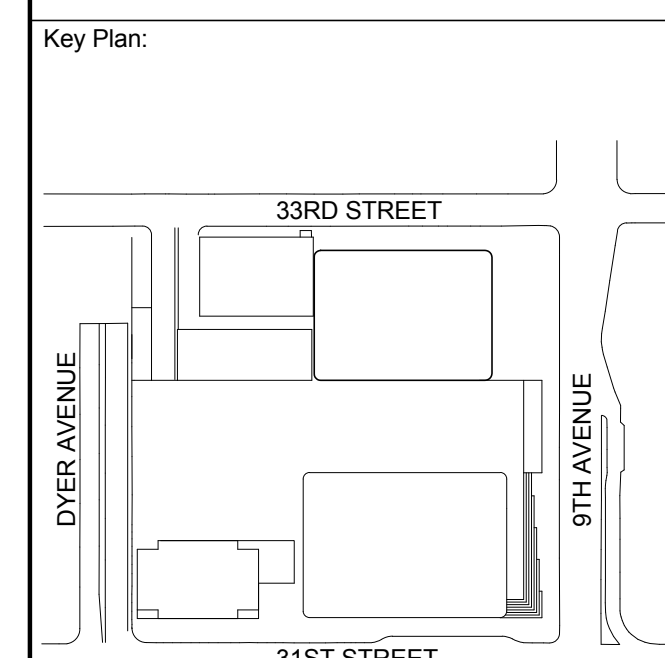

Seal & Signature:

PRELIMINARY
NOT FOR CONSTRUCTION

6	20 JUN 2014	ISSUED FOR FOUNDATION BID
5	20 JUN 2014	ISSUED FOR FOUNDATION PERMIT
4	20 DEC 2013	ISSUED FOR FOUNDATION PERMIT
3	15 NOV 2013	ISSUED FOR 30% PROGRESS PRICING
2	12 JUL 2013	ISSUED FOR 90% DESIGN DEVELOPMENT
1	19 MAR 2012	ISSUED FOR RECONCILIATION

No. Date Description

Sheet Name

**CORE WALL
REINFORCEMENT
LAYOUT**

Project No.: 211157

Date: 20 JUN 2014

Scale: 3/16" = 1'-0"

File No.: S-343

B-SCAN Sheet No.: S-343.00

Sheet No.: S-343

Page No.: 50 of 90



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Vibration Consultant

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65 Broadway, Suite 401, New York, NY 10006

Code Consultant


Code Consultants Professional Engineers PC
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Facade Maintenance Consultant

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166 Ames Street, Hackensack, NJ 07601

Wind Tunnel Consultant

Rowan Williams Davies & Irwin Inc.
650 Woodlawn Road West, Guelph
Ontario, Canada N1K 1B6

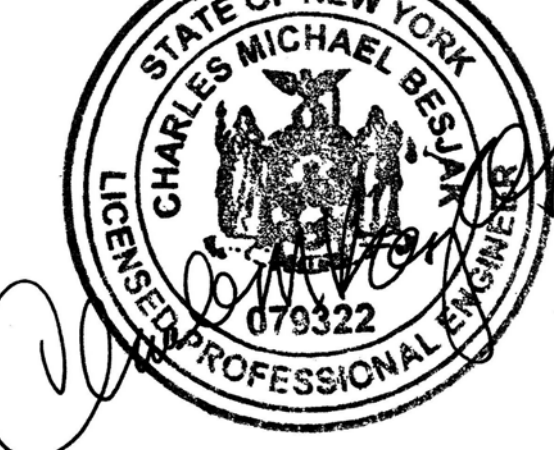

Key Plan:



Seal & Signature:


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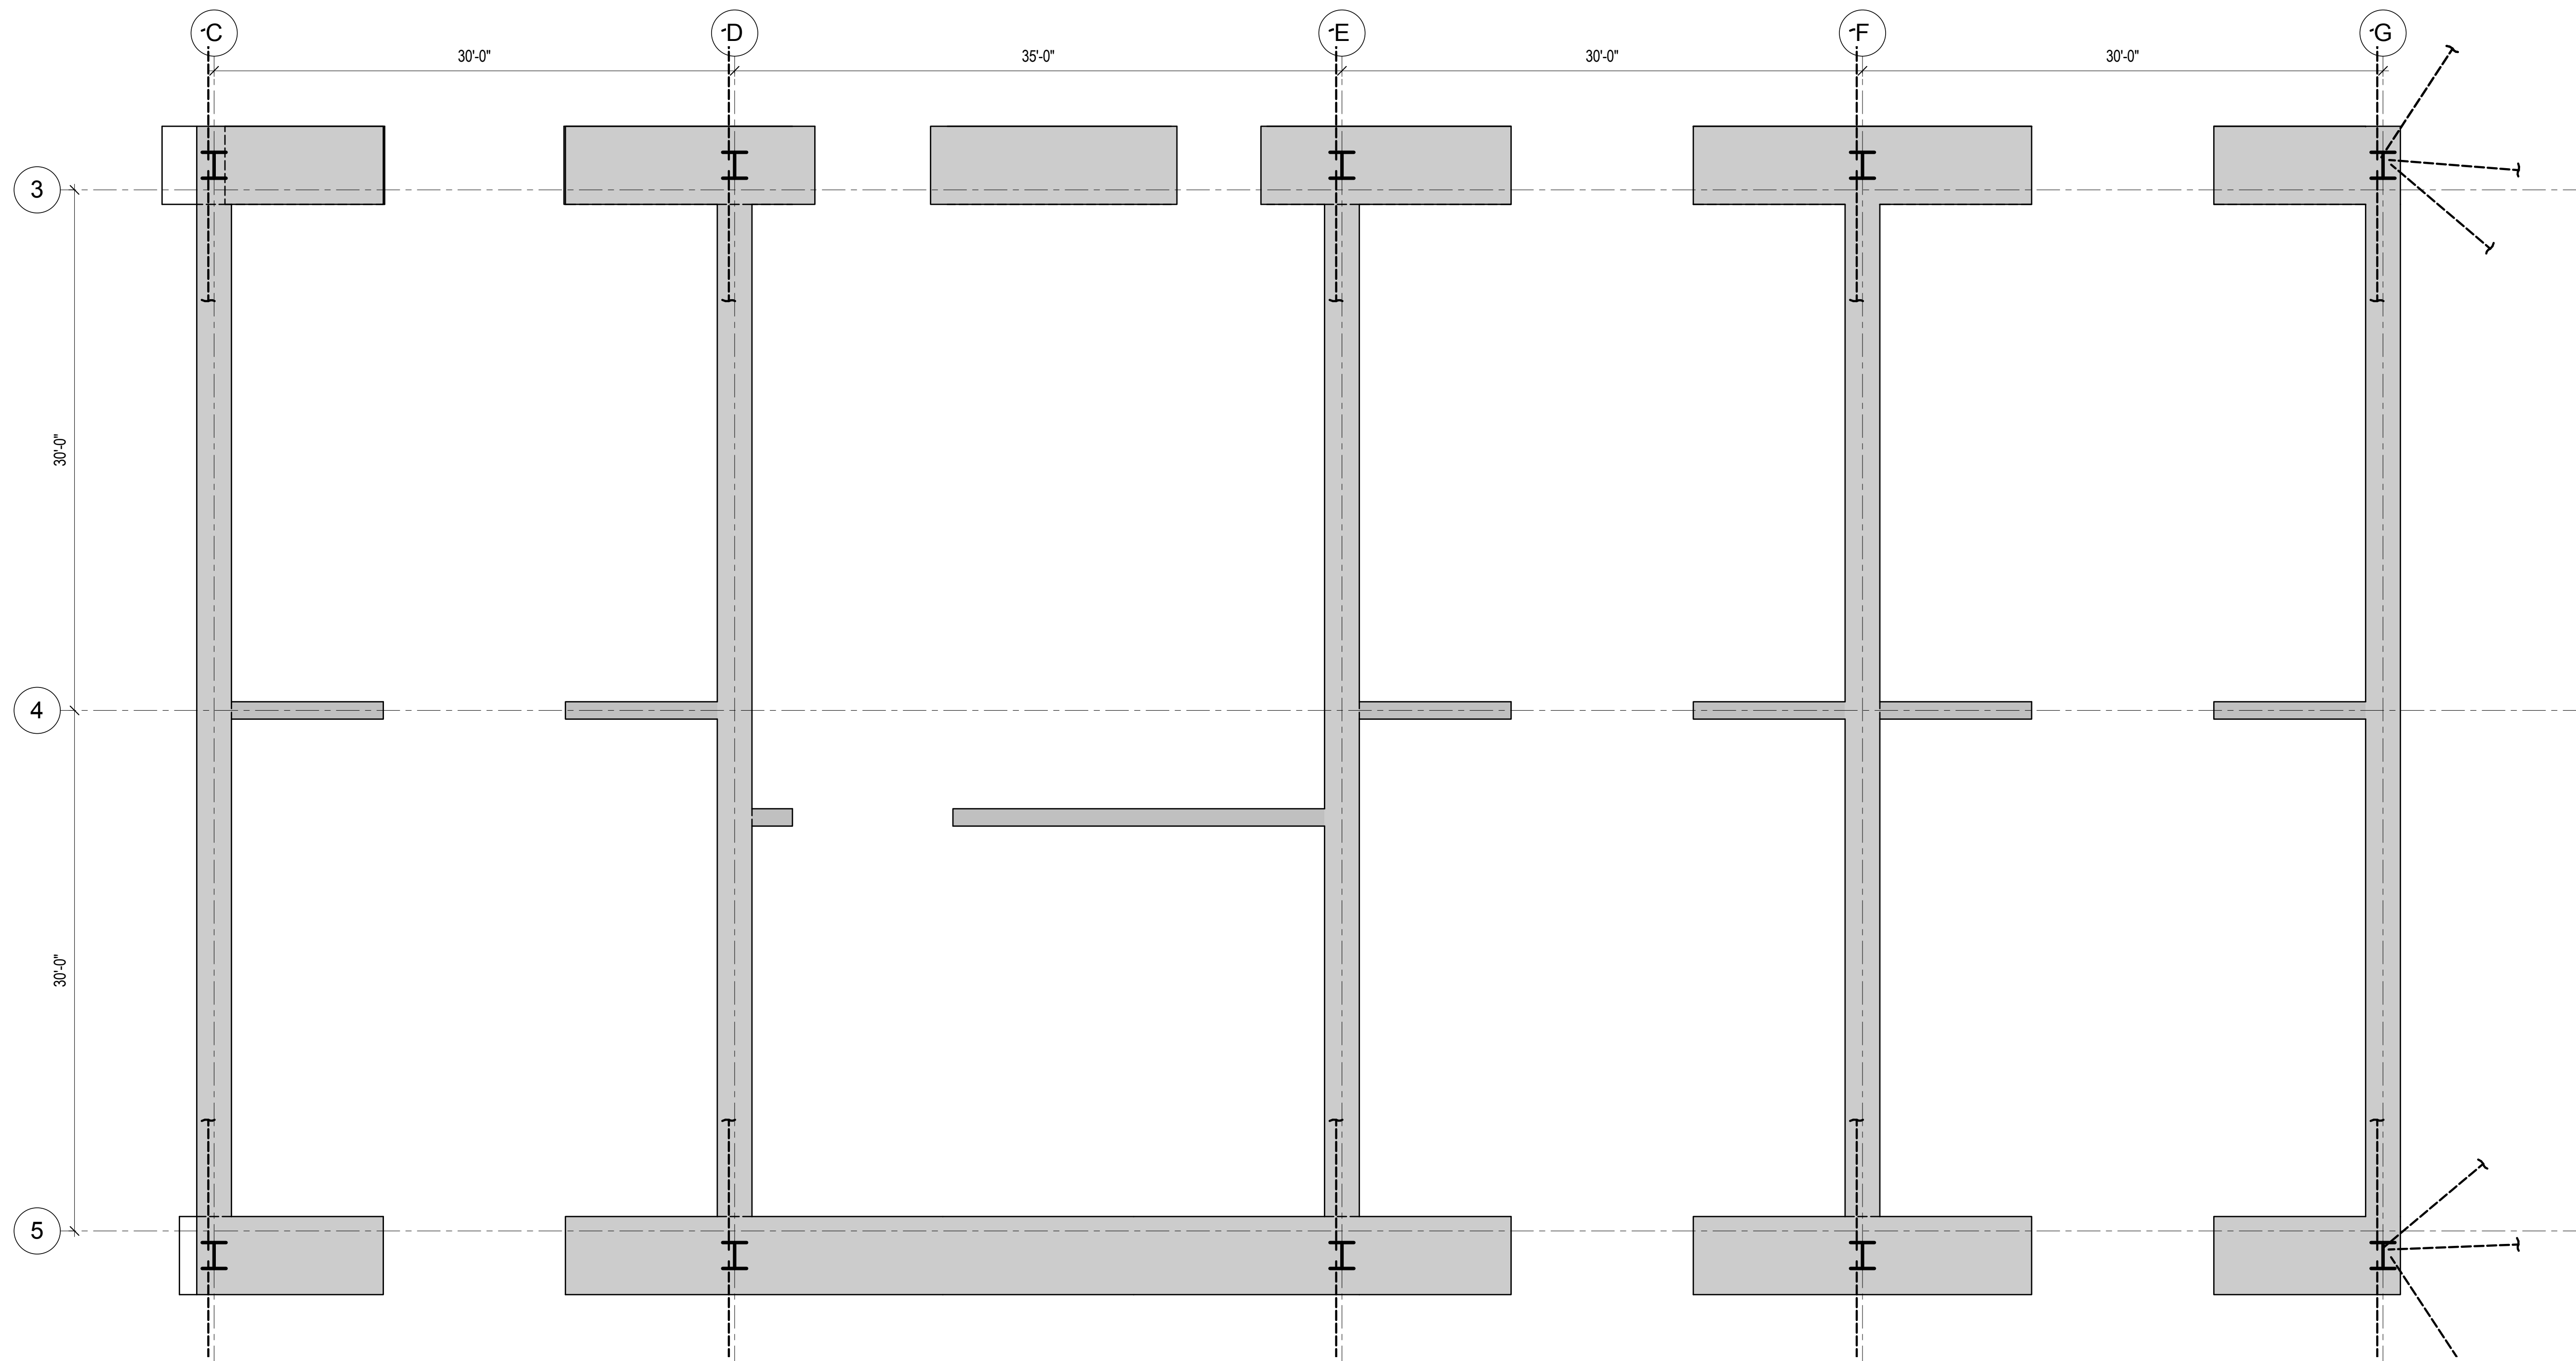
No. Date Description
Sheet Name

CORE WALL
REINFORCEMENT
LAYOUT

Project No.: 211157	B-SCAN Sheet No.: S-345.00
Date: 20 JUN 2014	Sheet No.: S-345
Scale: 3/16" = 1'-0"	Page No.: 52 of 90
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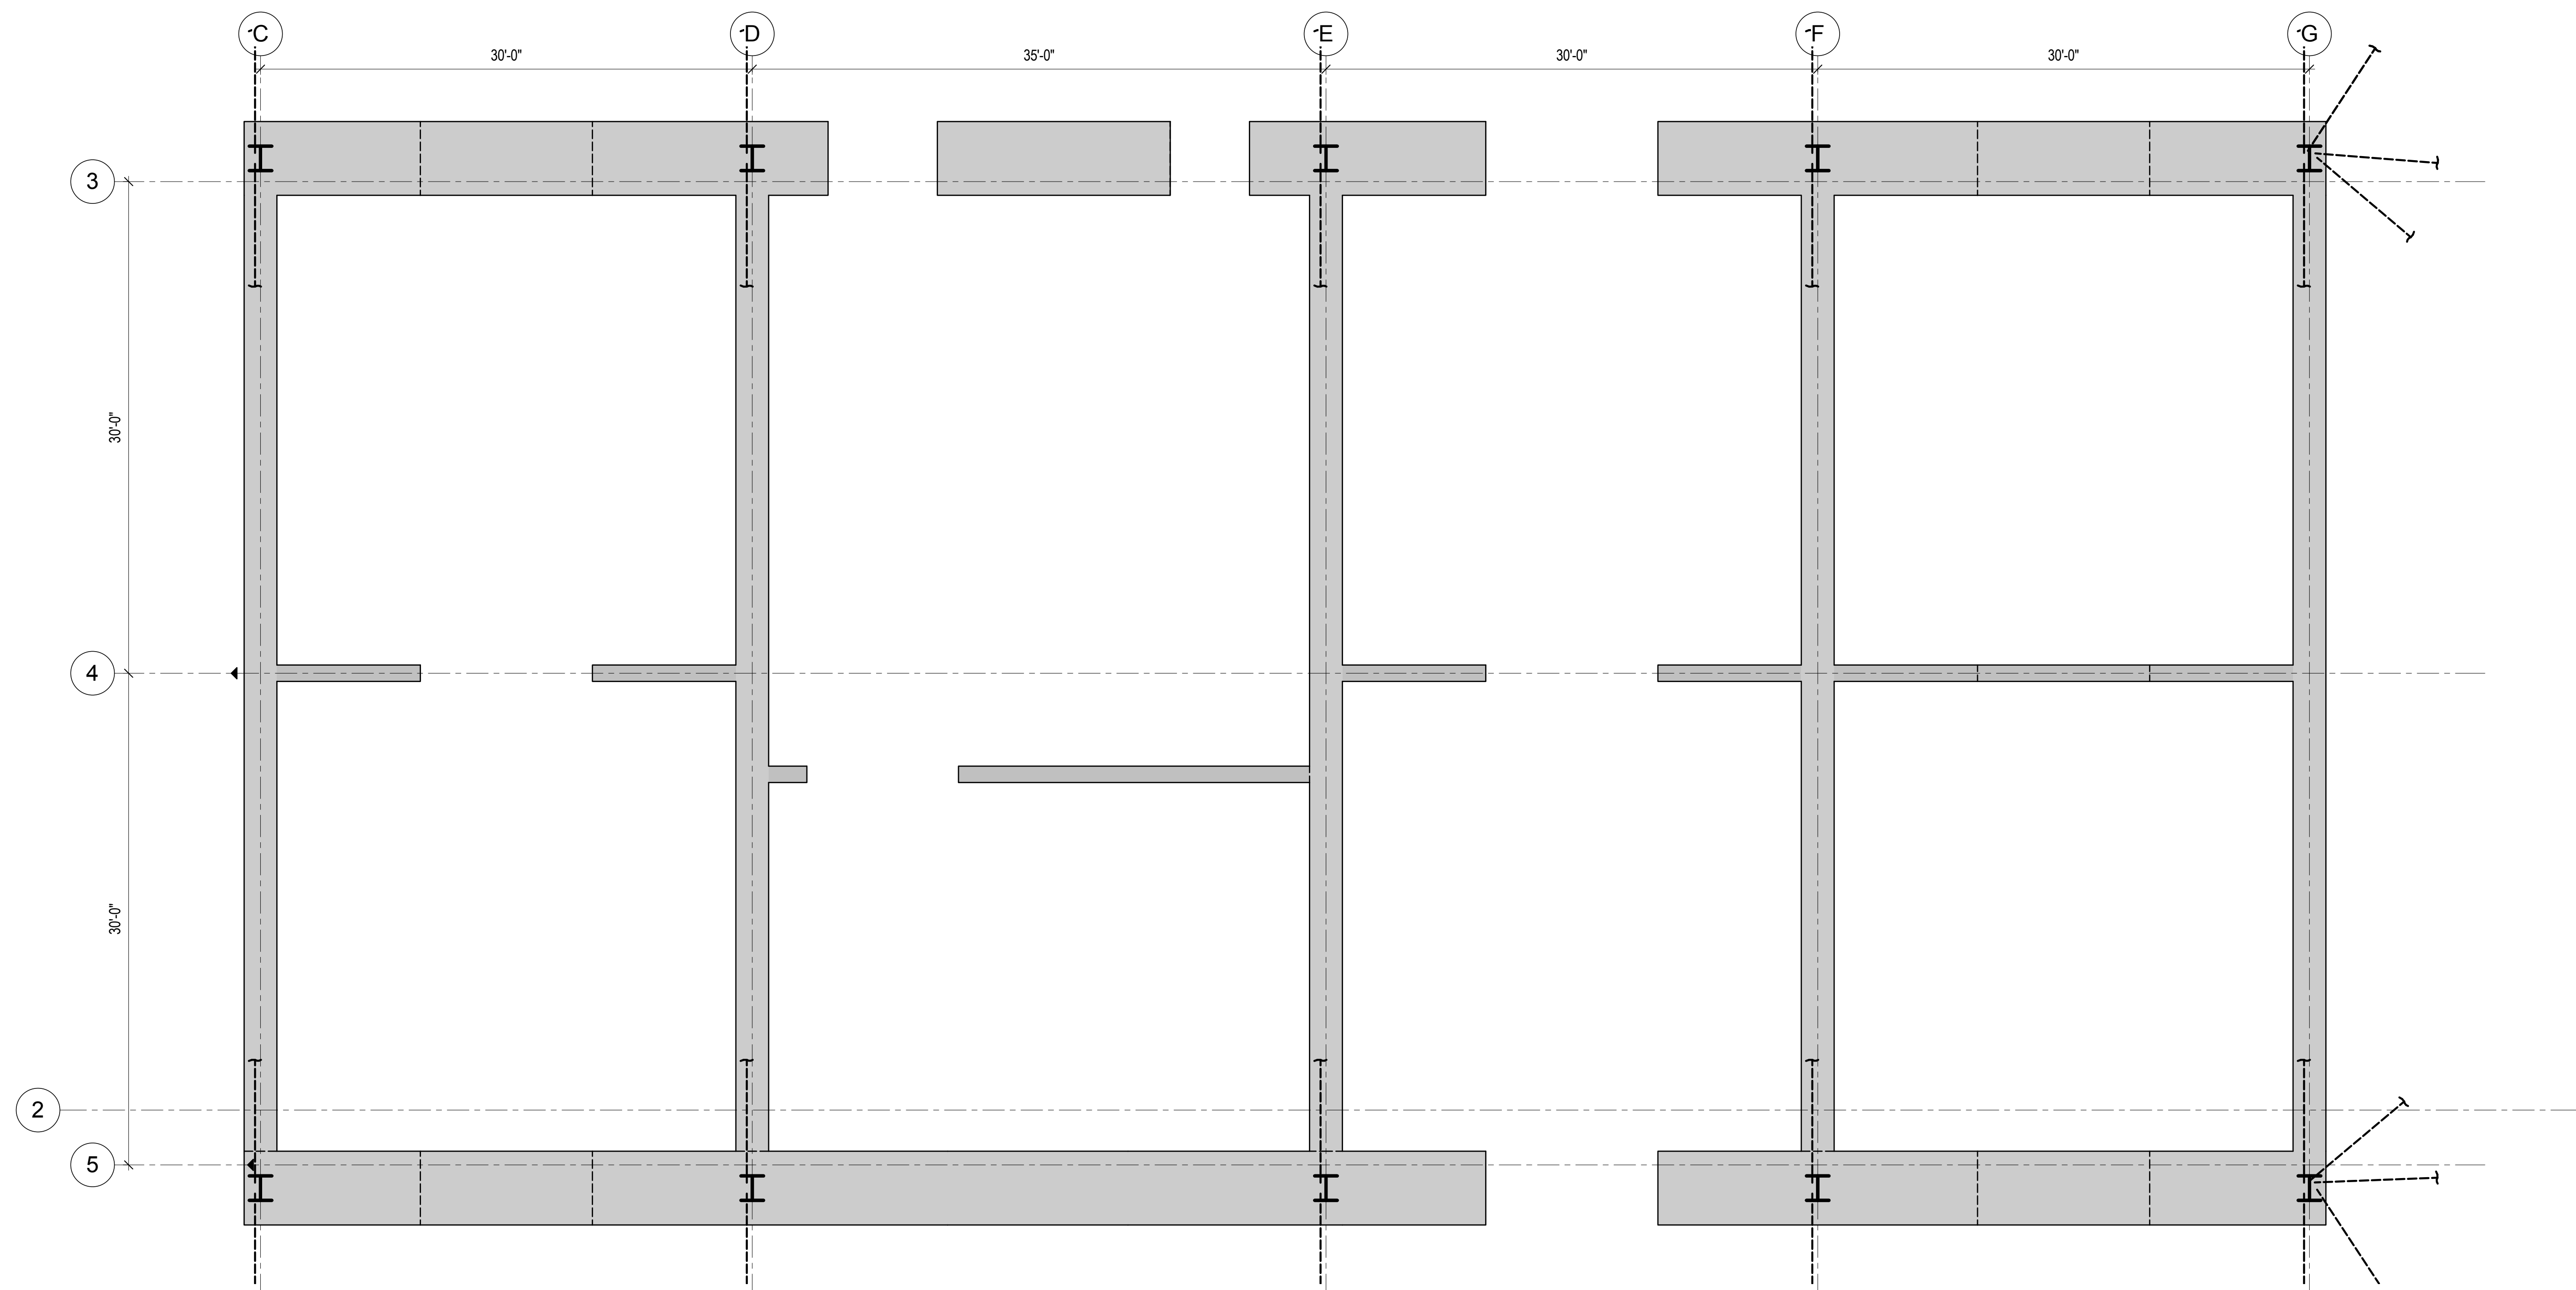
1 REINFORCEMENT LAYOUT - LEVEL 3 TO LEVEL 4
3/16" = 1'-0"



2 REINFORCEMENT LAYOUT - LEVEL 4 TO LEVEL 5
3/16" = 1'-0"

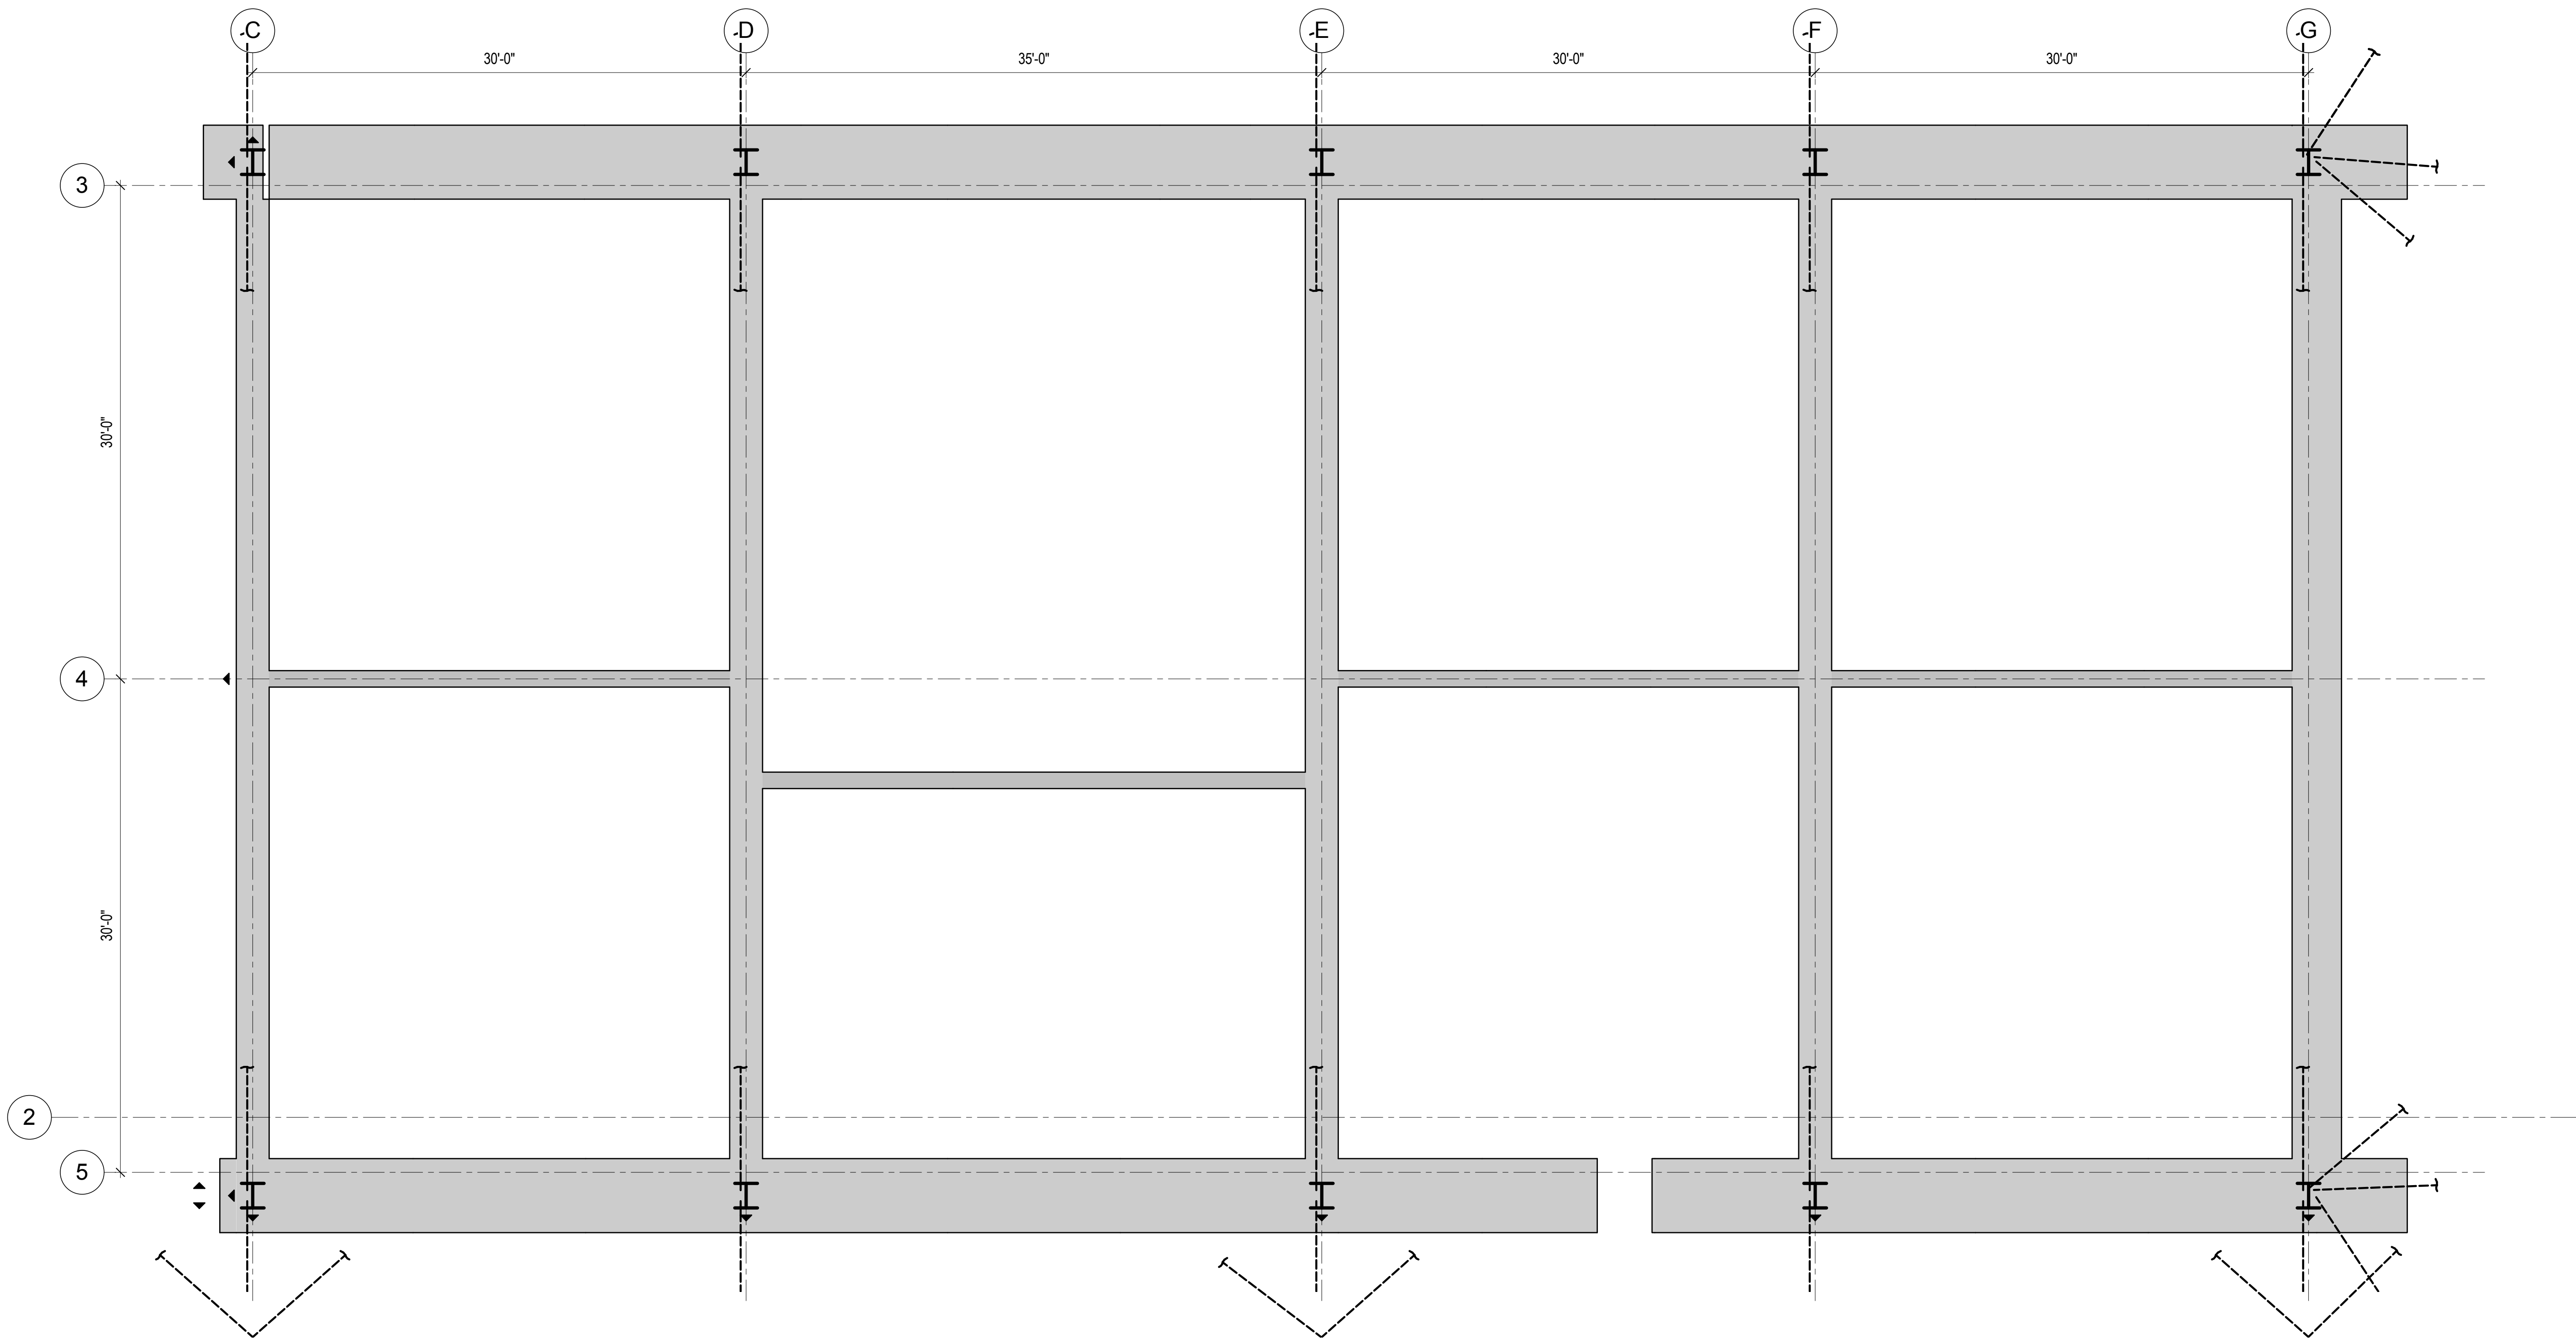
REINFORCING LAYOUT DESIGN IN-
PROGRESS AND WILL BE SHOWN ON
FUTURE DRAWING ISSUES.

REINFORCING LAYOUT DESIGN IN-
PROGRESS AND WILL BE SHOWN ON
FUTURE DRAWING ISSUES.



REINFORCING LAYOUT DESIGN IN-PROGRESS AND WILL BE SHOWN ON FUTURE DRAWING ISSUES.

1 REINFORCEMENT LAYOUT - LEVEL 5 TO LEVEL 6
3/16" = 1'-0"

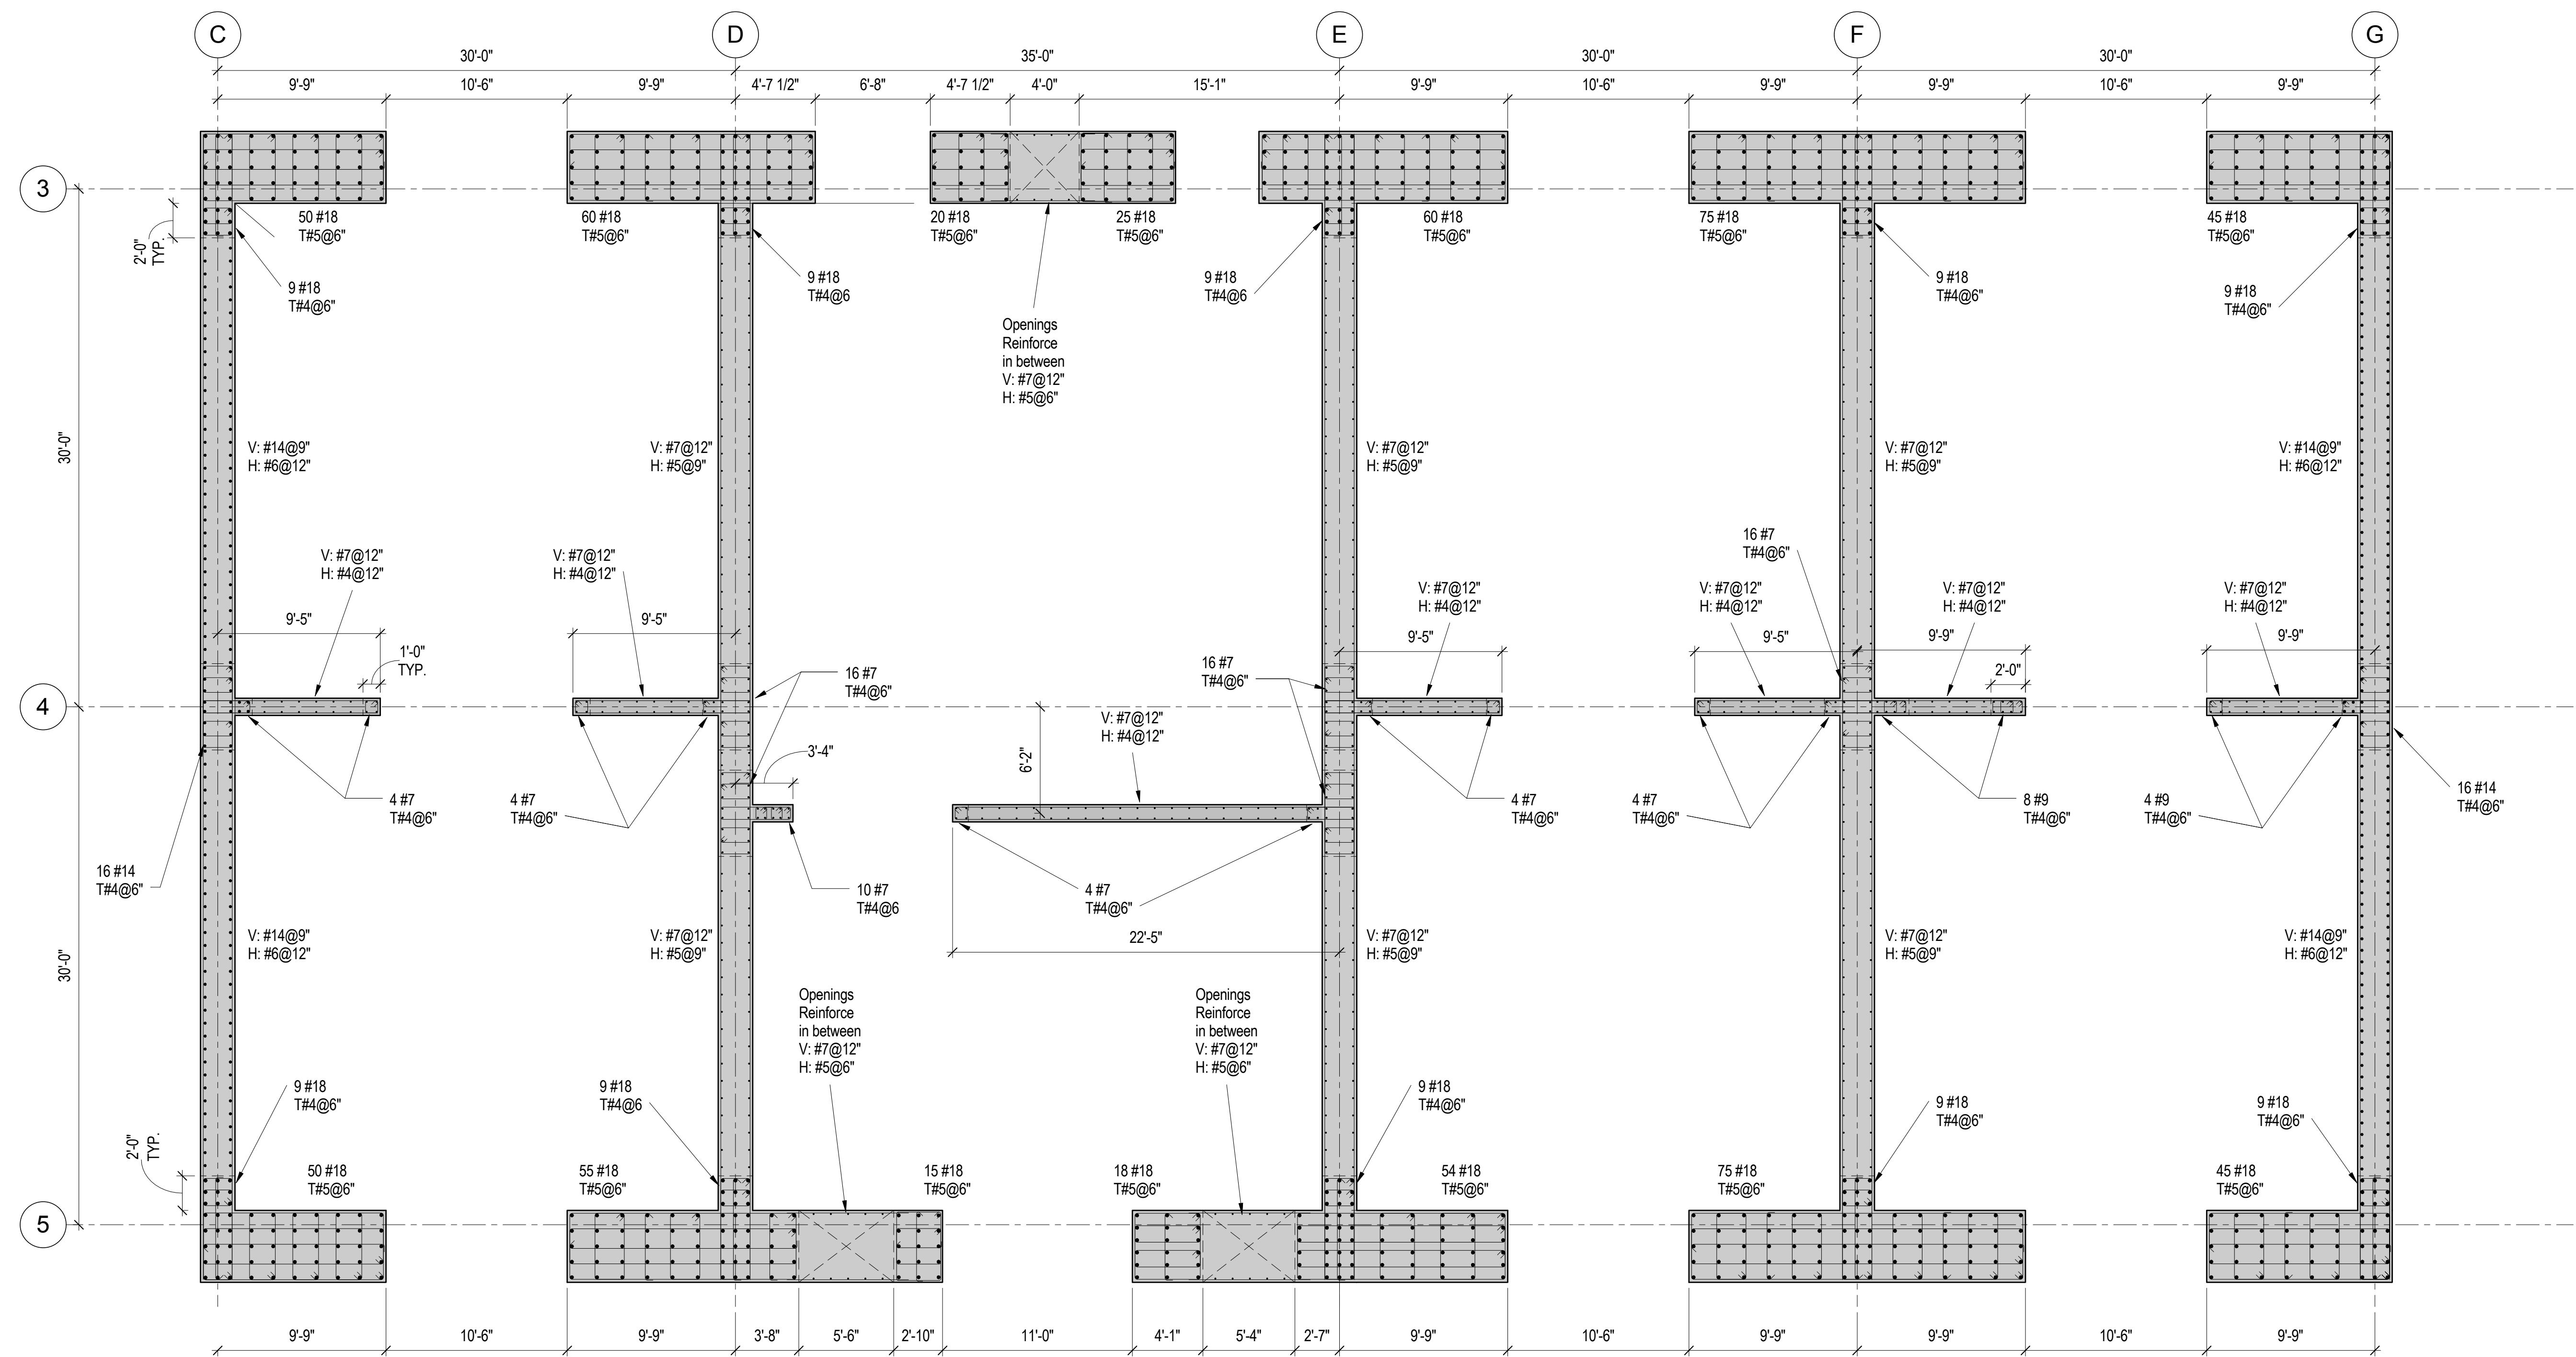

2 REINFORCEMENT LAYOUT - LEVEL 6 TO LEVEL 11
3/16" = 1'-0"

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Brookfield
Brookfield Place
250 Vesey Street, 15th Floor, New York, NY 10021

Architecture/Structural Engineering
SOM
Skidmore, Owings & Merrill LLP
14 Wall Street, New York, NY 10005

Civil Engineering
Philip Habib & Associates
102 Madison Avenue #11, New York, NY 10016

MEP Engineering
Jaros Baum & Bolles
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Vertical Transportation
Edgett Williams Consulting Group, Inc.
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Sustainable Design
Viridian Energy & Environmental
50 Washington Street, Newark, CT 06854

Geo-Technical Engineering
Mueser Rutledge Consulting Engineers
14 Penn Plaza, 225 W, 34th Street #610,
New York, NY 10122

Landscape Consultant
Field Operations
475 10th Avenue, New York, NY 10018

Security Consultant
Ducibella, Ventor & Santore
250 State Street #F1, North Haven, CT 06473

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Weidinger Associates, Inc.
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Acoustical Consultant
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404 Fifth Avenue #8, New York, NY 10016

Vibration Consultant
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65 Broadway, Suite 401, New York, NY 10006

Code Consultant
Code Consultants Professional Engineers PC
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Facade Maintenance Consultant
Entek Engineering LLC
166 Ames Street, Hackensack, NJ 07601

Wind Tunnel Consultant
Rowan Williams Davies & Irwin Inc.
680 Woodlawn Road West, Guelph
Ontario, Canada N1K 1B8

Key Plan:

Seal & Signature:

PRELIMINARY
NOT FOR CONSTRUCTION

No.	Date	Description
6	20 JUN 2014	ISSUED FOR FOUNDATION BID
5	20 JUN 2014	ISSUED FOR FOUNDATION PERMIT
4	20 DEC 2013	ISSUED FOR FOUNDATION PERMIT
3	15 NOV 2013	ISSUED FOR 50% PROGRESS PRICING
2	12 JUL 2013	ISSUED FOR 90% DESIGN DEVELOPMENT
1	16 MAR 2012	ISSUED FOR RECONCILIATION

Sheet Name: CORE WALL REINFORCEMENT LAYOUT

Project No.:	B-SCAN Sheet No.:
211157	S-346.00

Date:	Sheet No.:
20 JUN 2014	S-346

Scale:	Page No.:
3/16" = 1'-0"	53 of 90

File No.: 3-346



MANHATTAN WEST:
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Security Consultant
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Blast Consultant
Weidinger Associates, Inc.
40 Wall Street, New York, NY 10005


Acoustical Consultant
Cerami & Associates
404 Fifth Avenue #8, New York, NY 10016

Vibration Consultant
Wilson, Uhrig & Associates, Inc.
65 Broadway, Suite 401, New York, NY 10006


Code Consultant
Code Consultants Professional Engineers PC
215 West 40th Street, 15th Floor, New York, NY 10018

Facade Maintenance Consultant
Entek Engineering LLC
166 Ames Street, Hackensack, NJ 07601

Wind Tunnel Consultant
Rowan Williams Davies & Irwin Inc.
650 Woodlawn Road West, Guelph
Ontario, Canada N1K 1B6

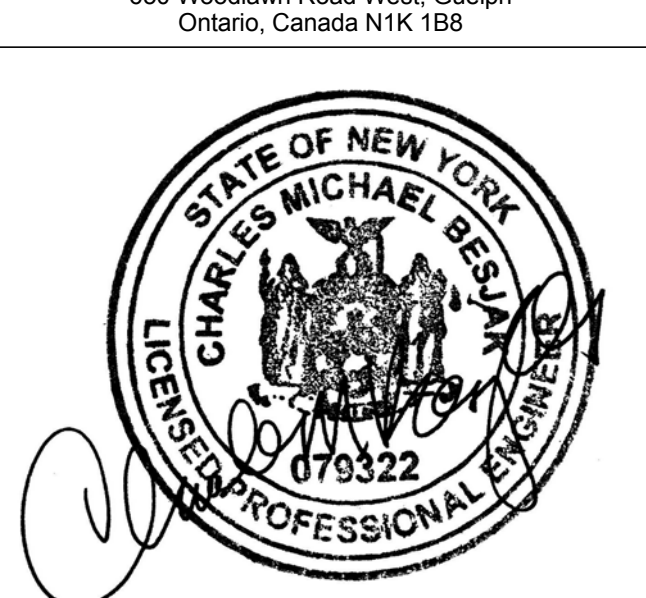

Key Plan:

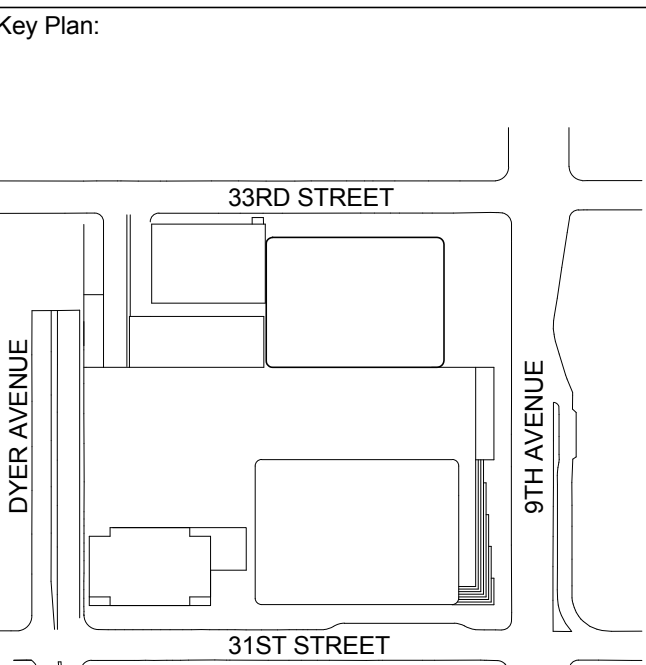


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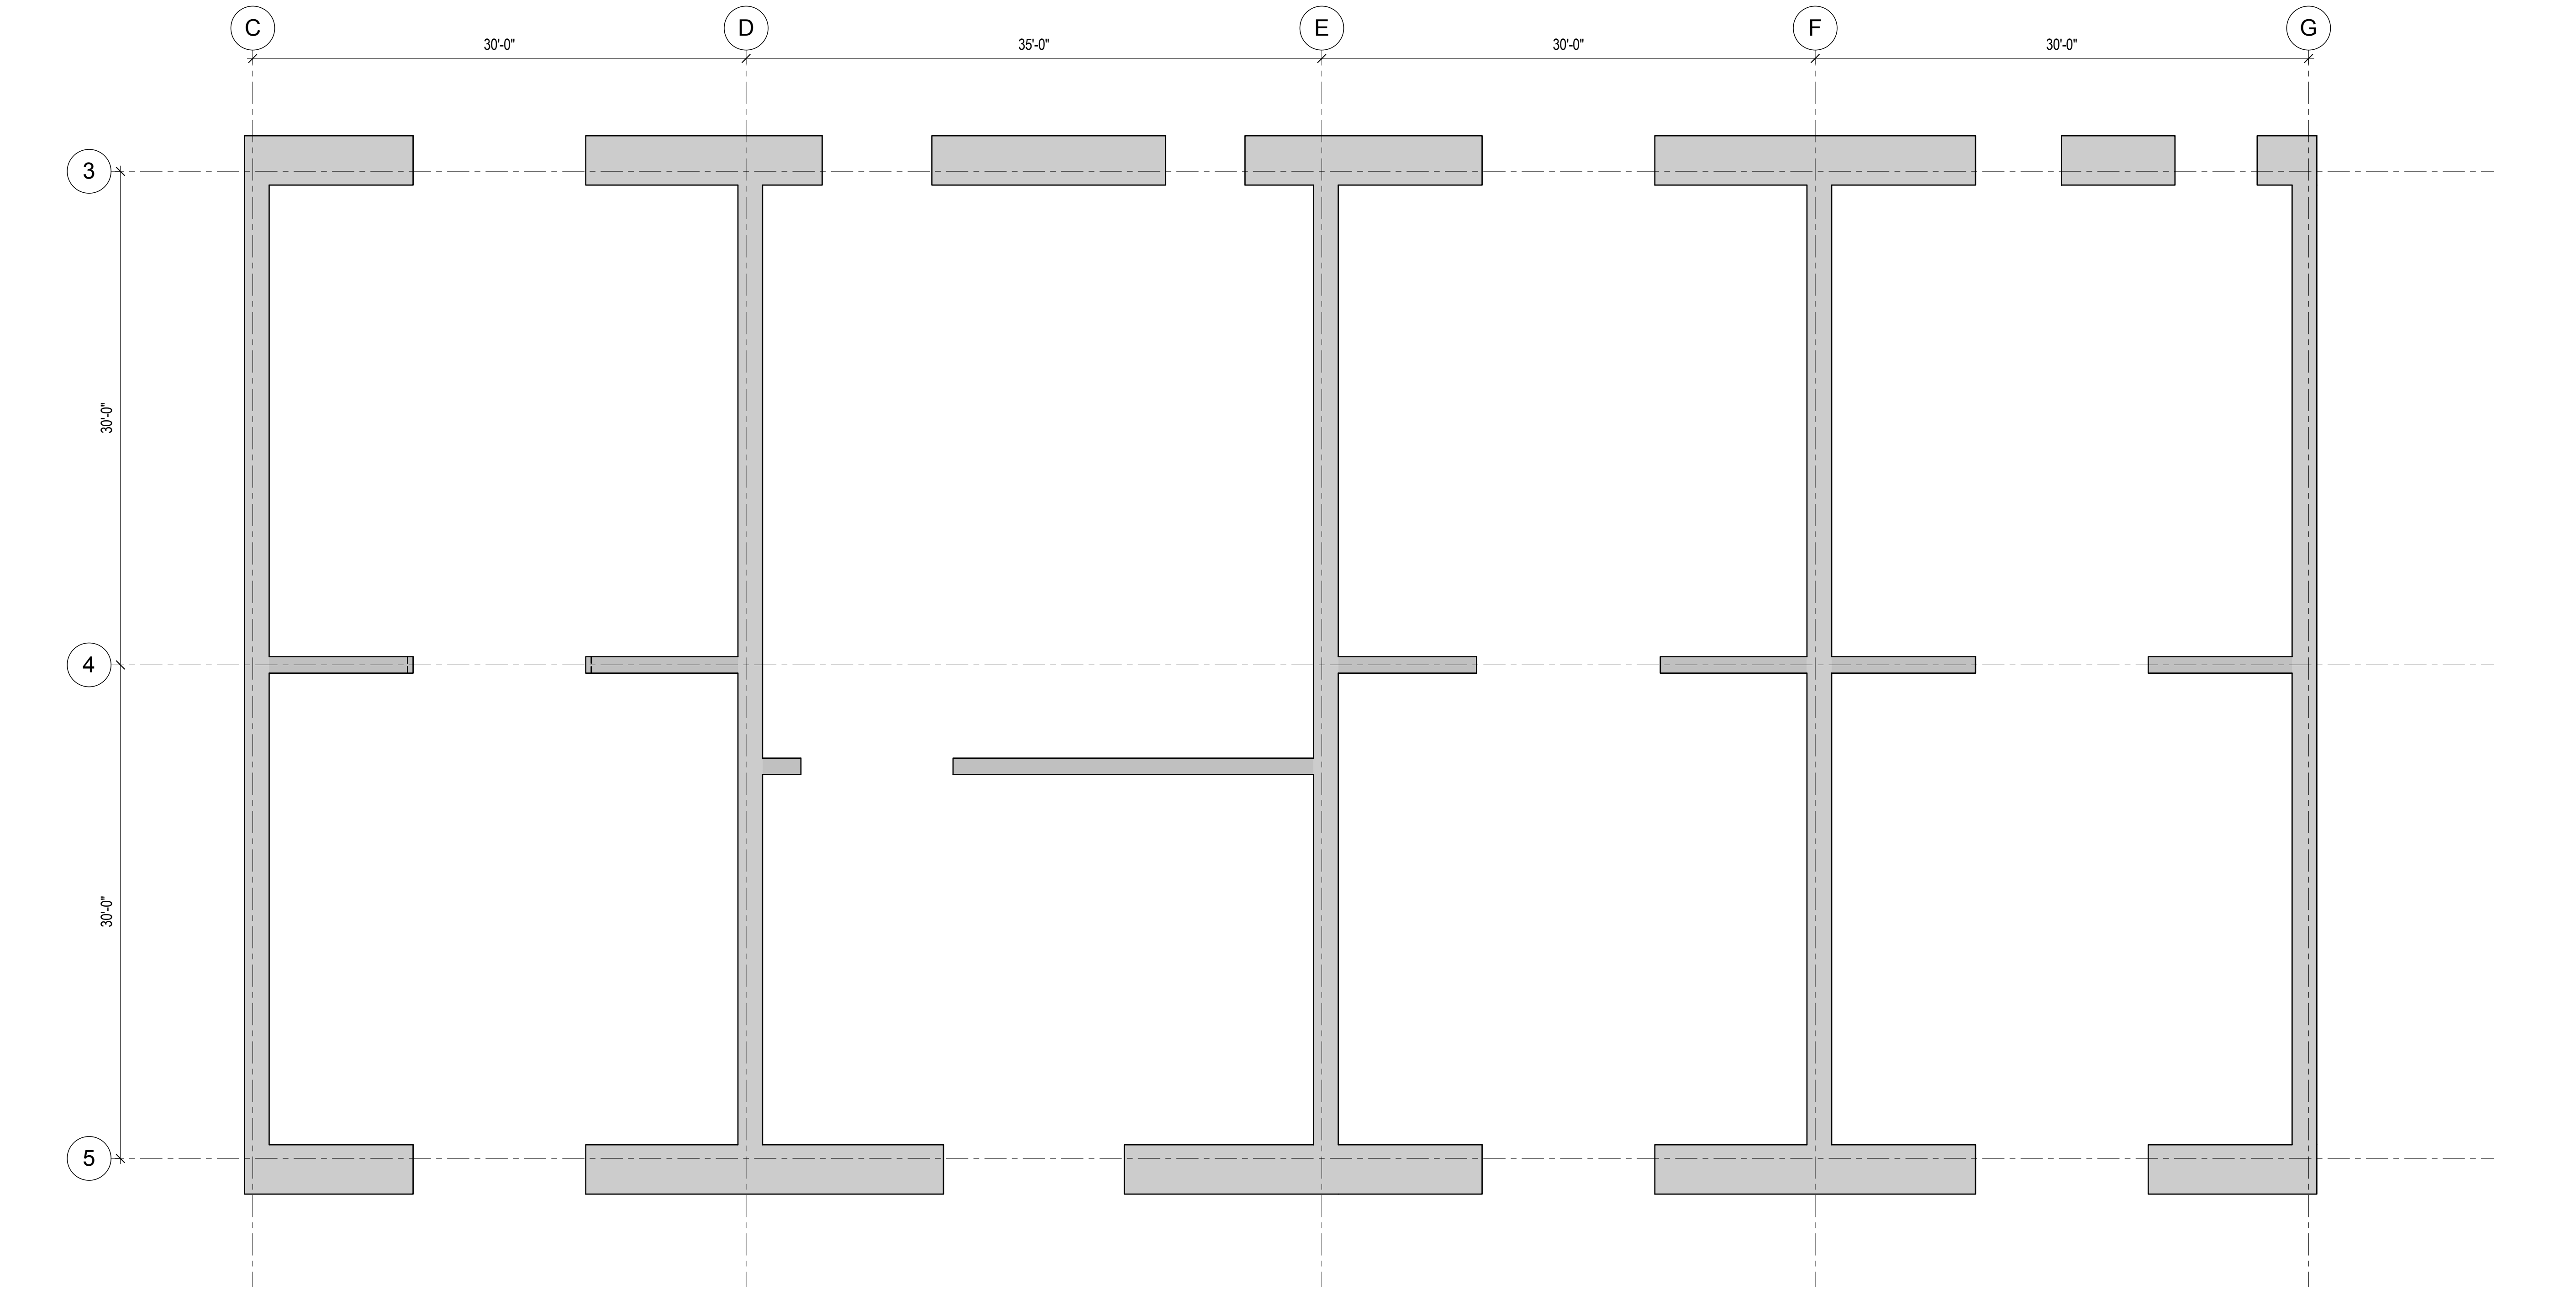
No.	Date	Description
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1	19 MAR 2012	ISSUED FOR RECONCILIATION

Project No.: 211157
Date: 20 JUN 2014
Scale: 3/16" = 1'-0"


B-SCAN Sheet No.: S-348.00
Sheet No.: S-348
Page No.: 55 of 90




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3/16" = 1'-0"

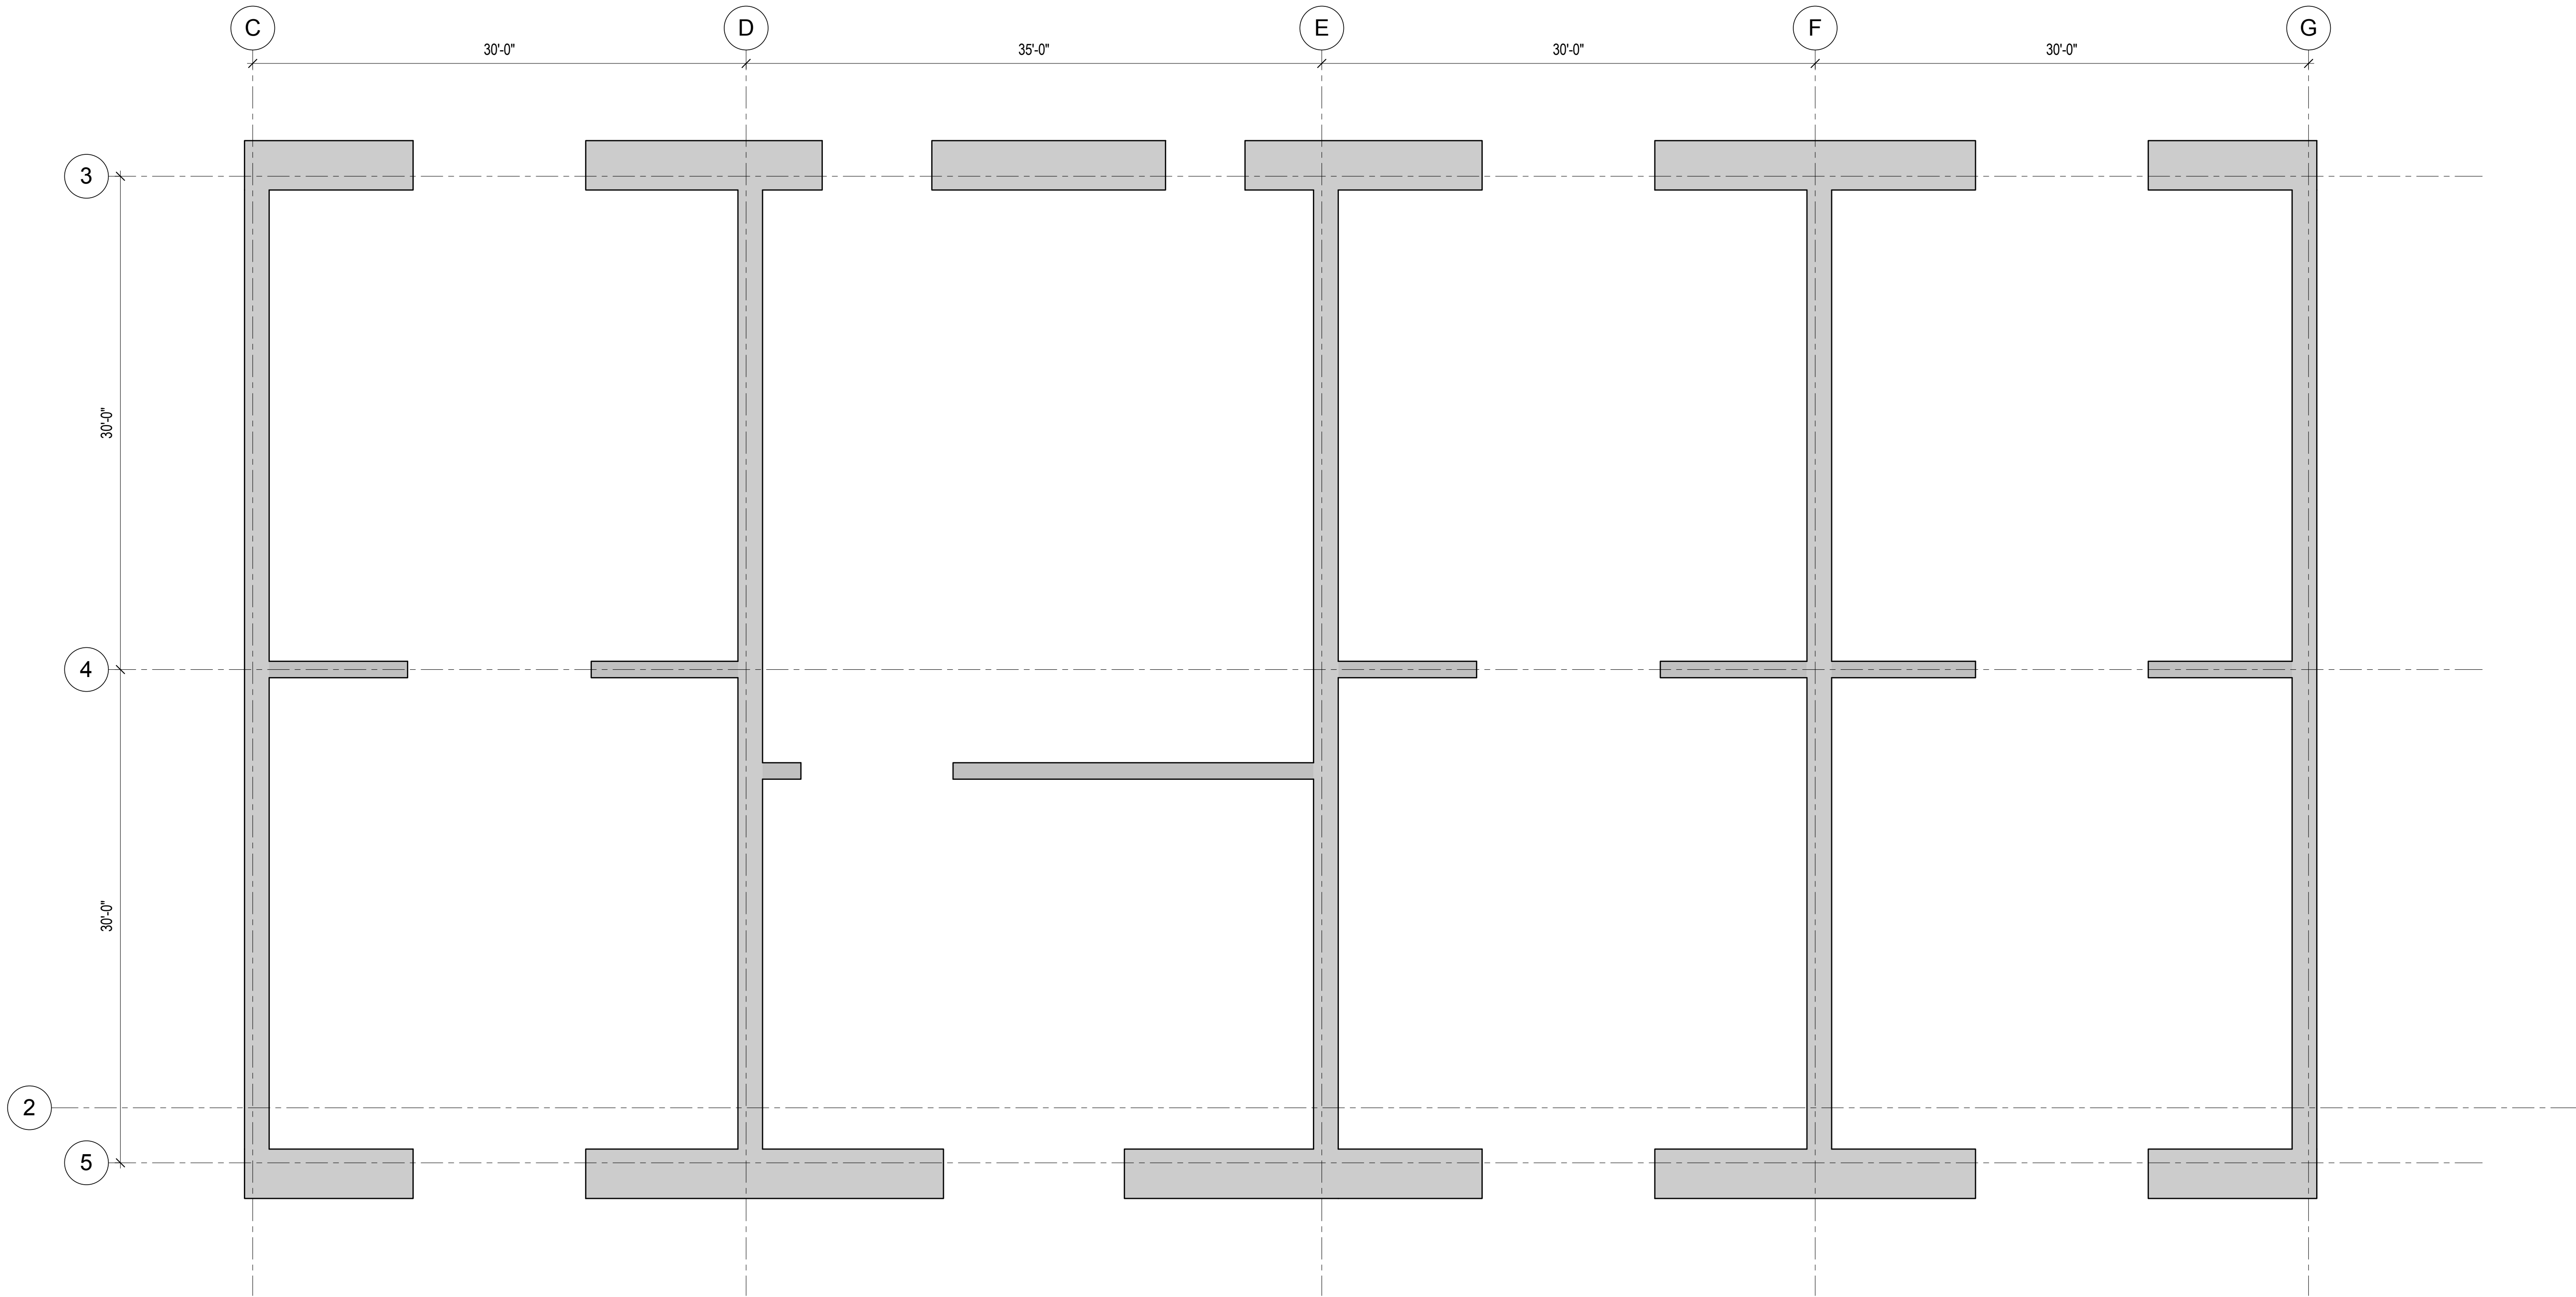

2 REINFORCEMENT LAYOUT - LEVEL 28 TO LEVEL 31
3/16" = 1'-0"

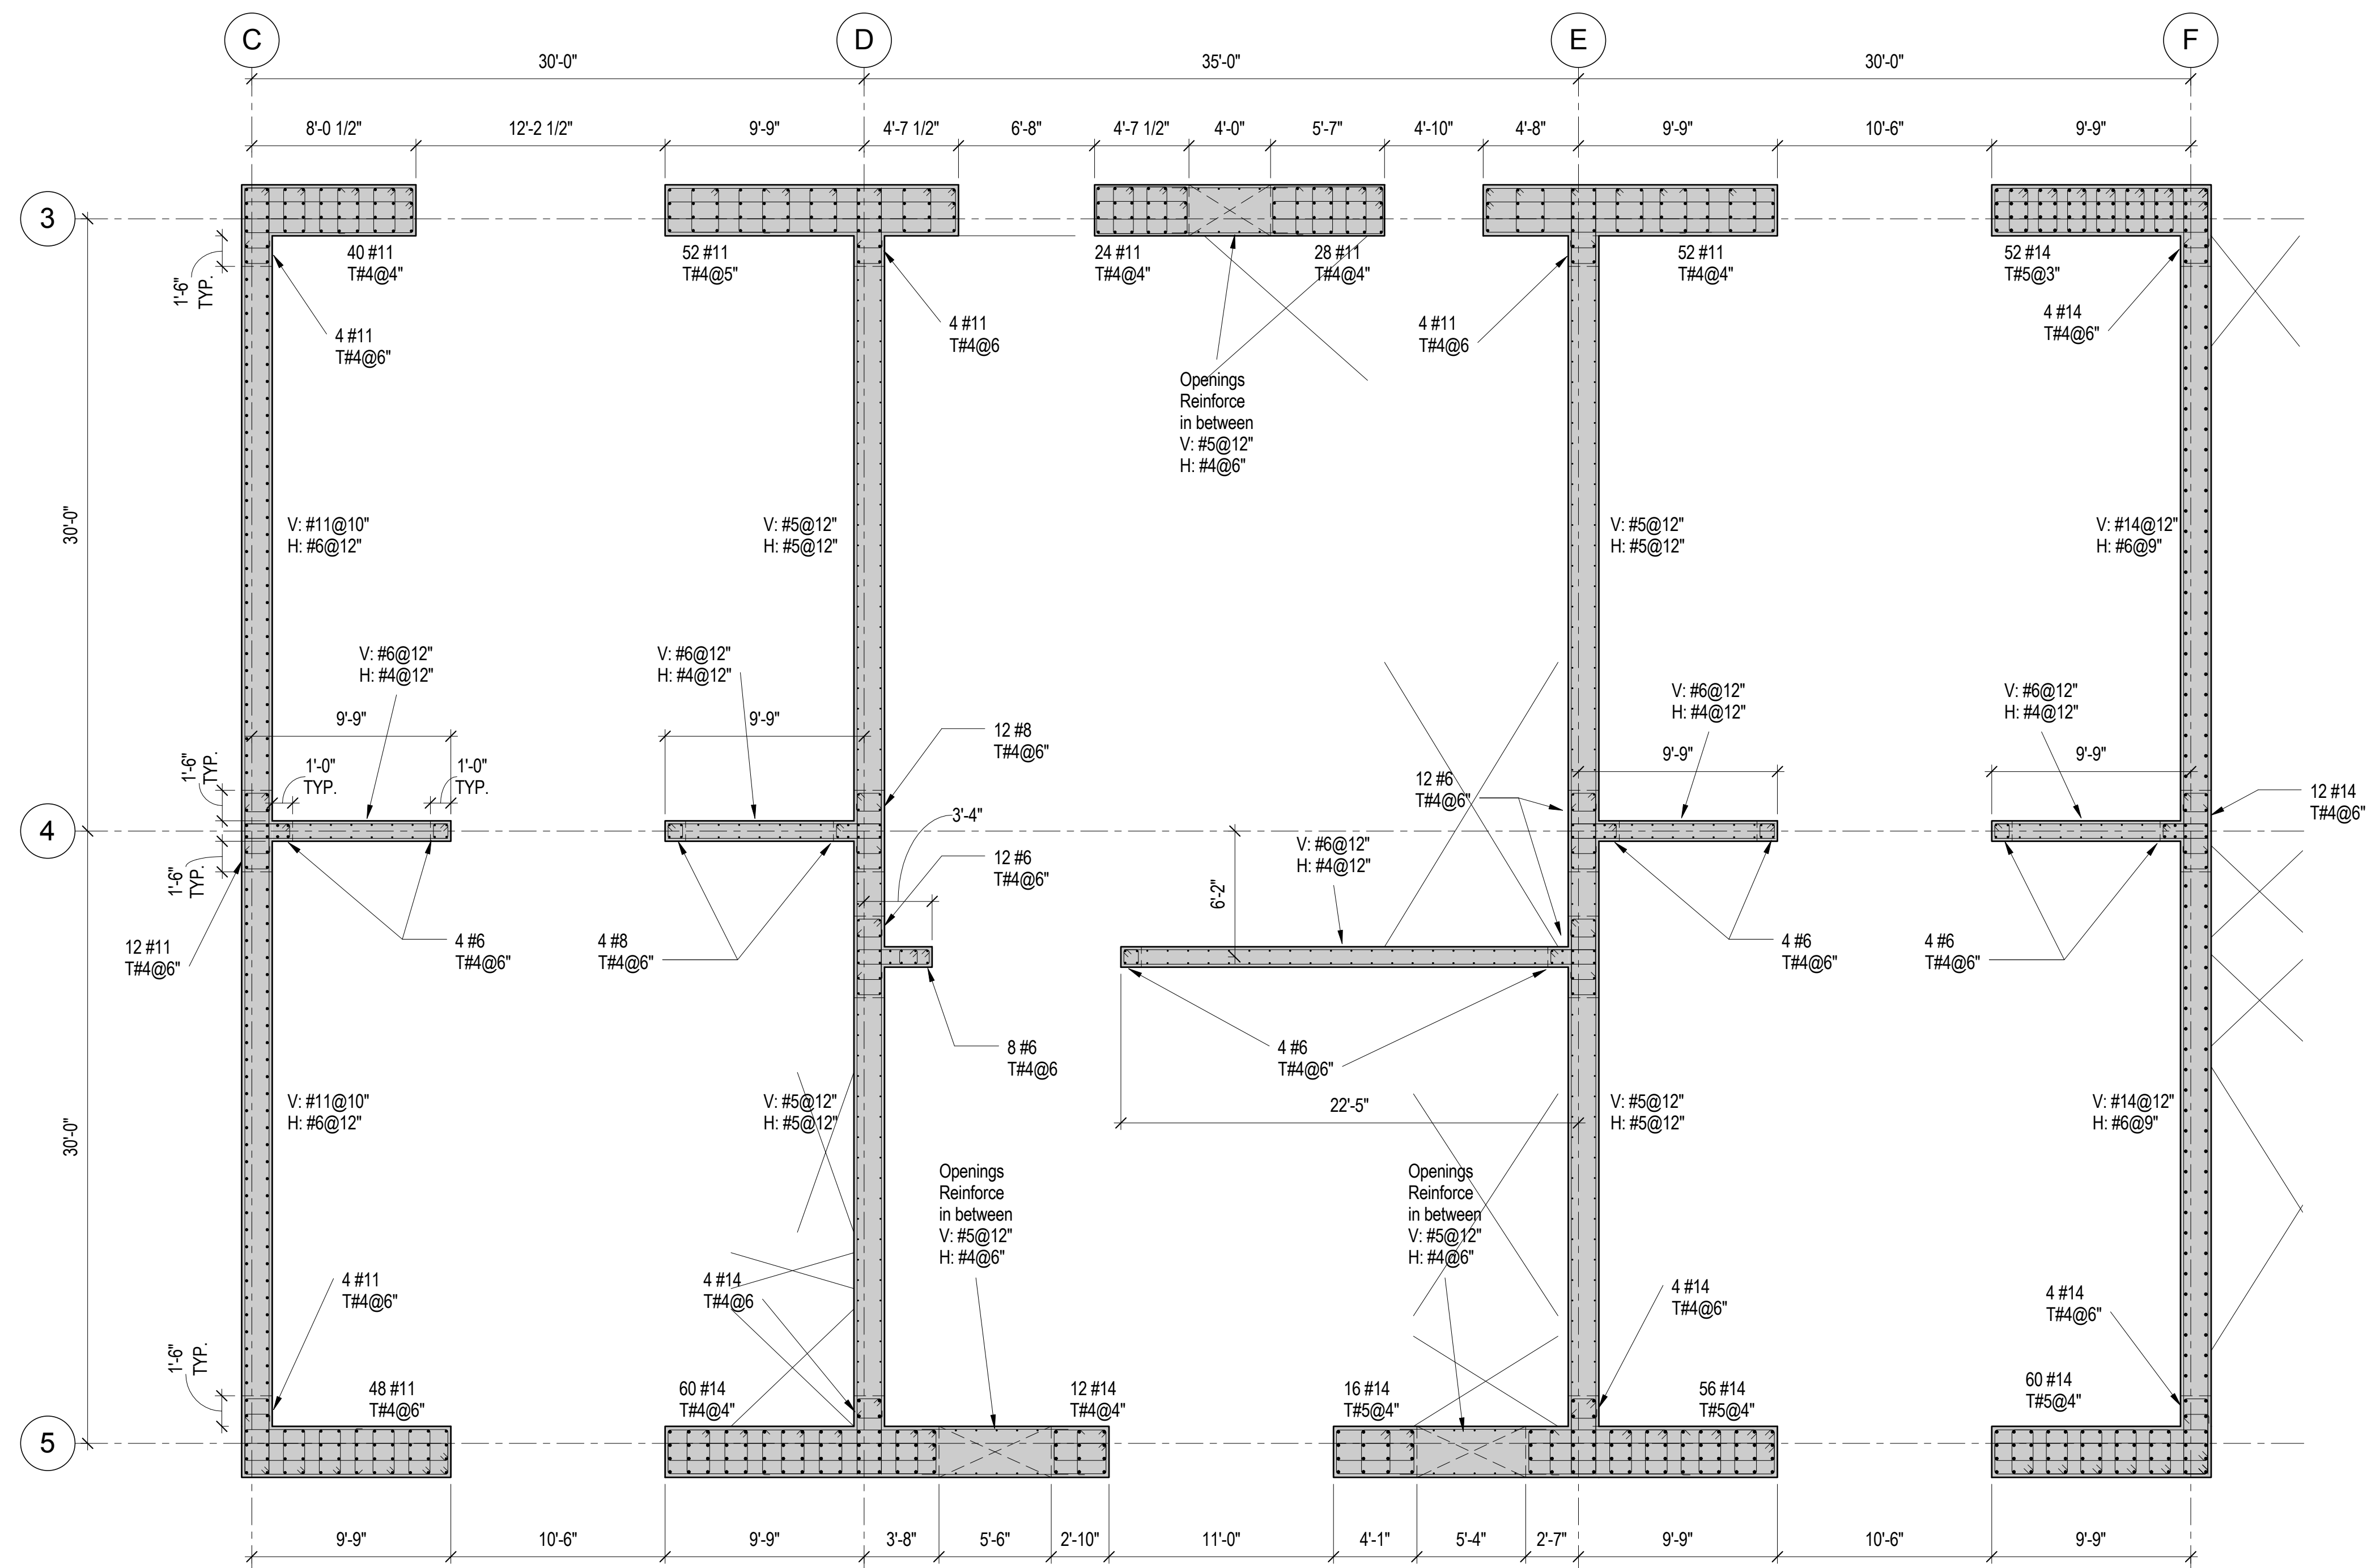

1 REINFORCEMENT LAYOUT - LEVEL 31 TO LEVEL 36
3/16" = 1'-0"

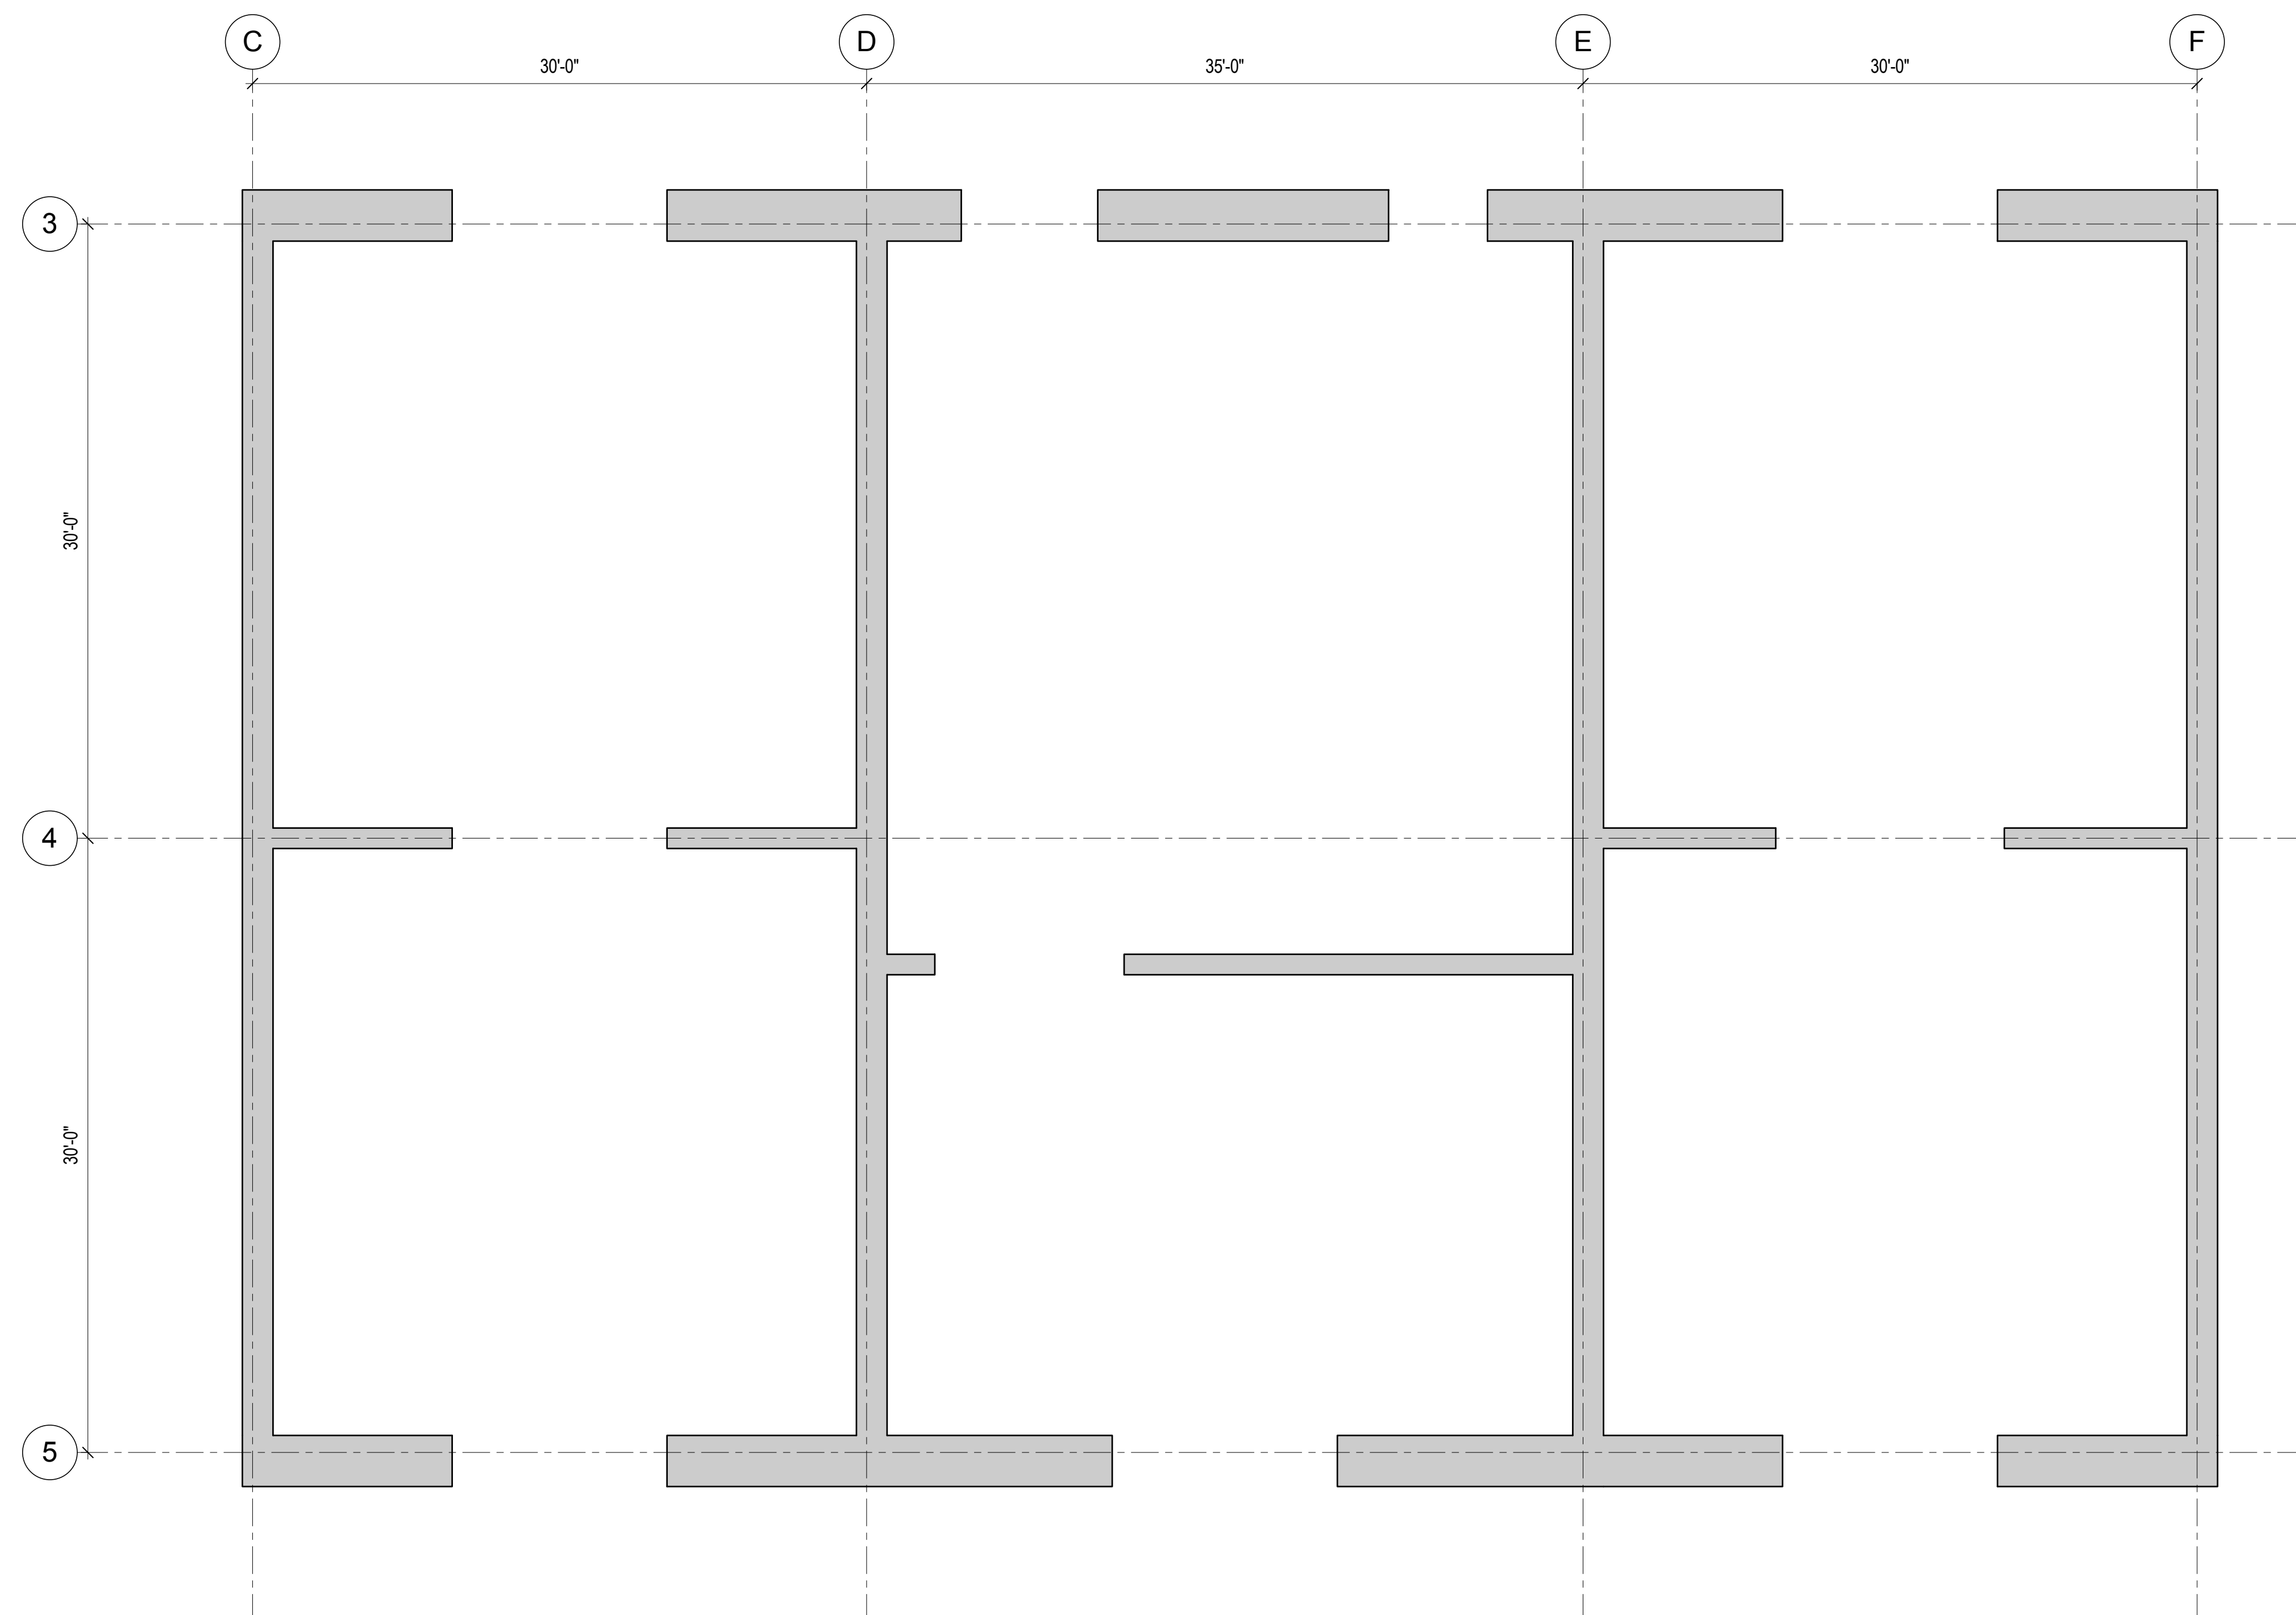

2 REINFORCEMENT LAYOUT - LEVEL 36 TO LEVEL 42
3/16" = 1'-0"

REINFORCING LAYOUT DESIGN IN-PROGRESS AND WILL BE SHOWN ON FUTURE DRAWING ISSUES. REFER TO 1/S-349 FOR SIMILAR LAYOUT.



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166 Ames Street, Hackensack, NJ 07601

Wind Tunnel Consultant
Rowan Williams Davies & Irwin Inc.
650 Woodlawn Road West, Guelph, Ontario, Canada N1K 1B8

Professional Engineer Seal and Signature

Key Plan: Map showing the project location on a street grid with 33rd Street, 31st Street, Dyer Avenue, and 9th Avenue.


PRELIMINARY
NOT FOR CONSTRUCTION

Project No.: 211157
Date: 20 JUN 2014
Scale: 3/16" = 1'-0"


Sheet No.: S-349
Page No.: 56 of 90

Revision Log:

No.	Date	Description
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2	12 JUL 2013	ISSUED FOR 90% DESIGN DEVELOPMENT
1	18 MAR 2012	ISSUED FOR RECONCILIATION

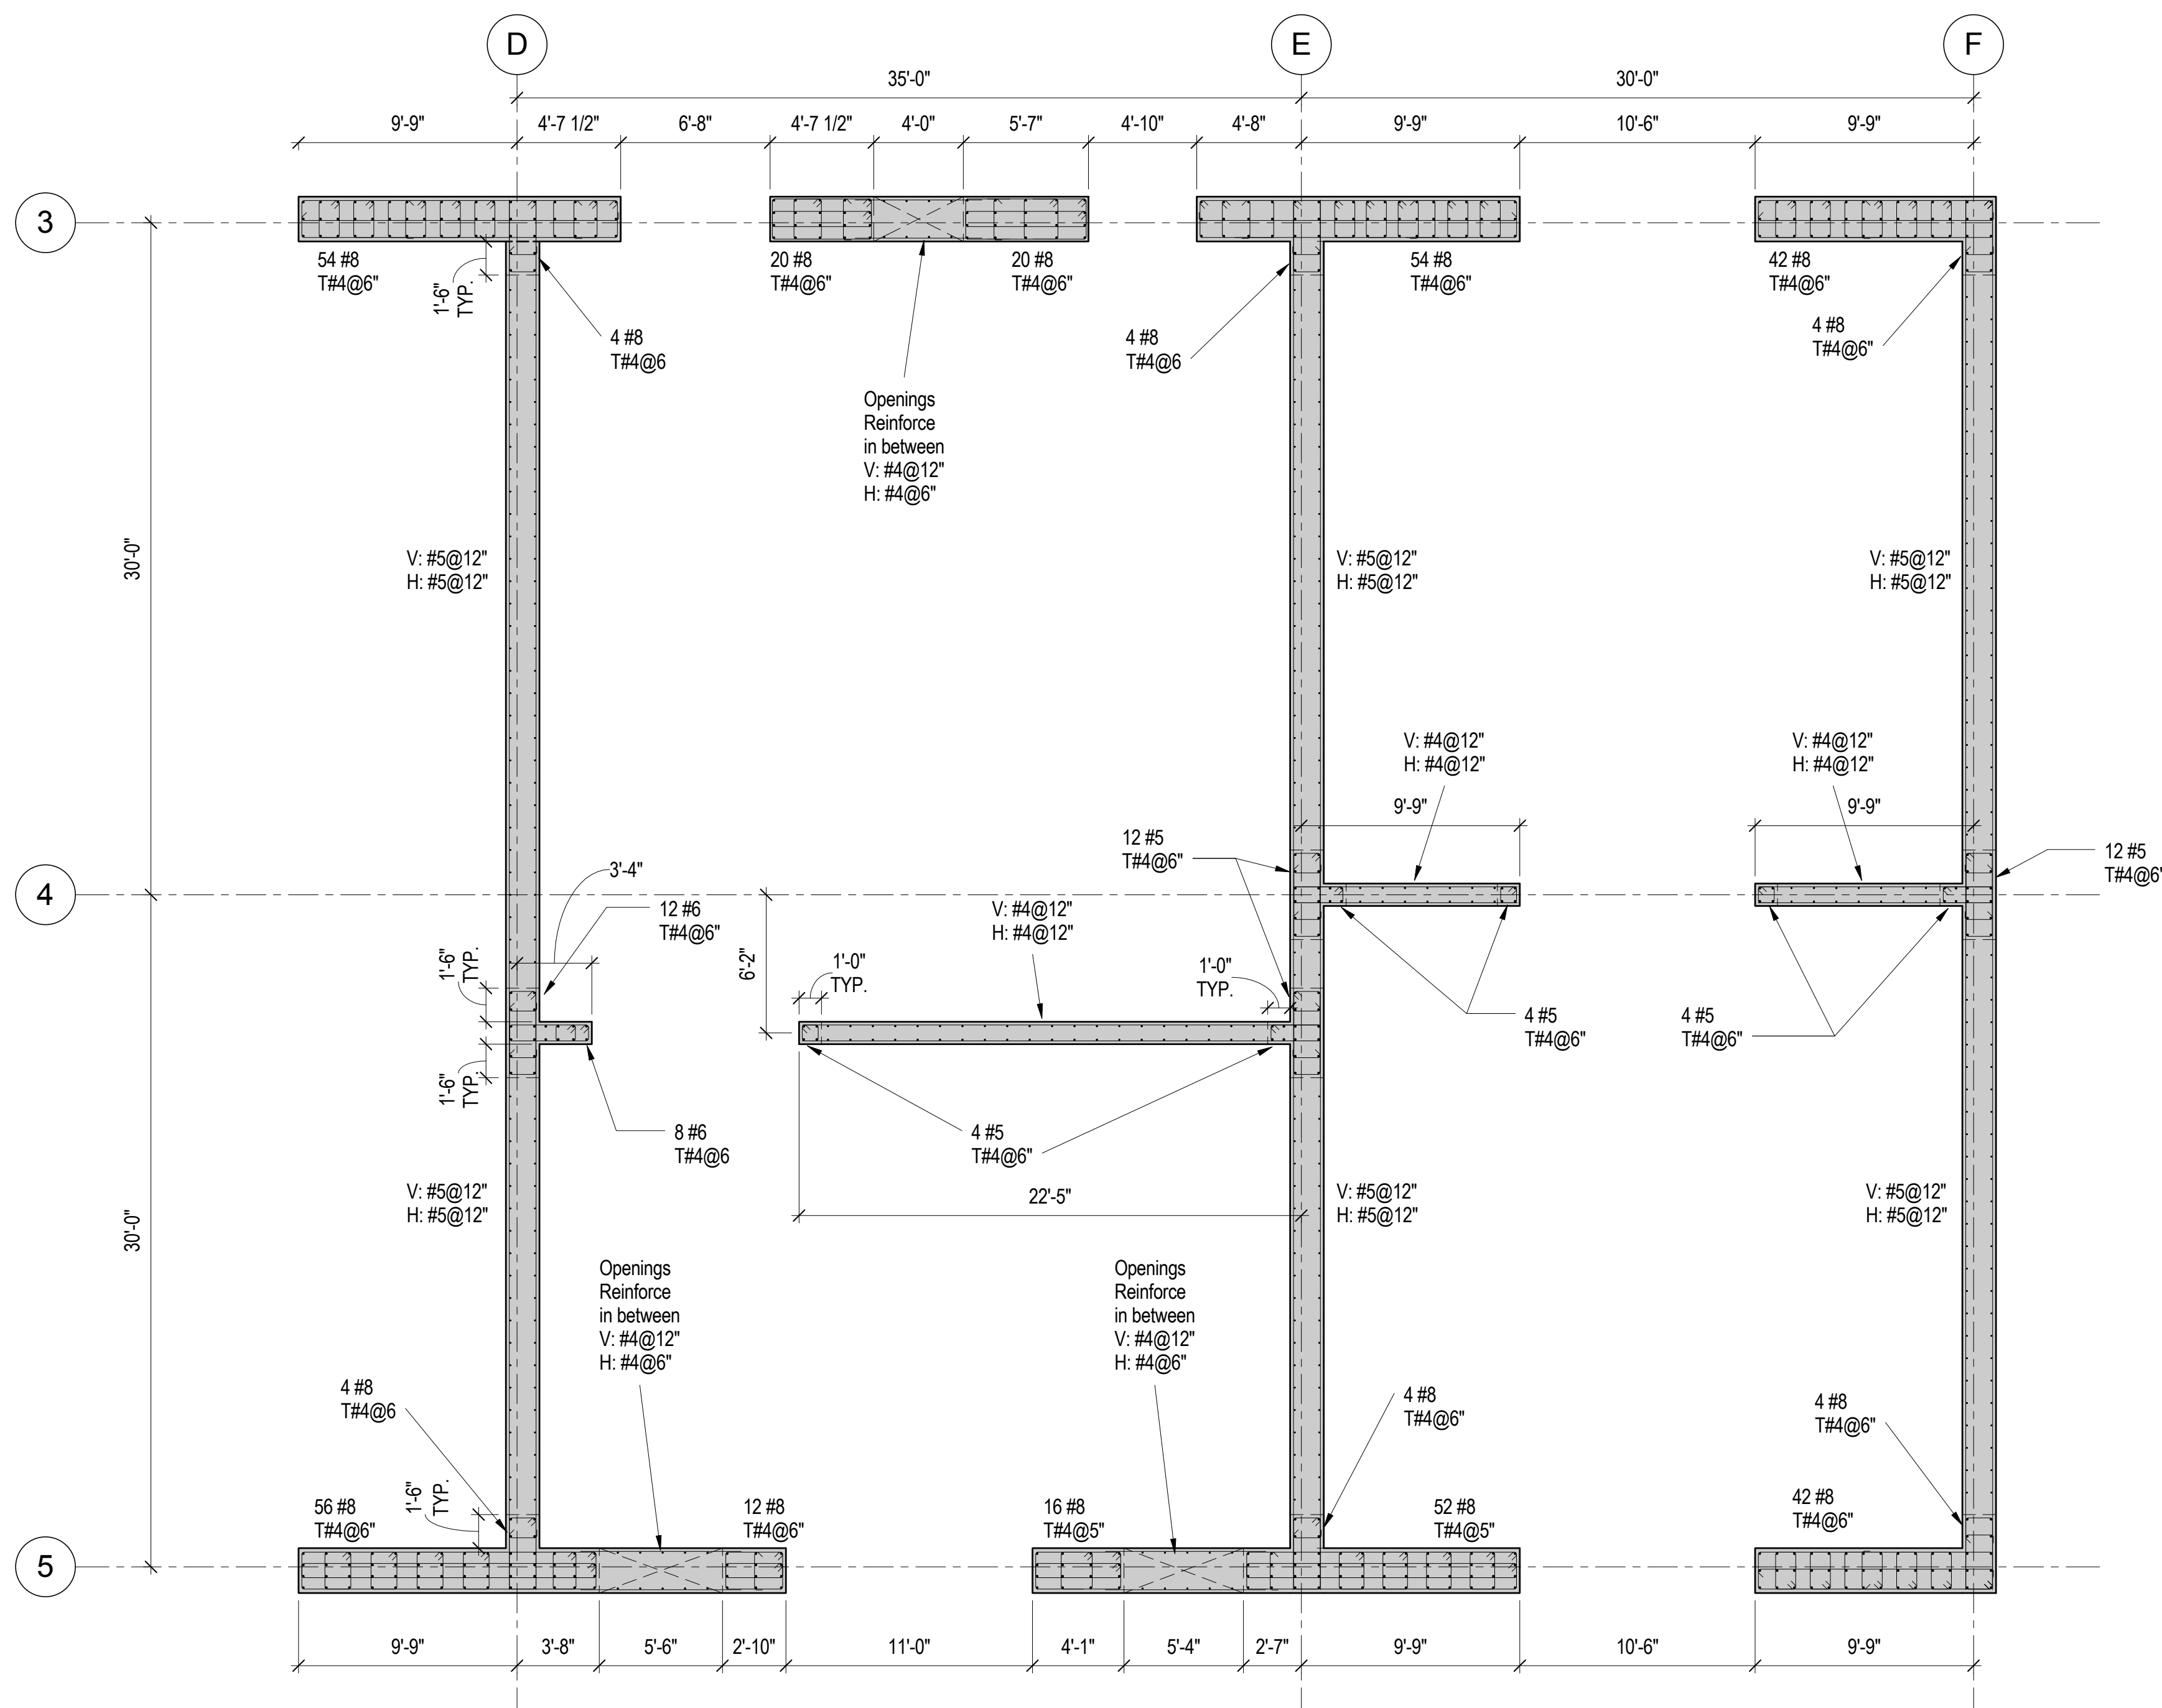

1 REINFORCEMENT LAYOUT - LEVEL 53 TO LEVEL 58
3/16" = 1'-0"

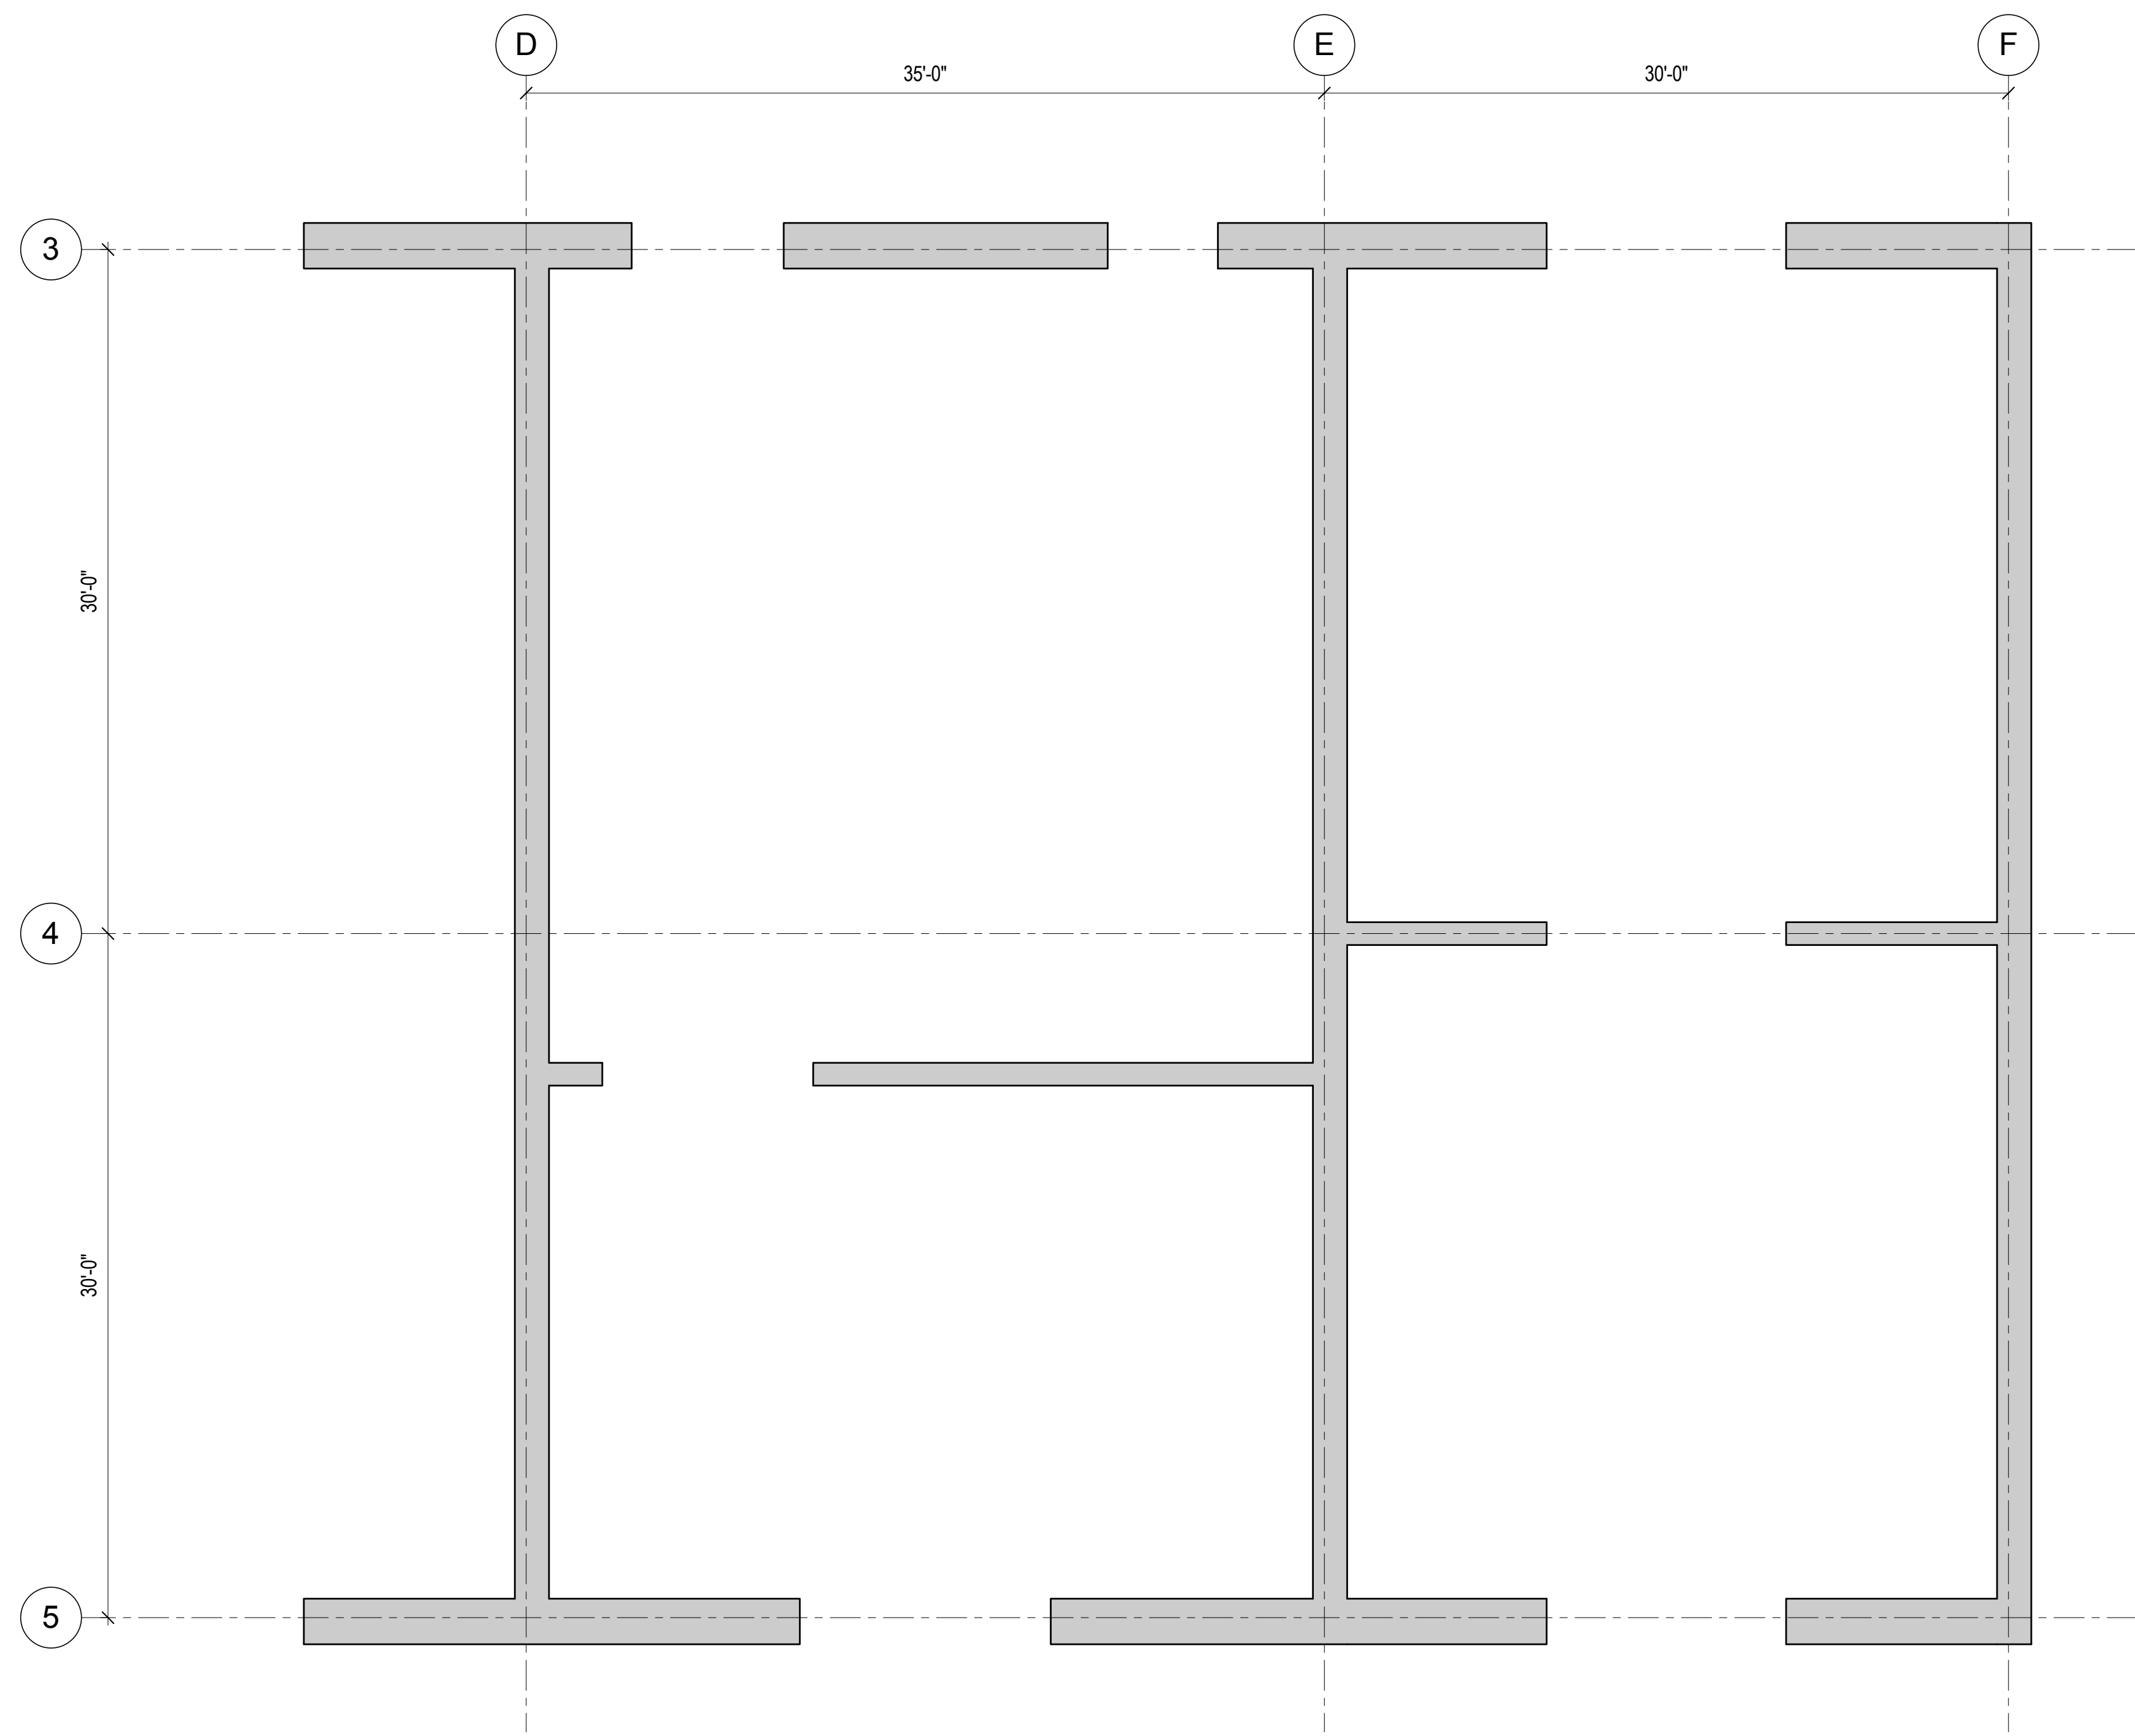

2 REINFORCEMENT LAYOUT - LEVEL 58 TO LEVEL 63
3/16" = 1'-0"

REINFORCING LAYOUT DESIGN IN-PROGRESS AND WILL BE SHOWN ON FUTURE DRAWING ISSUES. REFER TO 1/S-349 FOR SIMILAR LAYOUT.

REINFORCING LAYOUT DESIGN IN-PROGRESS AND WILL BE SHOWN ON FUTURE DRAWING ISSUES. REFER TO 1/S-351 FOR SIMILAR LAYOUT.



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Ontario, Canada N1K 1B8

Professional Engineer Seal
CHARLES MICHAEL BEEBE
070322
PROFESSIONAL ENGINEER

Key Plan:
Map showing the project location relative to 33RD STREET, 31ST STREET, DYER AVENUE, and 9TH AVENUE.

Seal & Signature:
PRELIMINARY
NOT FOR CONSTRUCTION

Project No.: 211157
Date: 20 JUN 2014
Scale: 3/16" = 1'-0"
File No.: S-351

B-SCAN Sheet No.:
Sheet No.: S-351.00
Page No.: 58 of 90

Project No.: 211157
Date: 20 JUN 2014
Scale: 3/16" = 1'-0"
File No.: S-351

B-SCAN Sheet No.:
Sheet No.: S-351.00
Page No.: 58 of 90

Project No.: 211157
Date: 20 JUN 2014
Scale: 3/16" = 1'-0"
File No.: S-351

B-SCAN Sheet No.:
Sheet No.: S-351.00
Page No.: 58 of 90

Project No.: 211157
Date: 20 JUN 2014
Scale: 3/16" = 1'-0"
File No.: S-351

B-SCAN Sheet No.:
Sheet No.: S-351.00
Page No.: 58 of 90

Project No.: 211157
Date: 20 JUN 2014
Scale: 3/16" = 1'-0"
File No.: S-351

B-SCAN Sheet No.:
Sheet No.: S-351.00
Page No.: 58 of 90

Project No.: 211157
Date: 20 JUN 2014
Scale: 3/16" = 1'-0"
File No.: S-351

B-SCAN Sheet No.:
Sheet No.: S-351.00
Page No.: 58 of 90

Project No.: 211157
Date: 20 JUN 2014
Scale: 3/16" = 1'-0"
File No.: S-351

B-SCAN Sheet No.:
Sheet No.: S-351.00
Page No.: 58 of 90


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Date: 20 JUN 2014
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File No.: S-351

B-SCAN Sheet No.:
Sheet No.: S-351.00
Page No.: 58 of 90


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Date: 20 JUN 2014
Scale: 3/16" = 1'-0"
File No.: S-351

B-SCAN Sheet No.:
Sheet No.: S-351.00
Page No.: 58 of 90

Project No.: 211157
Date: 20 JUN 2014
Scale: 3/16" = 1'-0"
File No.: S-351

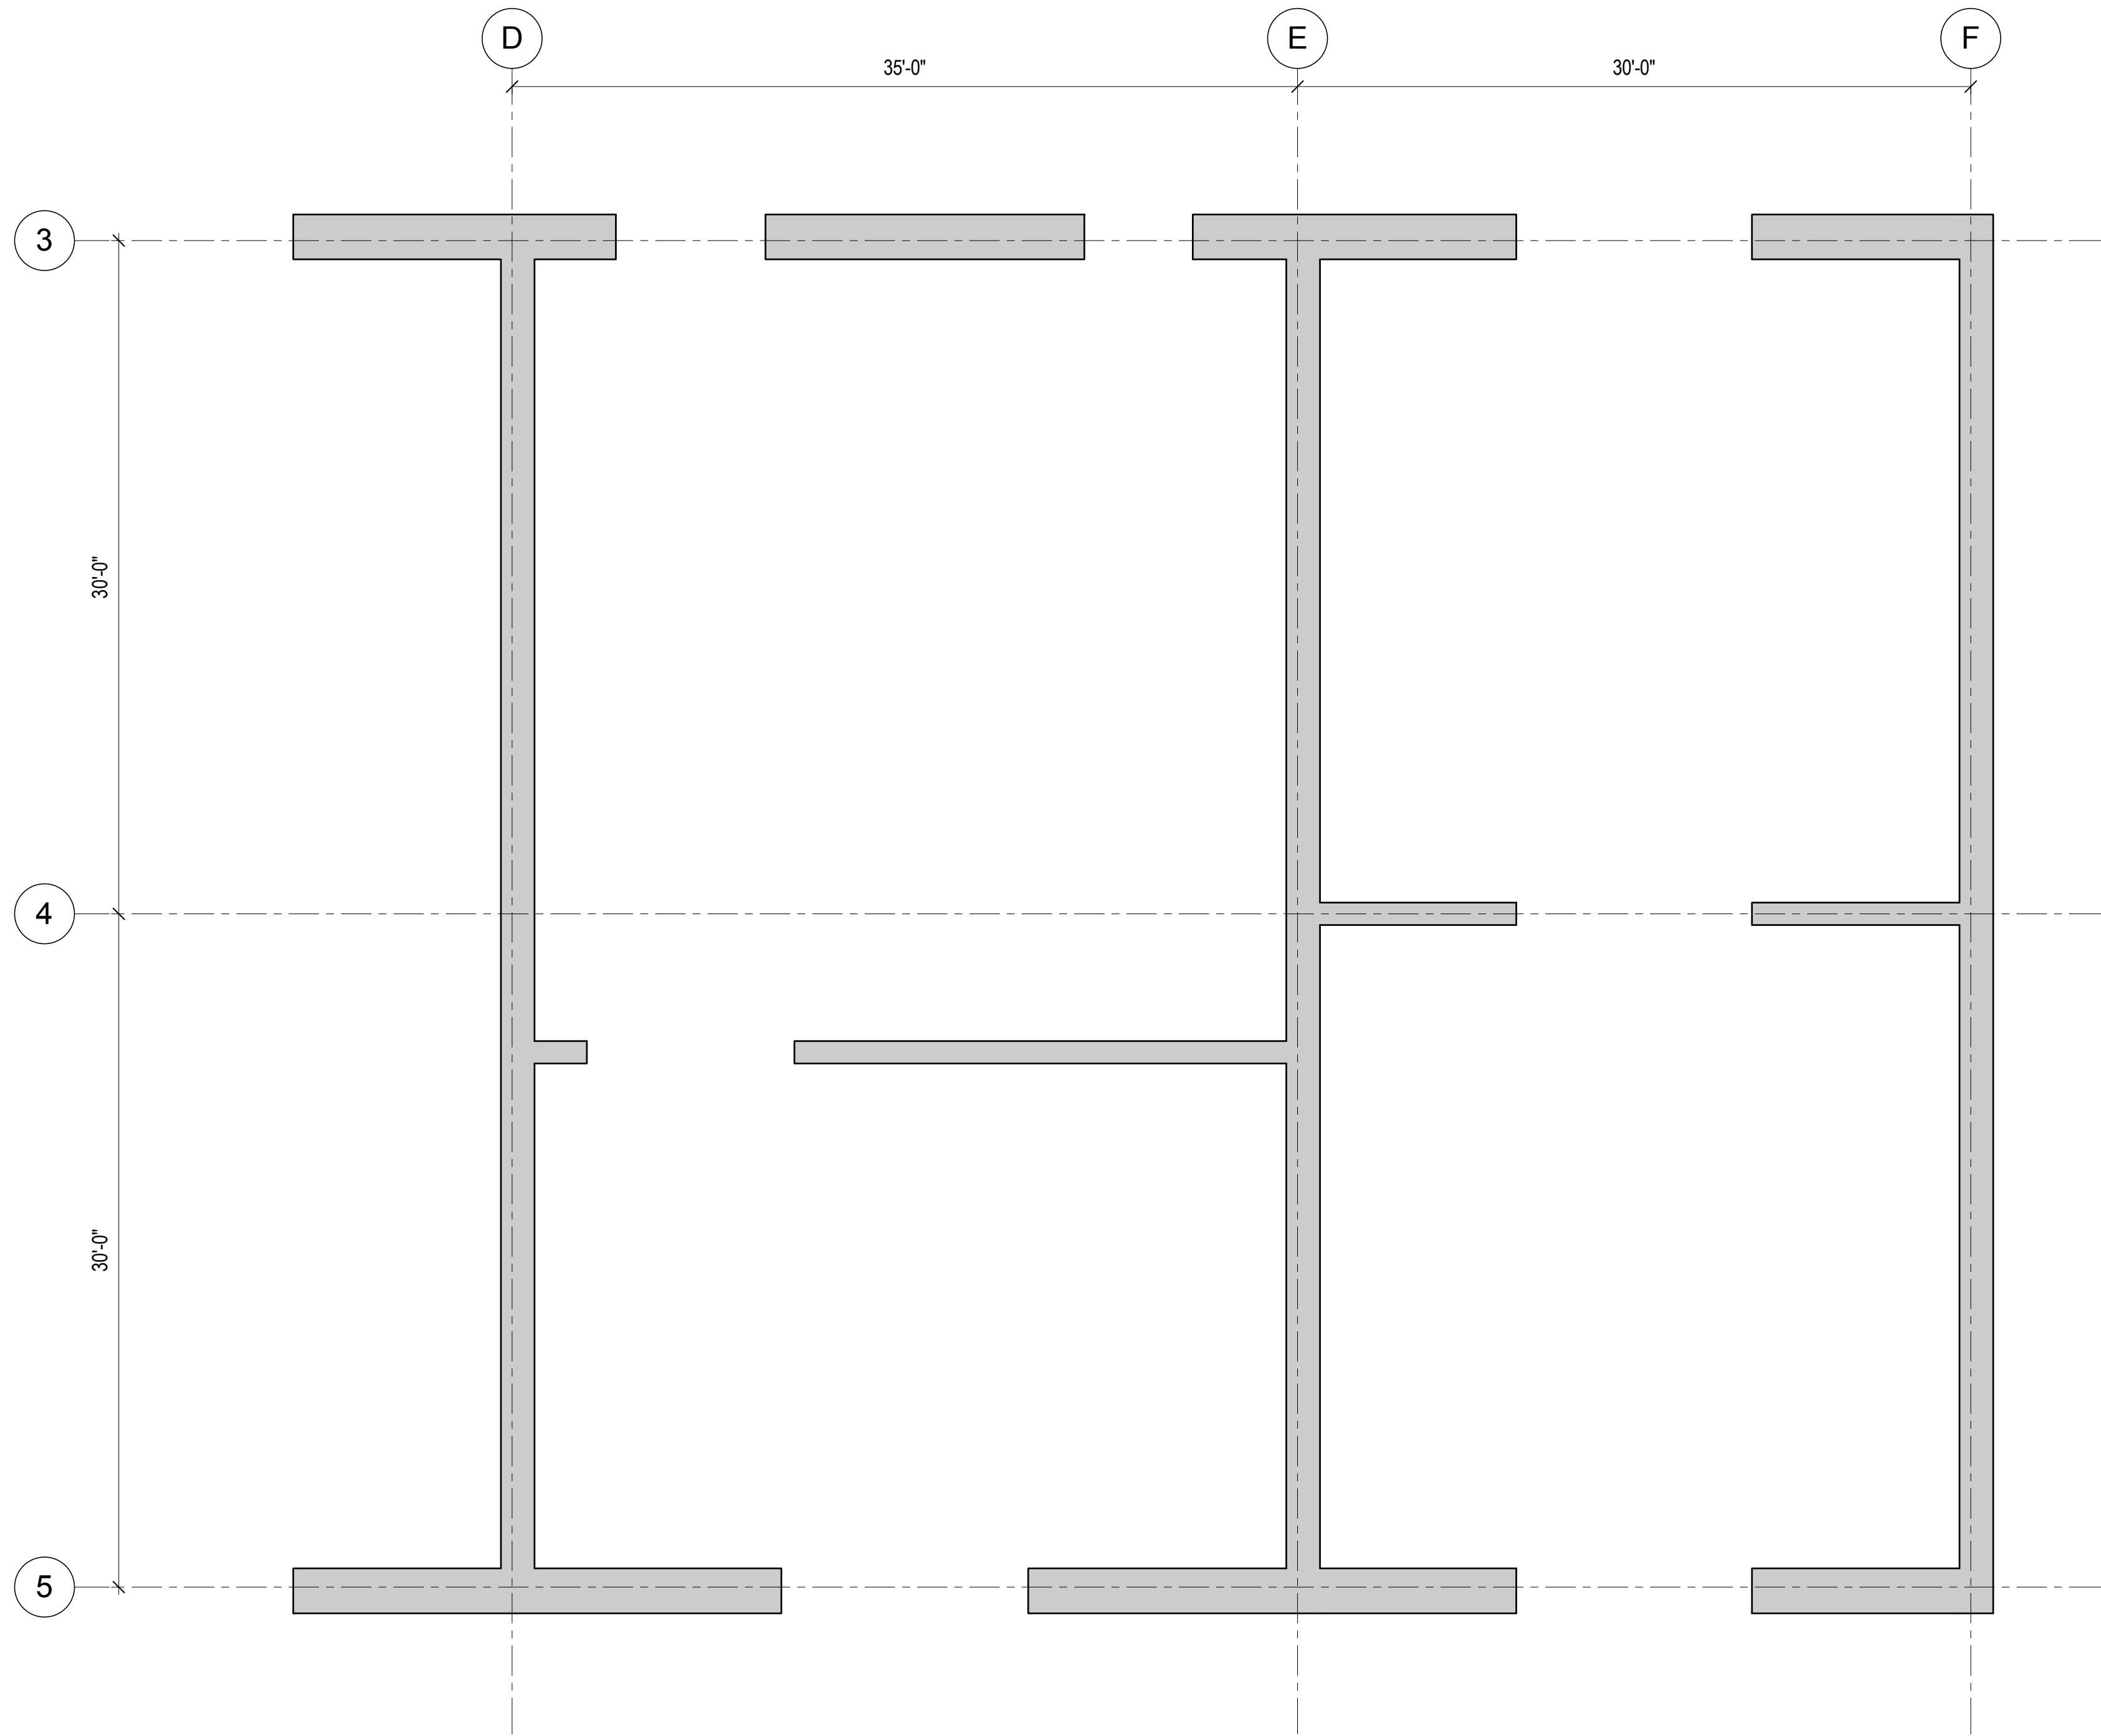

1 REINFORCEMENT LAYOUT - LEVEL 63 TO LEVEL 68
3/16" = 1'-0"

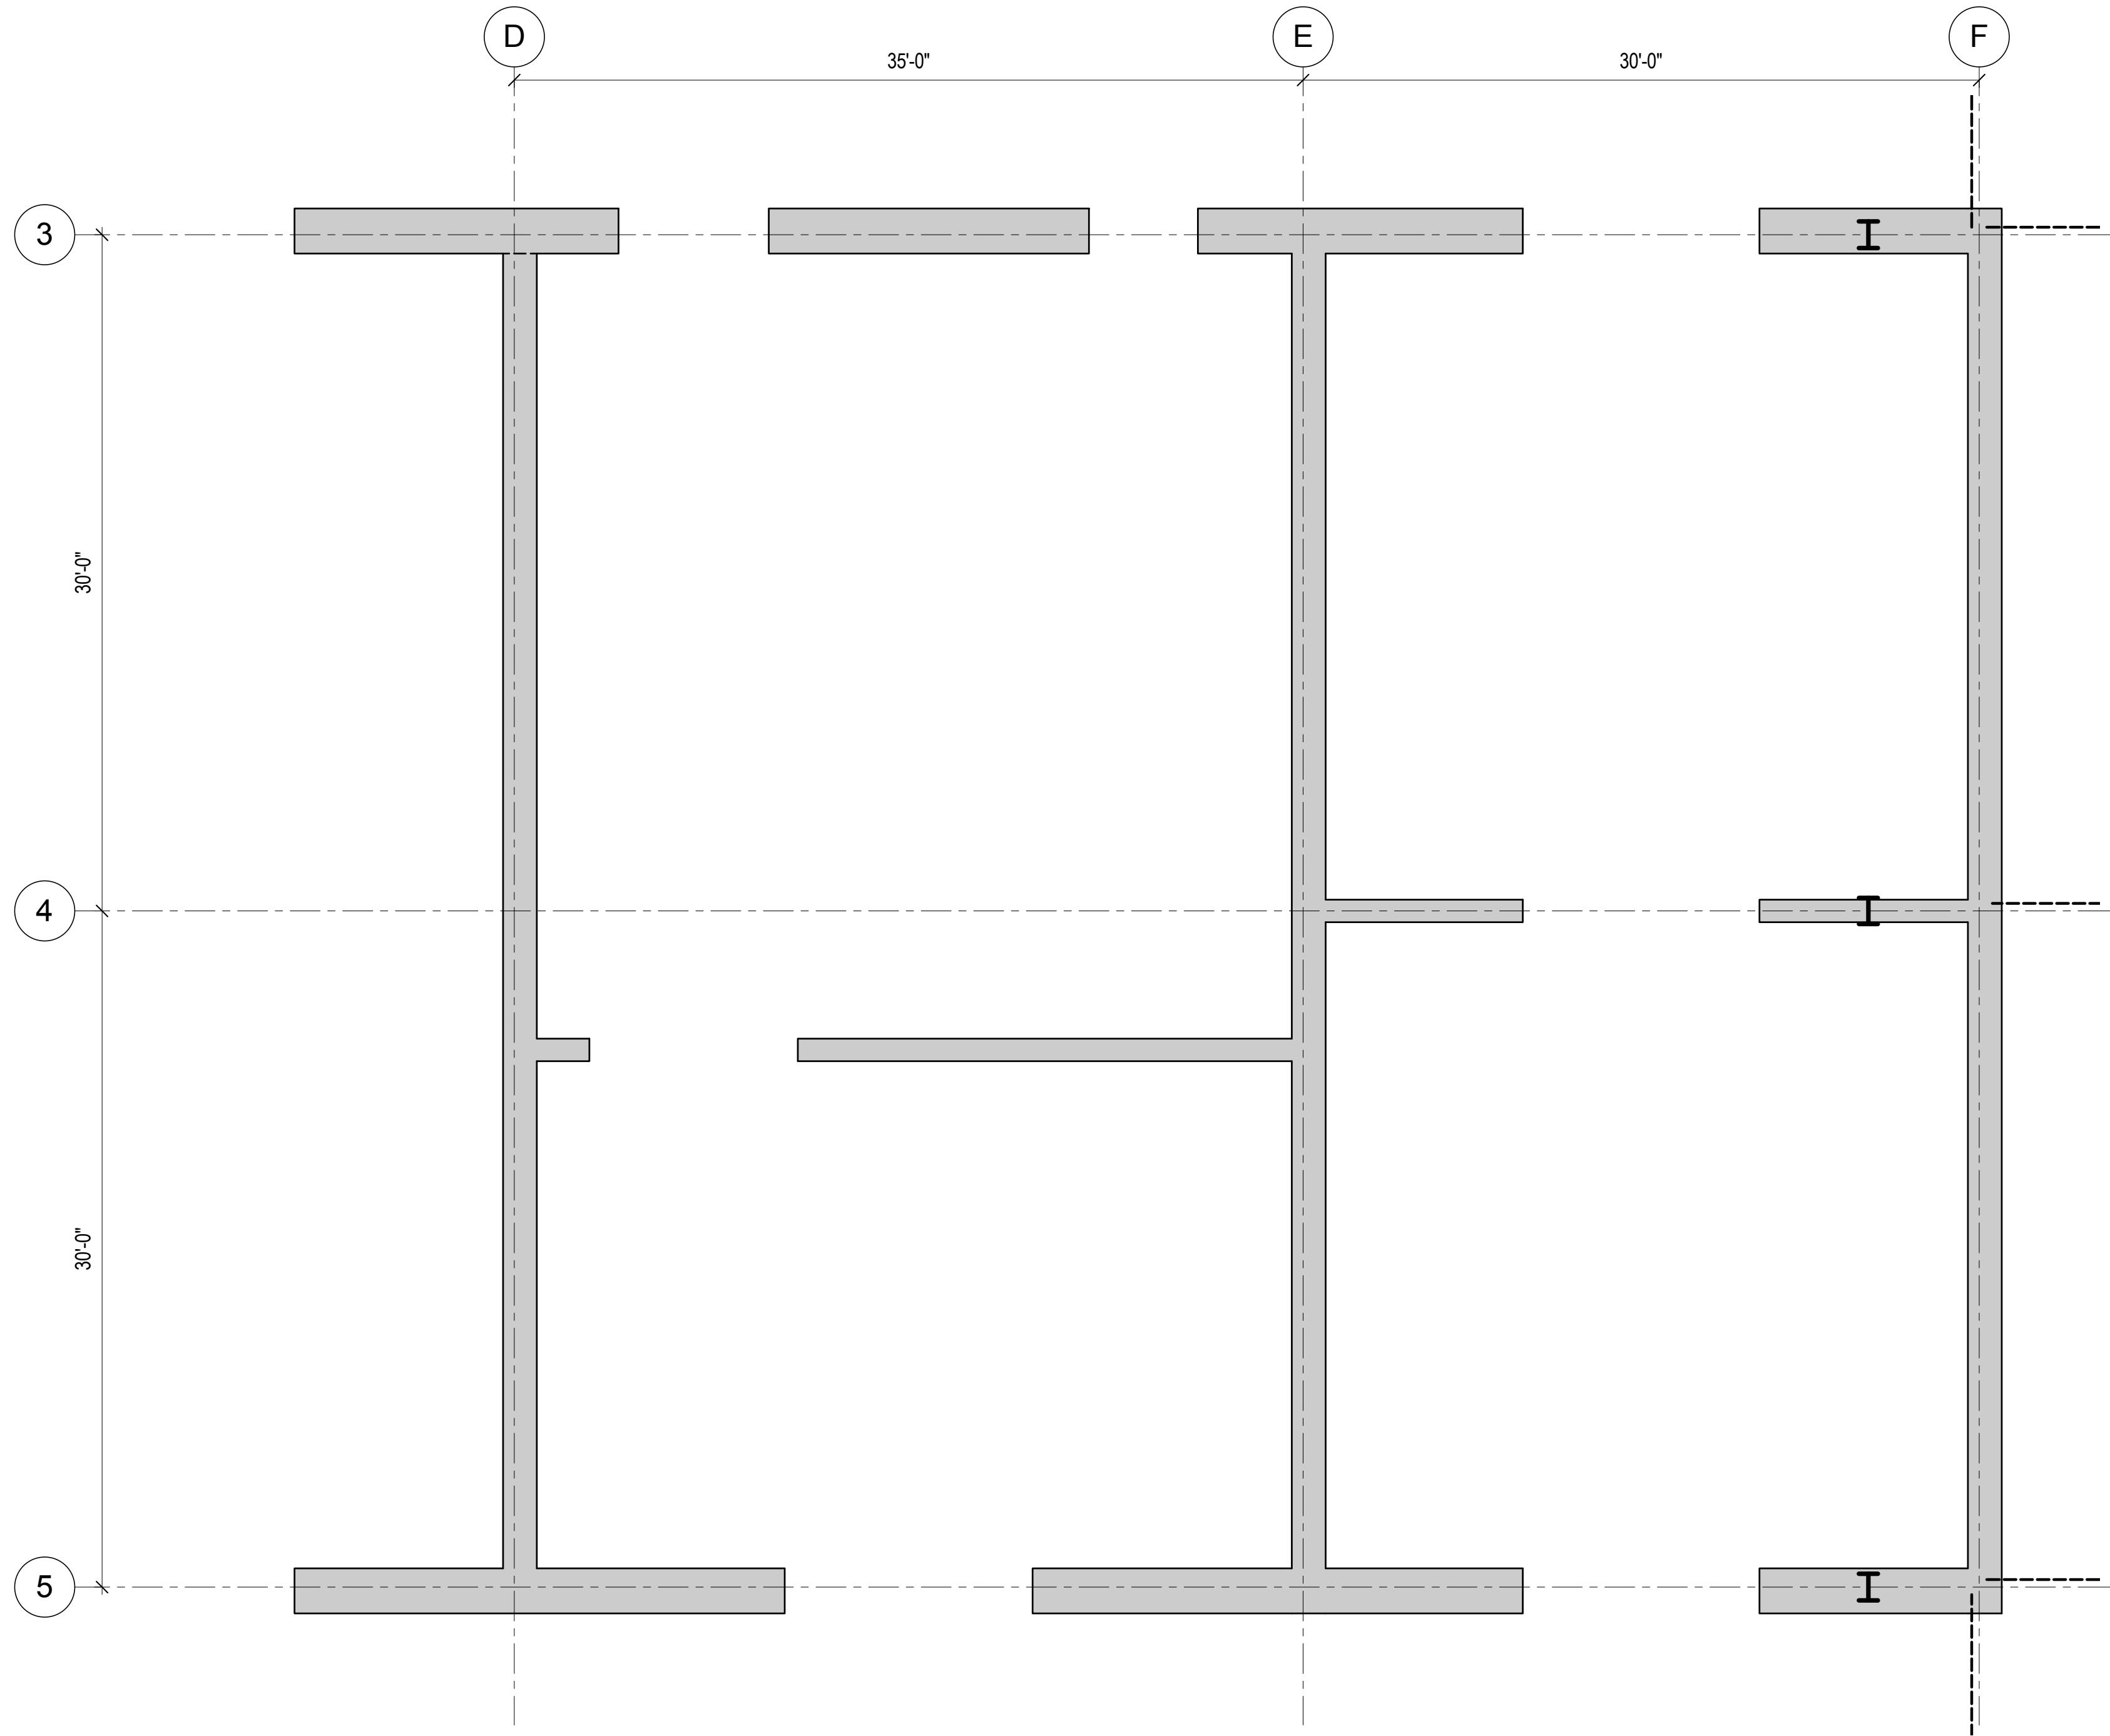

2 REINFORCEMENT LAYOUT - LEVEL 68 TO LEVEL 69
3/16" = 1'-0"

REINFORCING LAYOUT DESIGN IN-PROGRESS AND WILL BE SHOWN ON FUTURE DRAWING ISSUES. REFER TO 1/S-351 FOR SIMILAR LAYOUT.

REINFORCING LAYOUT DESIGN IN-PROGRESS AND WILL BE SHOWN ON FUTURE DRAWING ISSUES. REFER TO 1/S-351 FOR SIMILAR LAYOUT.



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Wind Tunnel Consultant
Rowan Williams Davies & Irwin Inc.
650 Woodlawn Road West, Guelph, Ontario, Canada N1K 1B8

Professional Engineer Seal
Charles Michael Bell
076322
Professional Engineer

Key Plan:
Map showing the project location relative to 33rd Street, 31st Street, Dyer Avenue, and 9th Avenue.

Seal & Signature:
PRELIMINARY
NOT FOR CONSTRUCTION

Project No.: 211157
Date: 20 JUN 2014
Scale: 3/16" = 1'-0"
File No: S-352

B-SCAN Sheet No.: S-352.00
Sheet No.: S-352
Page No.: 59 of 90

Revision Table:
6 20 JUN 2014 ISSUED FOR FOUNDATION BID
5 20 JUN 2014 ISSUED FOR FOUNDATION PERMIT
4 20 DEC 2013 ISSUED FOR FOUNDATION PERMIT
3 15 NOV 2013 ISSUED FOR 50% PROGRESS PRICING
2 12 JUL 2013 ISSUED FOR 90% DESIGN DEVELOPMENT
1 19 MAR 2012 ISSUED FOR RECONCILIATION

Sheet Name:
CORE WALL
REINFORCEMENT
LAYOUT



MANHATTAN WEST:
NORTH TOWER

375 Ninth Avenue, New York, NY 10001

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166 Ames Street, Hackensack, NJ 07601

Wind Tunnel Consultant

Rowan Williams Davies & Irwin Inc.
650 Woodlawn Road West, Guelph
Ontario, Canada N1K 1B6



Key Plan:



Seal & Signature:

PRELIMINARY
NOT FOR CONSTRUCTION


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No.	Date	Description
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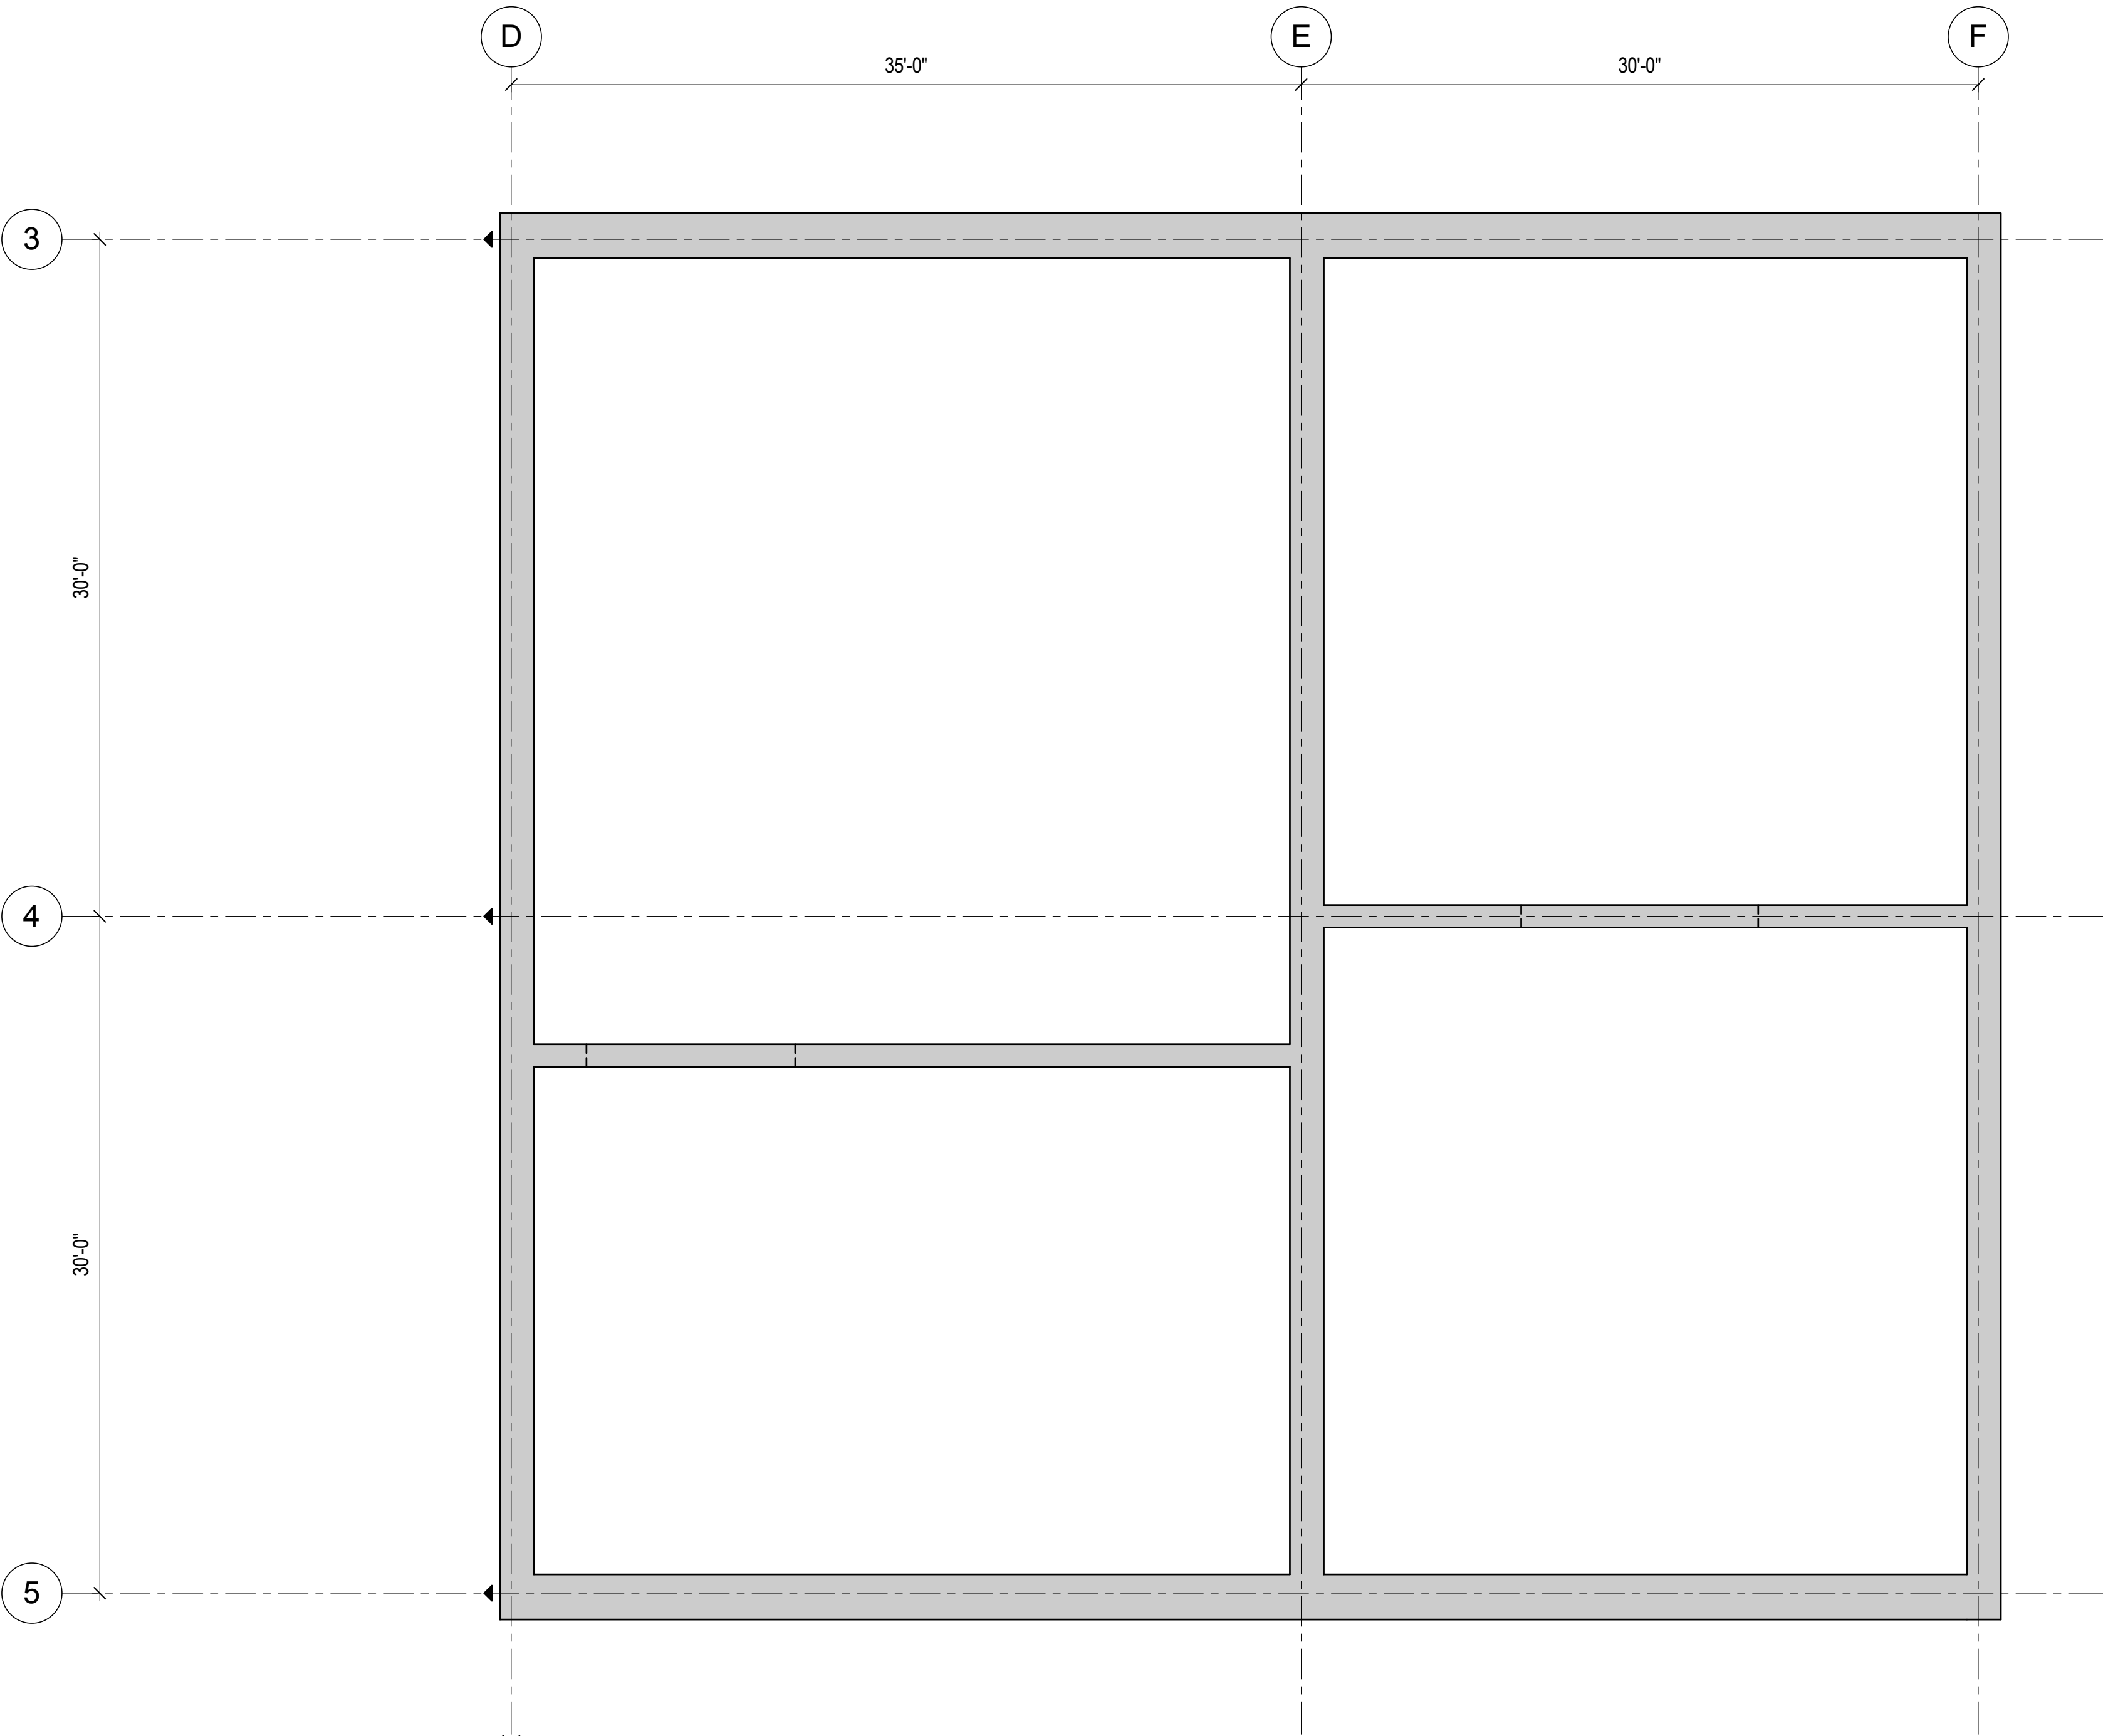
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CORE WALL
REINFORCEMENT
LAYOUT

Project No.: 211157	B-SCAN Sheet No.: S-353.00
Date: 20 JUN 2014	Sheet No.: S-353
Scale: 3/16" = 1'-0"	Page No.: 60 of 90
File No.: S-353	



1 REINFORCEMENT LAYOUT - LEVEL 69 TO LEVEL 70
3/16" = 1'-0"

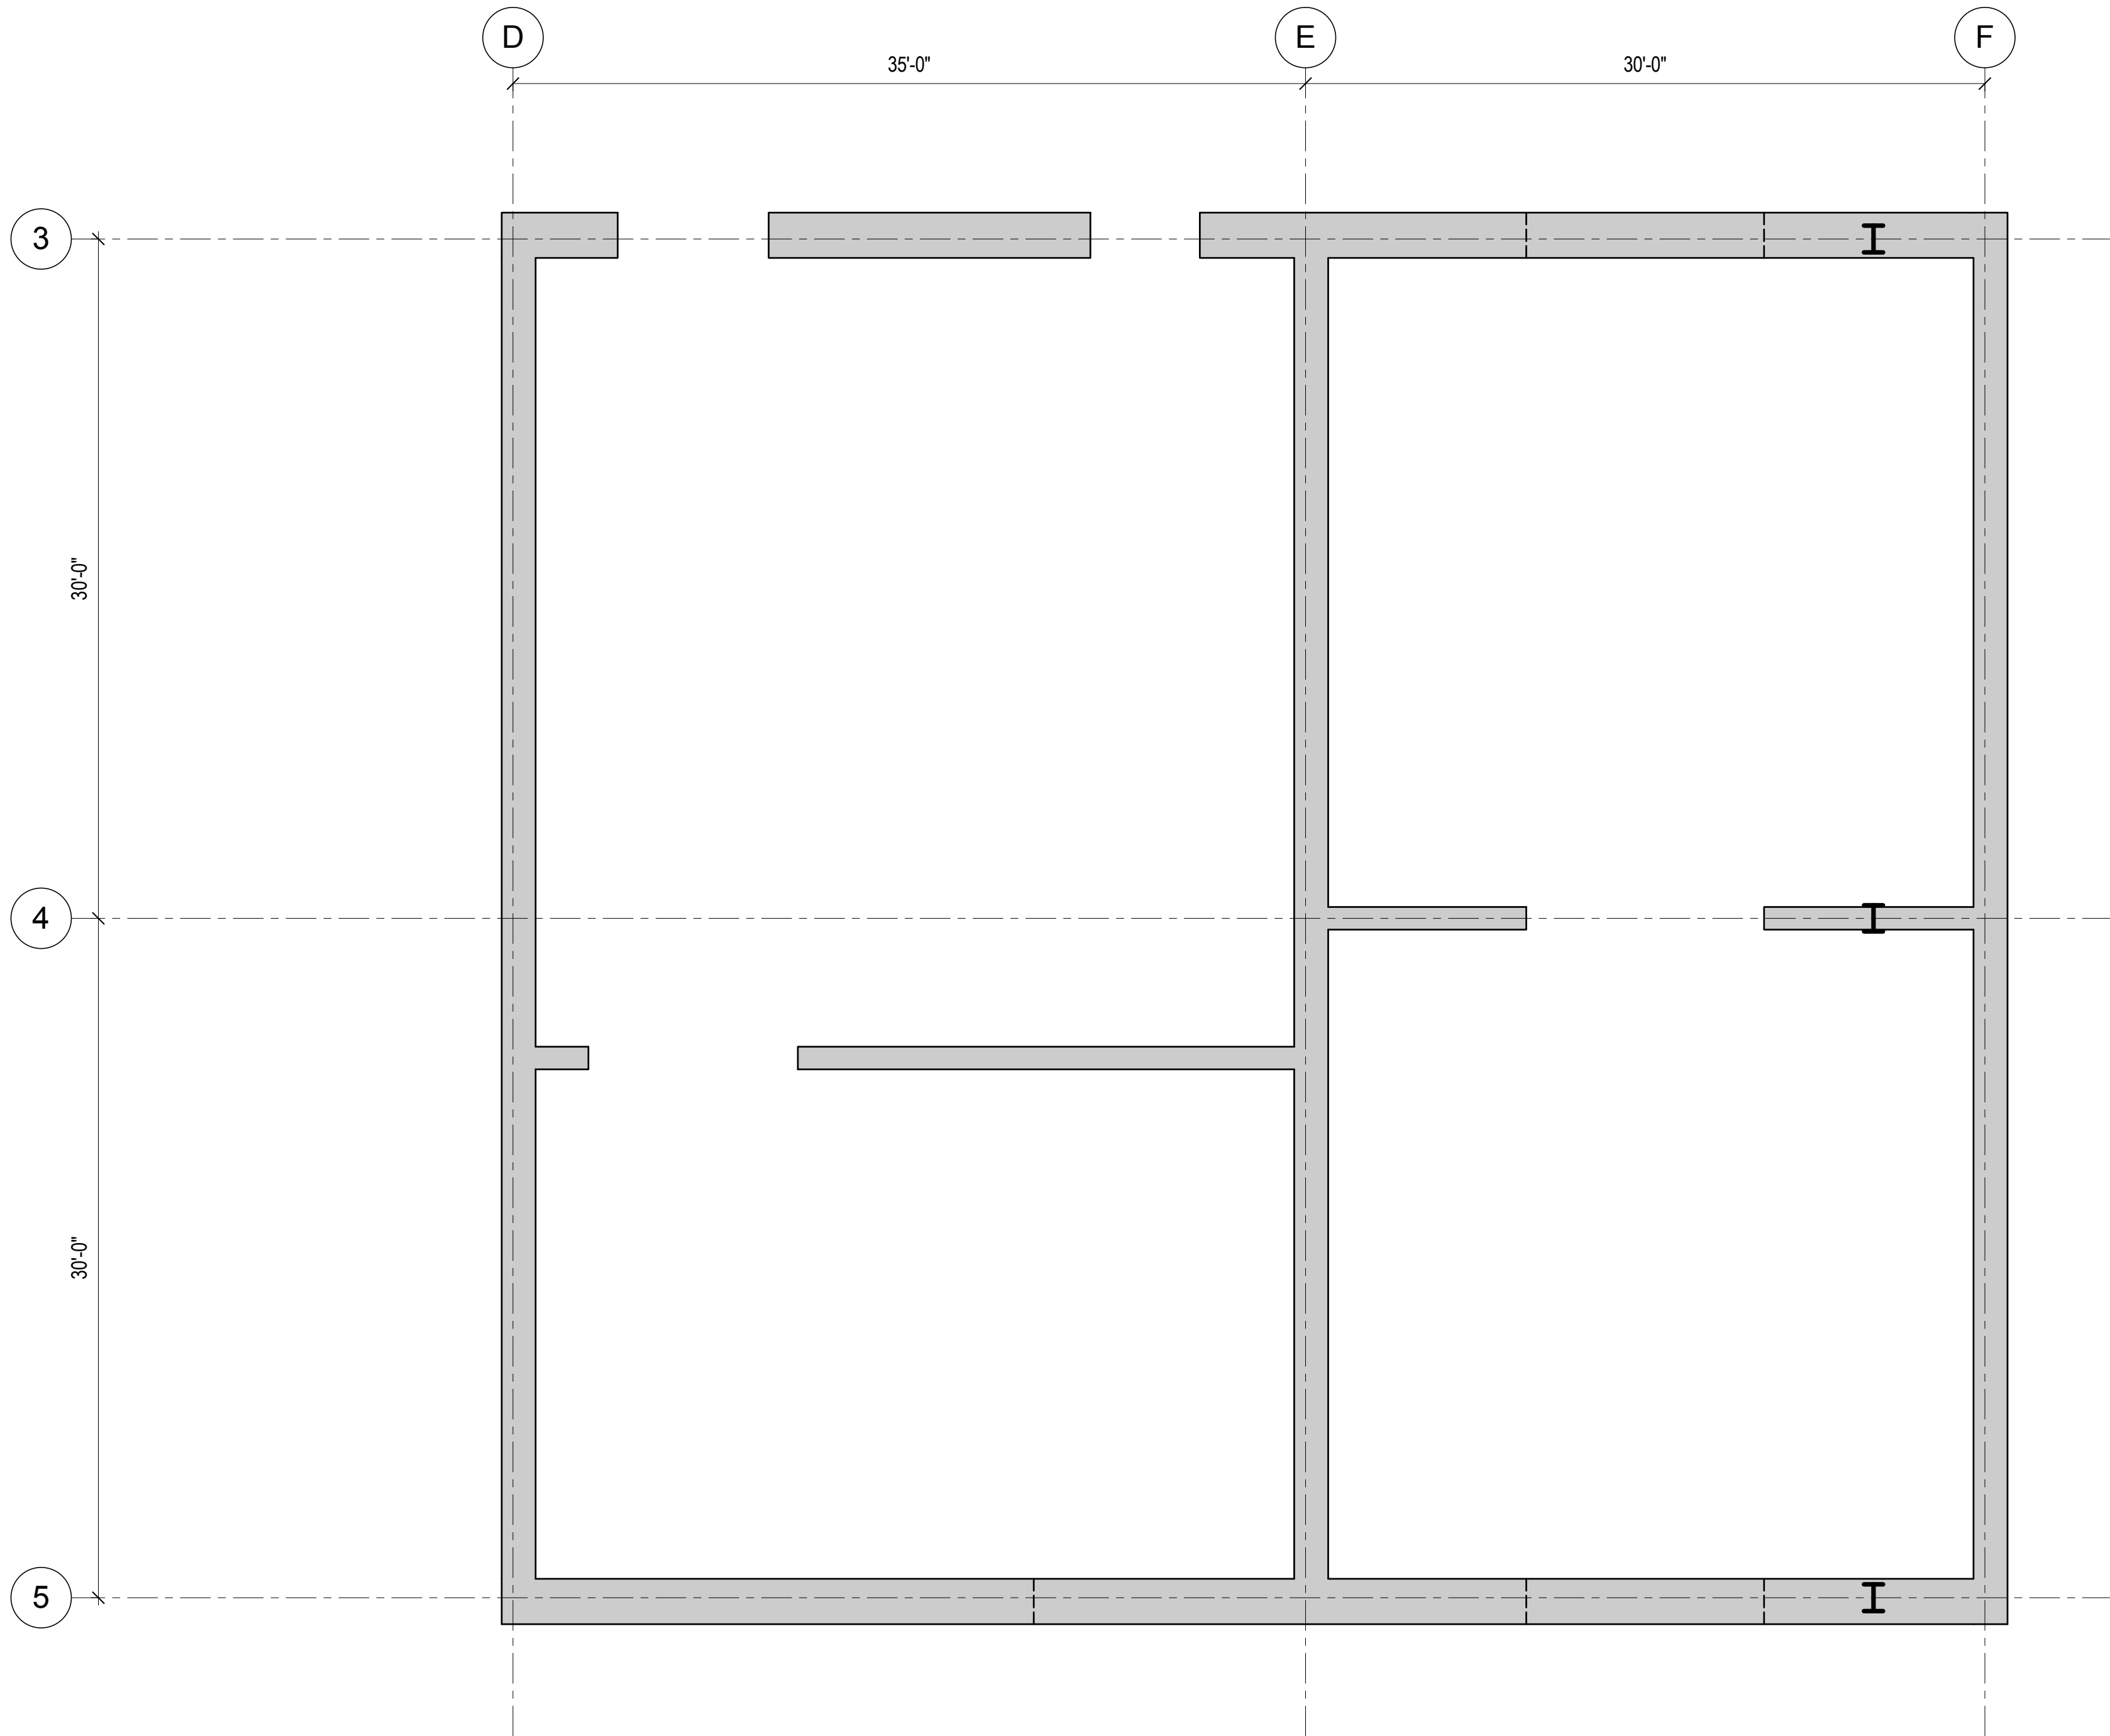

2 REINFORCEMENT LAYOUT - LEVEL 70 TO ROOF
3/16" = 1'-0"

REINFORCING LAYOUT DESIGN IN-
PROGRESS AND WILL BE SHOWN ON
FUTURE DRAWING ISSUES.

REINFORCING LAYOUT DESIGN IN-
PROGRESS AND WILL BE SHOWN ON
FUTURE DRAWING ISSUES.



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Ontario, Canada N1K 1B6



Key Plan:
33RD STREET
DYER AVENUE
31ST STREET
9TH AVENUE

Seal & Signature:
PRELIMINARY
NOT FOR CONSTRUCTION

Project No.: 211157
Date: 20 JUN 2014
Scale: As Indicated
File No.: 3-355


B-SCAN Sheet No.:
S-355.00
Sheet No.:
S-355
Page No.: 62 of 90

REINFORCED CONCRETE CORE WALL LINK BEAM SCHEDULE

fy = 60 ksi
fc = SEE NOTE 1
E = SEE NOTE 1


LEVEL	LOCATION (SEE KEY PLANS)	DIMENSIONS		TOP AND BOTTOM REINF.	SIDE REINF. (EA. FACE)	STIRRUPS		REMARKS
		DEPTH "D" (IN)	WIDTH "W" (IN)			SIZE/ SPACING	TYPE	
54 - ROOF	LB2	111	30	2 x 12 - #9	2 - #5	#5 @ 6.0"	-	
	LB3	66	30	2 x 7 - #9	2 - #5	#5 @ 6.0"	-	EMBEDDED W18x158 ON LEVEL 53 TO 60
	LB4, LB8	120	42	3 x 9 - #9	4 - #5	#5 @ 5.0"	-	
	LB7	132	32	3 x 10 - #9	2 - #5	#5 @ 6.0"	-	UPTURNED LINK BEAM, EMBEDDED W24x162 ON LEVEL 53 TO 60
	LB11, LB12	120	24	8 - #9	2 - #5	#4 @ 6.0"	-	
32 - 53	LB1, LB6	124	42	3 x 9 - #9	3 - #5	#5 @ 4.0"	-	
	LB2	111	30	3 x 12 - #9	1 - #5	#5 @ 5.0"	-	EMBEDDED W18x234
	LB3	66	30	2 x 10 - #9	2 - #5	#5 @ 5.0"	-	EMBEDDED W18x234
	LB4, LB8	120	42	3 x 10 - #9	3 - #5	#5 @ 5.0"	-	EMBEDDED W27x258 ON LEVEL 31 TO 42
	LB7	132	32	5 - #9	3 - #5	#5 @ 6.0"	-	UPTURNED LINK BEAM, EMBEDDED 24x32x2x1 STEEL BUILT-UP MEMBER
	LB10	124	24	4 - #9	2 - #5	#4 @ 6.0"	-	
	LB11	111	24	4 - #9	2 - #5	#4 @ 6.0"	-	
29 - 31	LB12	120	24	4 - #9	2 - #5	#4 @ 6.0"	-	
	LB1, LB6	124	42	3 x 9 - #9	3 - #5	#5 @ 4.0"	-	
	LB2	111	30	3 x 14 - #9	1 - #5	#4 @ 5.0"	-	
	LB3	66	30	3 x 14 - #9	1 - #5	#4 @ 5.0"	-	
	LB4, LB8	120	42	3 x 12 - #9	4 - #5	#5 @ 5.0"	-	
	LB5, LB9	60	42	8 - #9	5 - #5	#5 @ 6.0"	-	EMBEDDED 24x34x2x2.5 STEEL BUILT-UP MEMBER
	LB7	132	32	6 - #9	3 - #5	#5 @ 6.0"	-	UPTURNED LINK BEAM, EMBEDDED 24x32x2x1 STEEL BUILT-UP MEMBER
	LB10	124	24	4 - #9	2 - #5	#4 @ 6.0"	-	
	LB11	111	24	8 - #9	2 - #5	#4 @ 6.0"	-	
	LB12	120	24	8 - #9	2 - #5	#4 @ 6.0"	-	
27 - 28	LB14	60	42	2 x 6 - #9	3 - #5	#5 @ 5.0"	-	
	LB1, LB6	124	42	3 x 9 - #9	3 - #5	#5 @ 5.0"	-	
	LB2	111	30	3 x 14 - #9	1 - #5	#4 @ 5.0"	-	
	LB3	66	30	3 x 14 - #9	1 - #5	#4 @ 5.0"	-	
	LB4, LB5, LB8, LB9	120	42	3 x 12 - #9	3 - #5	#5 @ 5.0"	-	
	LB7	132	32	6 - #9	3 - #5	#5 @ 6.0"	-	UPTURNED LINK BEAM, EMBEDDED 24x32x2x1 STEEL BUILT-UP MEMBER
	LB10	124	24	4 - #9	2 - #5	#4 @ 6.0"	-	
	LB11	111	24	8 - #9	2 - #5	#4 @ 6.0"	-	
	LB12, LB13	120	24	8 - #9	2 - #5	#4 @ 6.0"	-	
	LB1, LB6	124	42	3 x 9 - #9	3 - #5	#5 @ 5.0"	-	
17 - 26	LB2	111	30	2 x 18 - #9	2 - #5	#5 @ 5.0"	-	
	LB3	66	30	3 x 8 - #9	2 - #5	#5 @ 5.0"	-	
	LB4, LB5, LB8, LB9	120	42	3 x 14 - #9	3 - #5	#5 @ 4.0"	-	
	LB7	132	32	8 - #9	3 - #5	#5 @ 6.0"	-	UPTURNED LINK BEAM, EMBEDDED 24x32x2x1 STEEL BUILT-UP MEMBER
	LB10	124	24	4 - #9	2 - #5	#4 @ 6.0"	-	
	LB11	111	24	8 - #9	2 - #5	#4 @ 6.0"	-	
	LB12, LB13	120	24	8 - #9	2 - #5	#4 @ 6.0"	-	
	LB1, LB6	124	42	3 x 8 - #9	3 - #5	#5 @ 5.0"	-	
	LB2	111	30	3 x 11 - #9	2 - #5	#5 @ 5.0"	-	
	LB3	66	30	3 x 8 - #9	2 - #5	#5 @ 5.0"	-	
12 - 16	LB4, LB5, LB8, LB9	120	42	3 x 11 - #9	3 - #5	#5 @ 5.0"	-	
	LB7	132	32	10 - #9	3 - #5	#5 @ 6.0"	-	UPTURNED LINK BEAM, EMBEDDED 24x32x2x1.5 STEEL BUILT-UP MEMBER
	LB10	124	24	4 - #9	2 - #5	#4 @ 6.0"	-	
	LB11	111	24	8 - #9	2 - #5	#4 @ 6.0"	-	
	LB12, LB13	120	24	8 - #9	2 - #5	#4 @ 6.0"	-	
	LB1, LB6	124	42	3 x 8 - #9	3 - #5	#5 @ 5.0"	-	
	LB2	111	30	3 x 10 - #9	2 - #5	#5 @ 5.0"	-	
7 - 11	LB3	66	30	3 x 8 - #9	2 - #5	#5 @ 4.0"	-	
	LB4, LB5, LB8, LB9	120	42	3 x 10 - #9	3 - #5	#5 @ 6.0"	-	
	LB7	132	32	3 x 17 - #9	2 - #5	#5 @ 5.0"	-	UPTURNED LINK BEAM
	LB10	124	24	4 - #9	2 - #5	#4 @ 6.0"	-	
	LB11	111	24	4 - #9	2 - #5	#4 @ 6.0"	-	
	LB12, LB13	120	24	4 - #9	2 - #5	#4 @ 6.0"	-	
	LB2	111	224	3 x 10 - #9	2 - #5	#5 @ 5.0"	-	
6	LB3	66	224	3 x 8 - #9	2 - #5	#5 @ 4.0"	-	
	LB4	120	204	3 x 10 - #9	3 - #5	#5 @ 6.0"	-	
	LB8	120	180	3 x 10 - #9	3 - #5	#5 @ 6.0"	-	
	LB10	124	24	4 - #9	2 - #5	#4 @ 6.0"	-	
	LB11	111	24	4 - #9	2 - #5	#4 @ 6.0"	-	
	LB12	120	24	4 - #9	2 - #5	#4 @ 6.0"	-	
	LB1, LB6	124	42	3 x 8 - #9	3 - #5	#5 @ 5.0"	-	
5	LB2	111	30	3 x 10 - #9	2 - #5	#5 @ 5.0"	-	
	LB3	66	30	3 x 8 - #9	2 - #5	#5 @ 4.0"	-	
	LB4, LB5, LB8, LB9	120	42	3 x 10 - #9	3 - #5	#5 @ 6.0"	-	
	LB10	124	24	4 - #9	2 - #5	#4 @ 6.0"	-	
	LB11	111	24	4 - #9	2 - #5	#4 @ 6.0"	-	
	LB12, LB13	120	24	4 - #9	2 - #5	#4 @ 6.0"	-	
	LB1, LB6	124	474	8 - #8	40 - #8	#8 @ 12.0"	-	
2	LB2	111	474	8 - #8	40 - #8	#8 @ 12.0"	-	
	LB3	66	474	8 - #8	40 - #8	#8 @ 12.0"	-	
	LB4, LB5	120	474	8 - #8	40 - #8	#8 @ 12.0"	-	
	LB7	80	474	8 - #8	40 - #8	#8 @ 12.0"	-	
	LB8, LB9	46	474	8 - #8	40 - #8	#8 @ 12.0"	-	
	LB10	124	474	8 - #8	40 - #8	#8 @ 12.0"	-	
	LB11	111	474	8 - #8	40 - #8	#8 @ 12.0"	-	
	LB12, LB13	120	474	8 - #8	40 - #8	#8 @ 12.0"	-	

NOTE: SEE S-356 FOR LINK BEAM DETAILS W/ EMBEDDED STEEL SHAPES.

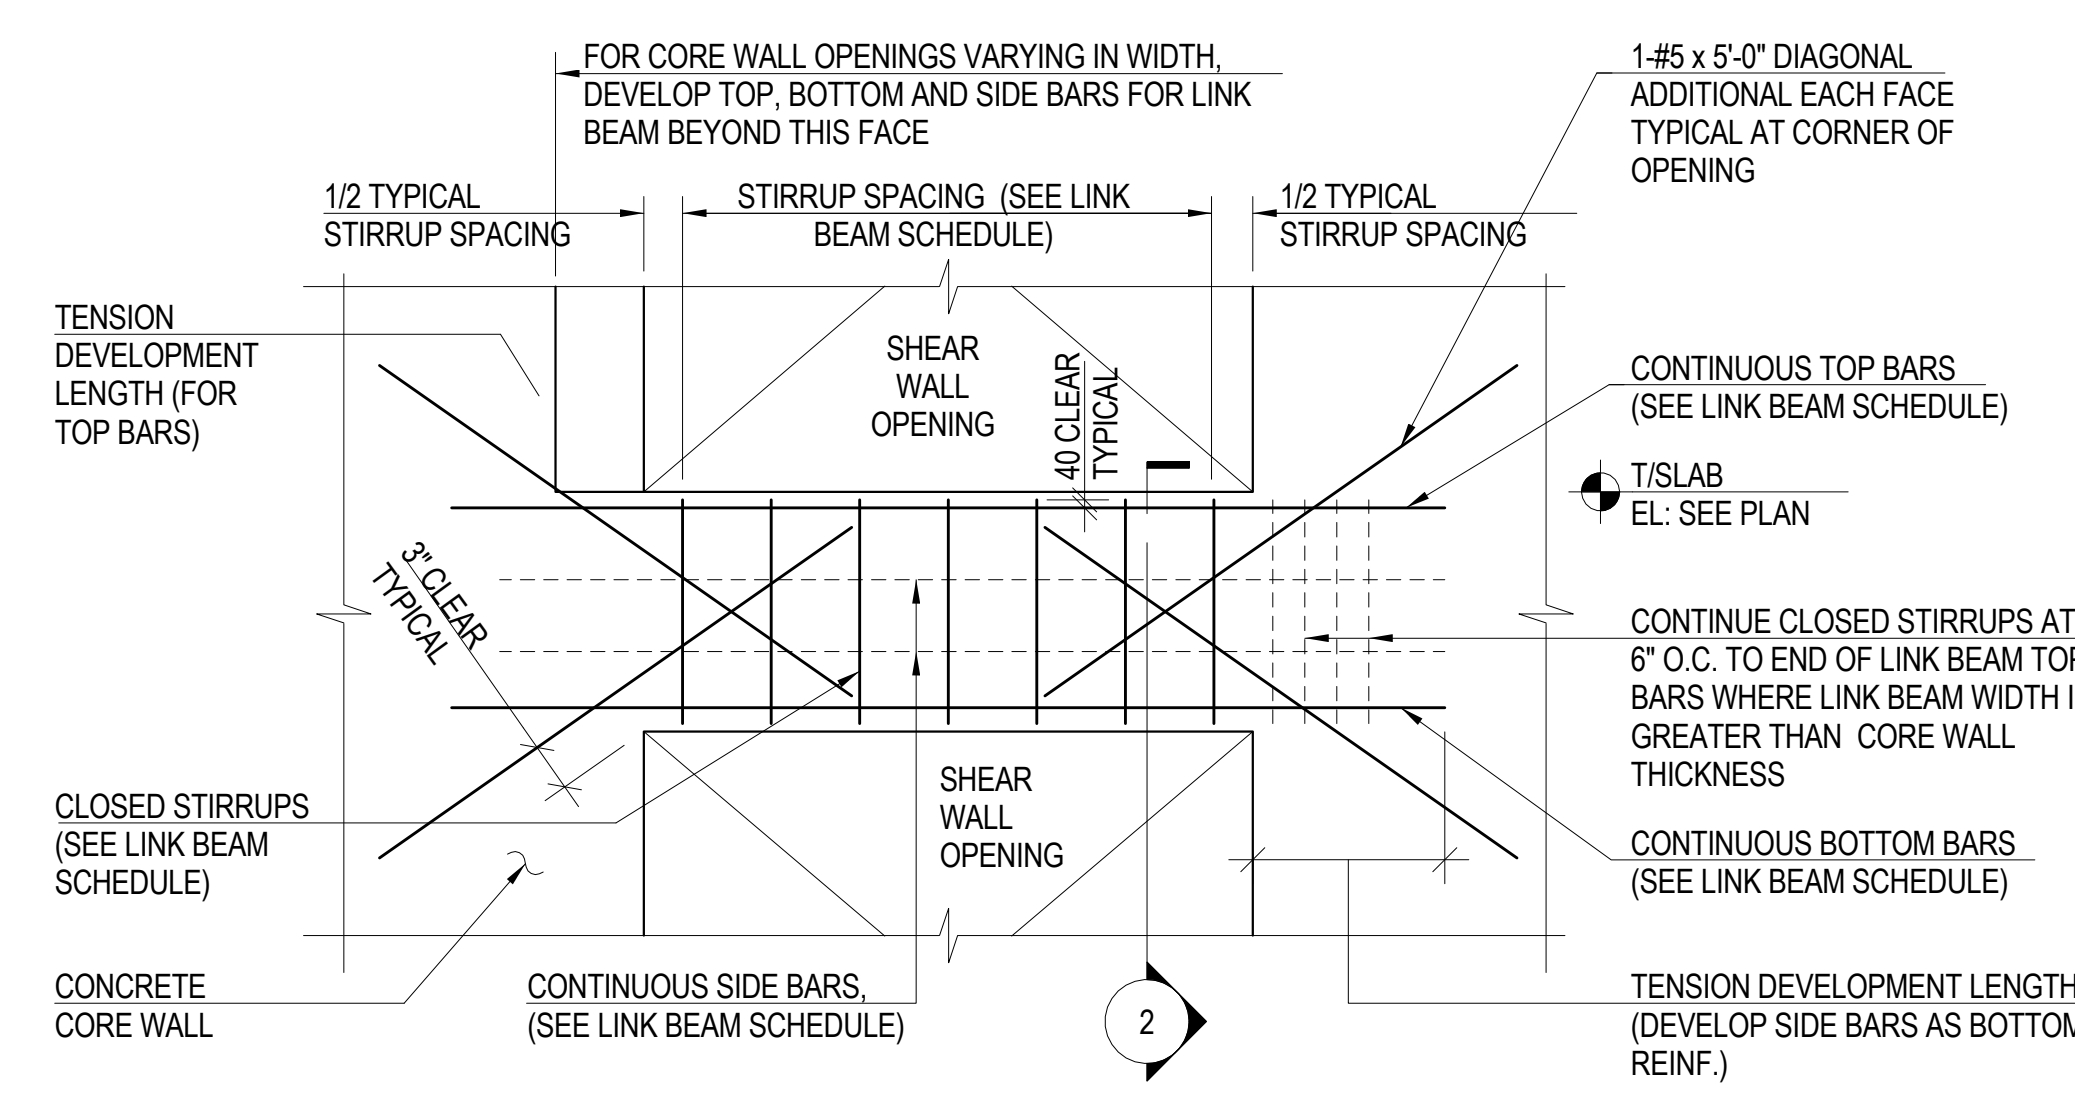


NOTES: 1. CORE WALL REINFORCEMENT NOT SHOWN FOR CLARITY.
2. SEE CORE WALL ELEVATION FOR SIZE OF OPENINGS.


1 TYPICAL LINK BEAM ELEVATION FOR SHEAR SPAN-TO-DEPTH RATIO LESS THAN 2.0
1" = 1'-0"

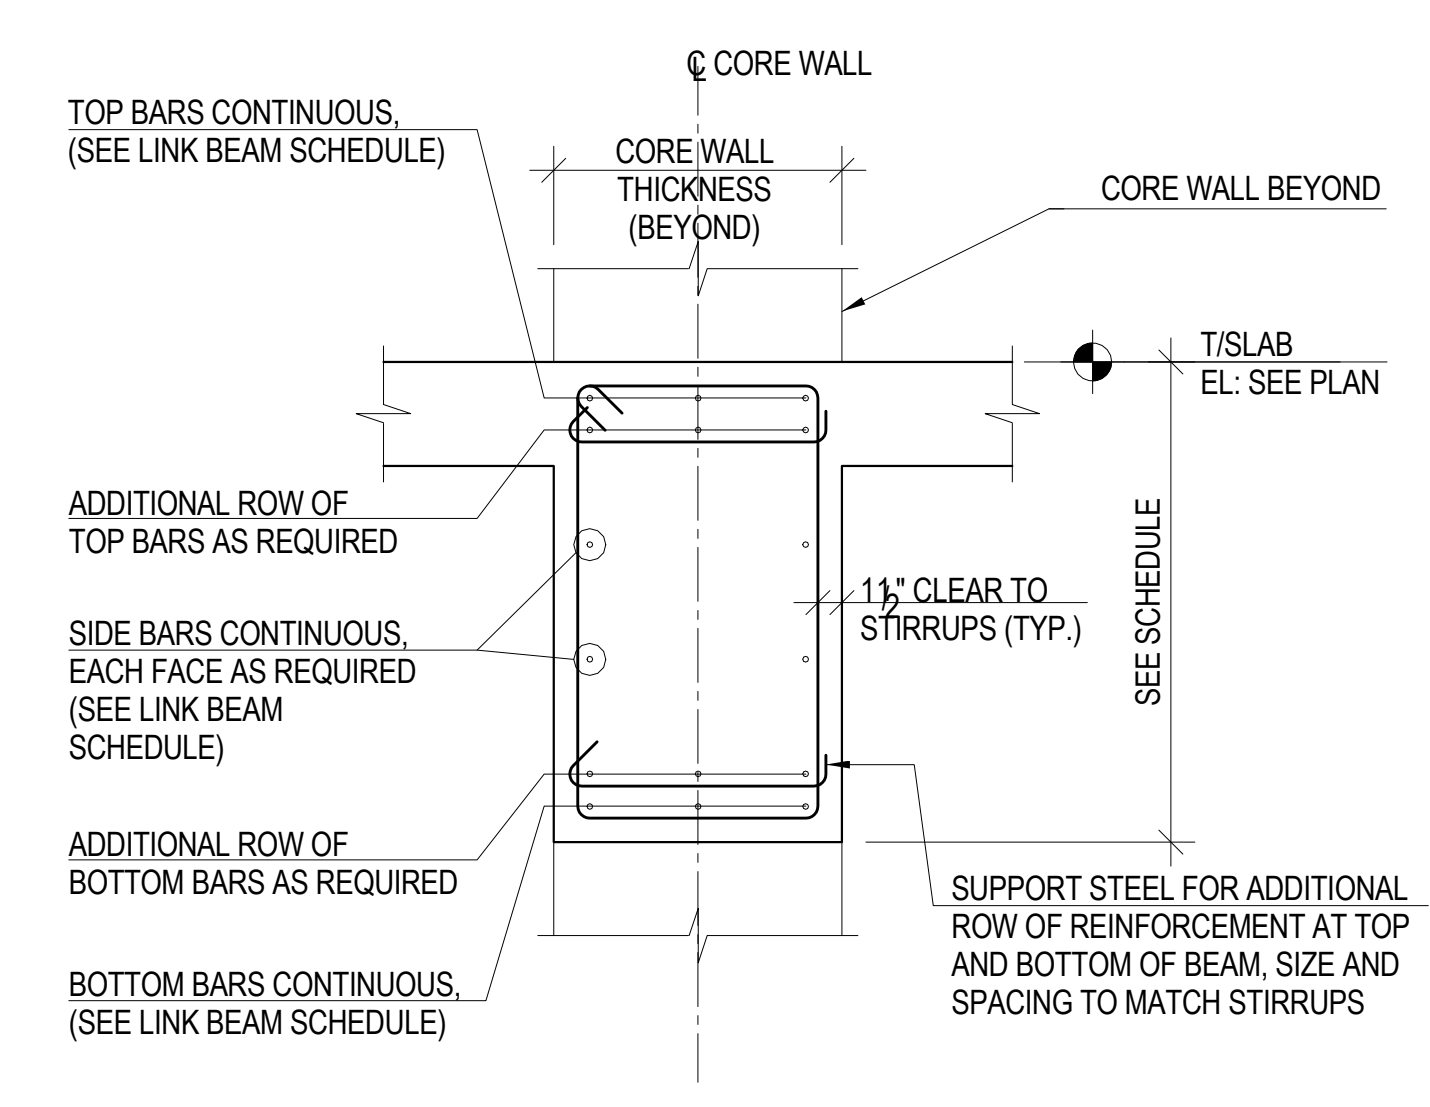


NOTES: 1. SLAB REINFORCEMENT NOT SHOWN FOR CLARITY.

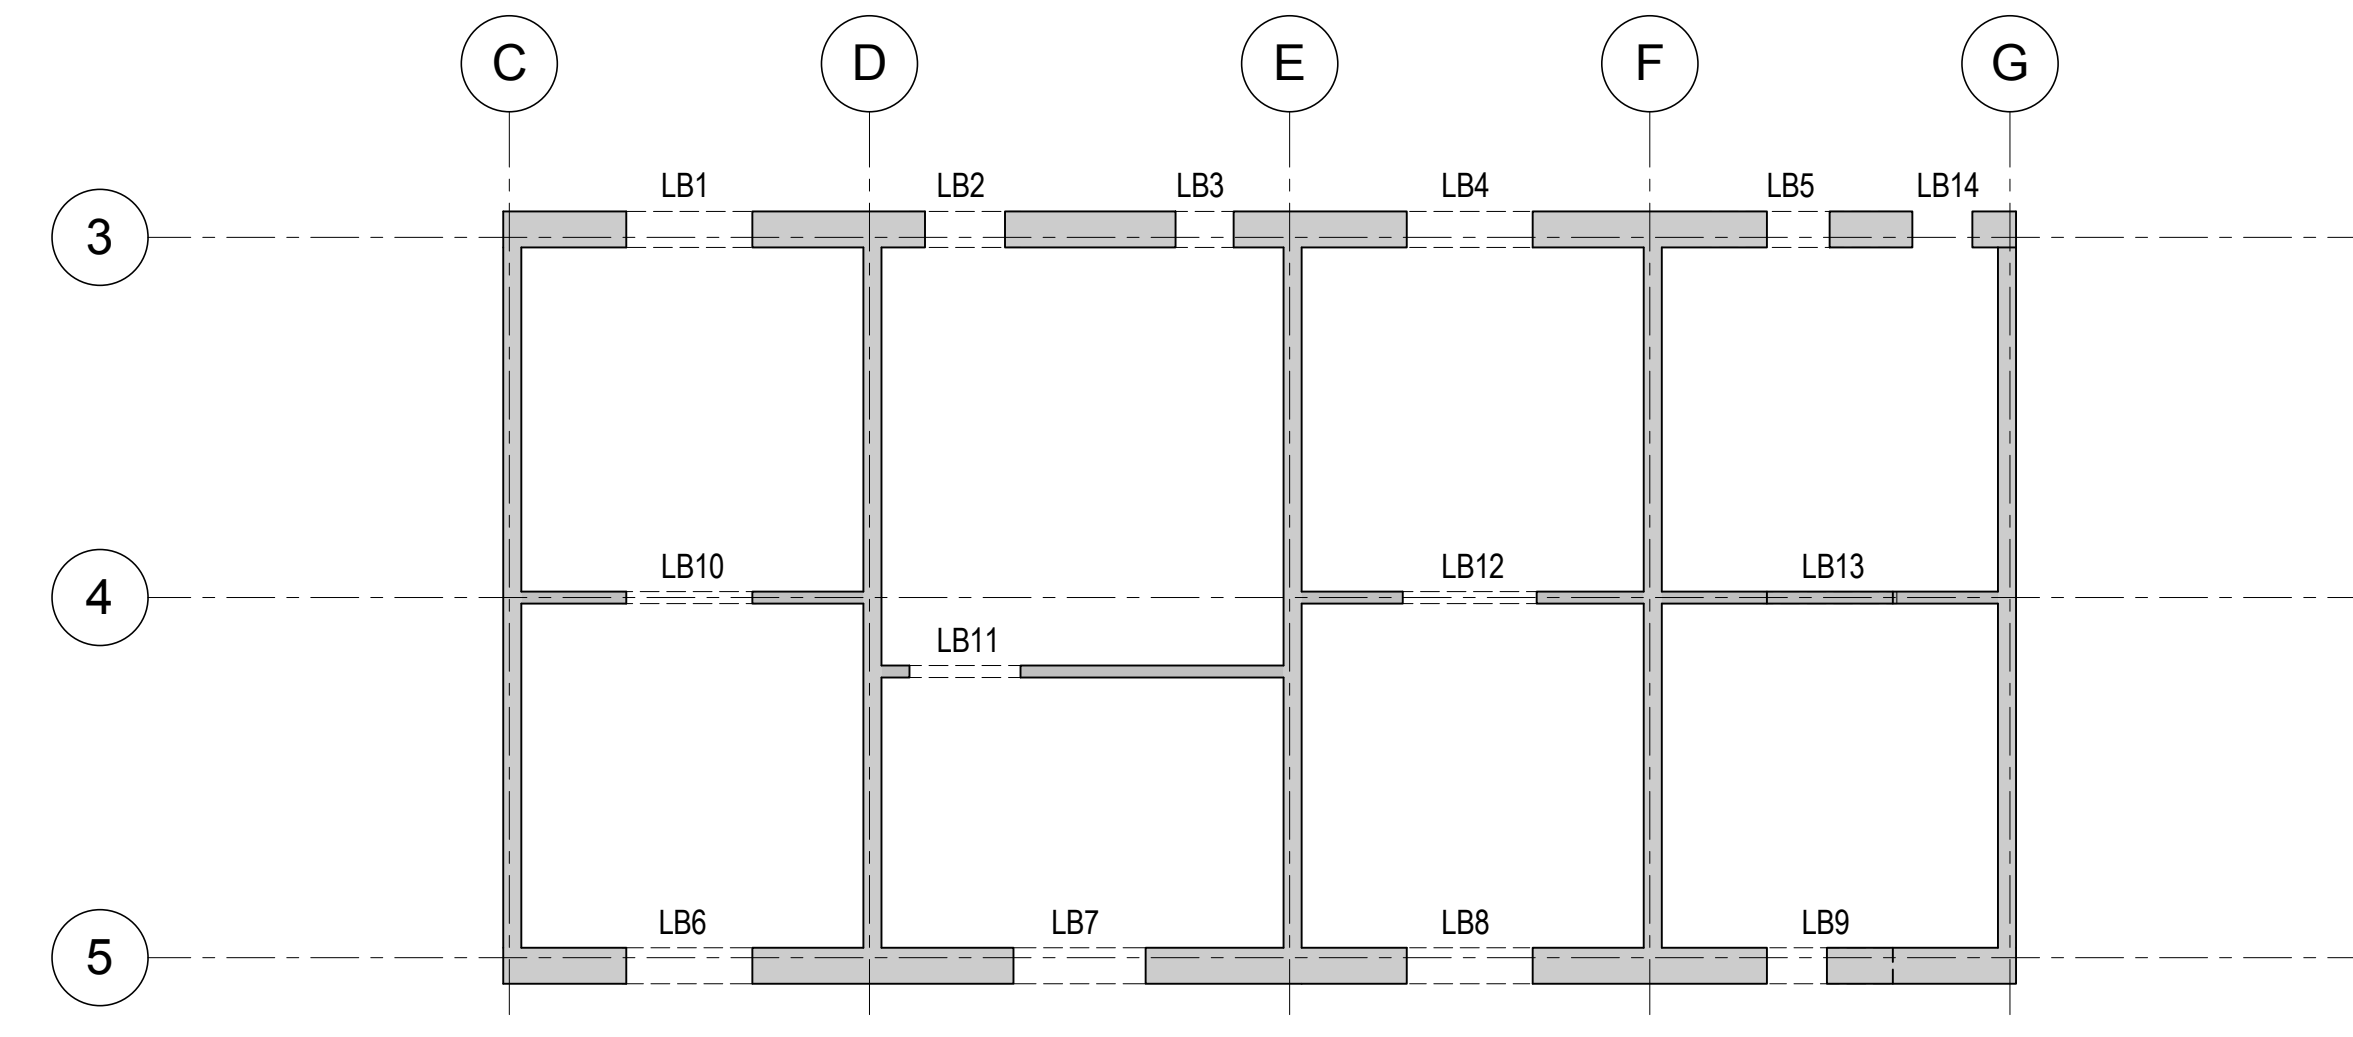


A KEY PLAN A - LEVEL 6 TO LEVEL 31 KEY PLAN
1/16" = 1'-0"

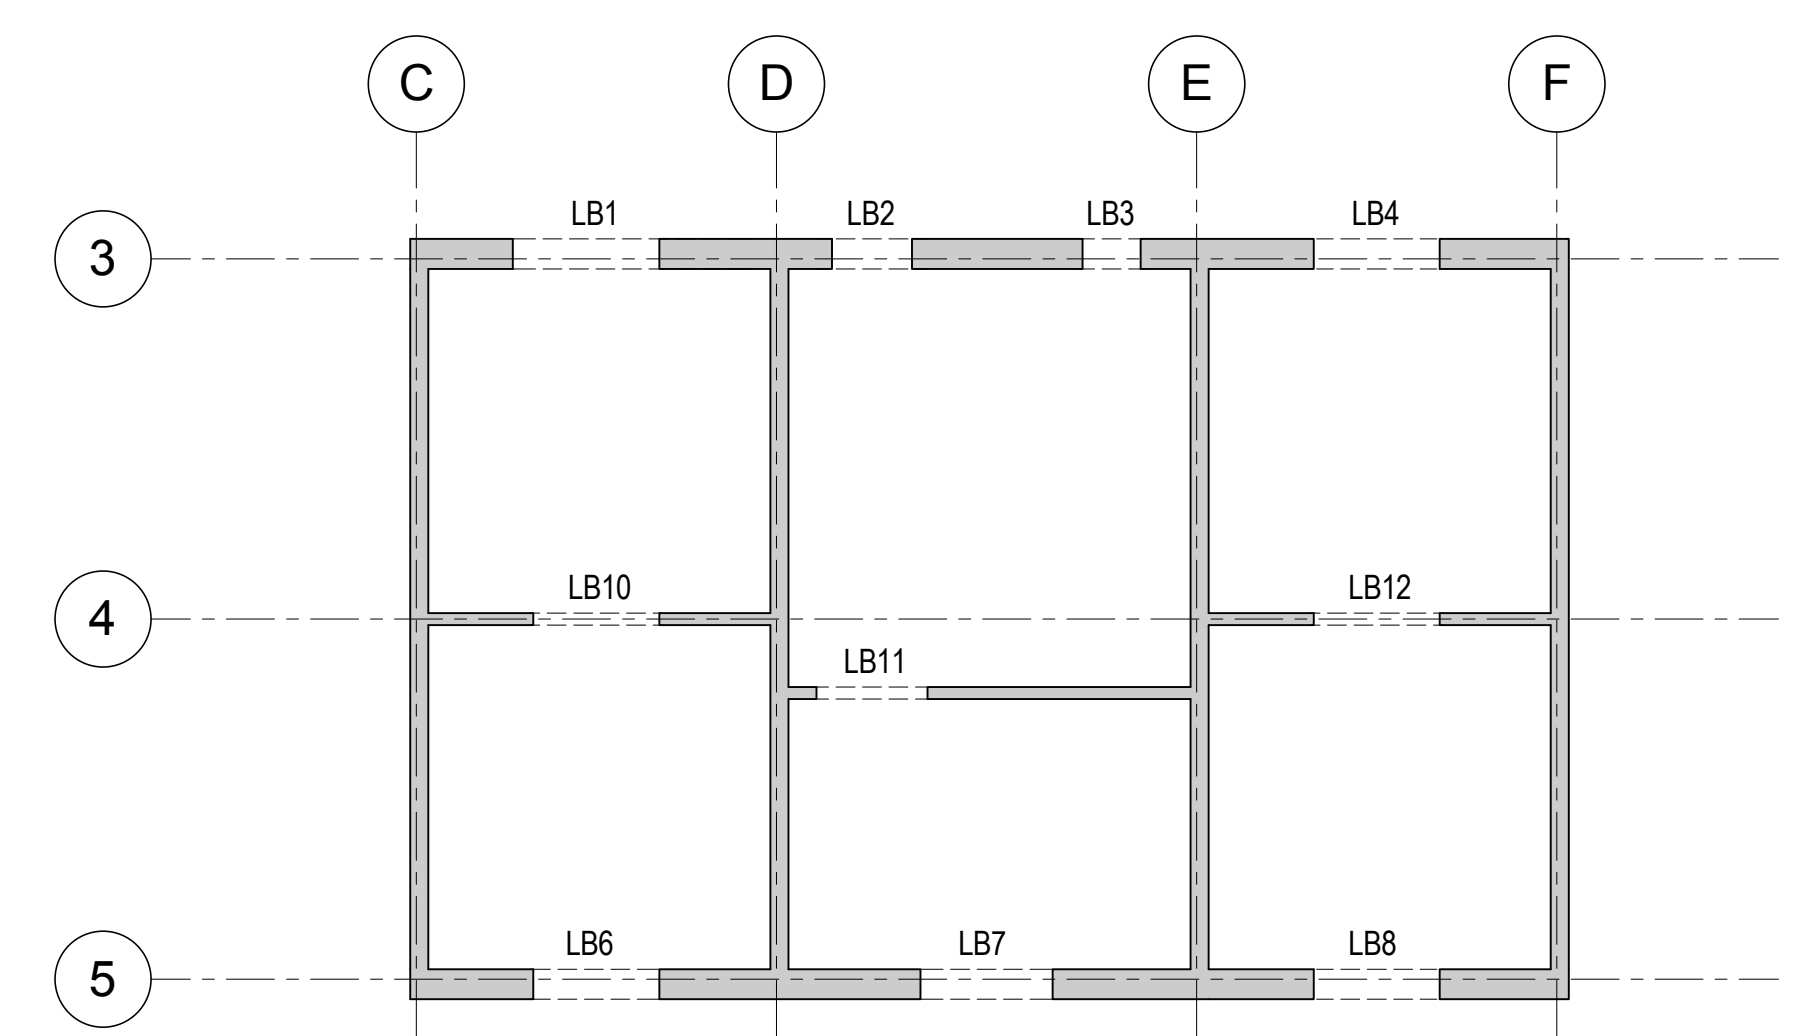


B KEY PLAN B - LEVEL 31 TO 53
1/16" = 1'-0"

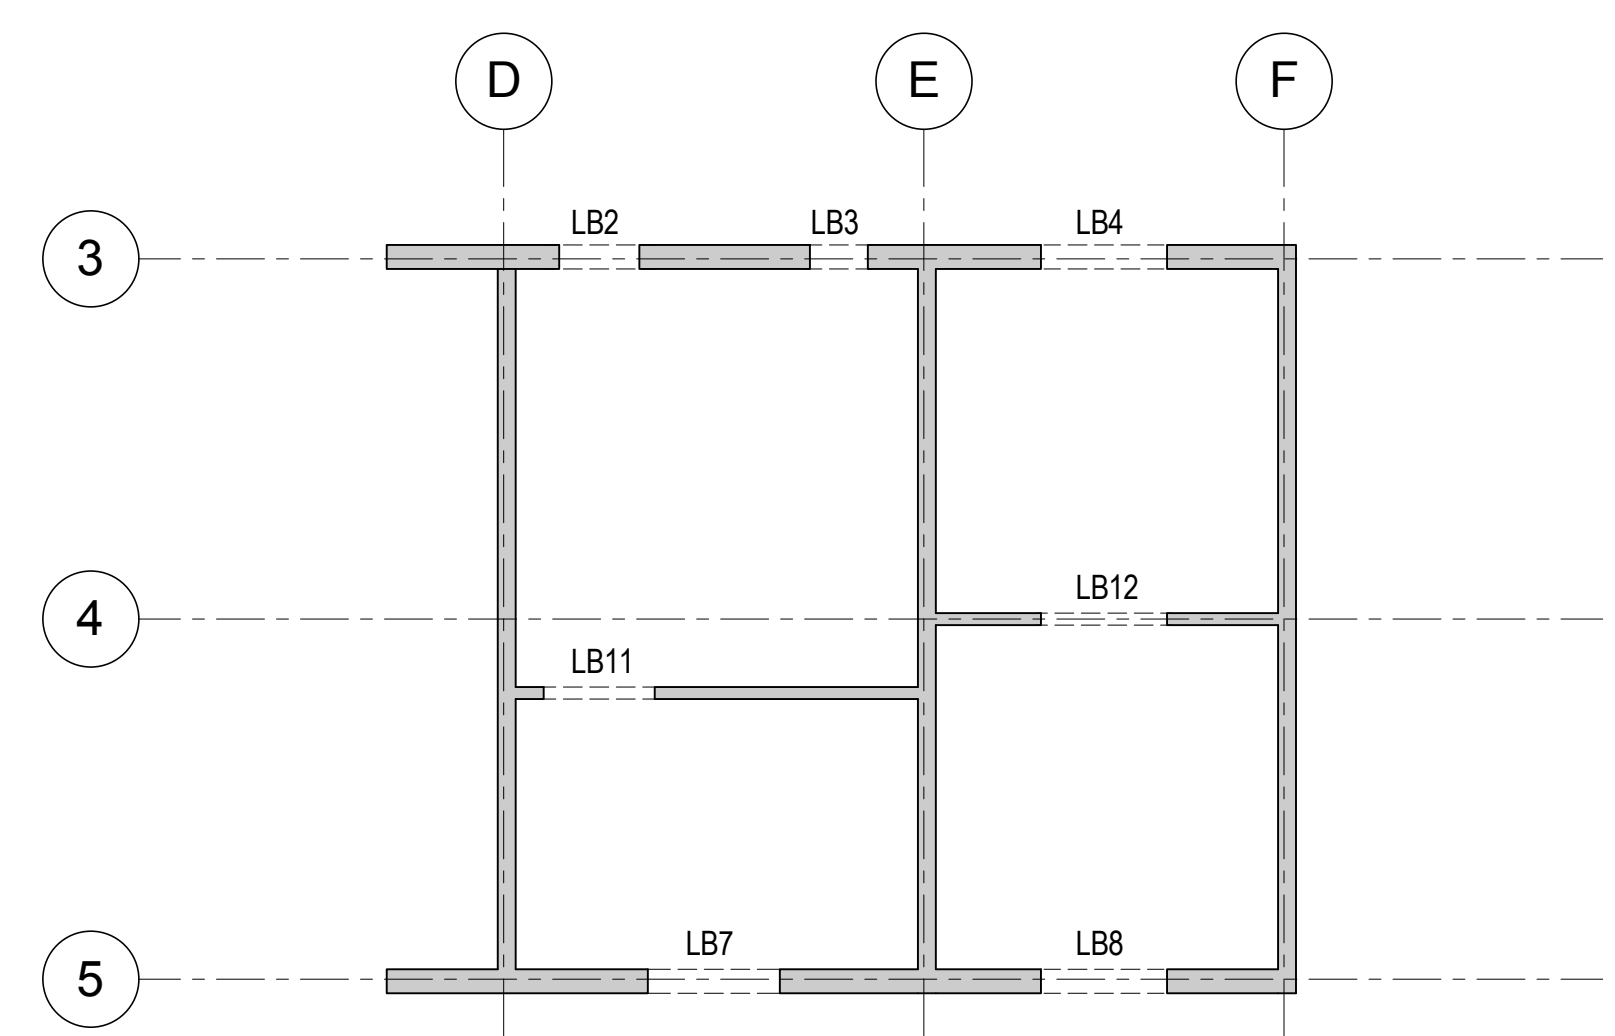


C KEY PLAN C - LEVEL 53 TO ROOF
1/16" = 1'-0"

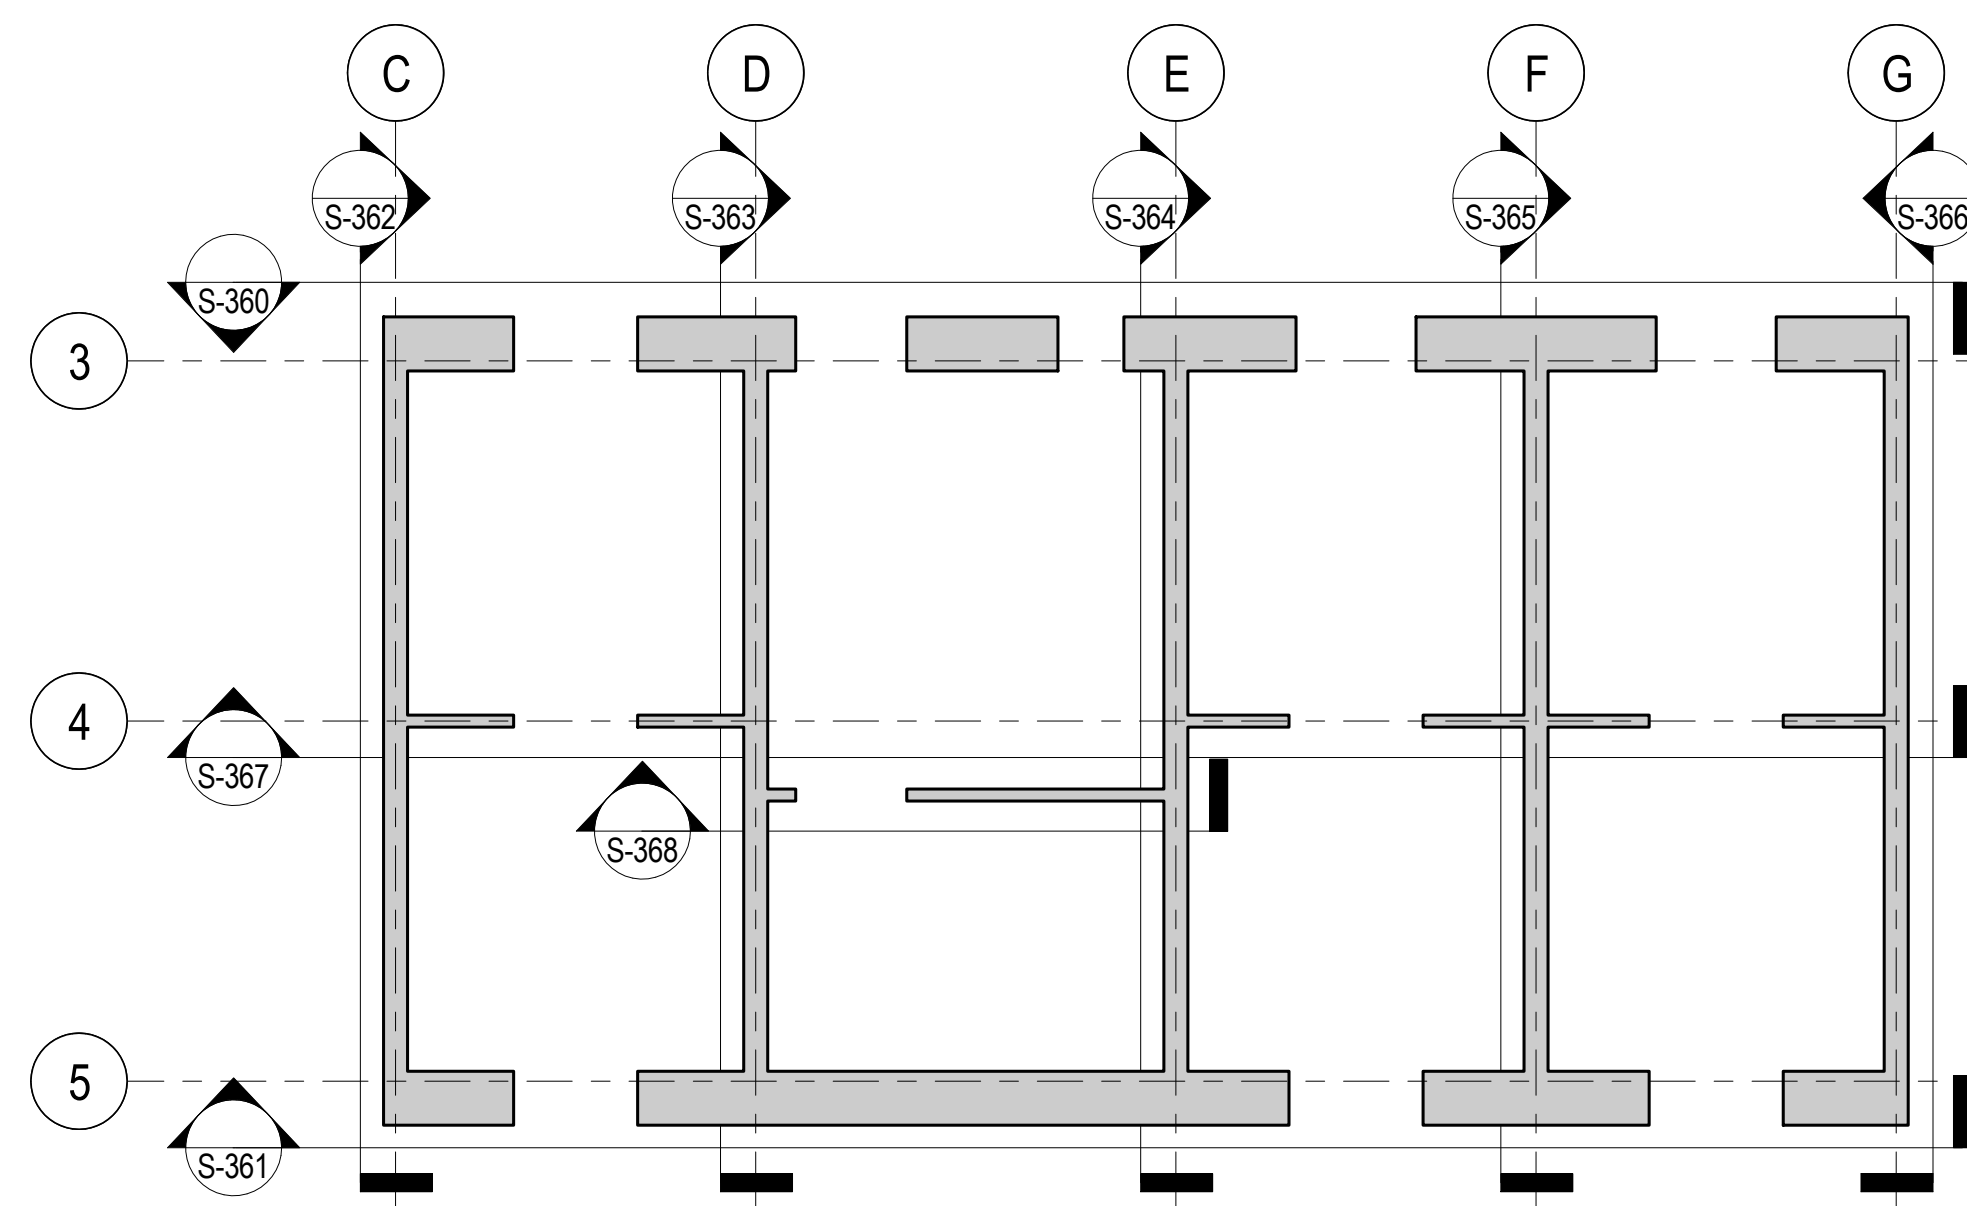


CORE WALL ELEVATION KEY PLAN
NTS

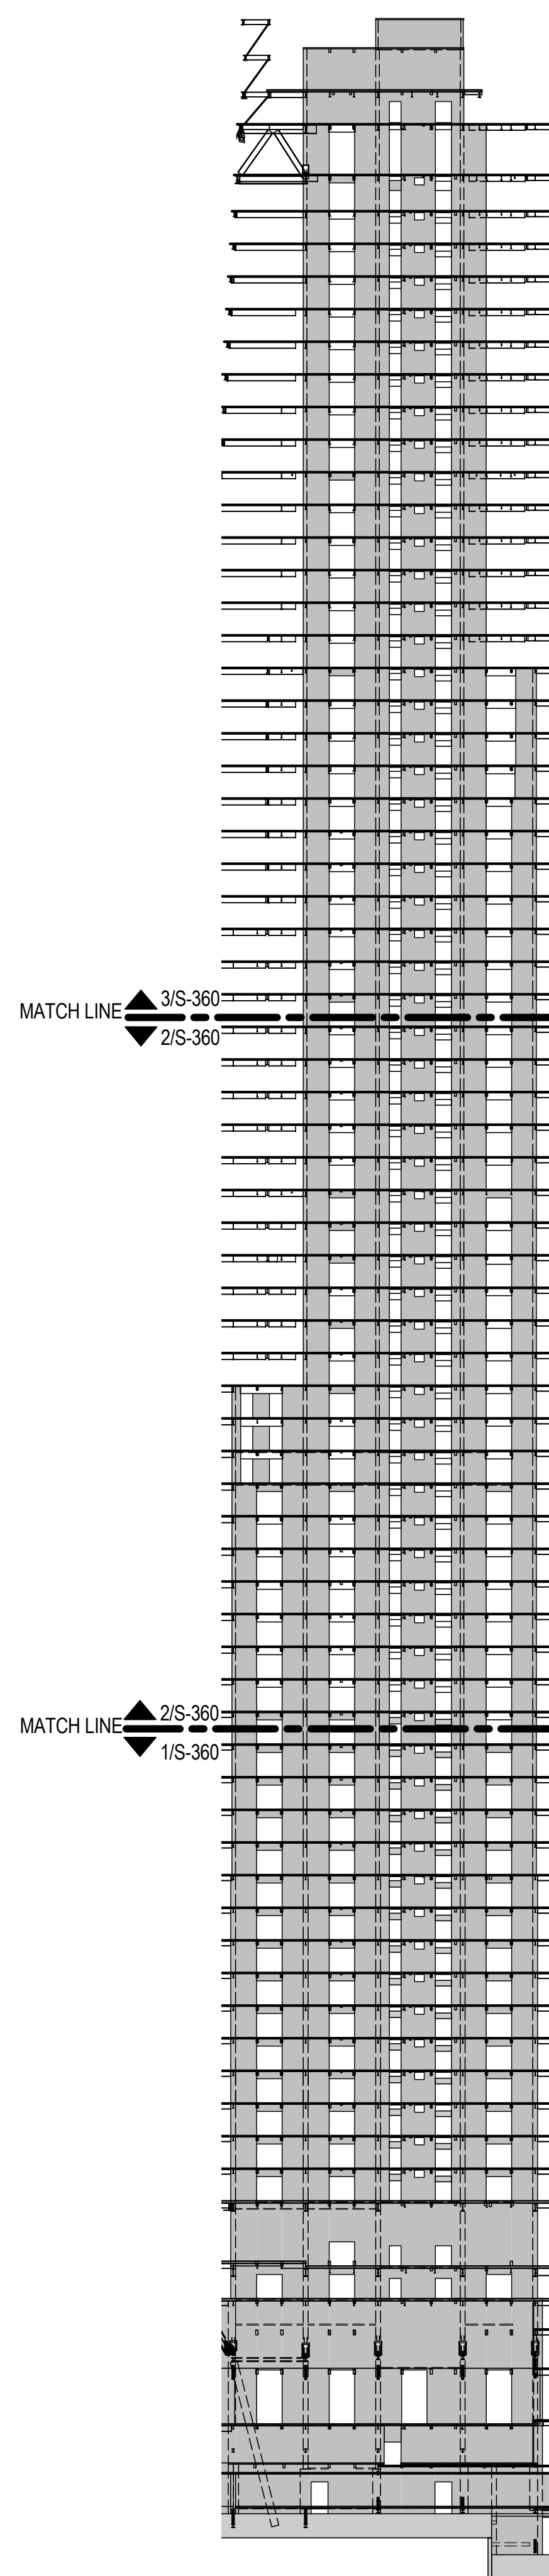


ELEVATION KEY
N.T.S.

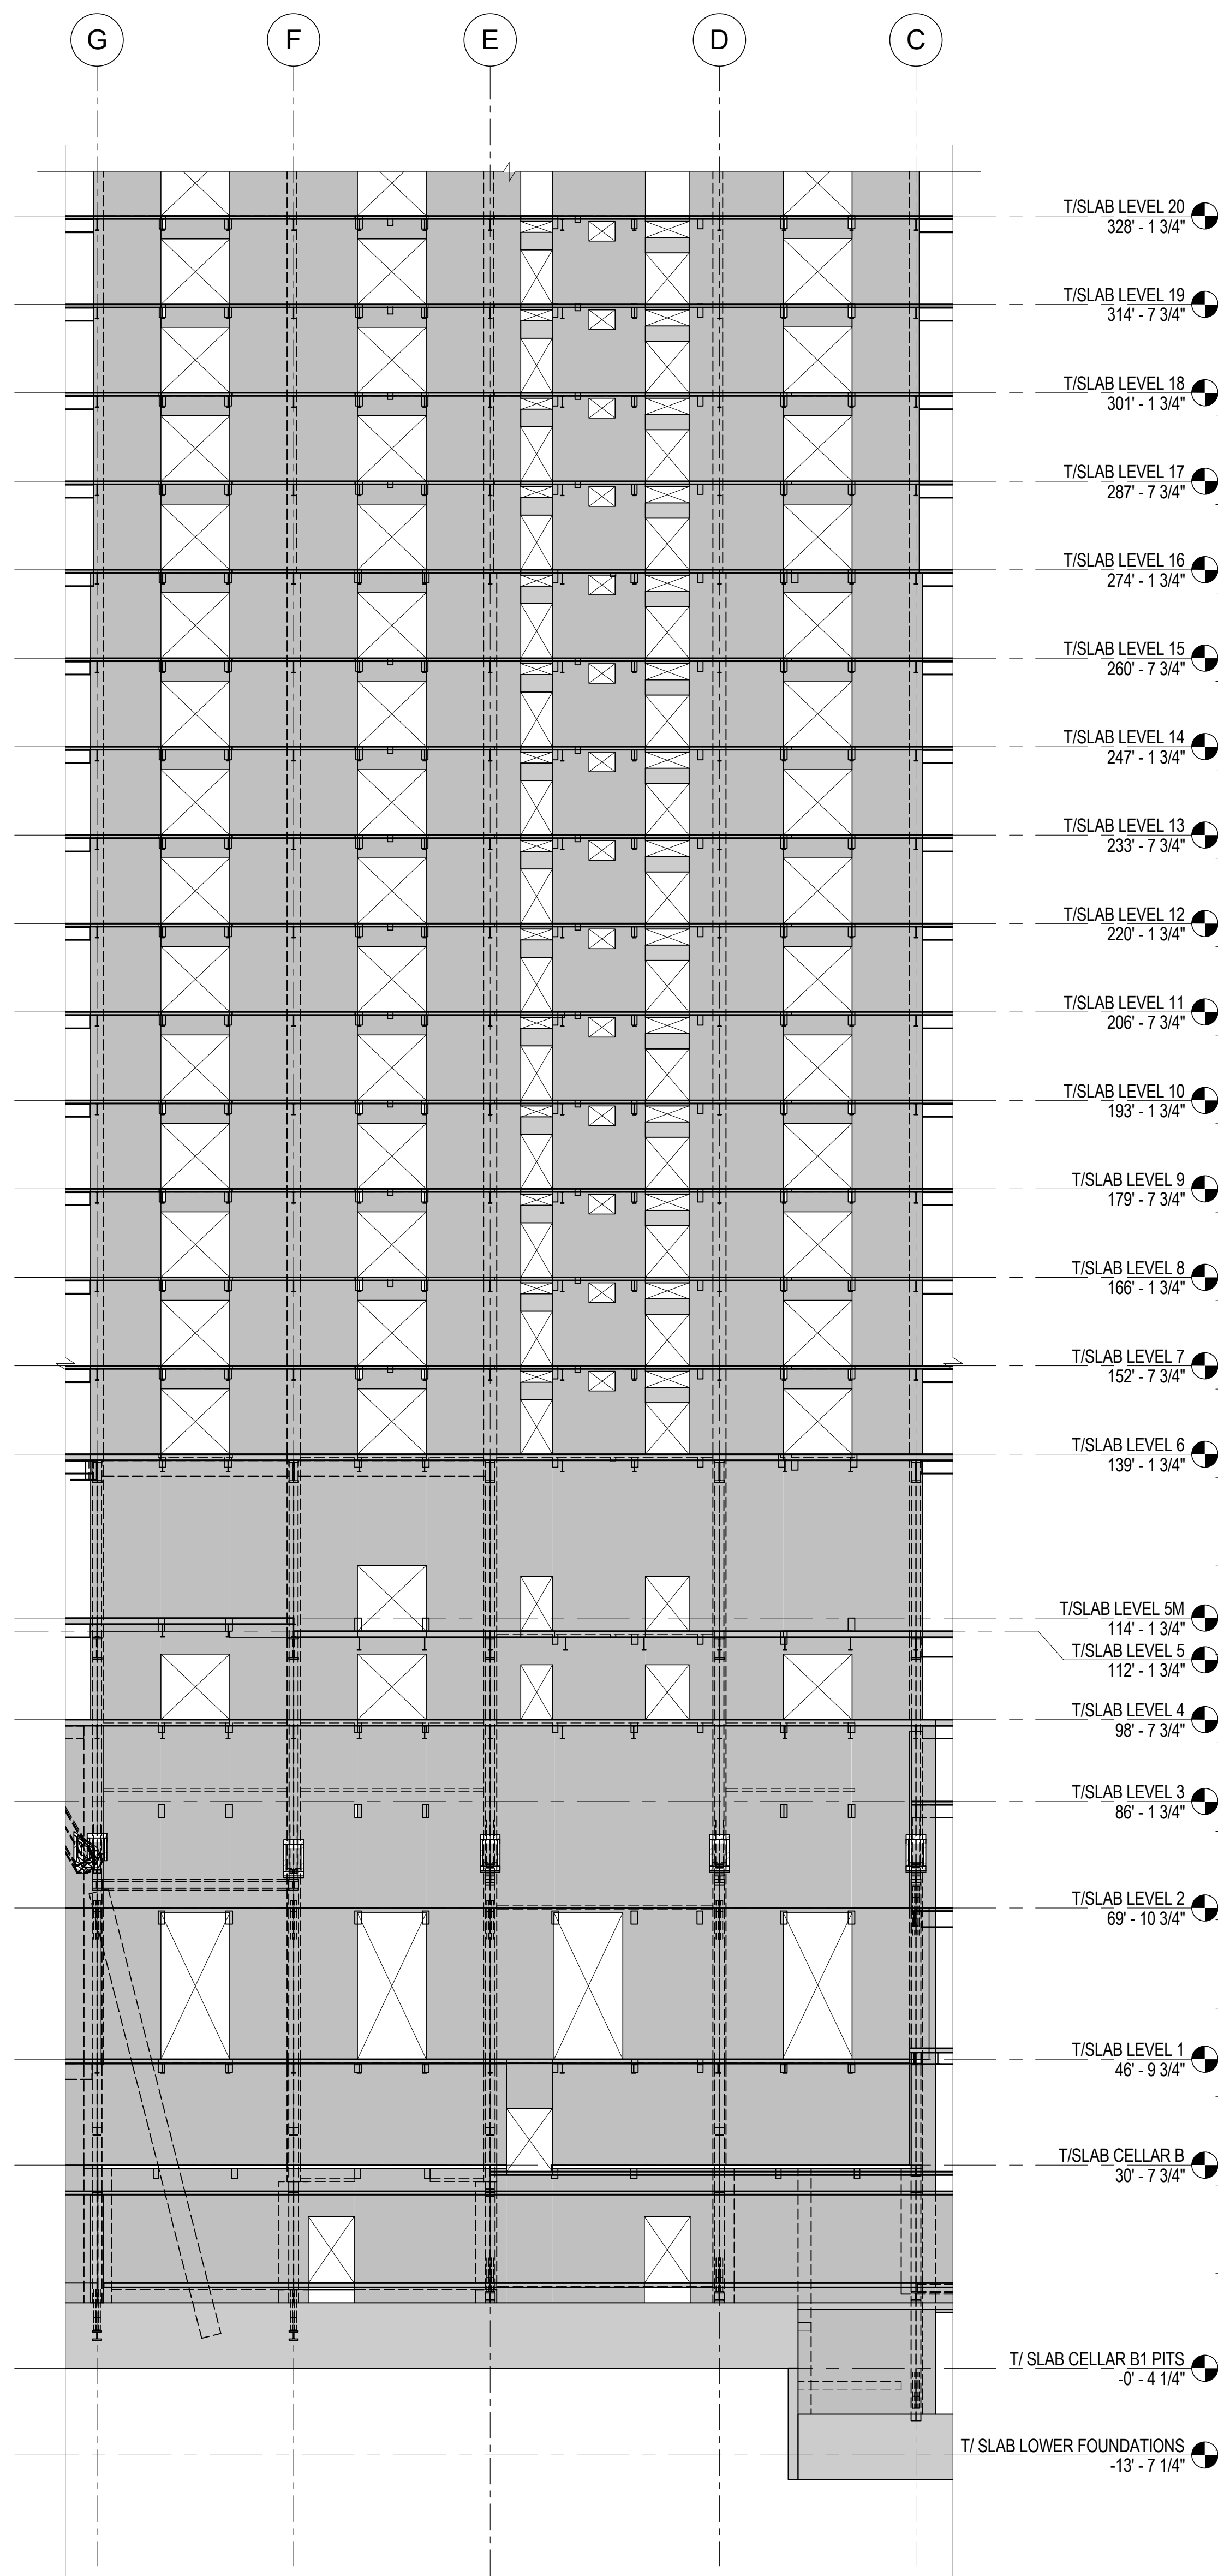

1 ELEVATION ALONG LINE 3
1/16" = 1'-0"

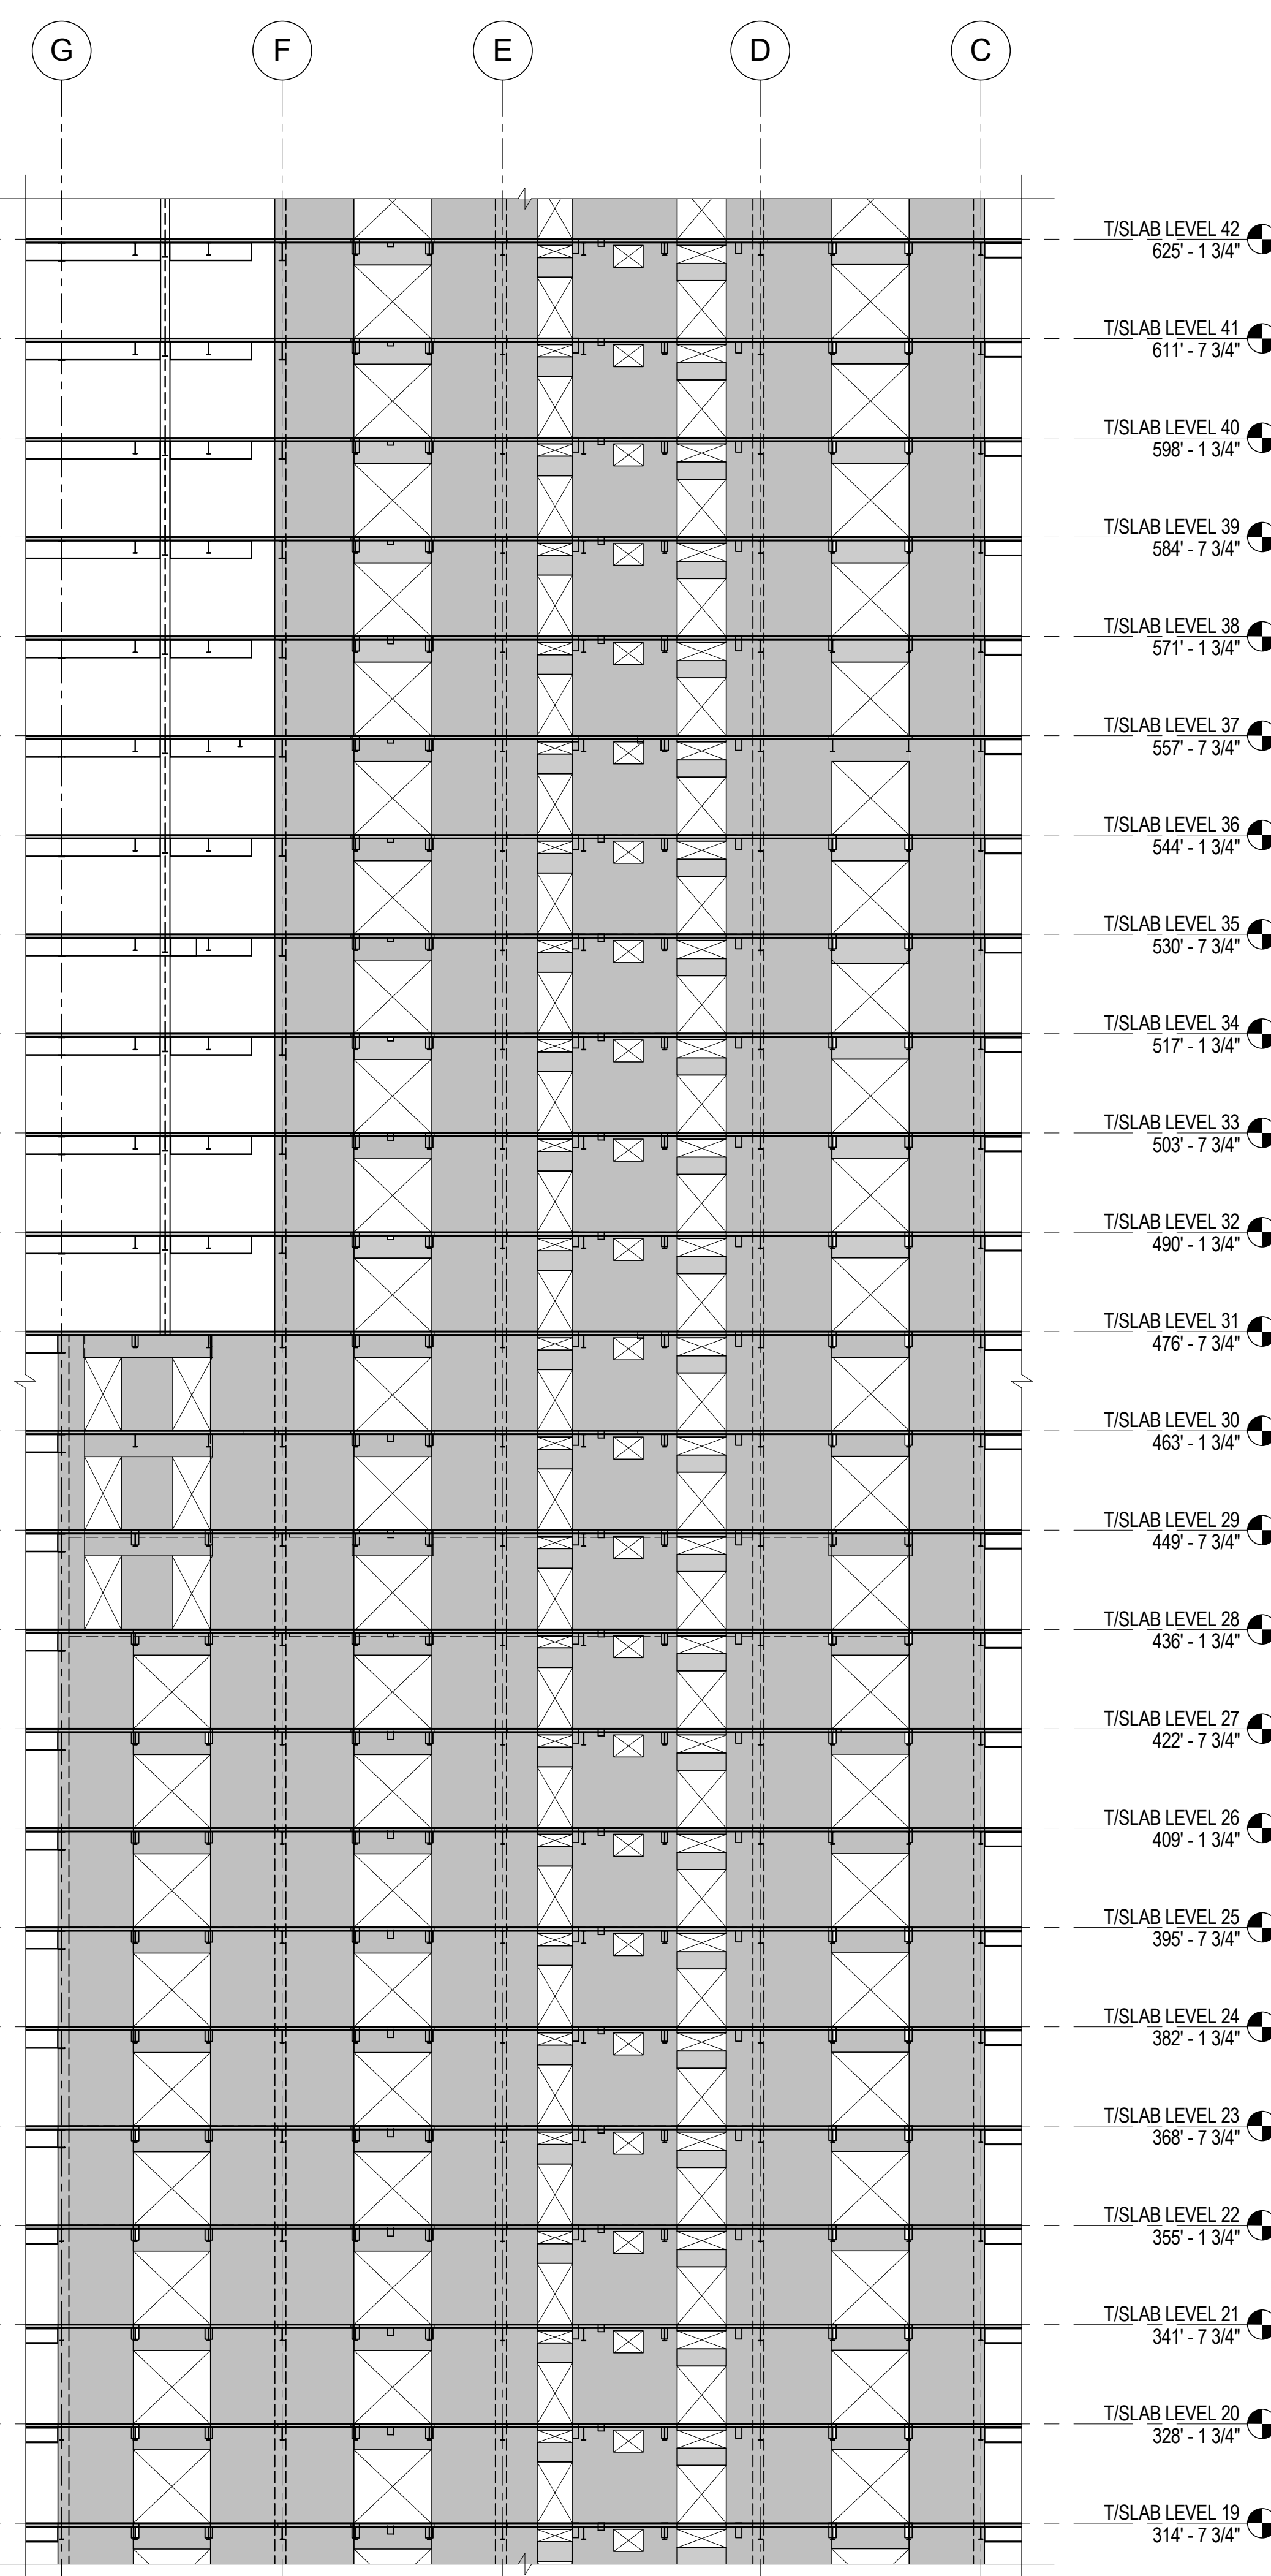

2 ELEVATION ALONG LINE 3
1/16" = 1'-0"

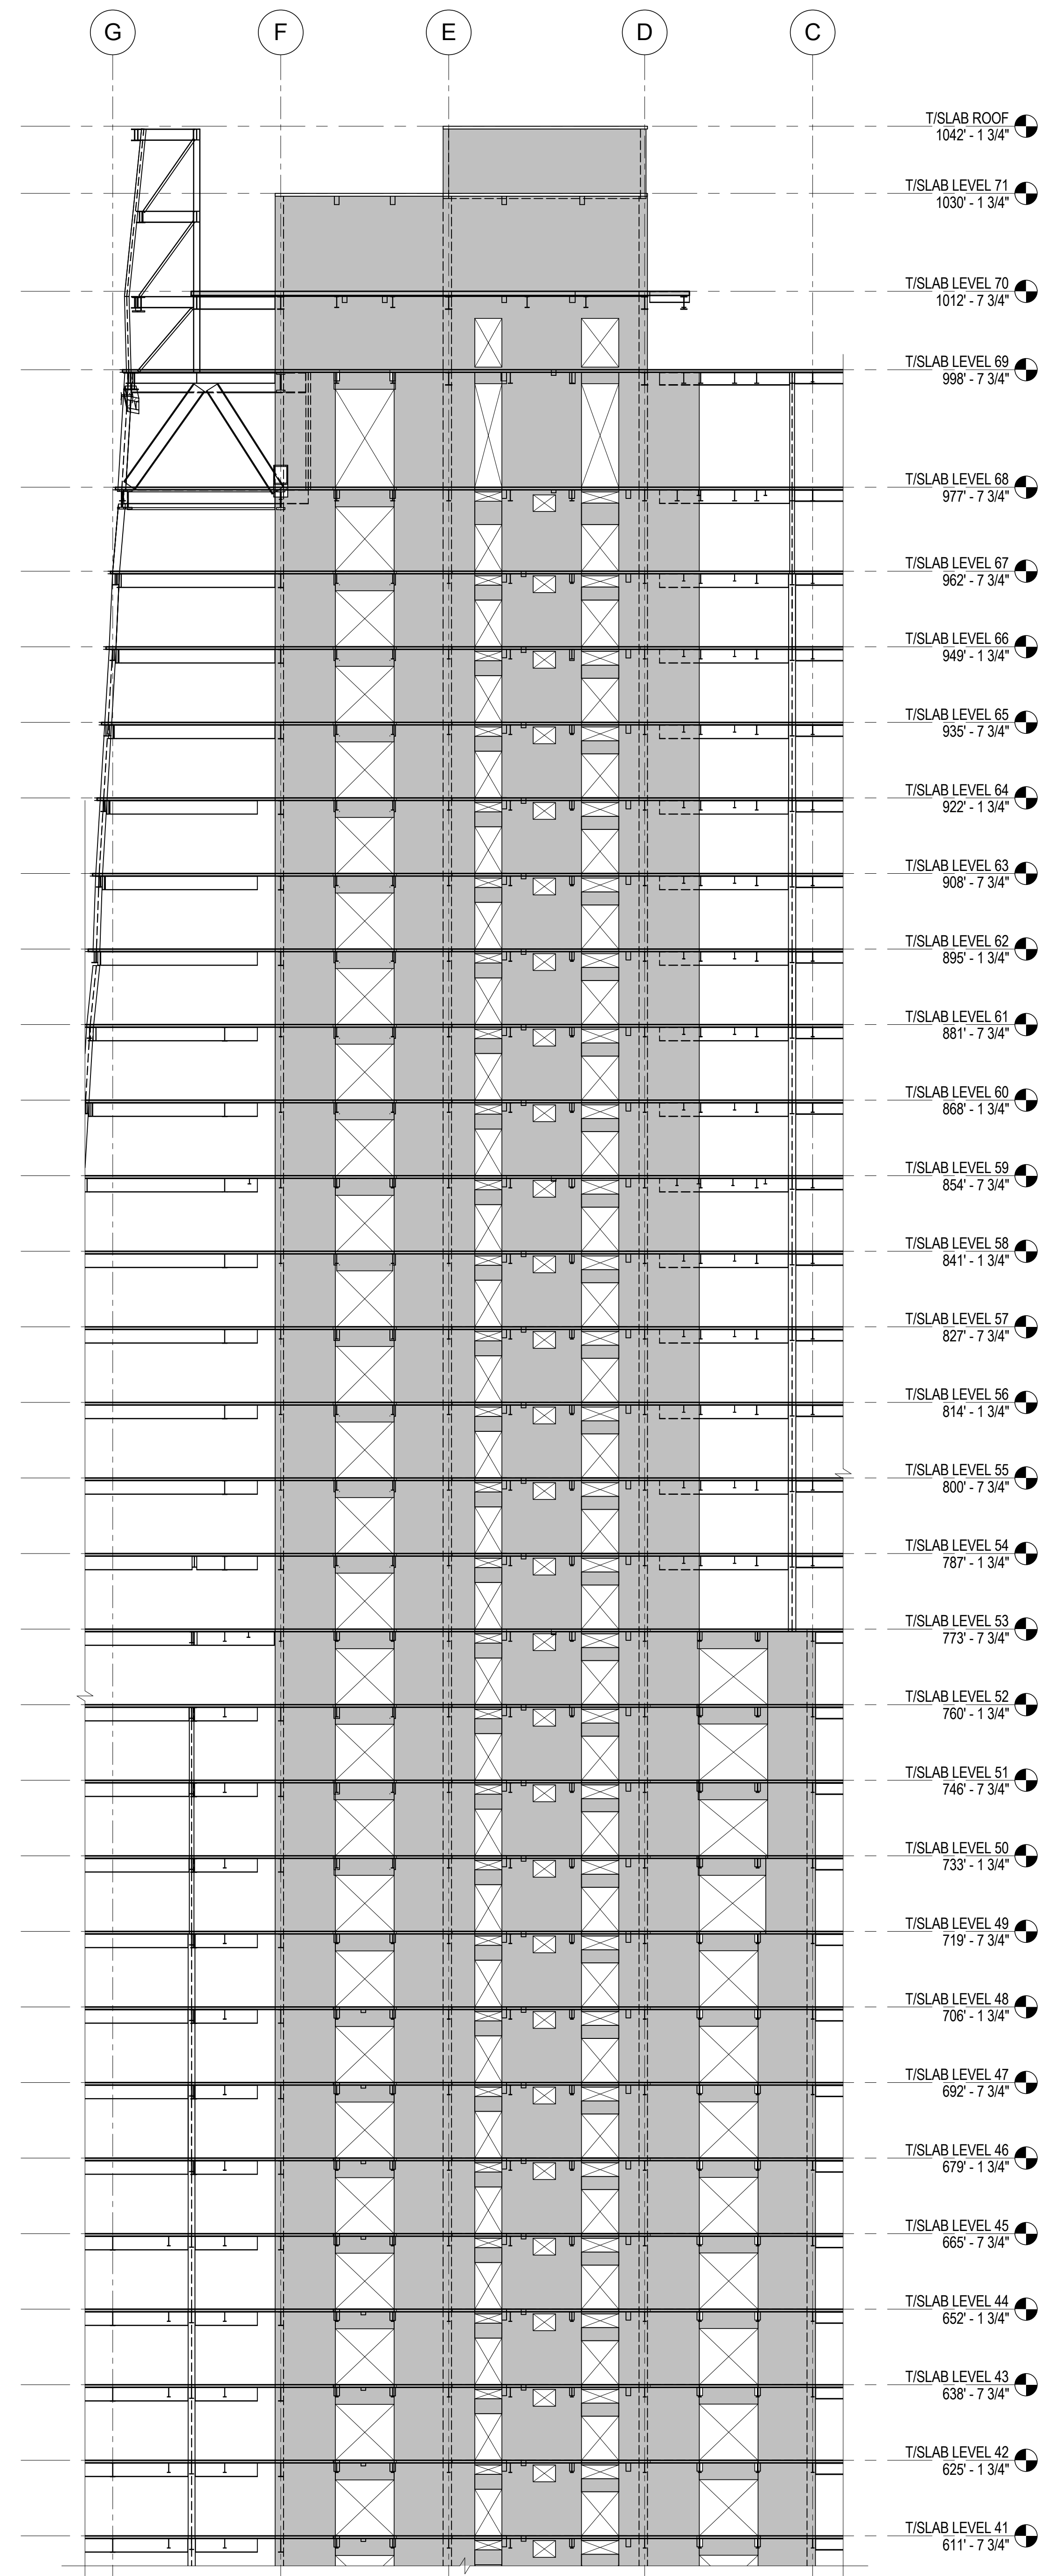

3 ELEVATION ALONG LINE 3
1/16" = 1'-0"

MANHATTAN WEST:
NORTH TOWER
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Vibration Consultant
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166 Ames Street, Hackensack, NJ 07601

Wind Tunnel Consultant
Rowan Williams Davies & Irwin Inc.
680 Woodlawn Road West, Guelph
Ontario, Canada N1K 1B8

Key Plan:

Seal & Signature:

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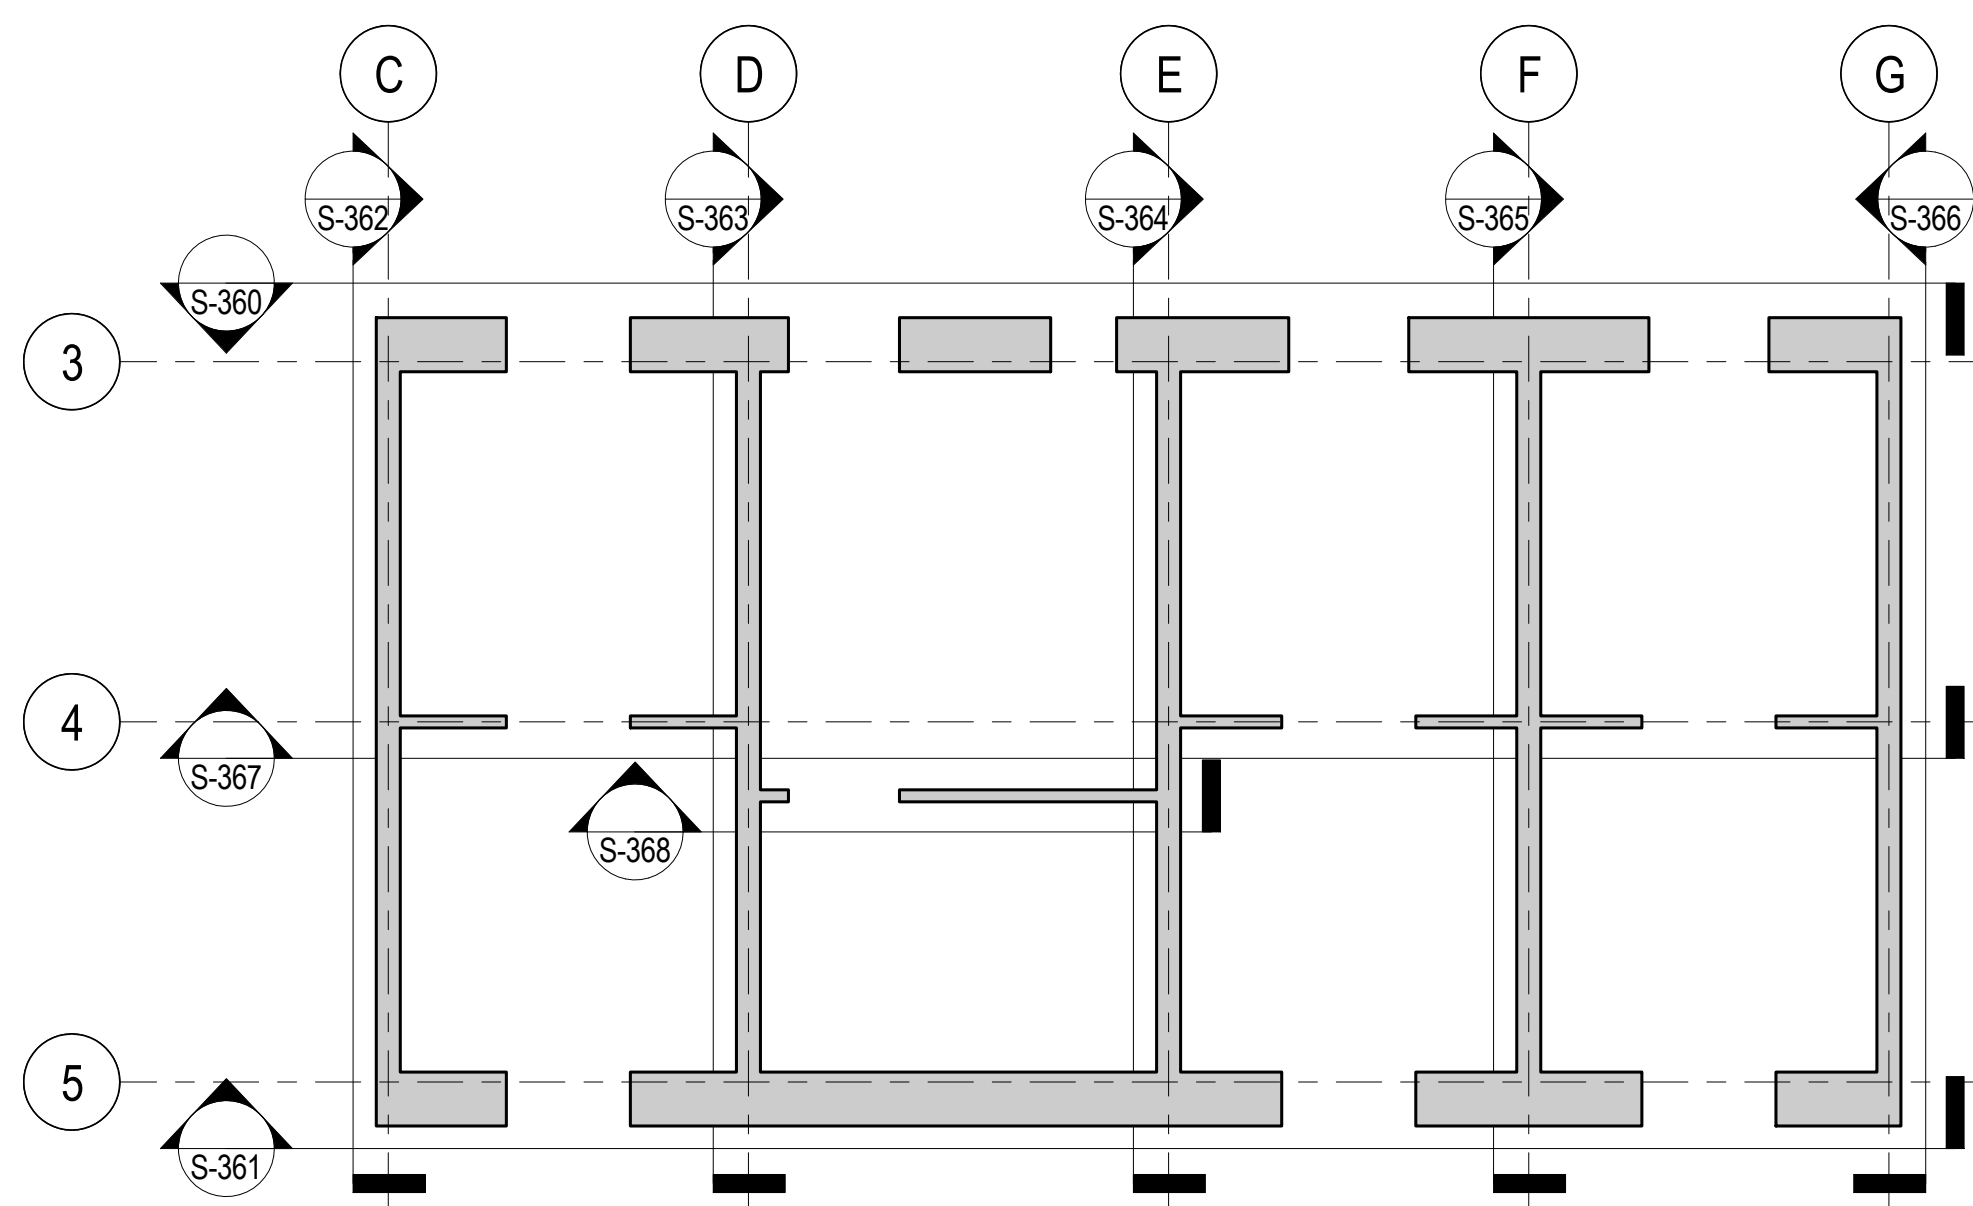
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5	20 JUN 2014	ISSUED FOR FOUNDATION PERMIT
4	20 DEC 2013	ISSUED FOR FOUNDATION PERMIT
3	15 NOV 2013	ISSUED FOR 2D PROGRESS PRICING
2	12 JUL 2013	ISSUED FOR 90% DESIGN DEVELOPMENT
1	18 MAR 2012	ISSUED FOR RECONCILIATION

Sheet Name: **CORE WALL ELEVATIONS ALONG LINE 3**


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211157	S-360.00

Date:	Scale:
20 JUN 2014	As indicated


File No.:	Page No.:
S-360	64 of 90




CORE WALL ELEVATION KEY PLAN
NTS

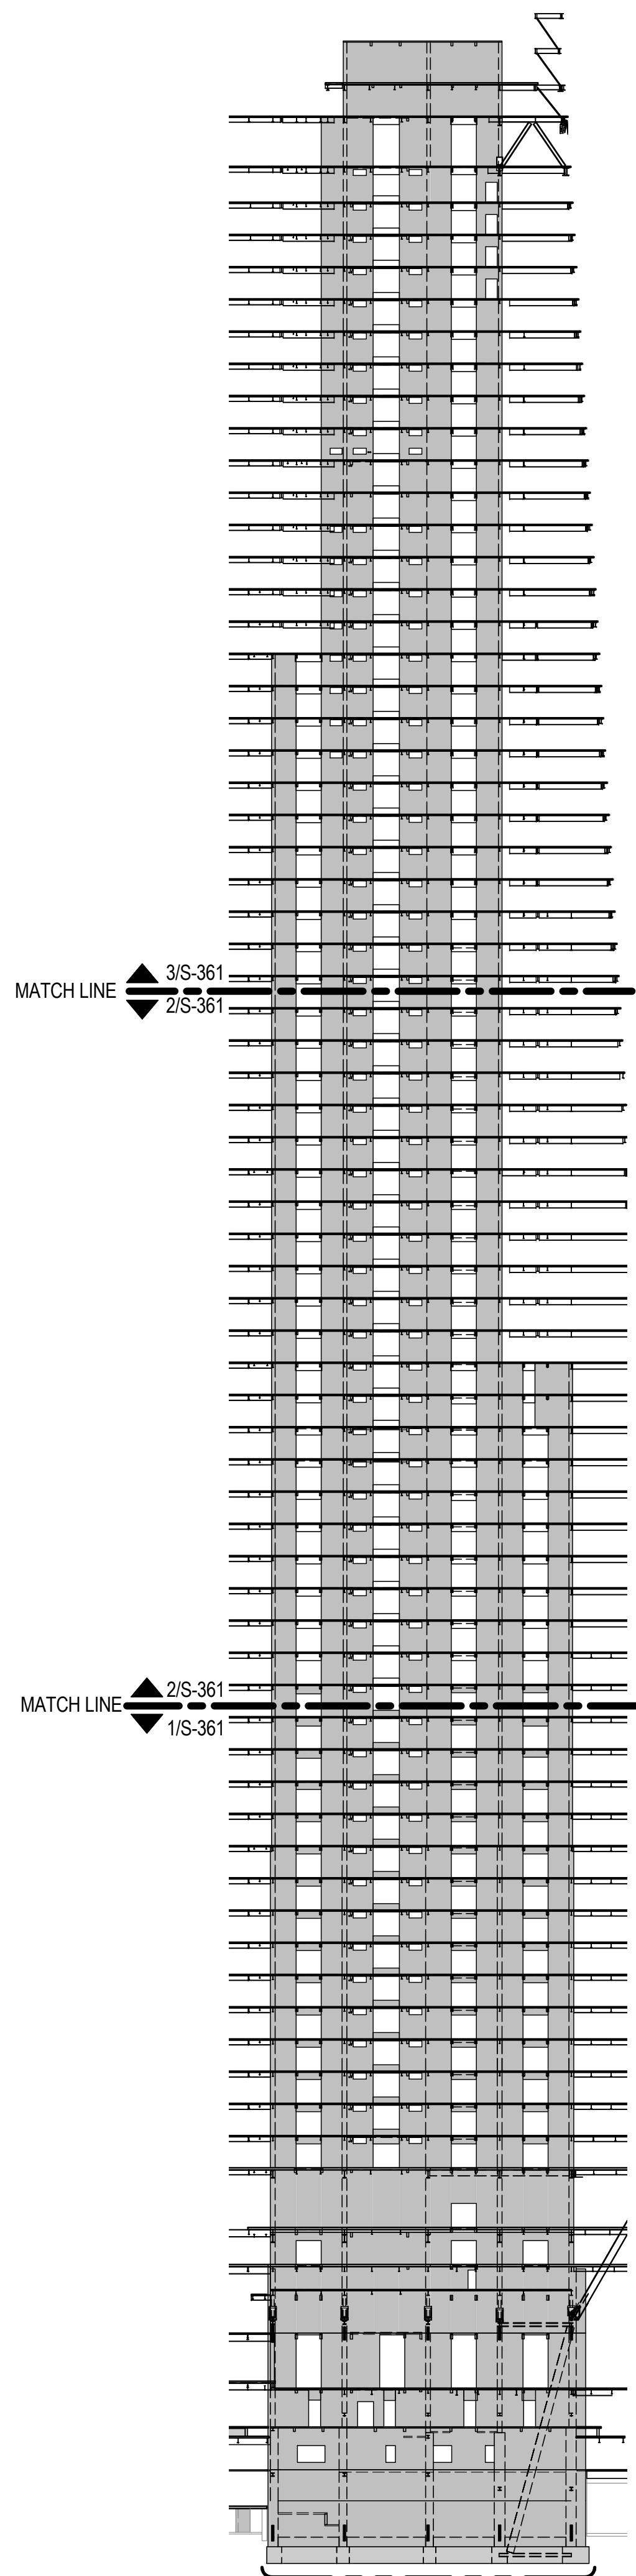


ELEVATION KEY
NTS

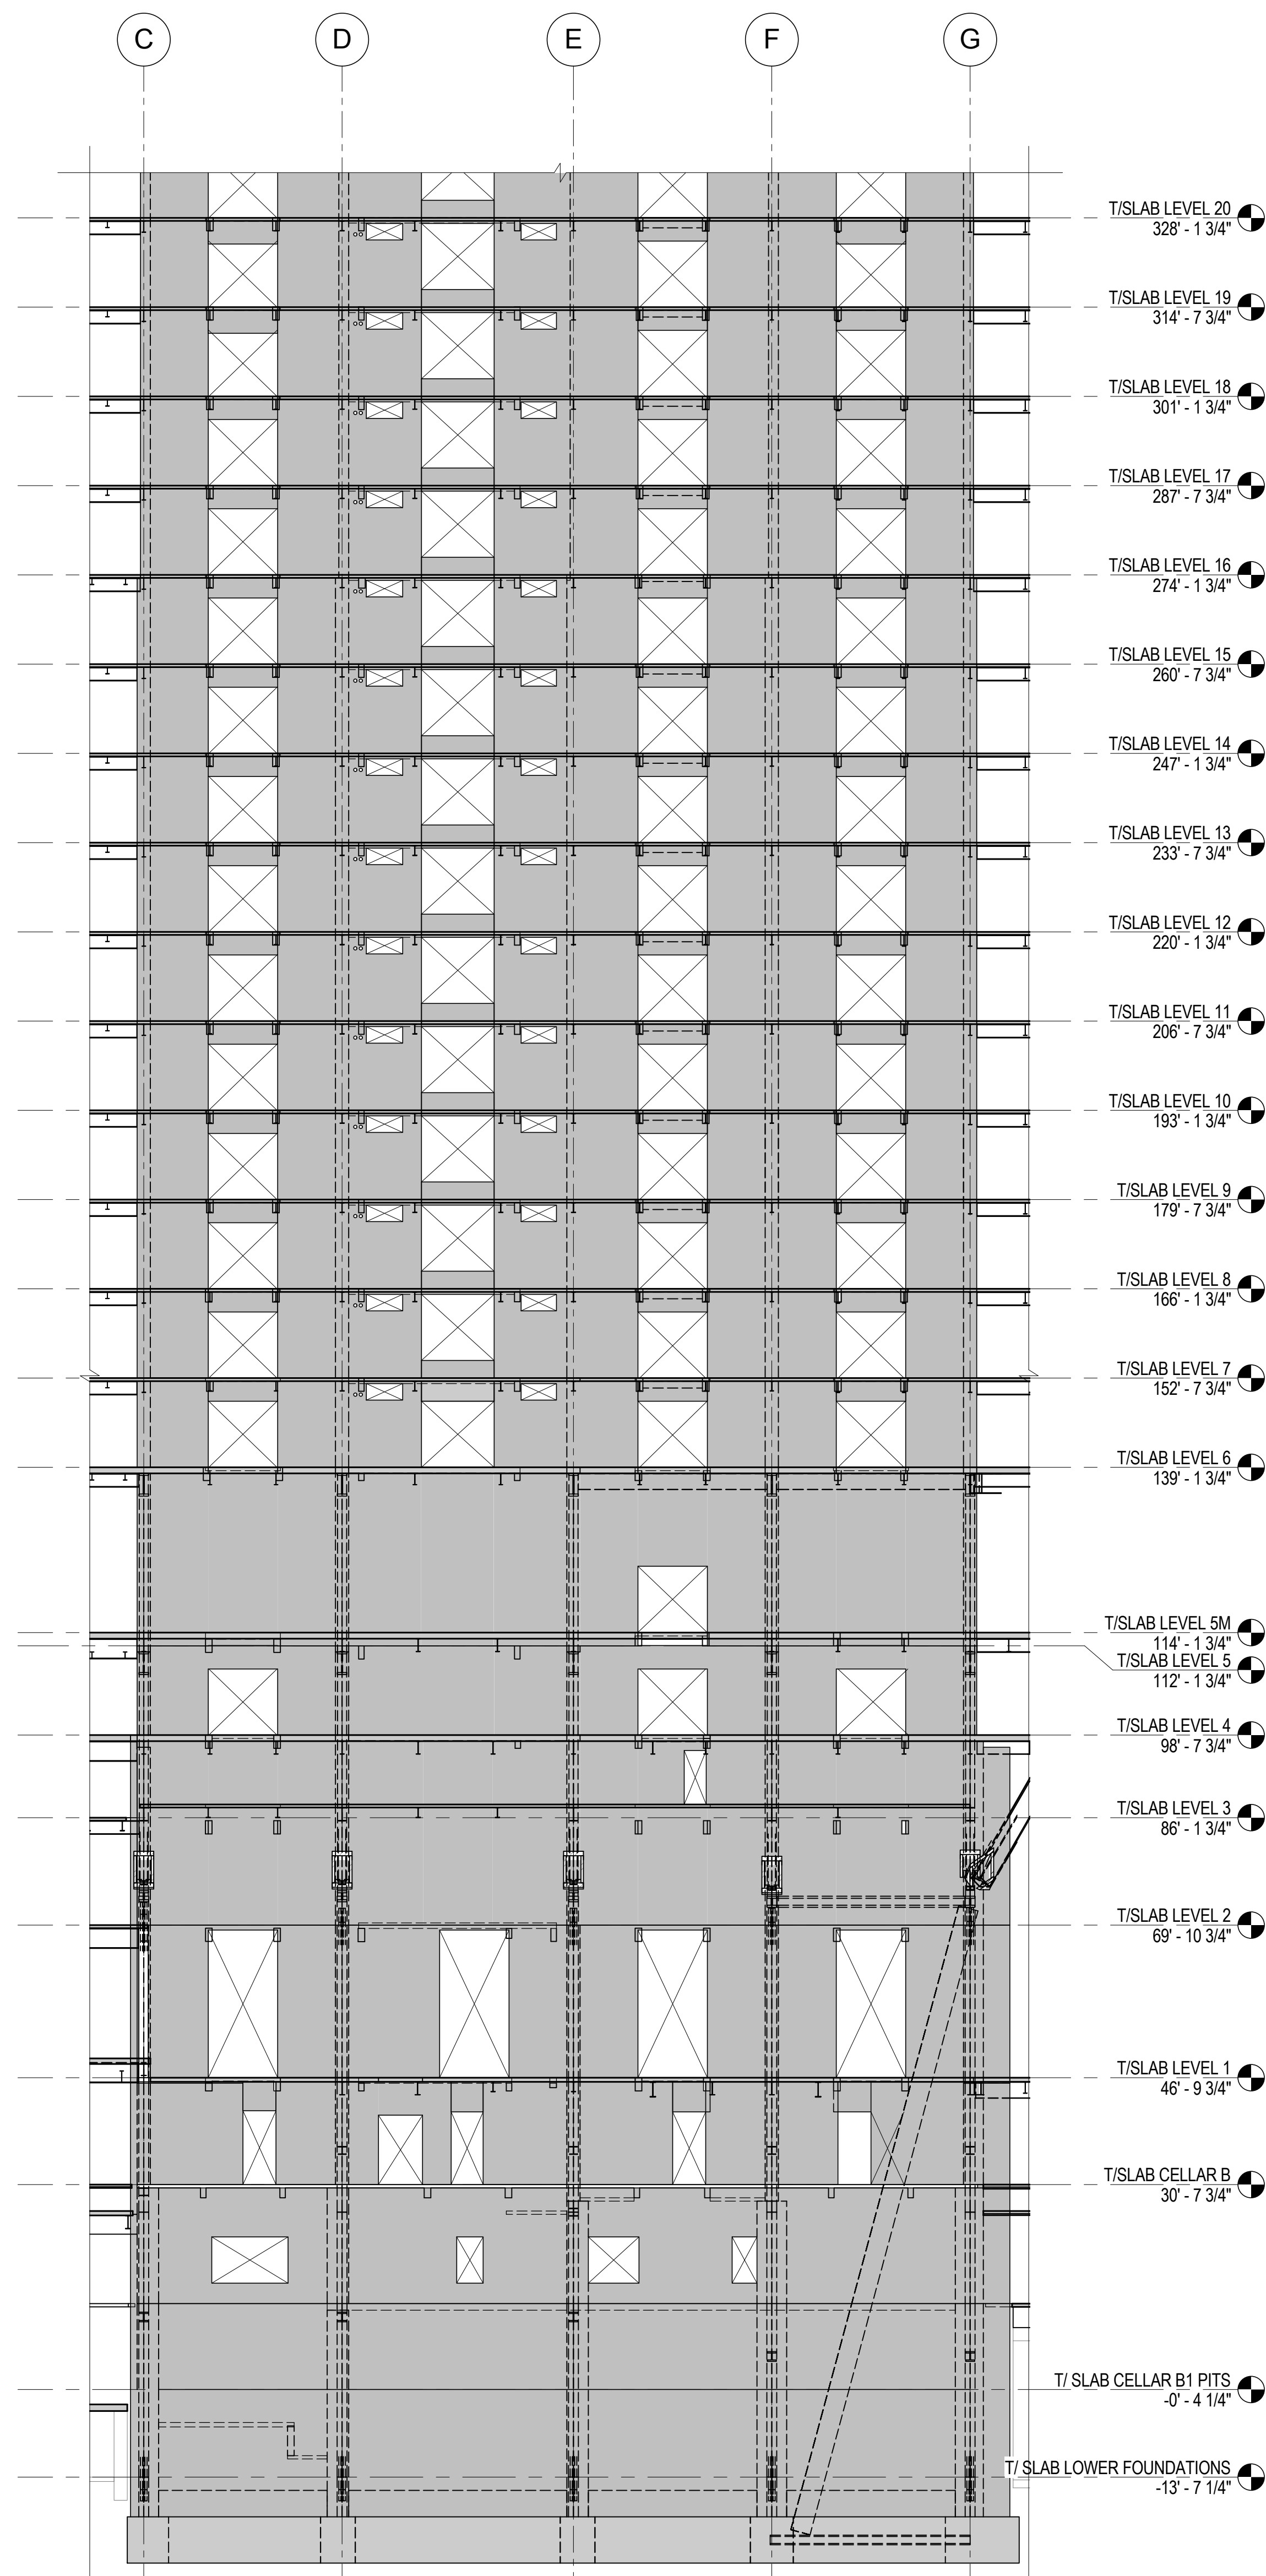

1 ELEVATION ALONG LINE 5
1/16" = 1'-0"

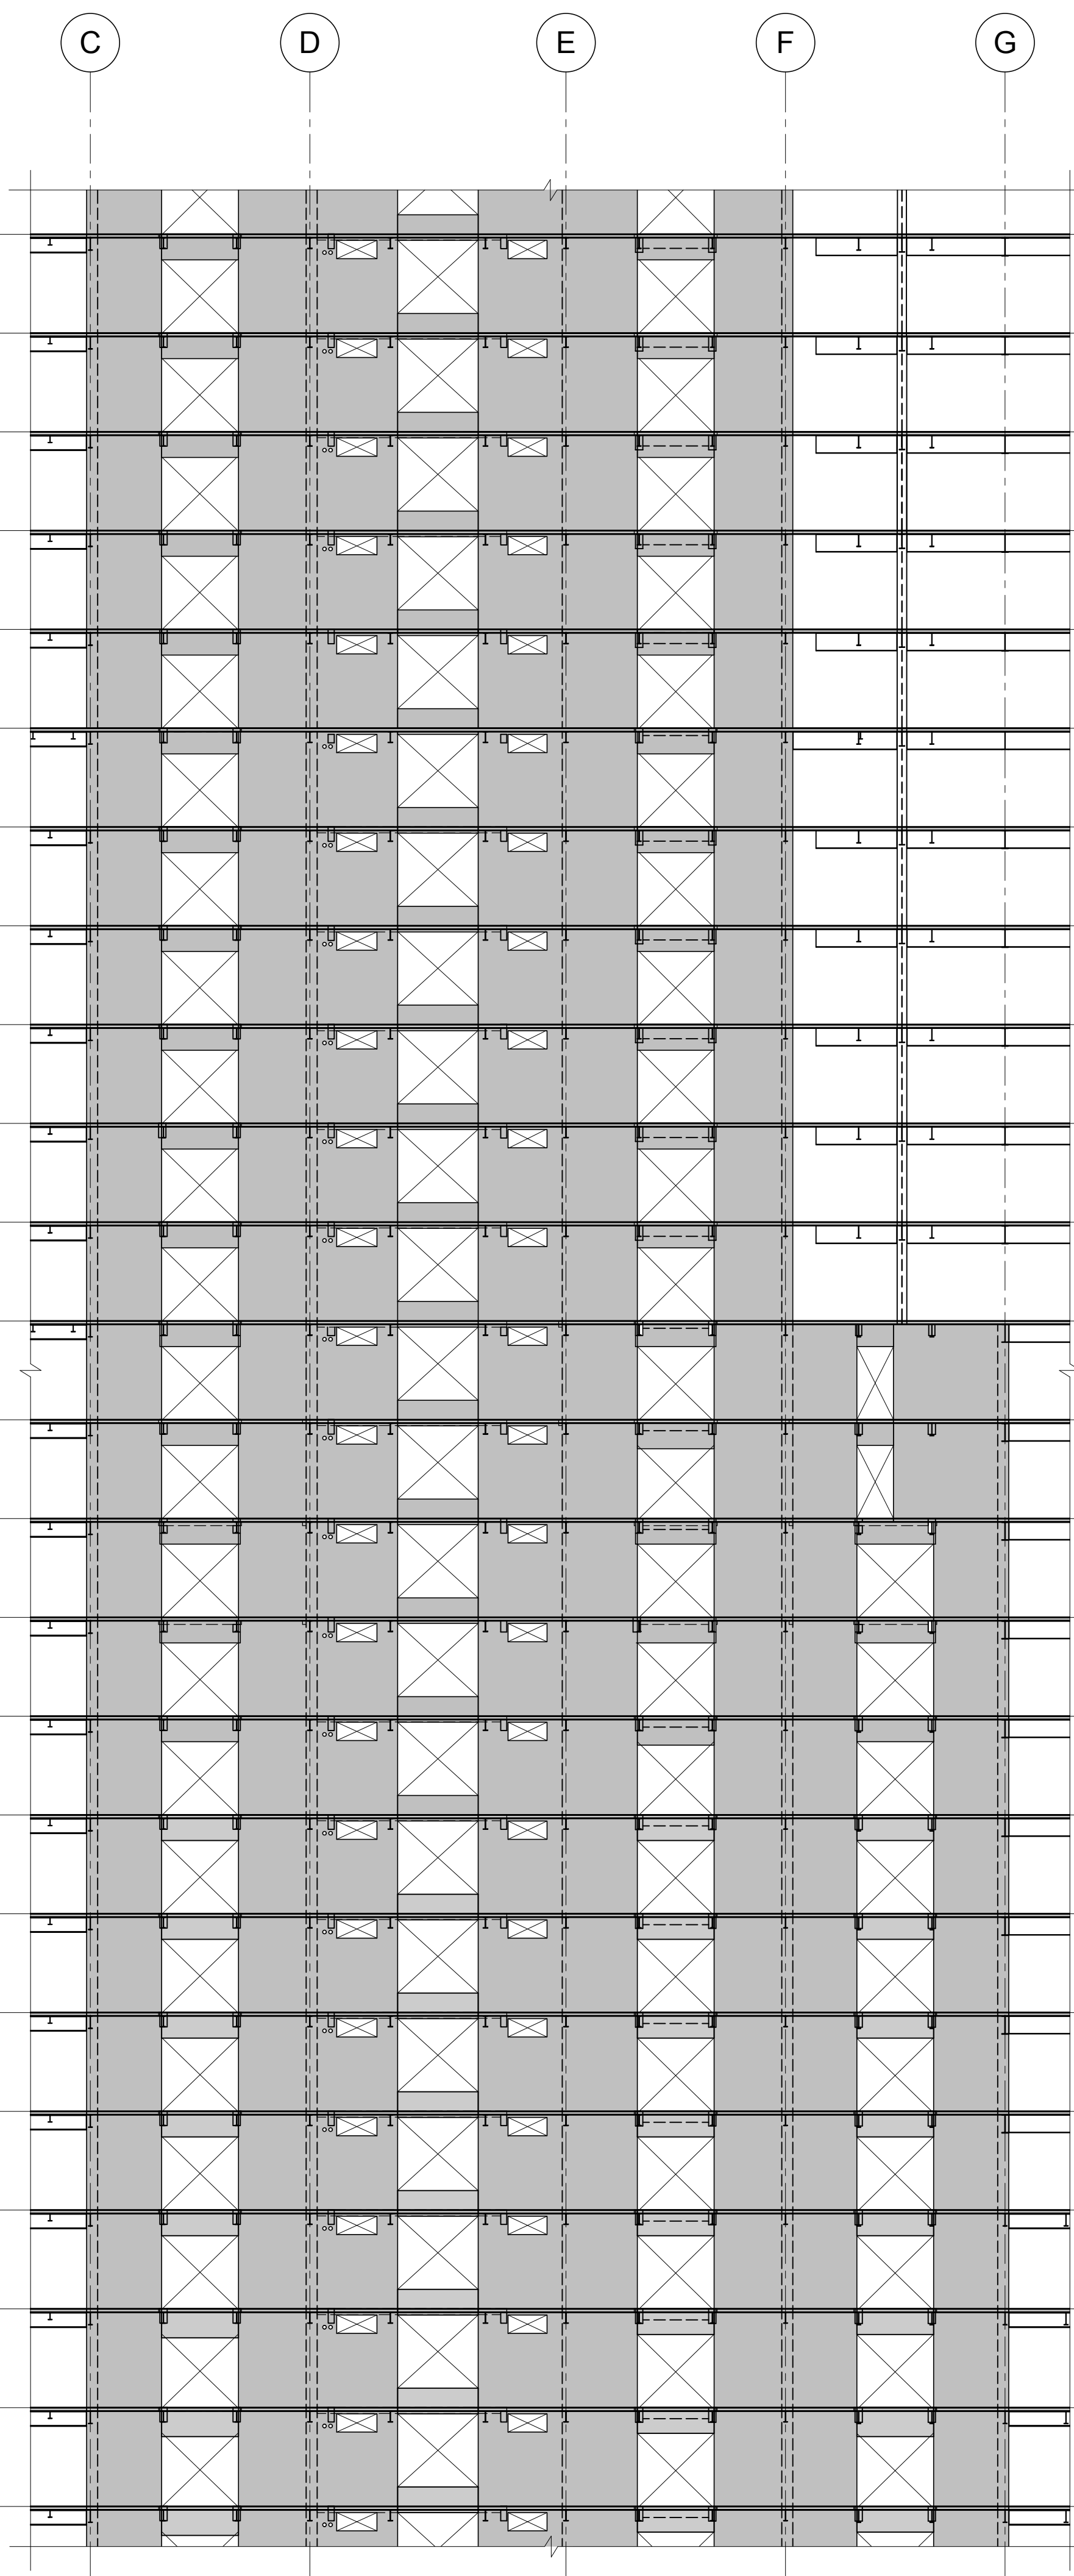

2 ELEVATION ALONG LINE 5
1/16" = 1'-0"

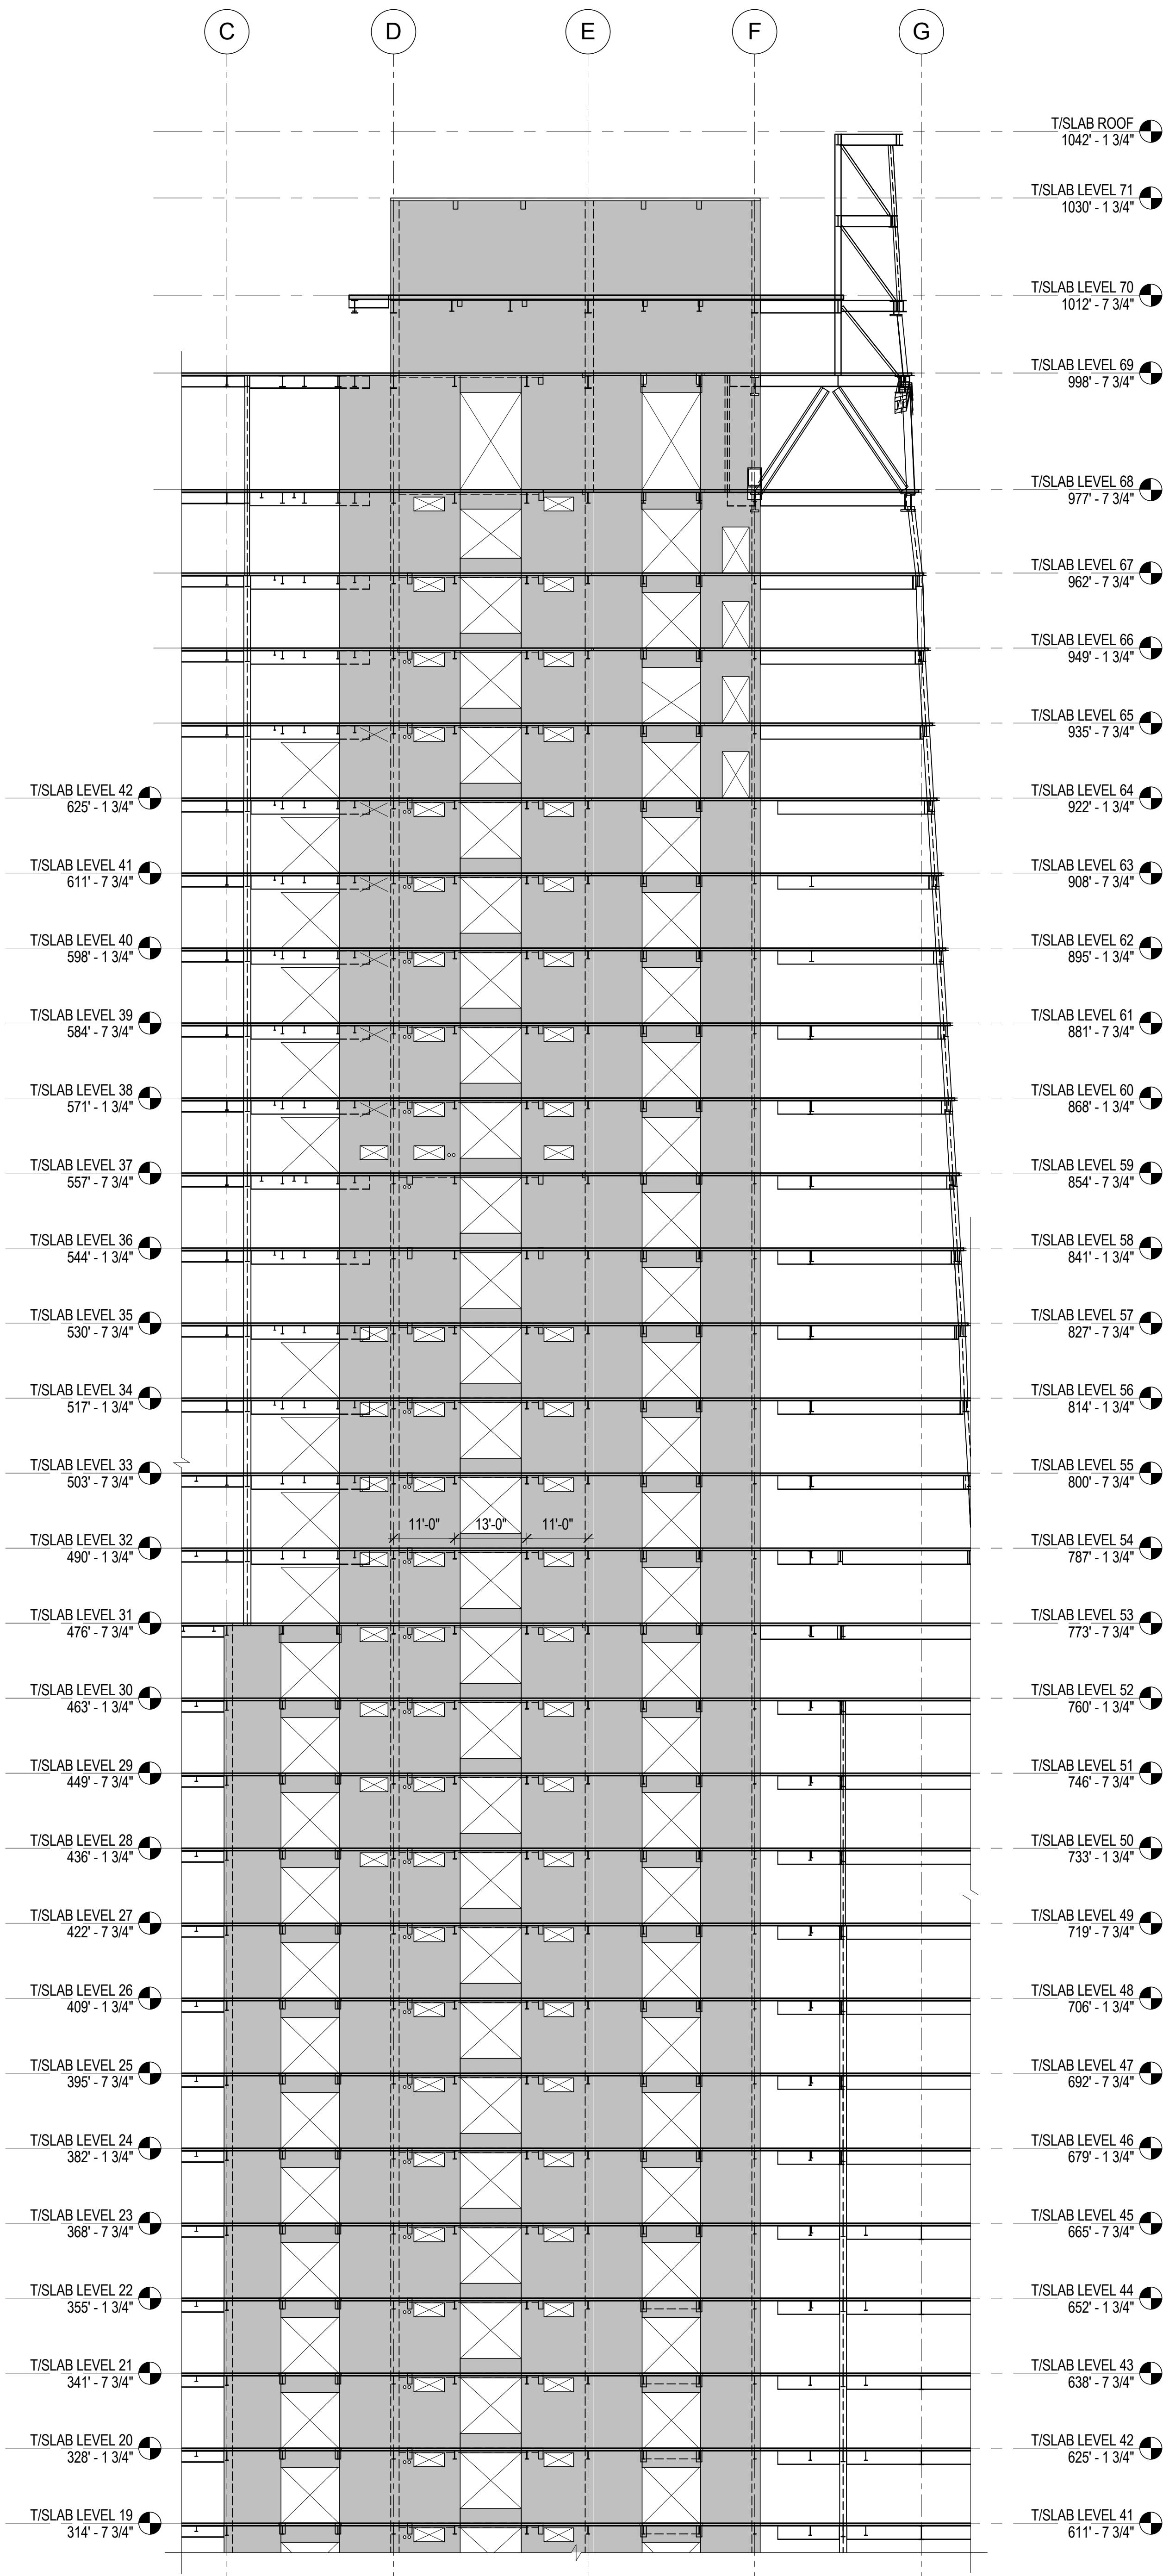

3 ELEVATION ALONG LINE 5
1/16" = 1'-0"

MANHATTAN WEST:
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166 Ames Street, Hackensack, NJ 07601

Wind Tunnel Consultant
Rowan Williams Davies & Irwin Inc.
680 Woodlawn Road West, Guelph
Ontario, Canada N1K 1B8

Key Plan:


Seal & Signature:

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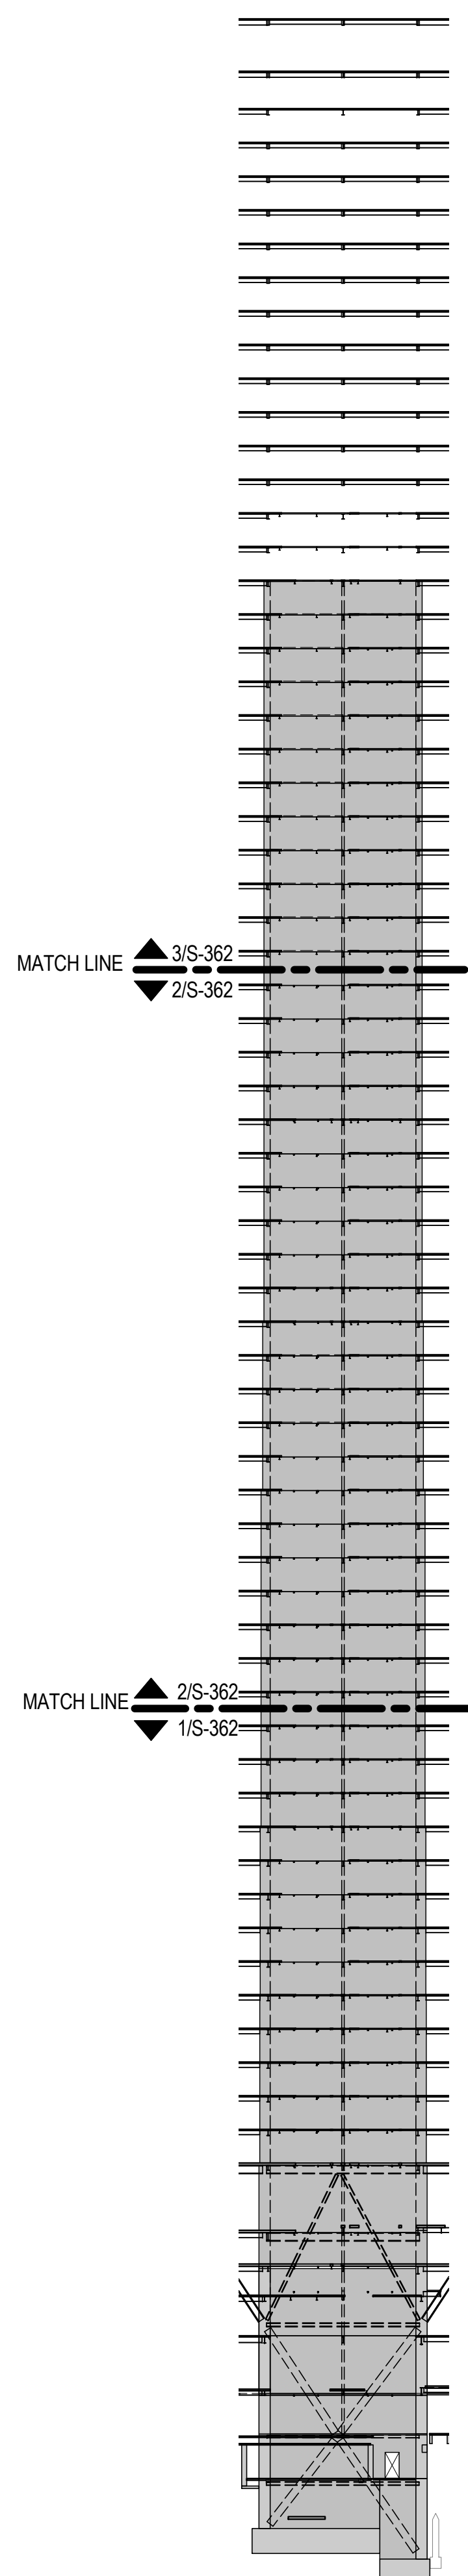
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5	20 JUN 2014	ISSUED FOR FOUNDATION PERMIT
4	20 DEC 2013	ISSUED FOR FOUNDATION PERMIT
3	15 NOV 2013	ISSUED FOR 50% PROGRESS PRICING
2	12 JUL 2013	ISSUED FOR 60% DESIGN DEVELOPMENT
1	19 MAR 2012	ISSUED FOR RECONCILIATION

No. _____ Date _____ Description _____
Sheet Name: **CORE WALL ELEVATIONS ALONG LINE 5**


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211157	S-361.00
Date: 20 JUN 2014	Sheet No.: S-361
Scale: As indicated	Page No.: 65 of 90

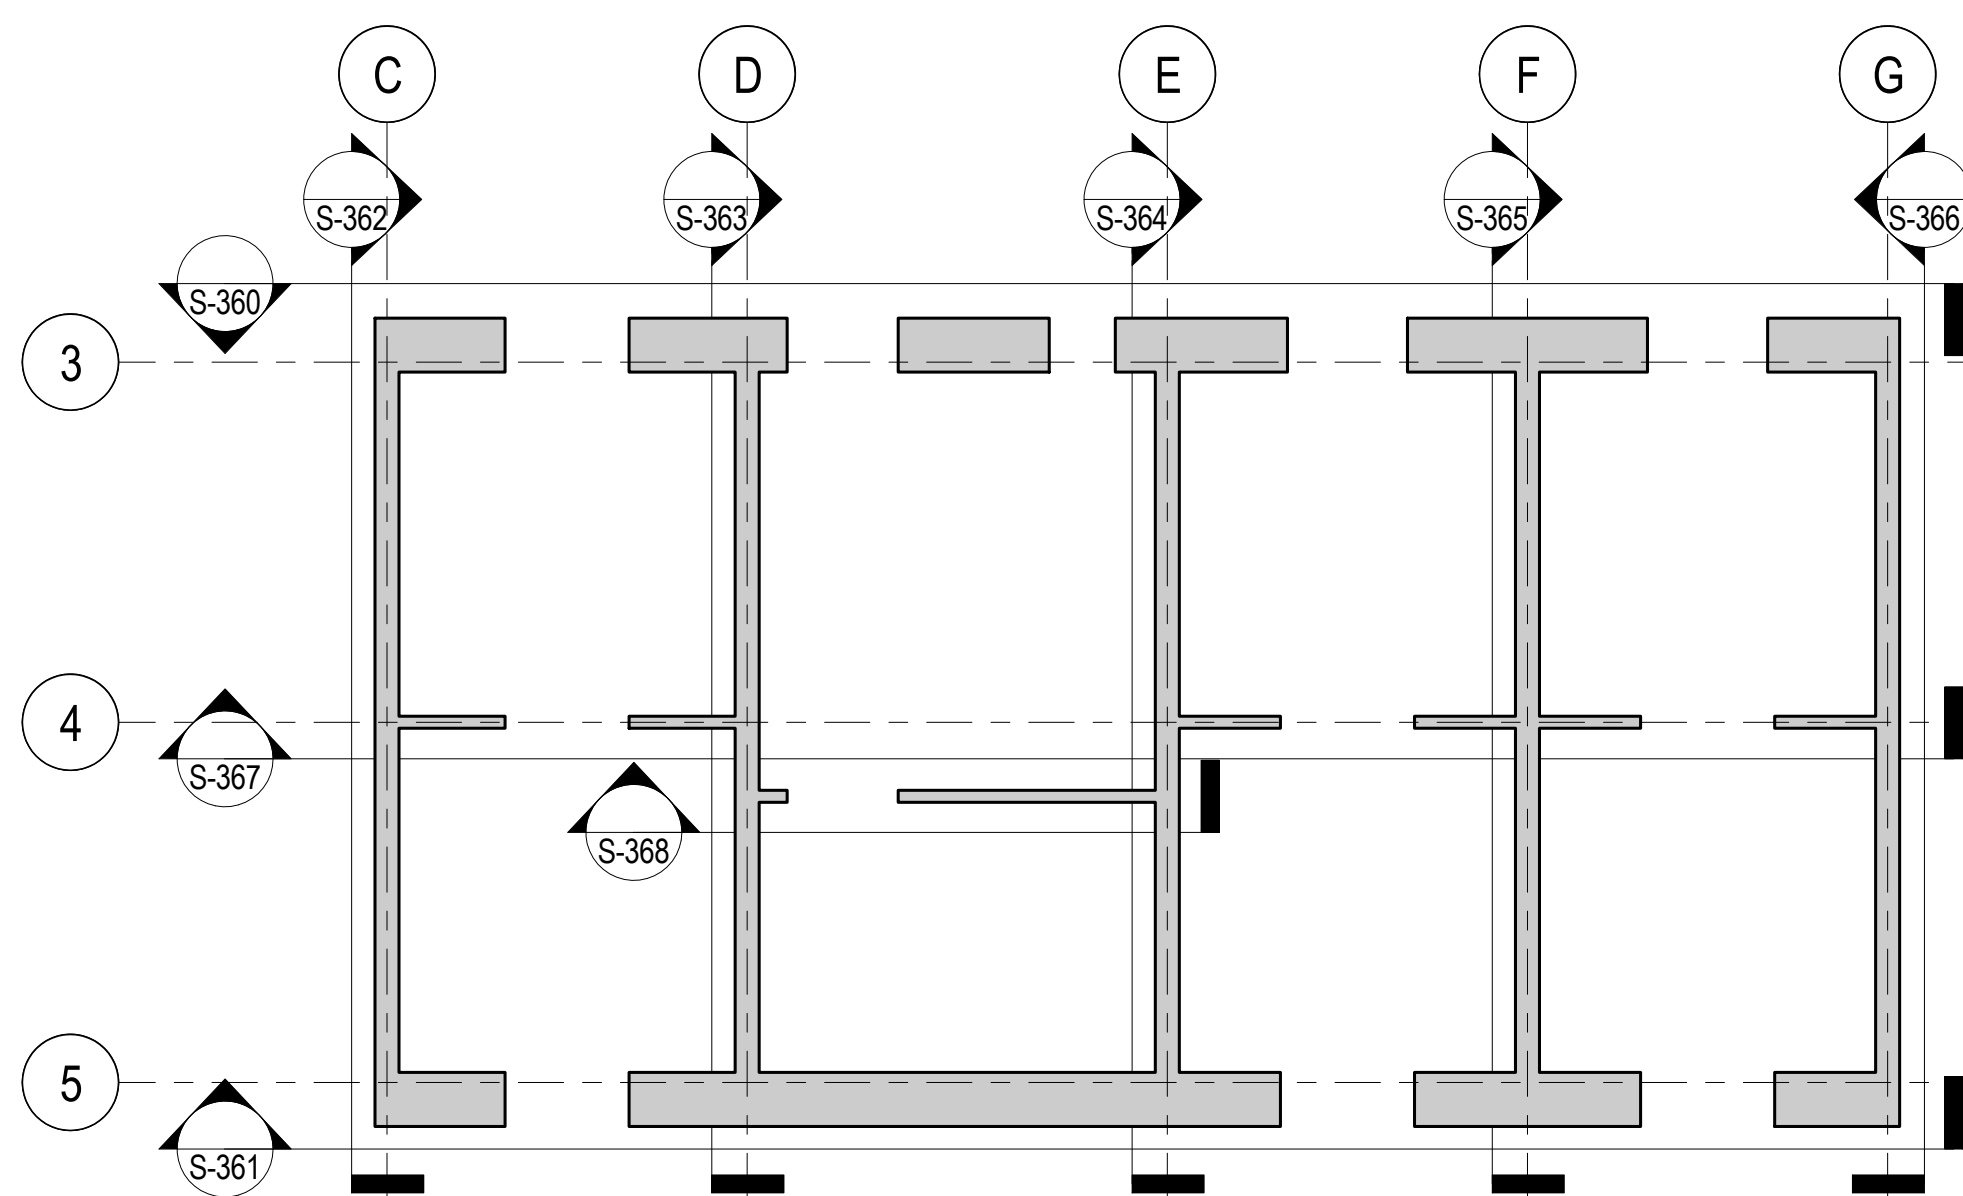


CORE WALL ELEVATION KEY PLAN
NTS



ELEVATION KEY
NTS

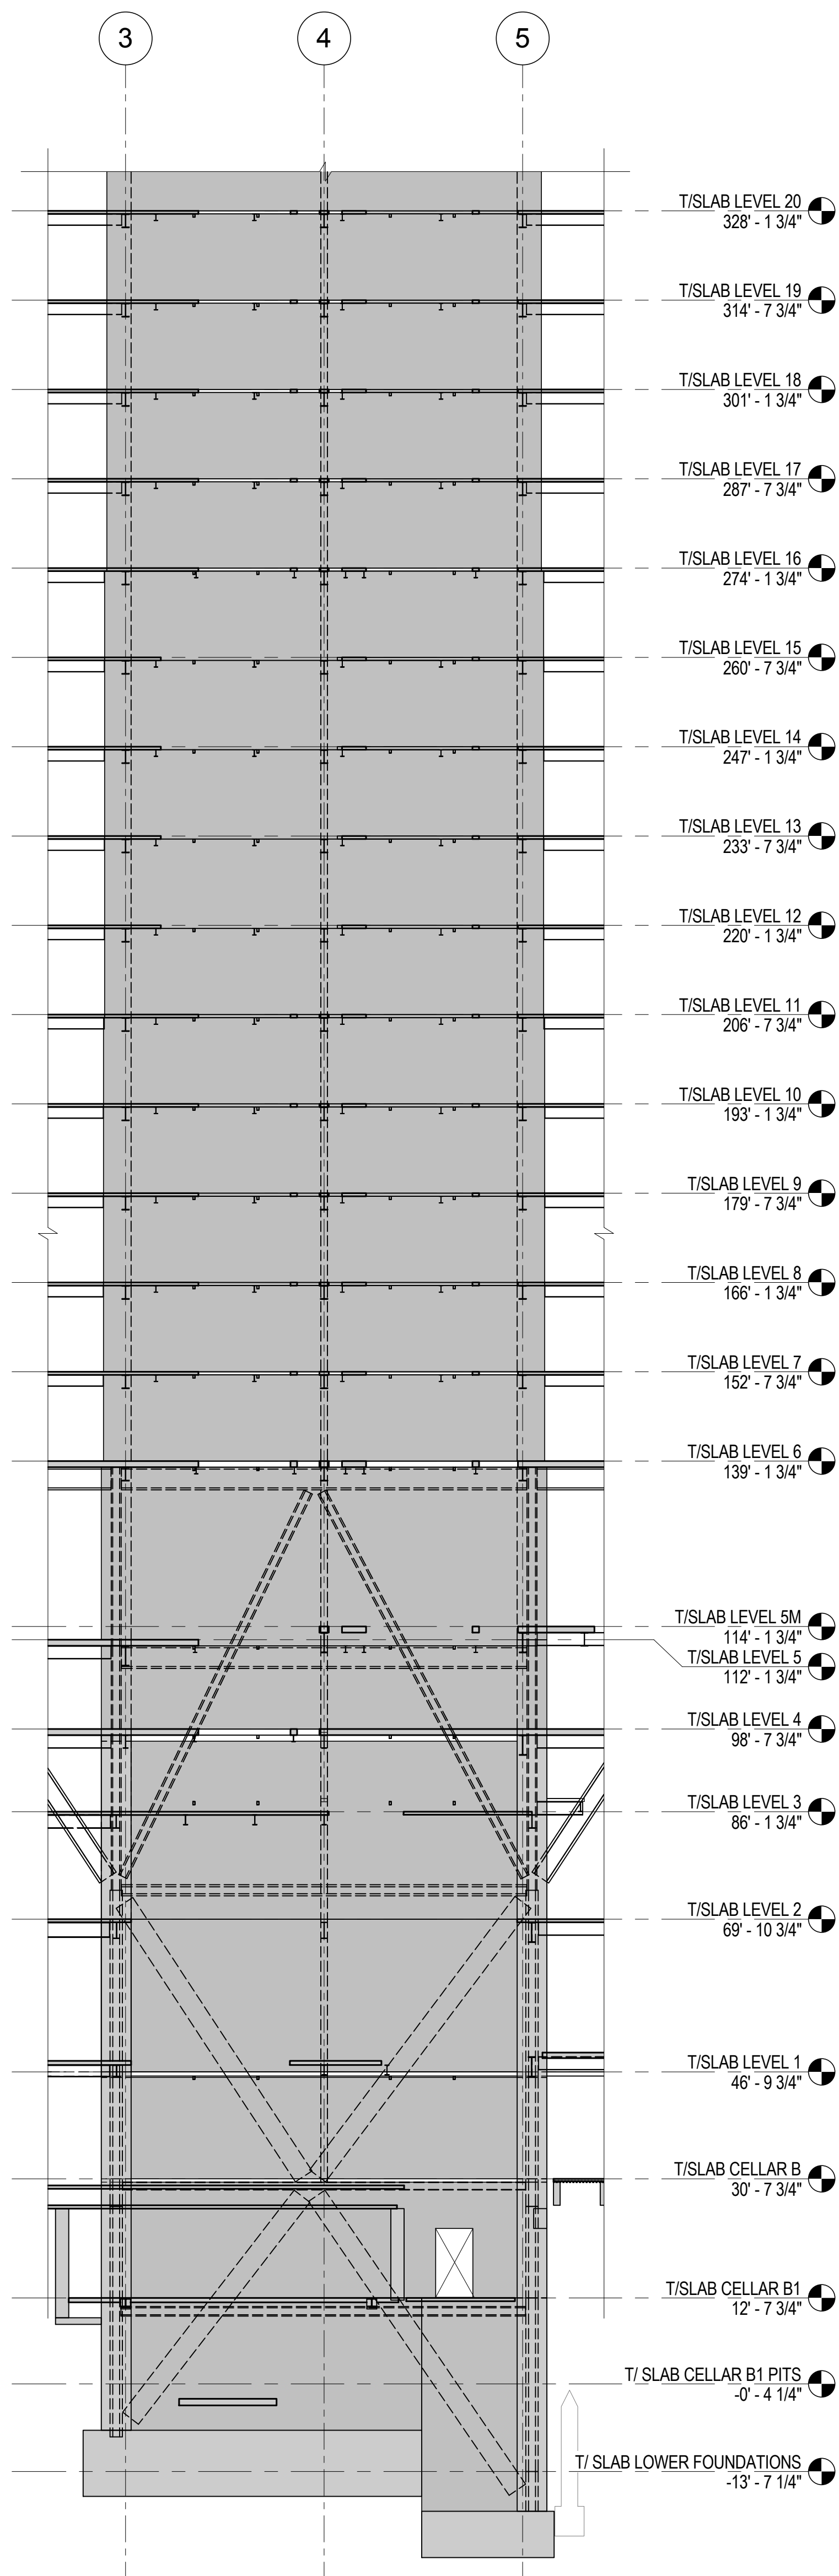

1 ELEVATION ALONG LINE C
1/16" = 1'-0"

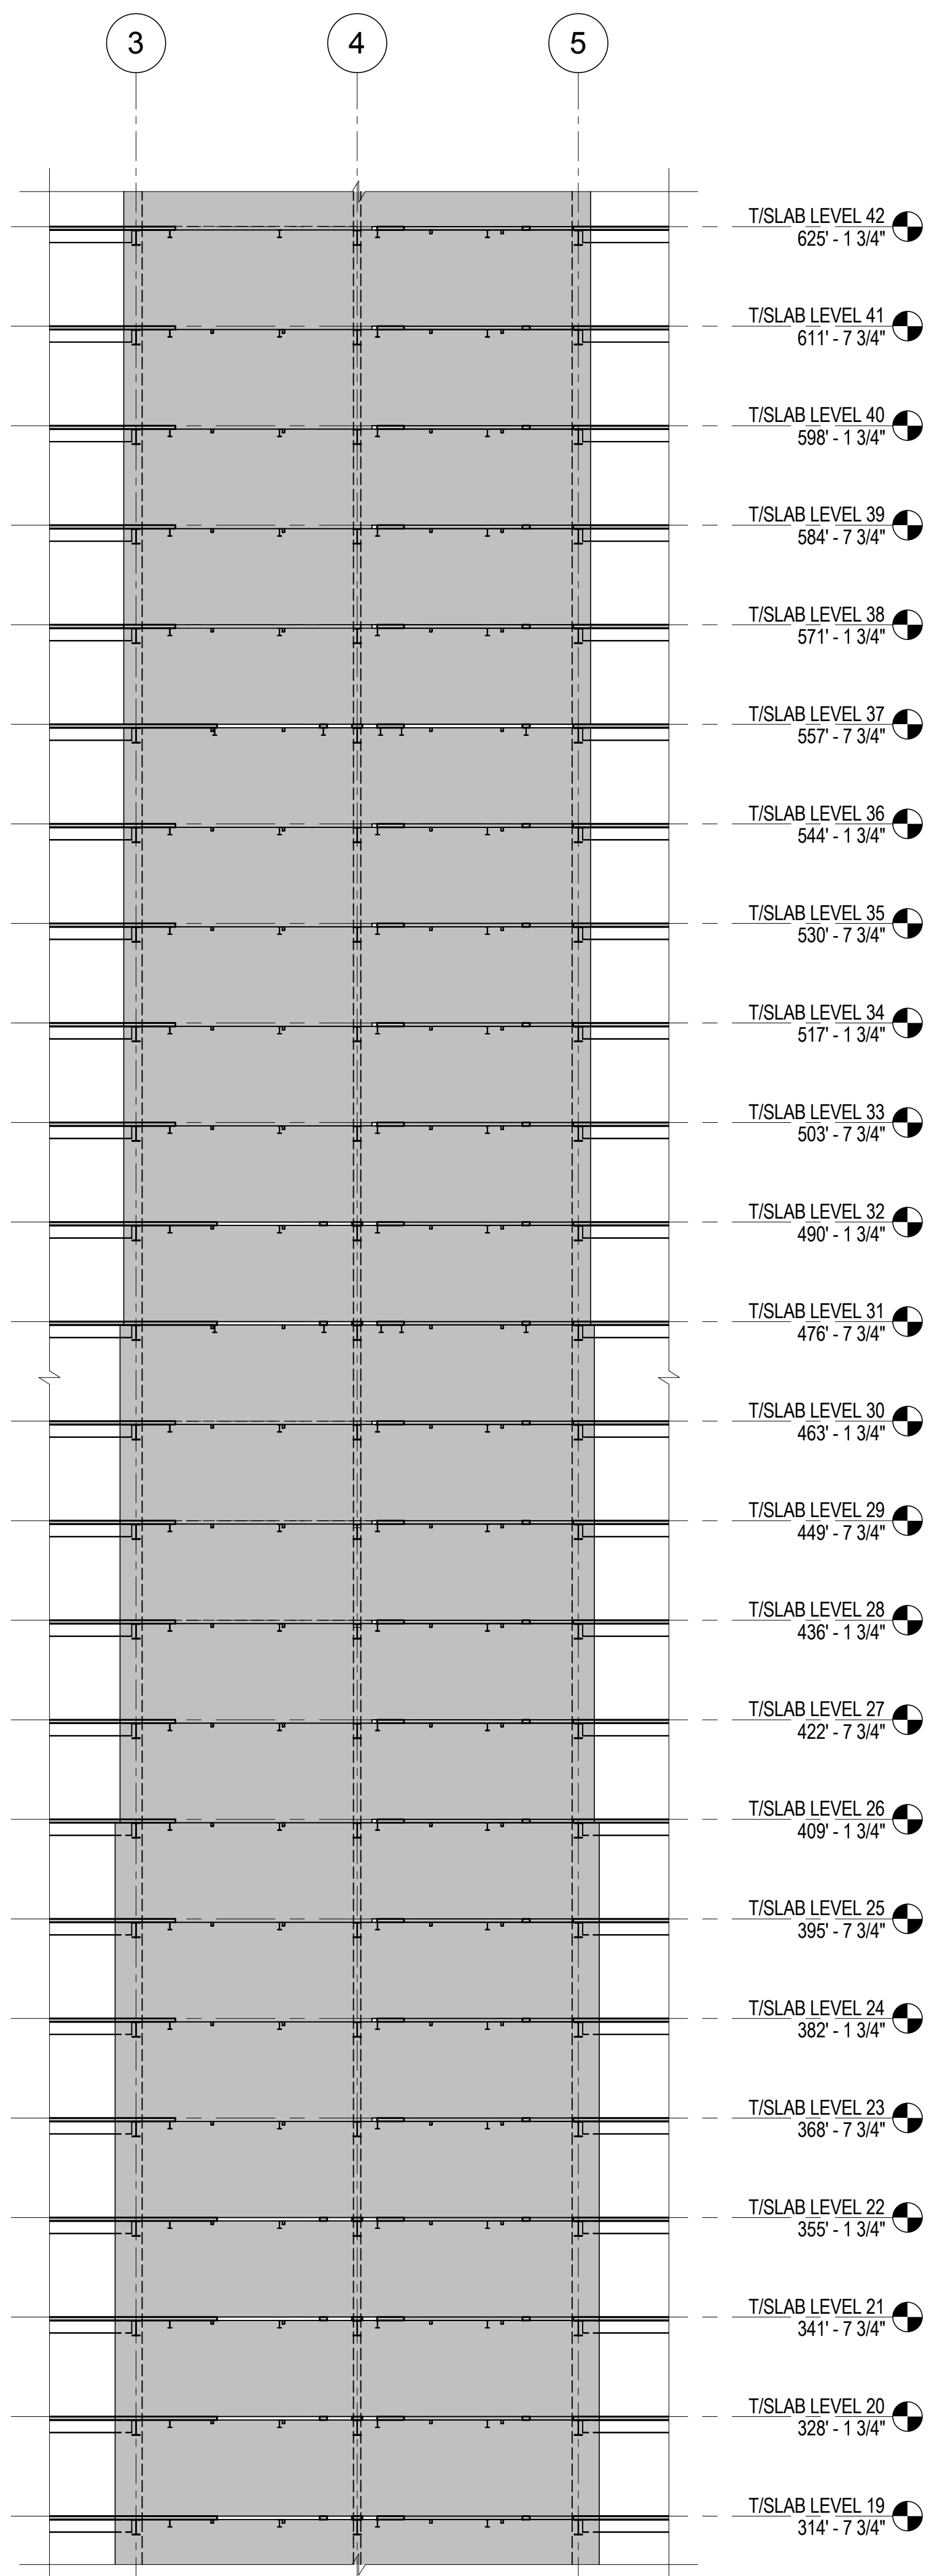

2 ELEVATION ALONG LINE C
1/16" = 1'-0"



3 ELEVATION ALONG LINE C
1/16" = 1'-0"



MANHATTAN WEST:
NORTH TOWER
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Client
Brookfield

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New York, NY 10122

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Ducibella, Ventor & Santore
250 State Street #F1, North Haven, CT 06473

Blast Consultant
Weidinger Associates, Inc.
40 Wall Street, New York, NY 10005


Acoustical Consultant
Cerami & Associates
404 Fifth Avenue #8, New York, NY 10016

Vibration Consultant
Wilson, Uhrig & Associates, Inc.
65 Broadway, Suite 401, New York, NY 10006


Code Consultant
Code Consultants Professional Engineers PC
215 West 40th Street, 15th Floor, New York, NY 10018

Facade Maintenance Consultant
Entek Engineering LLC
166 Ames Street, Hackensack, NJ 07601

Wind Tunnel Consultant
Rowan Williams Davies & Irwin Inc.
680 Woodlawn Road West, Guelph
Ontario, Canada N1K 1B8

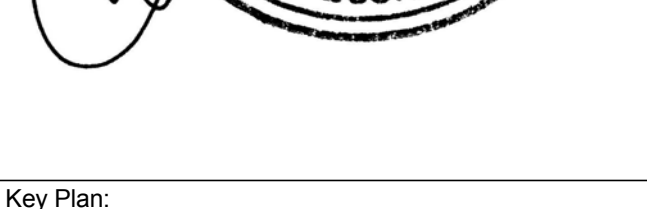

Key Plan:

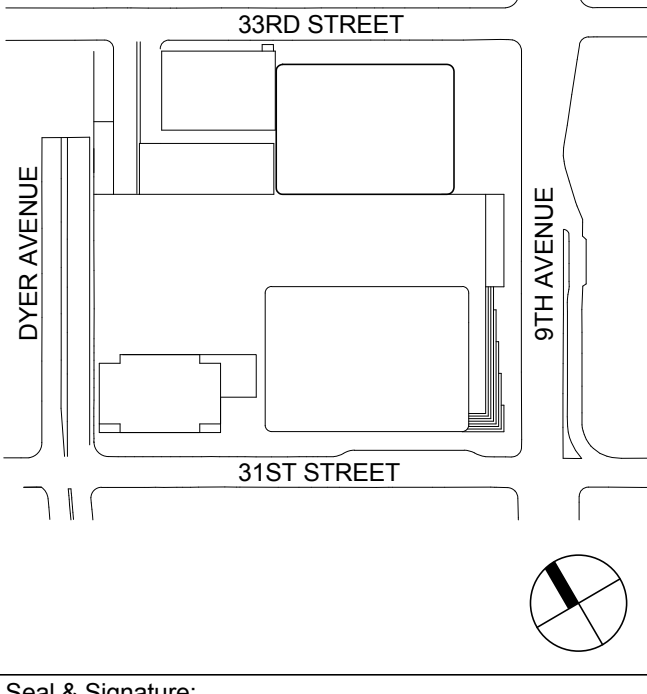


Seal & Signature:

PRELIMINARY
NOT FOR CONSTRUCTION

No.	Date	Description
6	20 JUN 2014	ISSUED FOR FOUNDATION BID
5	20 JUN 2014	ISSUED FOR FOUNDATION PERMIT
4	20 DEC 2013	ISSUED FOR FOUNDATION PERMIT
3	15 NOV 2013	ISSUED FOR 90% DESIGN DEVELOPMENT
2	12 JUL 2013	ISSUED FOR 90% DESIGN DEVELOPMENT
1	19 MAR 2012	ISSUED FOR RECONCILIATION


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**CORE WALL
ELEVATIONS
ALONG LINE C**

Project No.: 211157	B-SCAN Sheet No.: S-362.00
Date: 20 JUN 2014	Sheet No.: S-362
Scale: As indicated	Page No.: 66 of 90
File No.: S-362	

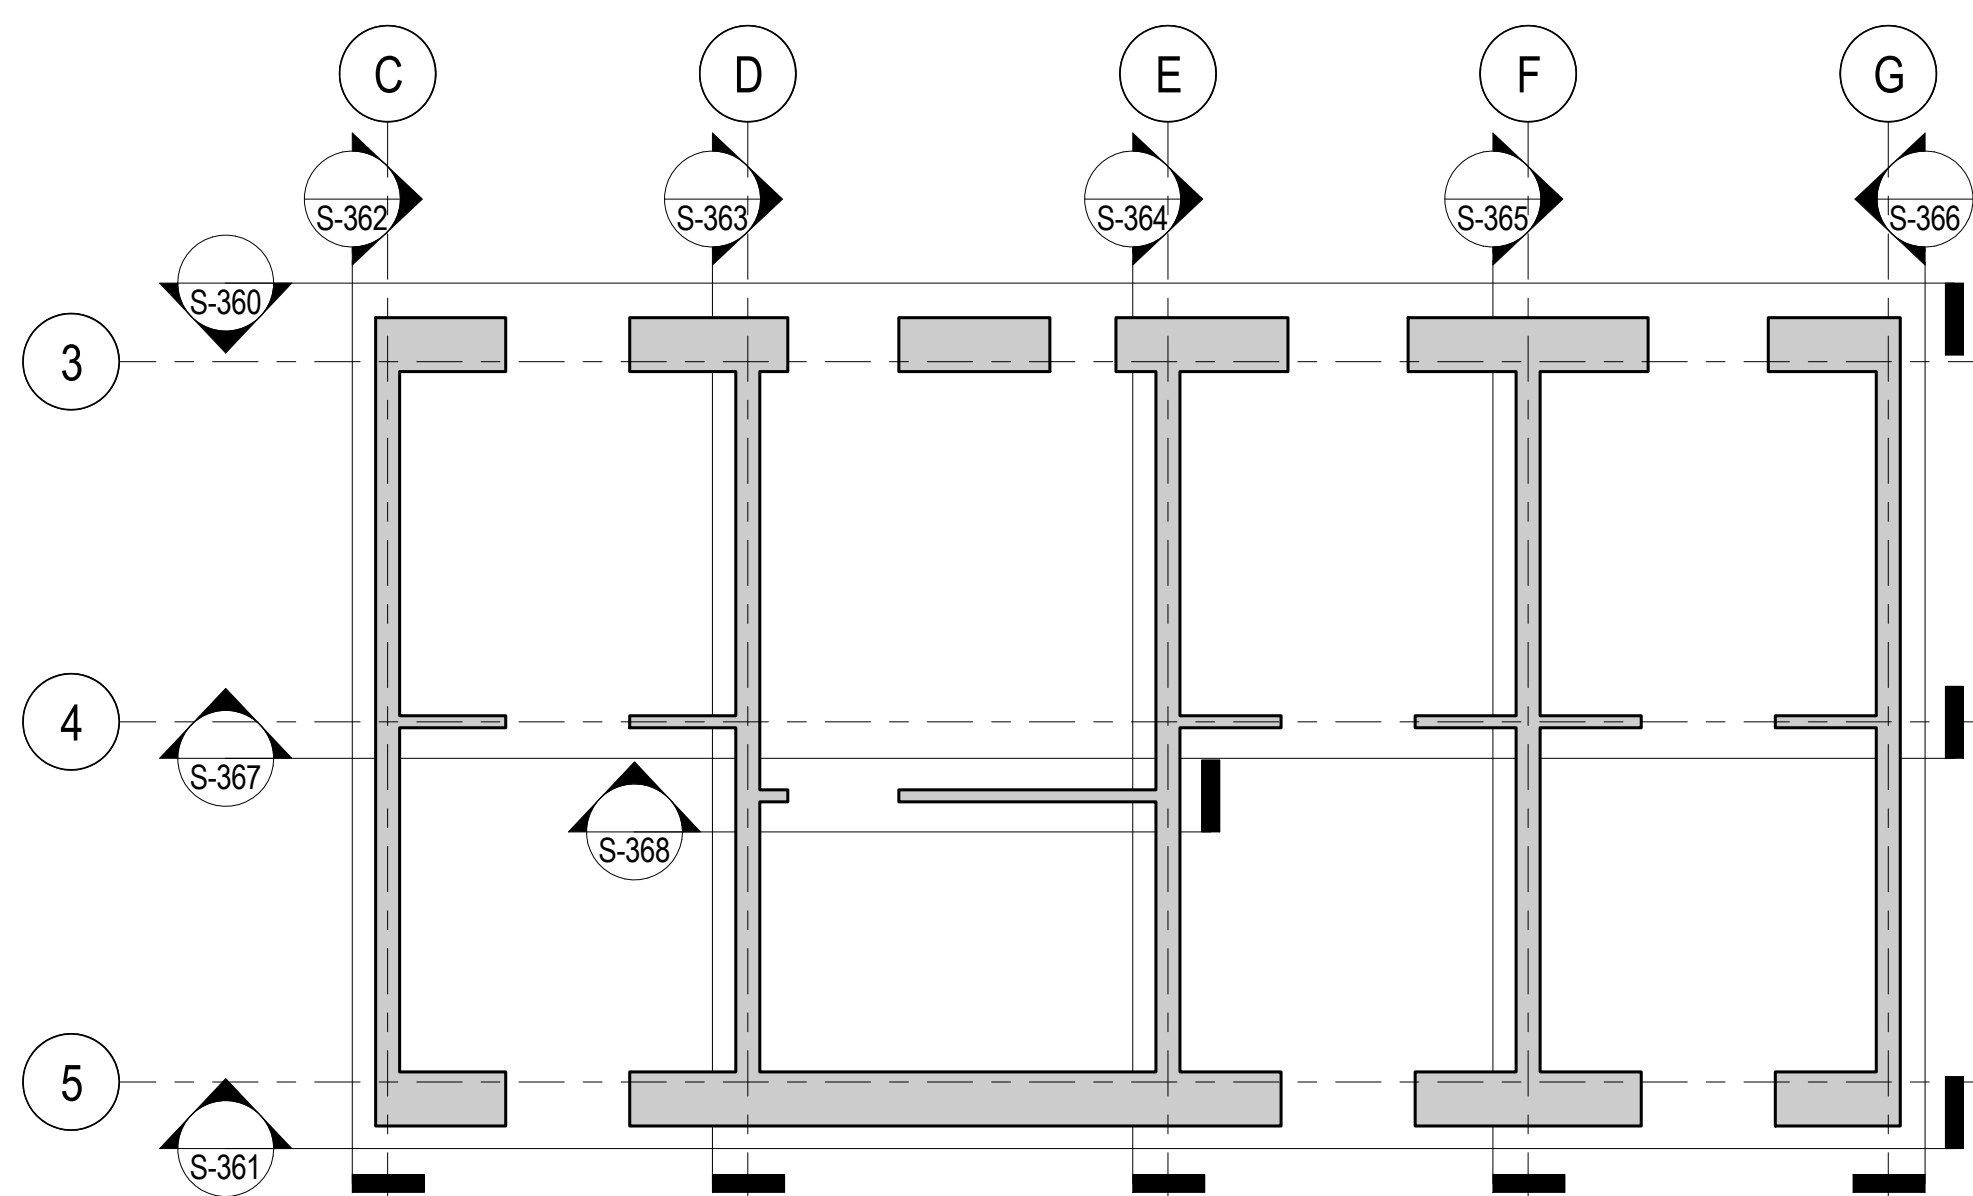


CORE WALL ELEVATION KEY PLAN

NTS

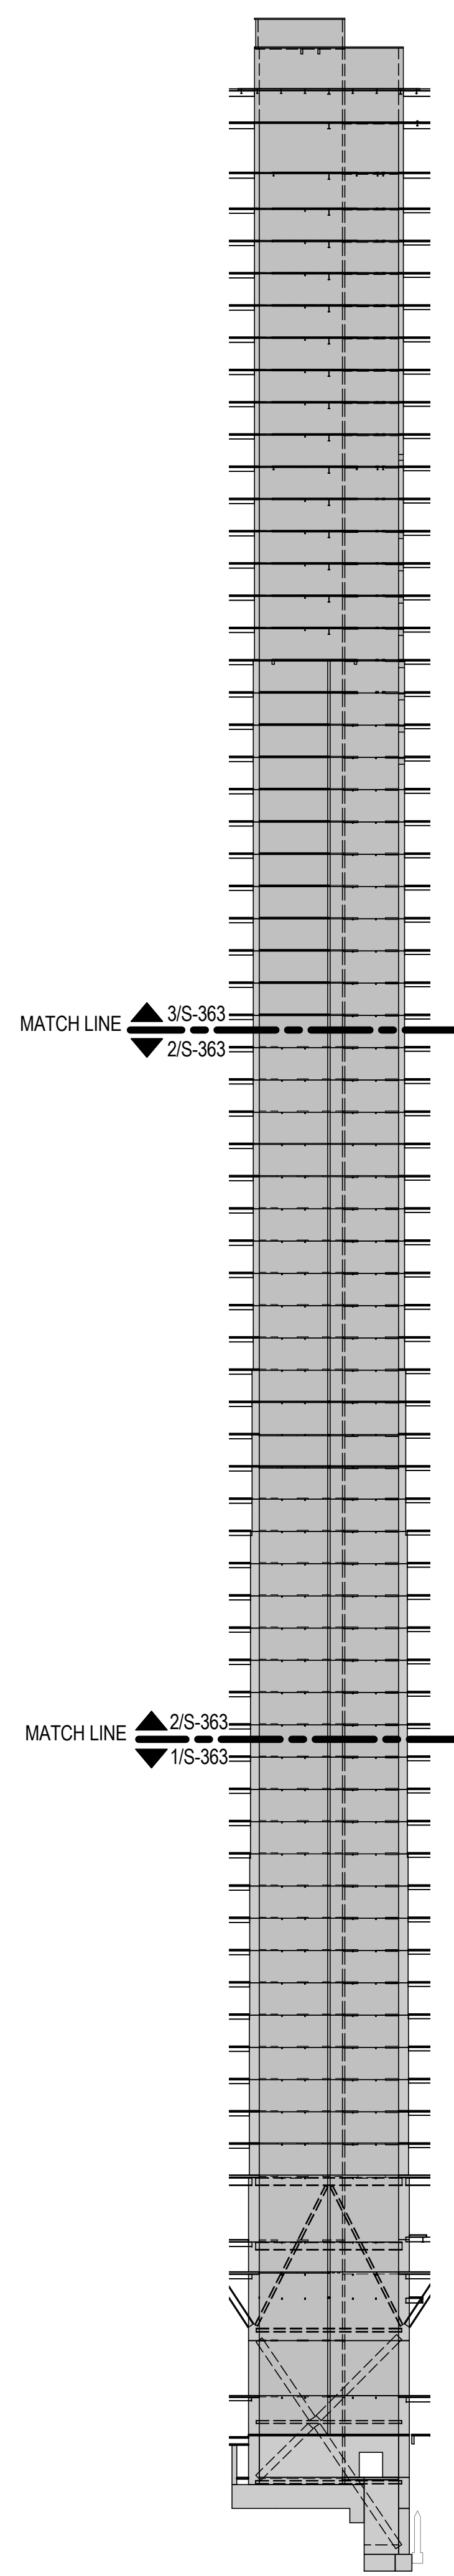


ELEVATION KEY

NTS

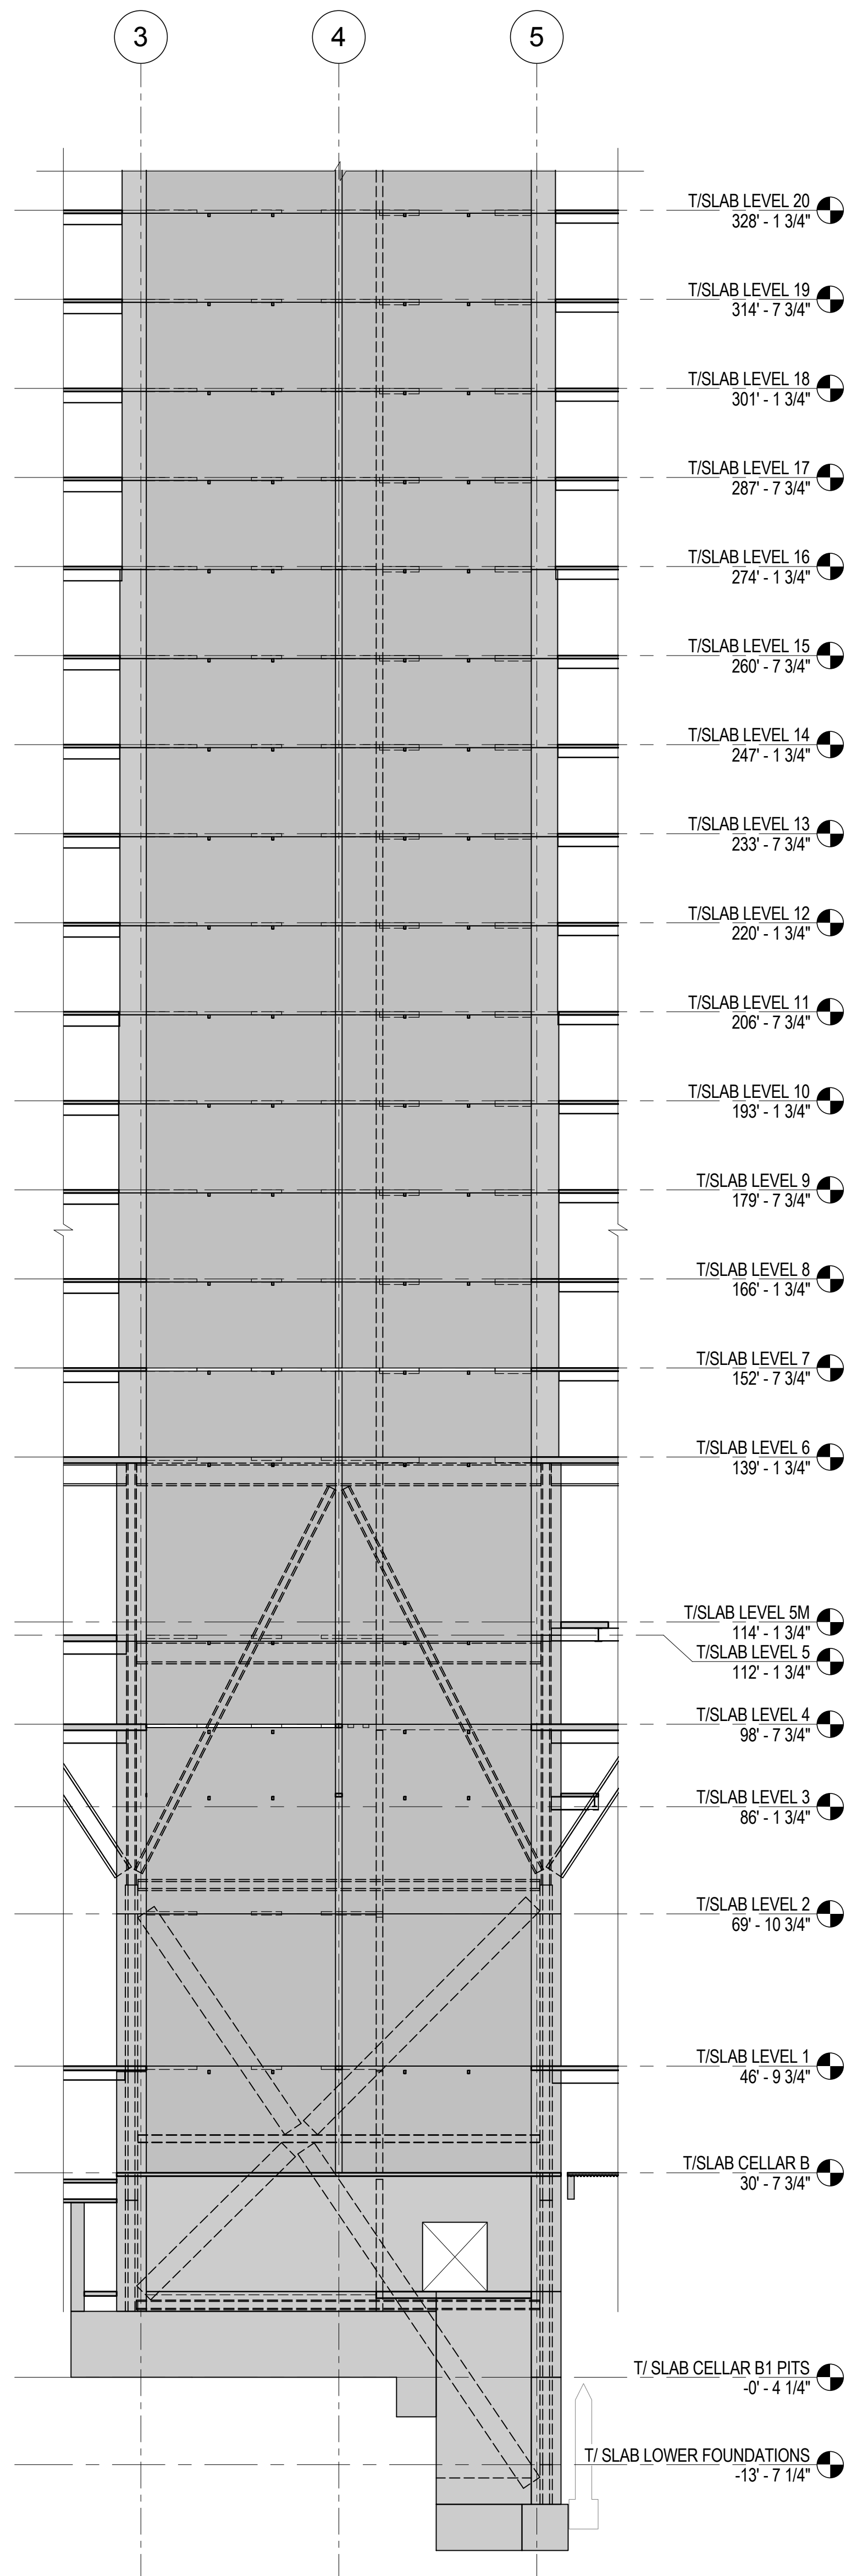


1 ELEVATION ALONG LINE D

1/16" = 1'-0"

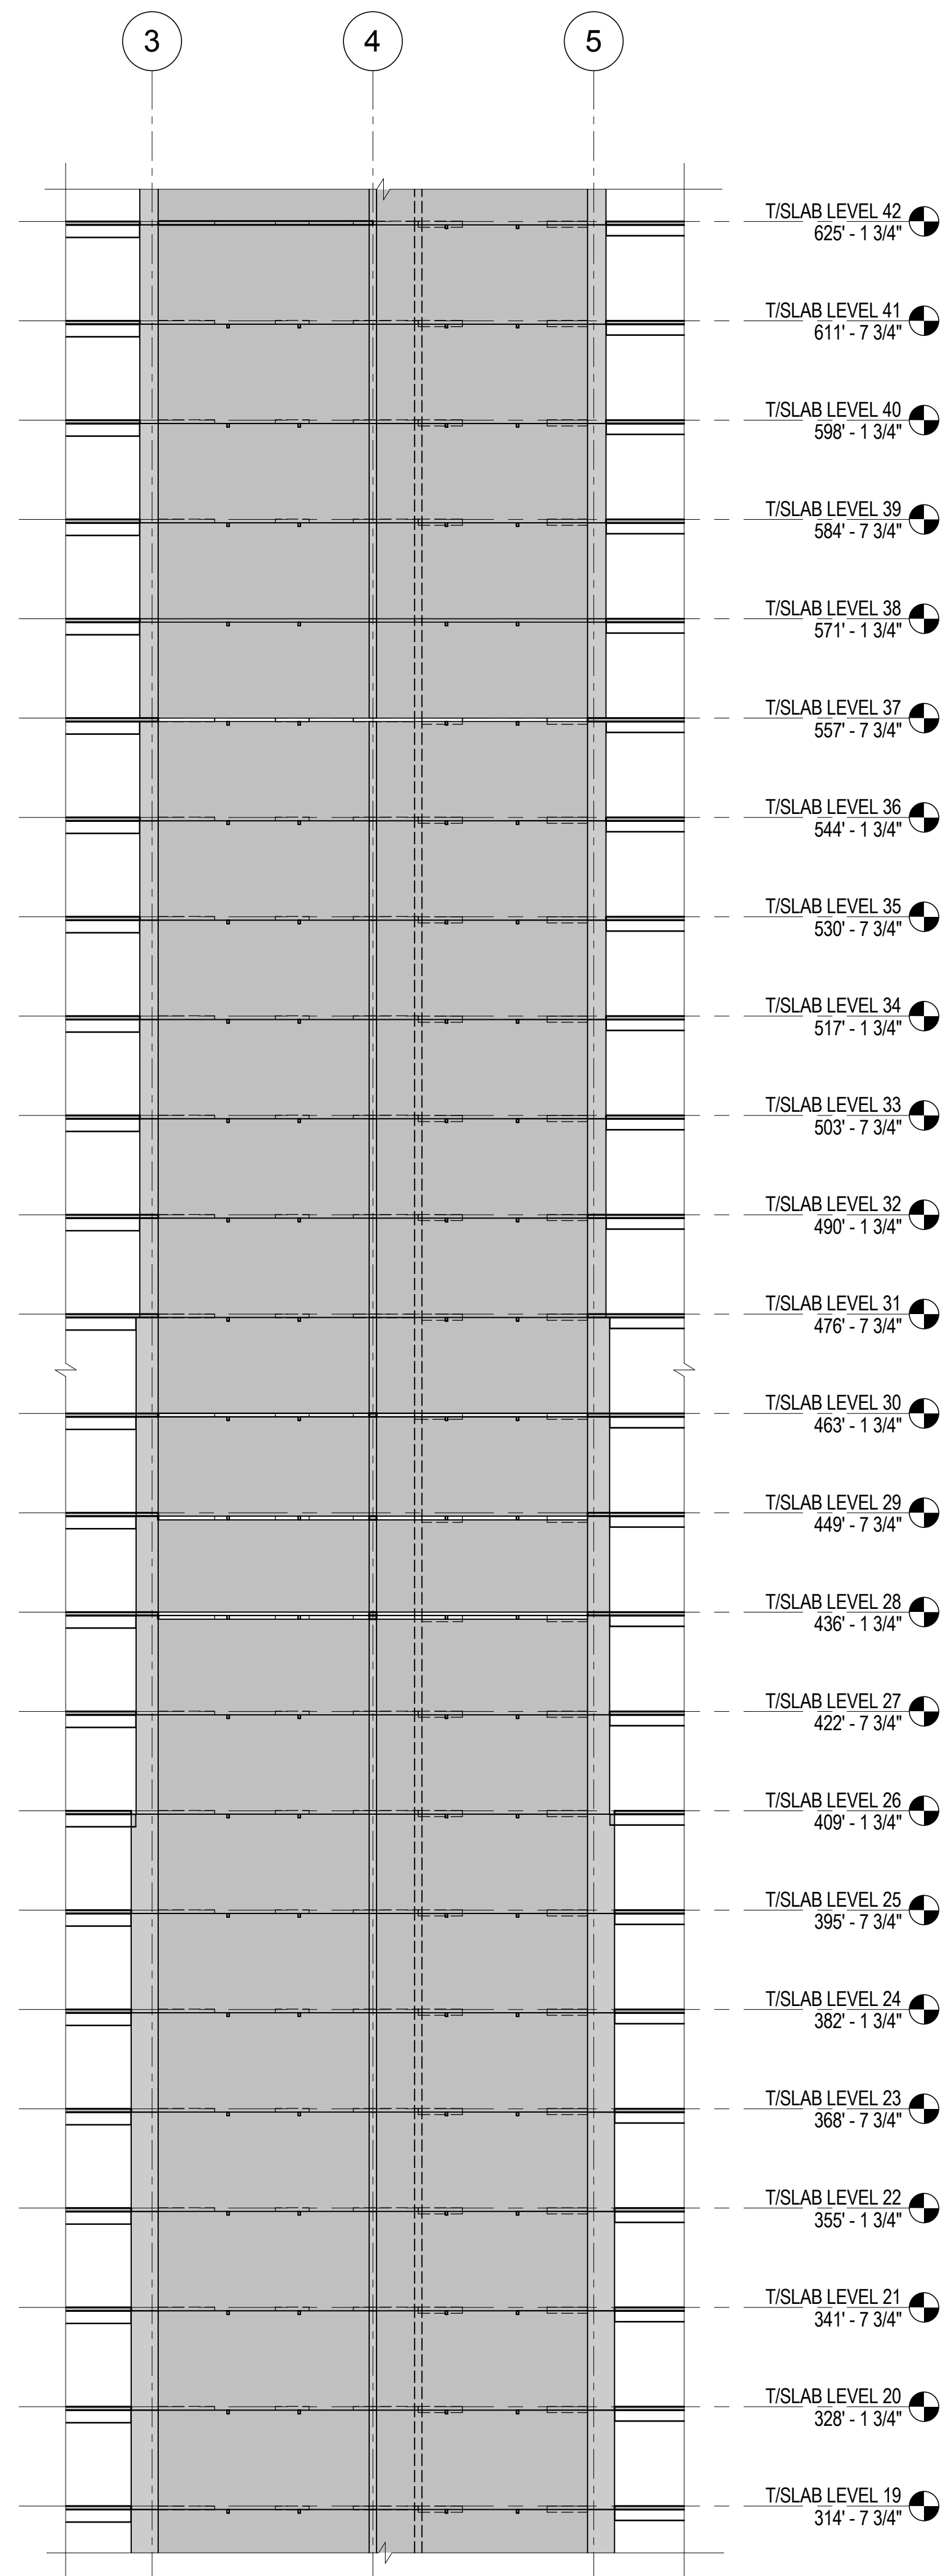


2 ELEVATION ALONG LINE D

1/16" = 1'-0"

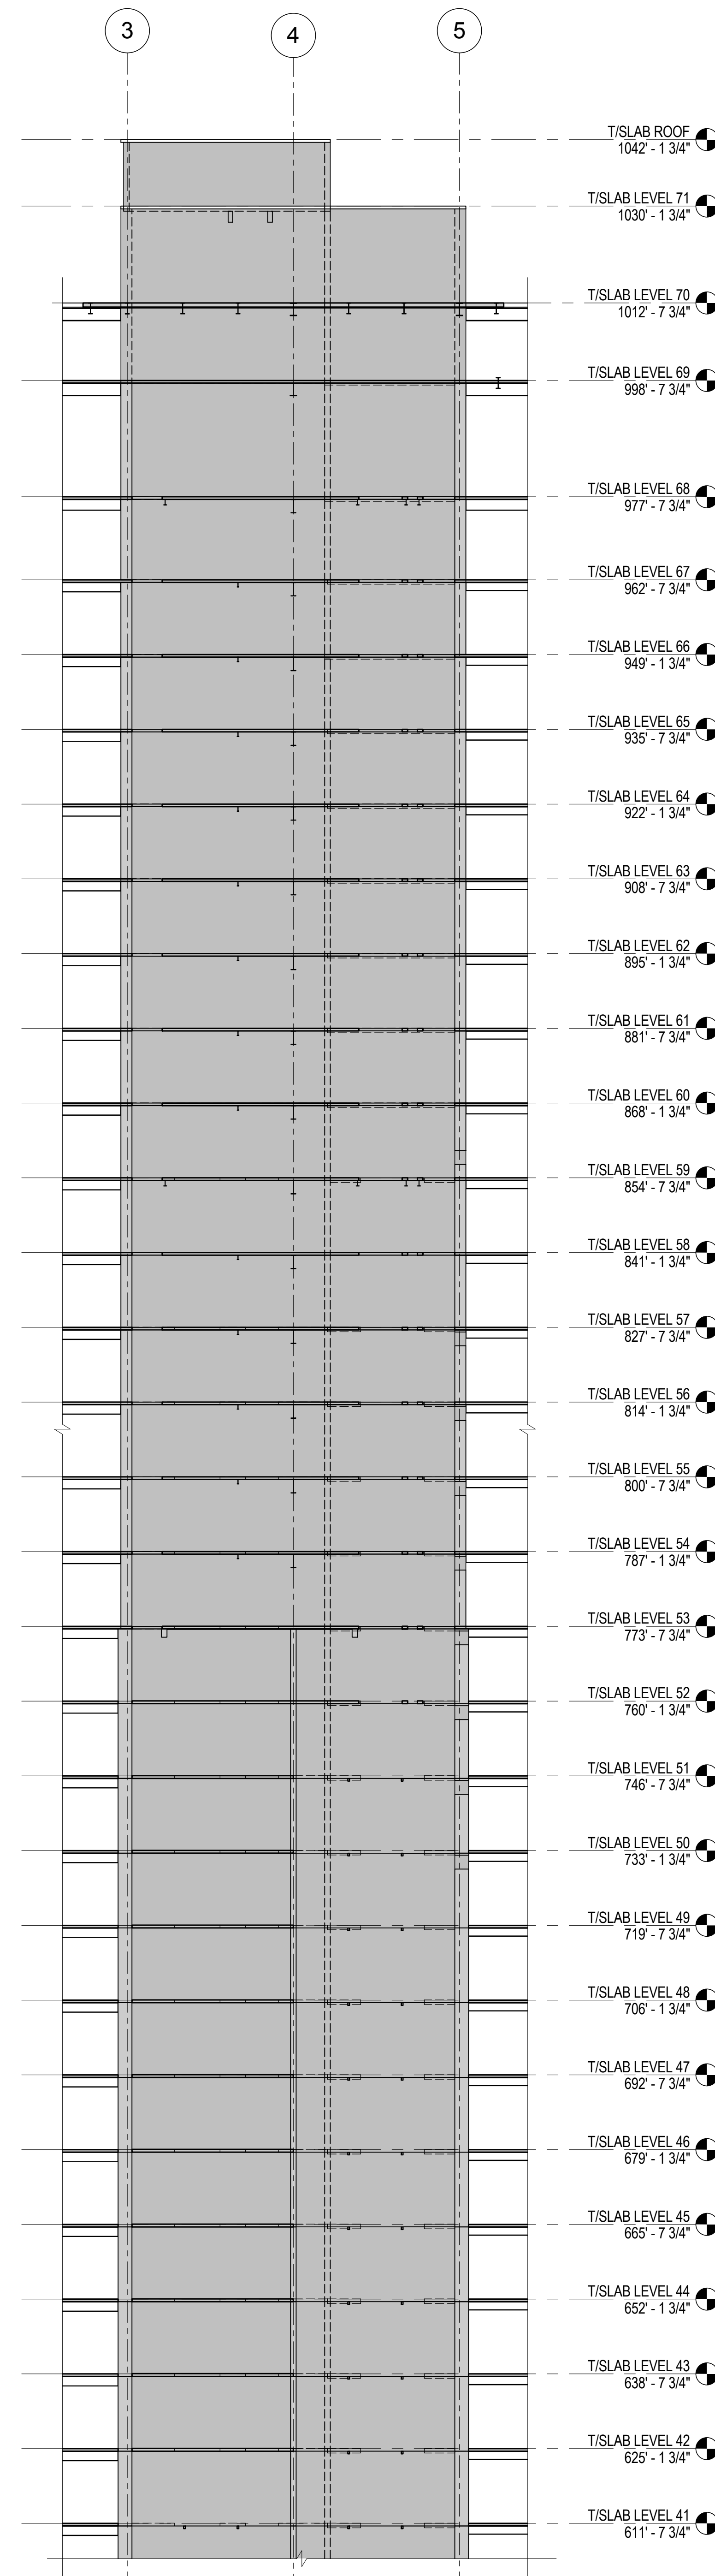

3 ELEVATION ALONG LINE D

1/16" = 1'-0"

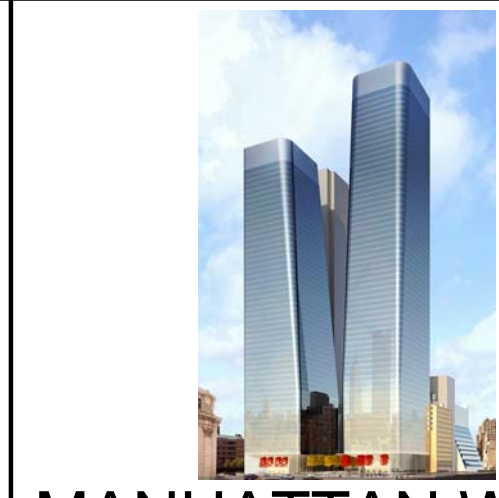

MANHATTAN WEST:
NORTH TOWER

375 Ninth Avenue, New York, NY 10001

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166 Ames Street, Hackensack, NJ 07601

Wind Tunnel Consultant

Rowan Williams Davies & Irwin Inc.

650 Woodlawn Road West, Guelph
Ontario, Canada N1K 1B6

Key Plan:

33RD STREET

DYER AVENUE

31ST STREET

9TH AVENUE

Seal & Signature:

PRELIMINARY
NOT FOR CONSTRUCTION

Project No.: 211157

Date: 20 JUN 2014

Scale: As indicated

File No: S-363

Sheet No.: S-363

Page No.: 67 of 90

Project Name: CORE WALL ELEVATIONS ALONG LINE D

Sheet Name: CORE WALL ELEVATIONS ALONG LINE D

Revision:

6 20 JUN 2014 ISSUED FOR FOUNDATION BID

5 20 JUN 2014 ISSUED FOR FOUNDATION PERMIT

4 20 DEC 2013 ISSUED FOR FOUNDATION PERMIT

3 15 NOV 2013 ISSUED FOR 2D PROGRESS PRICING

2 12 JUL 2013 ISSUED FOR 90% DESIGN DEVELOPMENT

1 19 MAR 2012 ISSUED FOR RECONCILIATION

No. Date Description

Sheet Name: CORE WALL ELEVATIONS ALONG LINE D

Project No.: 211157


Date: 20 JUN 2014

Scale: As indicated


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Sheet No.: S-363


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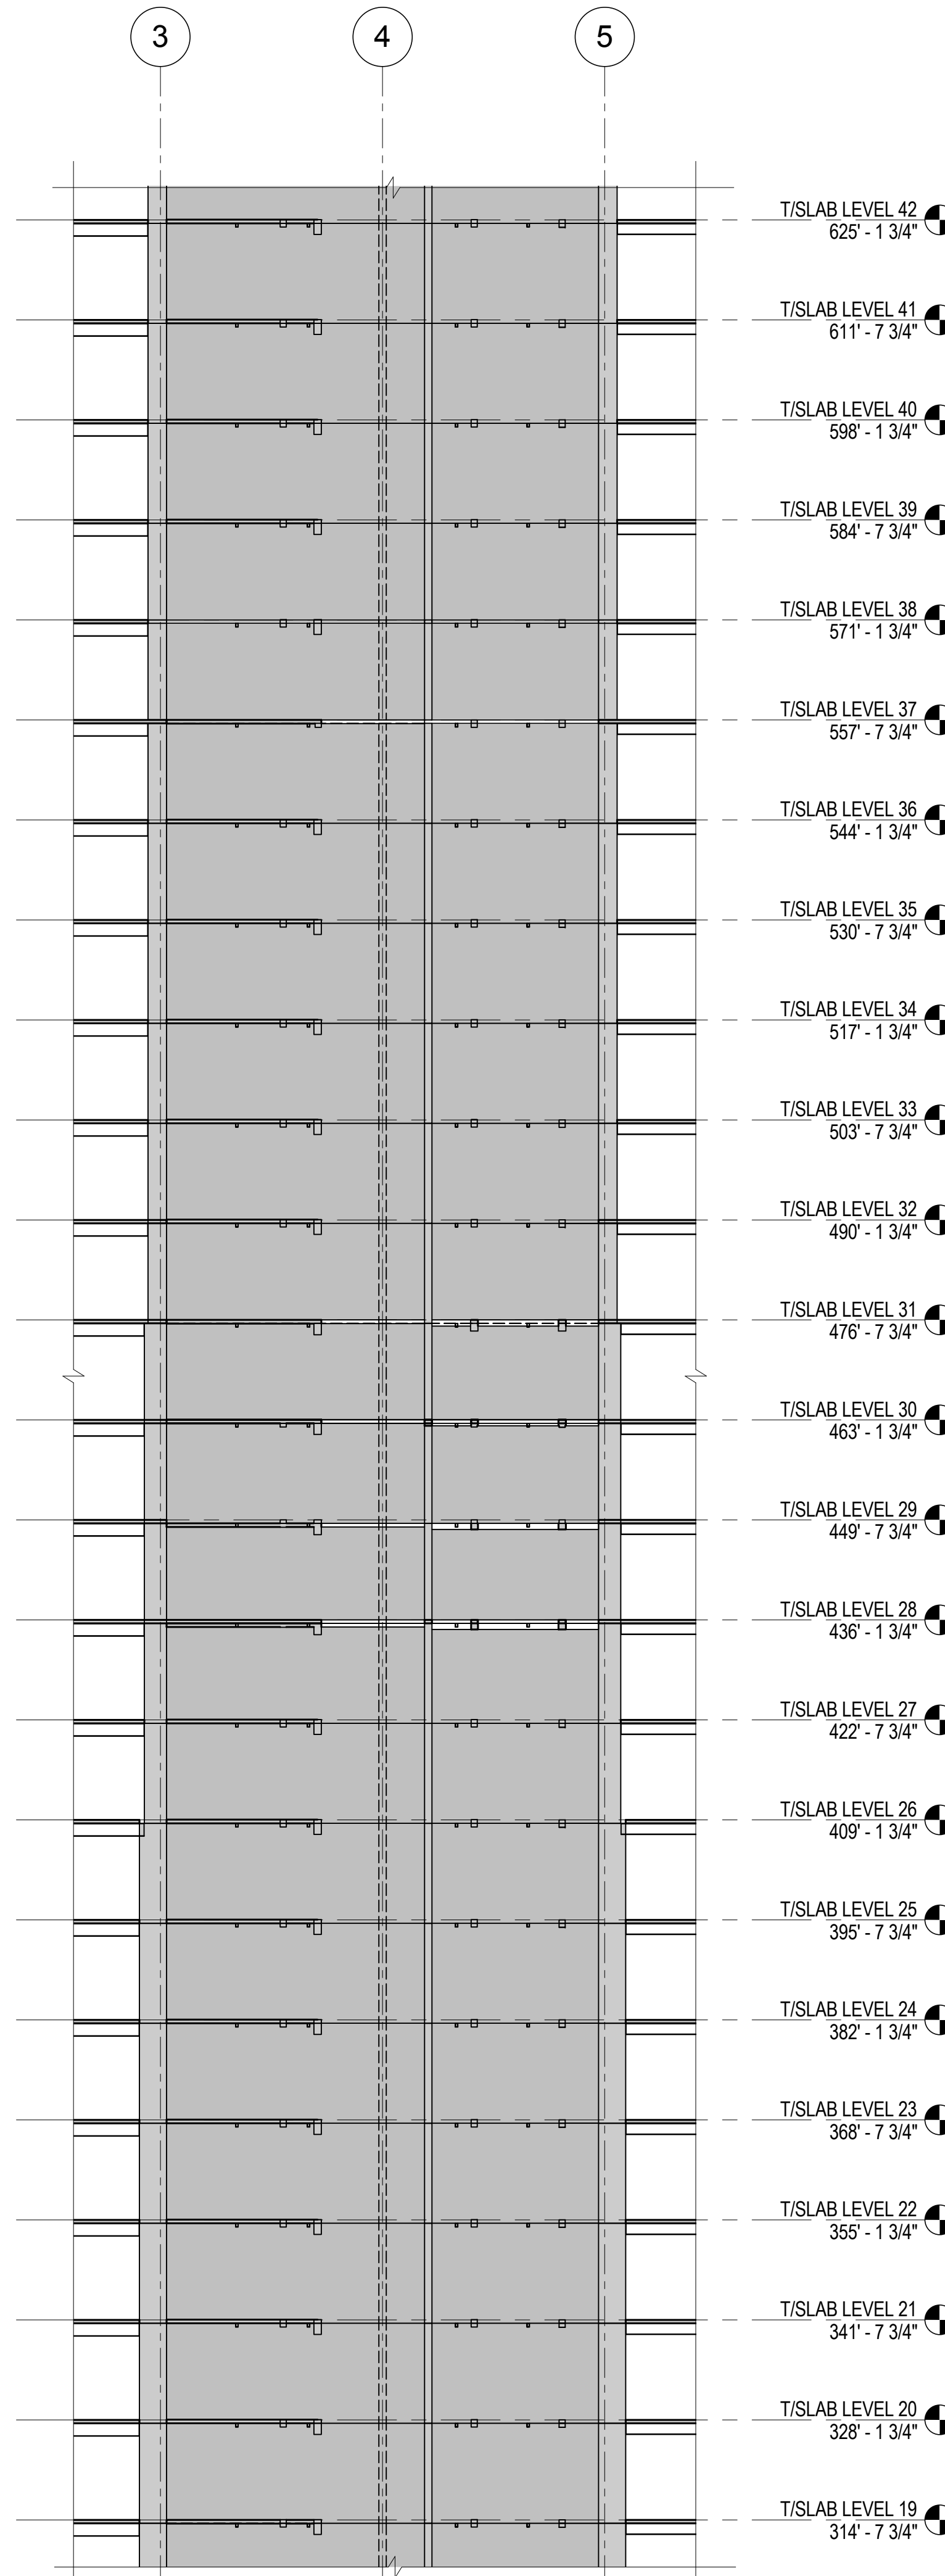
CORE WALL ELEVATION KEY PLAN
NTS

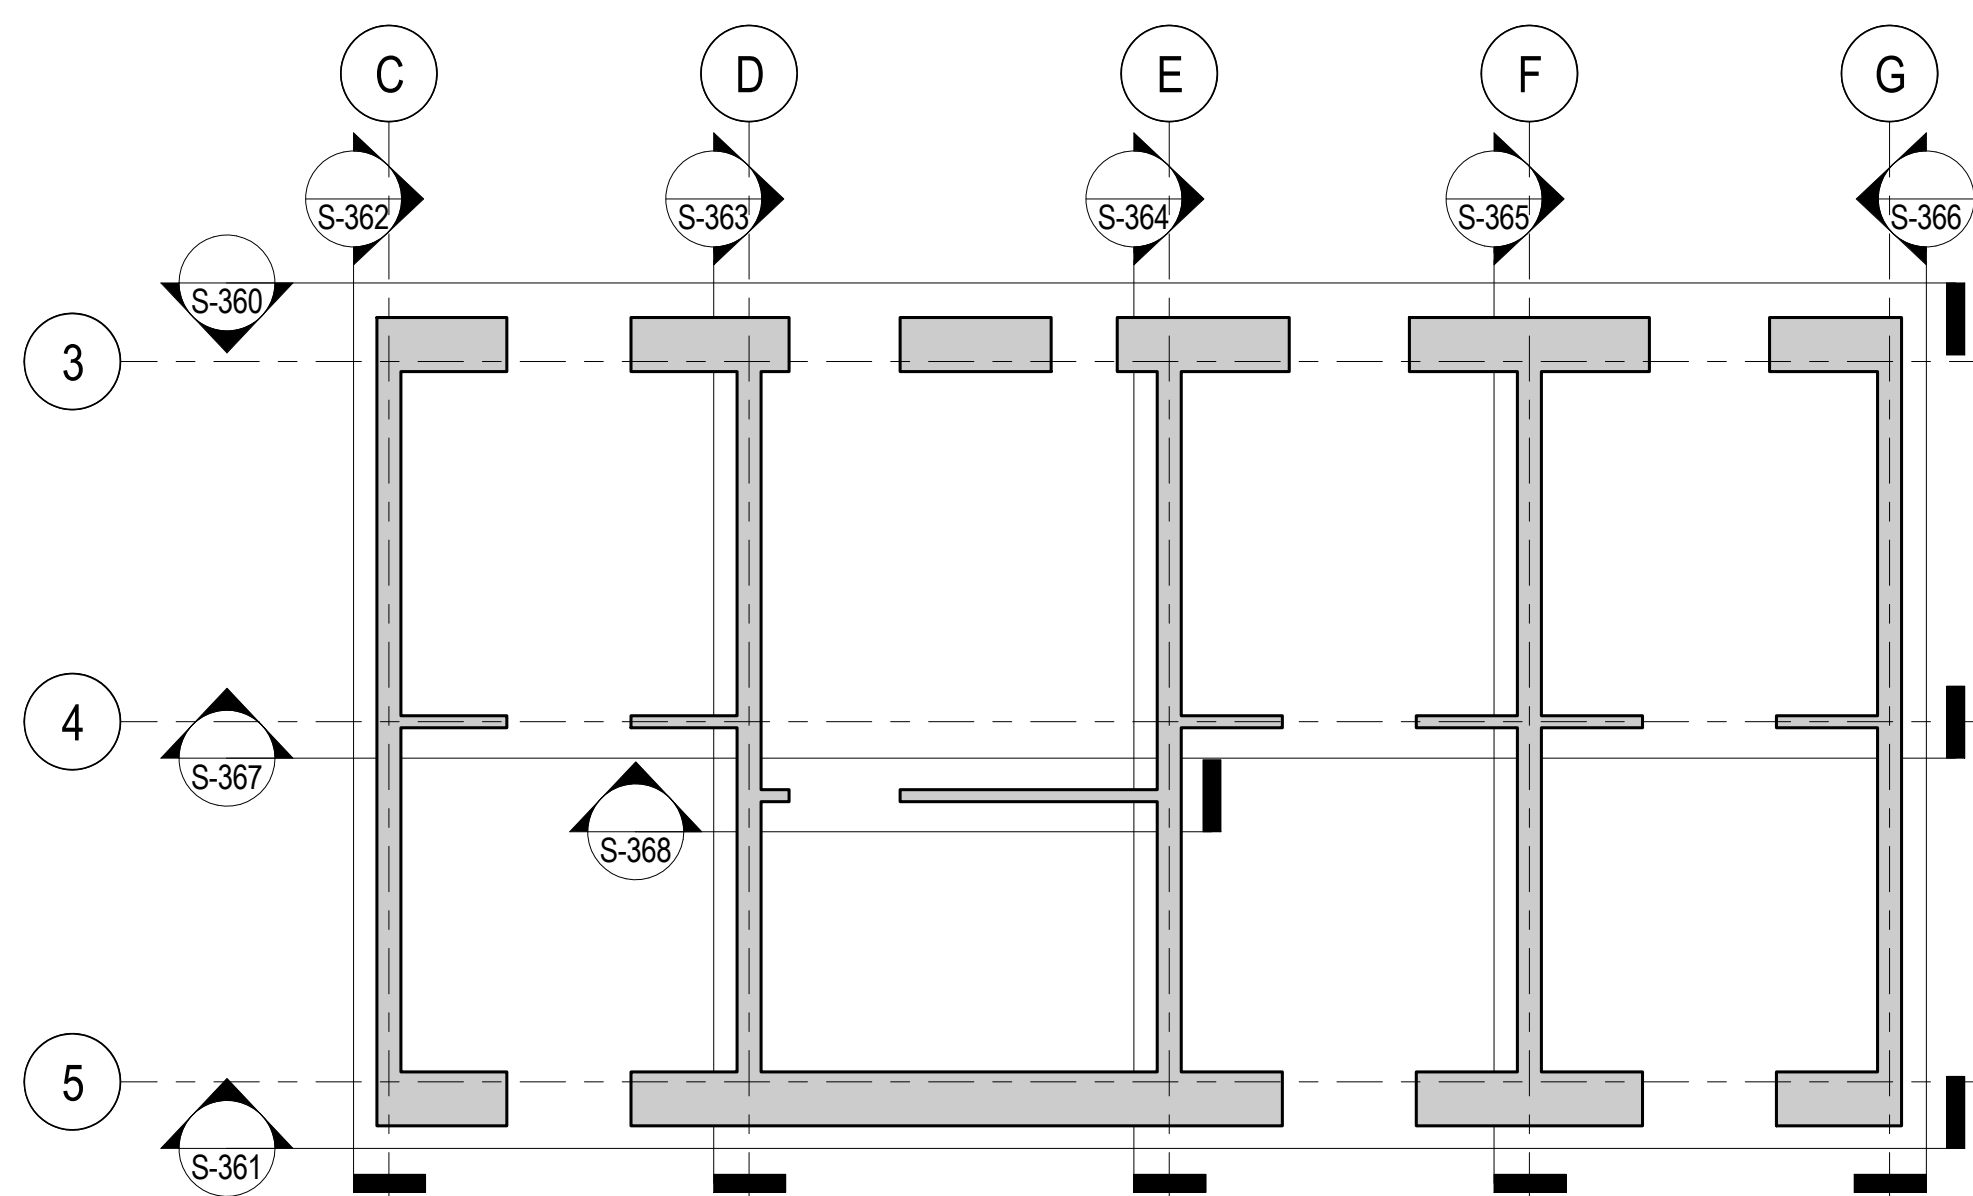


ELEVATION KEY
N.T.S

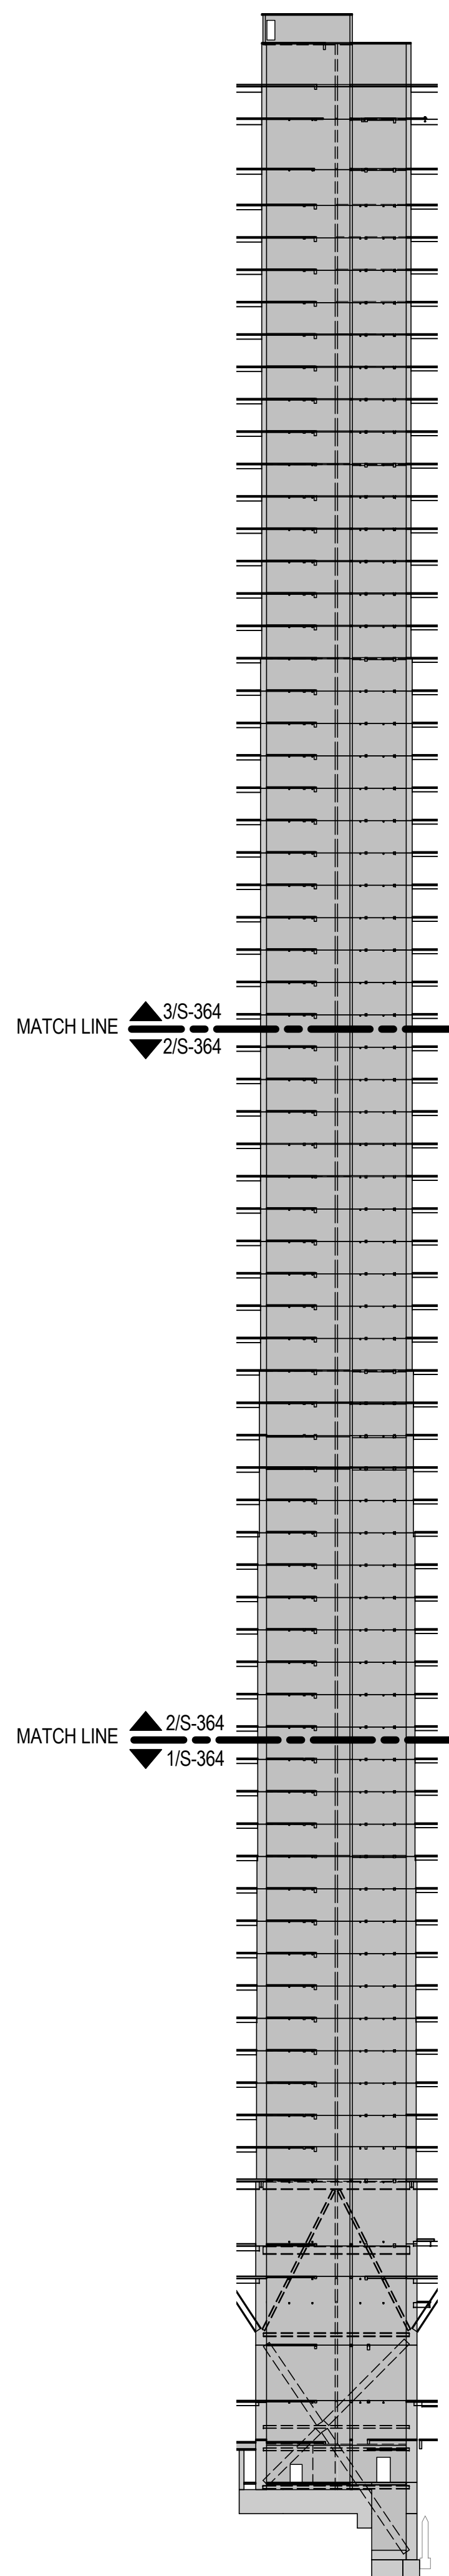

1 ELEVATION ALONG LINE E
1/16" = 1'-0"

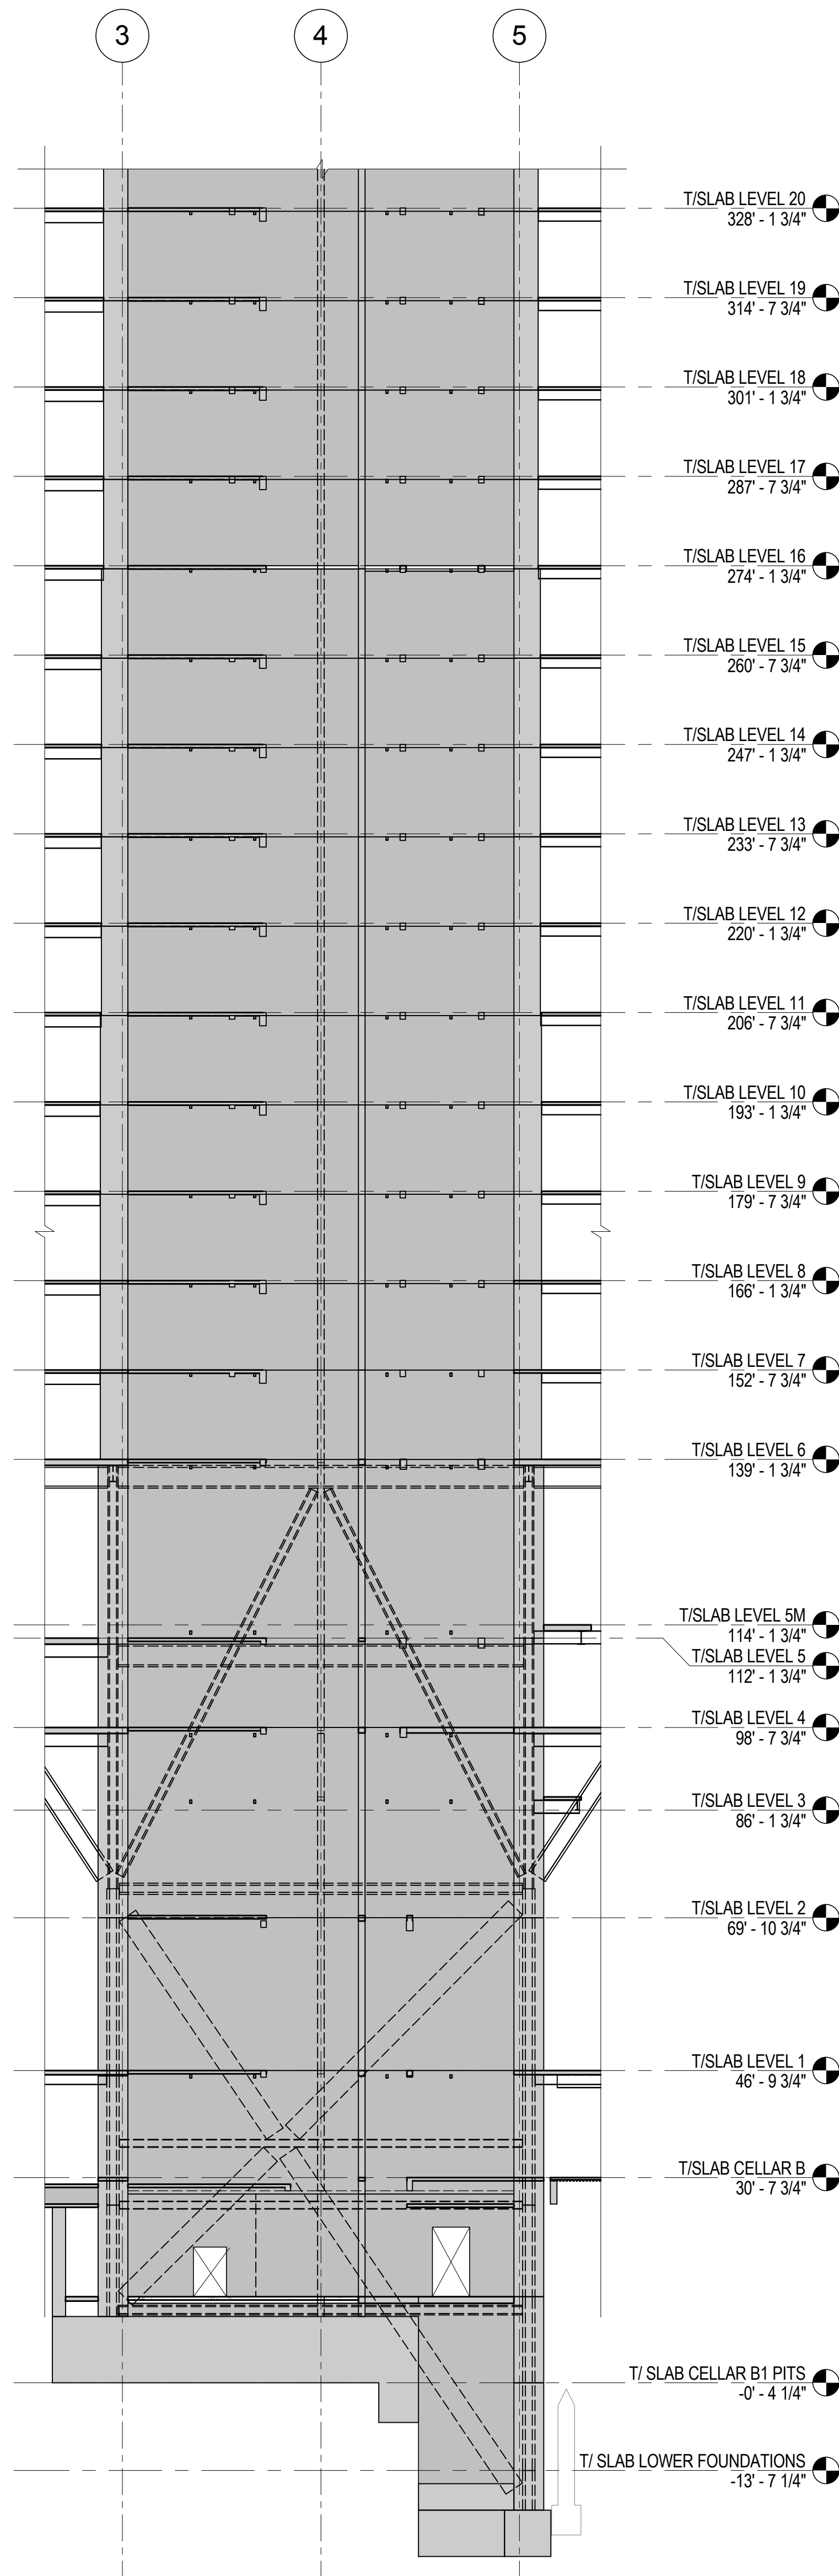

2 ELEVATION ALONG LINE E
1/16" = 1'-0"

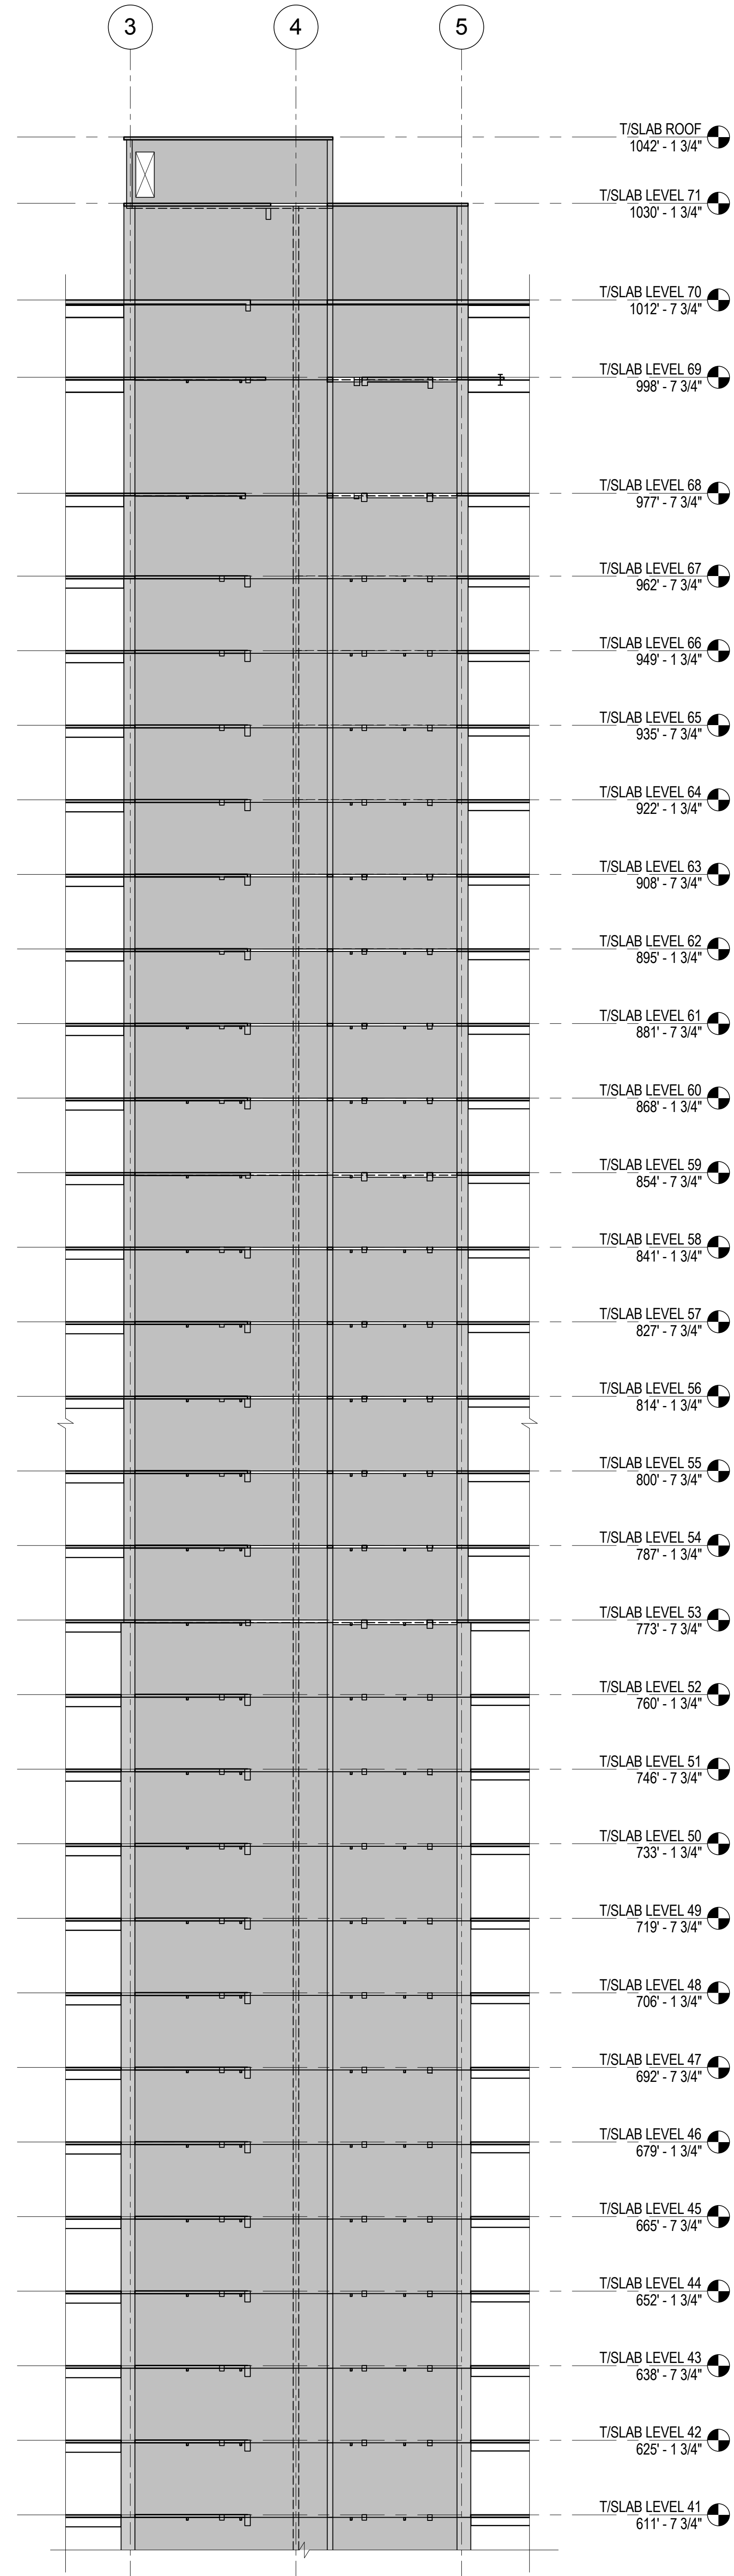

3 ELEVATION ALONG LINE E
1/16" = 1'-0"

MANHATTAN WEST:
NORTH TOWER
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Geo-Technical Engineering

Mueser Rutledge Consulting Engineers
14 Penn Plaza, 22nd W, 34th Street #610,
New York, NY 10022

Landscape Consultant

Field Operations
475 10th Avenue, New York, NY 10018

Security Consultant

Ducibella, Ventor & Santore
250 State Street #F1, North Haven, CT 06473

Blast Consultant

Weidinger Associates, Inc.
40 Wall Street, New York, NY 10005

Acoustical Consultant

Cerami & Associates
404 Fifth Avenue #8, New York, NY 10016

Vibration Consultant

Wilson, Uhrig & Associates, Inc.
65 Broadway, Suite 401, New York, NY 10006

Code Consultant

Code Consultants Professional Engineers PC
215 West 40th Street, 15th Floor, New York, NY 10018

Facade Maintenance Consultant

Entek Engineering LLC
166 Ames Street, Hackensack, NJ 07601

Wind Tunnel Consultant

Rowan Williams Davies & Irwin Inc.
680 Woodlawn Road West, Guelph
Ontario, Canada N1K 1B6

Key Plan:

Seal & Signature:


PRELIMINARY
NOT FOR CONSTRUCTION

6	20 JUN 2014	ISSUED FOR FOUNDATION BID
5	20 JUN 2014	ISSUED FOR FOUNDATION PERMIT
4	20 DEC 2013	ISSUED FOR FOUNDATION PERMIT
3	15 NOV 2013	ISSUED FOR 2D PROGRESS PRICING
2	12 JUL 2013	ISSUED FOR 90% DESIGN DEVELOPMENT
1	19 MAR 2012	ISSUED FOR RECONCILIATION


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Sheet Name: CORE WALL ELEVATIONS ALONG LINE E


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Date: 20 JUN 2014	Sheet No.: S-364
Scale: As indicated	Page No.: 68 of 90
File No.: S-364	

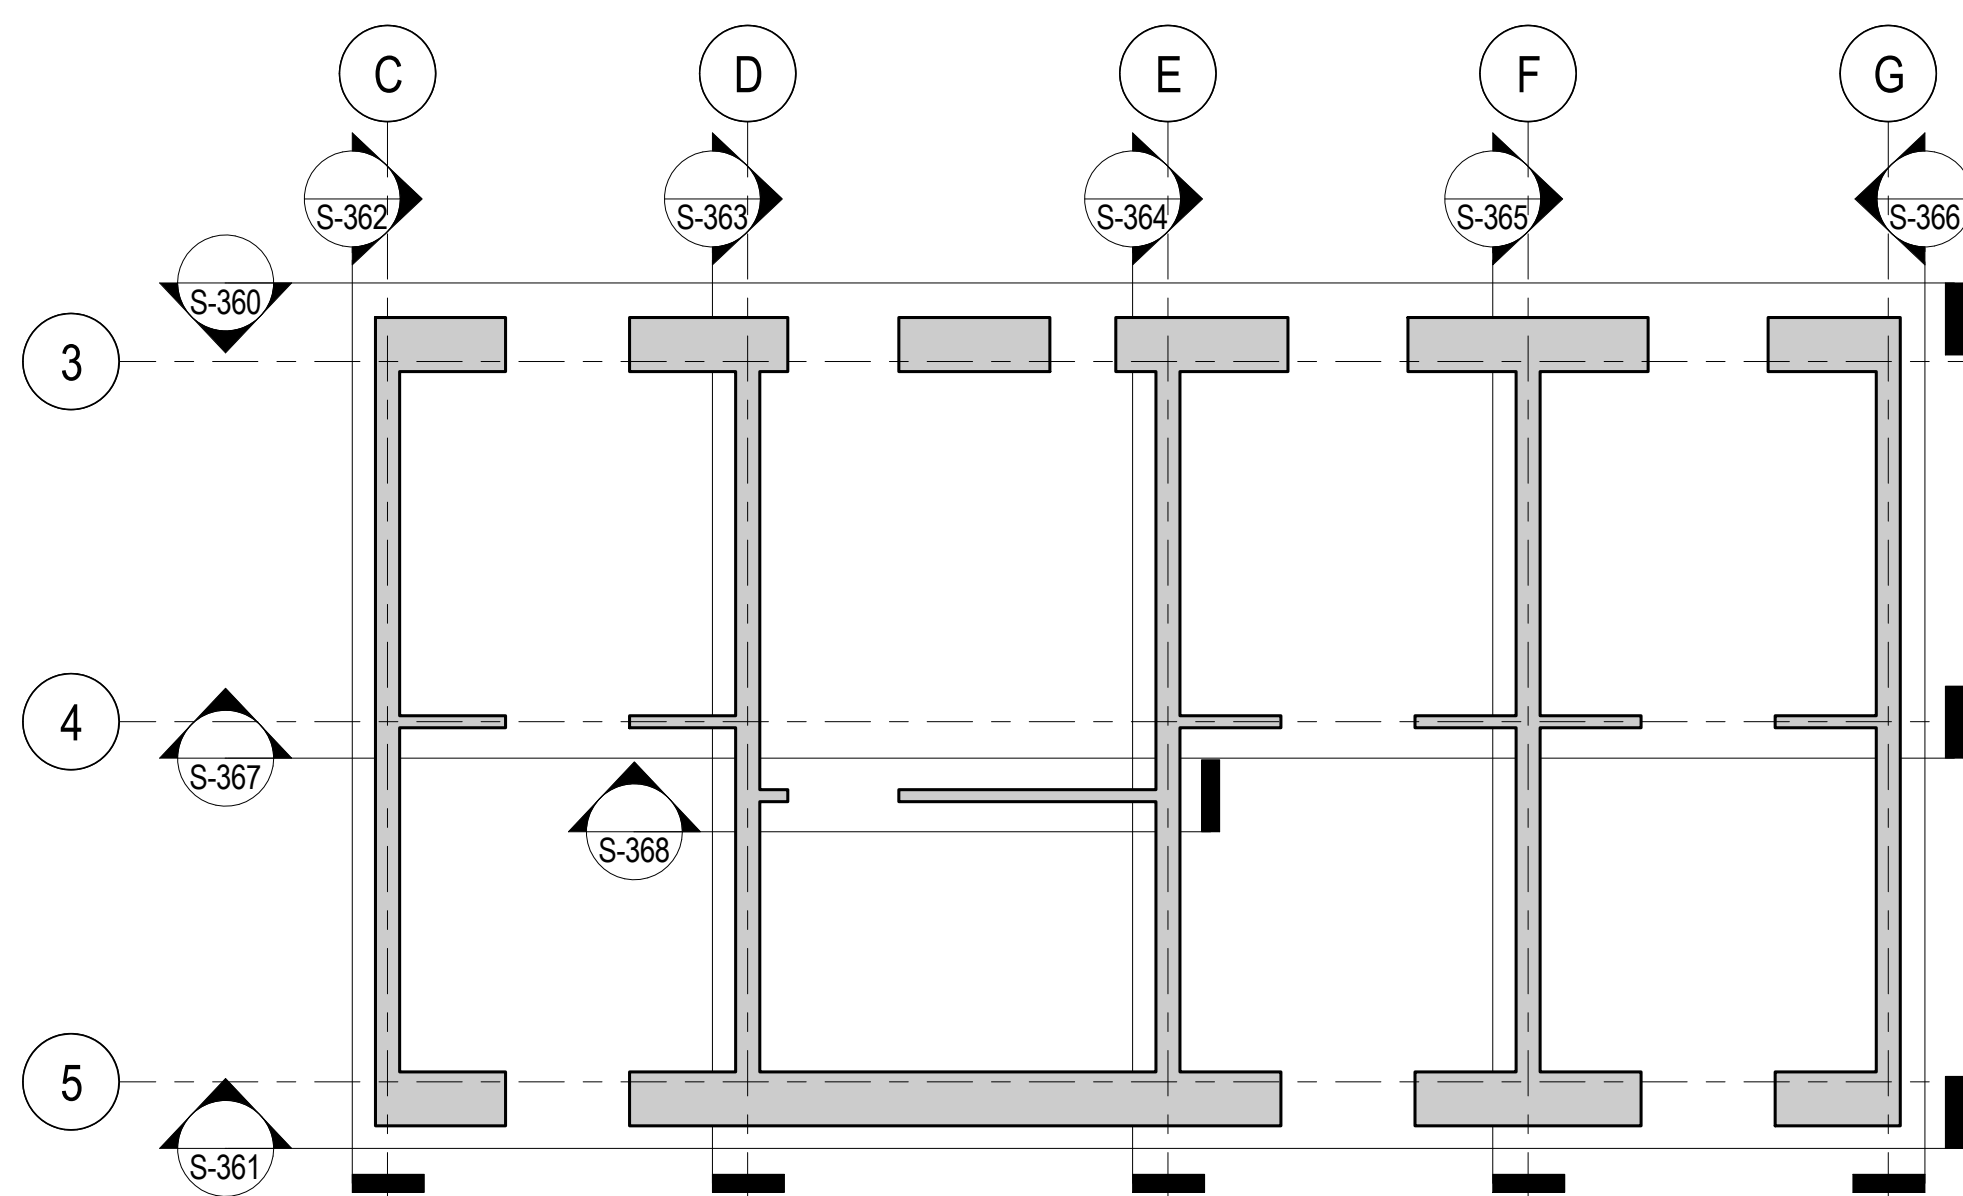


CORE WALL ELEVATION KEY PLAN
NTS

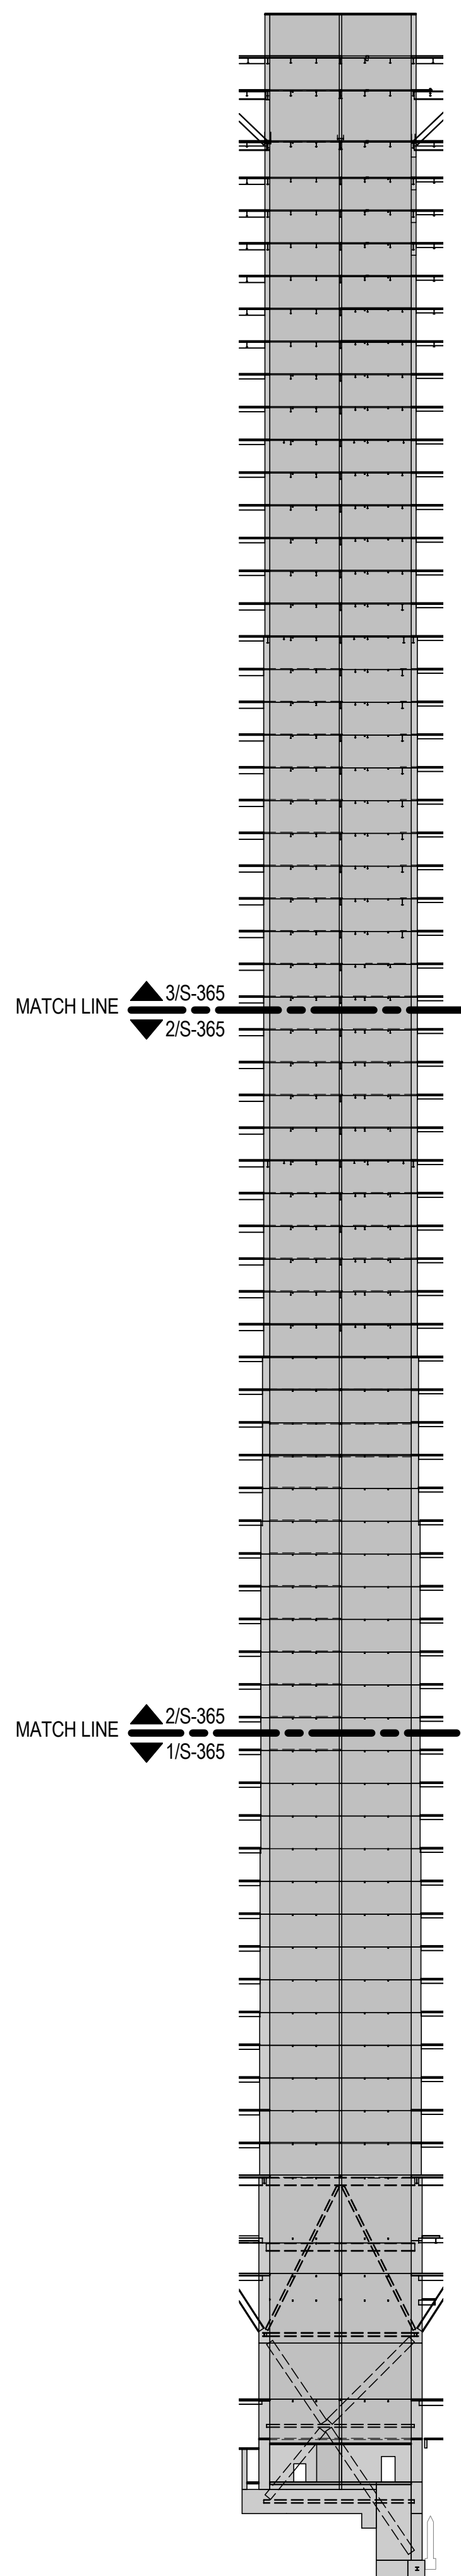


ELEVATION KEY
NTS

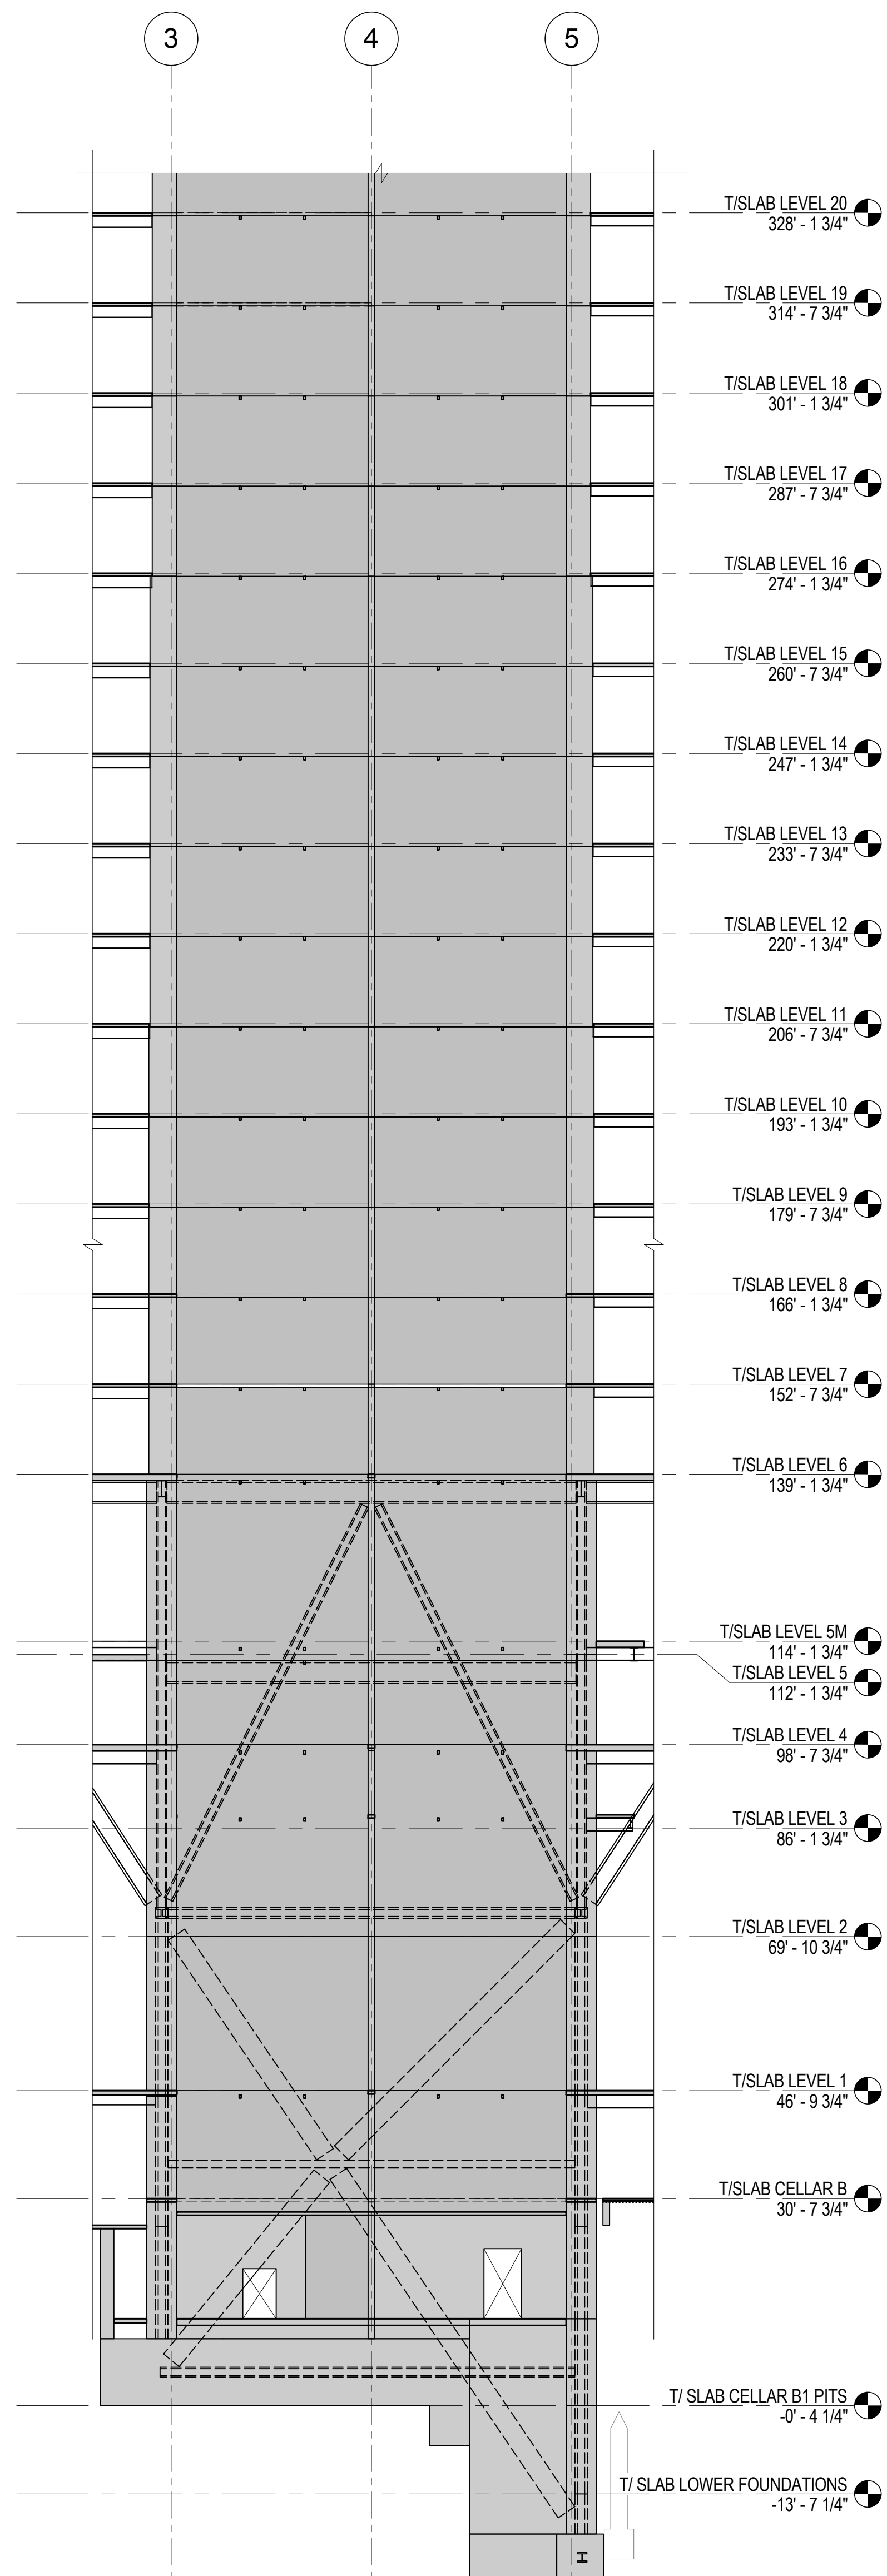

1 ELEVATION ALONG LINE F
1/16" = 1'-0"

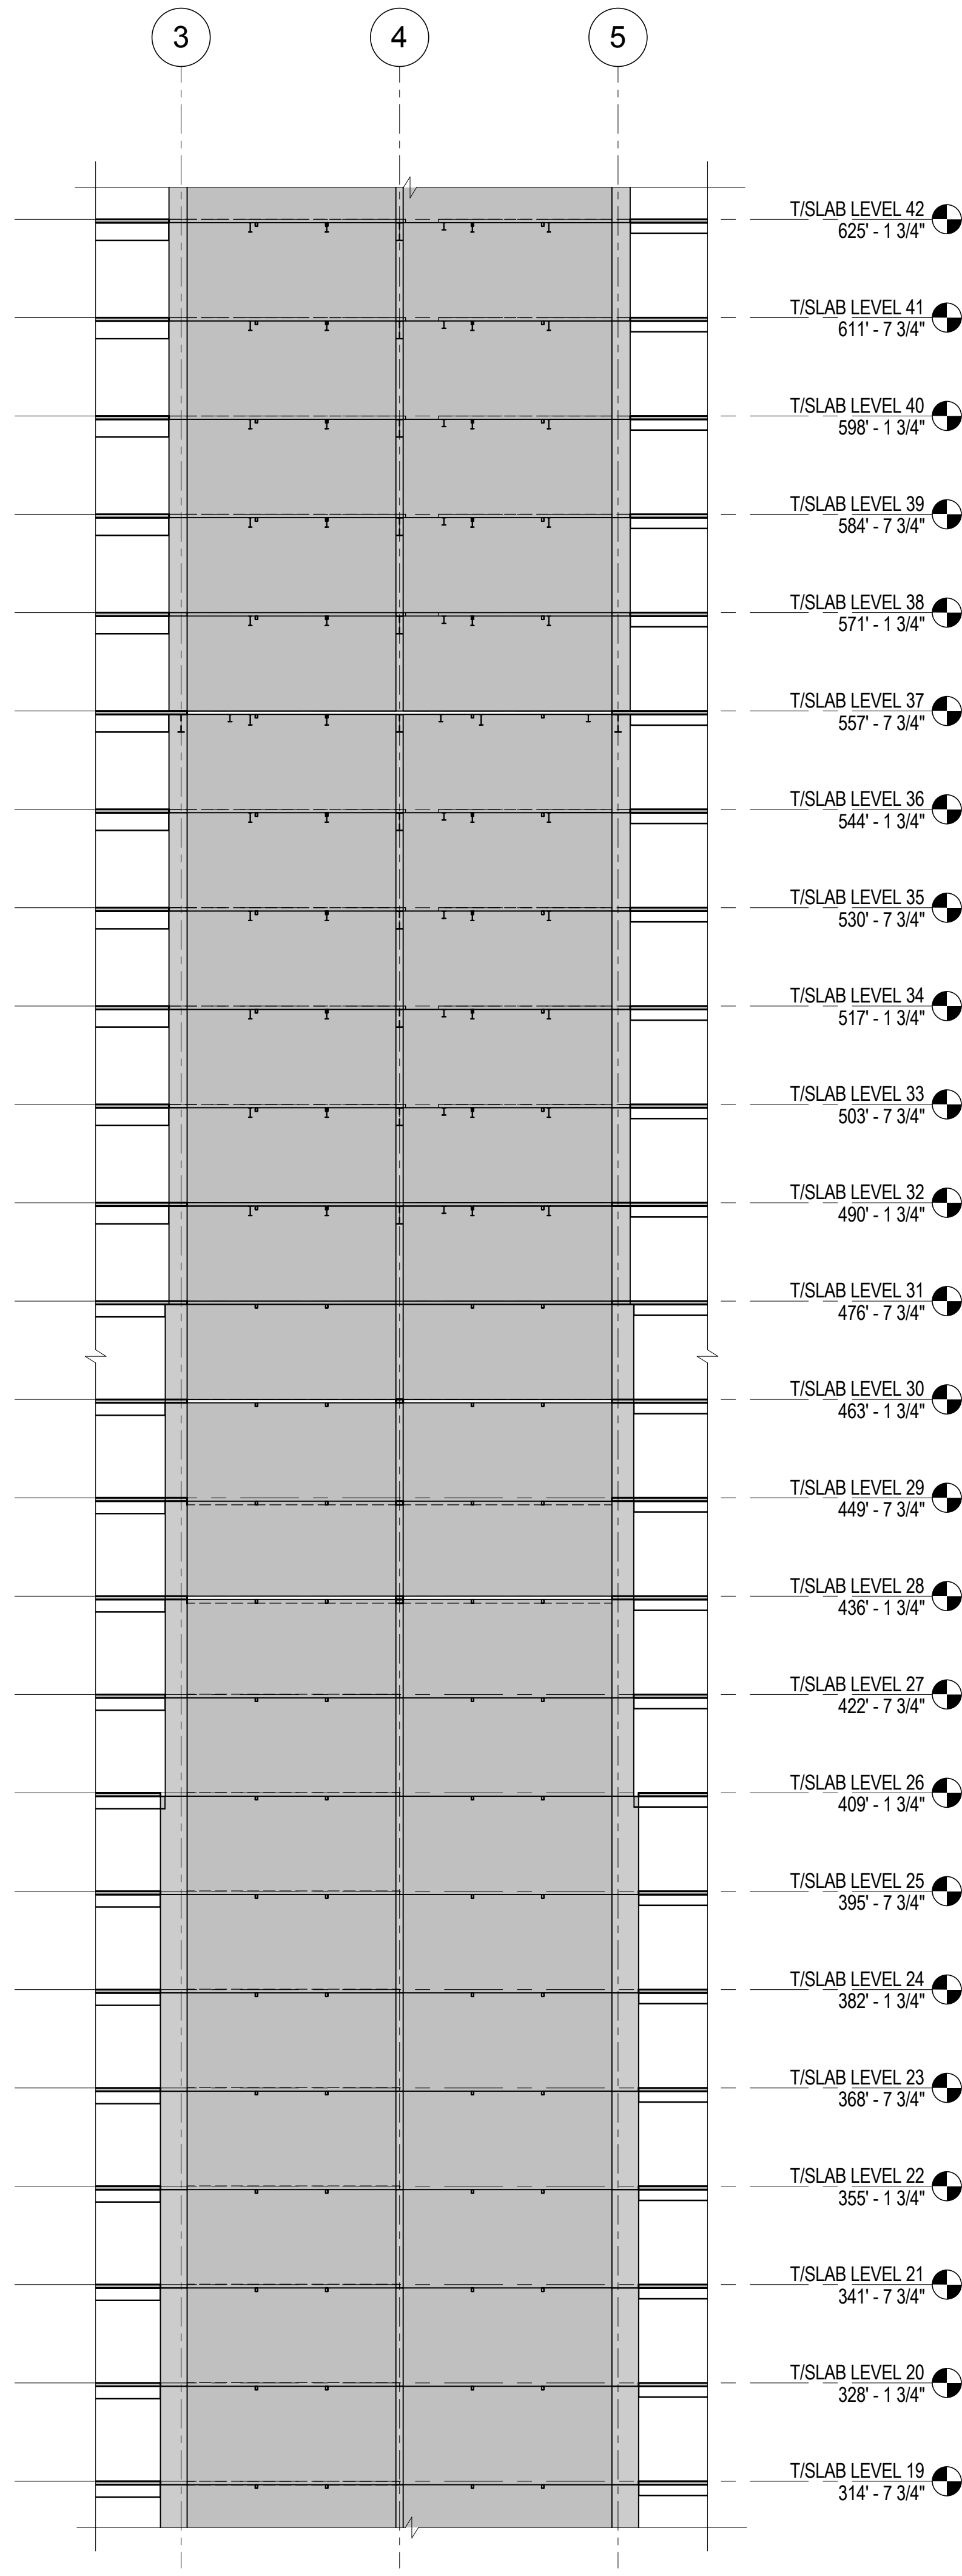

2 ELEVATION ALONG LINE F
1/16" = 1'-0"

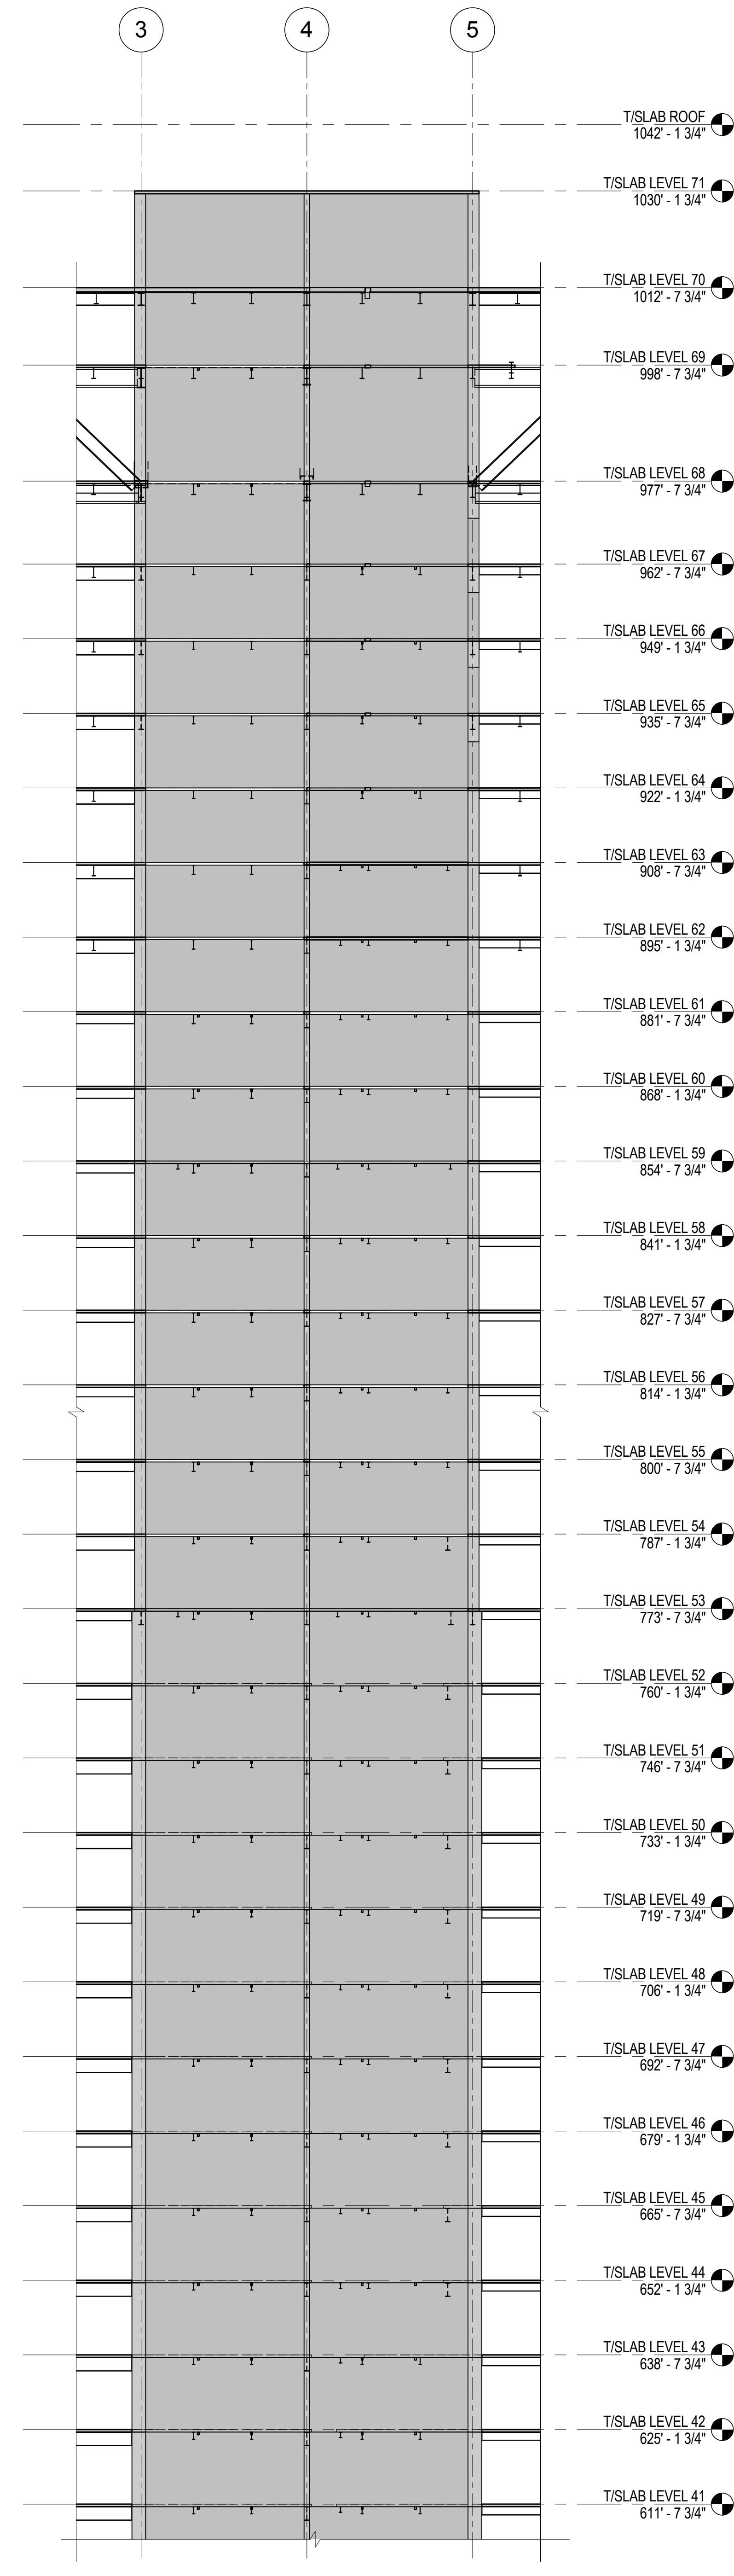

3 ELEVATION ALONG LINE F
1/16" = 1'-0"



MANHATTAN WEST:
NORTH TOWER
375 Ninth Avenue, New York, NY 10001

Client

Brookfield

Brookfield Place
250 Vesey Street, 15th Floor, New York, NY 10021

Architecture/Structural Engineering

SOM

Skidmore, Owings & Merrill LLP
14 Wall Street, New York, NY 10005

Civil Engineering

Philip Habib & Associates
102 Madison Avenue #11, New York, NY 10016

MEP Engineering

Jaros Baum & Bolles
80 Pine Street, New York, NY 10005

Vertical Transportation

Edgett Williams Consulting Group, Inc.
102 East 8th Street, Suite 1, Mill Valley, California 94040

Sustainable Design

Viridian Energy & Environmental
50 Washington Street, Newark, CT 06854

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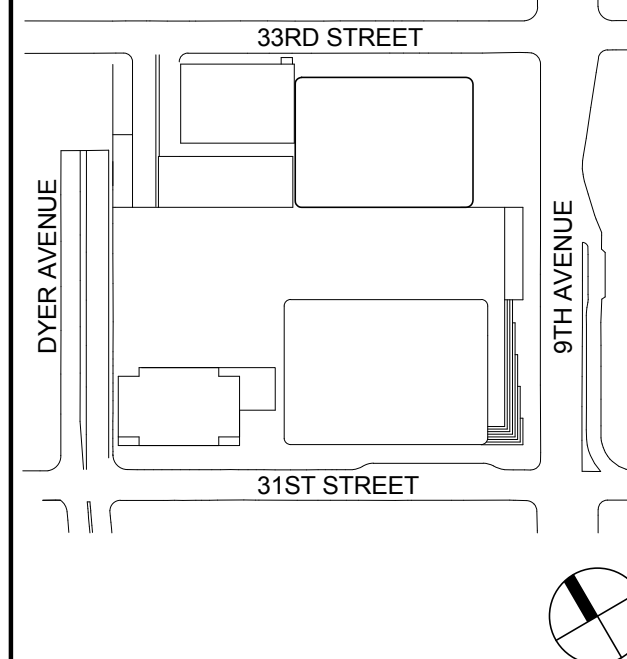
Entek Engineering LLC
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680 Woodlawn Road West, Guelph
Ontario, Canada N1K 1B8



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No. Date Description

Sheet Name

CORE WALL
ELEVATIONS
ALONG LINE F

Project No.:

211157

Date:

20 JUN 2014

Scale:

As indicated

File No.:

S-365

B-SCAN Sheet No.:


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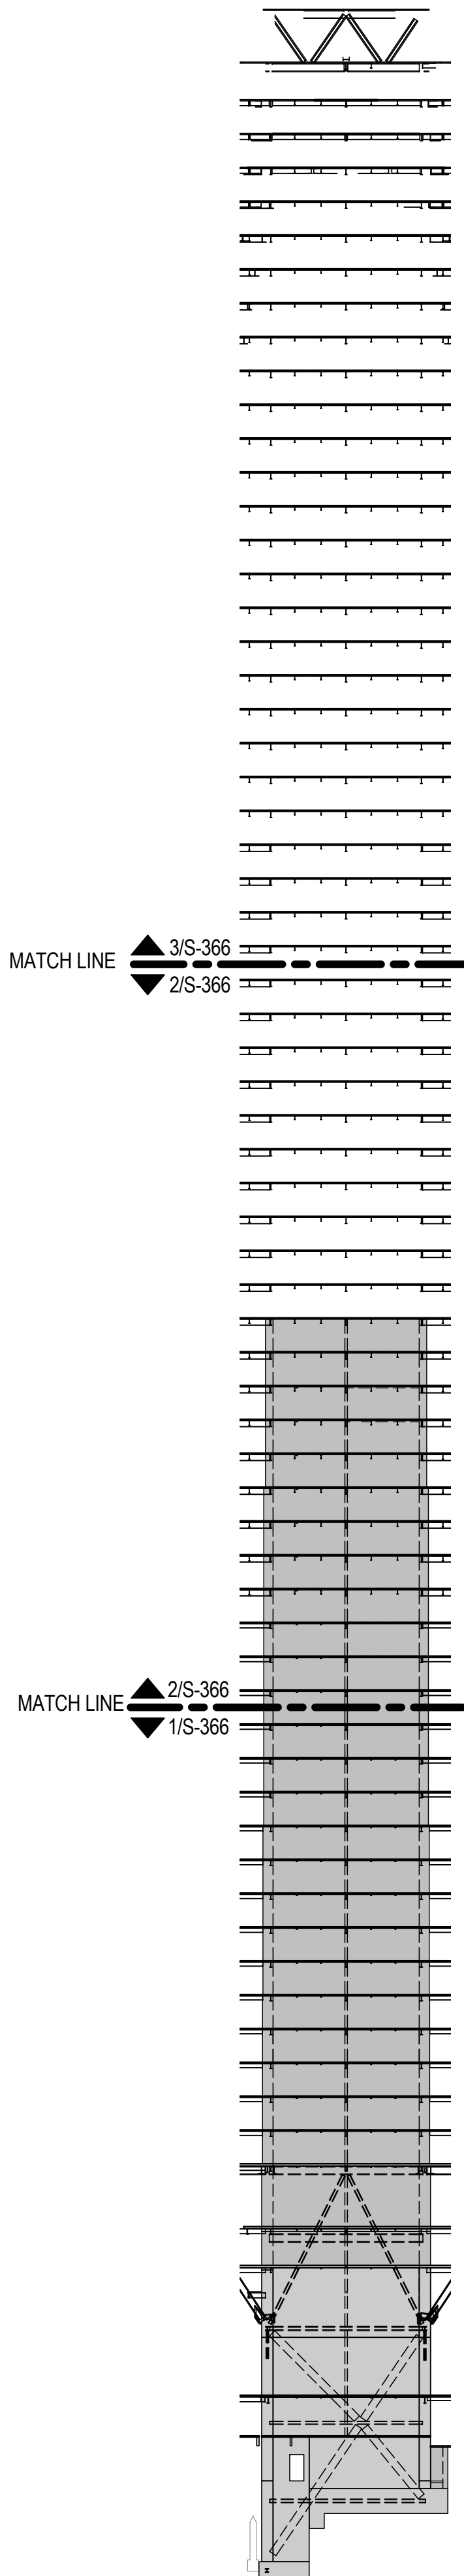
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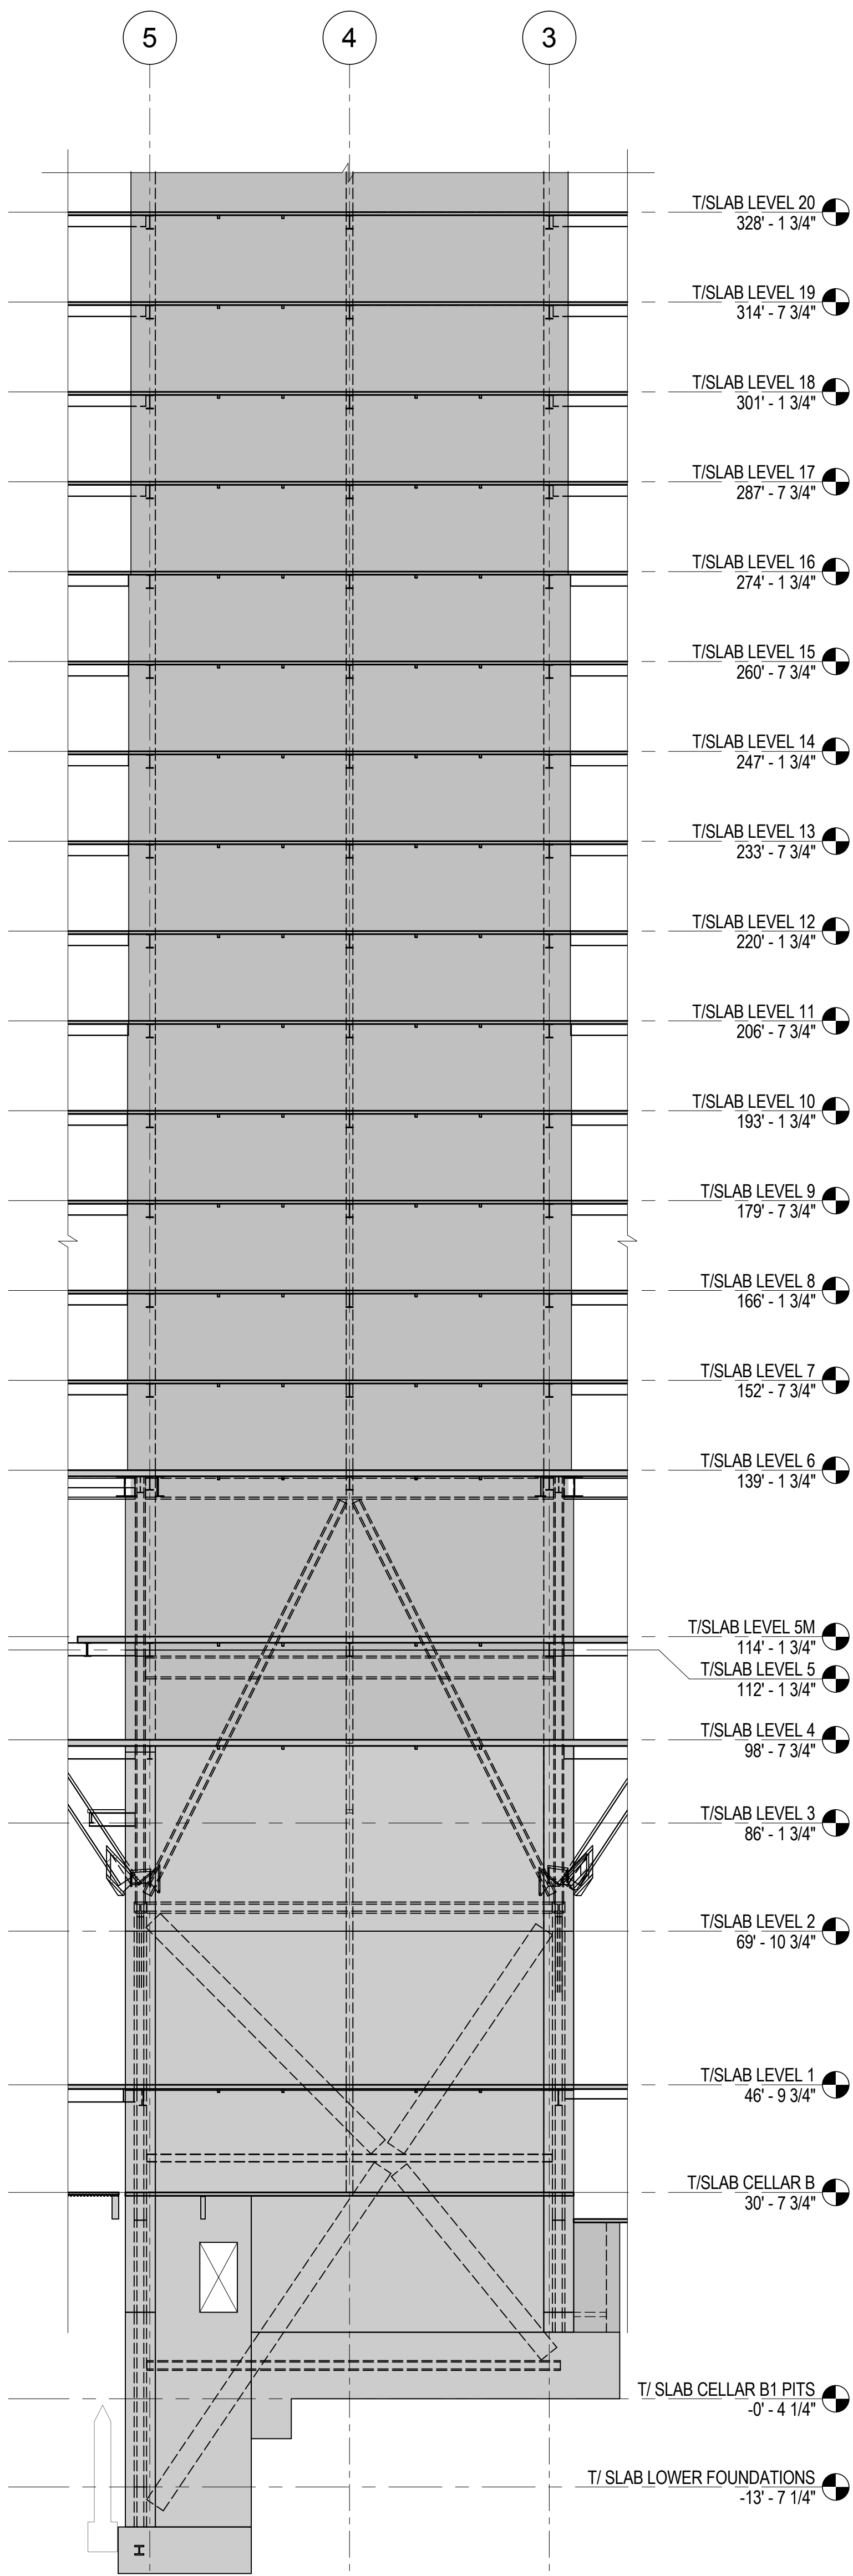
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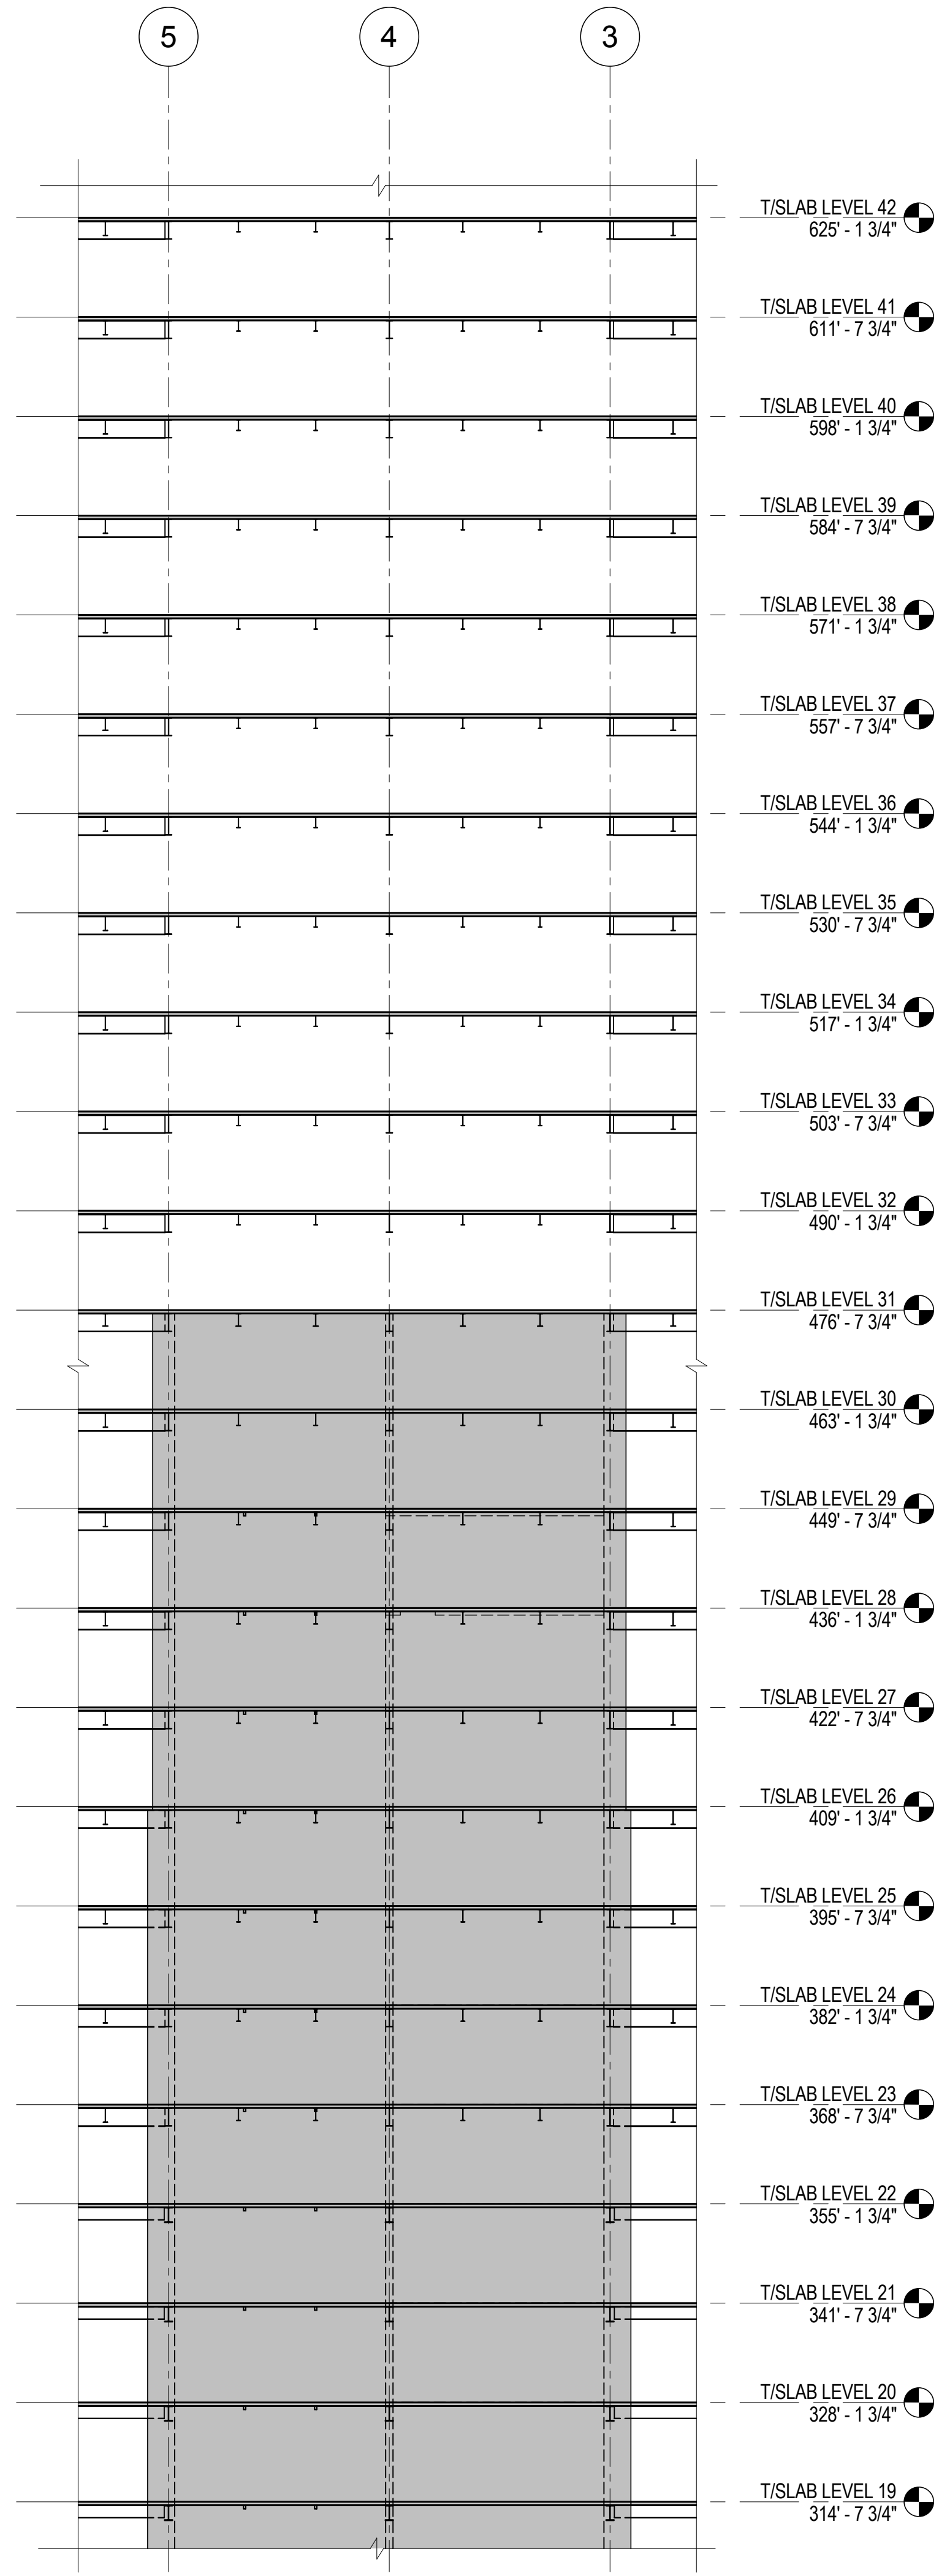
CORE WALL ELEVATION KEY PLAN
NTS



ELEVATION KEY
NTS



1 ELEVATION KEY
1/16" = 1'-0"

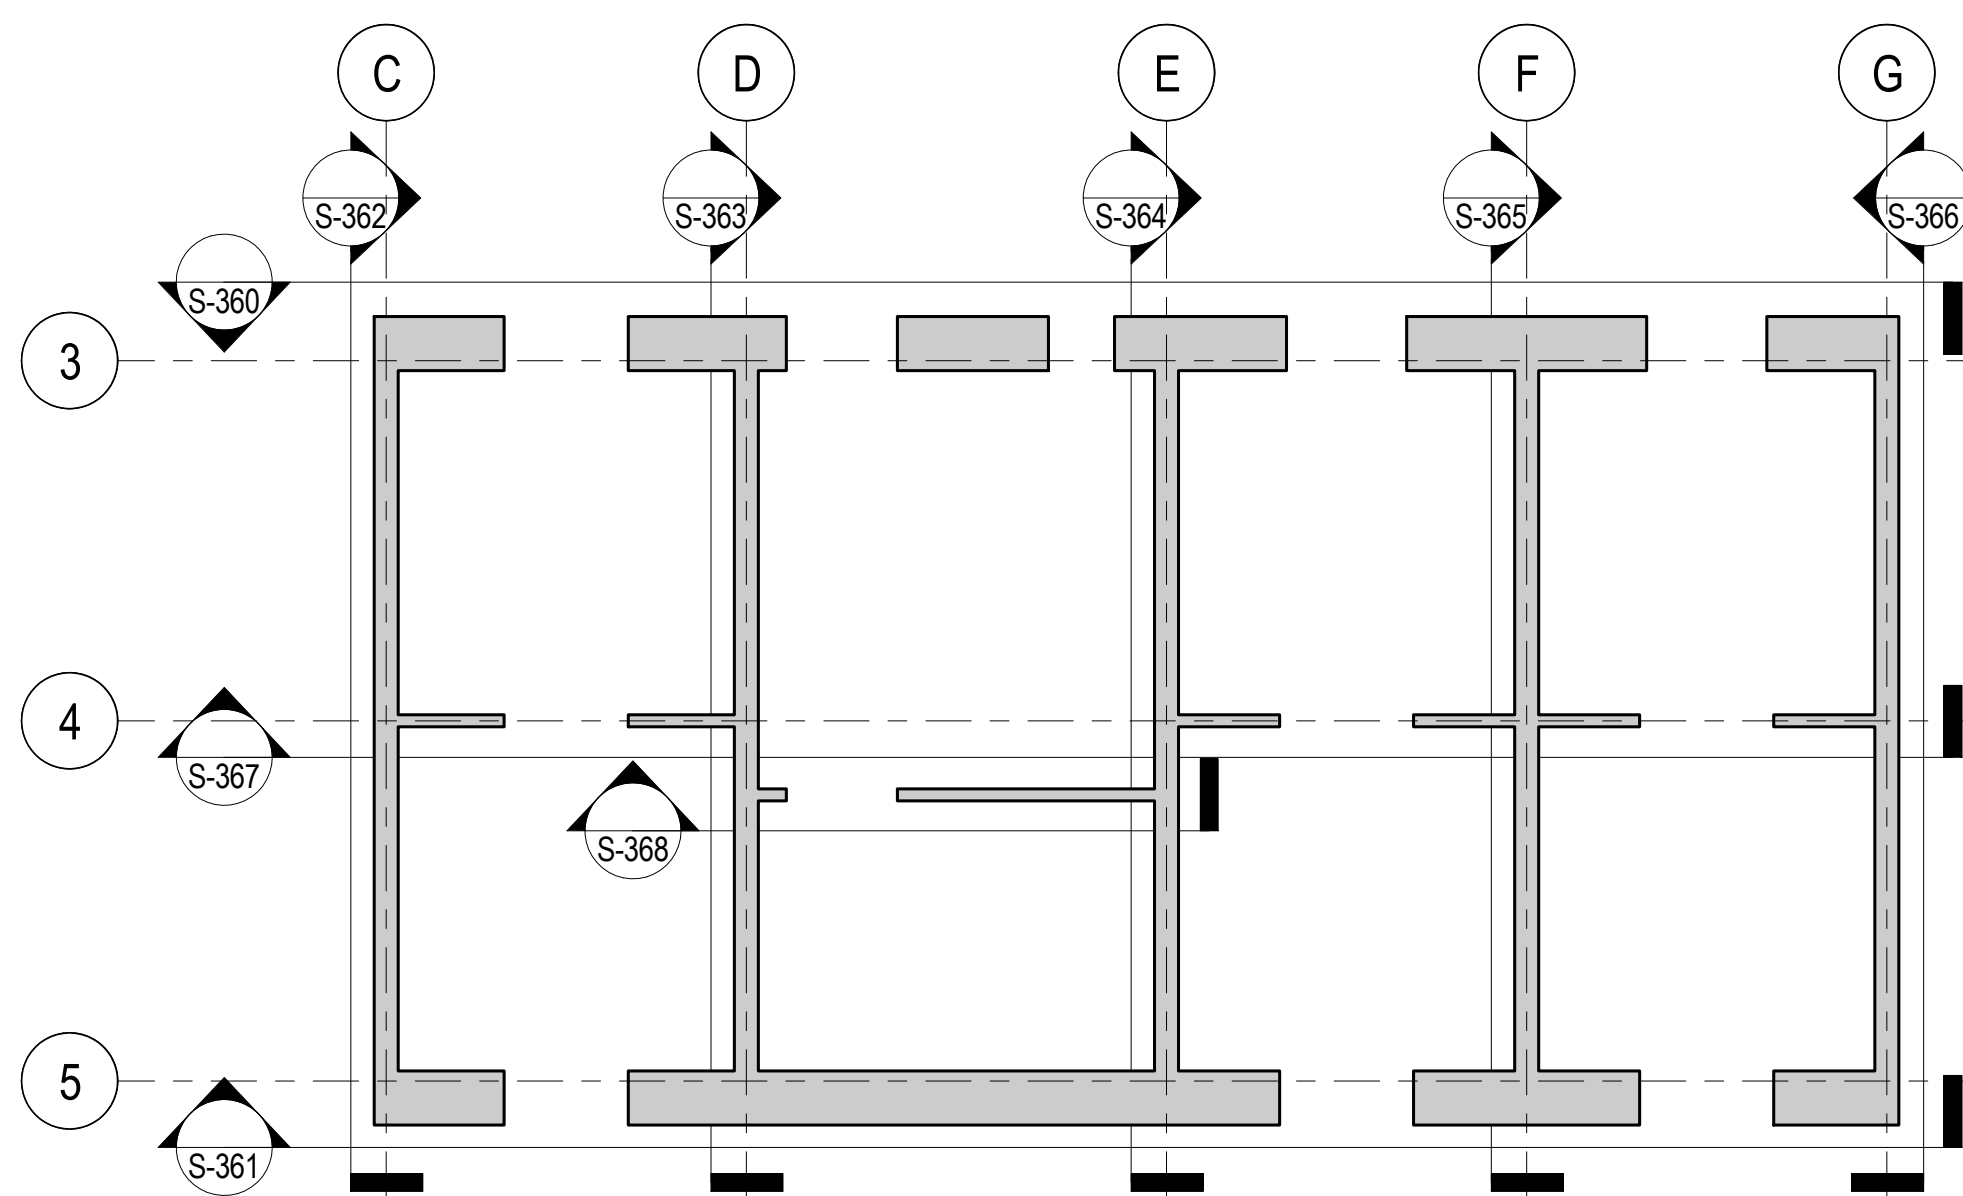

2 ELEVATION KEY
1/16" = 1'-0"



3 ELEVATION KEY
1/16" = 1'-0"



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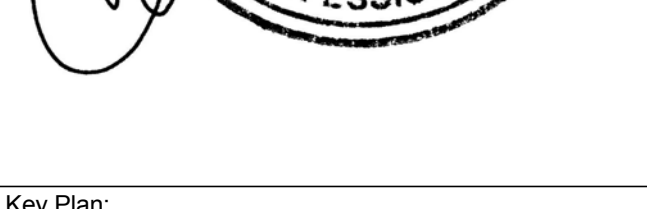
Acoustical Consultant
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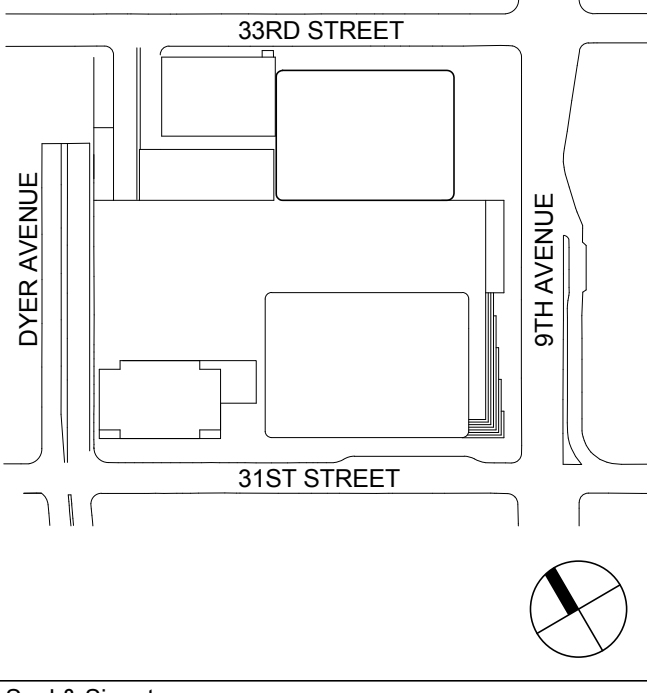
Code Consultant
Code Consultants Professional Engineers PC
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680 Woodlawn Road West, Guelph
Ontario, Canada N1K 1B8



Key Plan:



Seal & Signature:

PRELIMINARY
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Project No.: 211157
B-SCAN Sheet No.: S-366.00

Date: 20 JUN 2014
Scale: As indicated


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Page No.: 70 of 90

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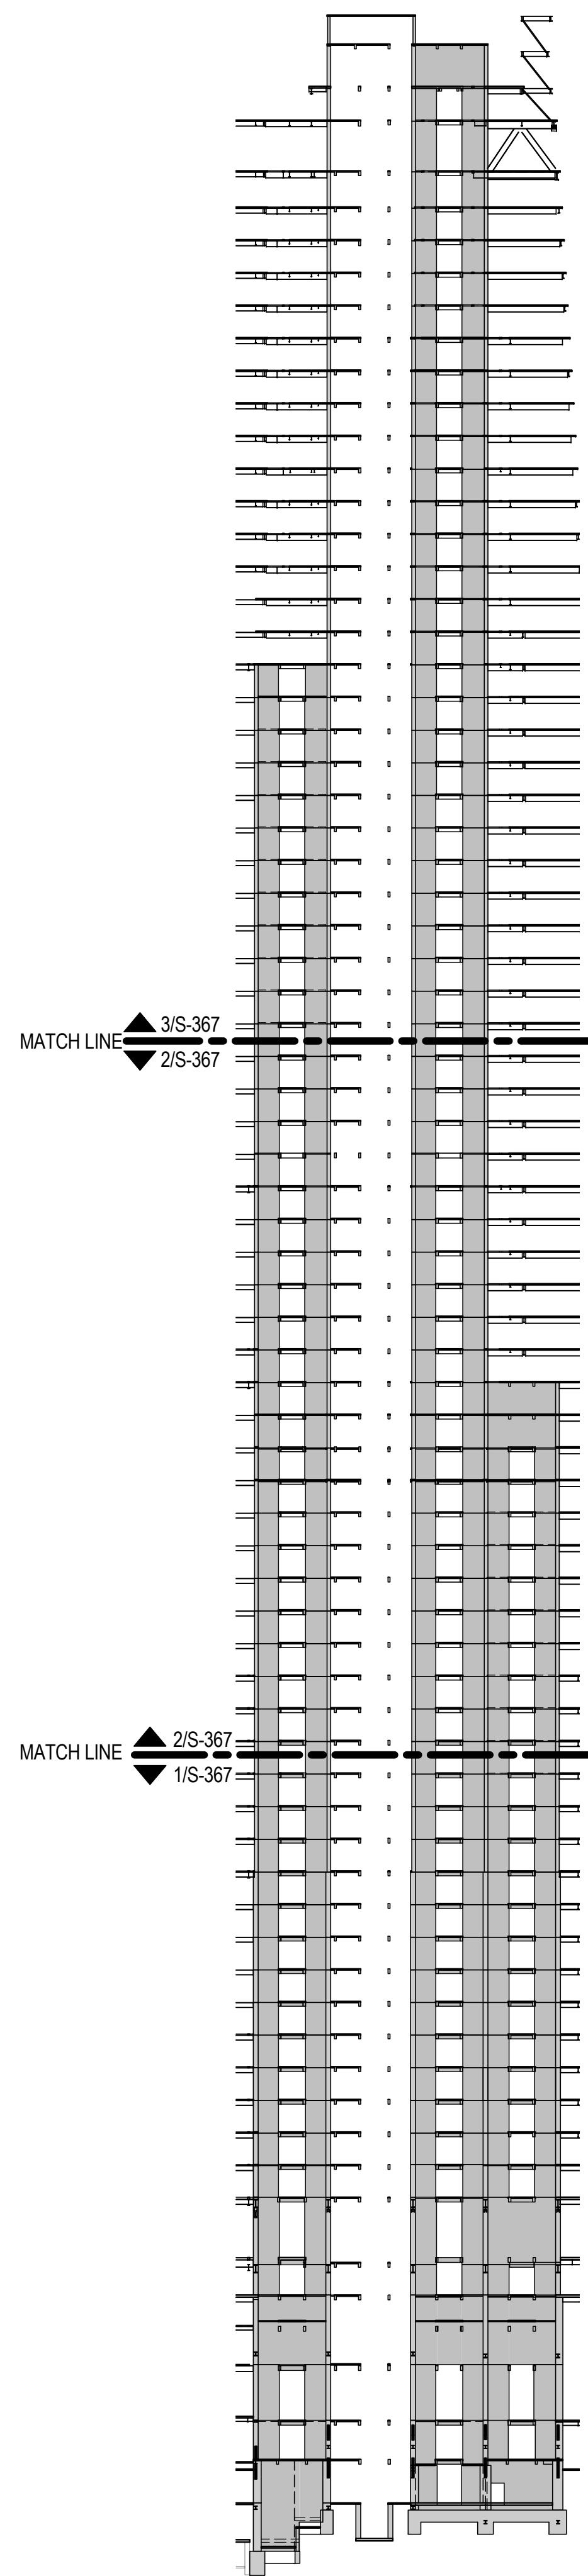
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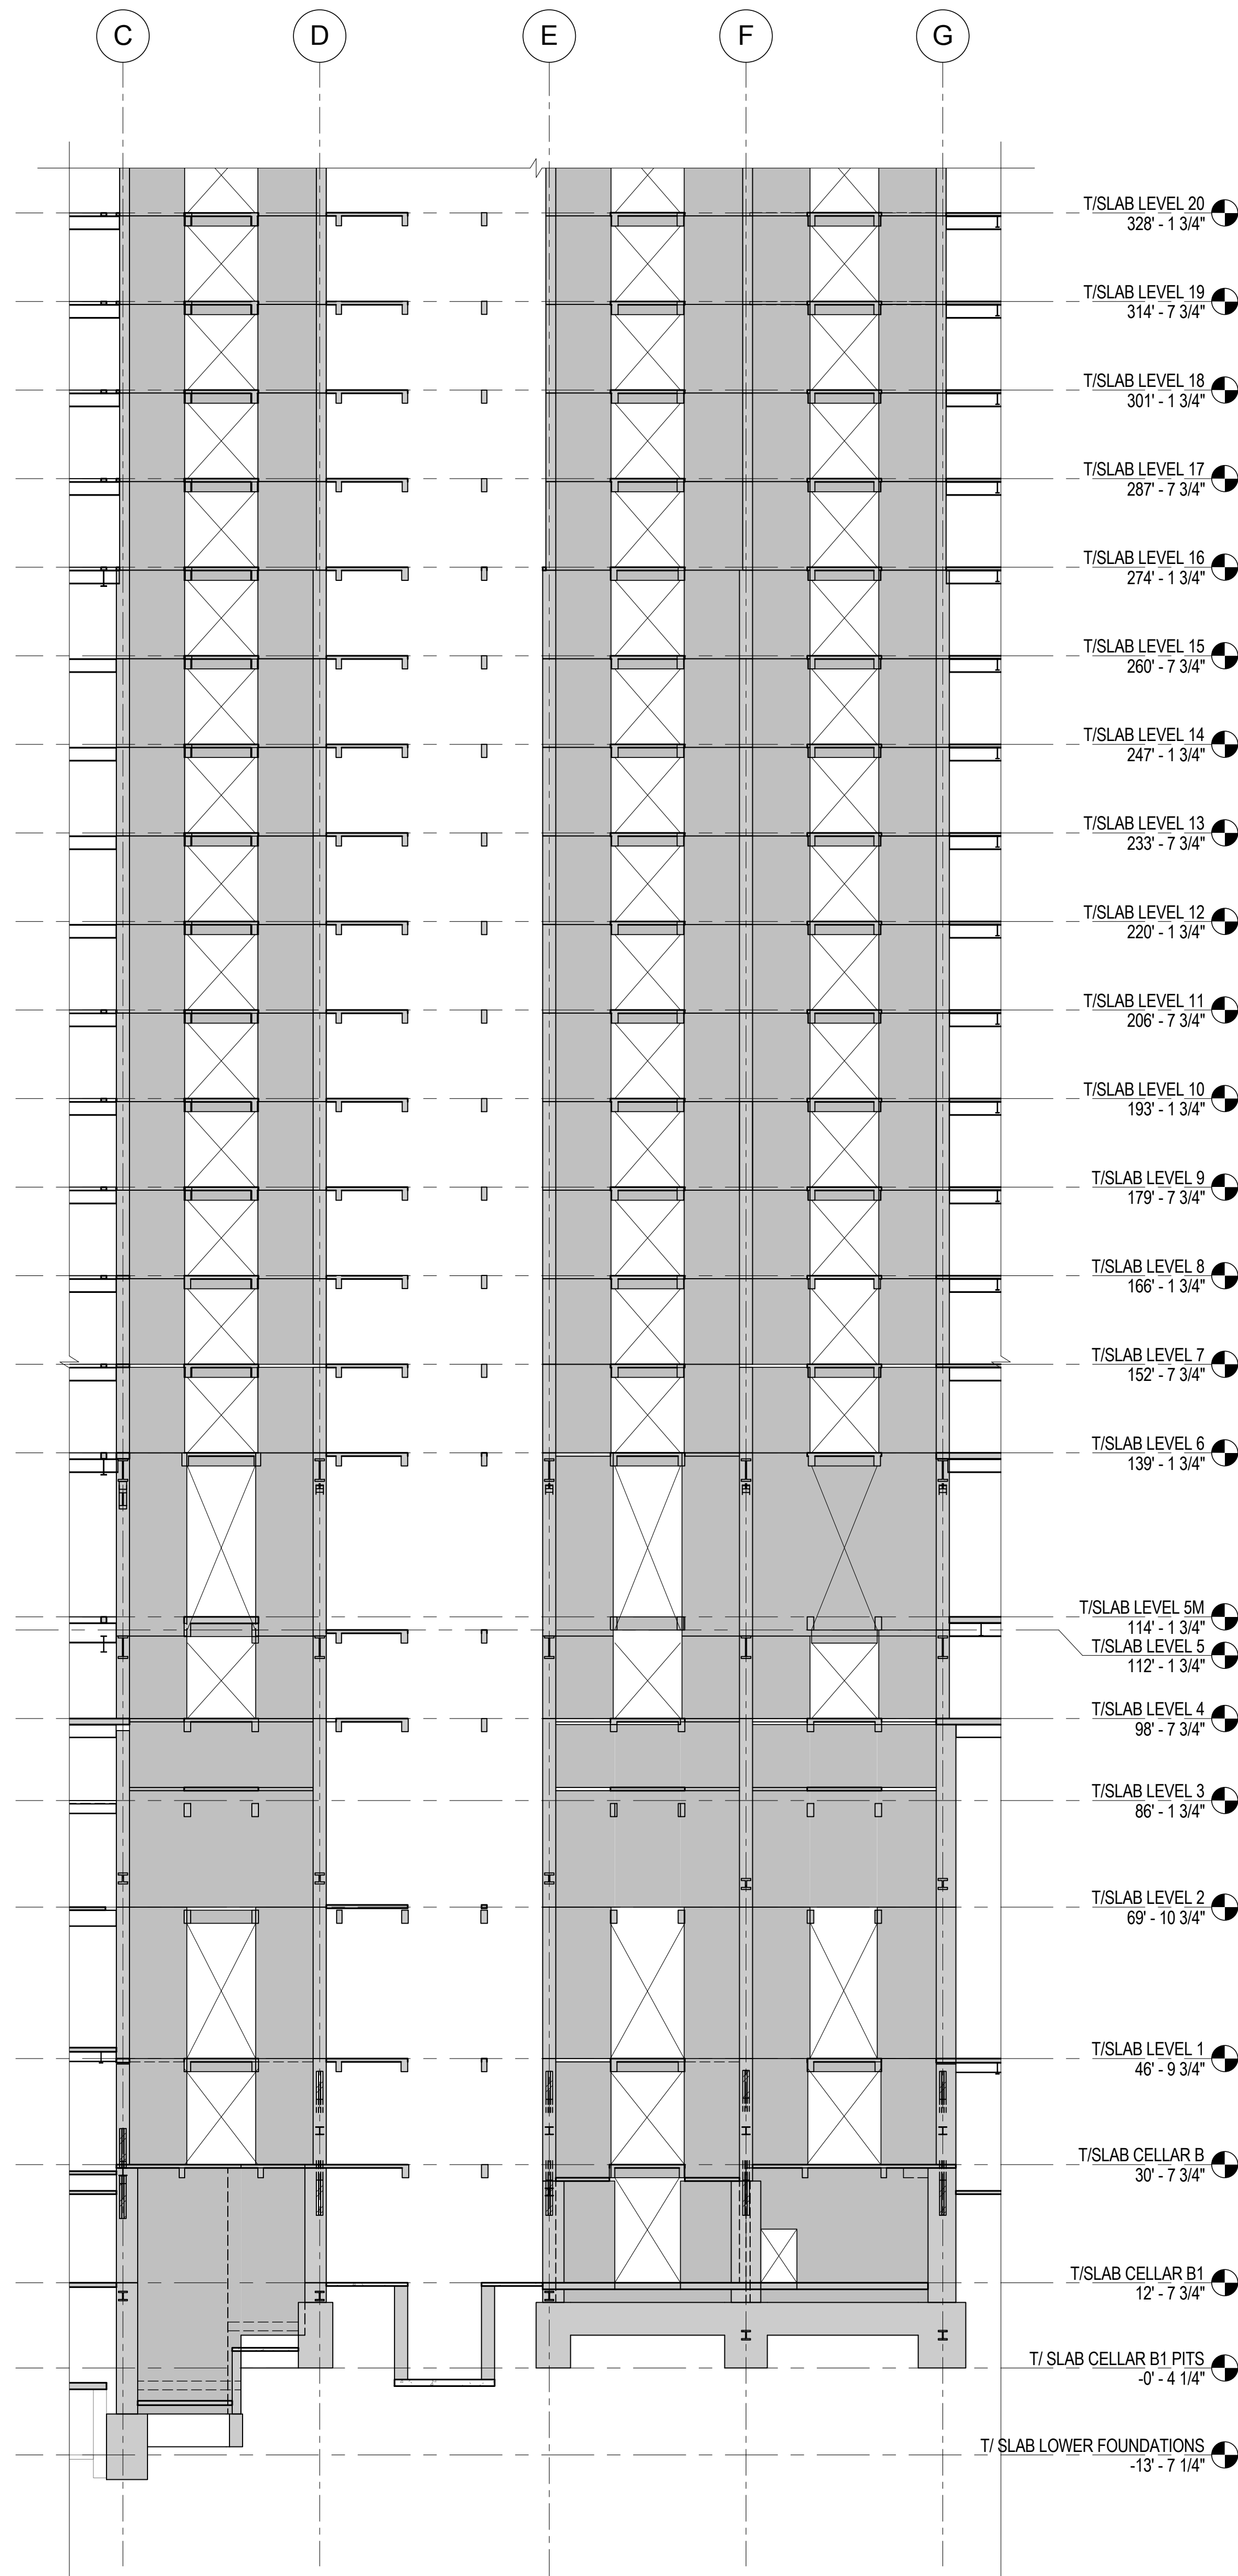
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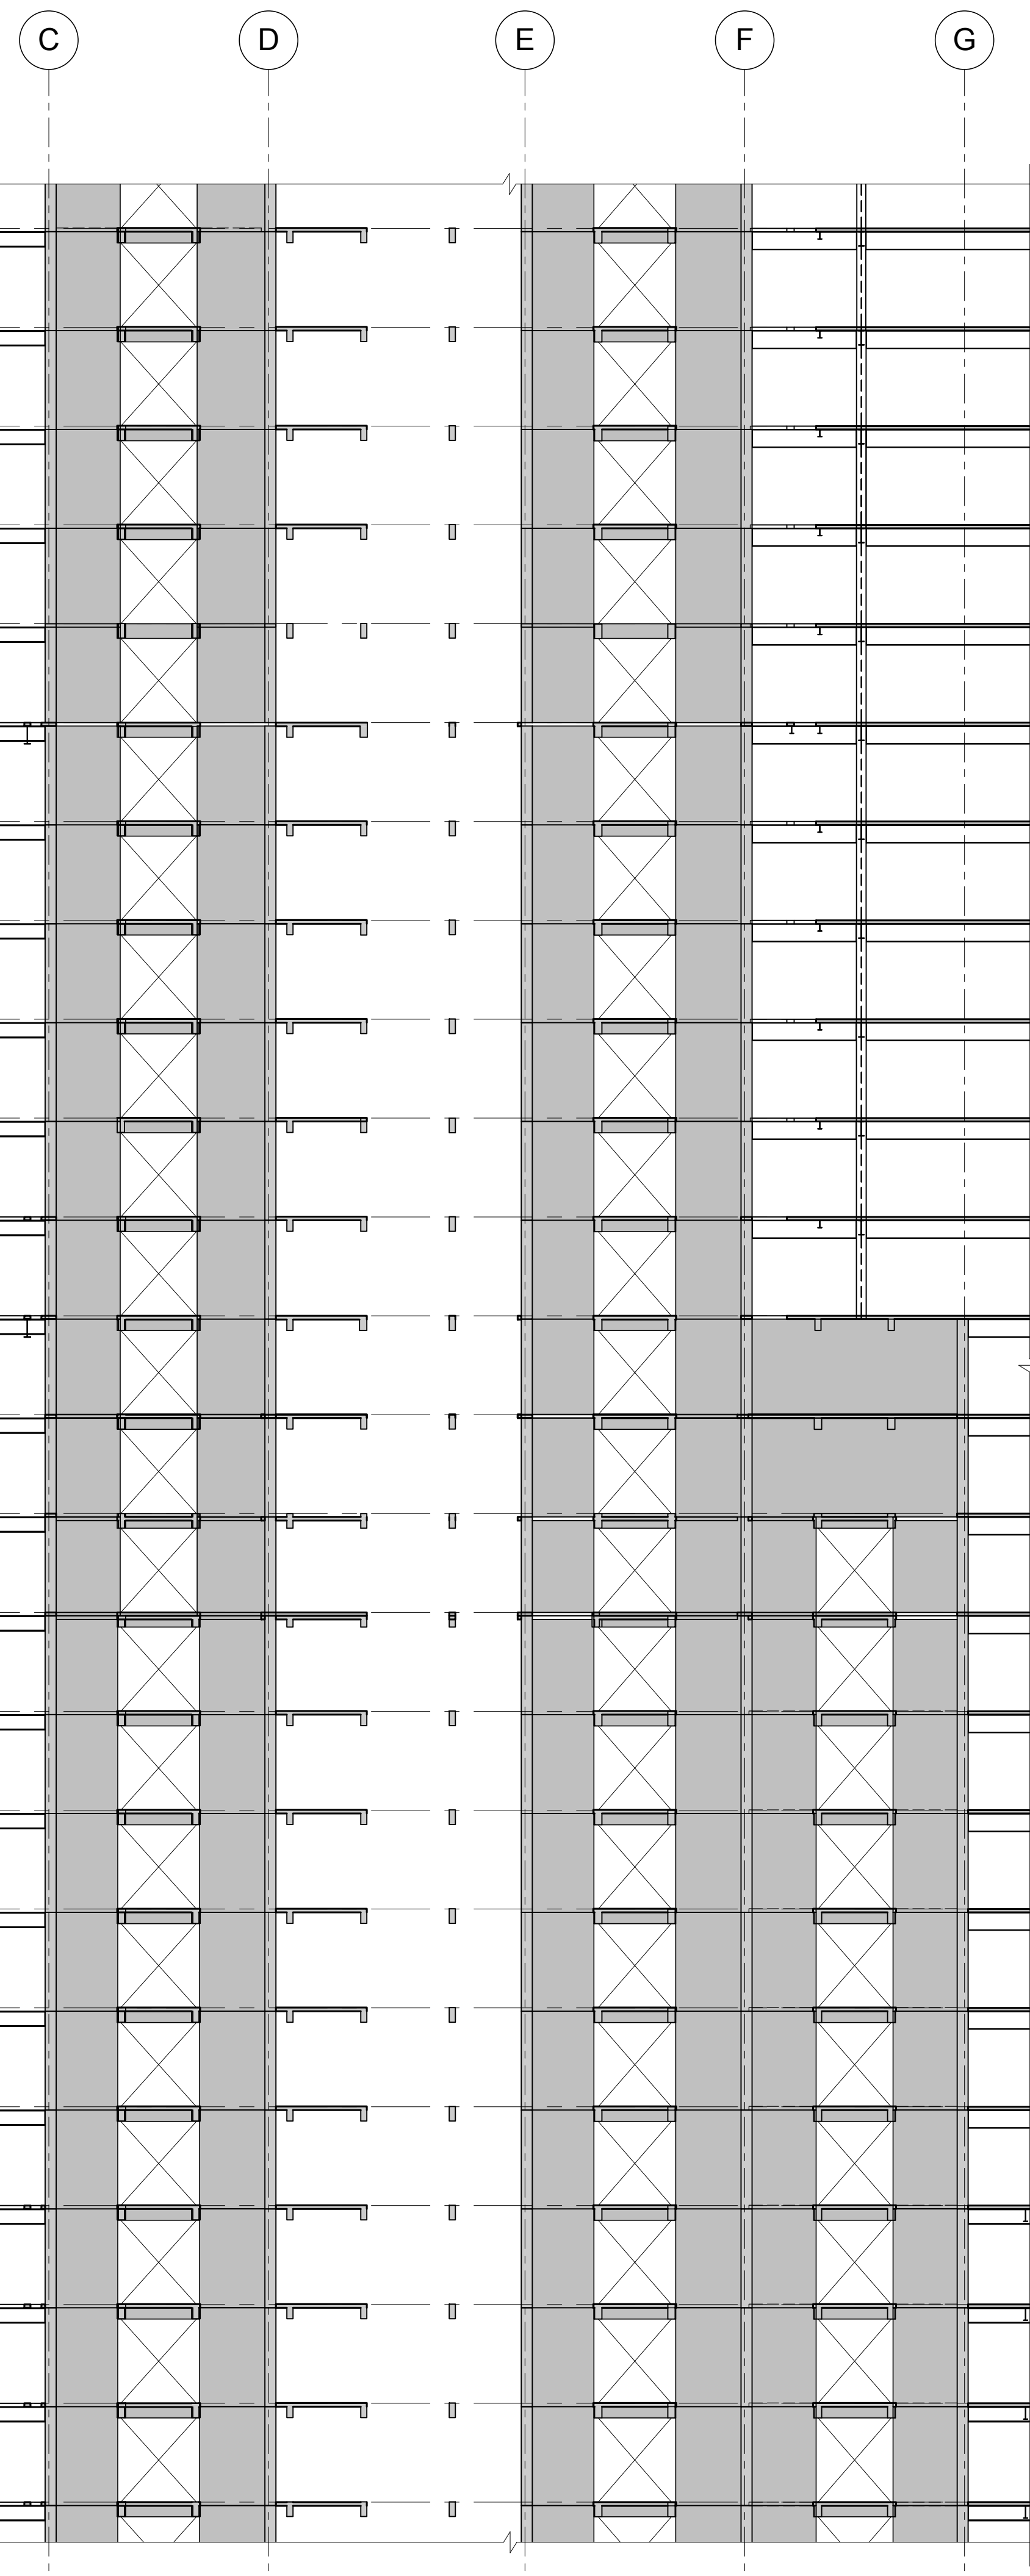
CORE WALL ELEVATION KEY PLAN
NTS




ELEVATION KEY
NTS

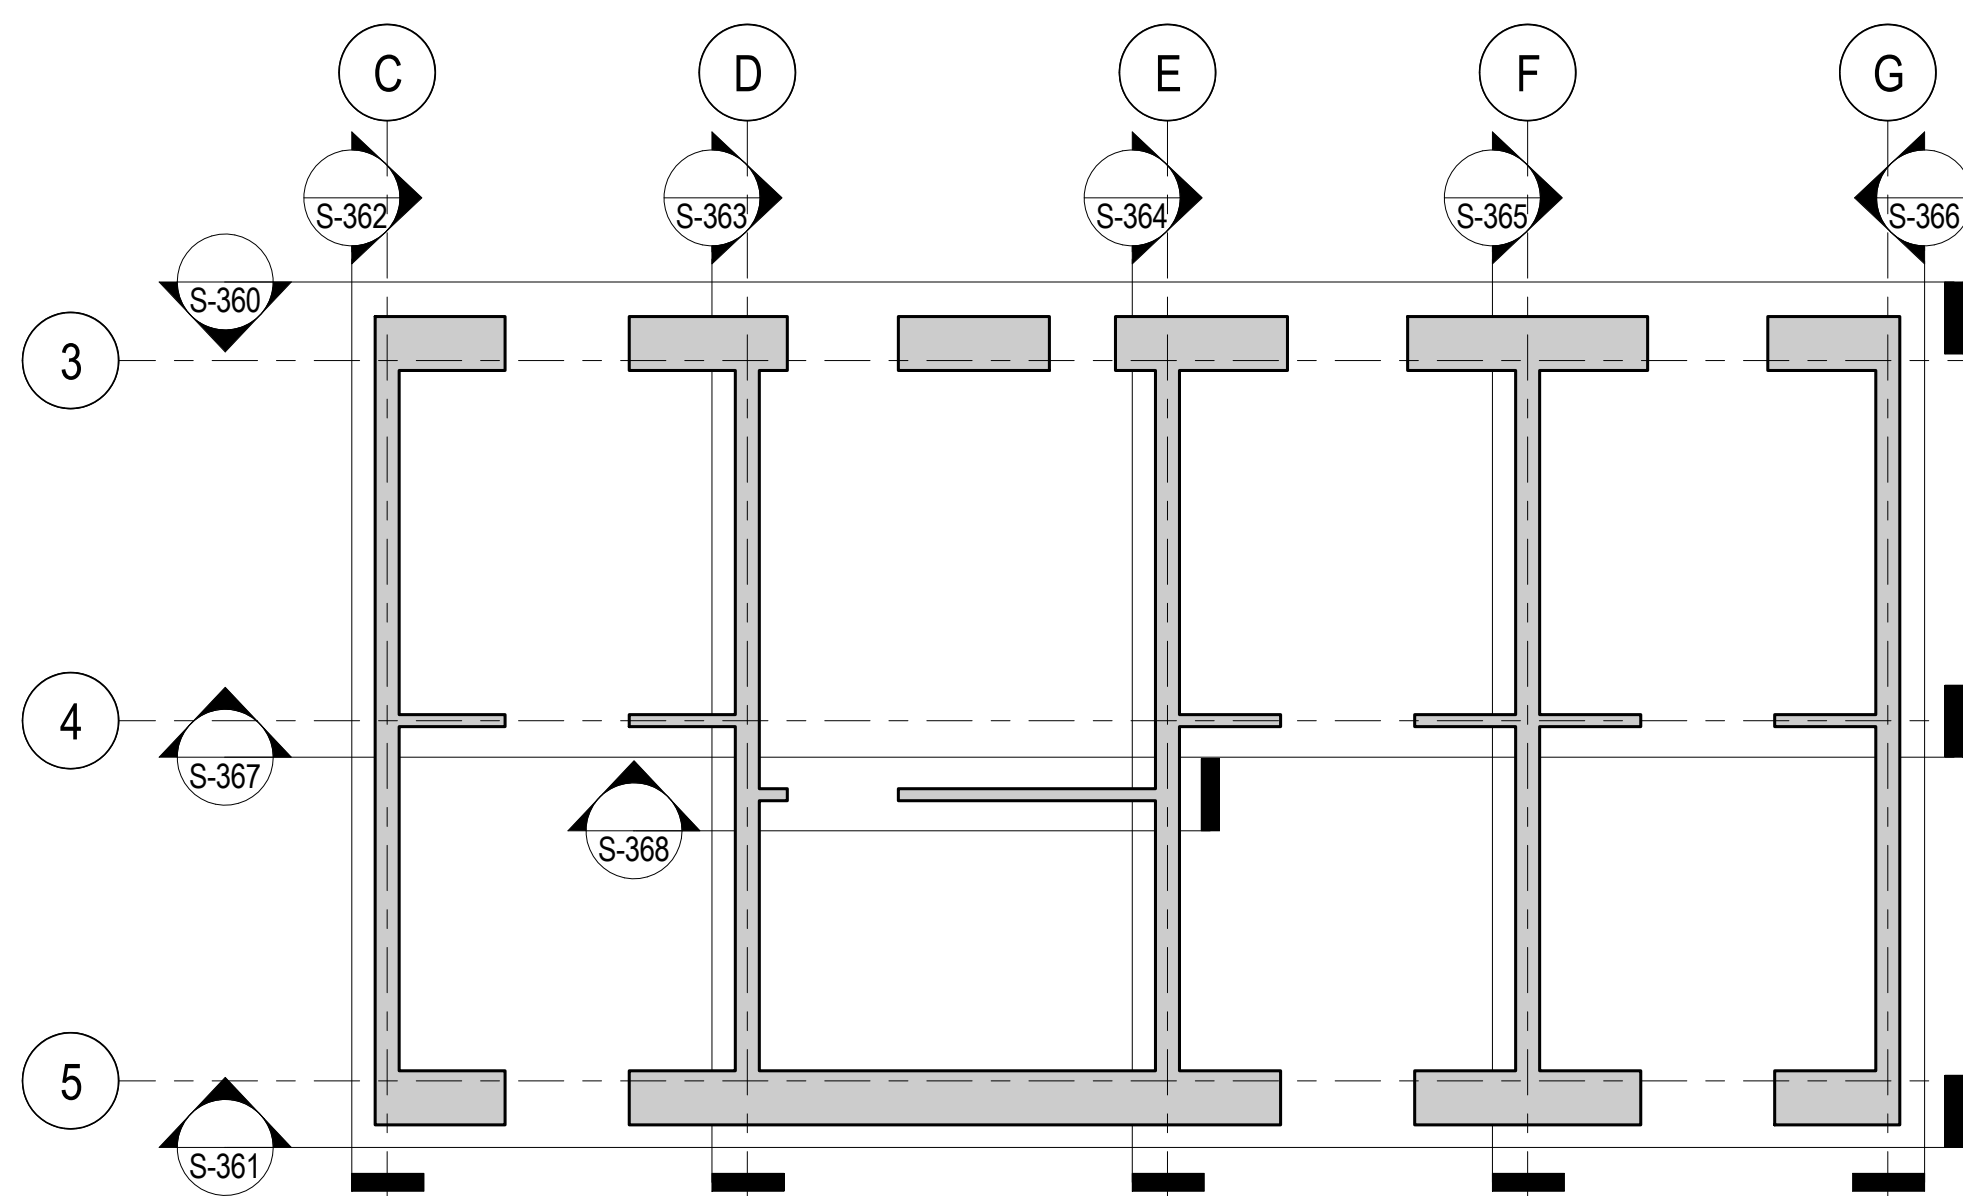

1 ELEVATION ALONG LINE 4
1/16" = 1'-0"



2 ELEVATION ALONG LINE 4
1/16" = 1'-0"

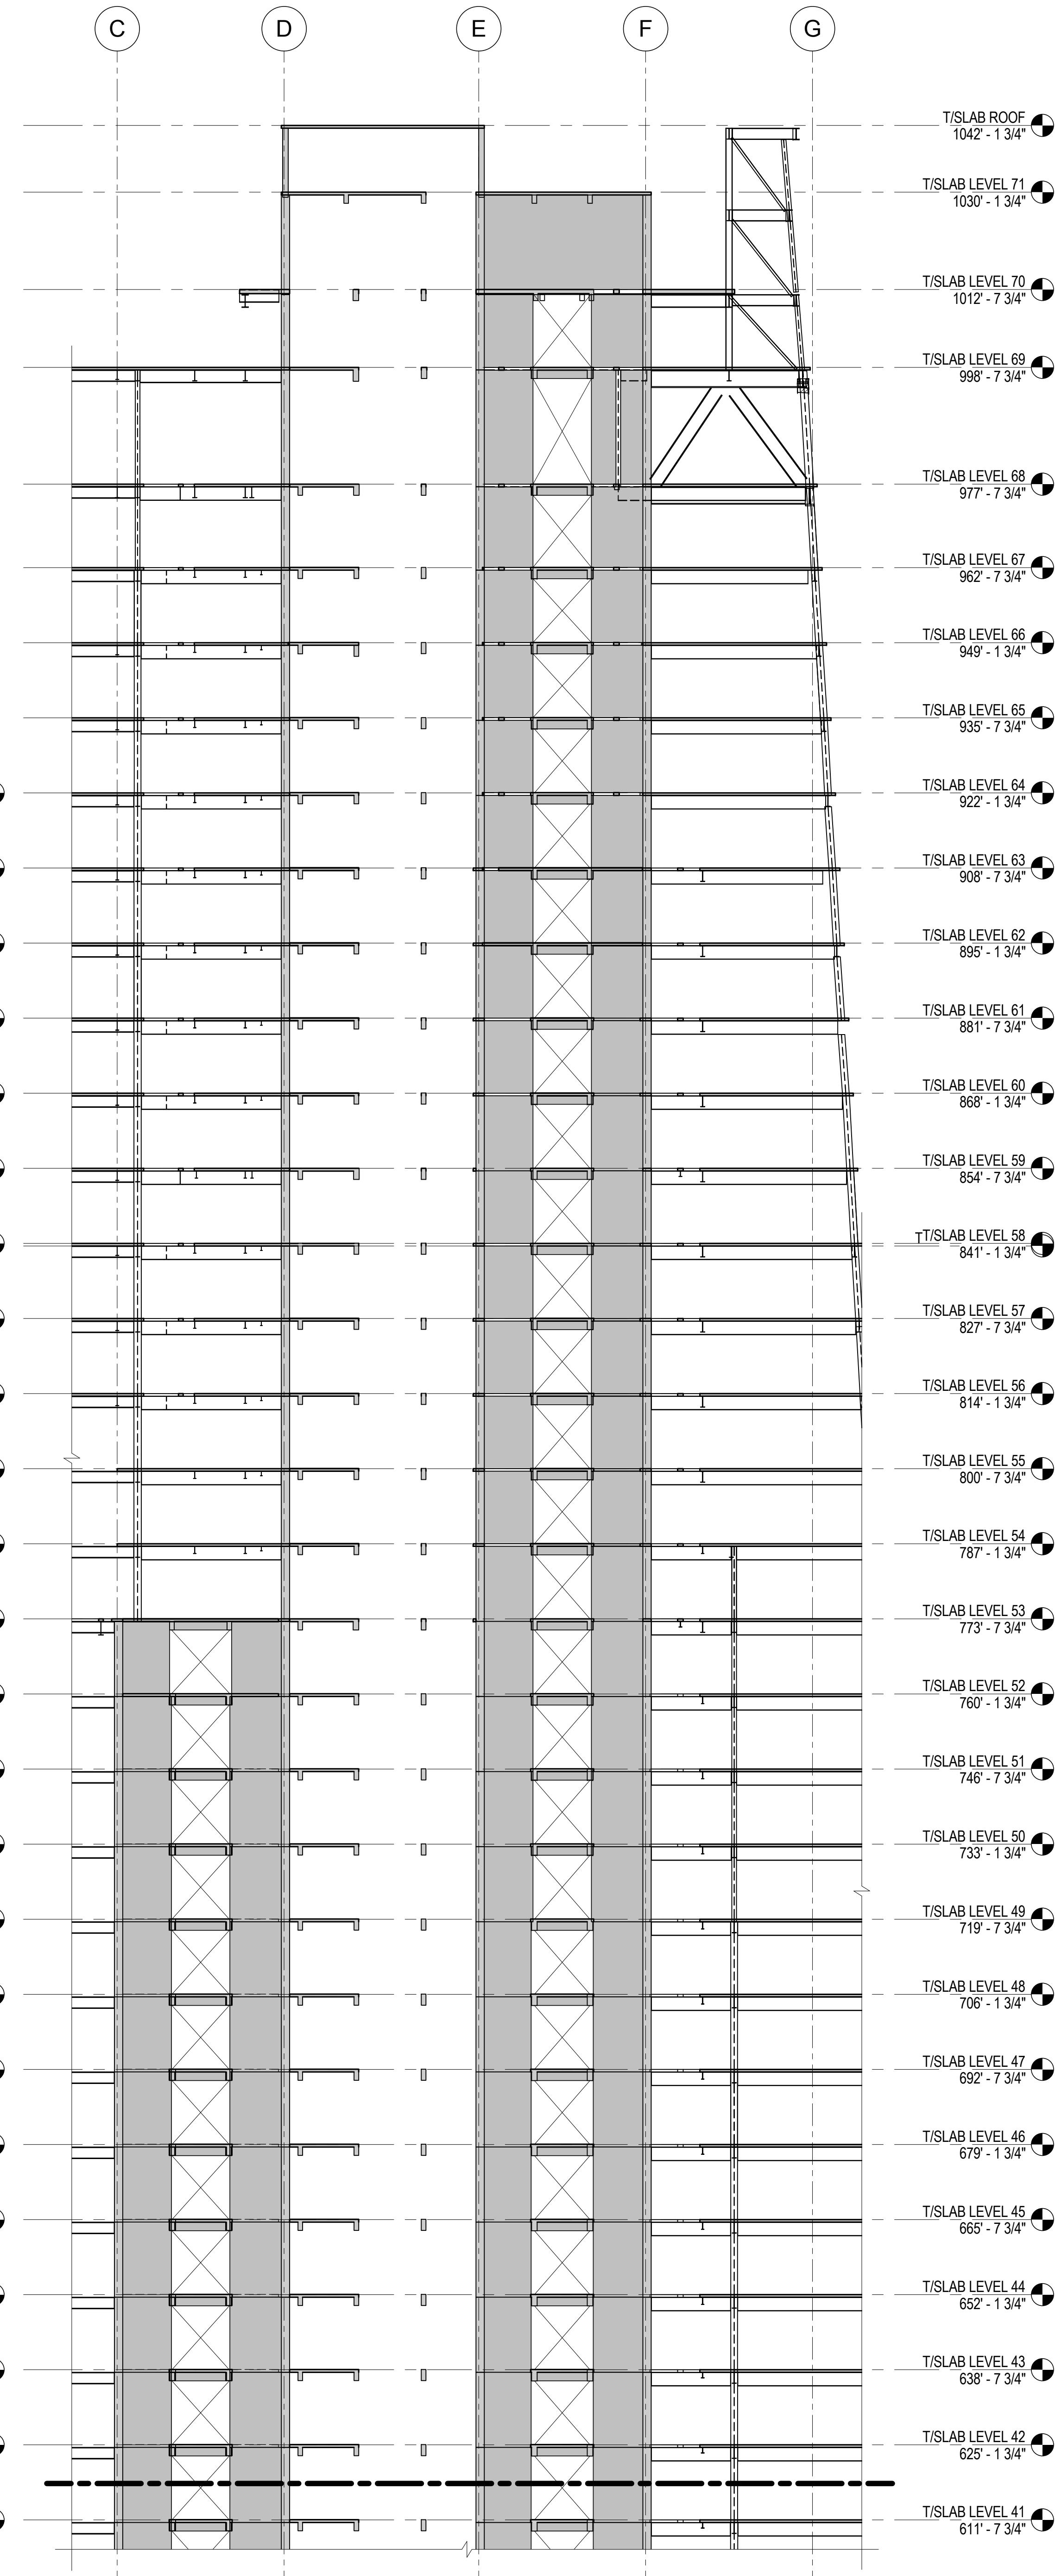

3 ELEVATION ALONG LINE 4
1/16" = 1'-0"

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Ontario, Canada N1K 1B8

Key Plan:

Seal & Signature:

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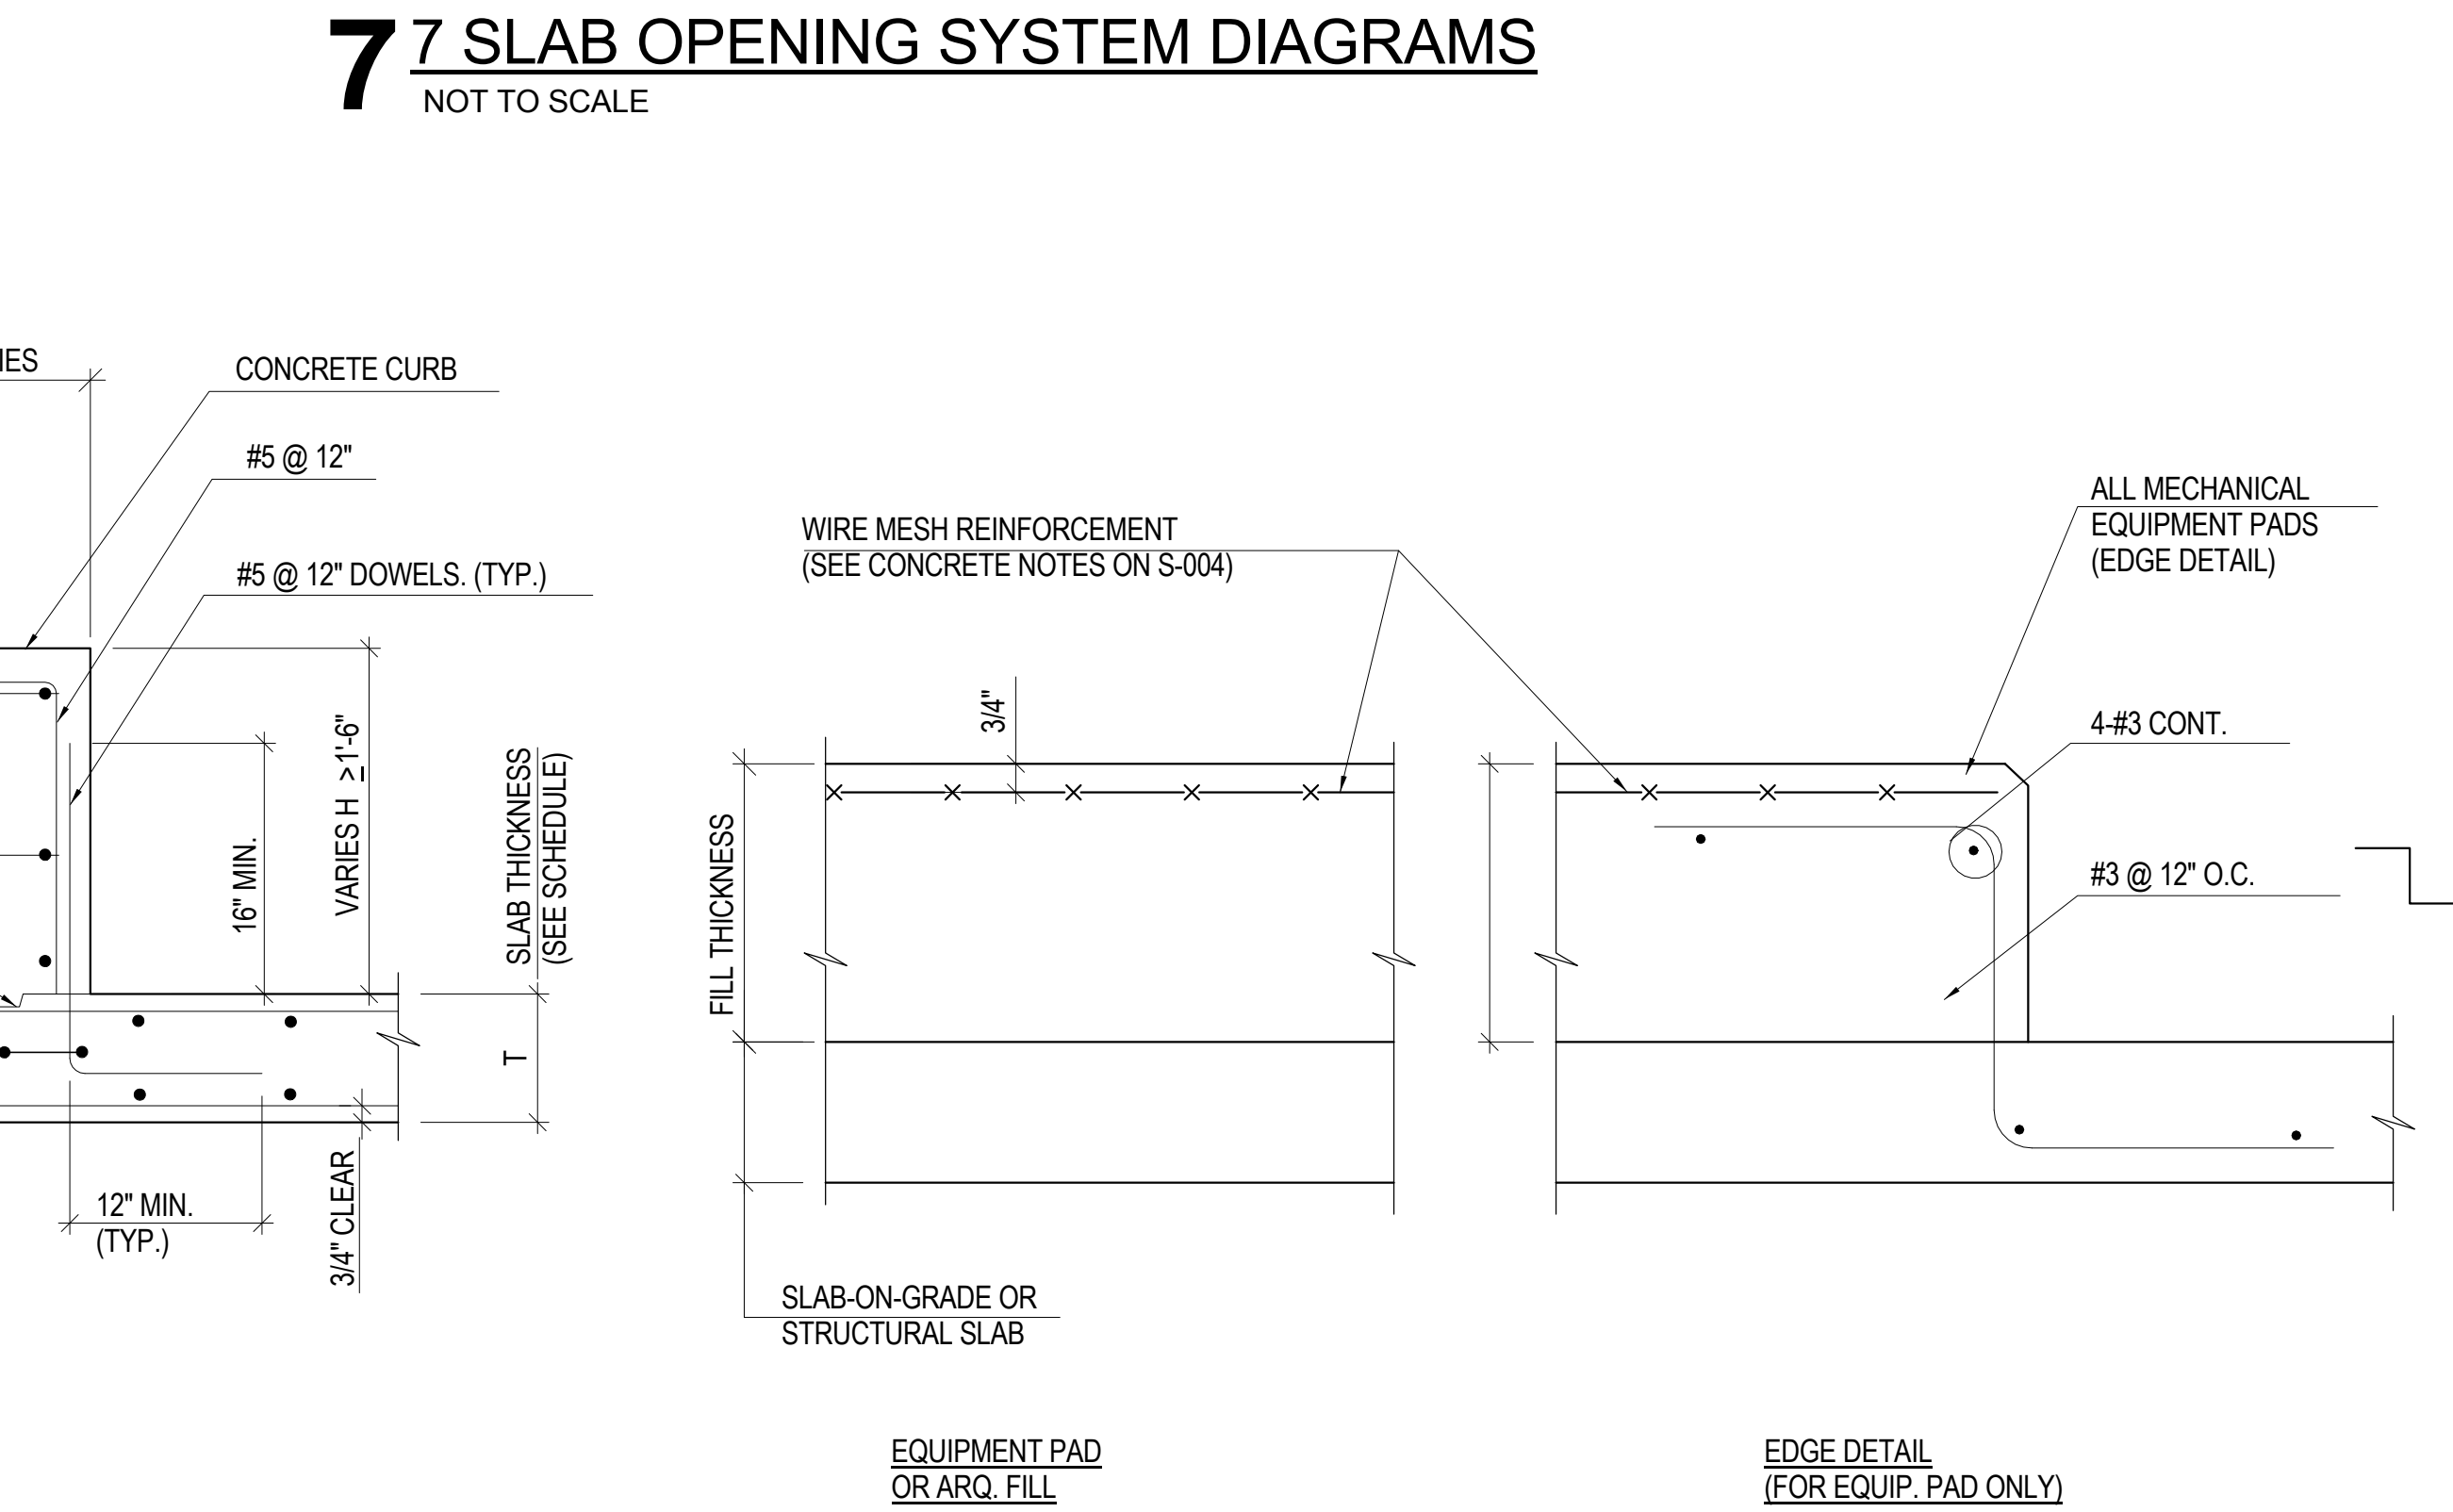
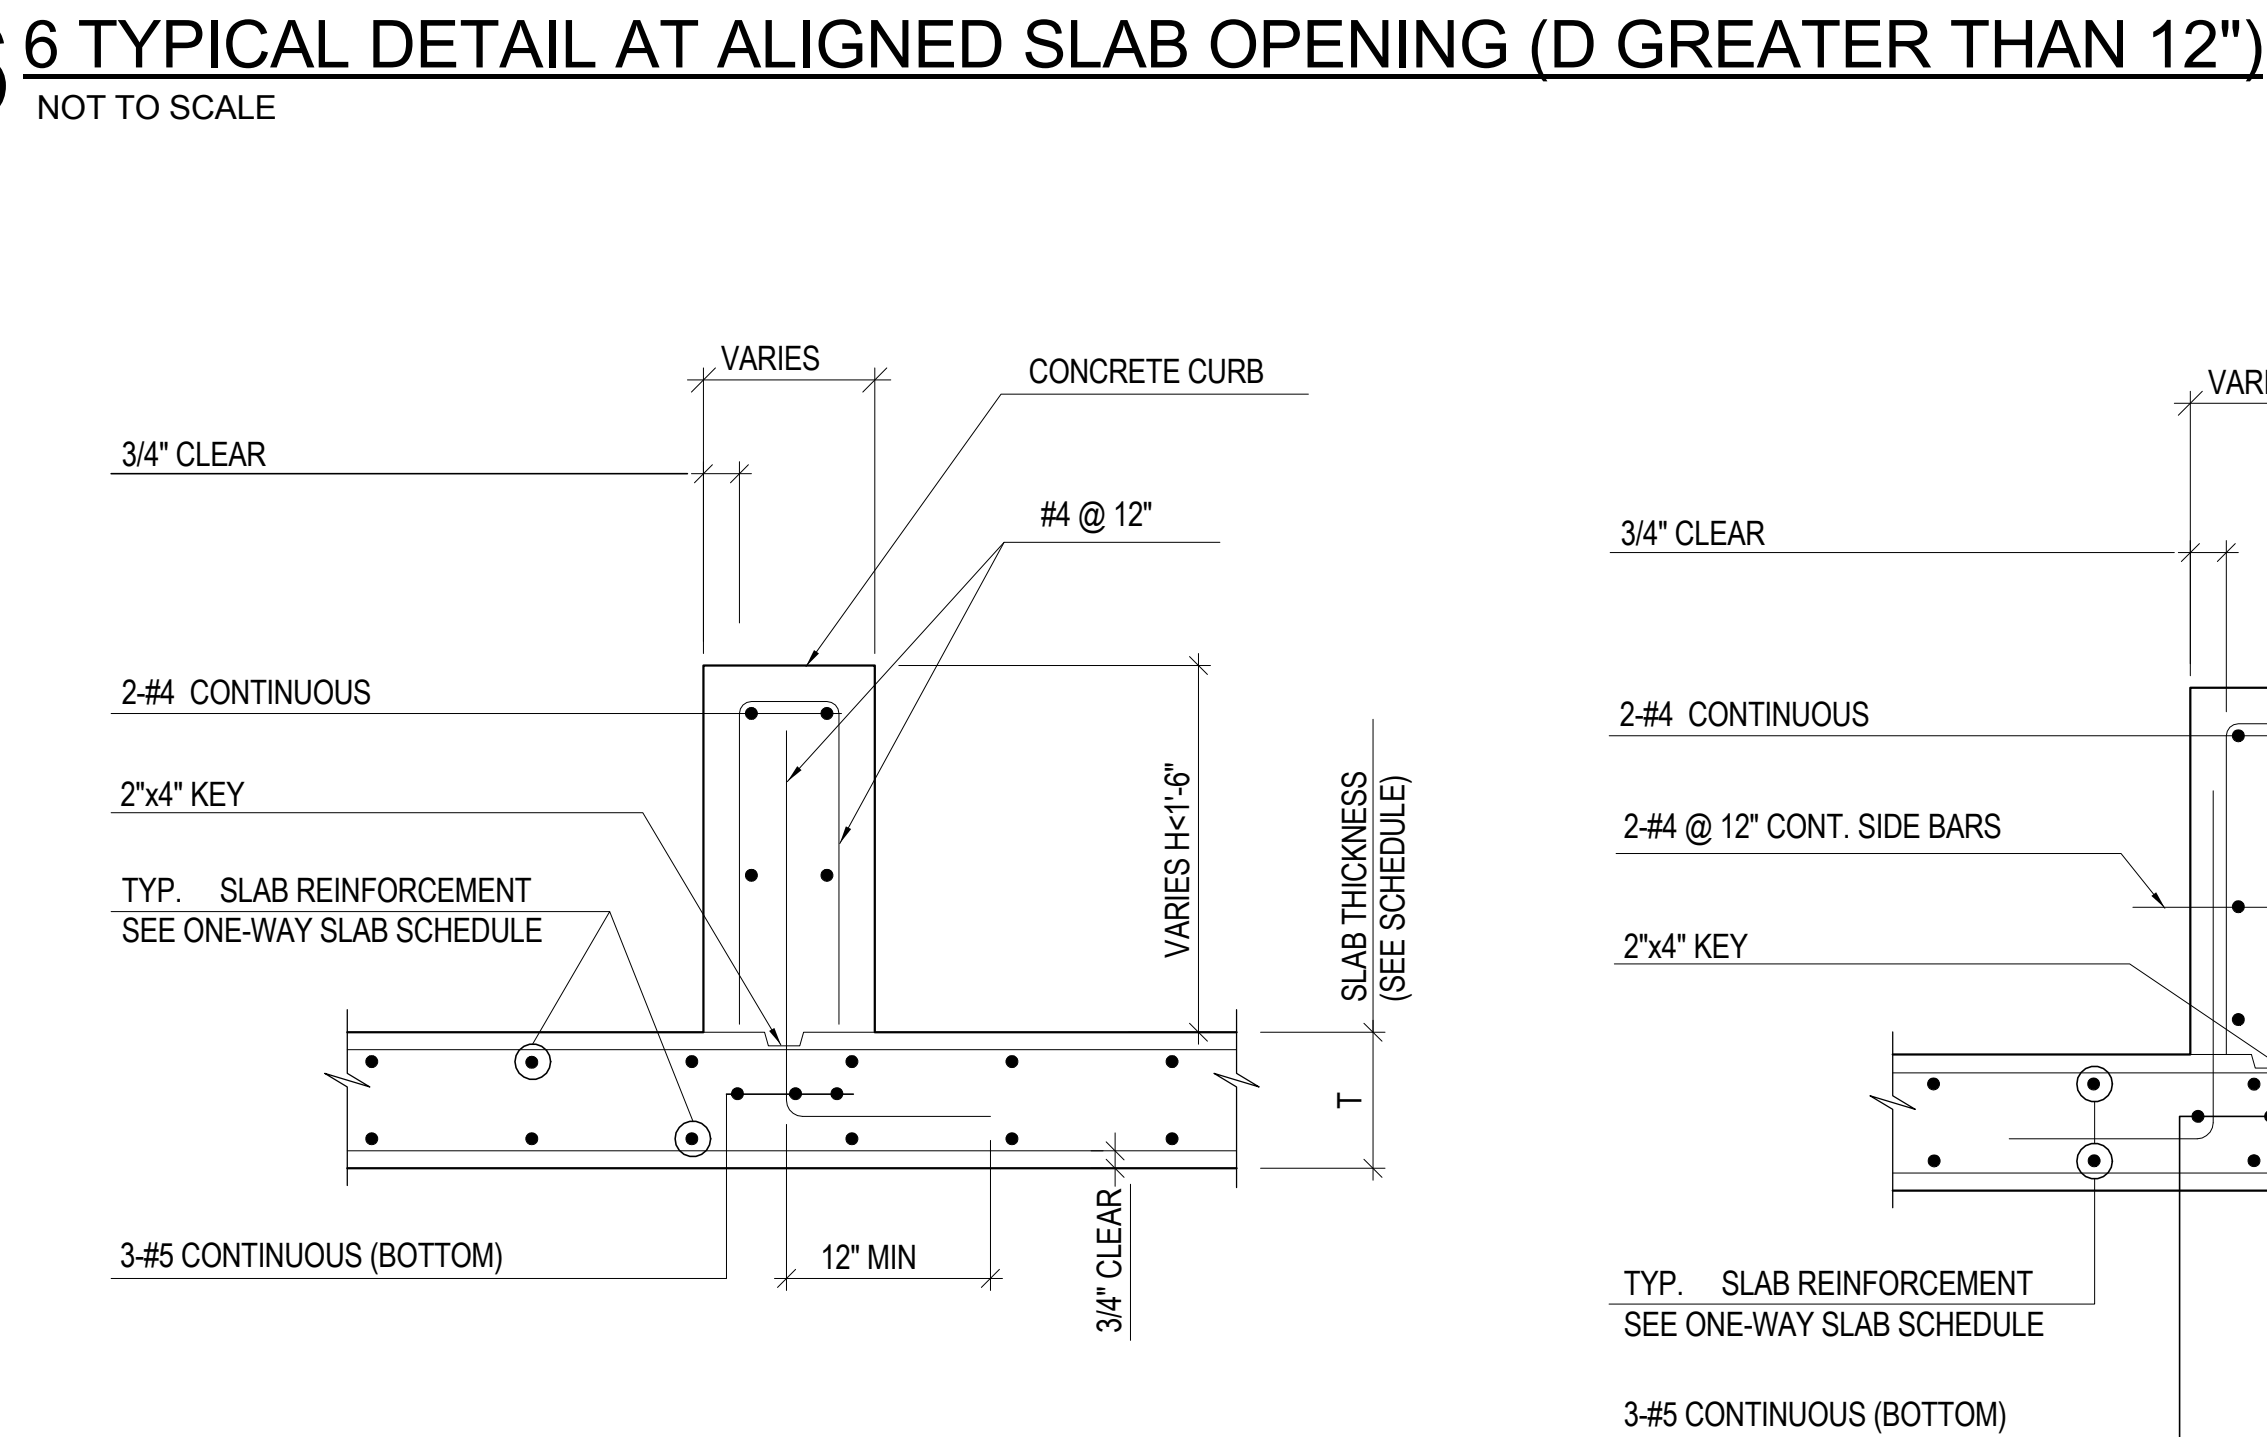
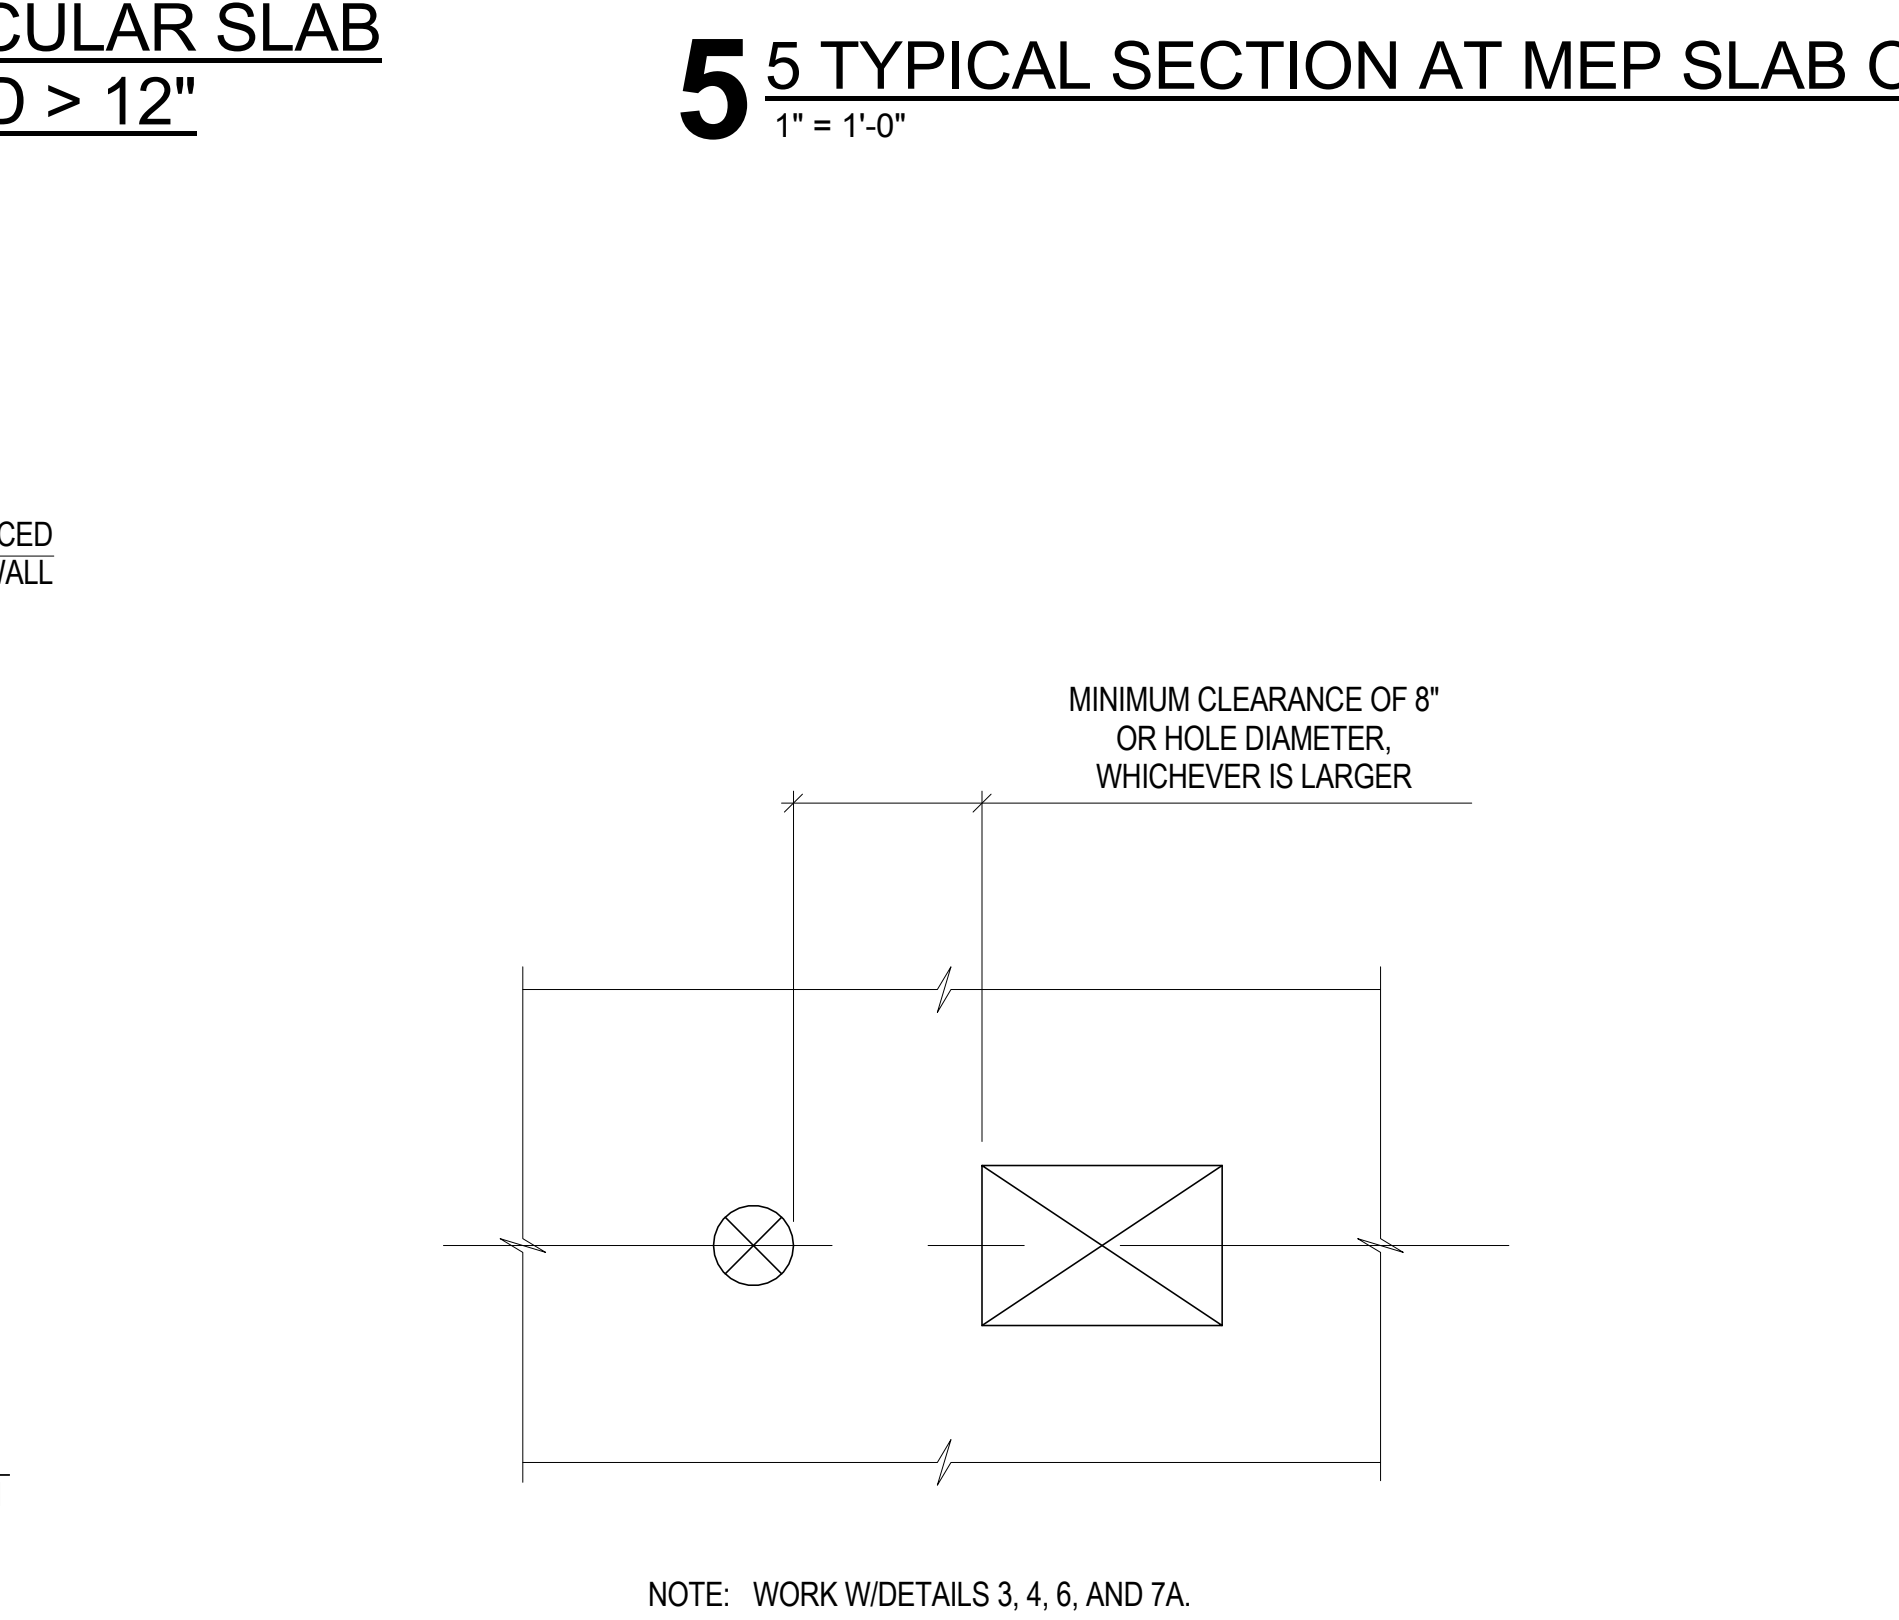
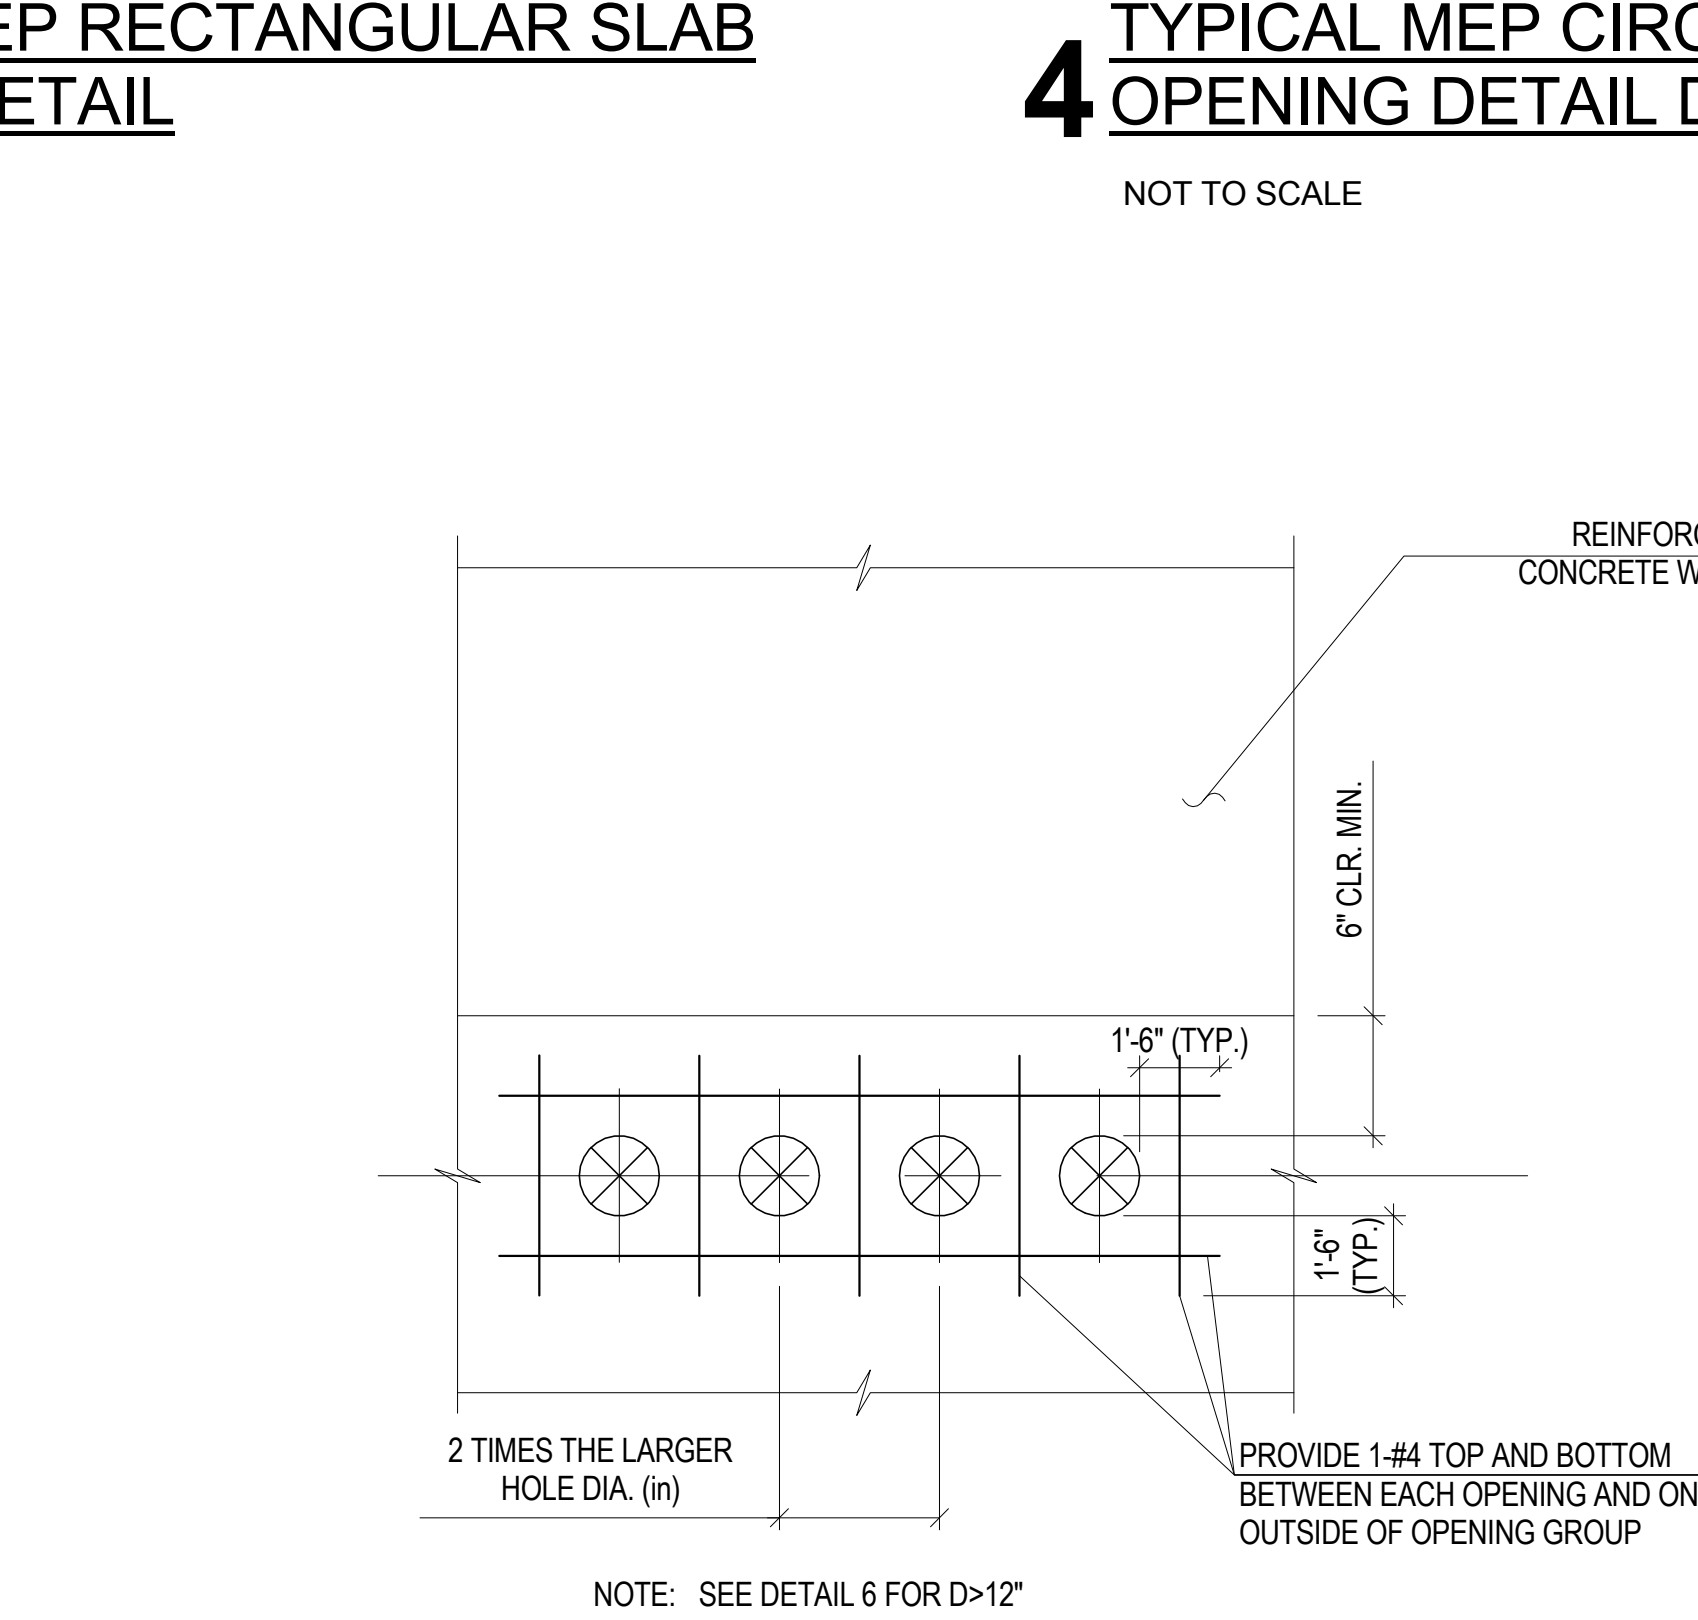
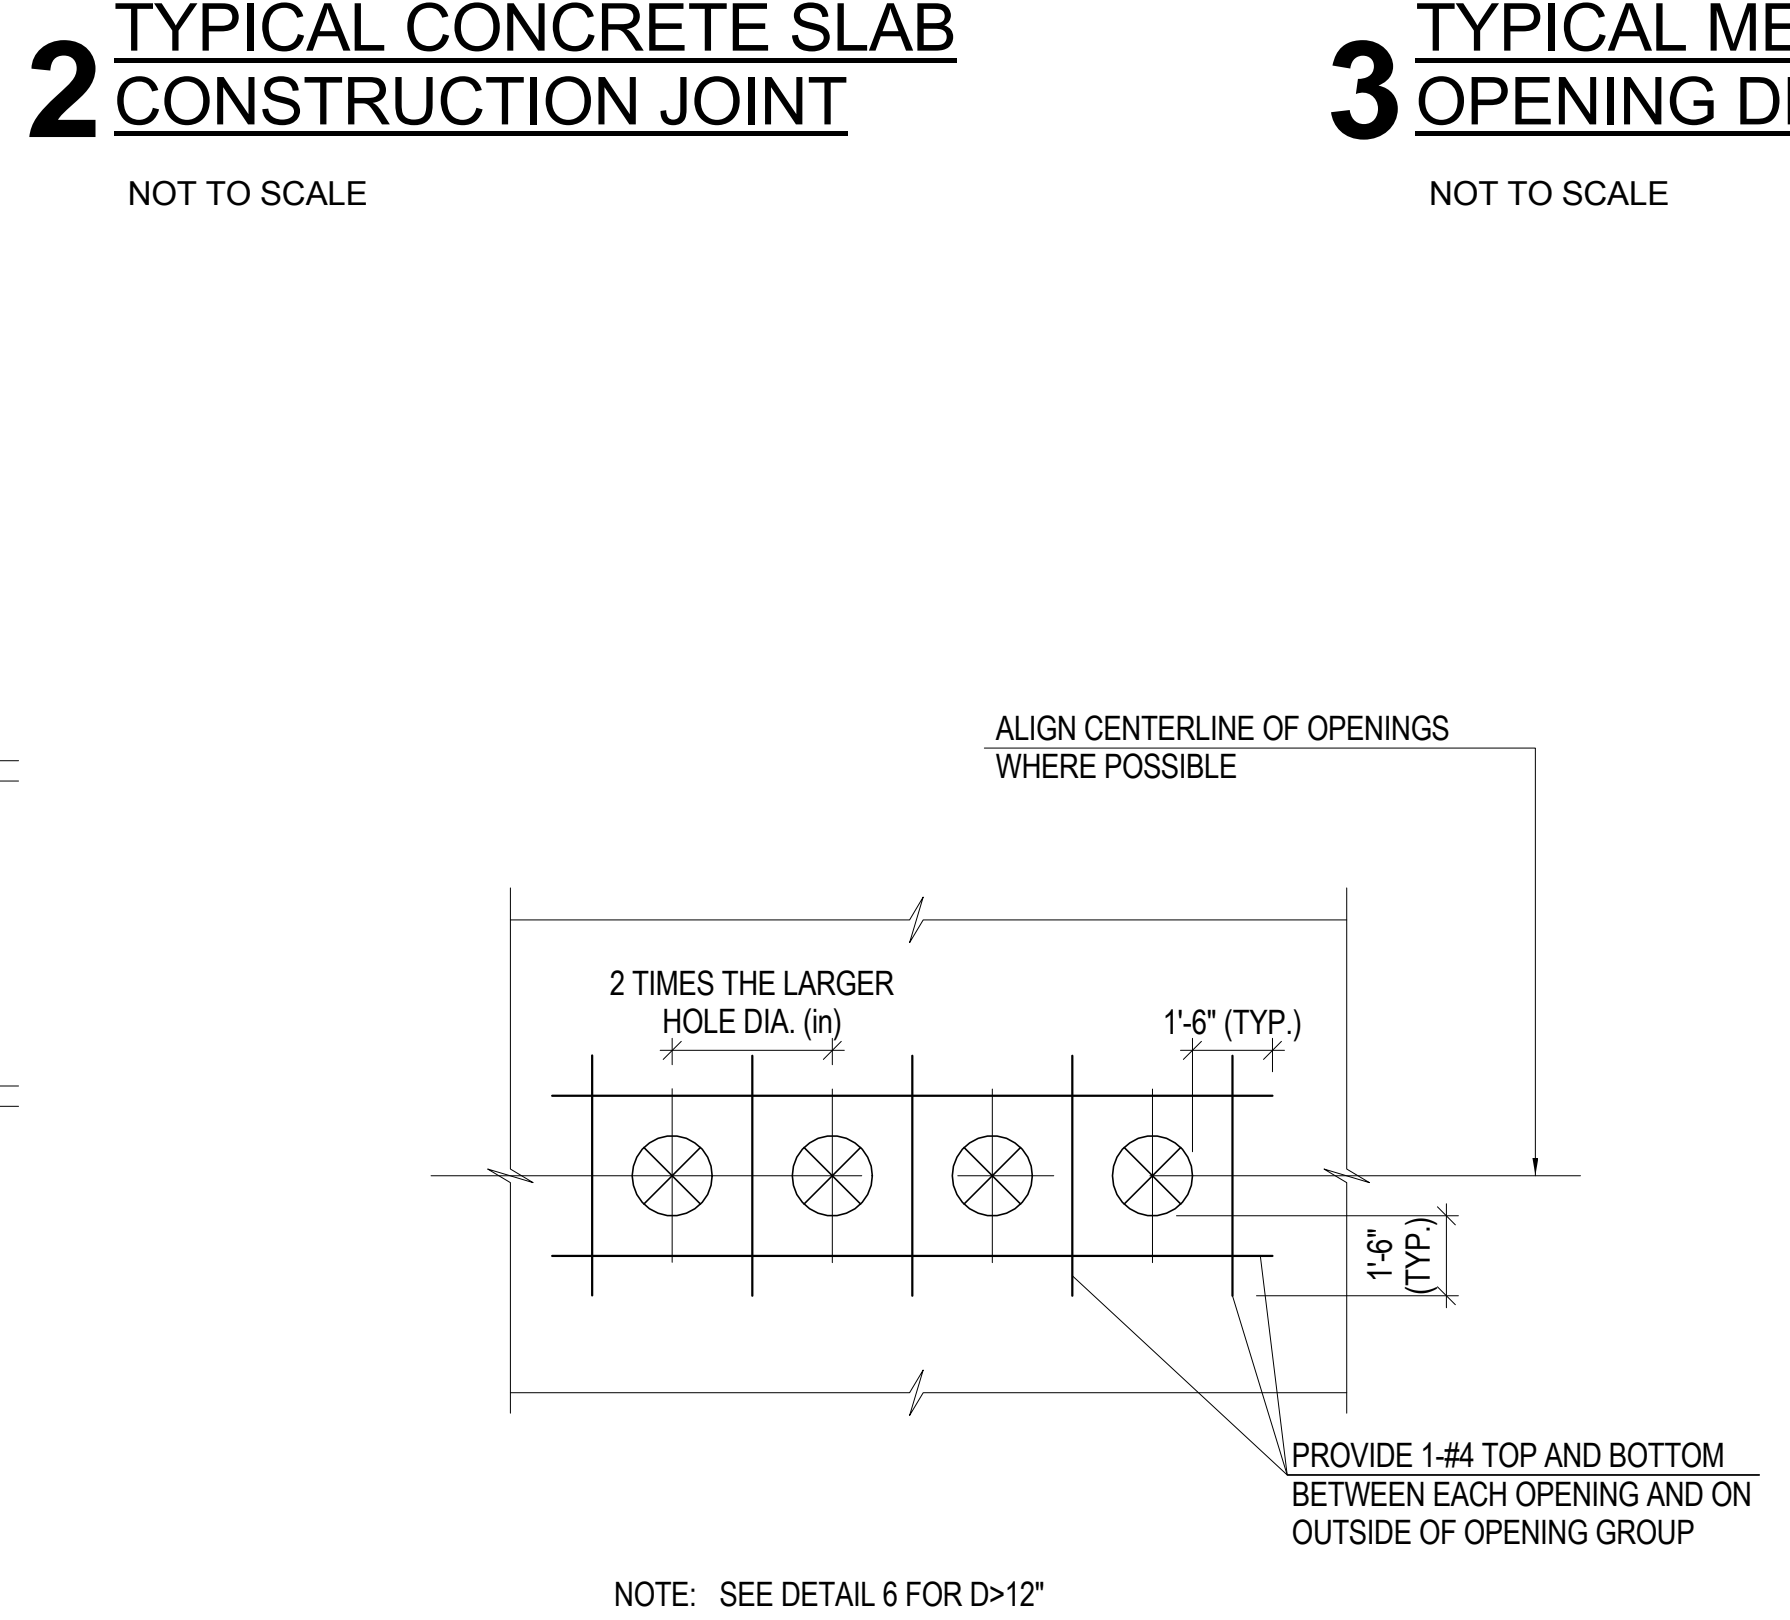
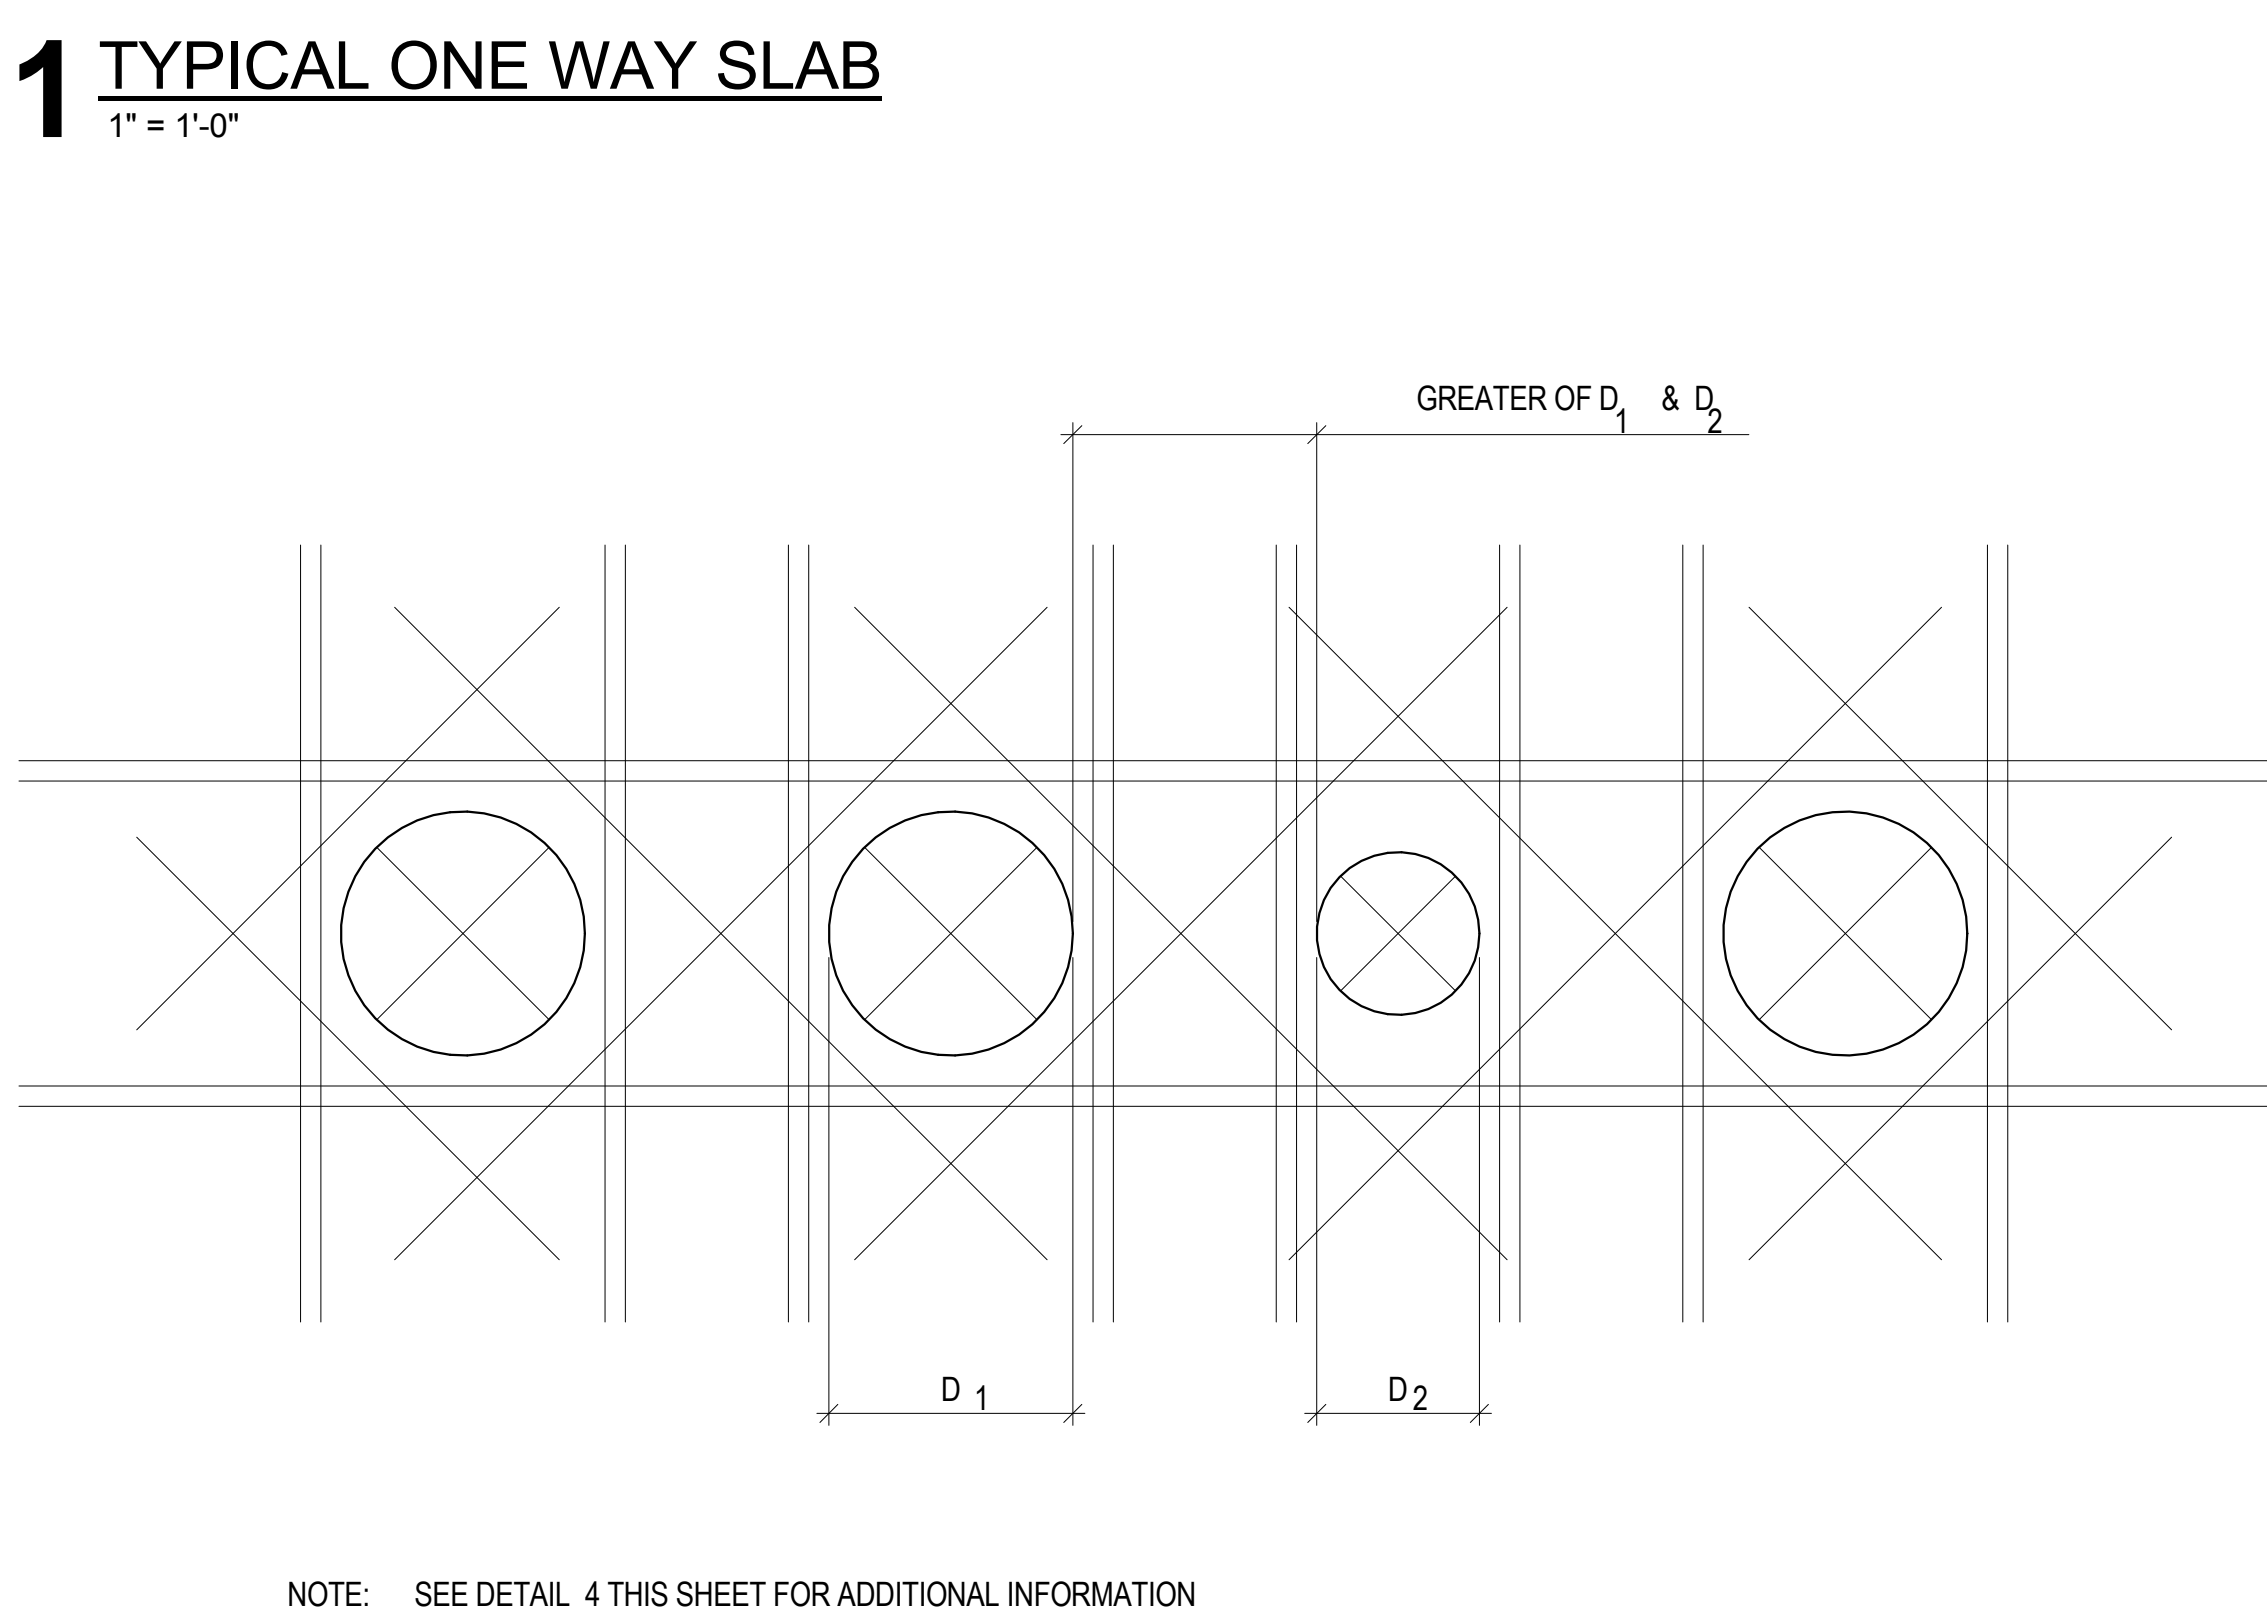
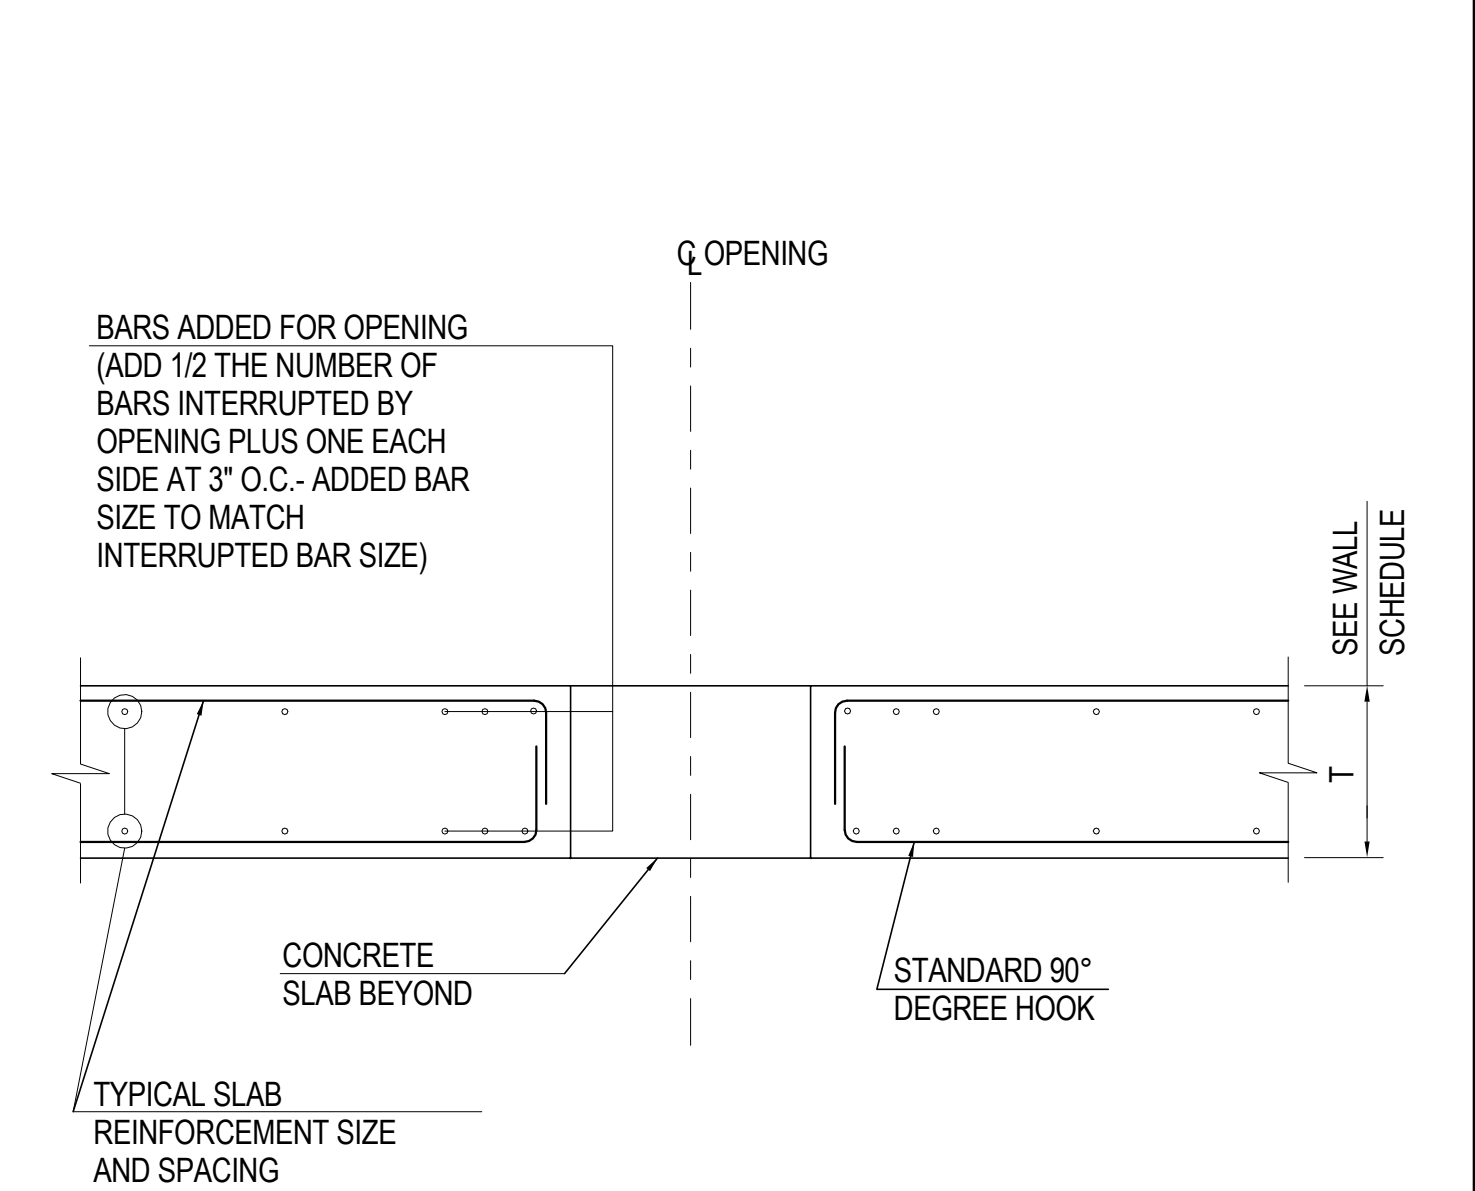
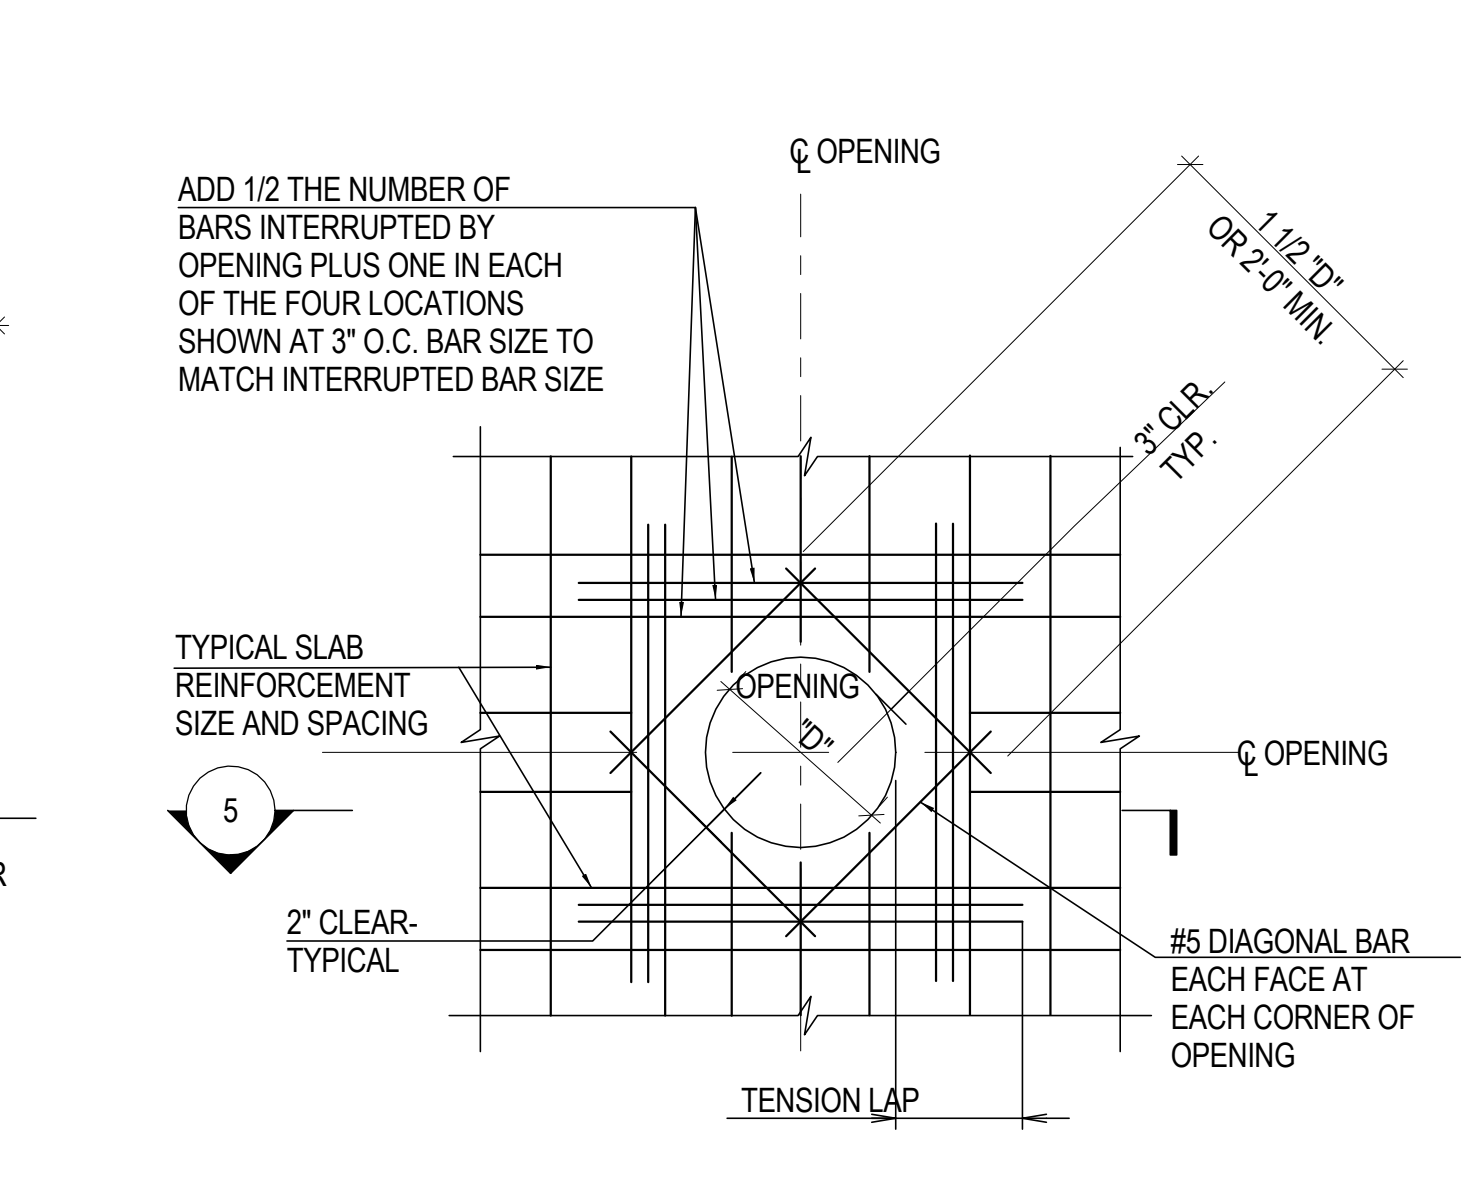
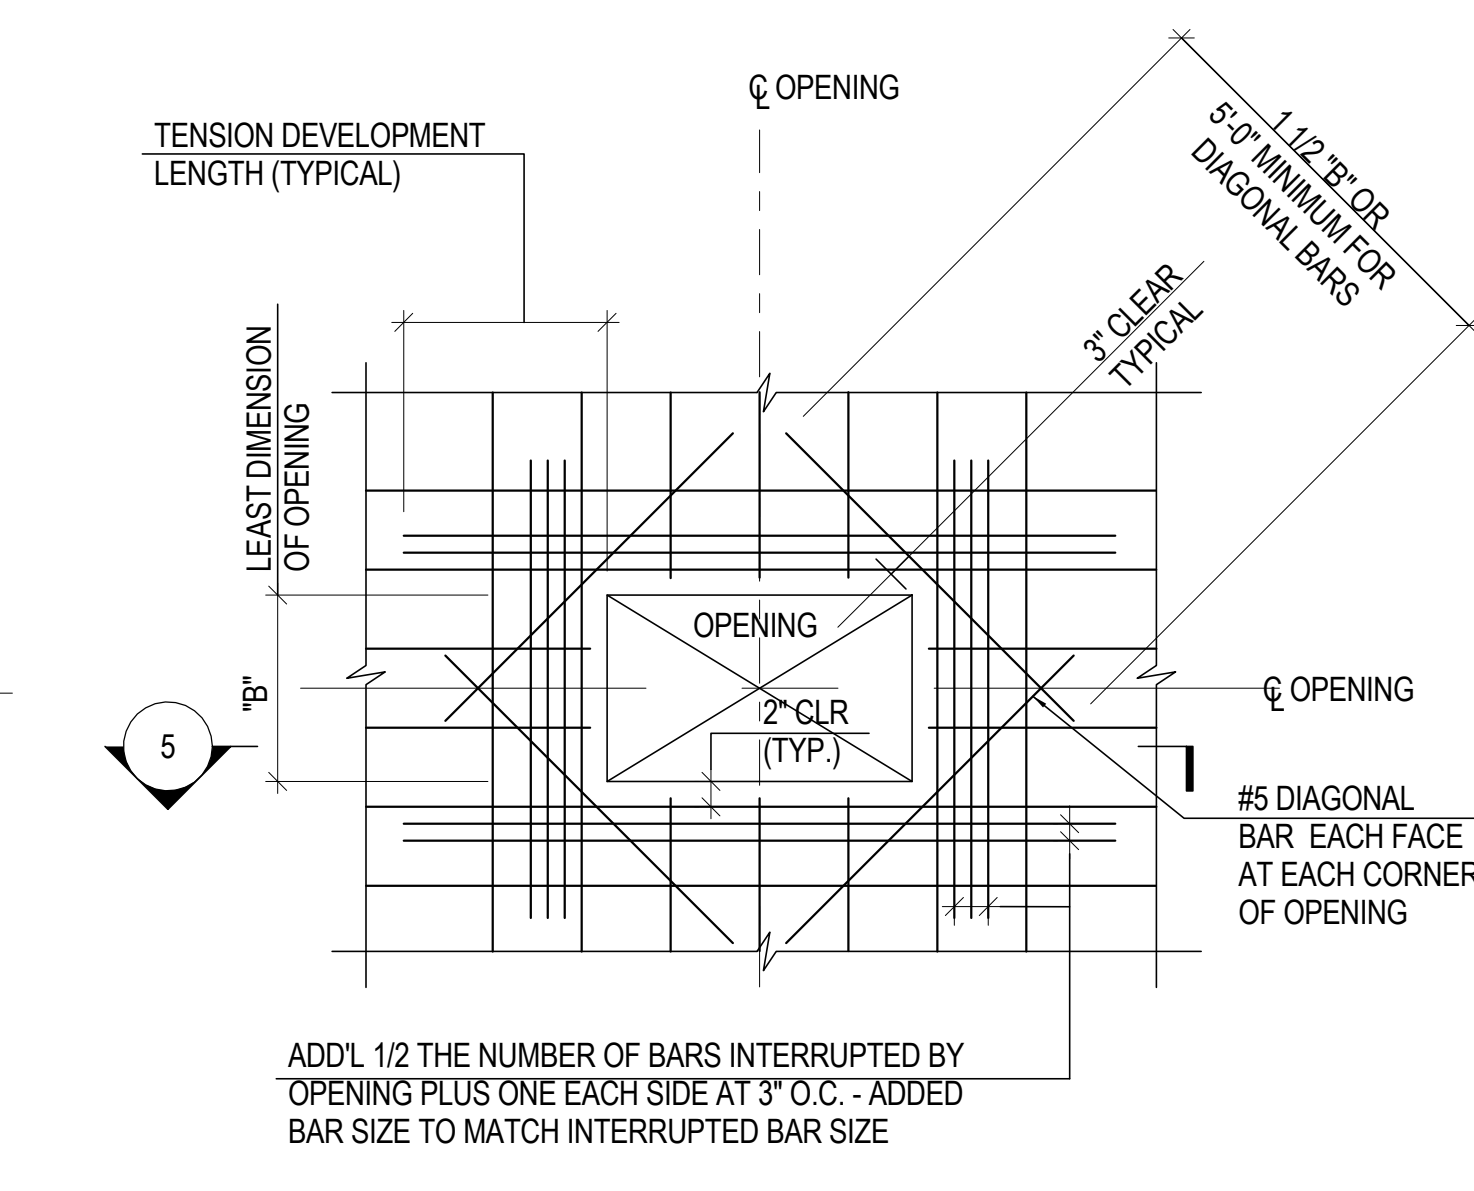
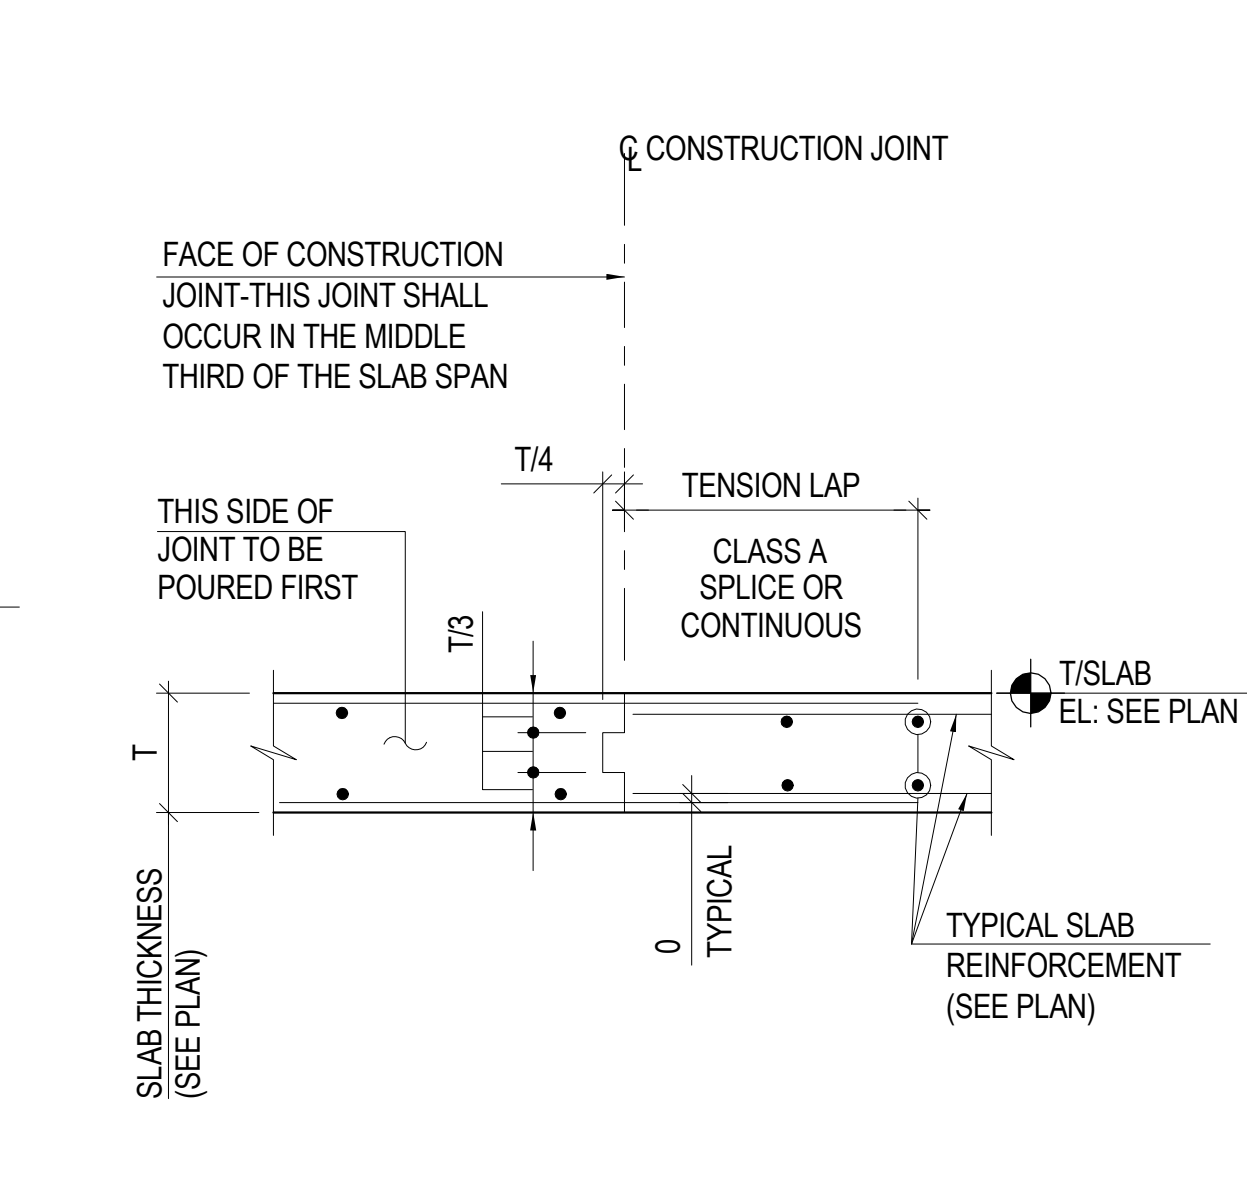
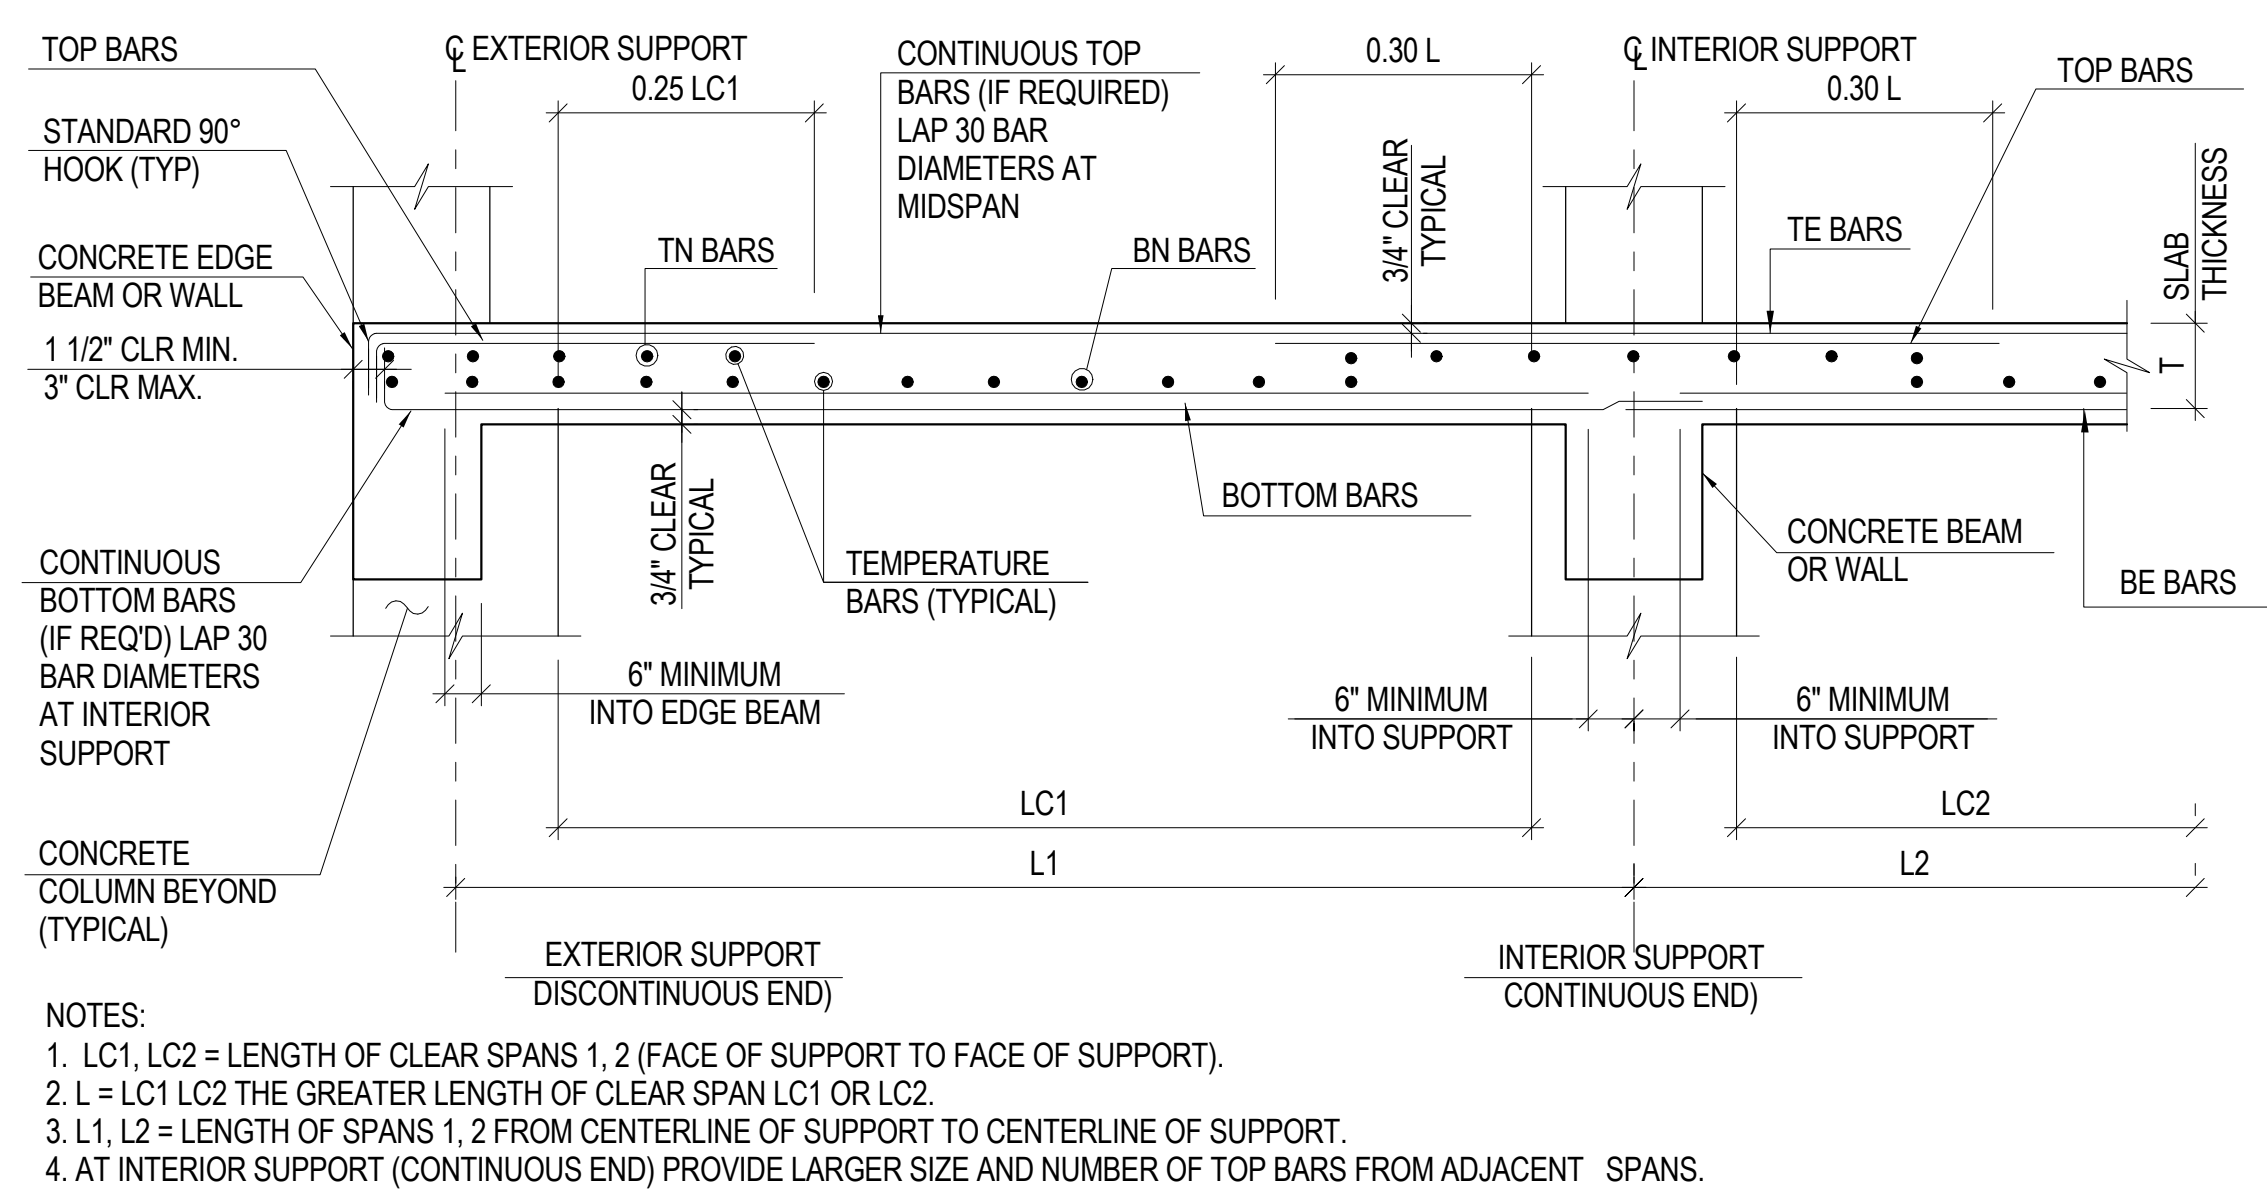
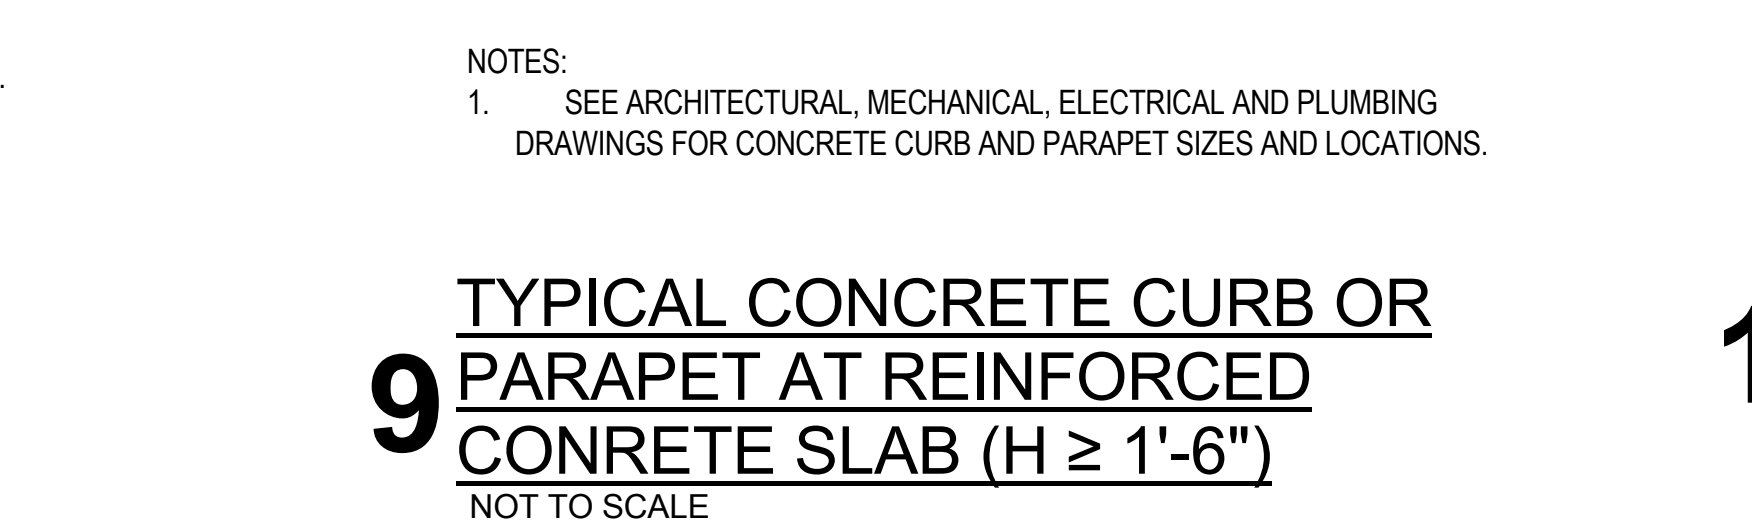
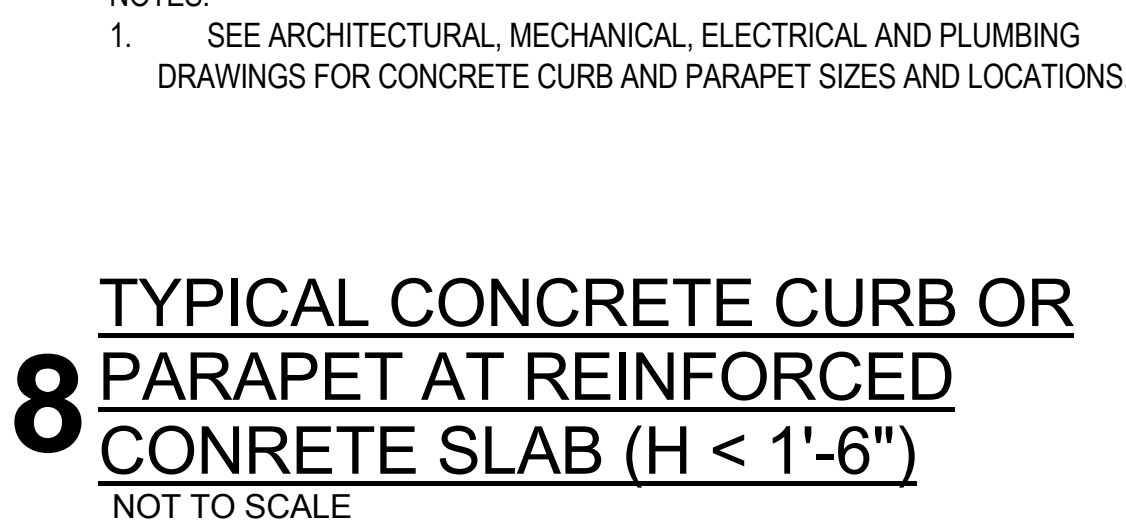
No.	Date	Description
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2	12 JUL 2013	ISSUED FOR 60% DESIGN DEVELOPMENT
1	19 MAR 2012	ISSUED FOR RECONCILIATION

Sheet Name: CORE WALL ELEVATIONS ALONG LINE 4

Project No.:	B-SCAN Sheet No.:
211157	S-367.00

Date:	Scale:
20 JUN 2014	As Indicated



File No.:	Page No.:
S-367	71 of 90

[illegible]

REINFORCED CONCRETE TWO-WAY SLAB SCHEDULE						CONCRETE: STEEL REINFORCEMENT:
MARK	SLAB THICKNESS, T (N)	MAIN REINFORCEMENT				REMARKS
		TE	TN	BE	BT	
S4	14	#8 @ 12	#8 @ 12	#4 @ 12	#4 @ 12	ELEVATOR PIT SLAB
S5	8	#4 @ 12	#4 @ 12	#4 @ 12	#4 @ 12	TYPICAL SLAB ON GRADE
S6	16	#8 @ 12	#8 @ 12	#4 @ 12	#4 @ 12	SLAB ON GRADE AT TANKS
S7	16	#8 @ 12	#8 @ 12	#4 @ 12	#4 @ 12	ELEVATOR PIT SLAB

[illegible]

STRUCTURAL STEEL COLUMN SCHEDULE OF NE TOWER										W14 COLUMNS: ASTM A913-GRADE 65 PLATE MATERIAL: ASTM A572 GR 50, TYP. U.N.O.	
GRID LOCATION											
FLOOR LEVEL	A-3, A-5	A-4	B-1, B-7	TC-1, TC-7	TC-3, TC-4, TC-5	C-1, C-7, D-1, D-7, E-1, E-7	F-1, F-7	C-1-3, C-1-4, C-1-5	G-1, G-7	F-5-3, F-5-4, F-5-5	
ROOF LEVEL EL: SEE PLAN	W14X61	W14X61	W14X90	W14X90	W14X61	W14X61	W14X61	--	--	--	
LEVEL 71 EL: SEE PLAN	W14X61	W14X61	W14X90	W14X90	W14X61	W14X61	W14X61	--	--	--	
LEVEL 70 EL: SEE PLAN	W14X61	W14X61	W14X90	W14X90	W14X61	W14X61	W14X61	--	--	--	
LEVEL 69 EL: SEE PLAN	W14X61	W14X61	W14X90	W14X90	W14X61	W14X61	W14X61	--	--	--	
LEVEL 68 EL: SEE PLAN	SEE NOTE 1	SEE NOTE 1	SEE NOTE 1	SEE NOTE 1	SEE NOTE 1	SEE NOTE 1	SEE NOTE 1	W14X109	--	--	
LEVEL 67 EL: SEE PLAN	W14X665	W14X665	WFP 14X730X16X2	W14X455	W14X665	W14X665	W14X665	W14X109	--	--	
LEVEL 66 EL: SEE PLAN	W14X665	W14X665	WFP 14X730X16X2	W14X455	W14X665	W14X665	W14X665	W14X109	--	--	
LEVEL 65 EL: SEE PLAN	W14X665	W14X665	WFP 14X730X16X2	W14X455	W14X665	W14X665	W14X665	W14X109	--	--	
LEVEL 64 EL: SEE PLAN	W14X665	W14X665	WFP 14X730X16X2	W14X455	W14X665	W14X665	W14X665	W14X109	--	--	
LEVEL 63 EL: SEE PLAN	W14X665	W14X665	WFP 14X730X16X2	W14X455	W14X665	W14X665	W14X665	W14X109	--	--	
LEVEL 62 EL: SEE PLAN	W14X665	W14X665	WFP 14X730X16X2	W14X455	W14X665	W14X665	W14X665	W14X109	--	--	
LEVEL 61 EL: SEE PLAN	W14X665	W14X665	WFP 14X730X16X2	W14X455	W14X665	W14X665	W14X665	W14X109	--	--	
LEVEL 60 EL: SEE PLAN	W14X665	W14X665	WFP 14X730X16X2	W14X455	W14X665	W14X665	W14X665	W14X109	--	--	
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LEVEL 58 EL: SEE PLAN	W14X665	W14X665	WFP 14X730X16X2	W14X455	W14X665	W14X665	W14X665	W14X159	--	--	
LEVEL 57 EL: SEE PLAN	W14X665	W14X665	WFP 14X730X16X2	W14X455	W14X665	W14X665	W14X665	W14X159	--	--	
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LEVEL 55 EL: SEE PLAN	W14X665	W14X665	WFP 14X730X16X2	W14X455	W14X665	W14X665	W14X665	W14X193	--	--	
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LEVEL 36 EL: SEE PLAN	W14X665	W14X665	WFP 14X730X16X2	W14X455	W14X665	W14X665	W14X665	--	W14X211	W14X211	
LEVEL 35 EL: SEE PLAN	W14X665	W14X665	WFP 14X730X16X2	W14X455	W14X665	W14X665	W14X665	--	W14X283	W14X211	
LEVEL 34 EL: SEE PLAN	W14X665	W14X665	WFP 14X730X16X2	W14X455	W14X665	W14X665	W14X665	--	W14X283	W14X211	
LEVEL 33 EL: SEE PLAN	W14X665	W14X665	WFP 14X730X16X2	W14X455	W14X665	W14X665	W14X665	--	W14X283	W14X211	
LEVEL 32 EL: SEE PLAN	W14X665	W14X665	WFP 14X730X16X2	W14X455	W14X665	W14X665	W14X665	--	W14X283	W14X283	
LEVEL 31 EL: SEE PLAN	W14X665	W14X665	WFP 14X730X16X2	W14X455	W14X665	W14X665	W14X665	--	W14X342	W14X283	
LEVEL 30 EL: SEE PLAN	W14X665	W14X665	WFP 14X730X16X2	W14X455	W14X665	W14X665	W14X665	--	W14X342	--	
LEVEL 29 EL: SEE PLAN	W14X665	W14X665	WFP 14X730X16X2	W14X455	W14X665	W14X665	W14X665	--	W14X342	--	
LEVEL 28 EL: SEE PLAN	W14X665	W14X665	WFP 14X730X16X2	W14X455	W14X665	W14X665	W14X665	--	W14X342	--	
LEVEL 27 EL: SEE PLAN	W14X665	W14X665	WFP 14X730X16X2	W14X455	W14X665	W14X665	W14X665	--	W14X426	--	
LEVEL 26 EL: SEE PLAN	W14X665	W14X665	WFP 14X730X16X2	W14X455	W14X665	W14X665	W14X665	--	W14X426	--	
LEVEL 25 EL: SEE PLAN	W14X665	W14X665	WFP 14X730X16X2	W14X455	W14X665	W14X665	W14X665	--	W14X426	--	
LEVEL 24 EL: SEE PLAN	W14X665	W14X665	WFP 14X730X16X2	W14X455	W14X665	W14X665	W14X665	--	W14X426	--	
LEVEL 23 EL: SEE PLAN	W14X665	W14X665	WFP 14X730X16X2	W14X455	W14X665	W14X665	W14X665	--	W14X426	--	
LEVEL 22 EL: SEE PLAN	W14X665	W14X665	WFP 14X730X16X2	W14X455	W14X665	W14X665	W14X665	--	W14X426	--	
LEVEL 21 EL: SEE PLAN	W14X665	W14X665	WFP 14X730X16X2	W14X455	W14X665	W14X665	W14X665	--	W14X500	--	
LEVEL 20 EL: SEE PLAN	W14X665	W14X665	WFP 14X730X16X2	W14X455	W14X665	W14X665	W14X665	--	W14X500	--	
LEVEL 19 EL: SEE PLAN	W14X665	W14X665	WFP 14X730X16X2	W14X455	W14X665	W14X665	W14X665	--	W14X500	--	
LEVEL 18 EL: SEE PLAN	W14X665	W14X665	WFP 14X730X16X2	W14X455	W14X665	W14X665	W14X665	--	W14X500	--	
LEVEL 17 EL: SEE PLAN	W14X665	W14X665	WFP 14X730X16X2	W14X455	W14X665	W14X665	W14X665	--	W14X500	--	
LEVEL 16 EL: SEE PLAN	W14X665	W14X665	WFP 14X730X16X2	W14X455	W14X665	W14X665	W14X665	--	W14X500	--	
LEVEL 15 EL: SEE PLAN	W14X665	W14X665	WFP 14X730X16X2	W14X455	W14X665	W14X665	W14X665	--	W14X550	--	
LEVEL 14 EL: SEE PLAN	W14X665	W14X665	WFP 14X730X16X2	W14X455	W14X665	W14X665	W14X665	--	W14X550	--	
LEVEL 13 EL: SEE PLAN	W14X665	W14X665	WFP 14X730X16X2	W14X455	W14X665	W14X665	W14X665	--	W14X550	--	
LEVEL 12 EL: SEE PLAN	W14X665	W14X665	WFP 14X730X16X2	W14X455	W14X665	W14X665	W14X665	--	W14X550	--	
LEVEL 11 EL: SEE PLAN	W14X665	W14X665	WFP 14X730X16X2	W14X500	W14X665	W14X665	W14X665	--	W14X605	--	
LEVEL 10 EL: SEE PLAN	W14X665	W14X665	WFP 14X730X16X2	W14X500	W14X730	W14X665	W14X665	--	W14X605	--	
LEVEL 09 EL: SEE PLAN	W14X665	W14X665	WFP 14X730X16X2	W14X500	W14X730	W14X665	W14X665	--	W14X605	--	
LEVEL 08 EL: SEE PLAN	W14X665	W14X665	WFP 14X730X16X3	W14X500	W14X730	W14X730	W14X730	--	W14X730	--	
LEVEL 07 EL: SEE PLAN	W14X665	W14X665	WFP 14X730X16X3	W14X500	W14X730	W14X730	W14X730	--	W14X730	--	
LEVEL 06 EL: SEE PLAN	W14X665	W14X665	WFP 14X730X16X3	W14X500	WFP 14X730X16X1	W14X730	W14X730	--	W14X730	--	
LEVEL 05 EL: SEE PLAN	WFP 14X730X16X1	W14X730	DP BOX 24X24X3X3	DP BOX 24X24X3 25X3 25	DP BOX 24X24X2 5X2 5	DP BOX 24X24X2 5X2 5	BOX 24X24X4X4	--	DP BOX 24X24X3X3	--	
LEVEL 04 EL: SEE PLAN	WFP 14X730X16X1	W14X730	DP BOX 24X24X3X3	DP BOX 24X24X3 25X3 25	DP BOX 24X24X2 5X2 5	DP BOX 24X24X2 5X2 5	BOX 24X24X4X4	--	DP BOX 24X24X3X3	--	
LEVEL 03 EL: SEE PLAN	SEE NOTE 2	SEE NOTE 2	W14X132	W14X132	SEE NOTE 3	W14X132	W14X132	--	W14X132	--	
LEVEL 02 EL: SEE PLAN	SEE NOTE 2	SEE NOTE 2	W14X132	W14X132	SEE NOTE 3	W14X132	W14X132	--	W14X132	--	
LEVEL 01 EL: SEE PLAN	SEE NOTE 2	SEE NOTE 2	HSS 12X12X1/2	HSS 12X12X1/2	DP BOX 24X24X3X3	HSS 12X12X1/2	HSS 12X12X1/2	--	HSS 12X12X1/2	--	
1. REFER TO S-416 FOR UPPER BELT TRUSS COLUMN SCHEDULE. 2. REFER TO S-409 FOR COLUMN SCHEDULE ALONG GRID A BELOW LEVEL 6. 3. REFER TO S-415 FOR COLUMN SCHEDULE ALONG GRID J ON LOWER BELT TRUSS.											

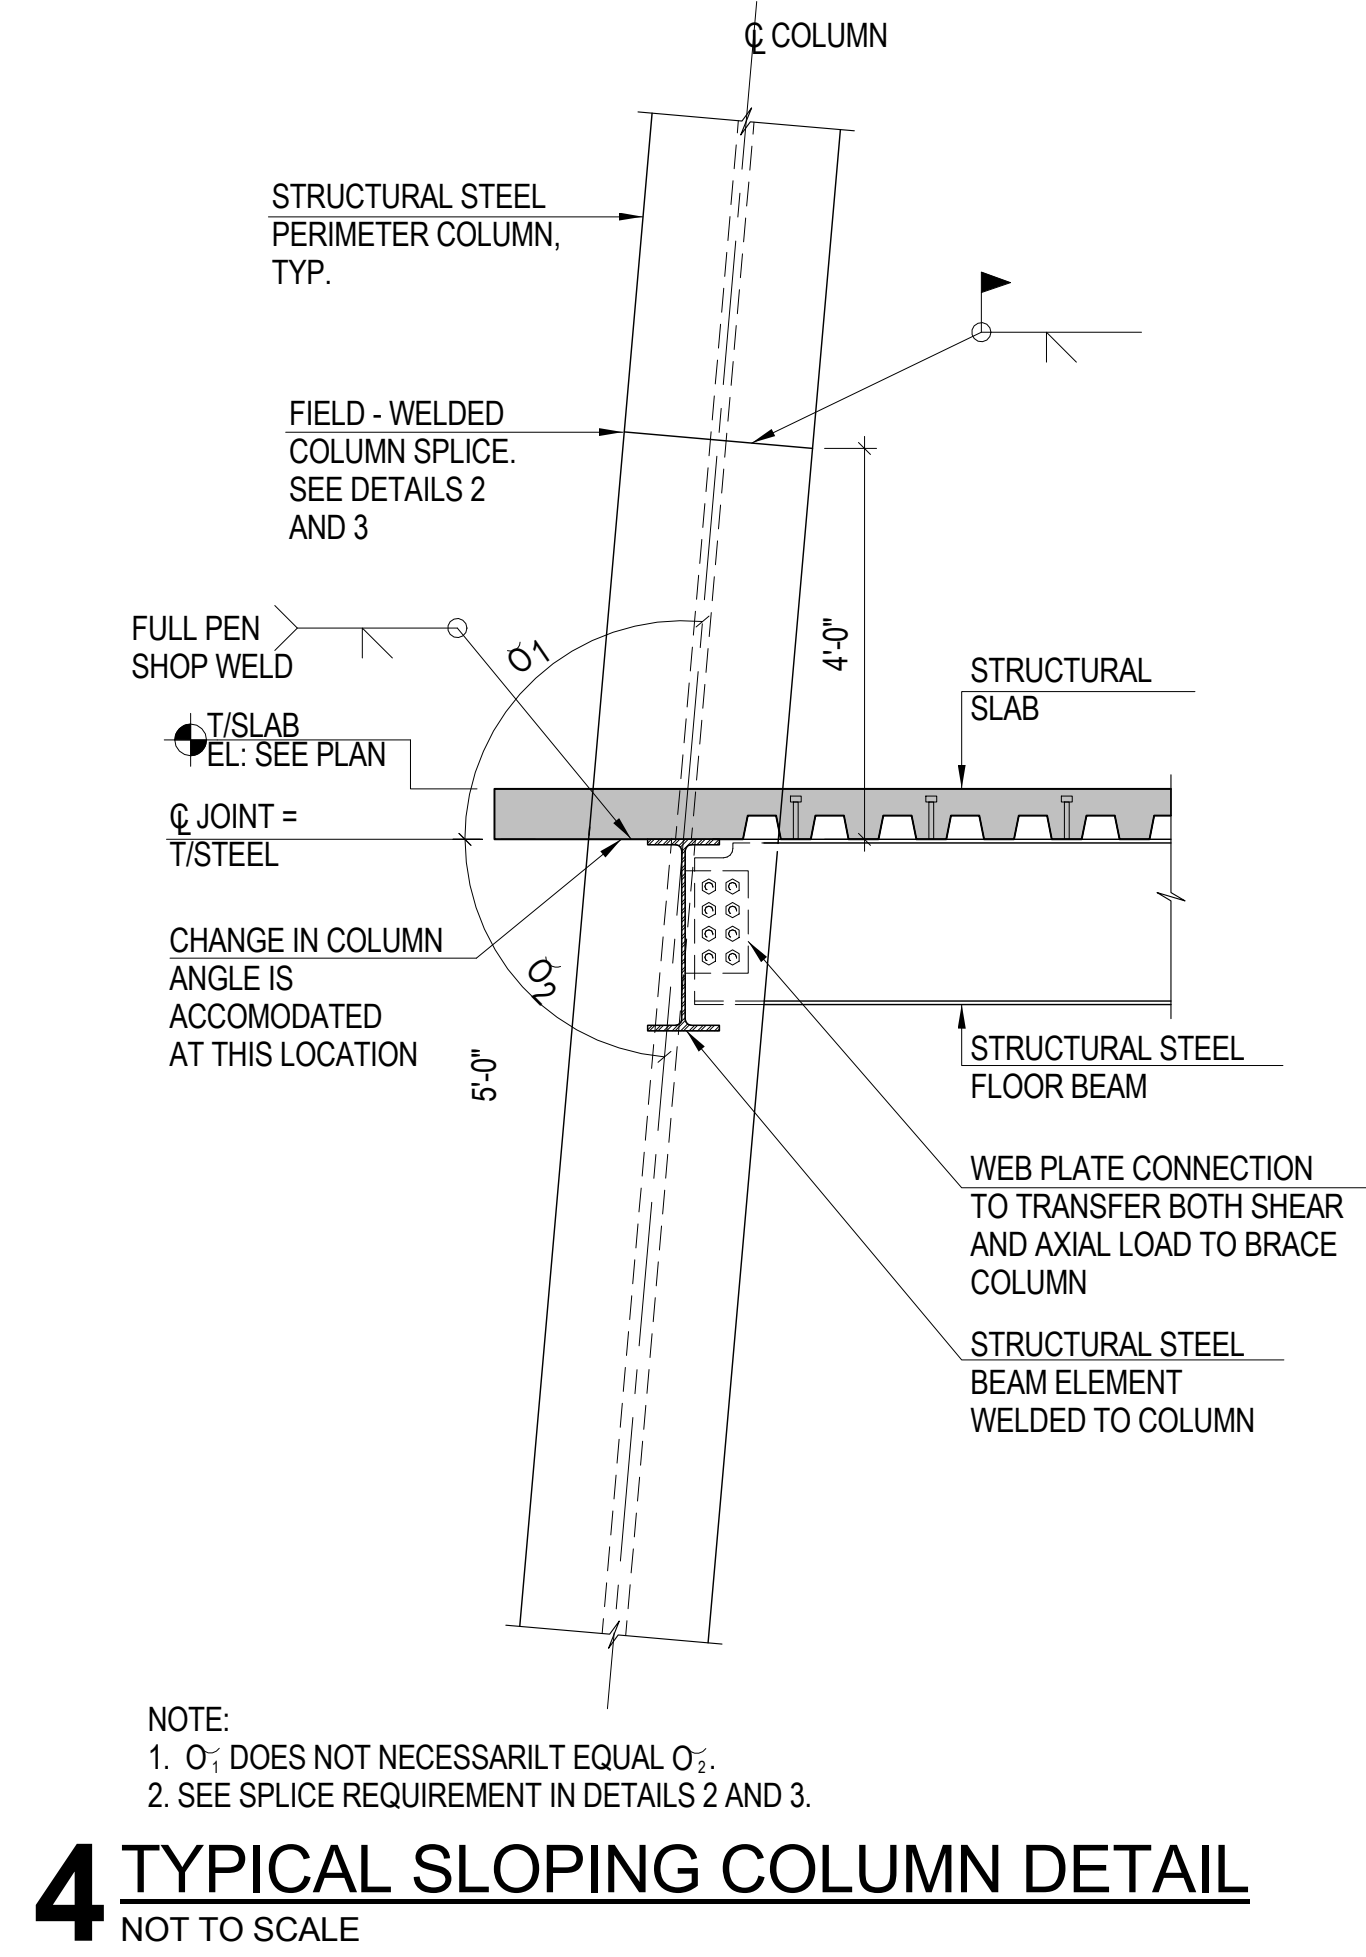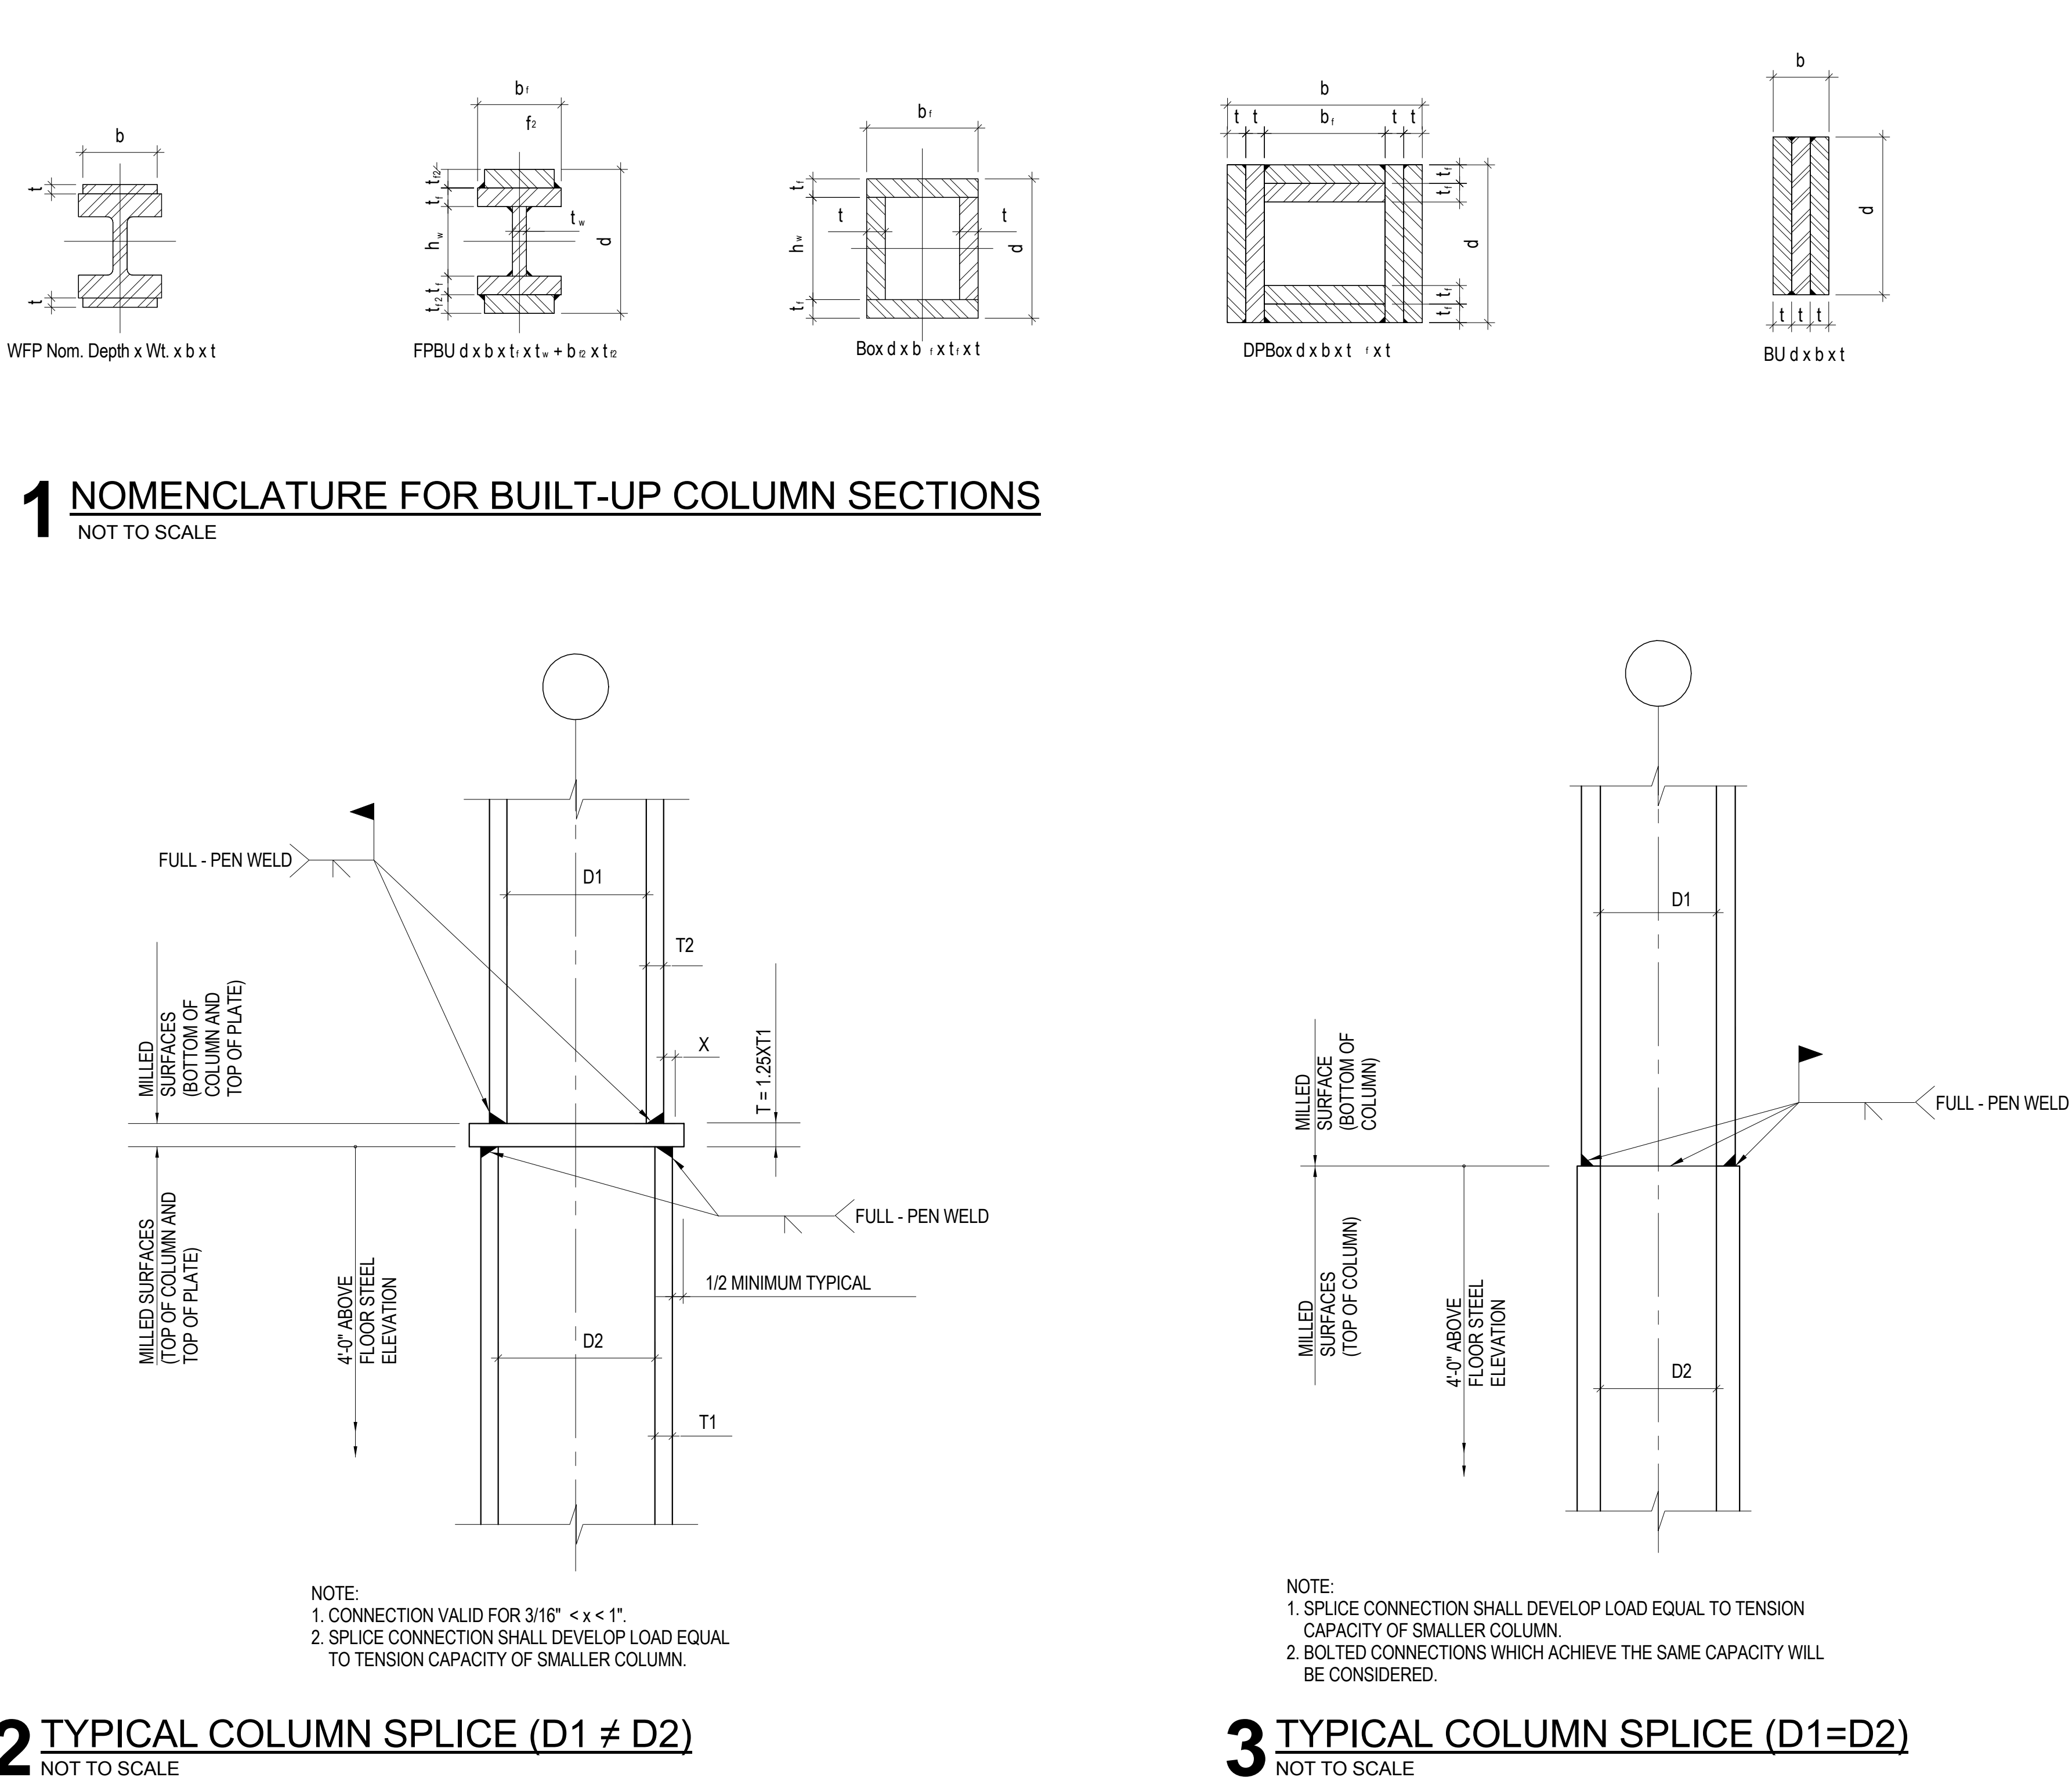

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Key Plan:

Seal & Signature:


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5	20 JUN 2014	ISSUED FOR FOUNDATION PERMIT
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2	12 JUL 2013	ISSUED FOR 90% DESIGN DEVELOPMENT
1	18 MAR 2012	ISSUED FOR RECONCILIATION


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Sheet Name: **STRUCTURAL
STEEL COLUMN
SCHEDULE,
SECTIONS &
DETAILS**


Project No.: 211157	B-SCAN Sheet No.: S-401.00
Date: 20 JUN 2014	Sheet No.: S-401
Scale: As indicated	Page No.: 75 of 90
File No.: S-401	




1 TYPICAL BASE PLATE ELEVATION
1" = 1'-0"

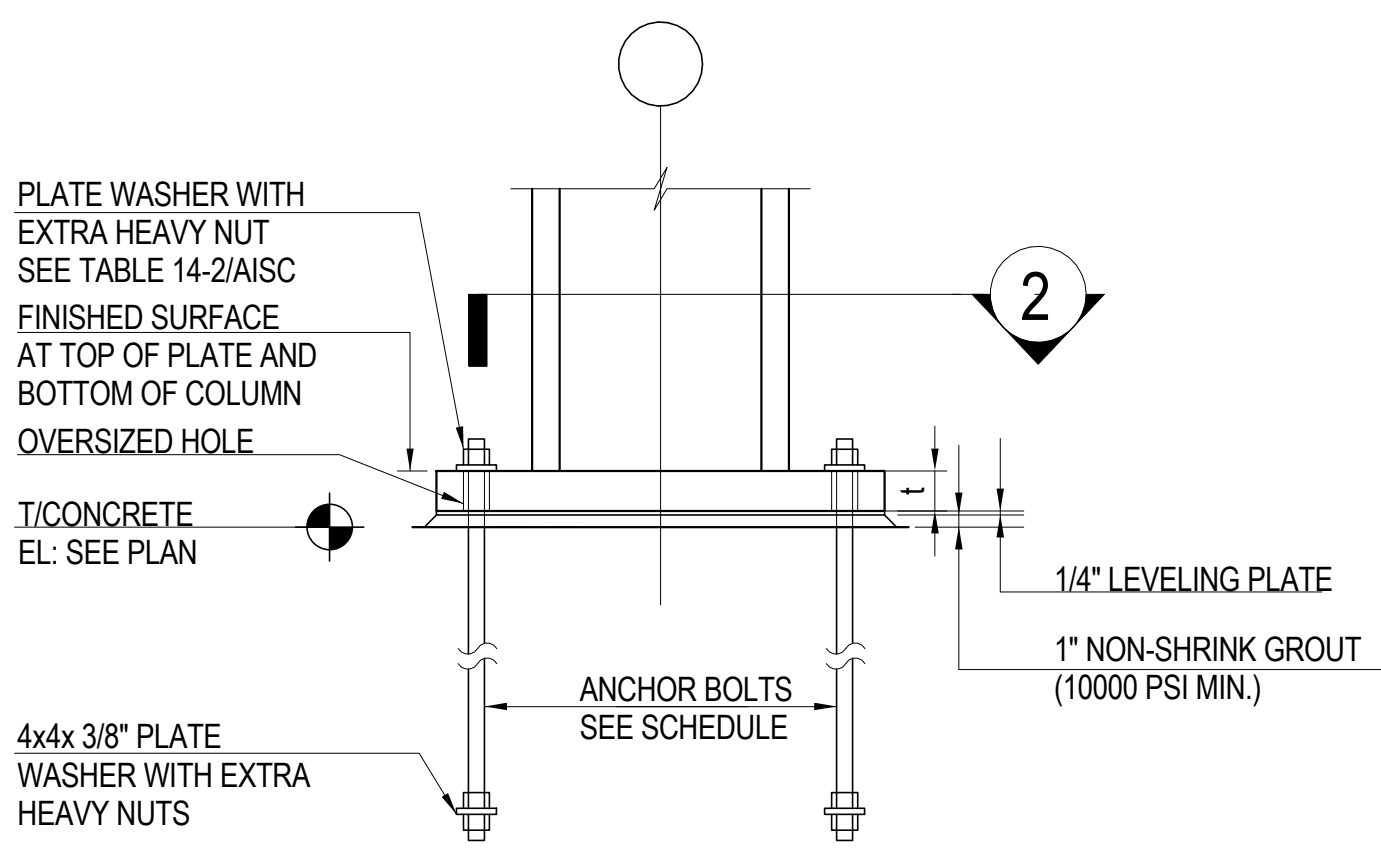

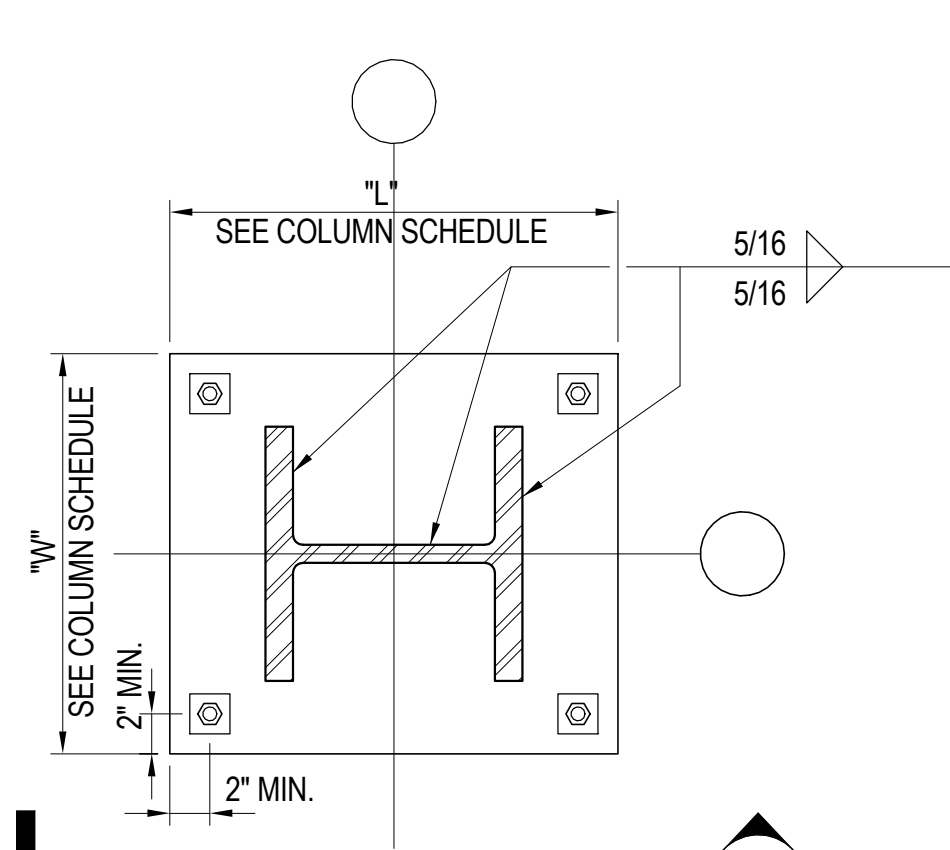
2 TYPICAL BASE PLATE PLAN
1" = 1'-0"

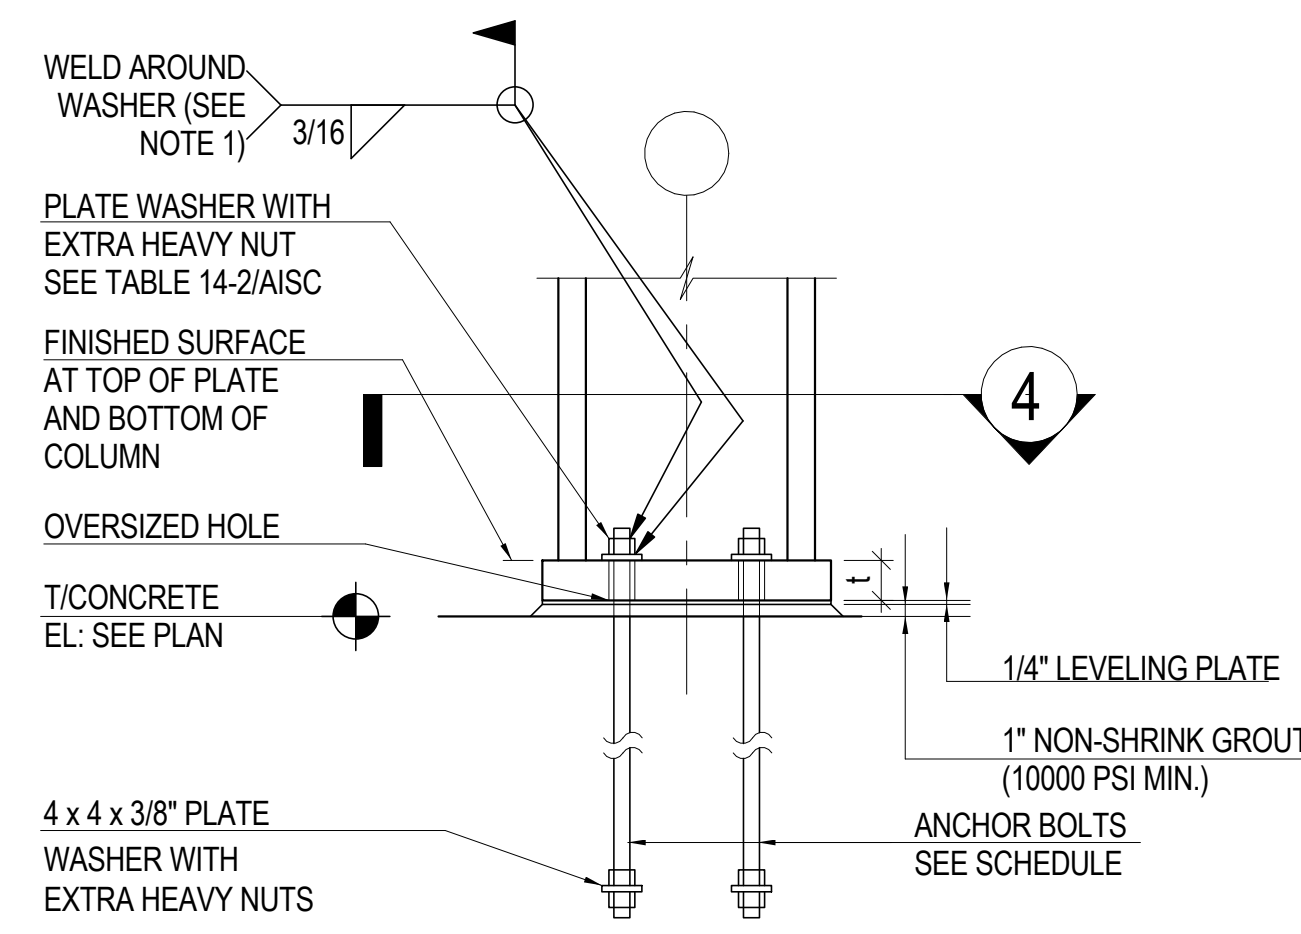

3 BASE PLATE WITH INTERIOR ANCHOR RODS ELEVATION
1" = 1'-0"

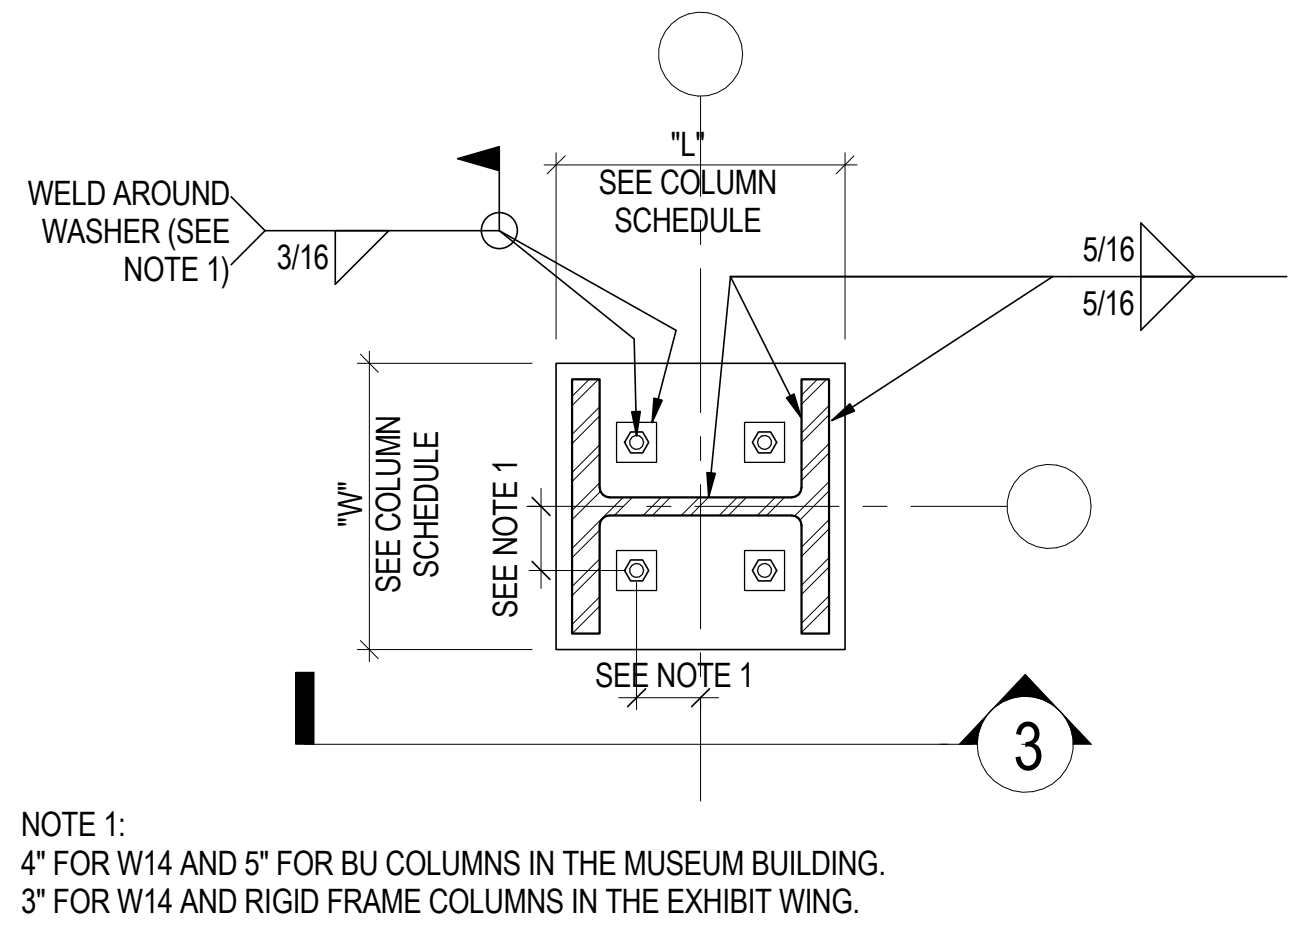

4 BASE PLATE WITH INTERIOR ANCHOR RODS PLAN
1" = 1'-0"

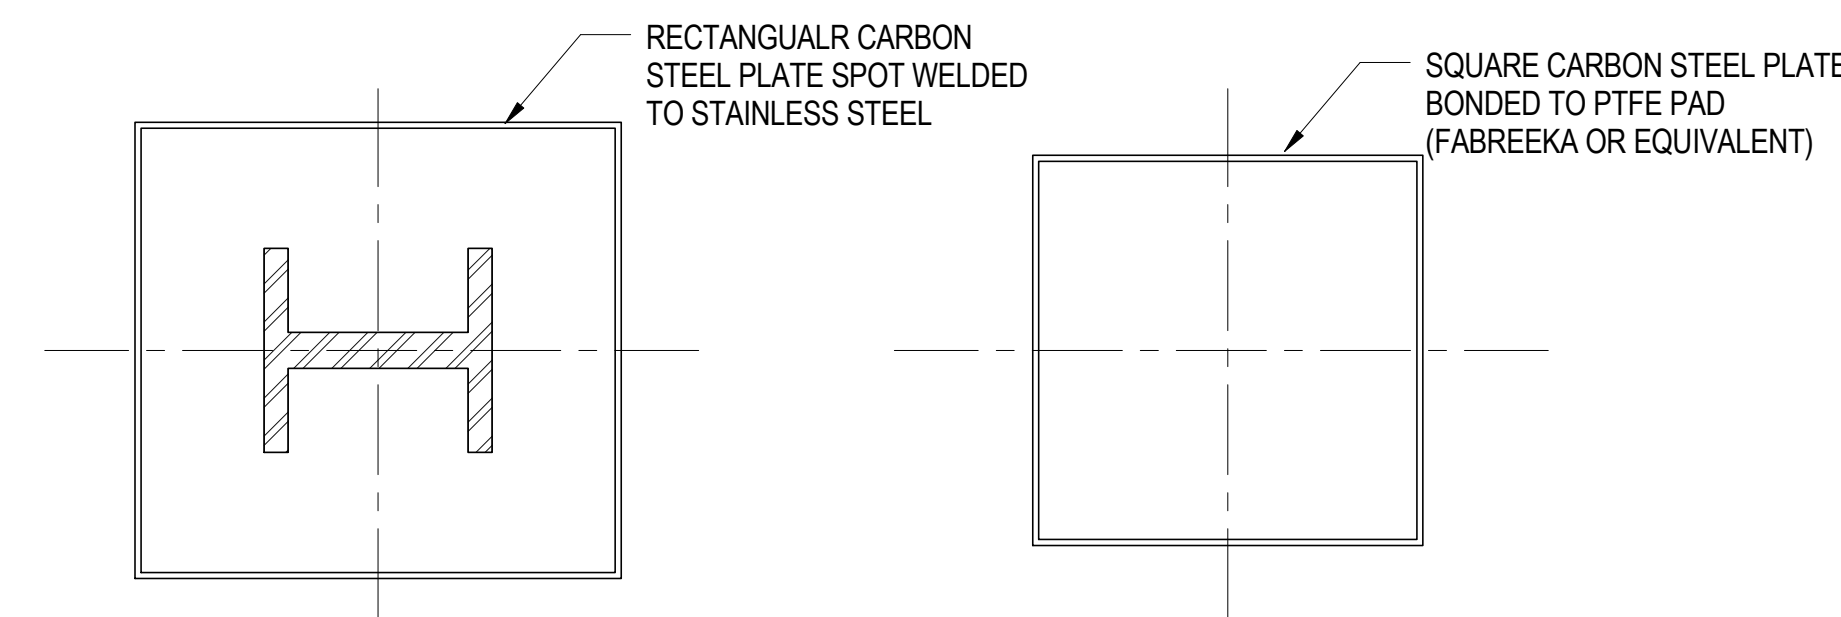

5 TYPICAL COLUMN BASE DETAIL AT SLIDING SUPPORT
3/4" = 1'-0"

STRUCTURAL STEEL COLUMN SCHEDULE AT RETAIL																										W14 COLUMNS: ASTM A913-GRADE 50 PLATE MATERIAL: ASTM A572 GR 50, TYP. U.N.O.			
GRID LOCATION																													
FLOOR LEVEL		B-7 - 6	C-8 - 6	D-6 - 6	E-3 - 6	B-7 - 8	C-8 - 8	D-6 - 8	E-3 - 8	A3 - 5	A2 - 5	A1 - 5	A3 - 4	A2 - 4	A1 - 4	A4 - 4.5	A4 - 5	A4 - 6	A4 - 8	A4 - 9	A3 - 6	A3 - 8	A3 - 9	A2 - 6	A2 - 8	A2 - 9	A - 6	A - 8	
LEVEL 05 EL: SEE PLAN																													
LEVEL 04 EL: SEE PLAN										W14X43	W14X43	W14X43	W14X43	W14X43	W14X43														
LEVEL 03 EL: SEE PLAN										W14X43	W14X43	W14X43	W14X43	W14X43	W14X43														
LEVEL 02 EL: SEE PLAN		W14X132	W14X132	W14X132	W14X132	W14X132	W14X132	W14X132	W14X132	W14X43	W14X61	W14X48	W14X48	W14X61	W14X43												W14X132	W14X132	
LEVEL 01 EL: SEE PLAN		W14X132	W14X132	W14X132	W14X132	W14X132	W14X132	W14X132	W14X132	W14X132	W14X176	W14X145	W14X132	W14X159	W14X145												W14X132	W14X132	
CELLAR B EL: SEE PLAN		W14X370	W14X132	W14X132	W14X132	W14X132	W14X132	W14X132	W14X370	W14X132	W14X176	W14X145	W14X132	W14X159	W14X145	W14X132	W14X132	W14X132	W14X132	W14X132	W14X132	W14X132	W14X132	W14X370	W14X370	W14X370			
<div>1. ALL COLUMNS SUPPORTED ON A SLIDGING BEARING PAD WEST OF GL C SHALL BE DESIGNED FOR AN AXIAL LOAD (LRFD) OF 1110 KIPS AND ACCOMMODATE MOVEMENTS IN THE EAST-WEST DIRECTION OF +/- 2-3/4in AND IN THE NORTH-SOUTH DIRECTION OF +/- 4in.</div> <div>2. ALL COLUMNS SUPPORTED ON A SLIDGING BEARING PAD EAST OF GL C AND WEST OF GL H SHALL BE DESIGNED FOR AN AXIAL LOAD (LRFD) OF 500 KIPS AND ACCOMMODATE MOVEMENTS IN THE EAST-WEST DIRECTION OF +/- 2-3/4in AND IN THE NORTH-SOUTH DIRECTION OF +/- 4in.</div> <div>3. ALL COLUMNS SUPPORTED ON A SLIDGING BEARING PAD EAST OF GL H SHALL BE DESIGNED FOR AN AXIAL LOAD (LRFD) OF 500 KIPS AND ACCOMMODATE MOVEMENTS IN THE EAST-WEST DIRECTION OF +/- 1-1/2in AND IN THE NORTH-SOUTH DIRECTION OF +/- 4in.</div>																													

STRUCTURAL STEEL COLUMN SCHEDULE OUTSIDE OF TOWER																														W14 COLUMNS: ASTM A913-GRADE 50 PLATE MATERIAL: ASTM A572 GR 50, TYP. U.N.O.							
GRID LOCATION																																					
FLOOR LEVEL		B-7 - 9	C-8 - 9	D-6 - 9	E-3 - 9	F-2 - 9	G-5 - 9	K - 9	K-7 - 9	F-2 - 7	G-5 - 7	K - 7	K-7 - 7	F-2 - 6	G-5 - 6	K - 6	K-7 - 6	J - 7	H - 4.8	K - 4.8	K-7 - 4.8	H - 4	K - 4	H - 3	K - 3	B - 1	B-7 - 1	C - 1	C-5 - 1	D - 1	D - 2	E - 1	F - 1	G - 1	H - 1	K - 1	
LEVEL 01 EL: SEE PLAN																										W14X132		W14X132		W14X132	W14X132						
CELLAR B EL: SEE PLAN		W14X370	W14X132	W14X132	<div>1. ALL COLUMNS SUPPORTED ON A SLIDGING BEARING PAD WEST OF GL C SHALL BE DESIGNED FOR AN AXIAL LOAD (LRFD) OF 1110 KIPS AND ACCOMMODATE MOVEMENTS IN THE EAST-WEST DIRECTION OF +/- 2-3/4in AND IN THE NORTH-SOUTH DIRECTION OF +/- 4in.</div> <div>2. ALL COLUMNS SUPPORTED ON A SLIDGING BEARING PAD EAST OF GL C AND WEST OF GL H SHALL BE DESIGNED FOR AN AXIAL LOAD (LRFD) OF 500 KIPS AND ACCOMMODATE MOVEMENTS IN THE EAST-WEST DIRECTION OF +/- 2-3/4in AND IN THE NORTH-SOUTH DIRECTION OF +/- 4in.</div> <div>3. ALL COLUMNS SUPPORTED ON A SLIDGING BEARING PAD EAST OF GL H SHALL BE DESIGNED FOR AN AXIAL LOAD (LRFD) OF 500 KIPS AND ACCOMMODATE MOVEMENTS IN THE EAST-WEST DIRECTION OF +/- 1-1/2in AND IN THE NORTH-SOUTH DIRECTION OF +/- 4in.</div>																																					



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Professional Engineer
Charles Michael Bell
070322
Professional Engineer

Key Plan:
33RD STREET
DYER AVENUE
31ST STREET
9TH AVENUE

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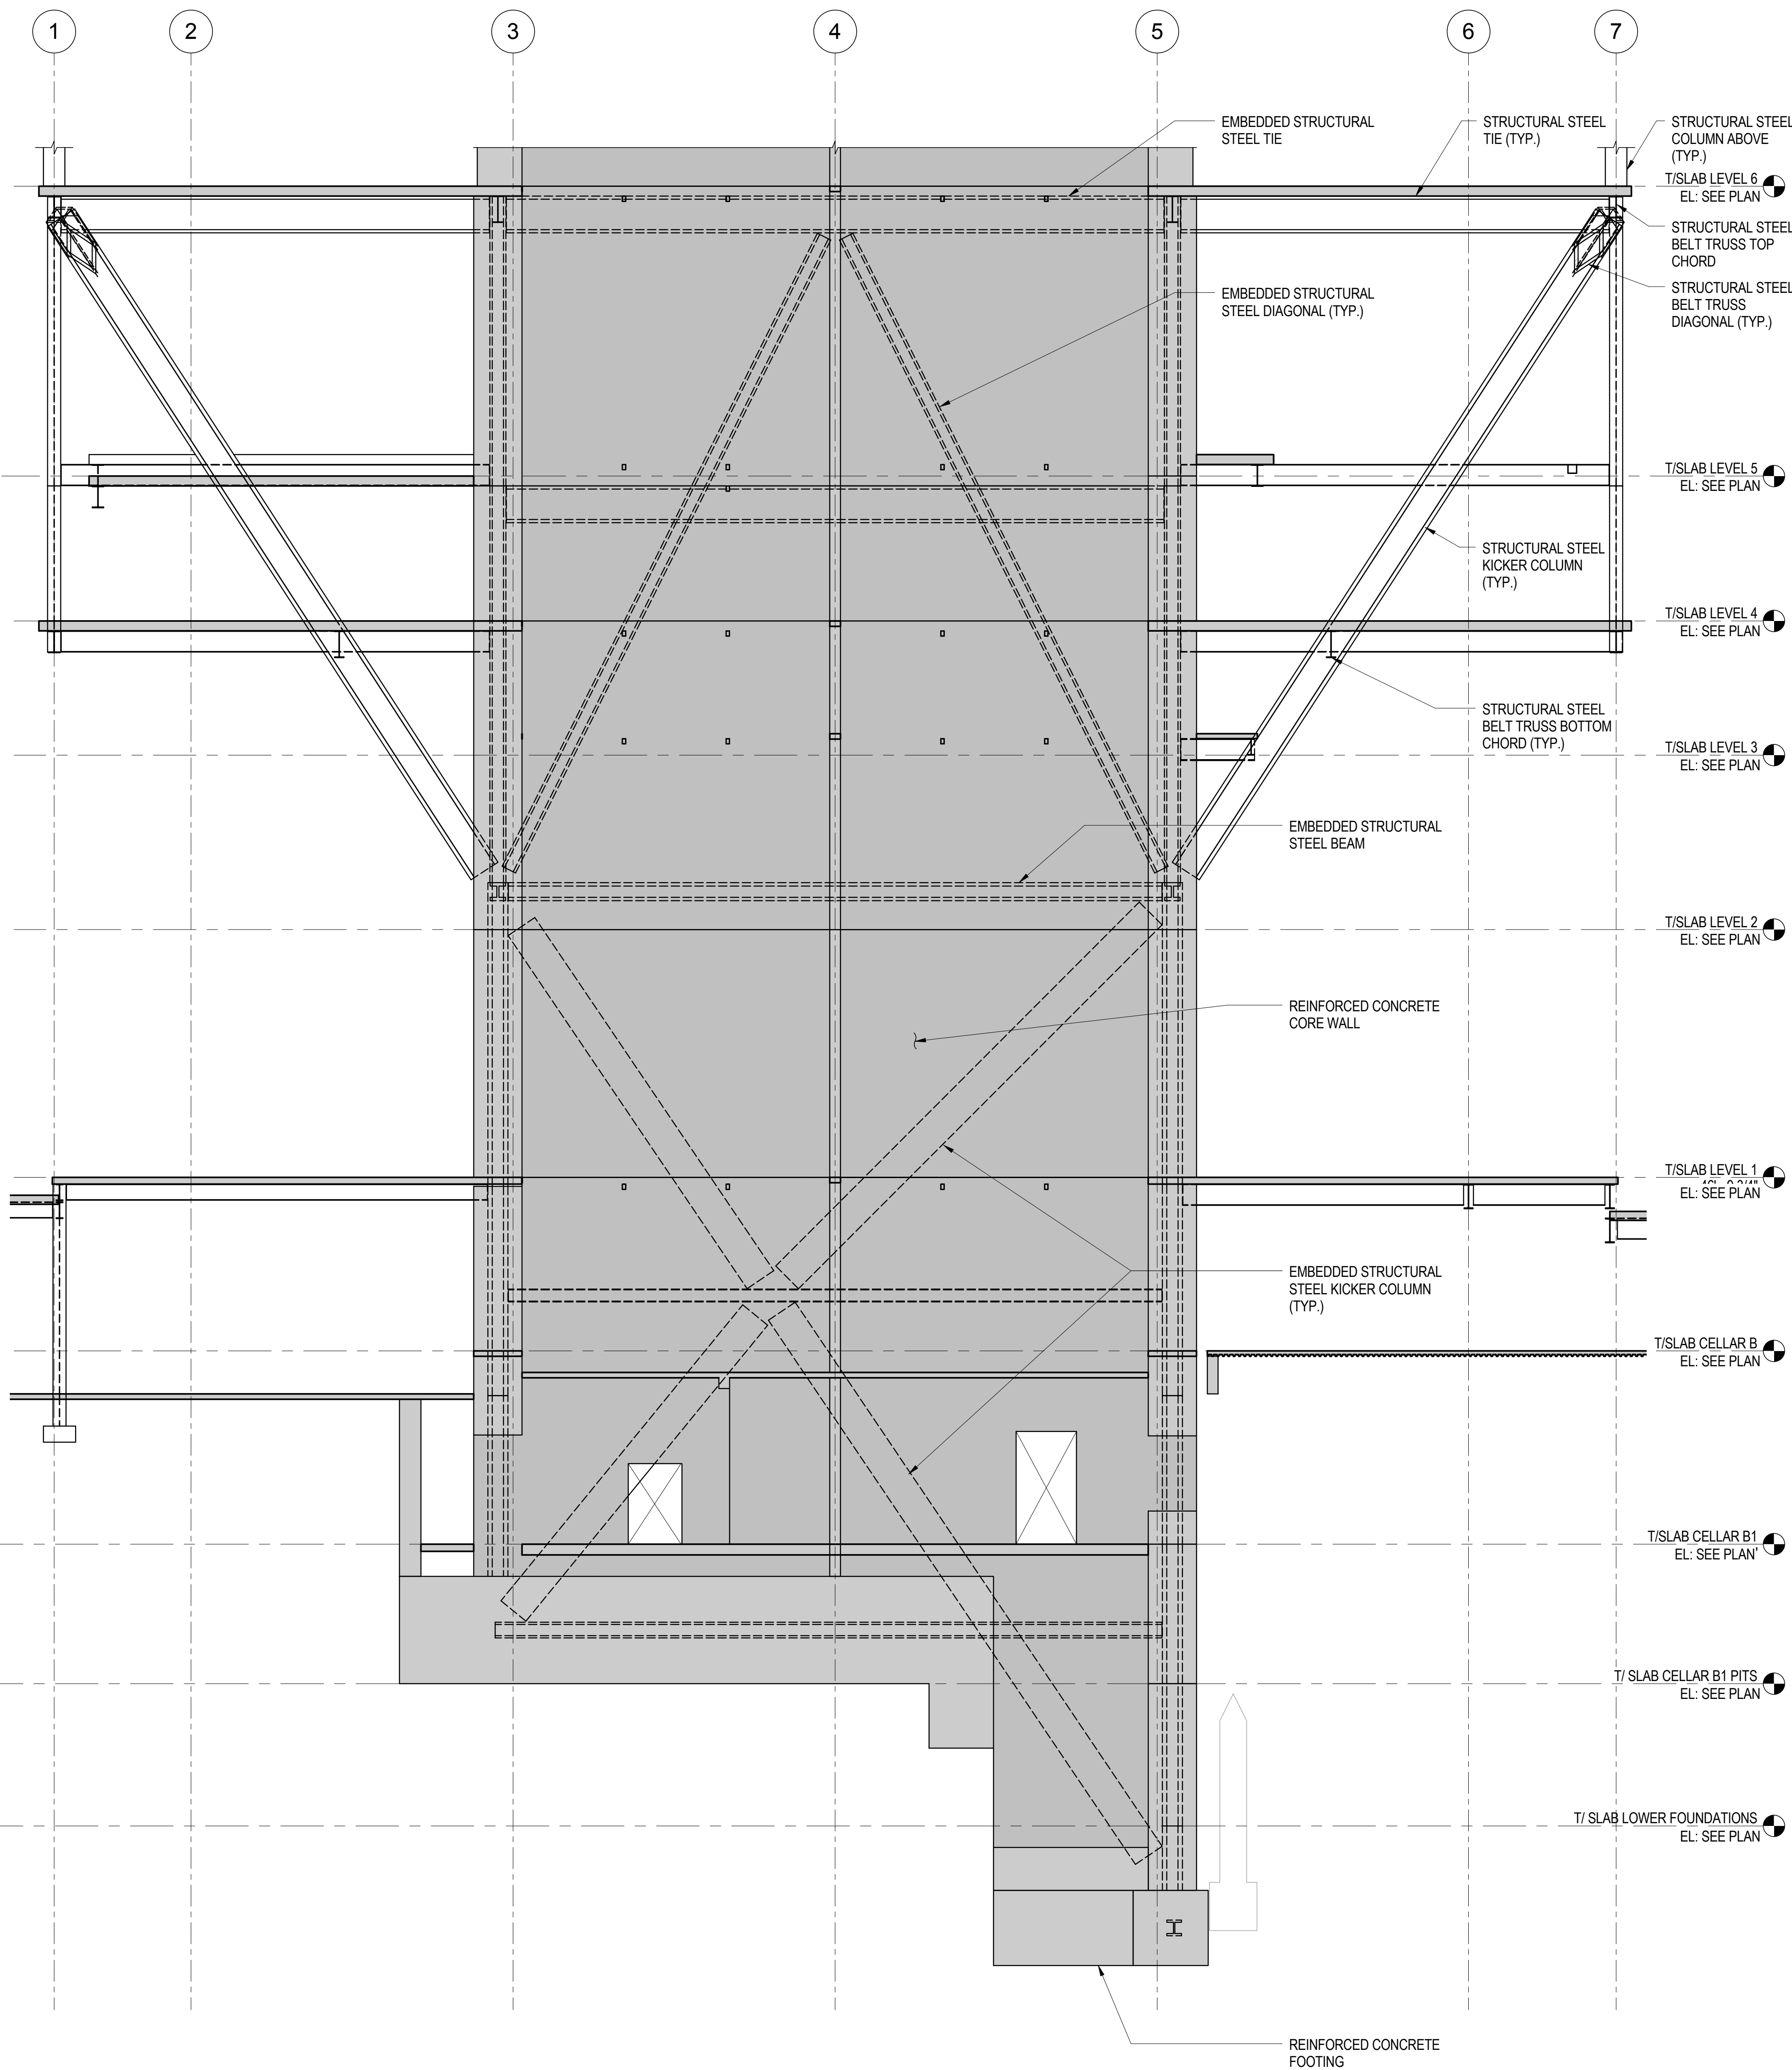
Project No.: 211157
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File No: S-402

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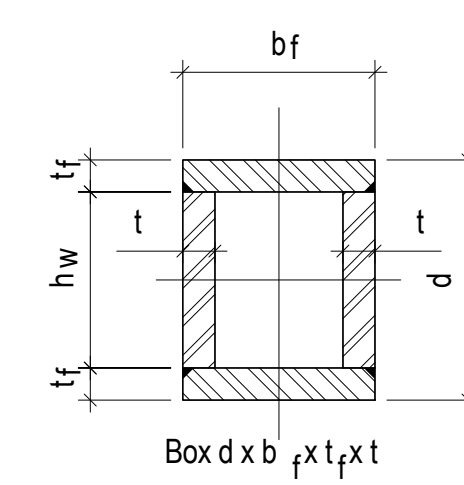
STRUCTURAL
STEEL COLUMN
SCHEDULE,
SECTIONS &
DETAILS

6 20 JUN 2014 ISSUED FOR FOUNDATION BID
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4 20 DEC 2013 ISSUED FOR FOUNDATION PERMIT
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2 12 JUL 2013 ISSUED FOR 90% DESIGN DEVELOPMENT
1 18 MAR 2012 ISSUED FOR RECONCILIATION


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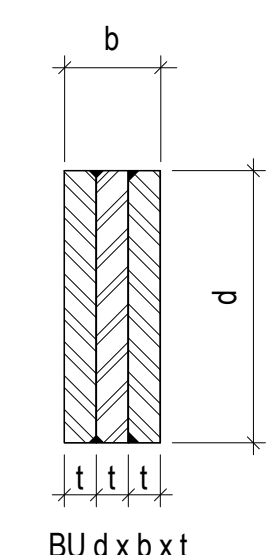
1 TYPICAL SECTION @ KICKERS THRU CORE WALL ALONG GRID LINES C TO F LOOKING EAST
NOT TO SCALE



A BOX




B DPBOX - DOUBLE PLATED BOX

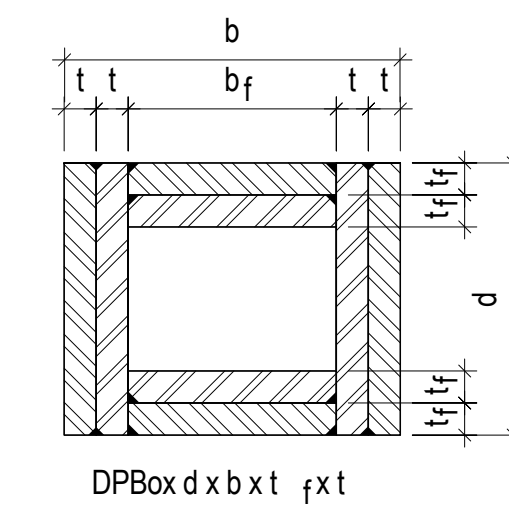

C BU - BUILT-TOP SOLID PLATE SECTION

NOMENCLATURE FOR BUILT-UP SECTIONS
1/2" = 1'-0"

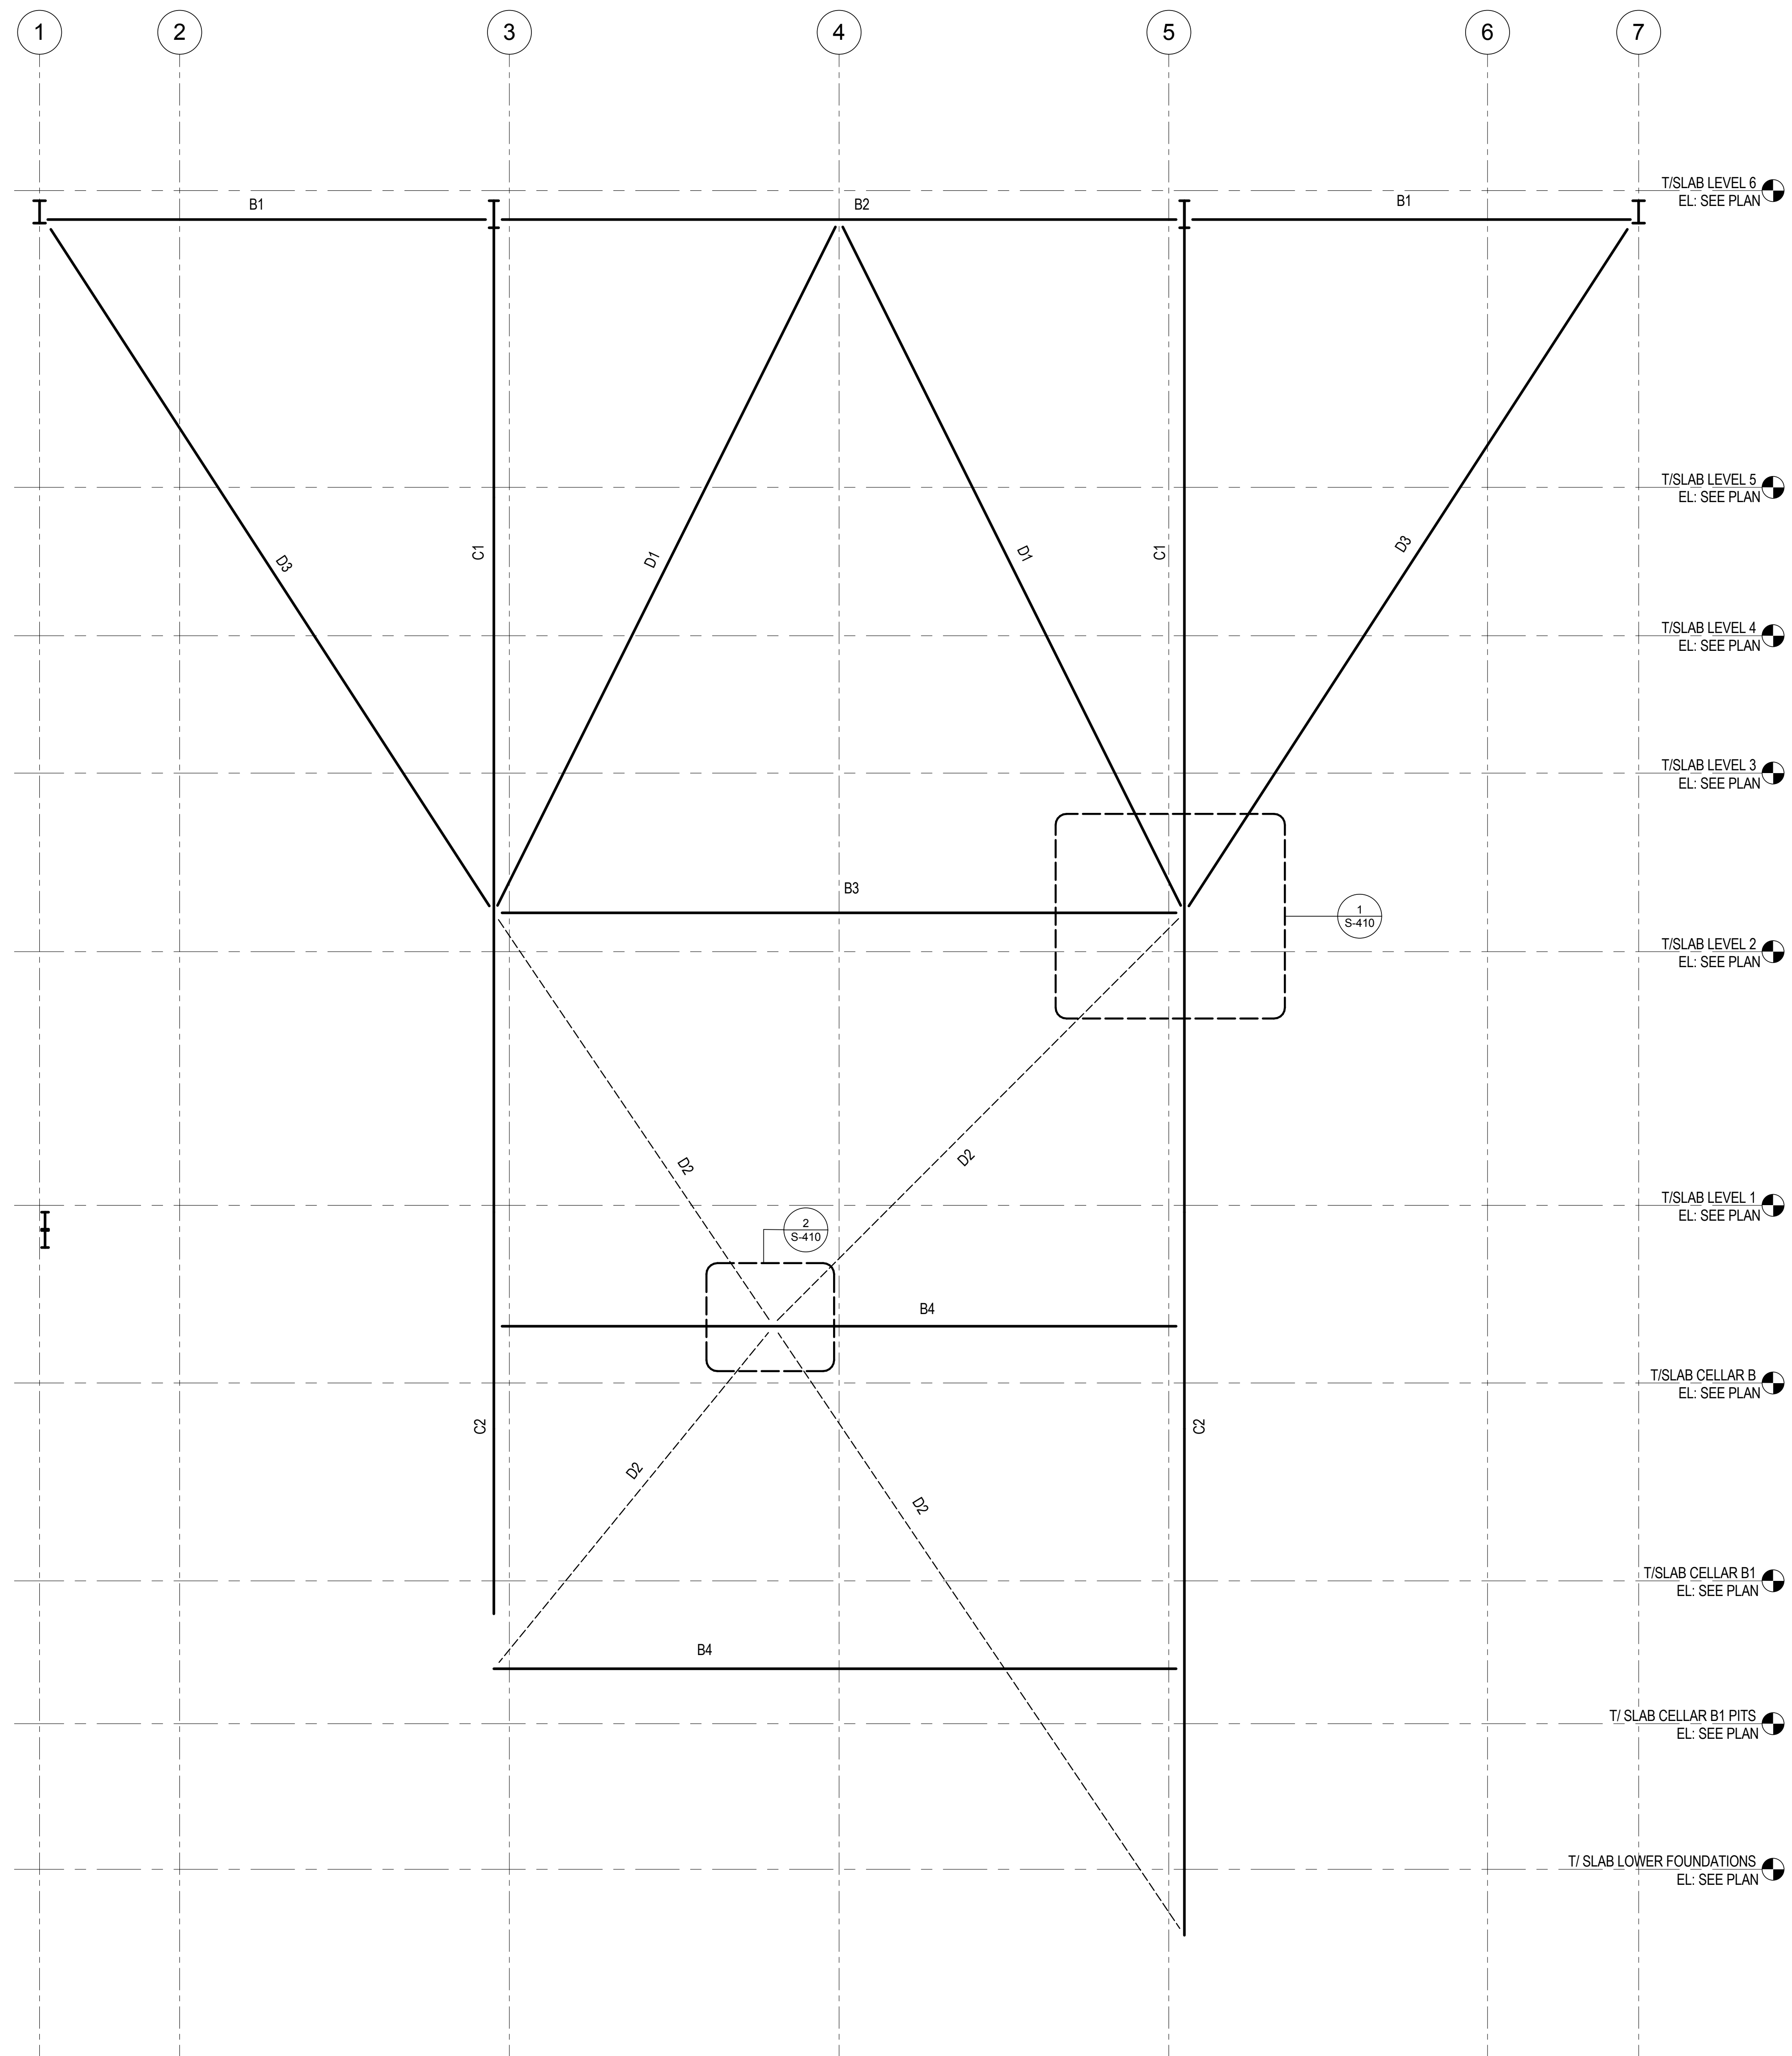

STEEL MEMBER SCHEDULE FOR KICKER COLUMN ASSEMBLY	
MARK	LINE C, D, E, F, G
B1	W36X852
B2	W36X852
B3	W14X550
B4	W14X109
B5	W14X311
D1	W12X336
D2	BU 36X12X4
D3	DPBOX 36X36X2-1/4X2-1/4
C1	W14X730
C2	W14X730

2 KEY SECTION AND SCHEDULE FOR KICKER COLUMN ASSEMBLY ALONG GRID LINES 'C' TO 'F'
NOT TO SCALE

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Key Plan:


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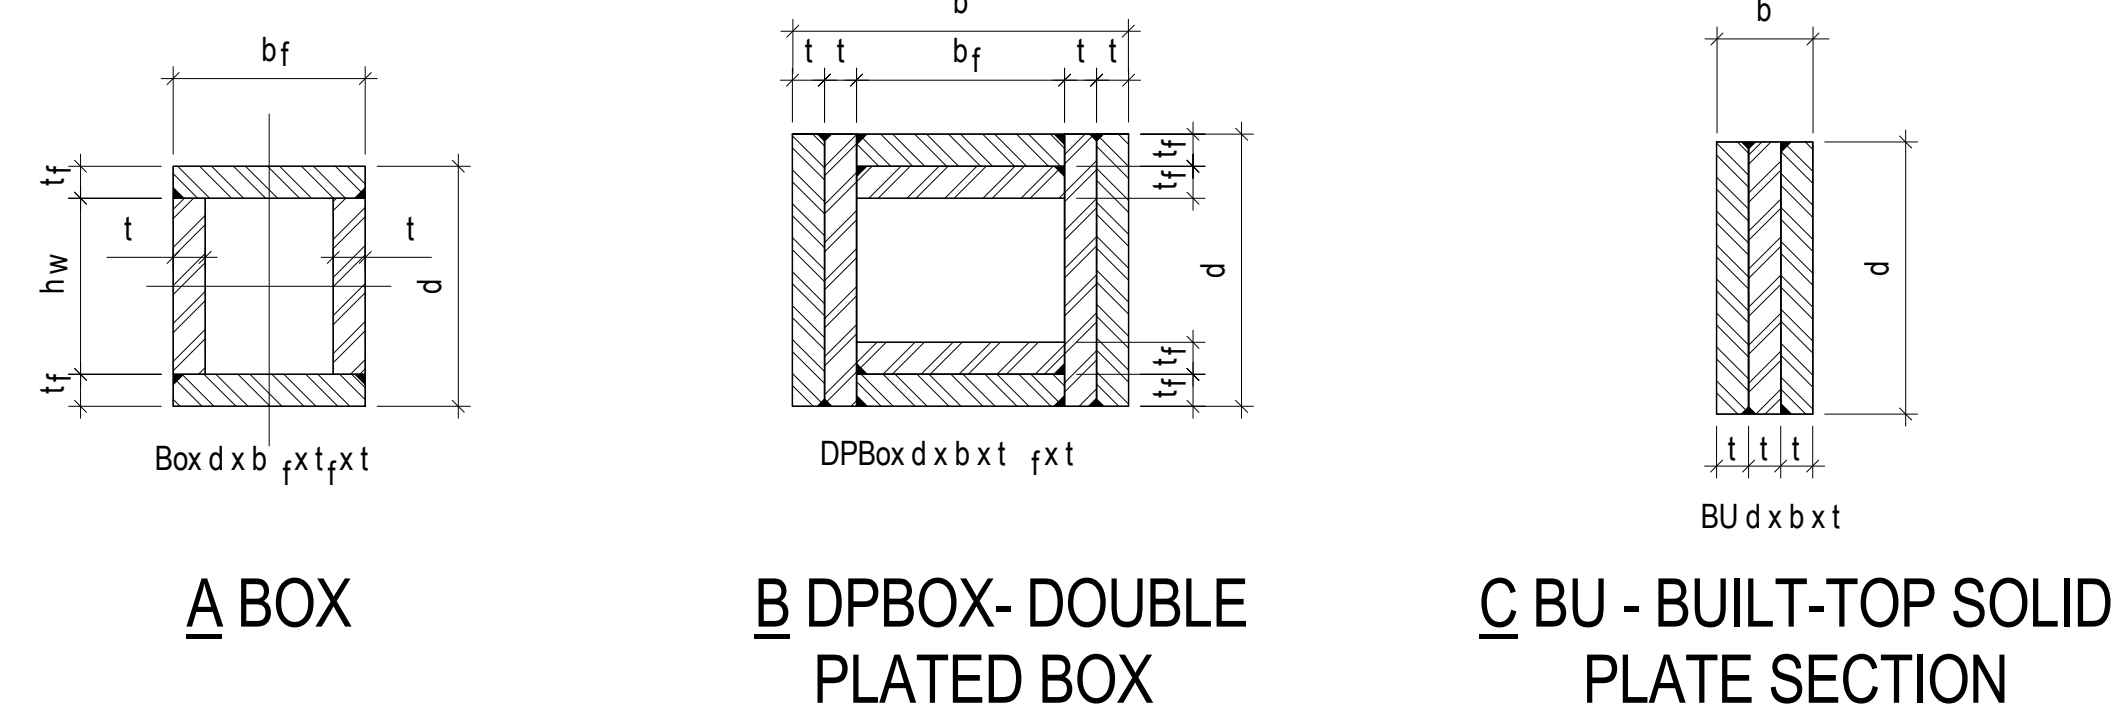
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2	12 JUL 2013	ISSUED FOR 60% DESIGN DEVELOPMENT
1	18 MAR 2012	ISSUED FOR RECONCILIATION

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Sheet Name: **KICKER COLUMNS AT CORE LINES C TO F - SCHEDULES, ELEVATIONS, SECTIONS & DETAILS**

Project No.: 211157	B-SCAN Sheet No.: S-405.00
Date: 20 JUN 2014	Sheet No.: S-405
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1 TYPICAL SECTION @ KICKERS THRU CORE WALL ALONG GRID LINE 'G' LOOKING EAST
NOT TO SCALE



NOMENCLATURE FOR BUILT-UP SECTIONS
1/2" = 1'-0"

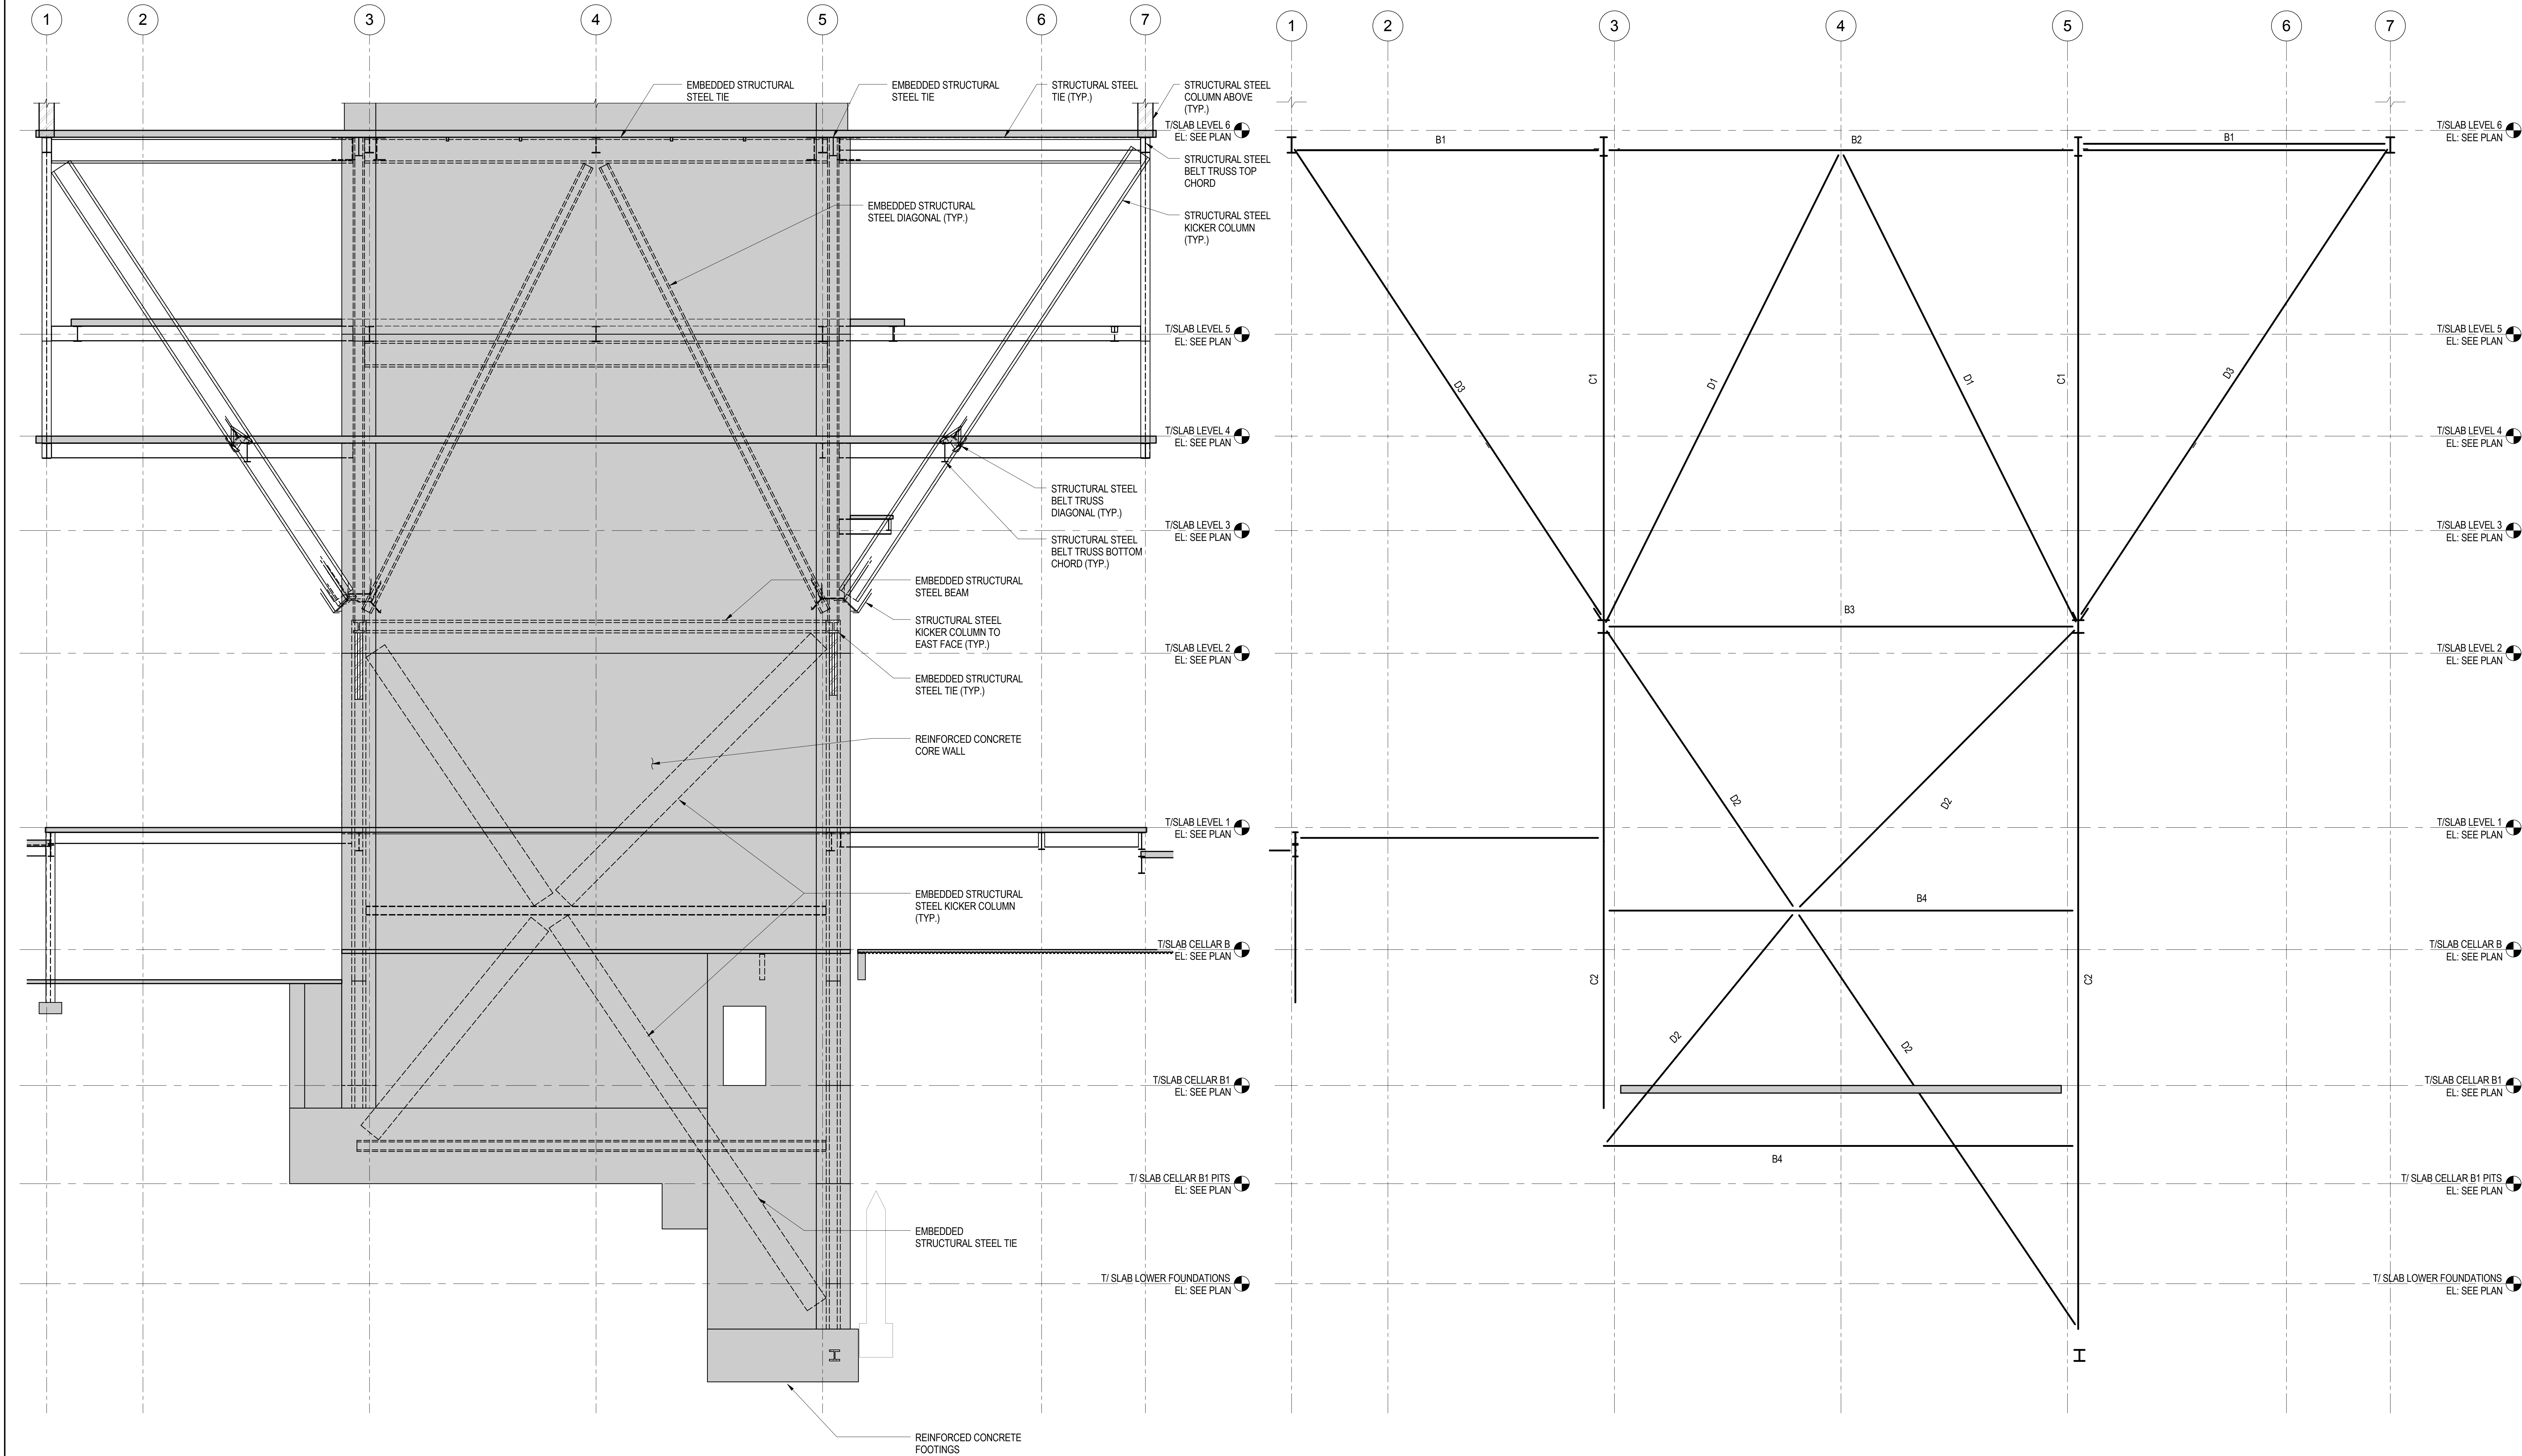STEEL MEMBER SCHEDULE FOR KICKER COLUMN ASSEMBLY	
MARK	LINE C, D, E, F, G
B1	W36X652
B2	W36X652
B3	W14X550
B4	W14X109
B5	W14X311
D1	W12X336
D2	BU 36X12X4
D3	DPBOX 36X36X2-1/4X2-1/4
C1	W14X730
C2	W14X730

2 KEY SECTION AND SCHEDULE FOR KICKER COLUMN ASSEMBLY ALONG LINE 'G'
1/8" = 1'-0"

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Cerami & Associates
404 Fifth Avenue #8, New York, NY 10016

Vibration Consultant
Wilson, Uhrig & Associates, Inc.
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Code Consultant
Code Consultants Professional Engineers PC
215 West 40th Street, 15th Floor, New York, NY 10018

Facade Maintenance Consultant
Entek Engineering LLC
166 Ames Street, Hackensack, NJ 07601

Wind Tunnel Consultant
Rowan Williams Davies & Irwin Inc.
680 Woodlawn Road West, Guelph
Ontario, Canada N1K 1B8


Key Plan:

Seal & Signature:


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NOT FOR CONSTRUCTION

**KICKER
COLUMNS AT
CORE LINE G -
SCHEDULES,
ELEVATIONS,
SECTIONS &
DETAILS**


Project No.: 211157	B-SCAN Sheet No.: S-406.00
Date: 20 JUN 2014	Sheet No.: S-406
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File No.: S-406	

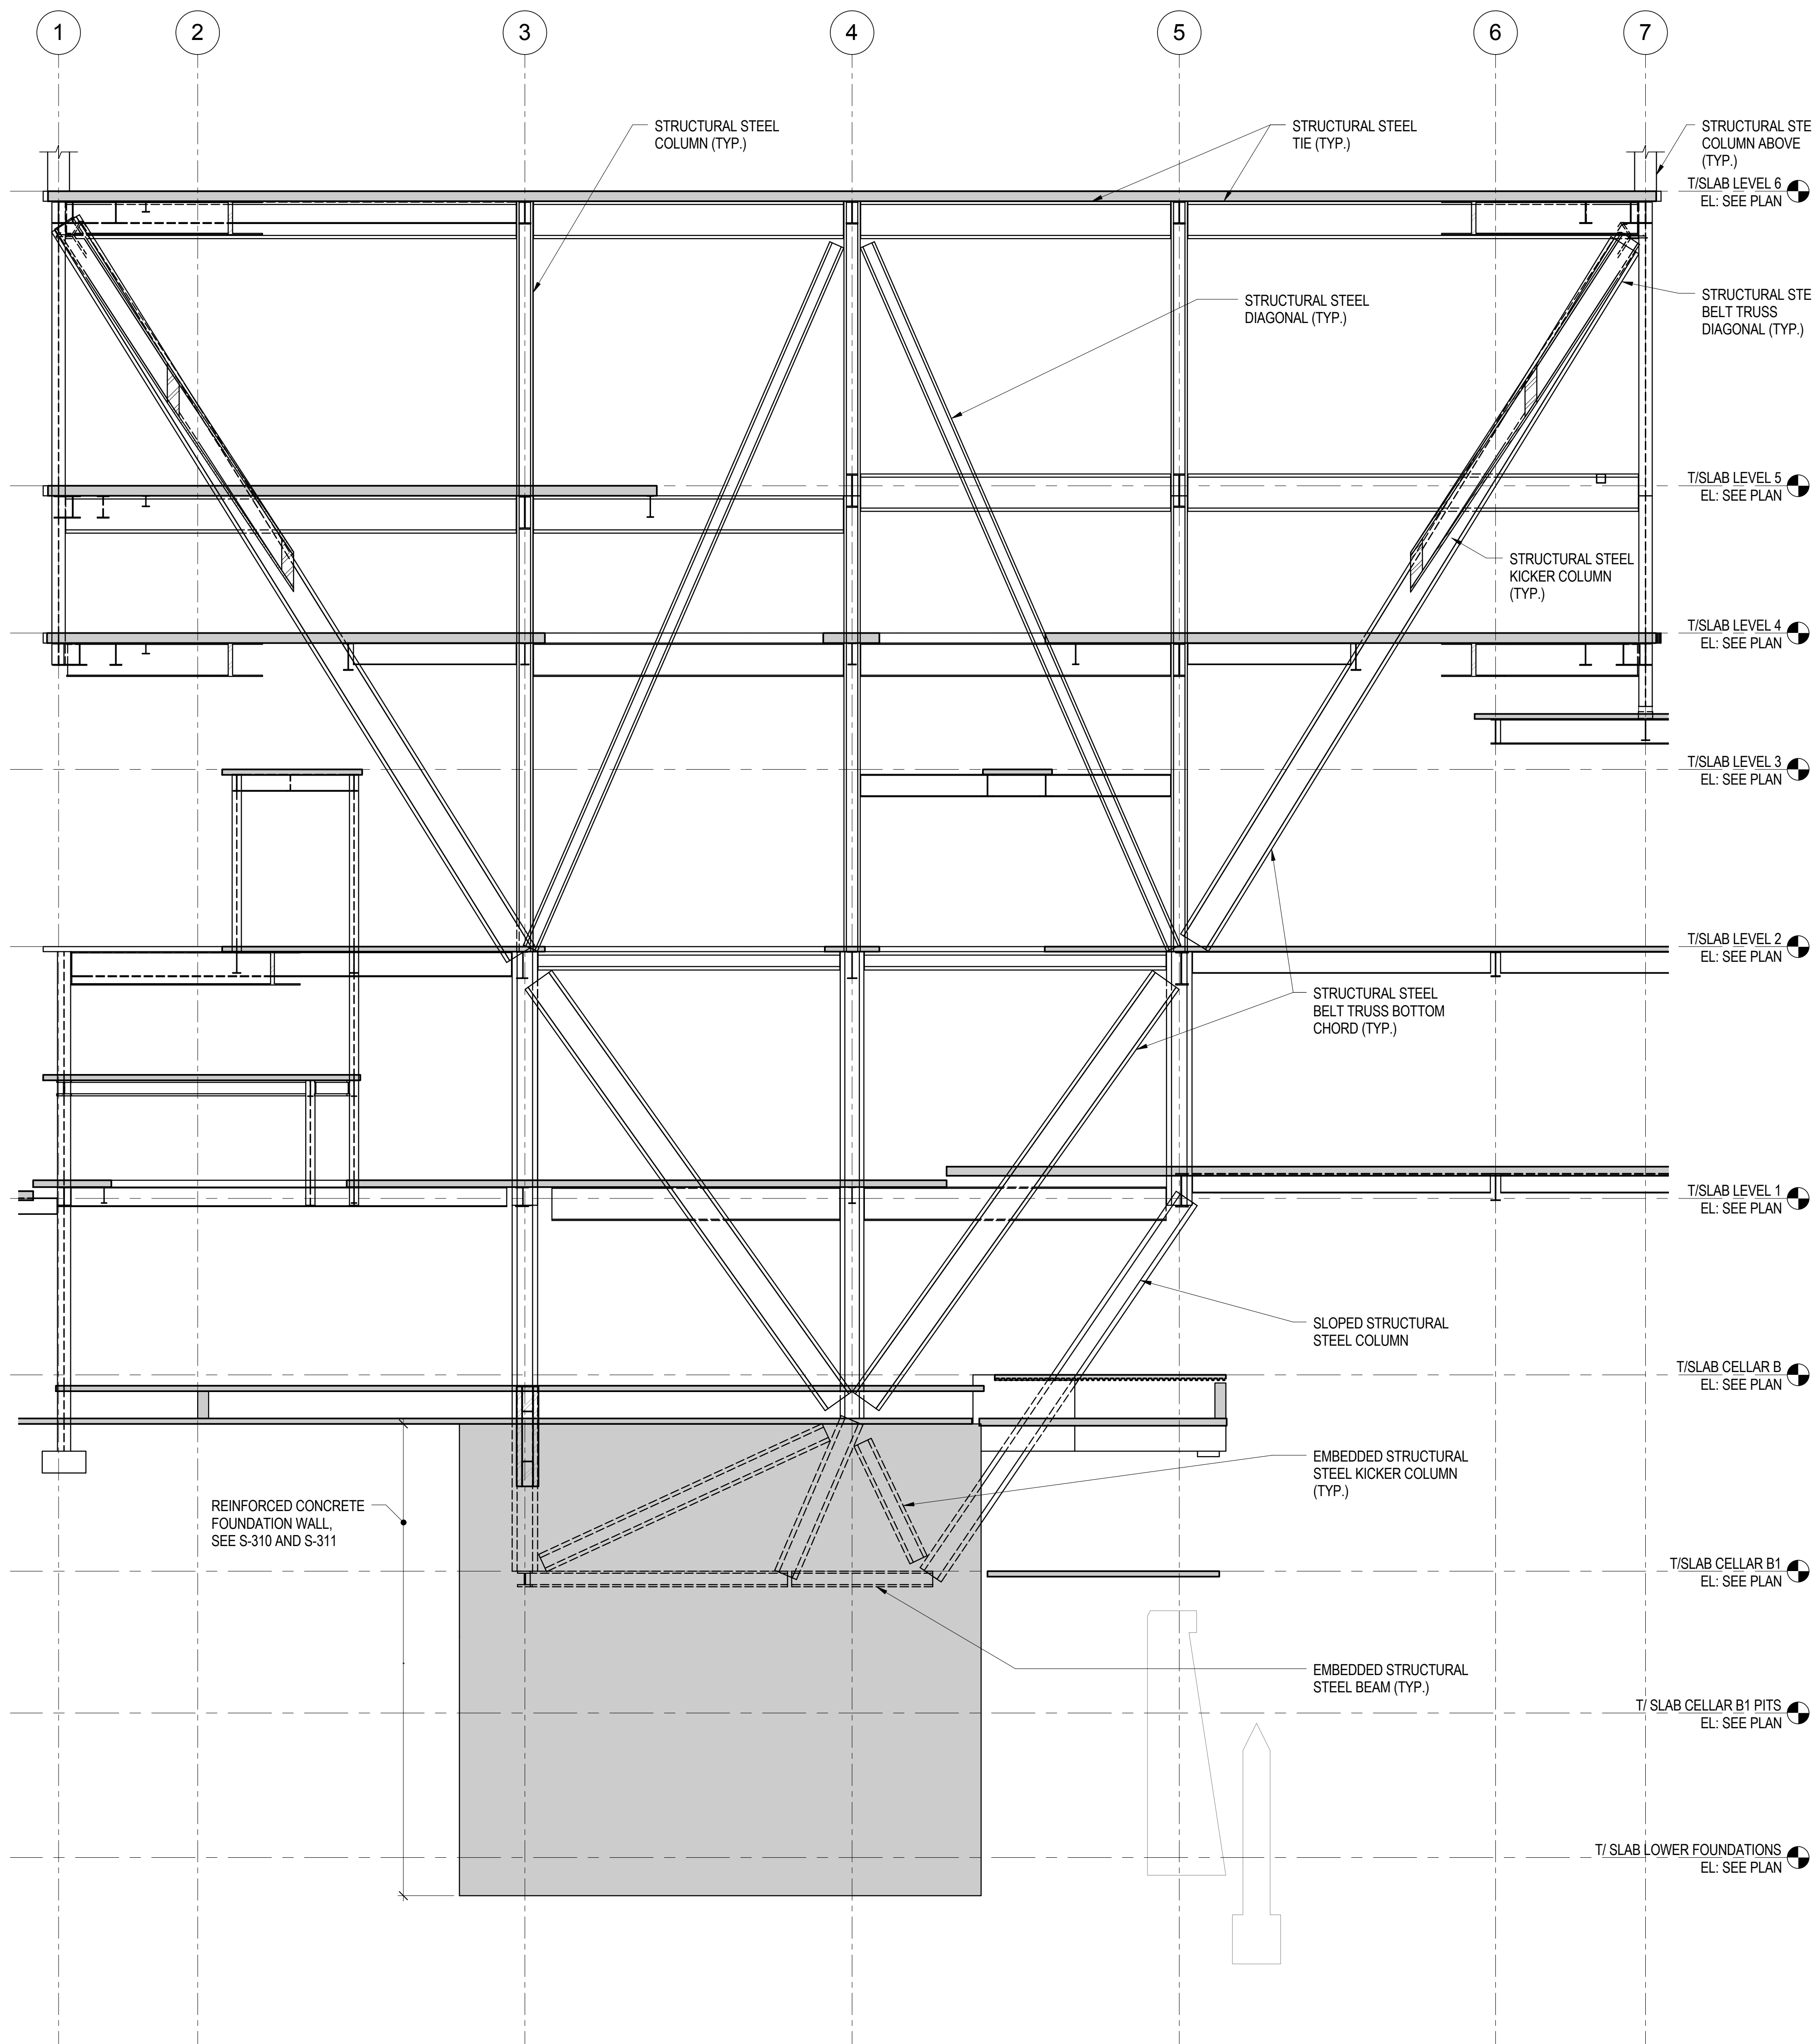

1 TYP SECTION @ LINE B KICKER COLUMN ASSEMBLY LOOKING EAST
1/8" = 1'-0"

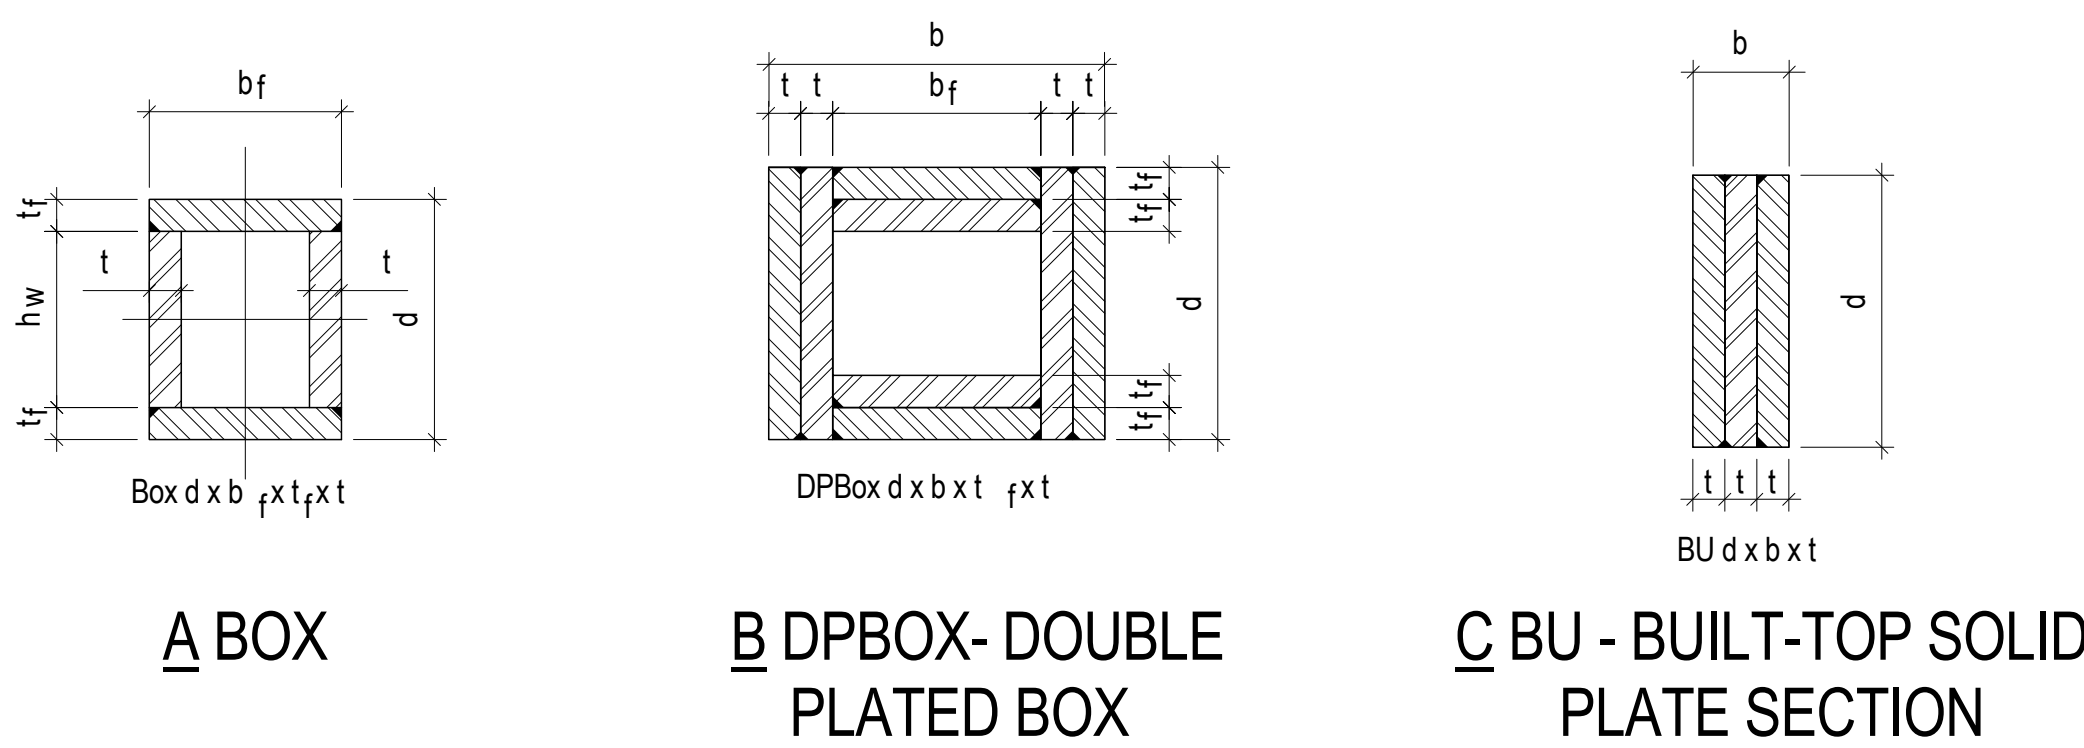

NOMENCLATURE FOR BUILT-UP SECTIONS
1/2" = 1'-0"

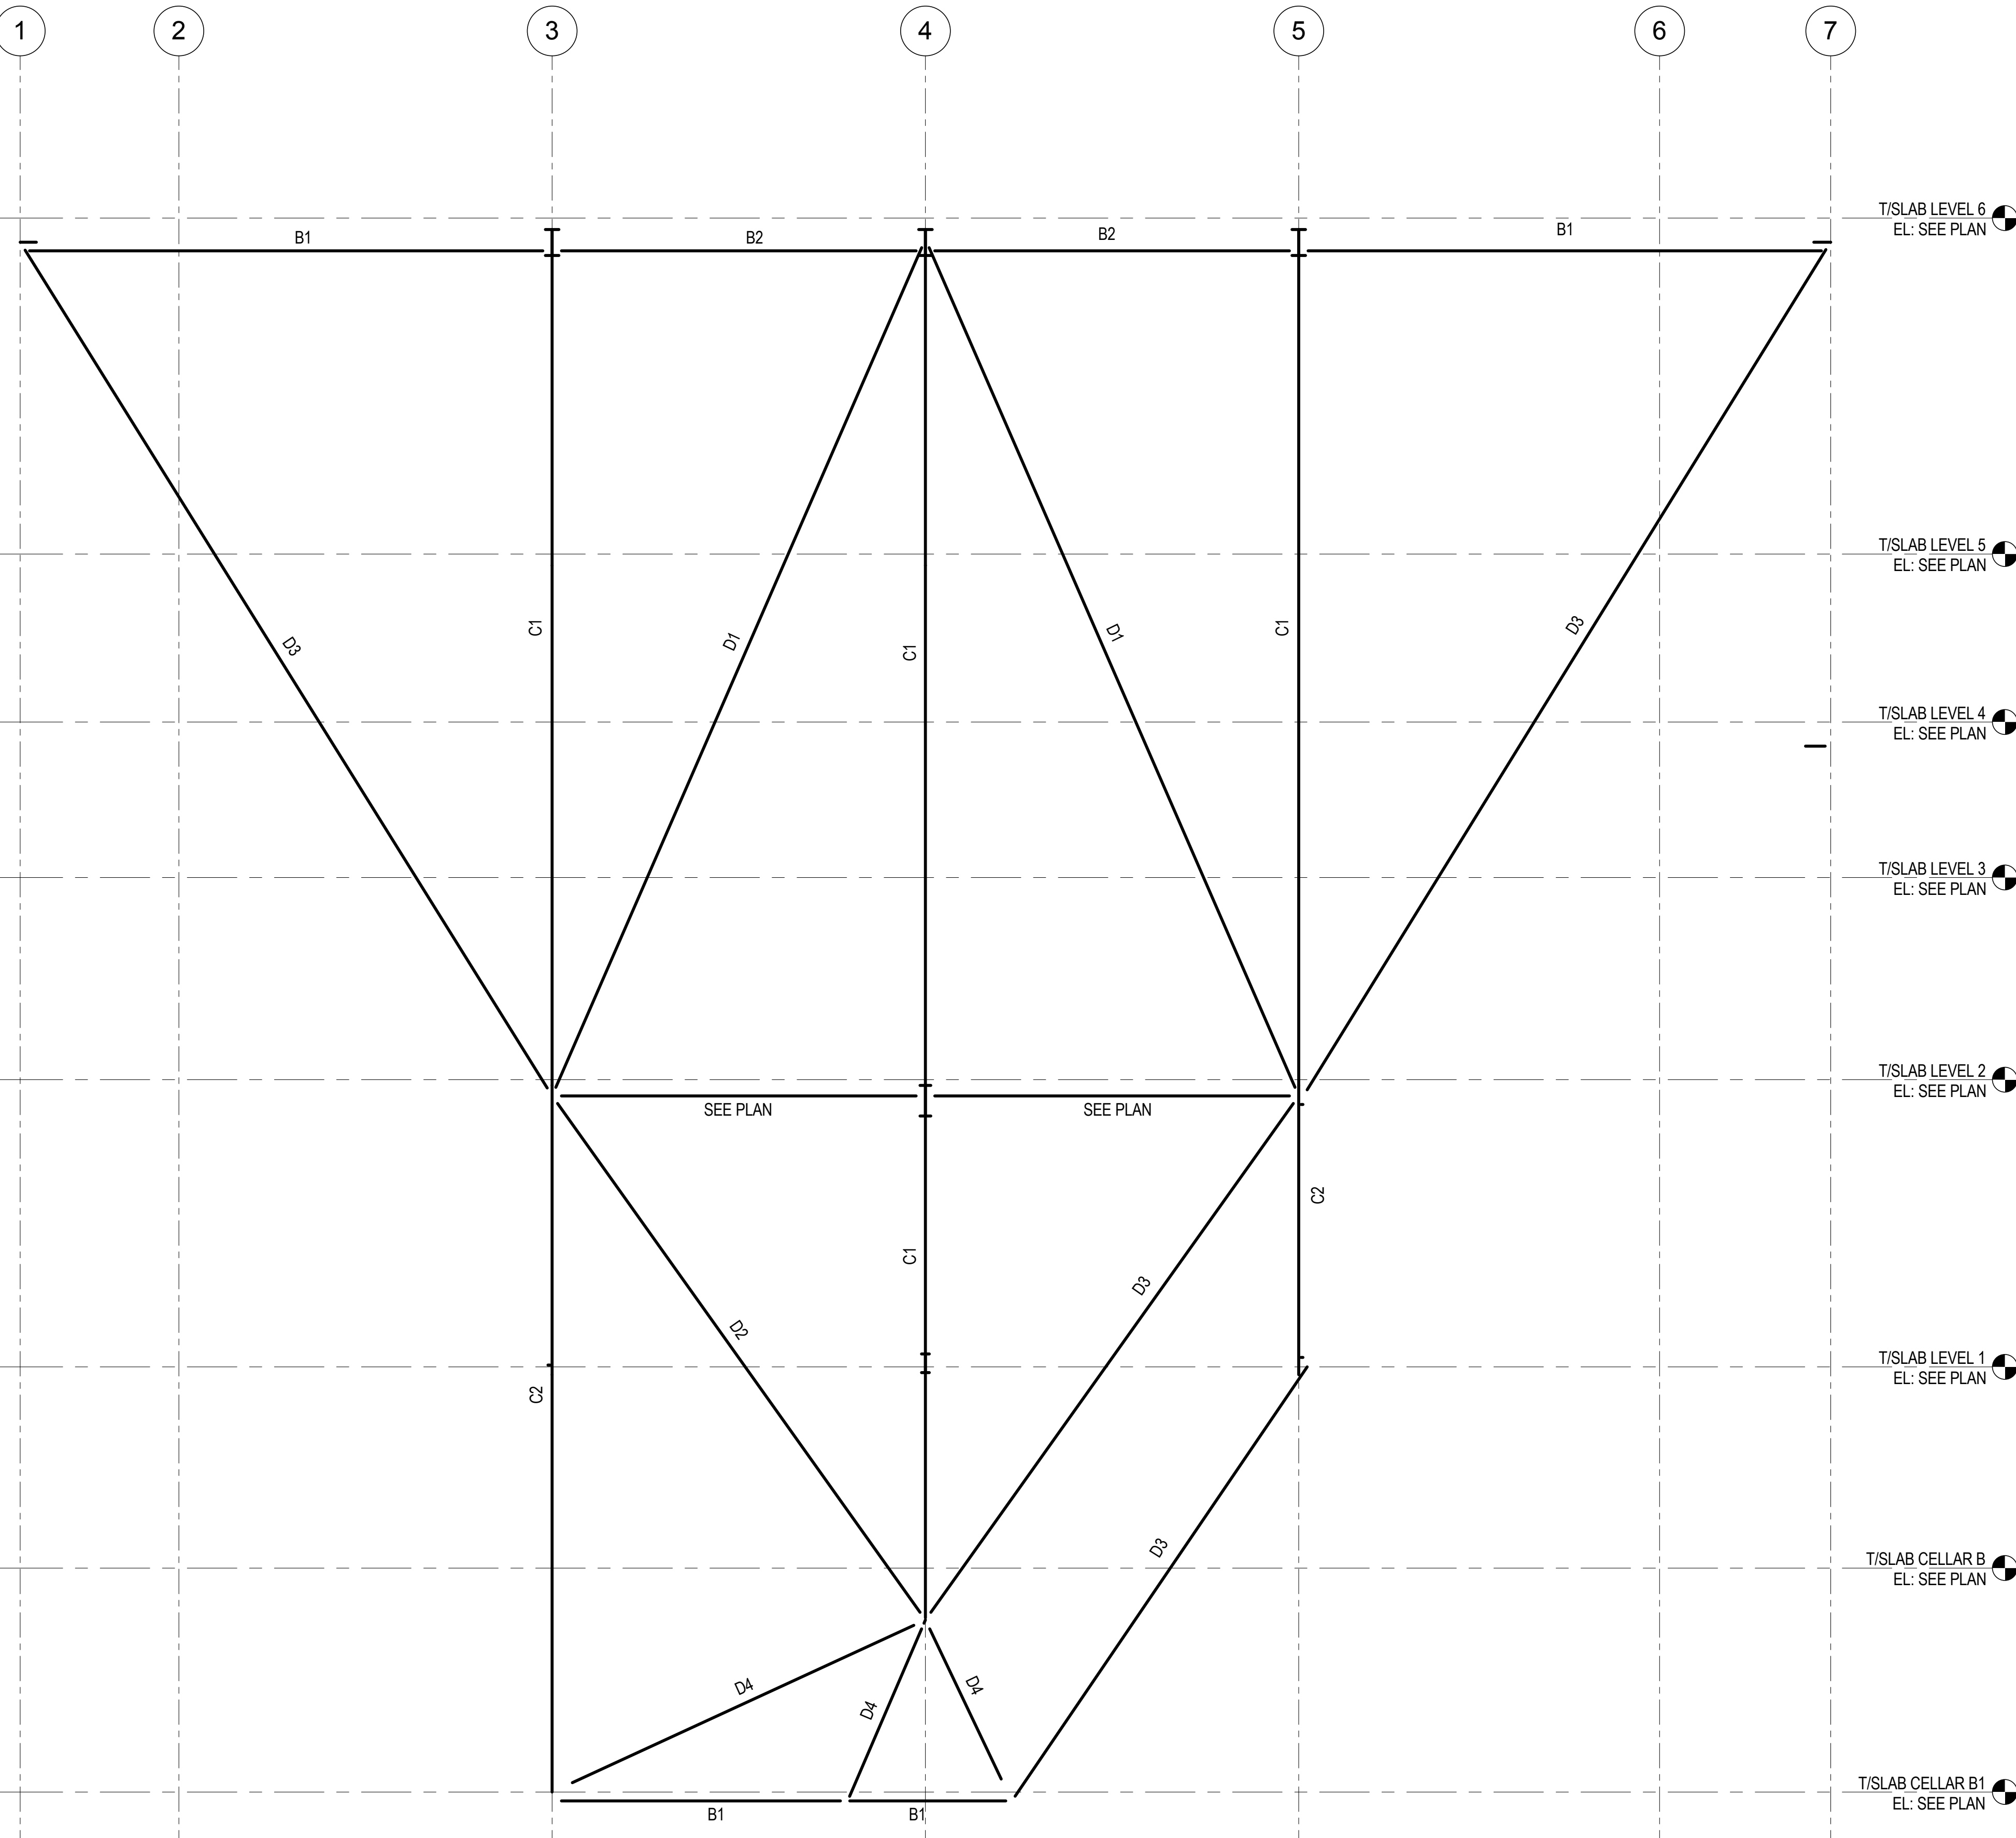

STEEL MEMBER SCHEDULE	
MARK	SECTION
B1	W14X311
B2	W36X552
C1	W14X370
C2	BOX 28X26X5.5X3.75
D1	W14X283
D2	BU 36X12X4
D3	DPBU 36X36X2 1/4X2 1/4
D4	W14X605

2 KEY SECTION AND SCHEDULE FOR KICKER COLUMN ASSEMBLY
NOT TO SCALE

**MANHATTAN WEST:
NORTH TOWER**
375 Ninth Avenue, New York, NY 10001
Client

Brookfield
Brookfield Place
250 Vesey Street, 15th Floor, New York, NY 10021

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SOM
Skidmore, Owings & Merrill LLP
14 Wall Street, New York, NY 10005

Civil Engineering
Philip Habib & Associates
102 Madison Avenue #11, New York, NY 10016

MEP Engineering
Jaros Baum & Bolles
80 Pine Street, New York, NY 10005

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Edgett Williams Consulting Group, Inc.
102 East Bluffside Ave., Suite 1, Mill Valley, California 94941

Sustainable Design
Viridian Energy & Environmental
50 Washington Street, Newark, CT 06854

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Mueser Rutledge Consulting Engineers
14 Penn Plaza, 225 W. 34th Street #610,
New York, NY 10022

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Field Operations
475 10th Avenue, New York, NY 10018

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Ducibella, Ventor & Santore
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Rowan Williams Davies & Irwin Inc.
680 Woodlawn Road West, Guelph
Ontario, Canada N1K 1B8

Key Plan:

Seal & Signature:


PRELIMINARY
NOT FOR CONSTRUCTION

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5	20 JUN 2014	ISSUED FOR FOUNDATION PERMIT
4	20 DEC 2013	ISSUED FOR FOUNDATION PERMIT
3	15 NOV 2013	ISSUED FOR 90% DESIGN DEVELOPMENT
2	12 JUL 2013	ISSUED FOR 90% DESIGN DEVELOPMENT
1	19 MAR 2012	ISSUED FOR RECONCILIATION


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Sheet Name: **KICKER COLUMN
AT LINE B -
SCHEDULE,
ELEVATIONS,
SECTIONS &
DETAILS**


Project No.: 211157	B-SCAN Sheet No.: S-408.00
Date: 20 JUN 2014	Sheet No.: S-408
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1 SECTION @ LINE 'A' BELOW LEVEL 6 LOOKING EAST
1/8" = 1'-0"

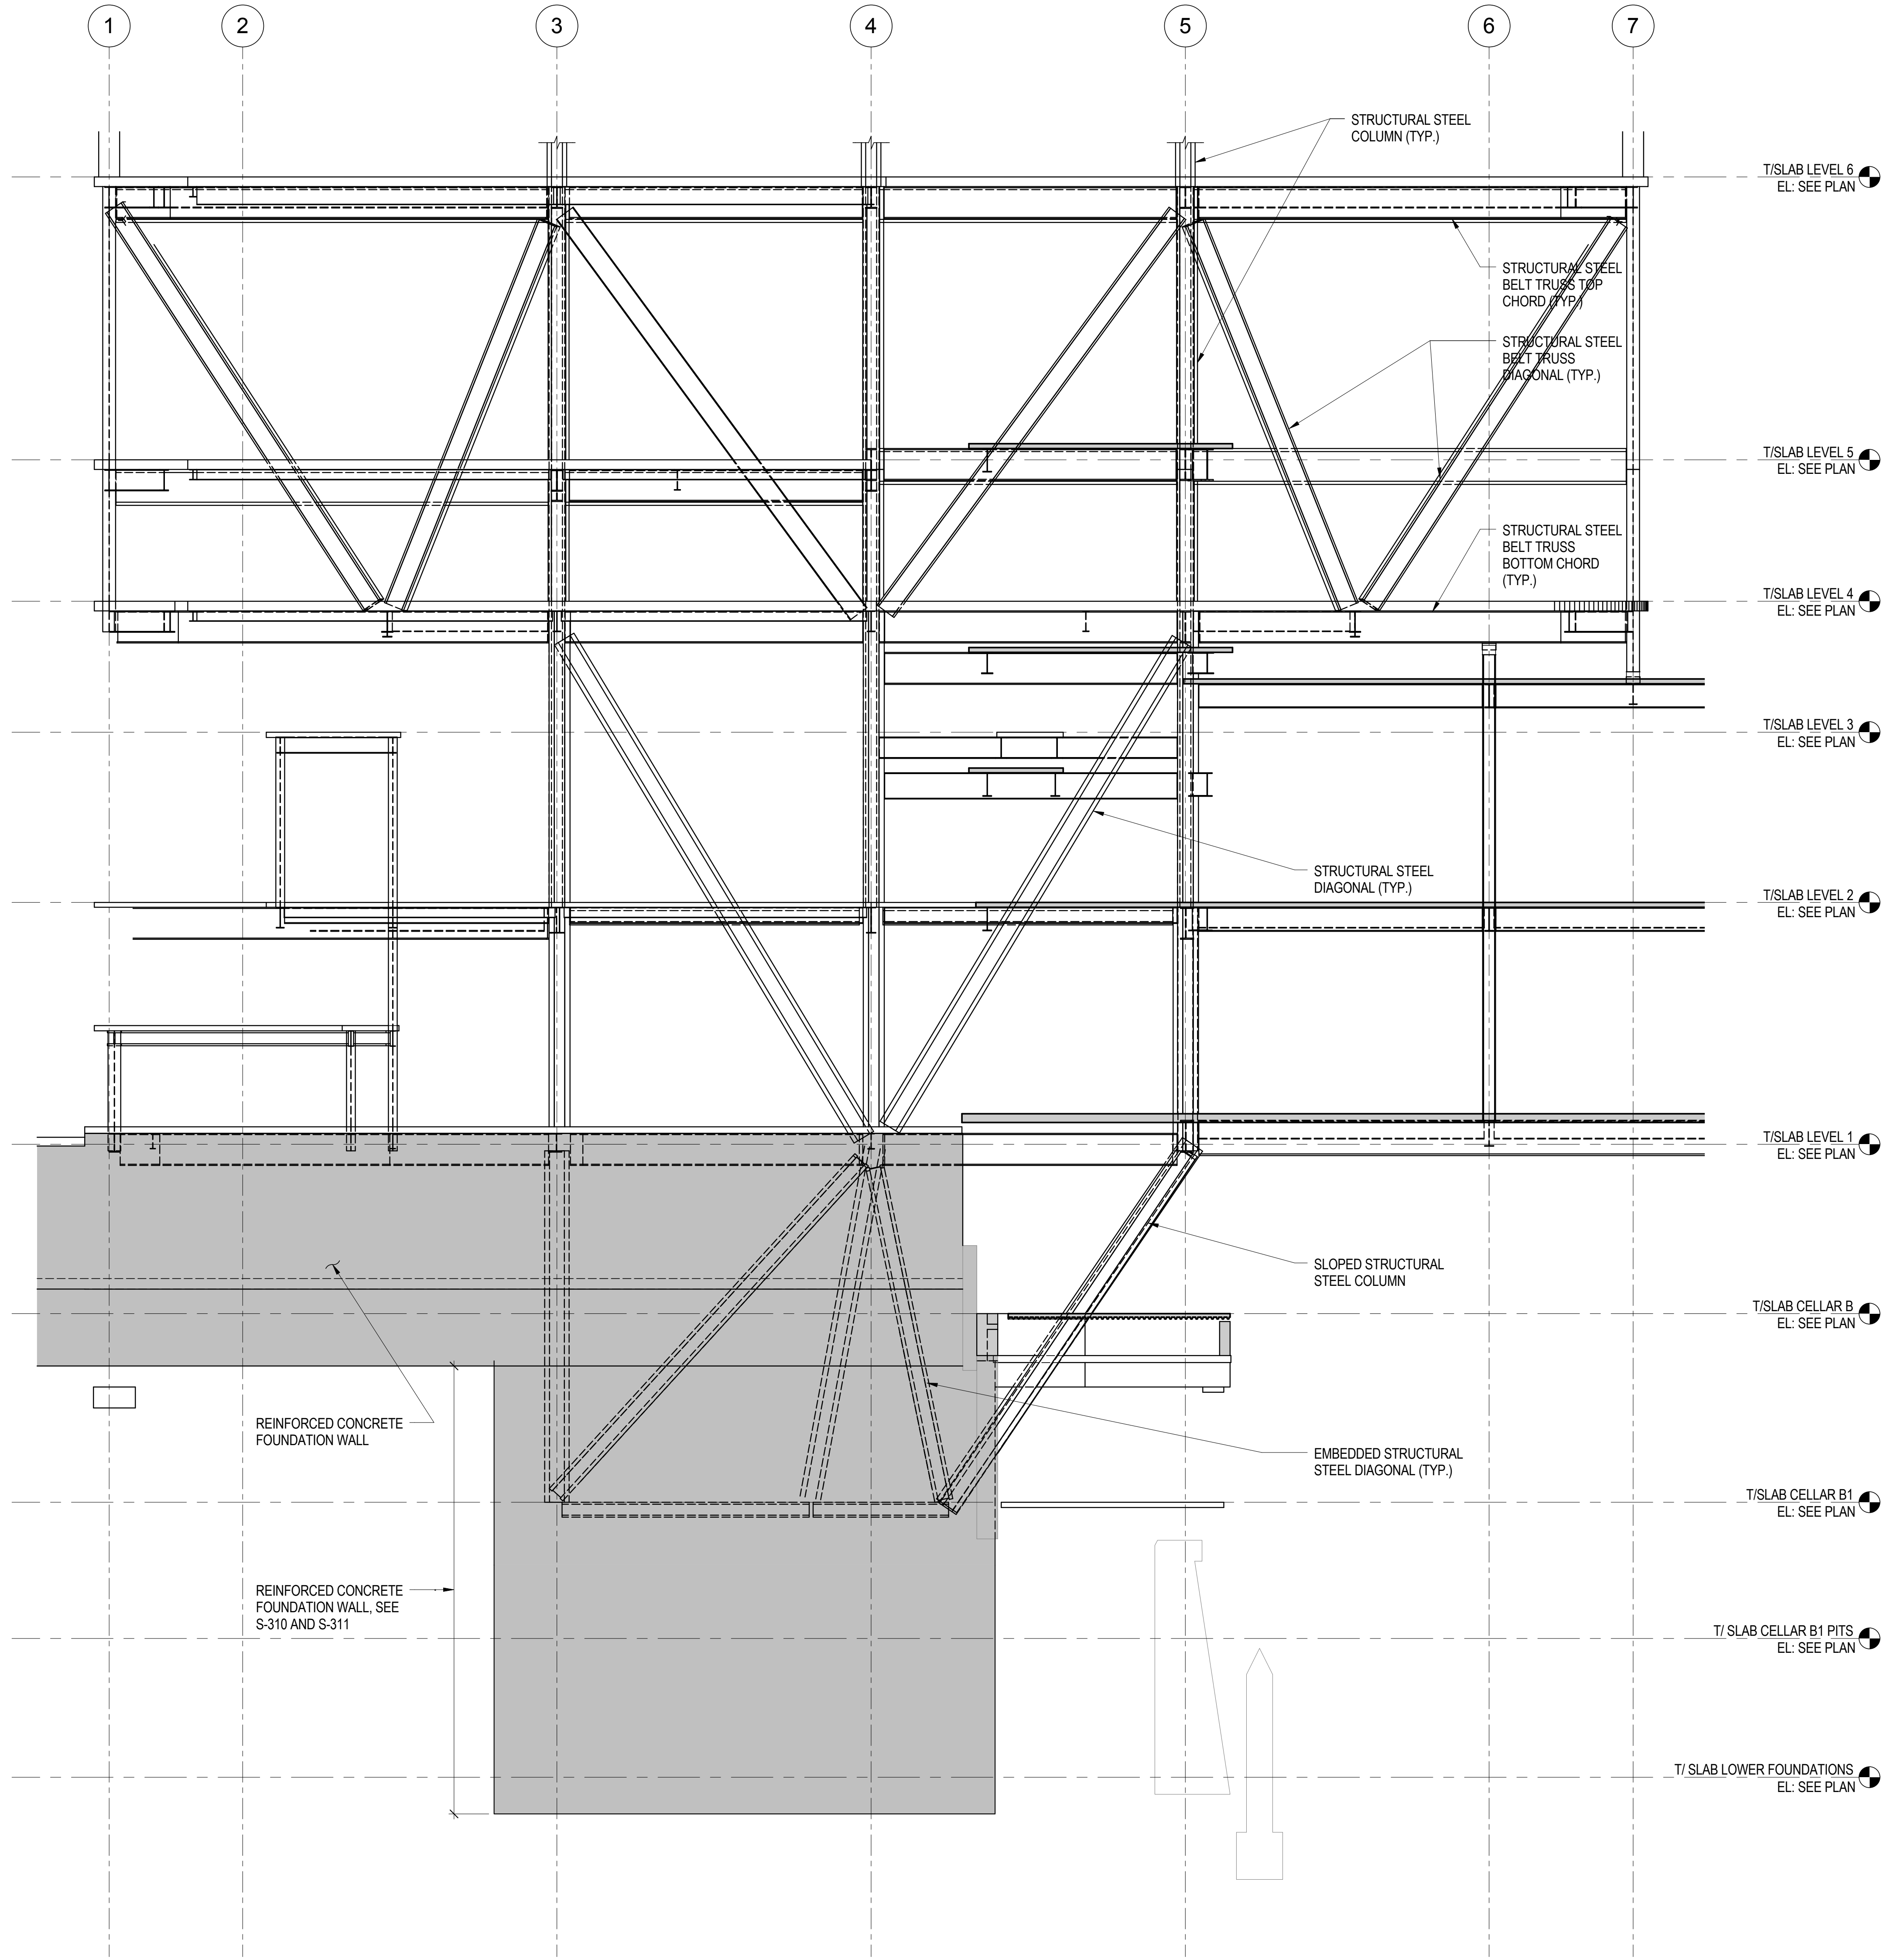

NOMENCLATURE FOR BUILT-UP SECTIONS
1/2" = 1'-0"

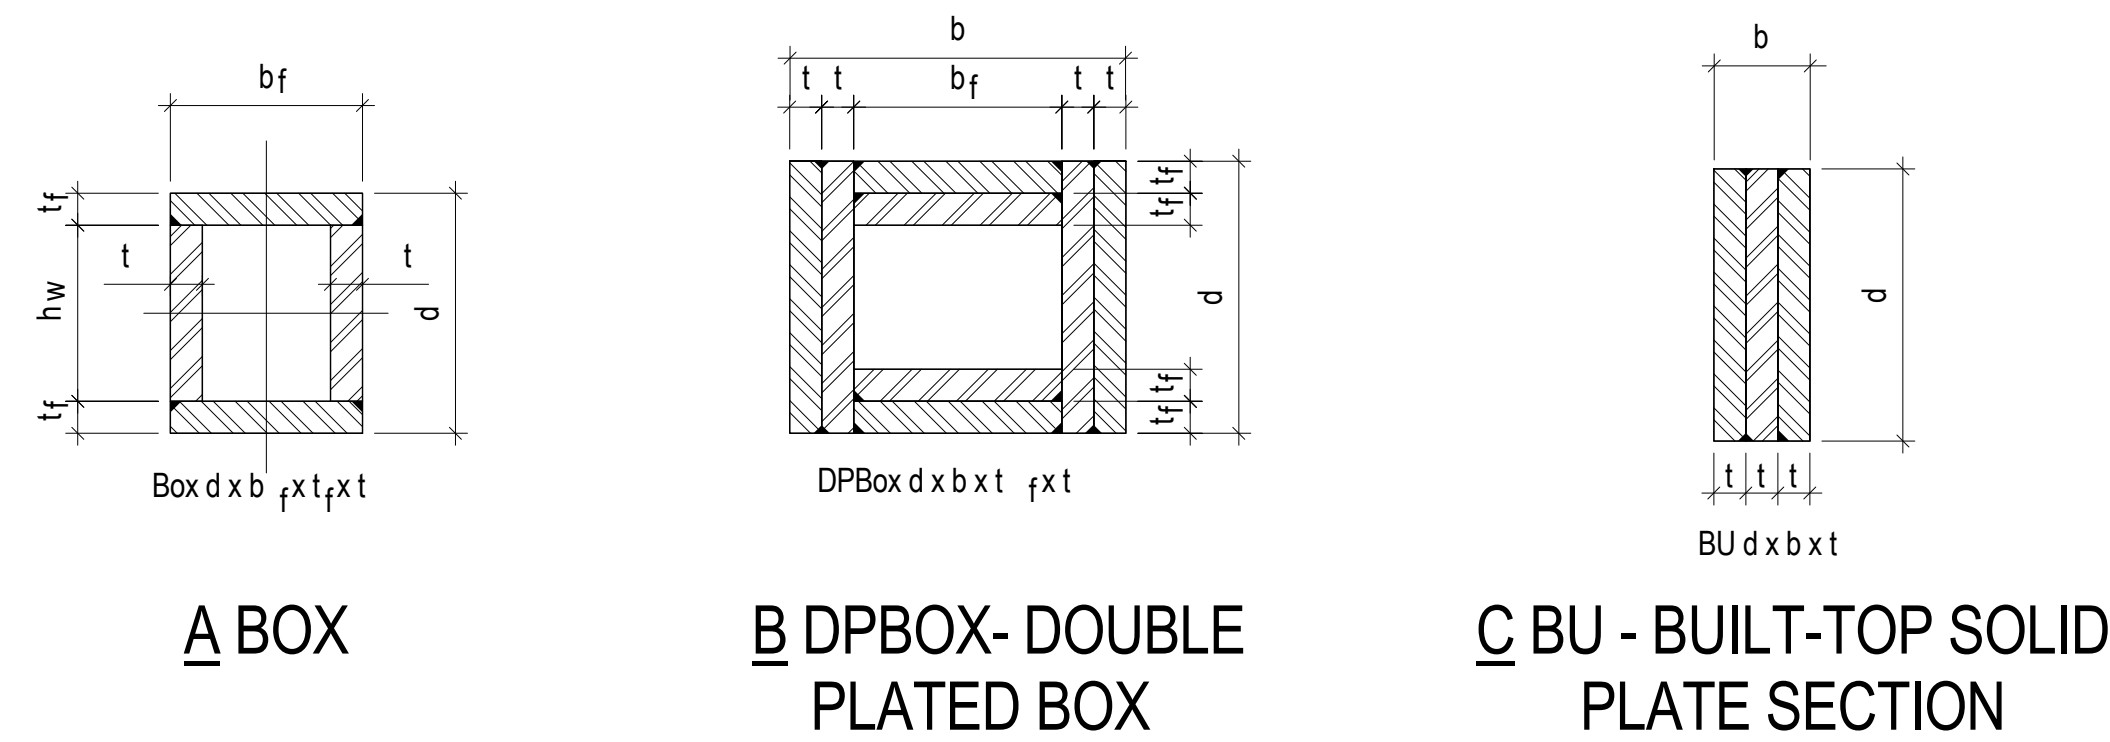

STEEL MEMBER SCHEDULE	
MARK	SECTION
B1	W24X76
B2	W24X76
B3	W14X311
D1	BU 26X24X3.5
D2	DP BOX 24X24X3X3
D3	W14X605
C1	DP BOX 24X24X3X3
C2	BOX 24X24X3.75X3.75
C3	DP BOX 24X24X2.375X2.375

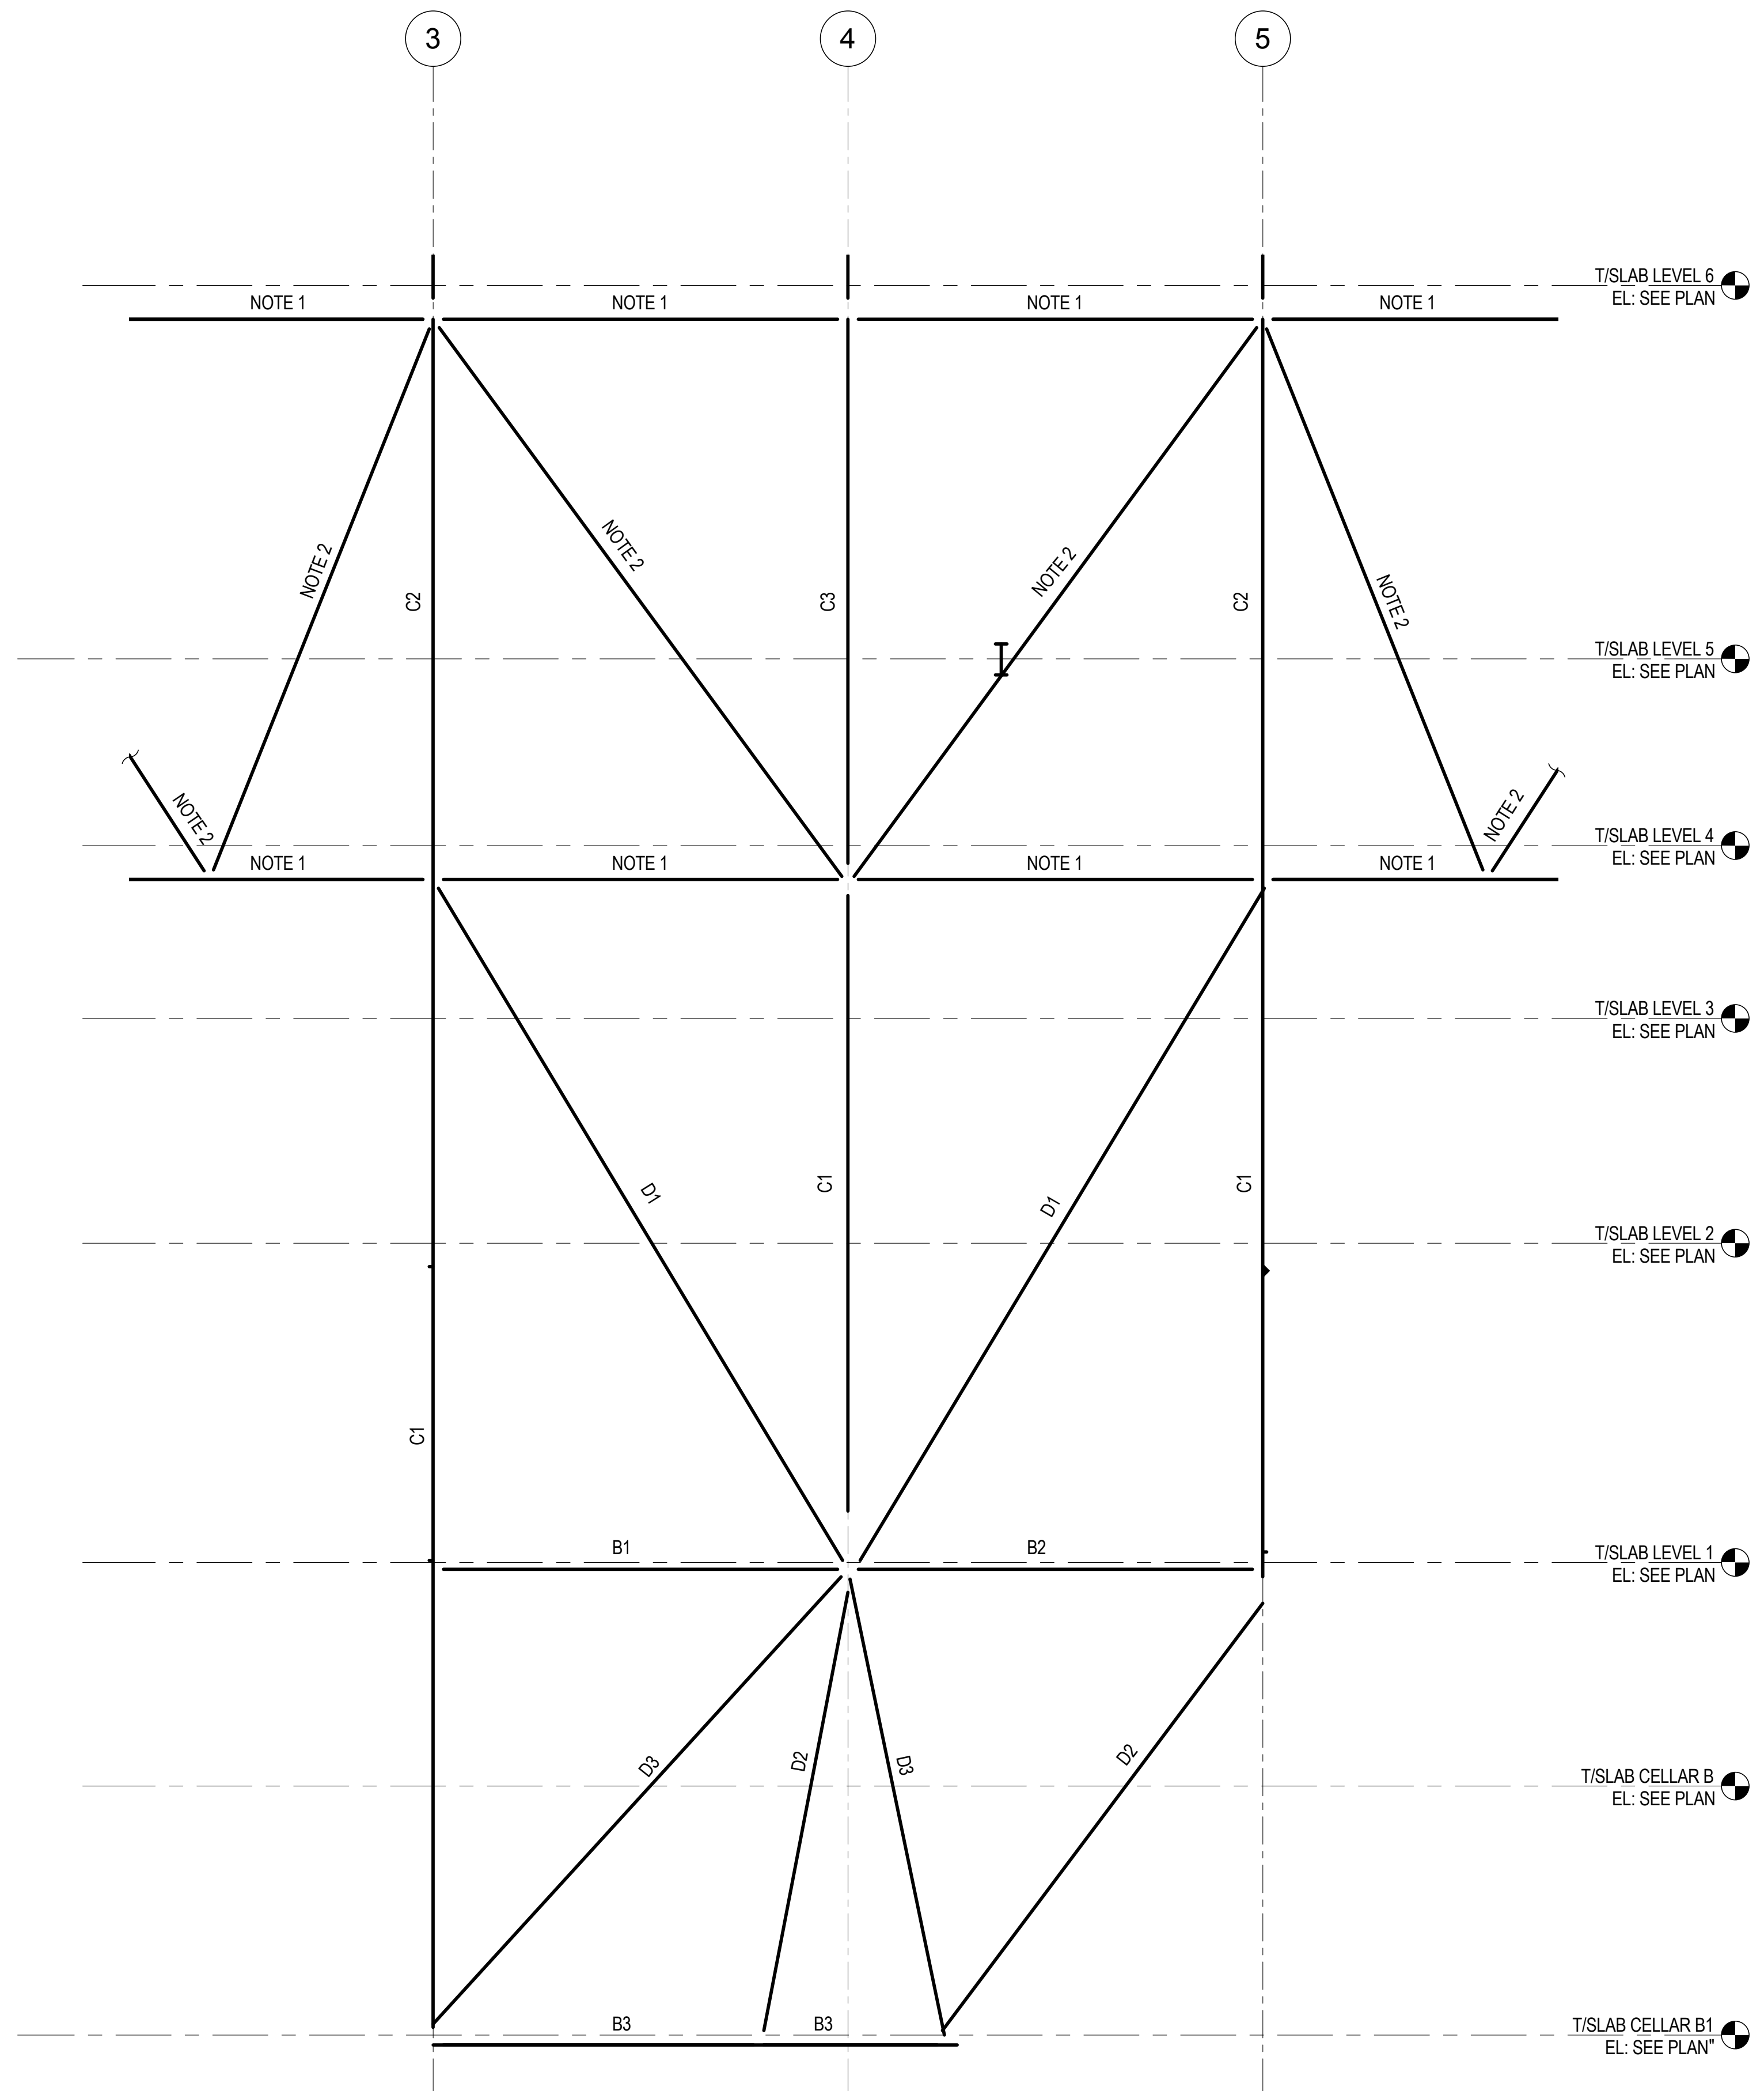NOTES:
1. BELT TRUSS CHORD MEMBER SEE S-415.
2. BELT TRUSS DIAGONAL MEMBER SEE S-415.

2 KEY SECTION AND SCHEDULE AT LINE 'A' BELOW LEVEL 6
NOT TO SCALE



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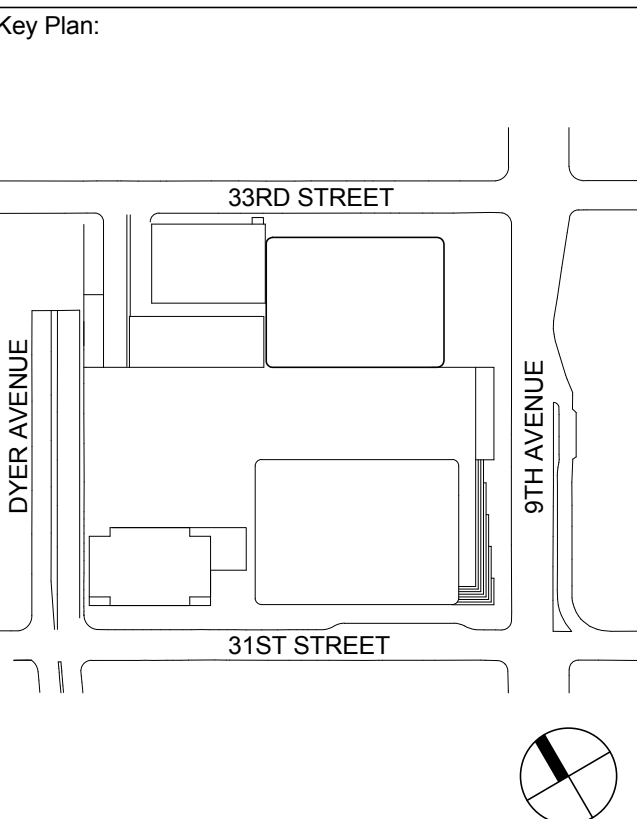
Acoustical Consultant
Cerami & Associates
404 Fifth Avenue #8, New York, NY 10016

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Ontario, Canada N1K 1B6



Seal & Signature

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2	12 JUL 2013	ISSUED FOR 60% DESIGN DEVELOPMENT
1	18 MAR 2012	ISSUED FOR RECONCILIATION

No.	Date	Description
Sheet Name		

**COLUMNS &
DIAGONALS ON
LINE A BELOW
LEVEL 6 -
SECTIONS &
DETAILS**

Project No.: 211157	B-SCAN Sheet No.: S-409.00
Date: 20 JUN 2014	Sheet No.: S-409
Scale: As indicated	Page No.: 81 of 90
File No.: S-409	



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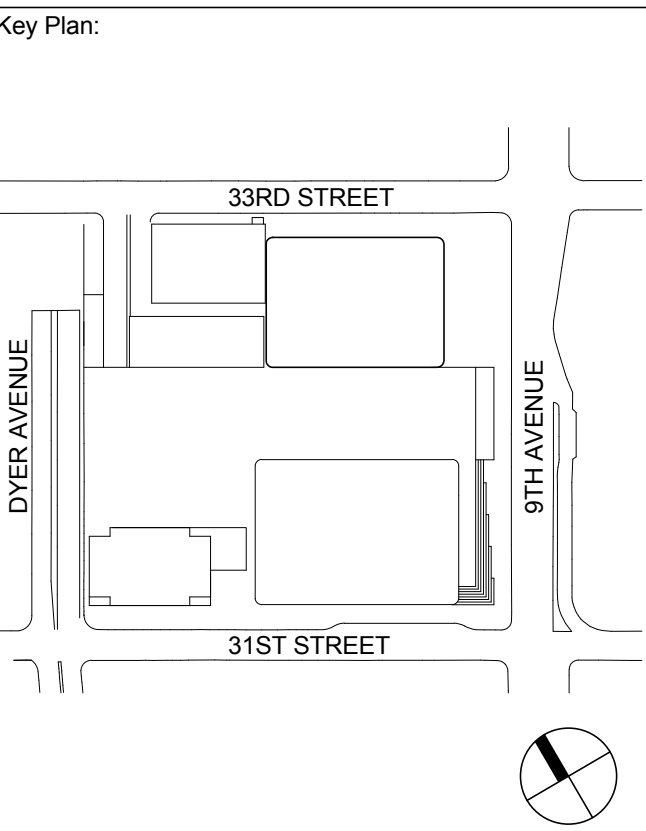
Acoustical Consultant
Cerami & Associates
404 Fifth Avenue #8, New York, NY 10016

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65 Broadway, Suite 401, New York, NY 10006

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Rowan Williams Davies & Irwin Inc.
650 Woodlawn Road West, Guelph
Ontario, Canada N1K 1B6



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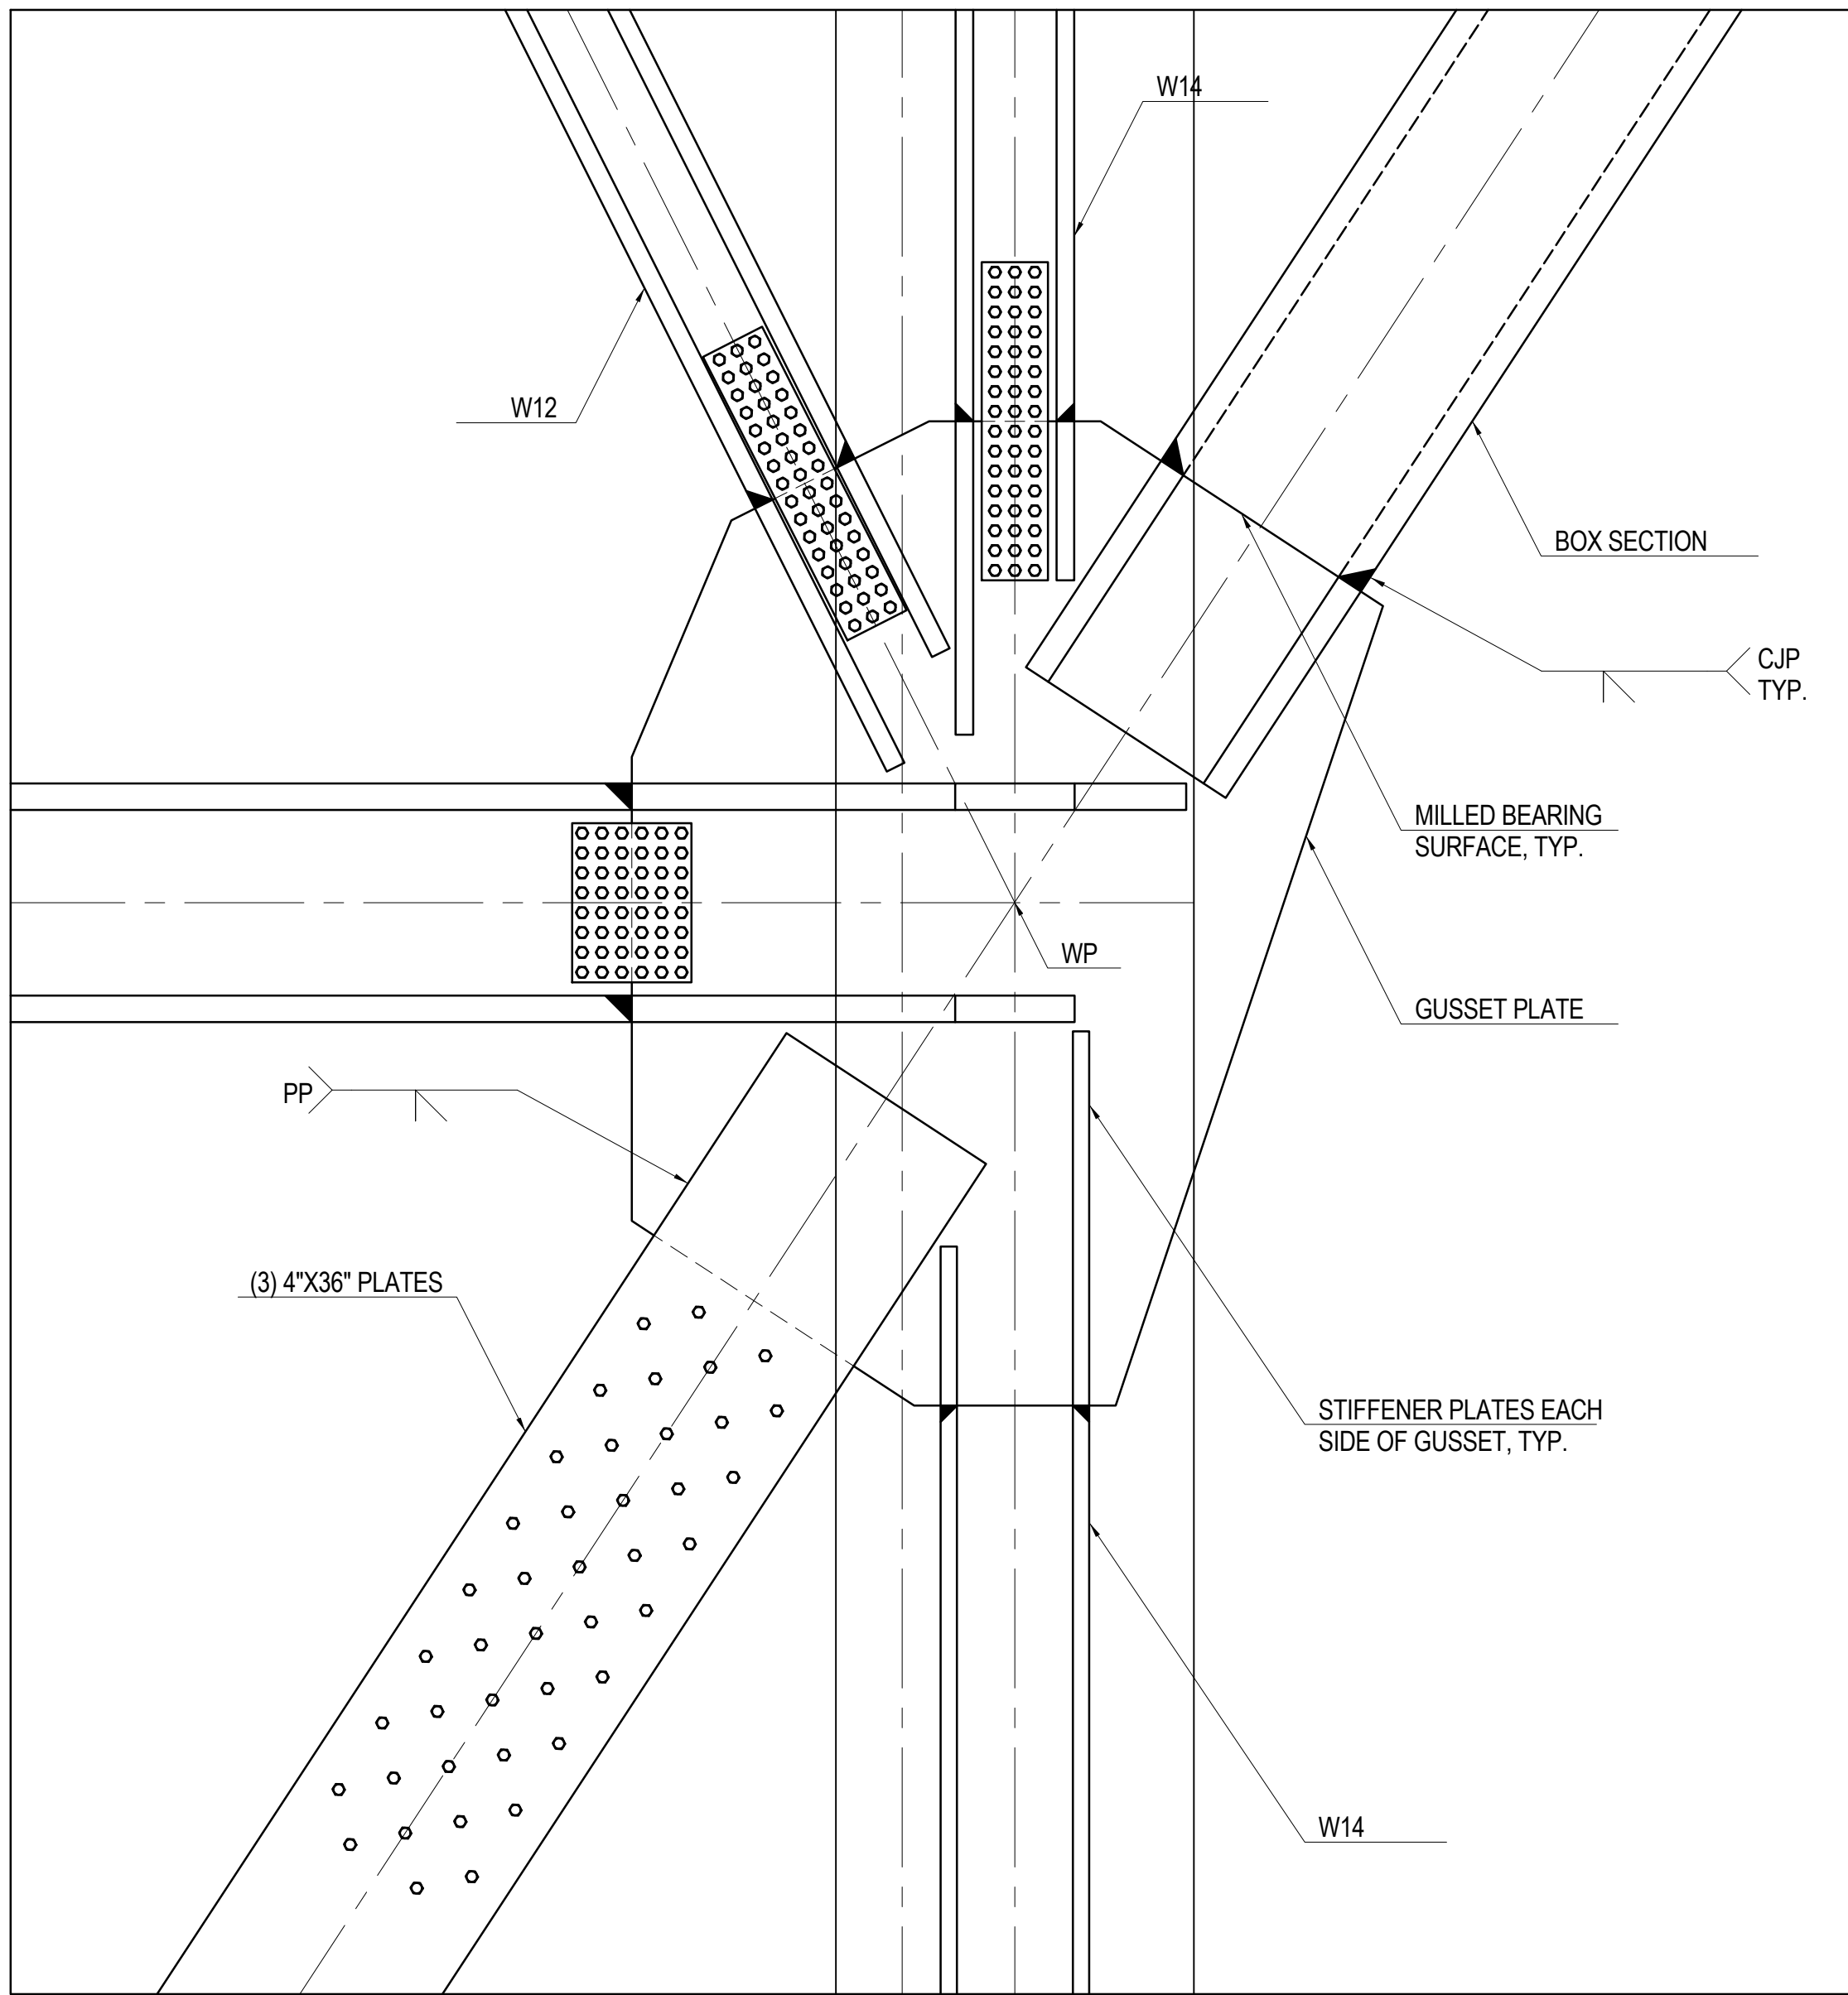
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1	19 MAR 2012	ISSUED FOR RECONCILIATION


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**KICKER COLUMN
SECTIONS &
DETAILS**


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Date: 20 JUN 2014	Sheet No.: S-410
Scale: 1/2" = 1'-0"	Page No.: 82 of 90
File No.: S-410	




1 DETAIL AT KICKER COLUMN INTERFACE WITH CORE WALL
1/2" = 1'-0"

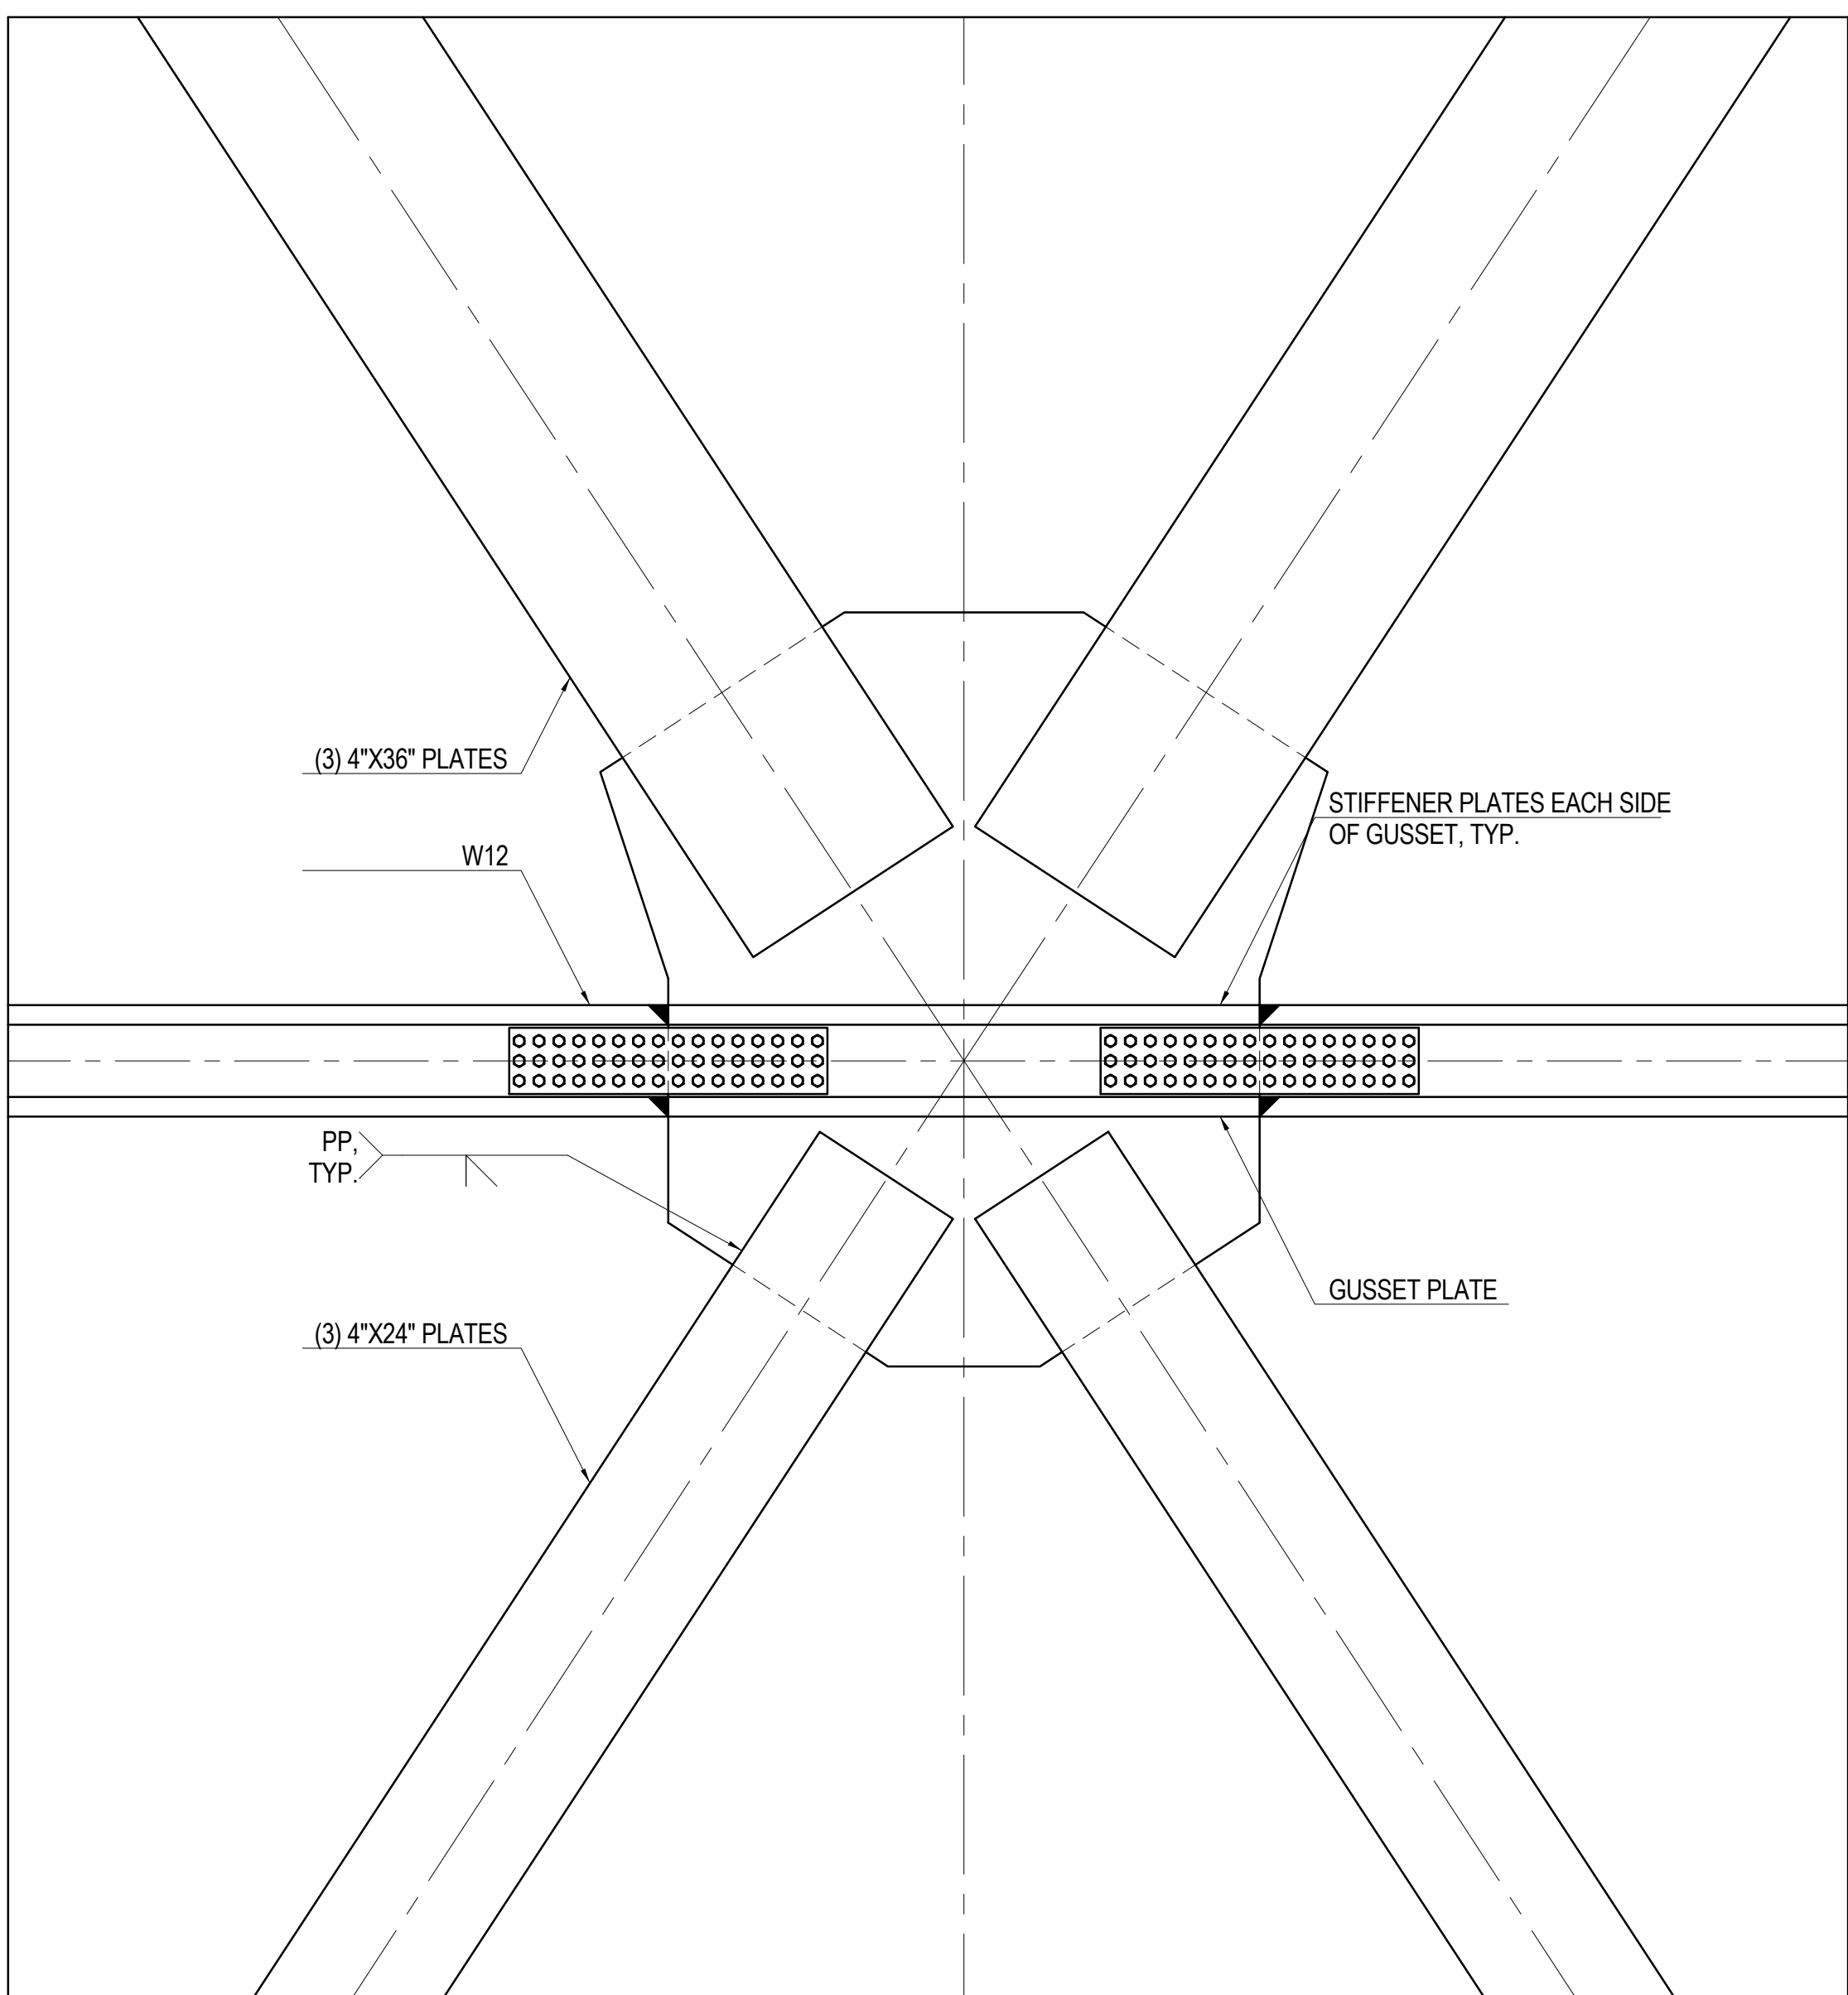


2 DETAIL AT KICKER COLUMN INTERSECTION WITHIN CORE WALL
1/2" = 1'-0"

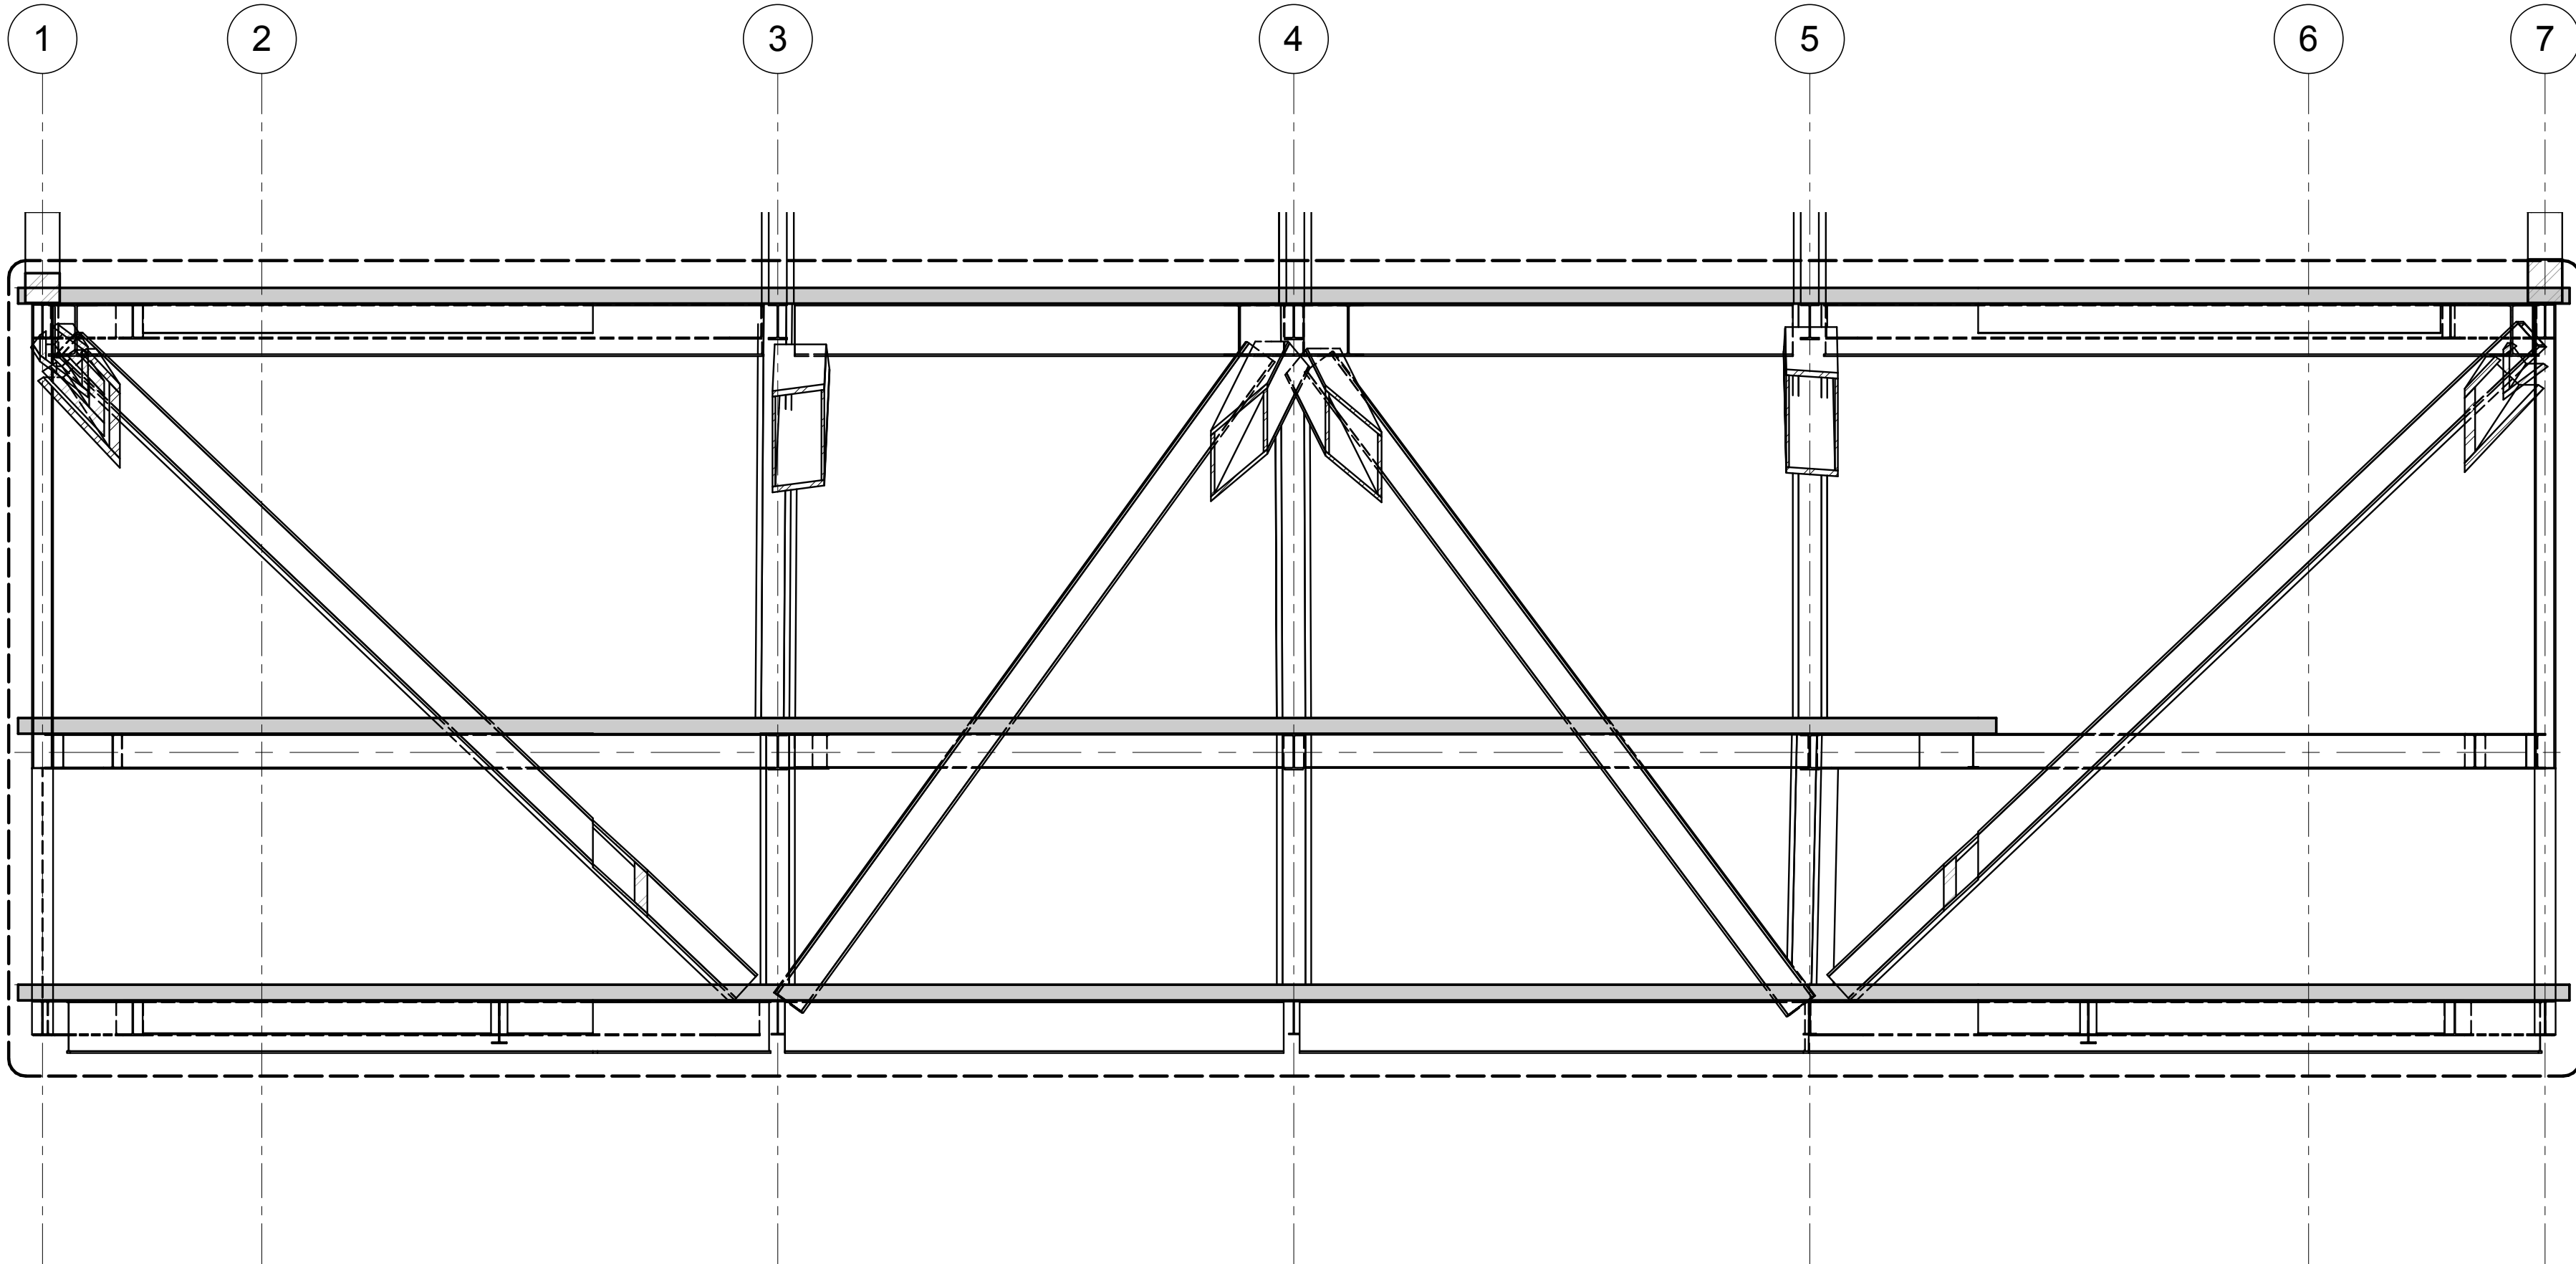


1 TYP SECTION @ LINE J LOOKING EAST
1/8" = 1'-0"

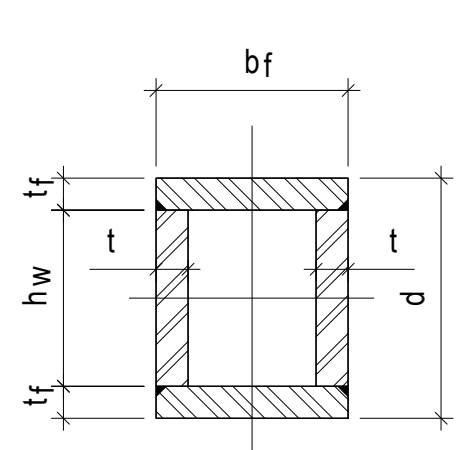

A BOX

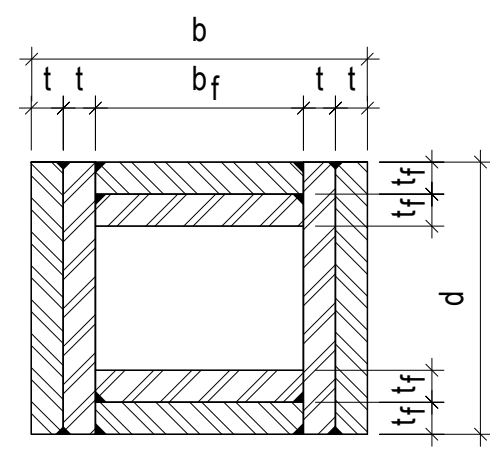


B DPBOX- DOUBLE PLATED BOX

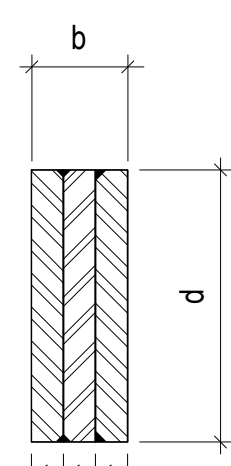

C BU - BUILT-TOP SOLID PLATE SECTION

NOMENCLATURE FOR BUILT-UP SECTIONS
1/2" = 1'-0"

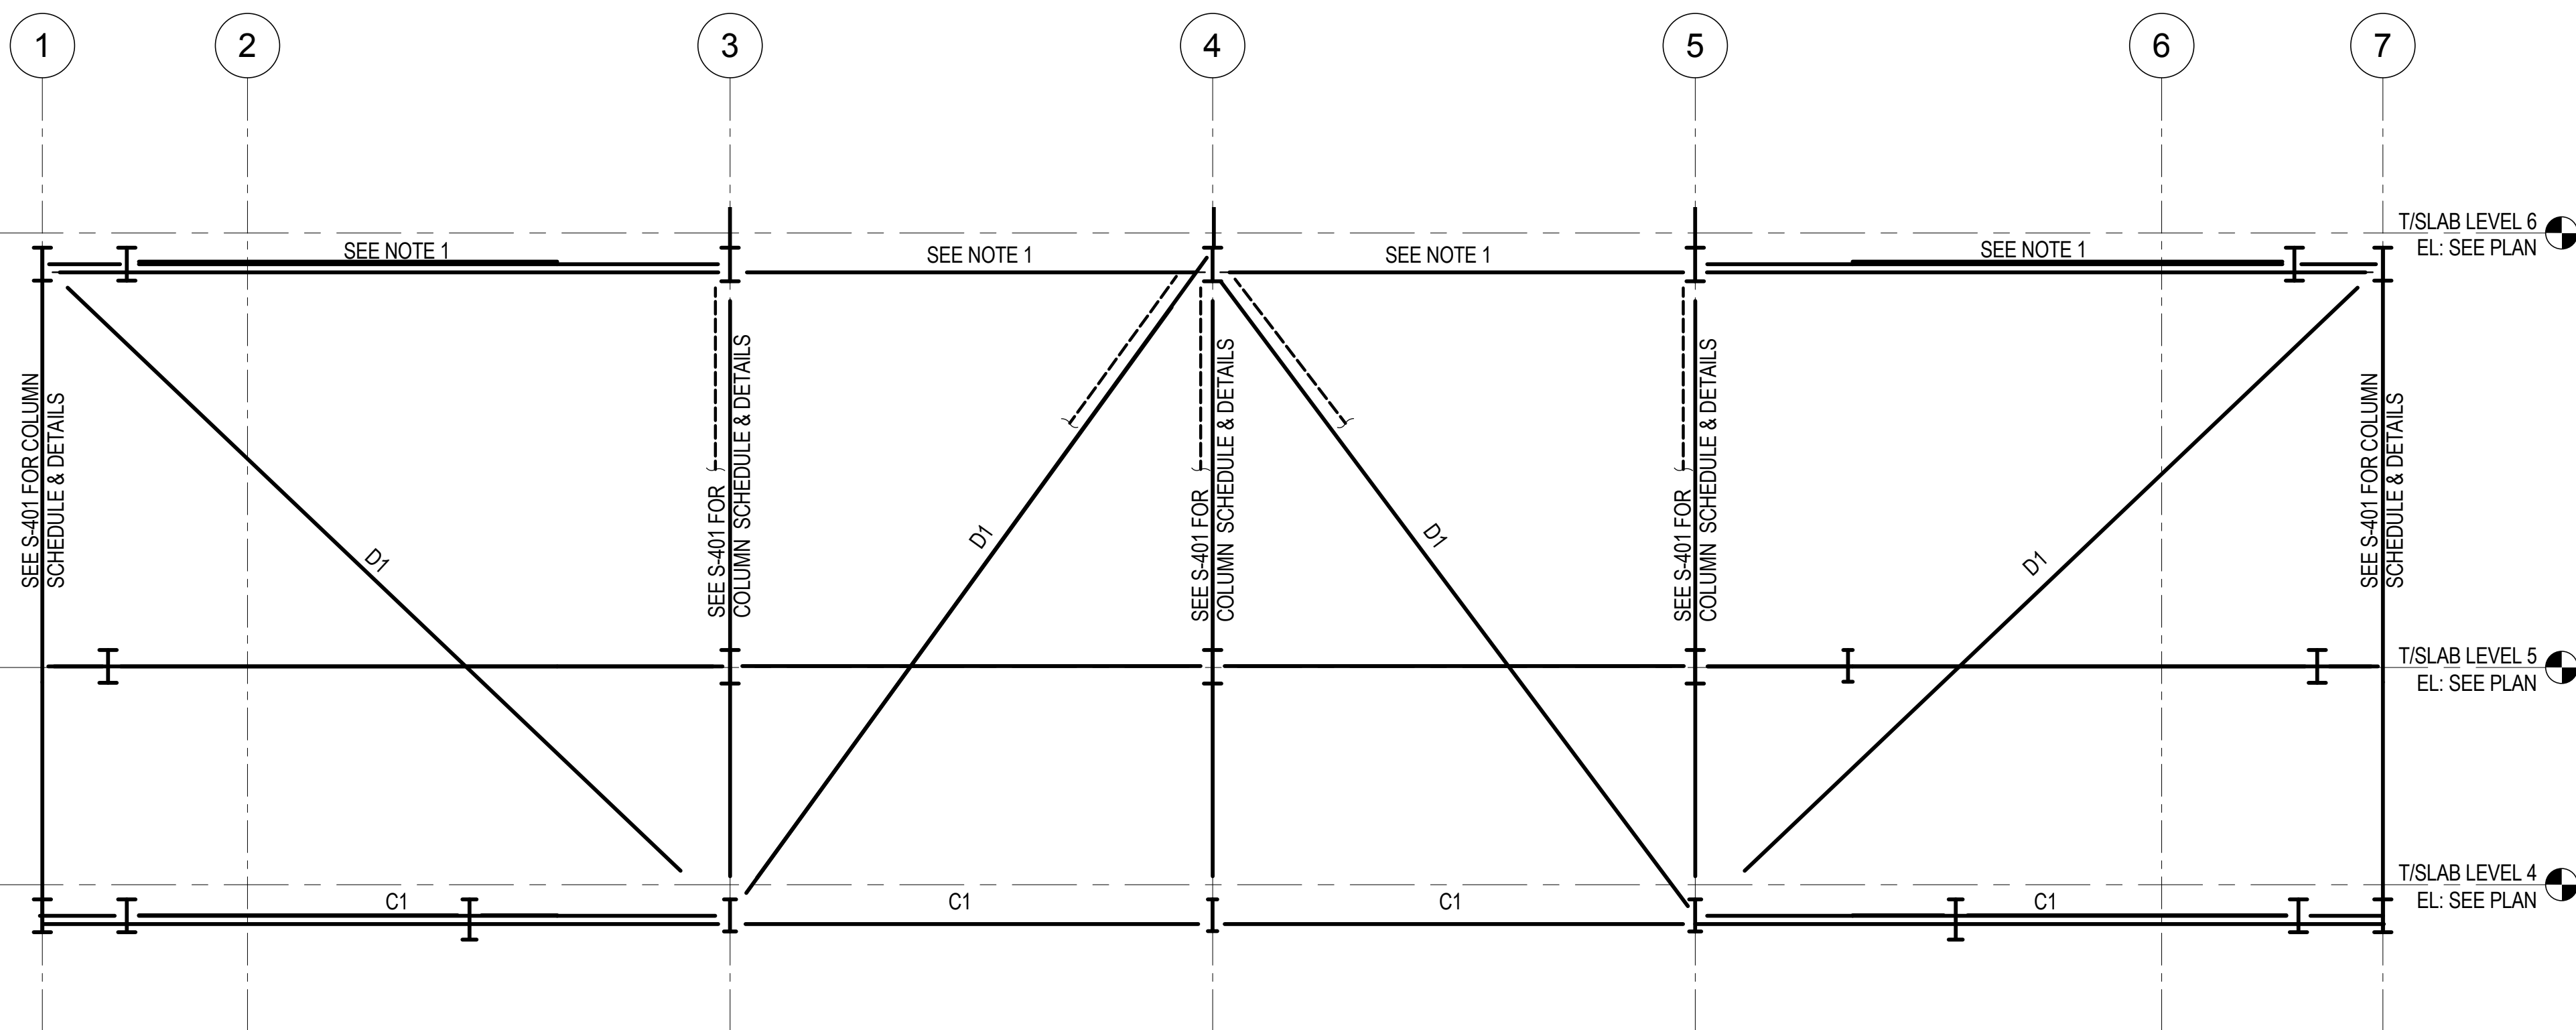

2 TYP SECTION @ LINE J LOOKING EAST
1/8" = 1'-0"

MANHATTAN WEST:
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Code Consultants Professional Engineers PC
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166 Ames Street, Hackensack, NJ 07601

Wind Tunnel Consultant
Rowan Williams Davies & Irwin Inc.
650 Woodlawn Road West, Guelph
Ontario, Canada N1K 1B6

Key Plan:

Seal & Signature:


PRELIMINARY
NOT FOR CONSTRUCTION

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1	19 MAR 2012	ISSUED FOR RECONCILIATION


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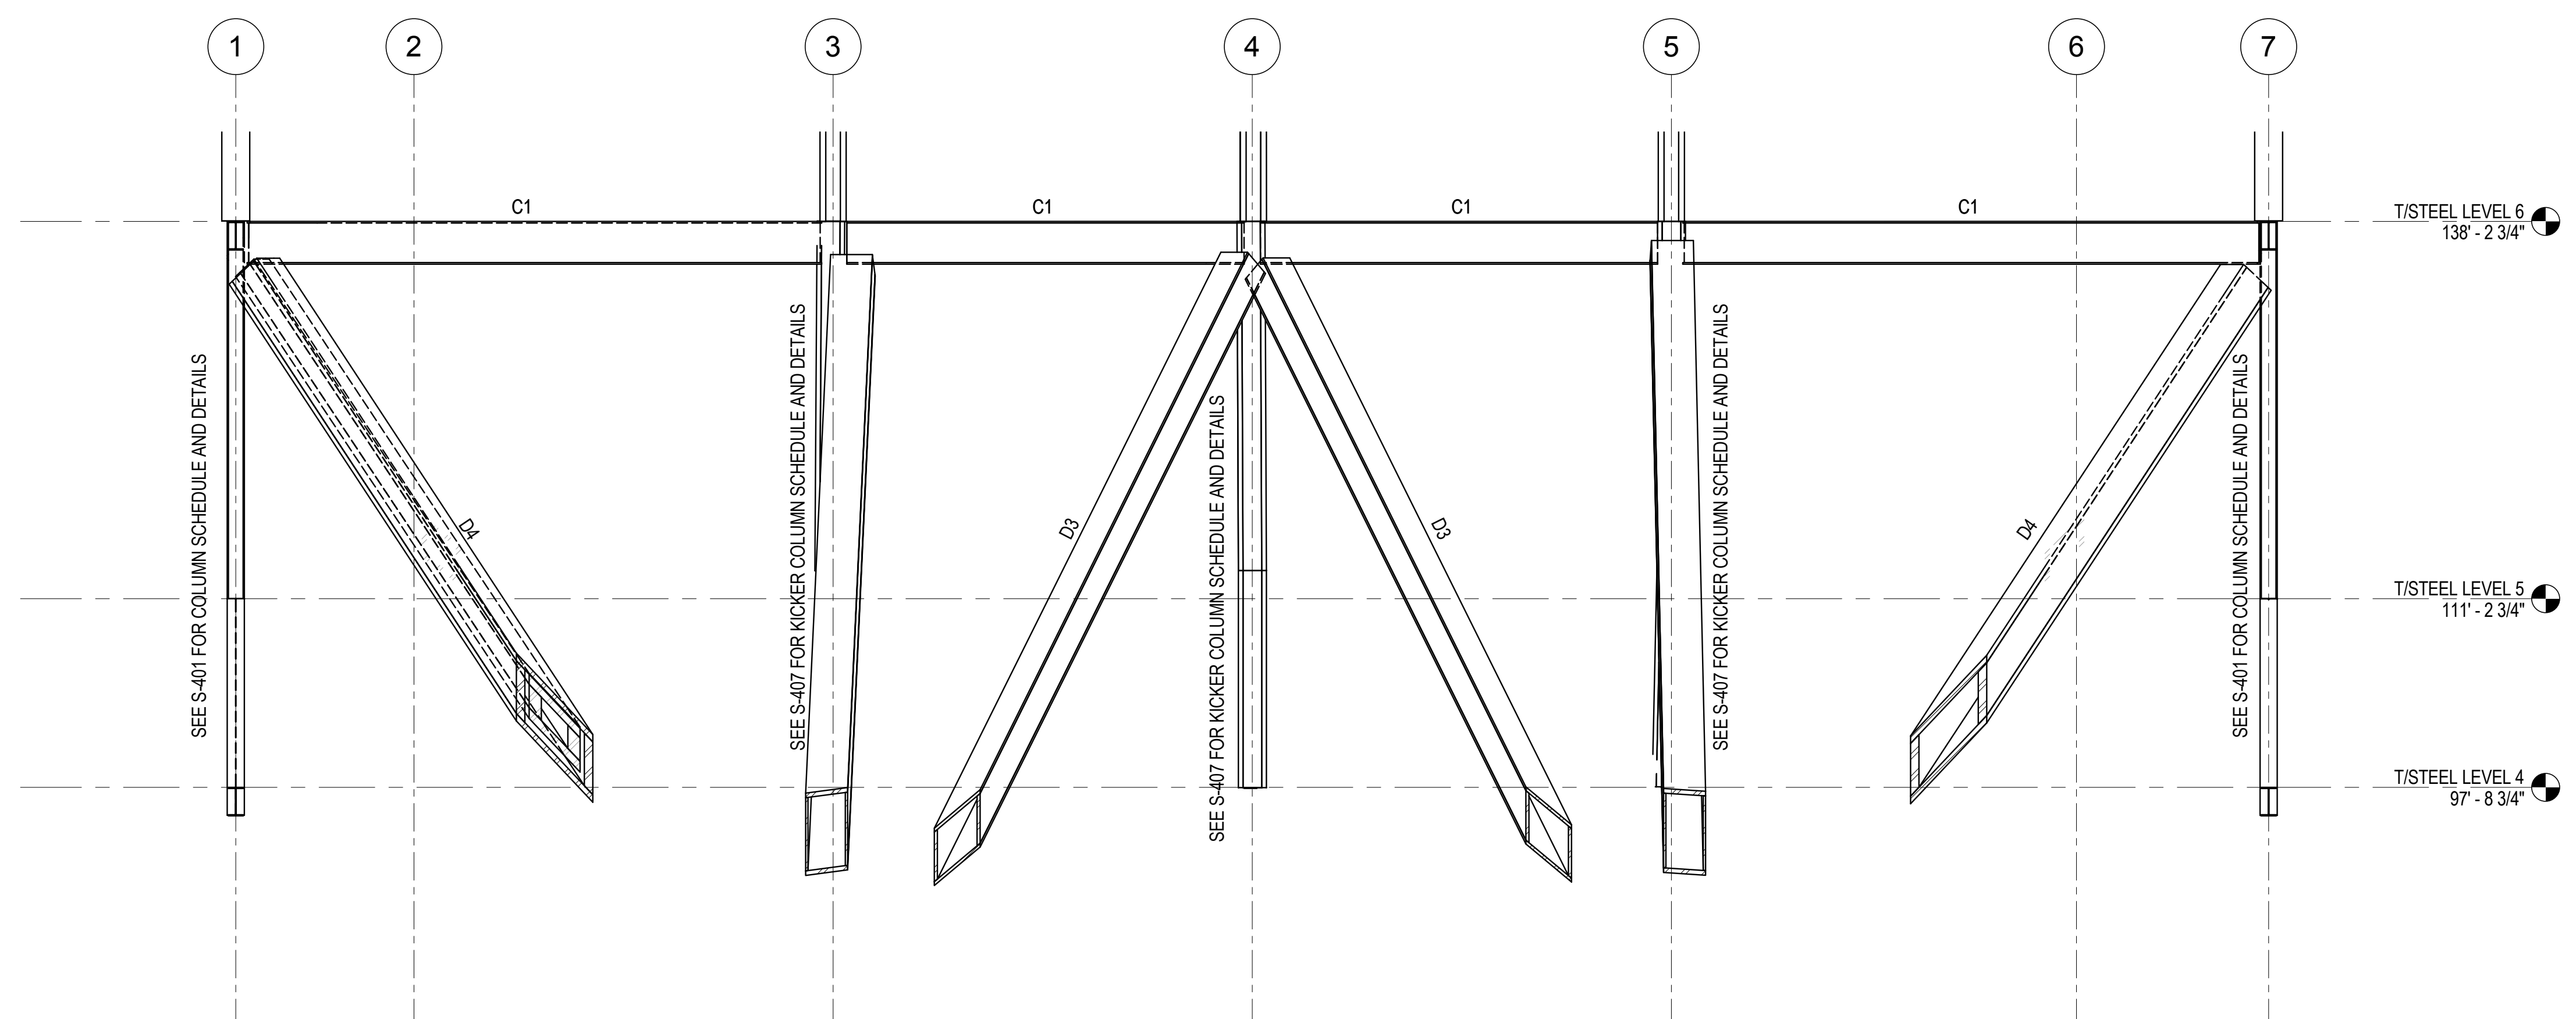
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Date: 20 JUN 2014	Sheet No.: S-411
Scale: As indicated	Page No.: 83 of 90
File No.: S-411	




LEVEL 2 TO 4 BELT TRUSS SCHEDULE			
	EAST ELEVATION	WEST ELEVATION	NORTH AND SOUTH ELEVATION
C1	W36x210	W36x210	-
C2	-	-	W24x131
C3	-	-	W30x116
D1	BOX 24X24X2 1/4X2 1/4	-	-
D2	-	BOX 24X24X7/8X7/8	-
D3	-	-	BOX 30X30X2X2
D4	BOX 36X36X4X4	-	-
D5	-	BOX 30X30X3X3	-

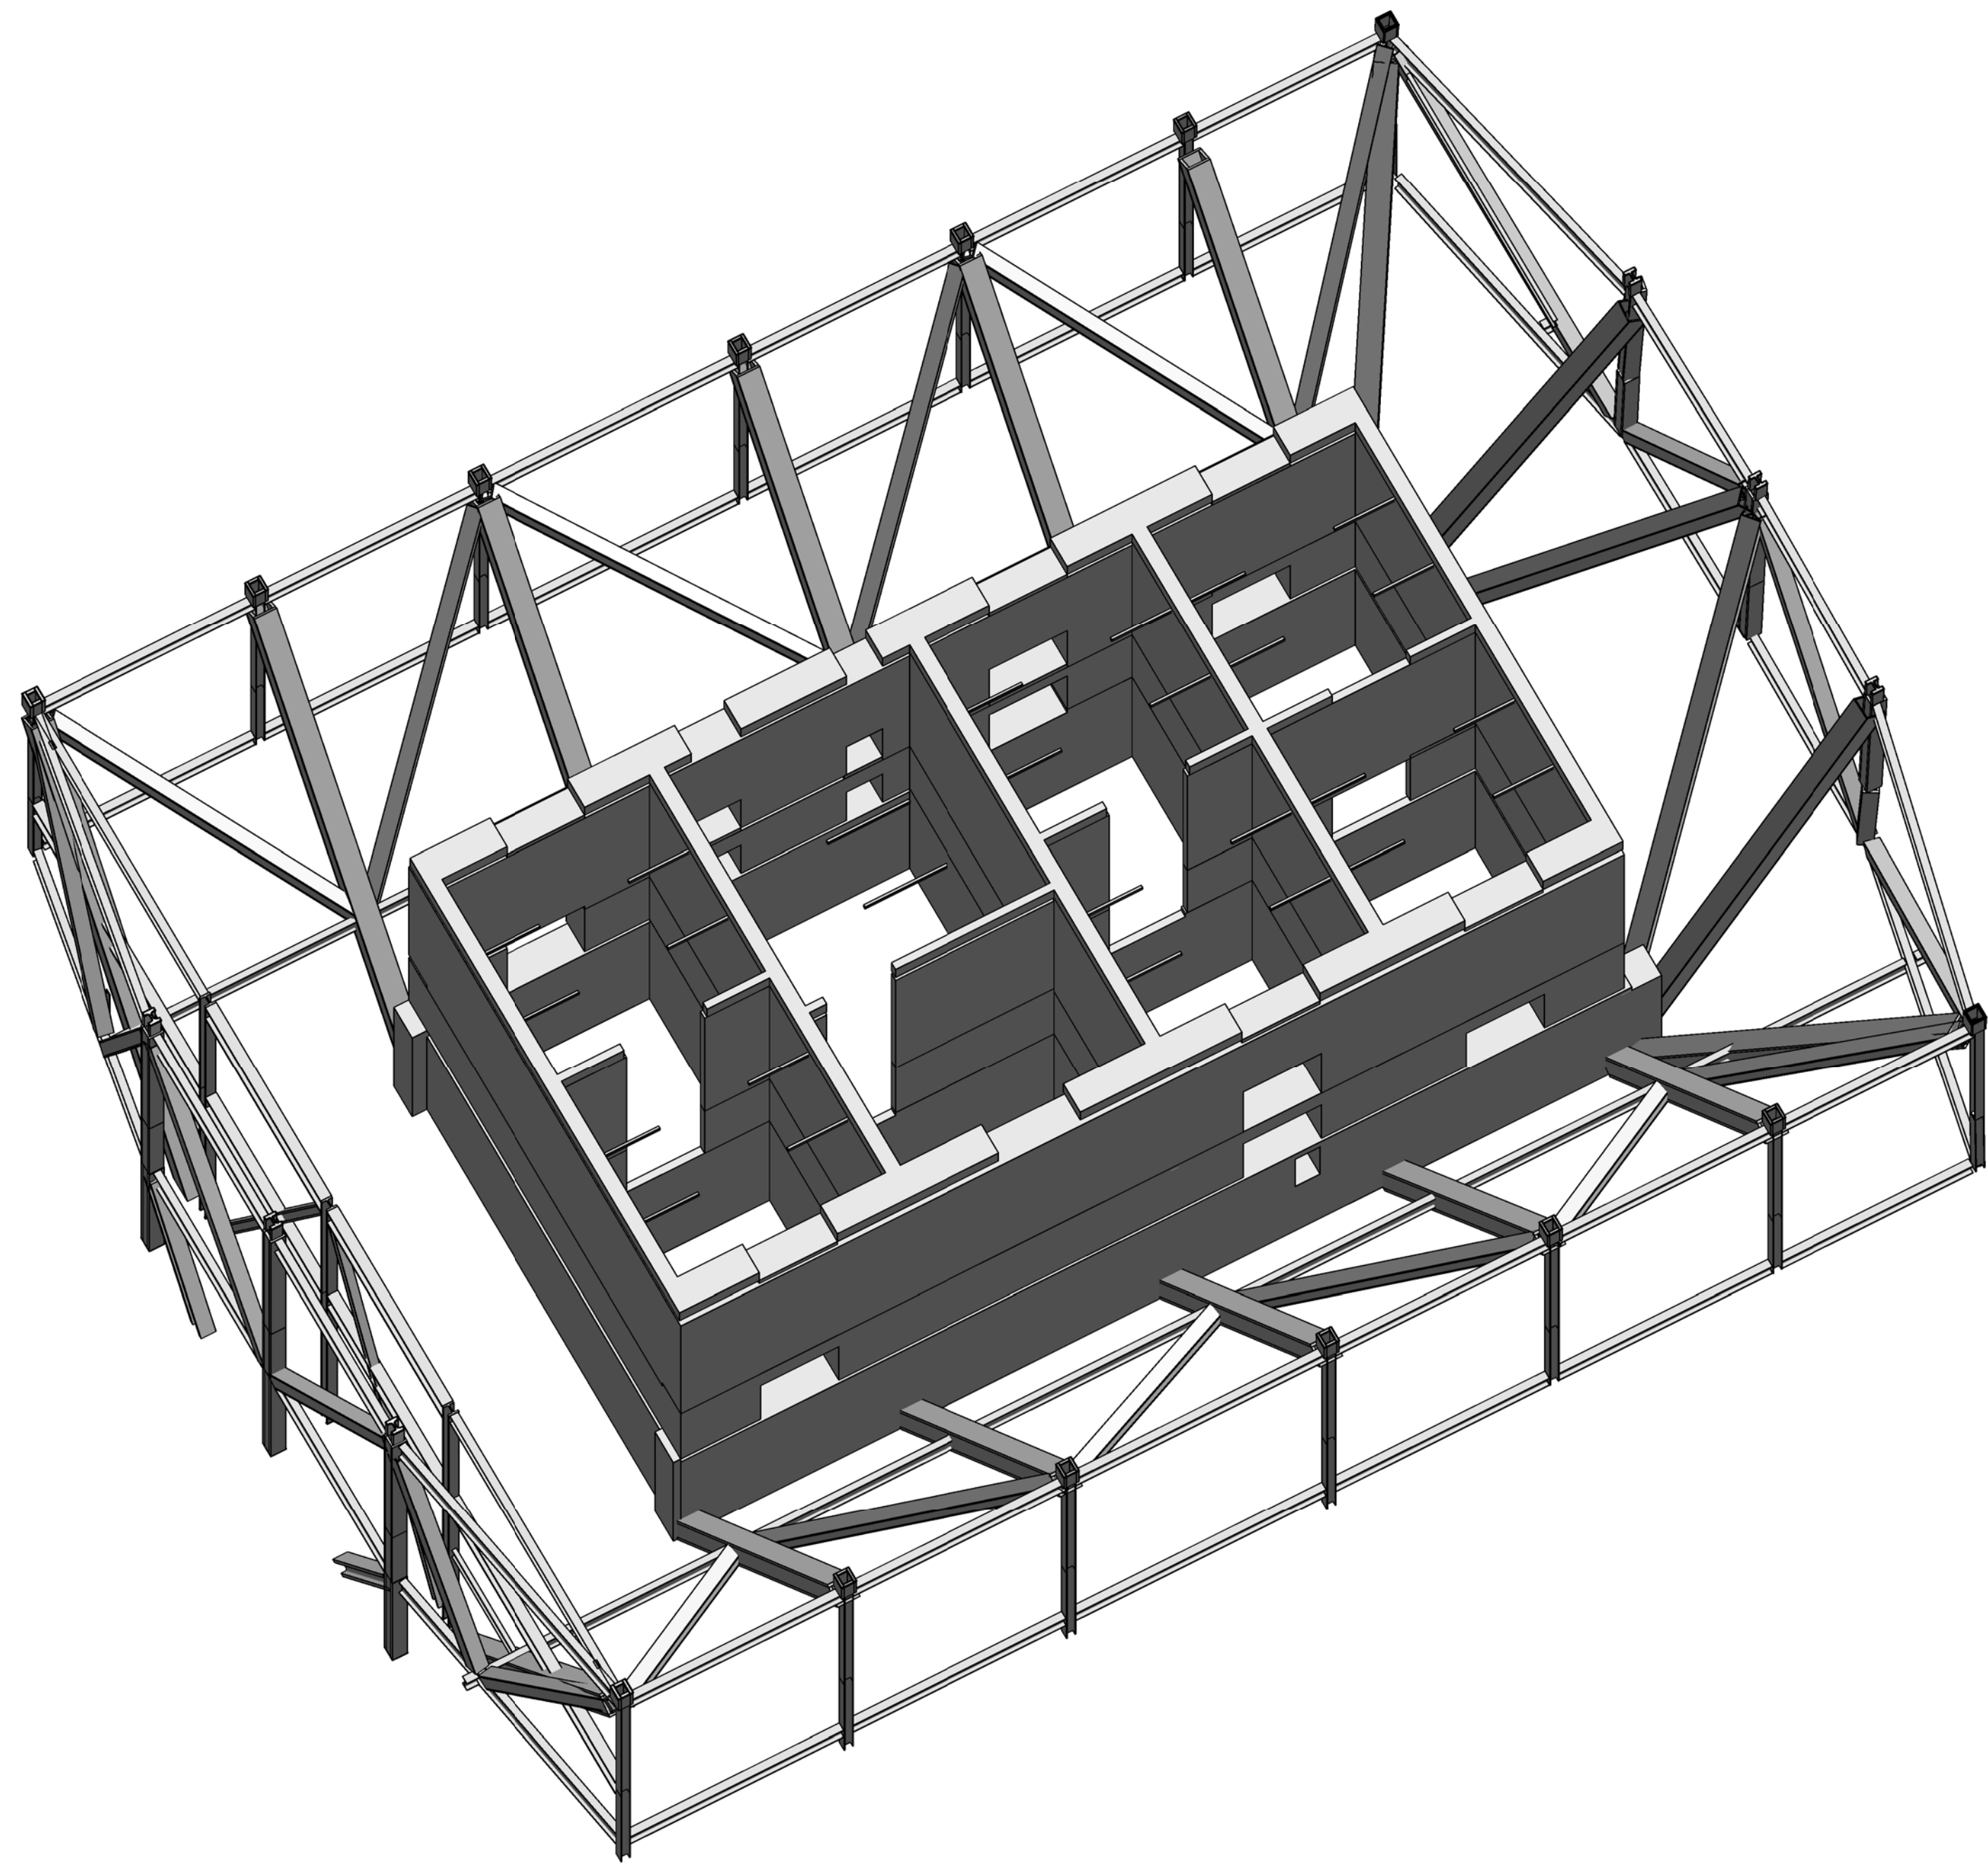

1 EAST ELEVATION @ BELT TRUSS GRID LINE A (LOOKING EAST)
1/8" = 1'-0"

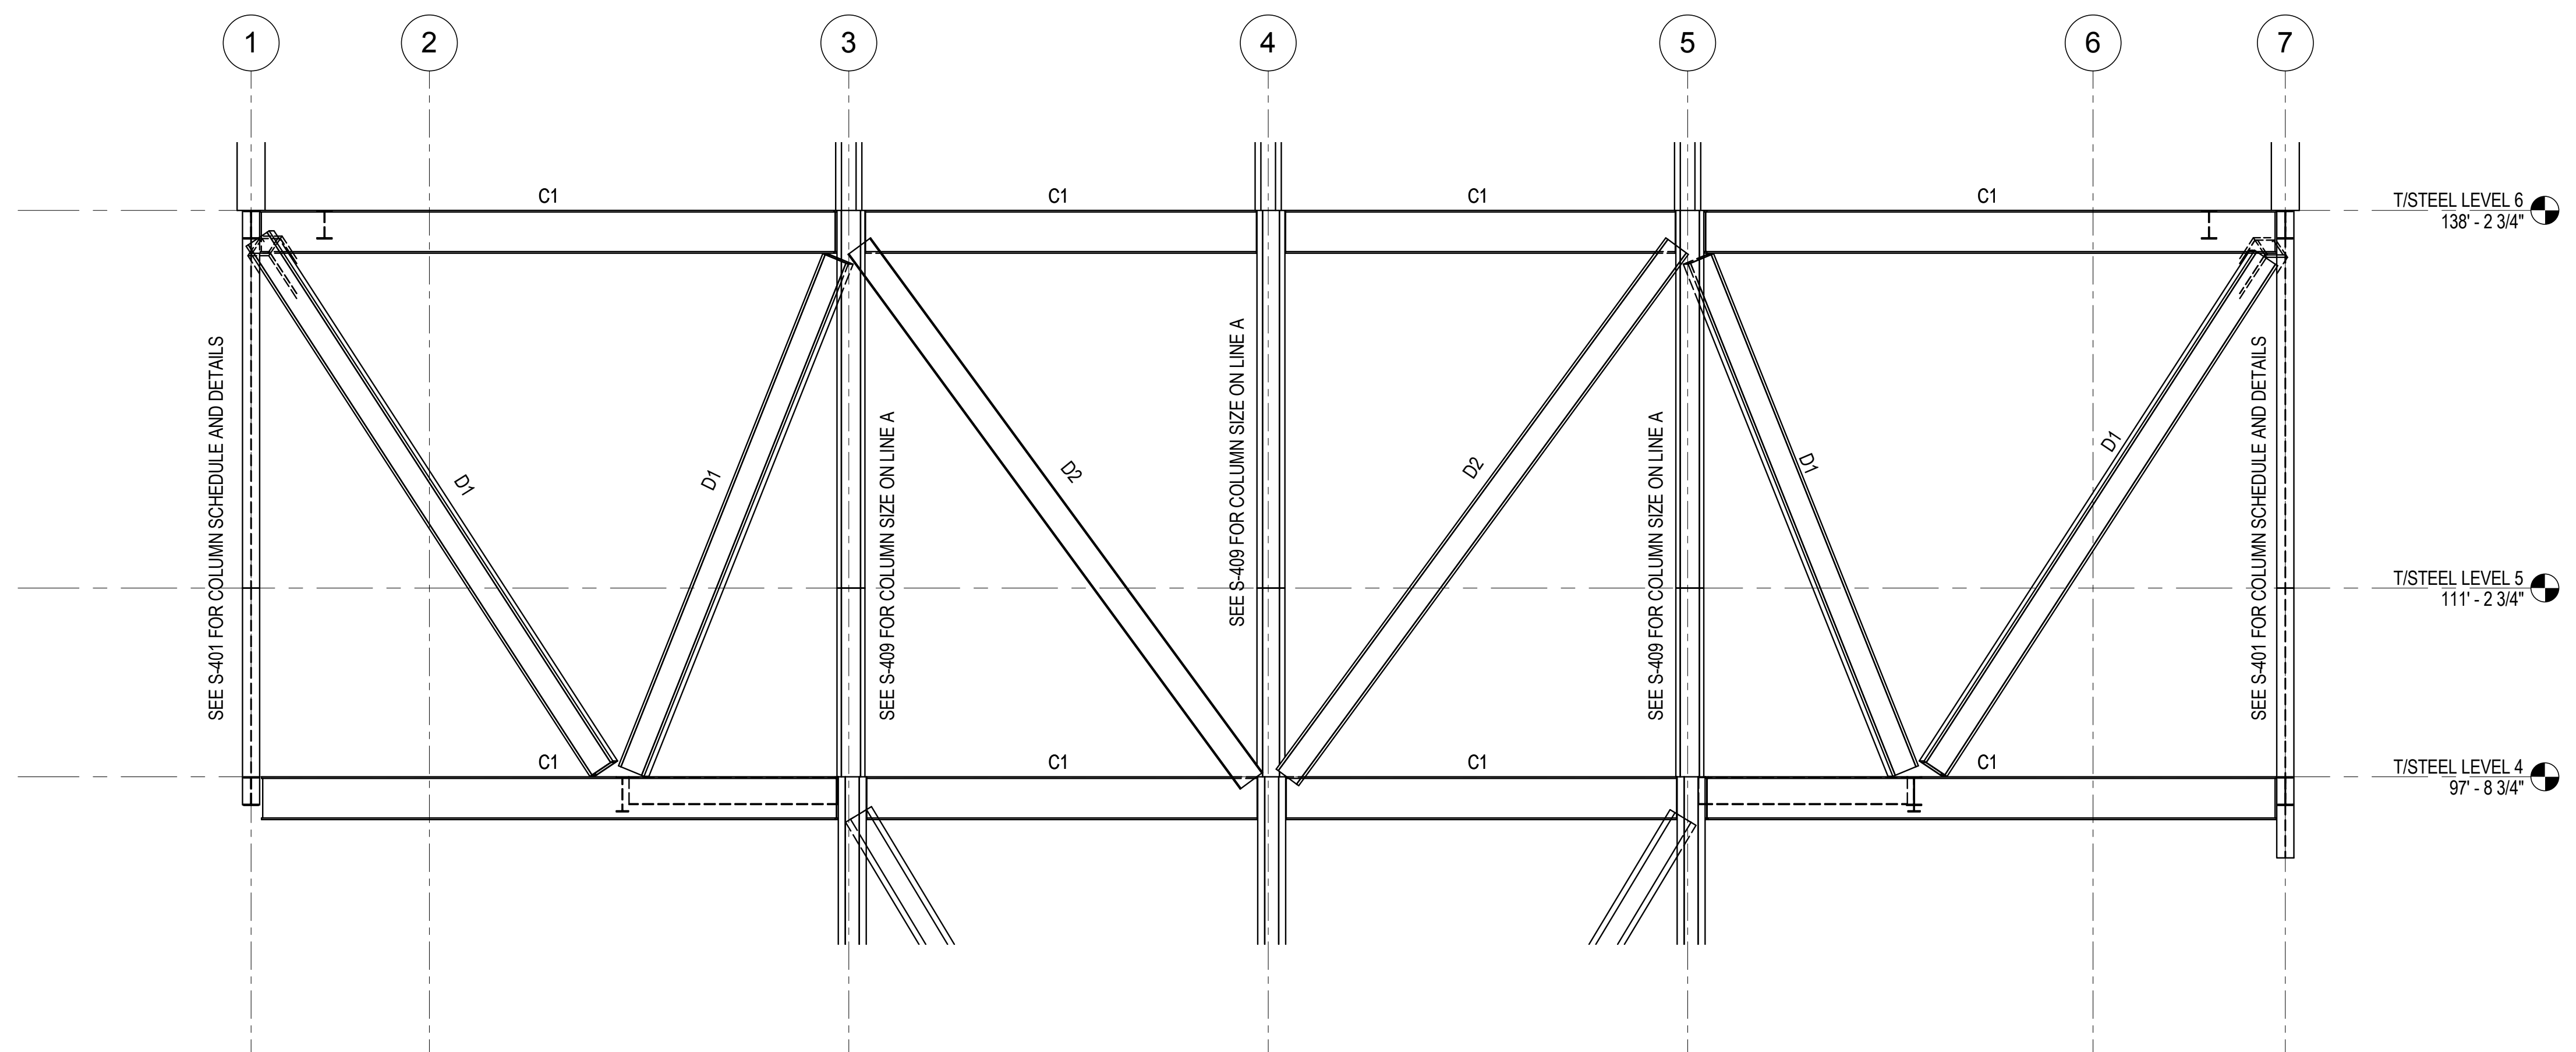

2 SLOPED STRUCTURAL STEEL ON EAST SIDE (LOOKING EAST)
1/8" = 1'-0"

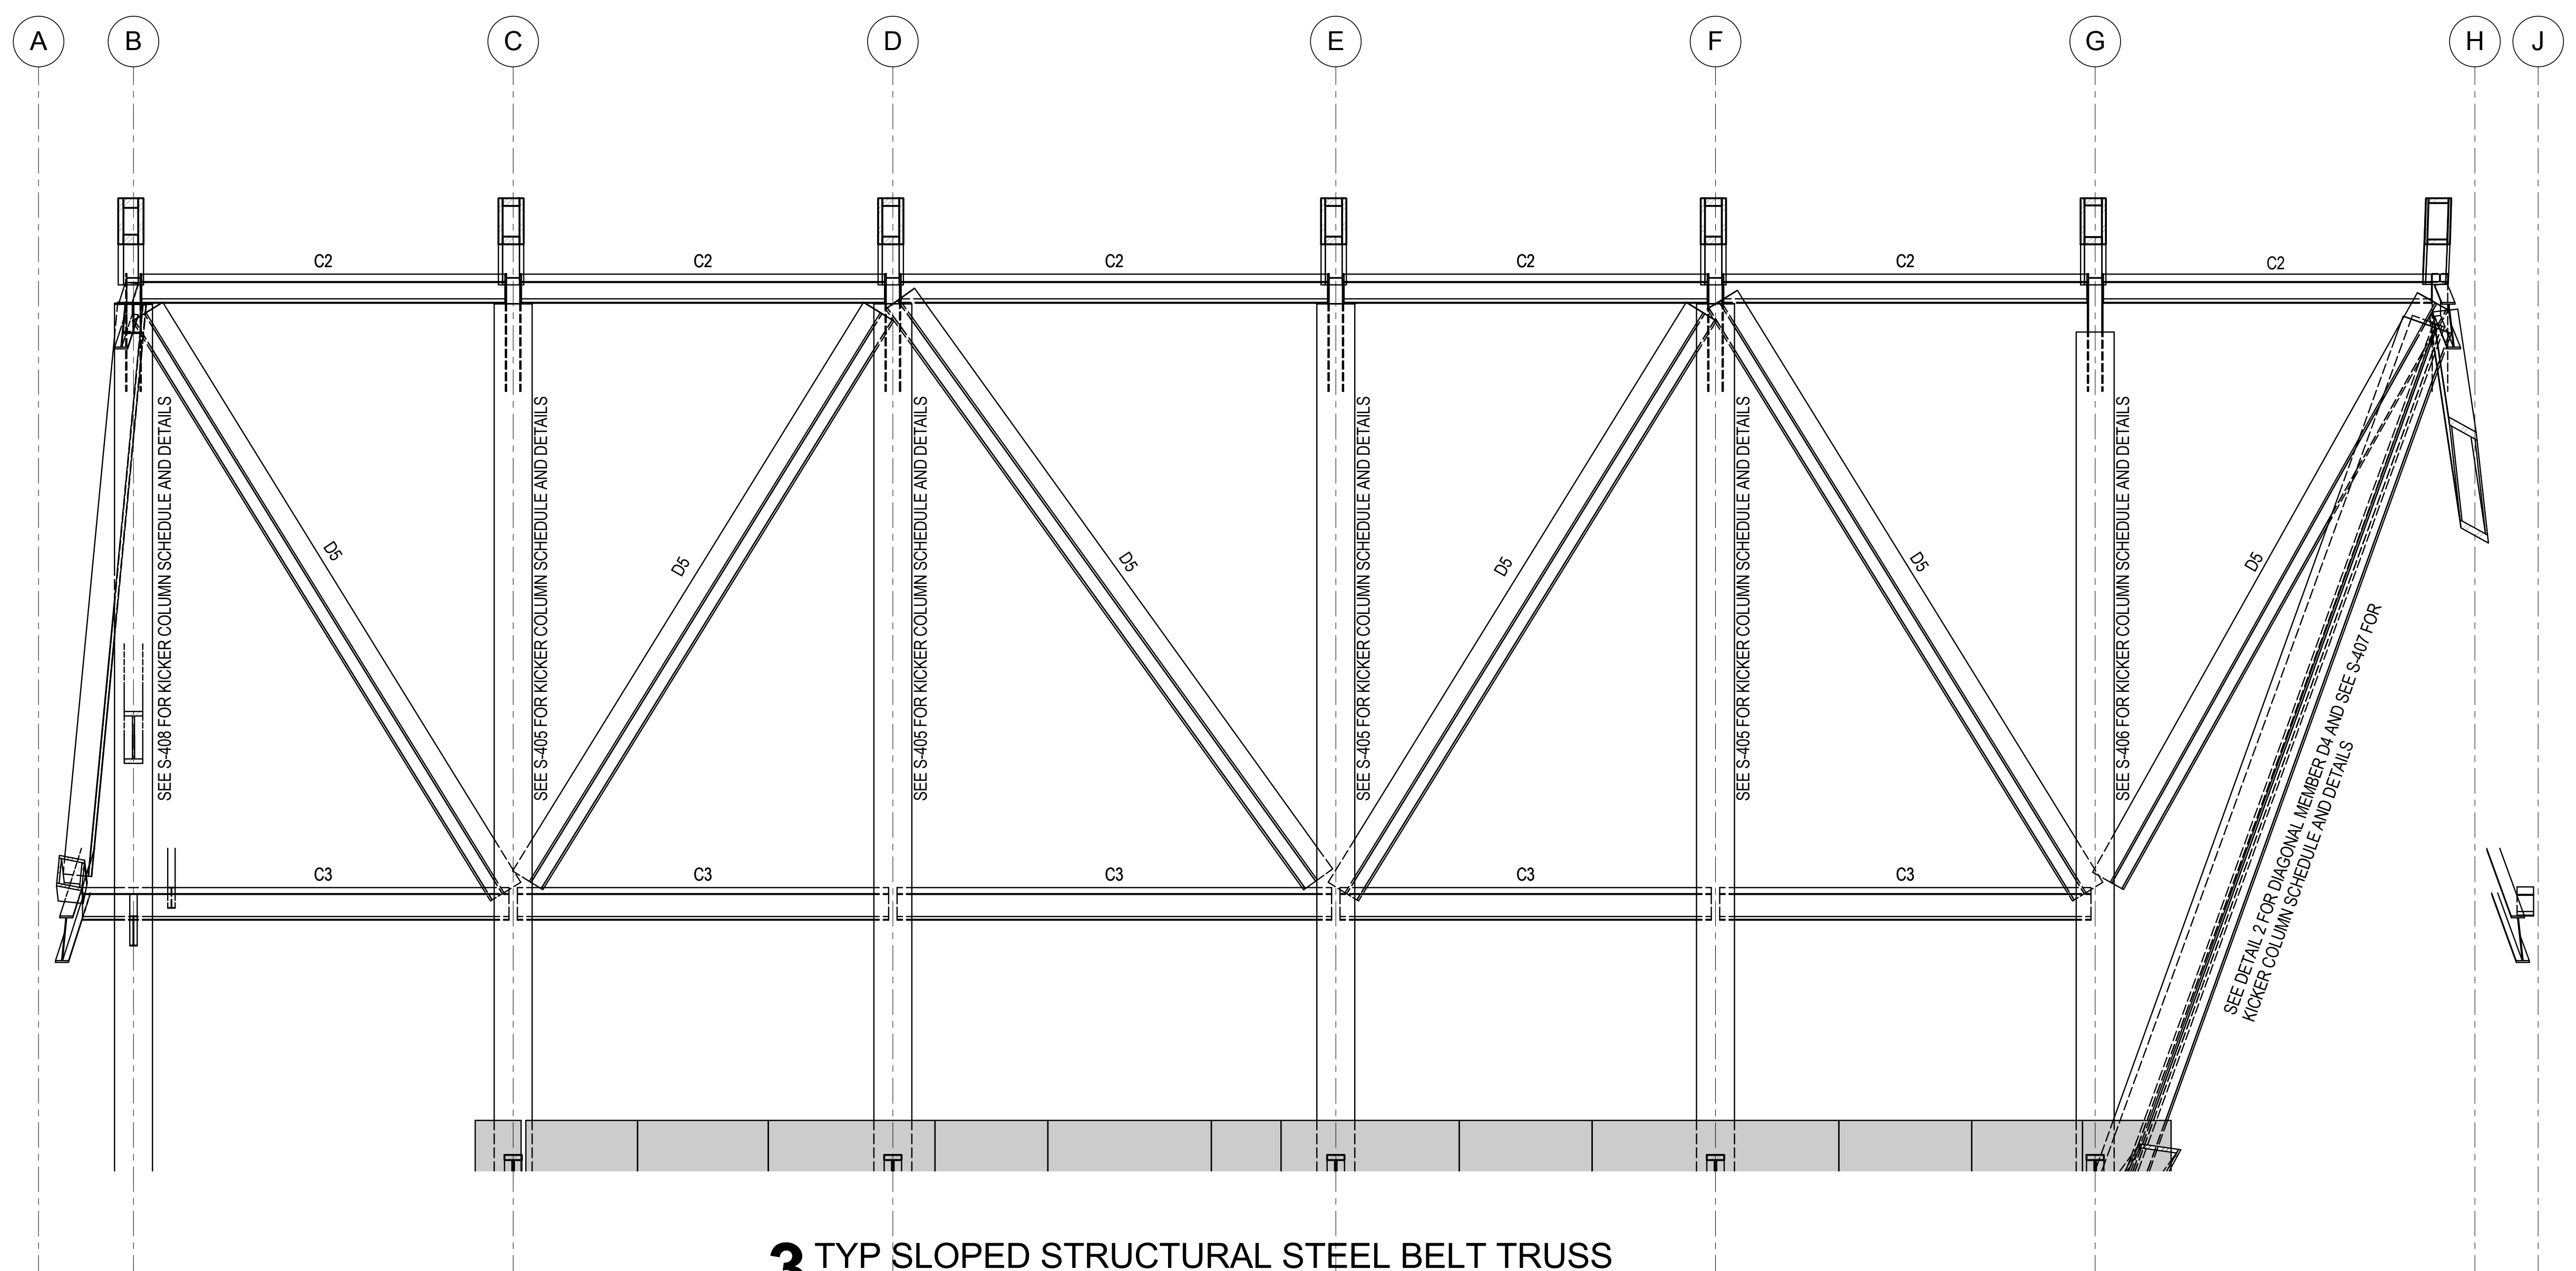

3 TYP SLOPED STRUCTURAL STEEL BELT TRUSS
1/8" = 1'-0"

**MANHATTAN WEST:
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102 East Blithedale Ave., Suite 1, Mill Valley, California 94041

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Key Plan:

Seal & Signature:

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3	15 NOV 2013	ISSUED FOR 50% PROGRESS PRICING
2	12 JUL 2013	ISSUED FOR 90% DESIGN DEVELOPMENT
1	19 MAR 2012	ISSUED FOR RECONCILIATION


Sheet Name:
**LOWER BELT
TRUSS
SCHEDULES,
SECTIONS &
DETAILS**

Project No.:	B-SCAN Sheet No.:
211157	S-415.00


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20 JUN 2014	S-415

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As indicated	84 of 90


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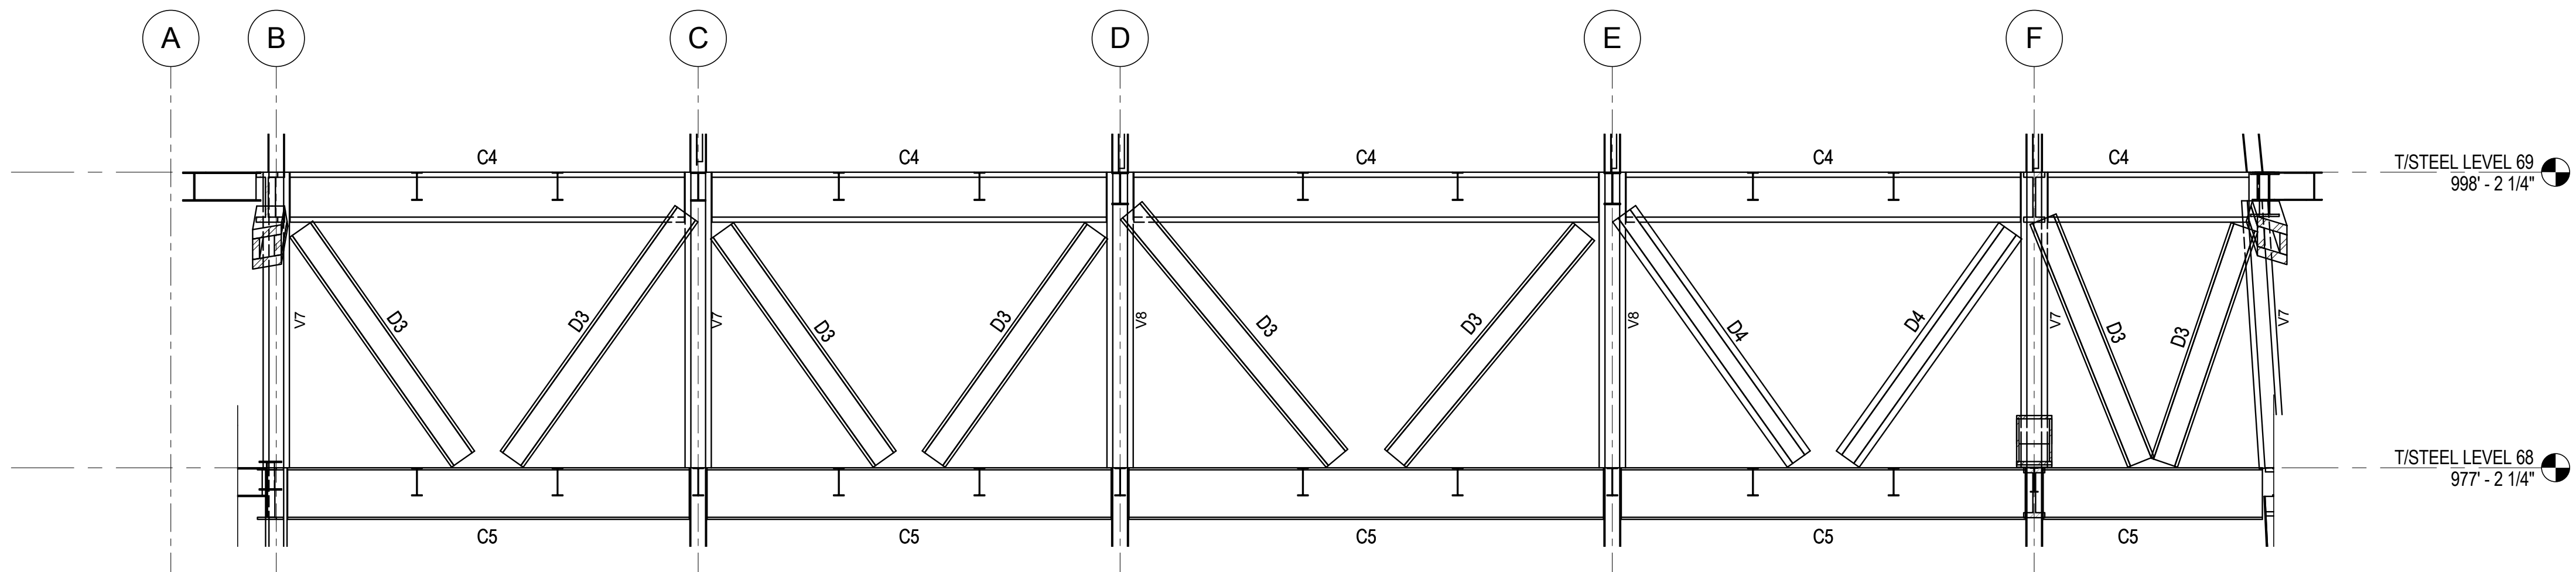
LEVEL 64 TO 65 BELT TRUSS SCHEDULE				
	NORTH AND SOUTH ELEVATION	WEST ELEVATION	EAST ELEVATION	OUTRIGGERS
C4	W36x800	W36x800	-	W36x800
C5	BU44x20x4x4	BU44x20x4x4	-	BU44x20x4x4
C6	-	-	W36x330	W36x330
C7	-	-	W36x652	W36x652
C8	-	-	-	W36x361
D3	BOX24x24x2 1/2x2 1/2	-	-	-
D4	BOX24x24x3 1/4x3 1/4	BOX24x24x3 1/4x3 1/4	-	-
D5	-	BOX24x24x2 1/4x2 1/4	-	-
D6	-	-	BOX24x24x1 1/4x1 1/4	-
D9	-	-	-	BOX30x24x4x4
D10	-	-	-	BOX30x24x1 1/2x1 1/2
D11	-	-	-	BOX30x24x3 1/2x3 1/2
V7	W14x730	W14x730	W14x730	-
V8	WFP14x730x17x1	WFP14x730x17x1	-	-
V9	-	-	W14x426	-

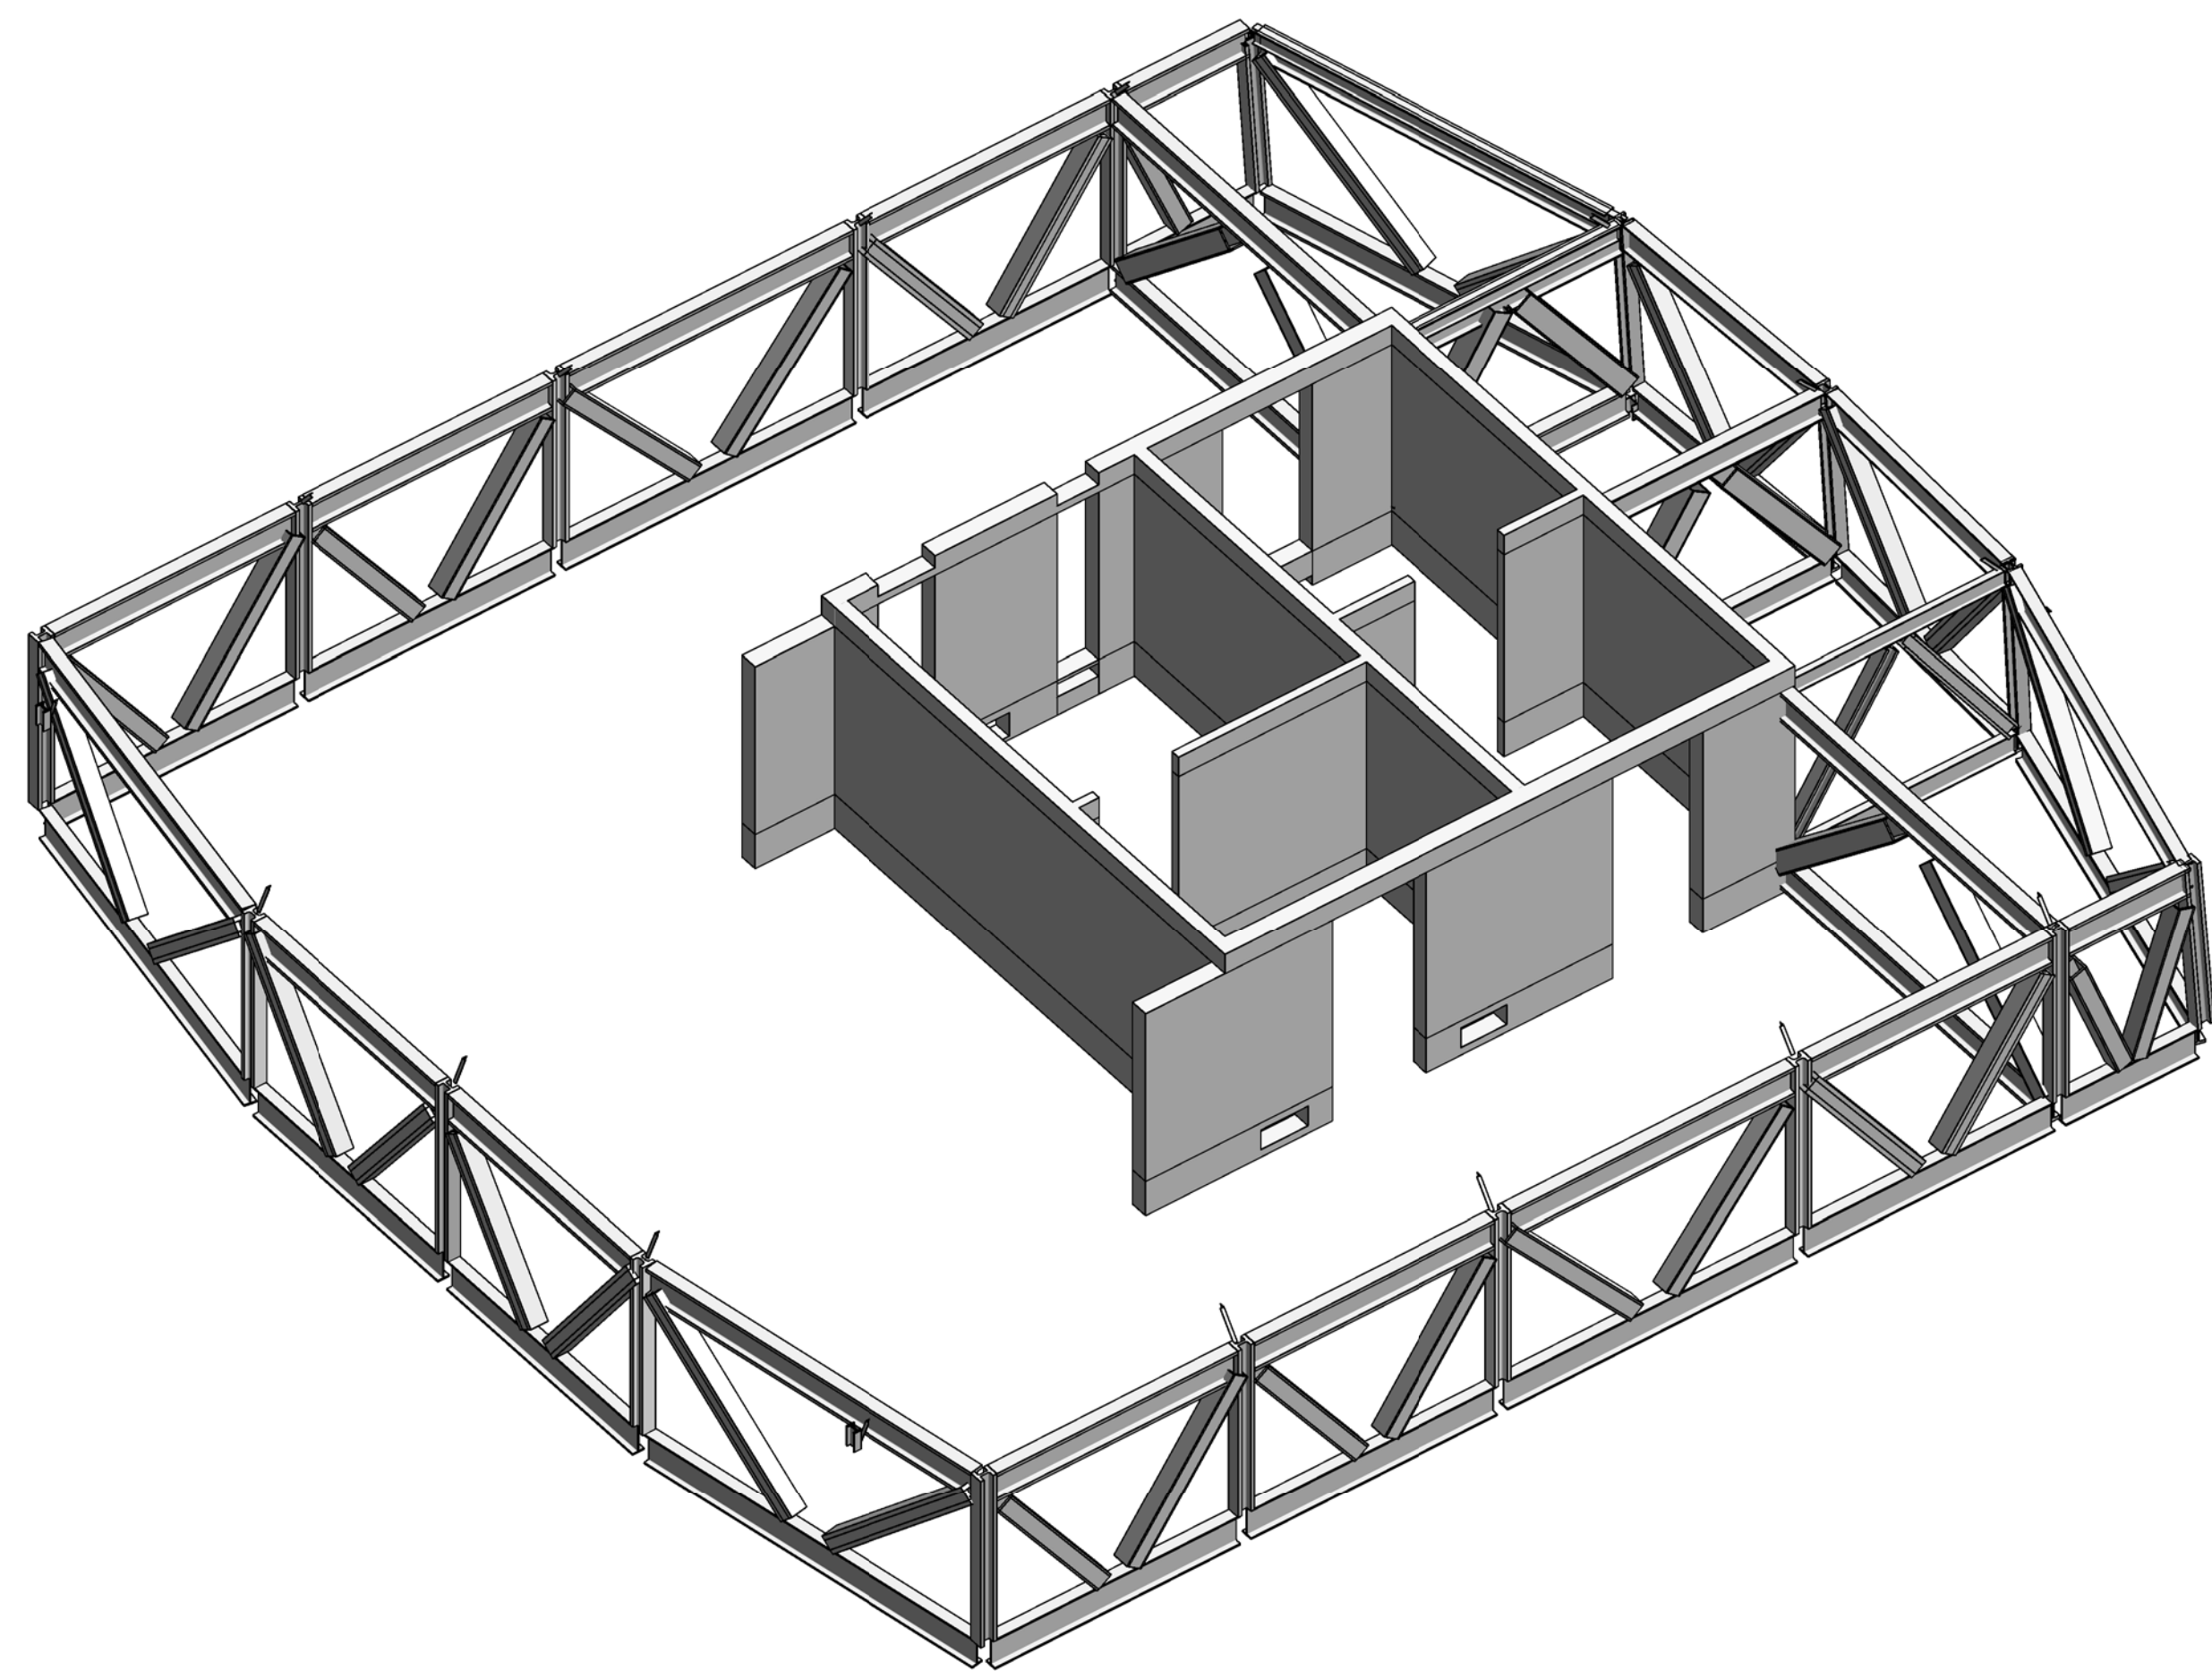


5 OUTRIGGER SECTION ALONG LINES 3 AND 5
1/8" = 1'-0"

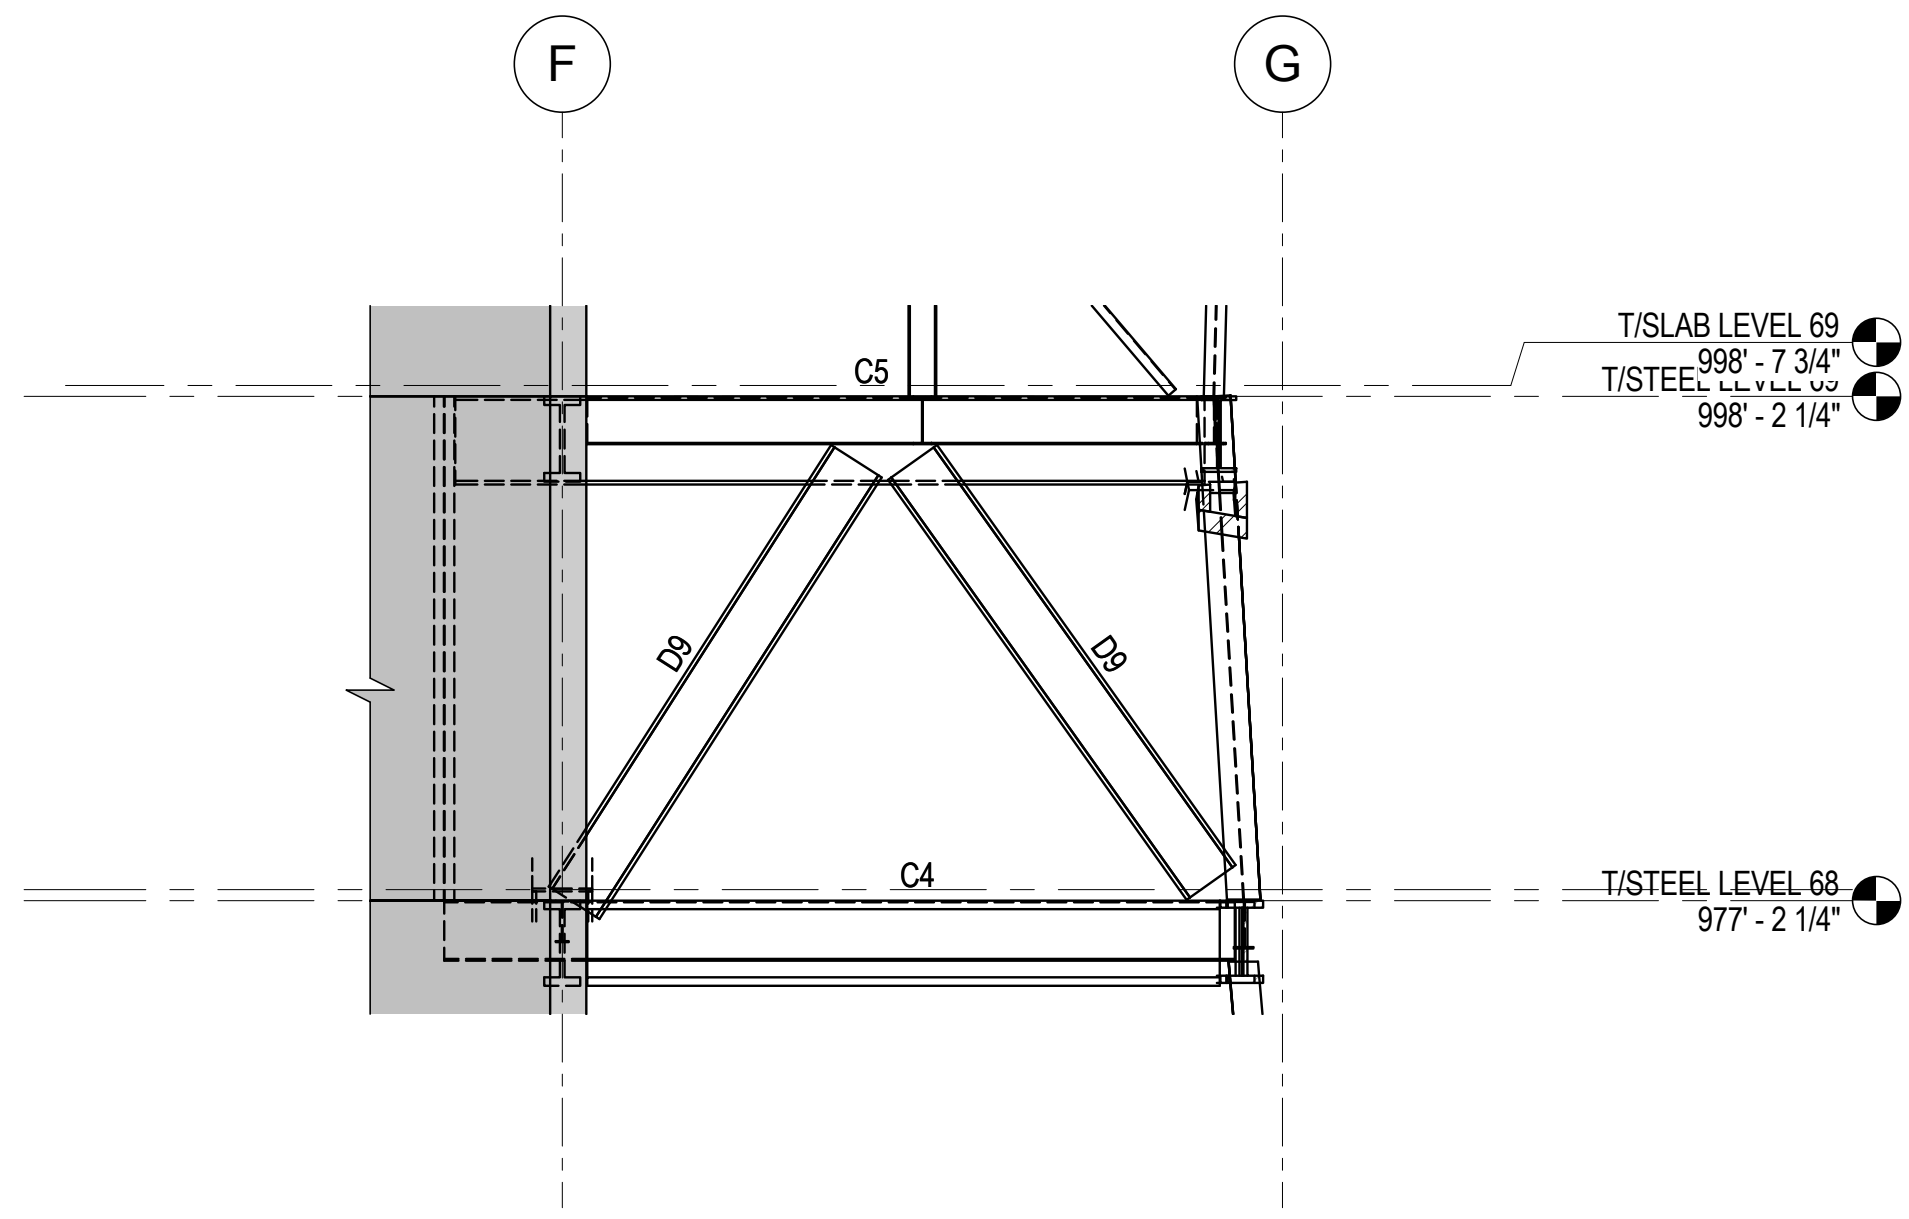


6 OUTRIGGER SECTION ALONG LINE 4
1/8" = 1'-0"

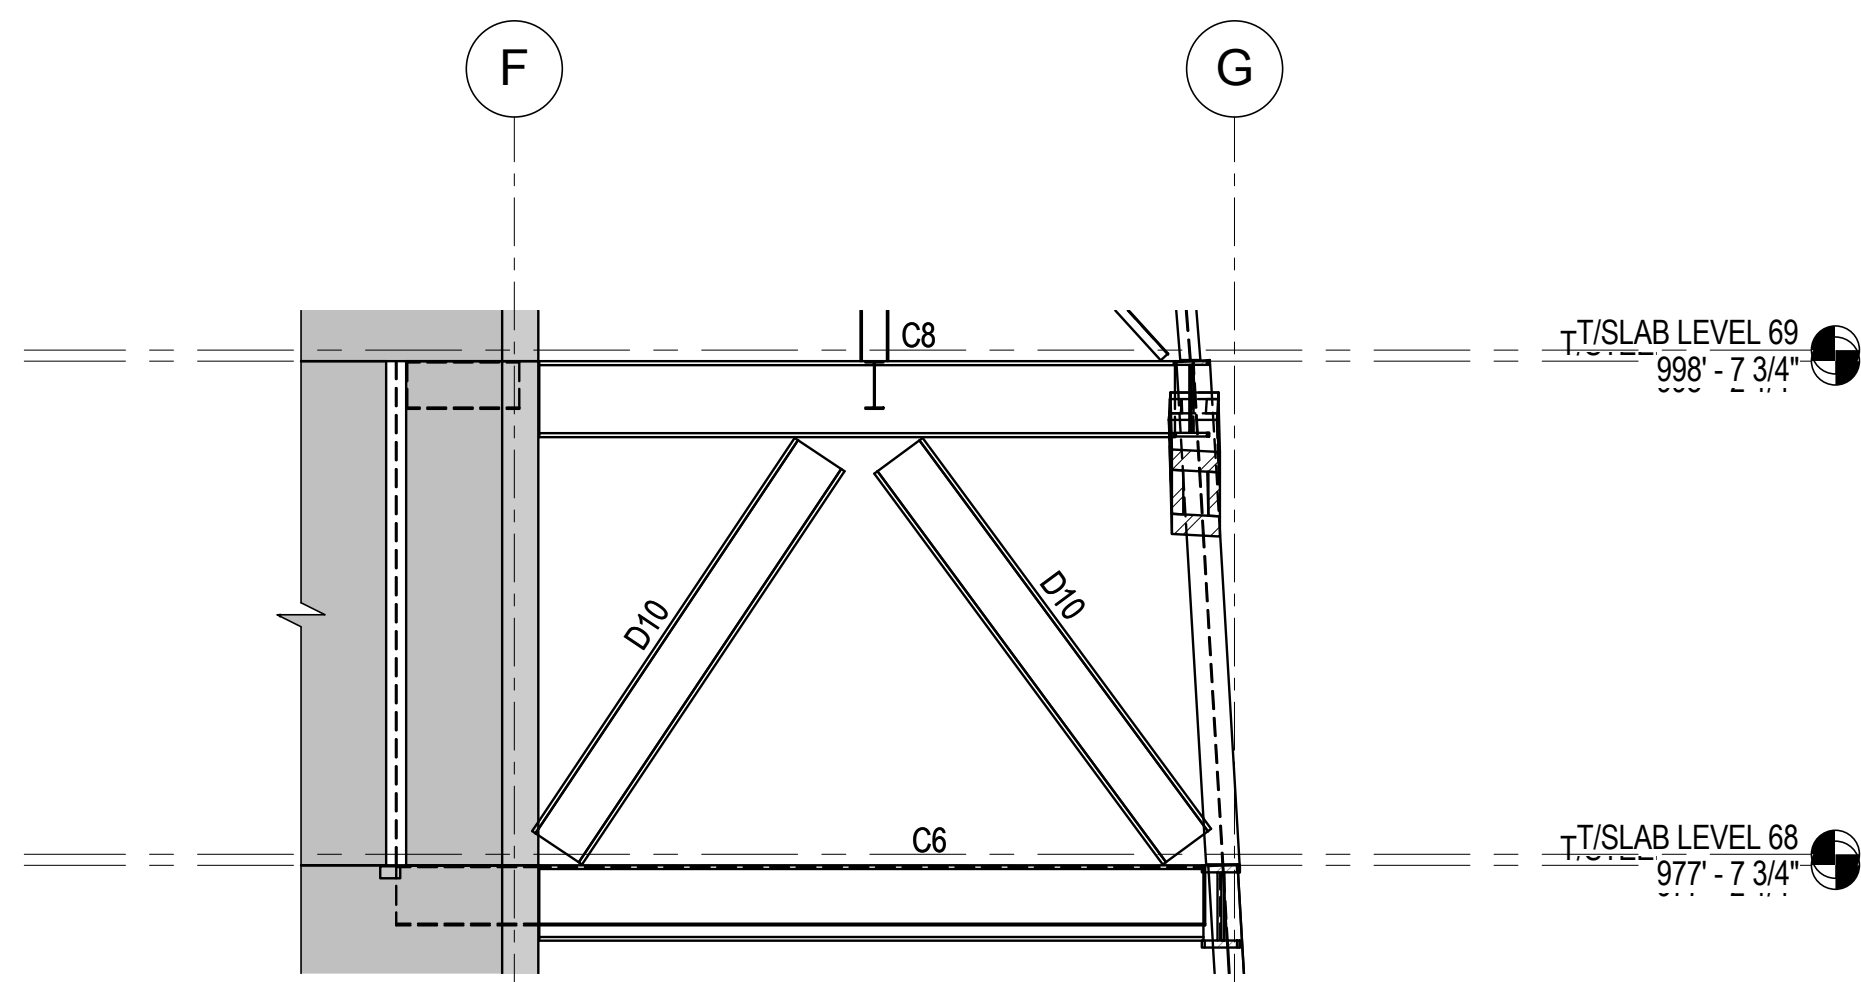


1 NORTH ELEVATION @ BELT TRUSS GRID LINE 1 (LOOKING NORTH)
1/8" = 1'-0"

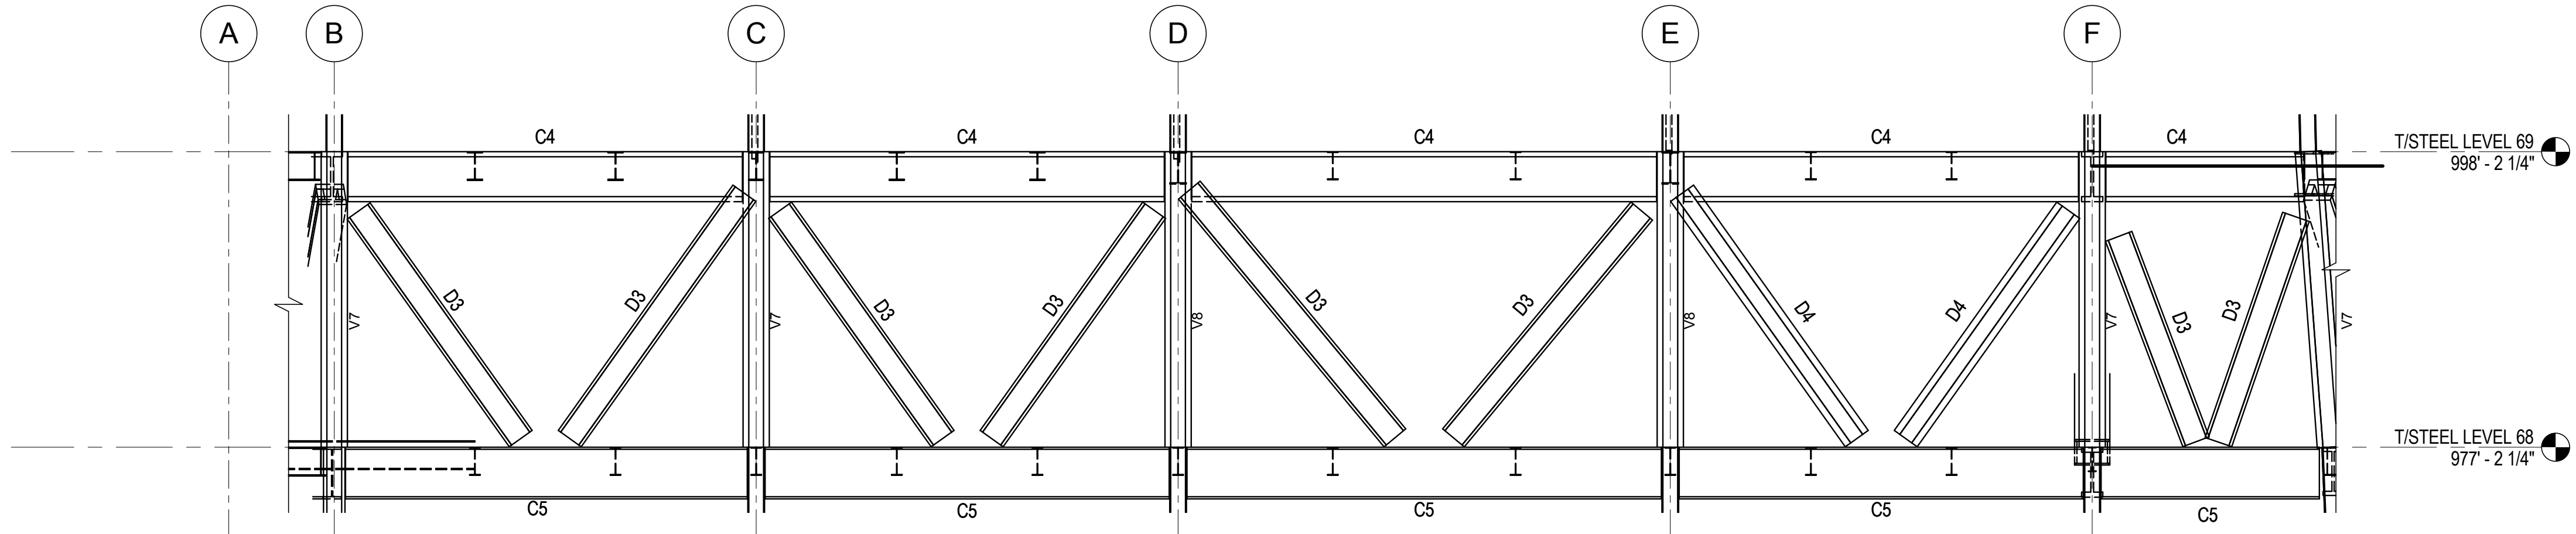


2 SOUTH ELEVATION @ BELT TRUSS GRID LINE 7 (LOOKING NORTH)
1/8" = 1'-0"

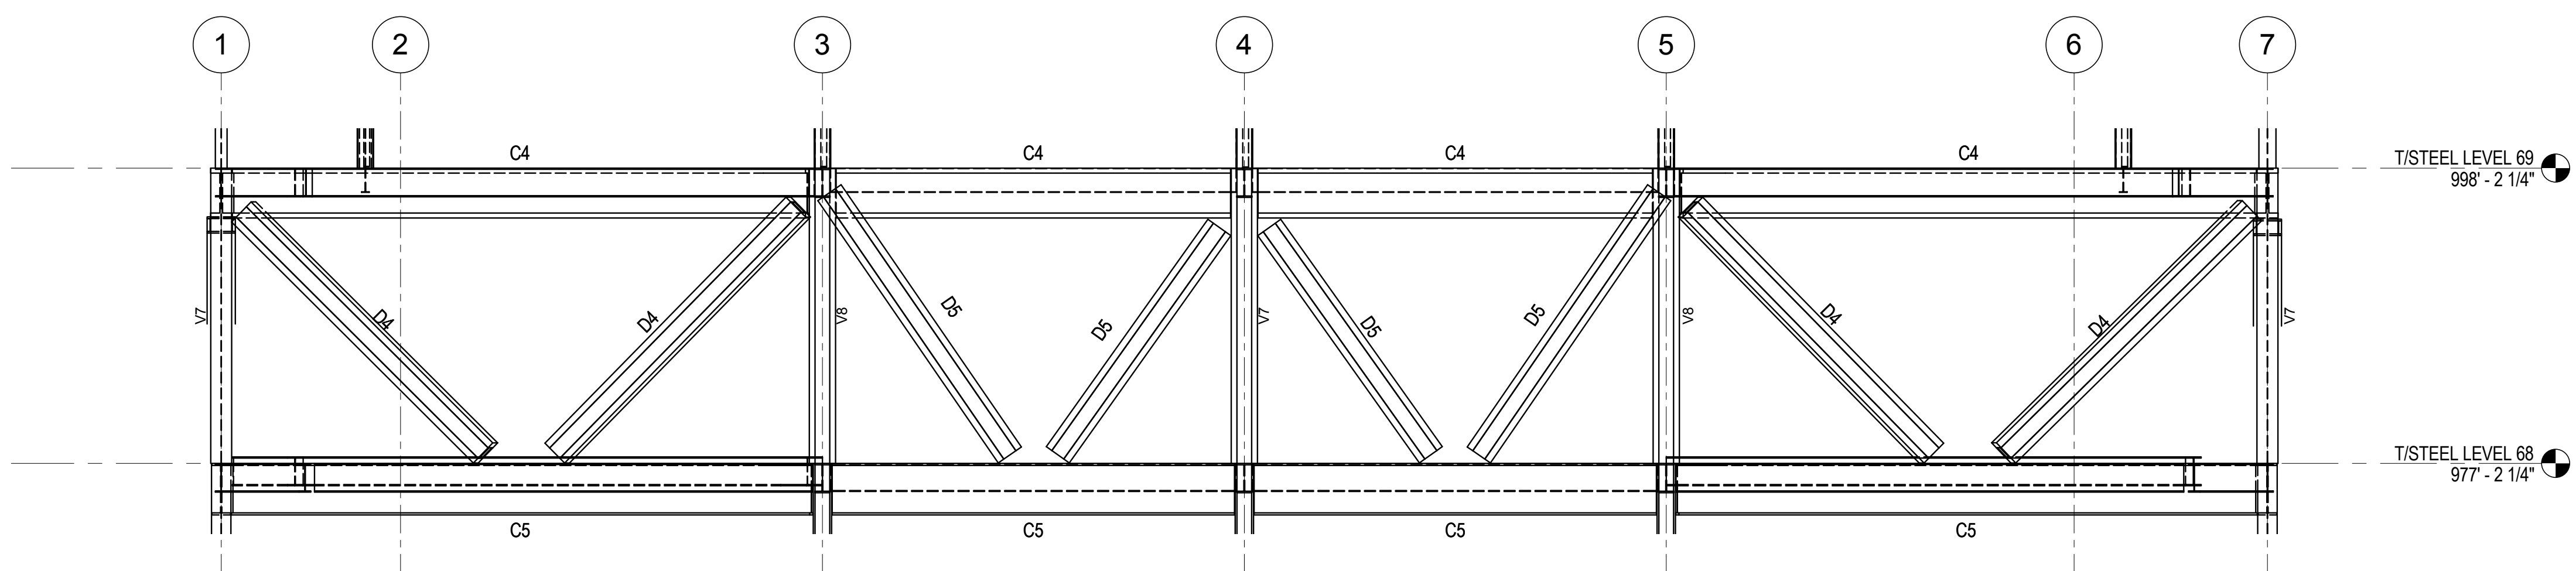

3 WEST ELEVATION @ BELT TRUSS GRID LINE A (LOOKING EAST)
1/8" = 1'-0"

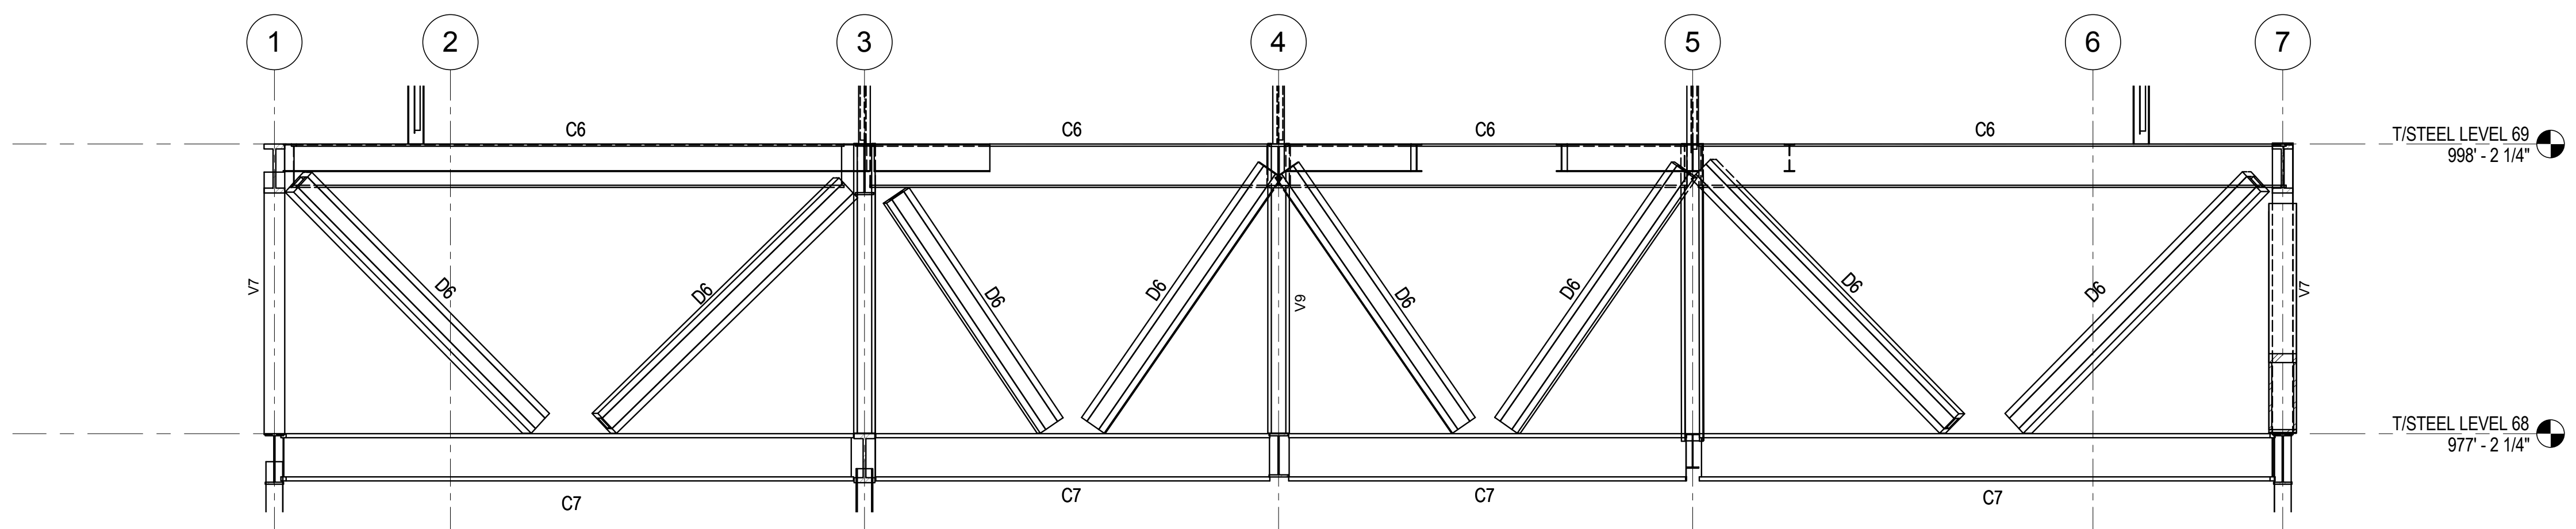

4 EAST ELEVATION @ BELT TRUSS GRID LINE G (LOOKING EAST)
1/8" = 1'-0"

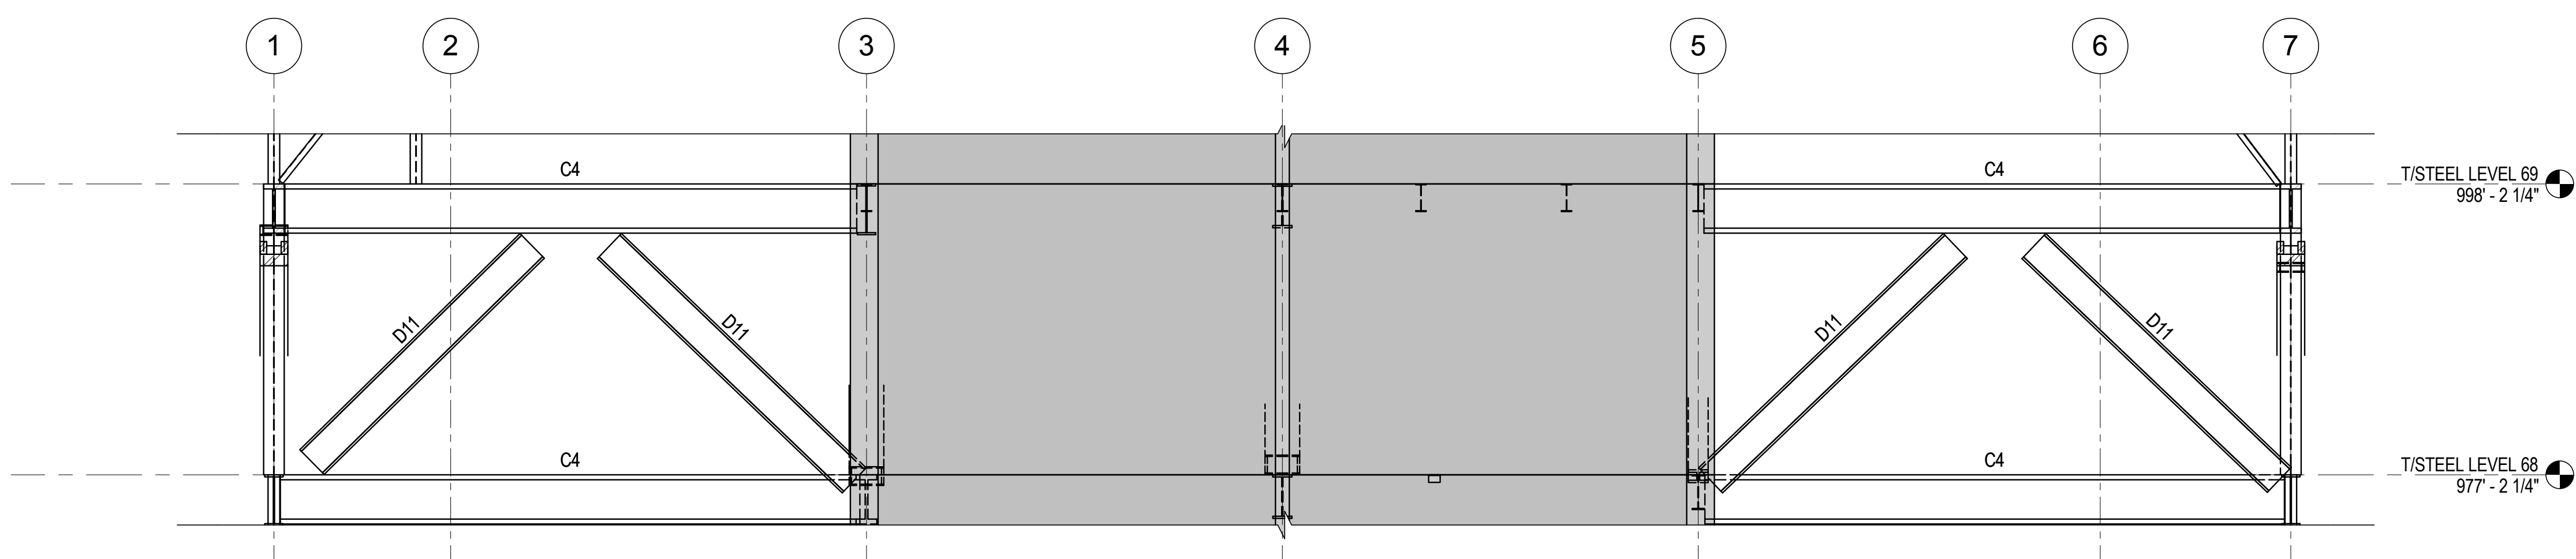

7 ELEVATION @ LINE F (LOOKING EAST)
1/8" = 1'-0"

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Key Plan:

Seal & Signature:


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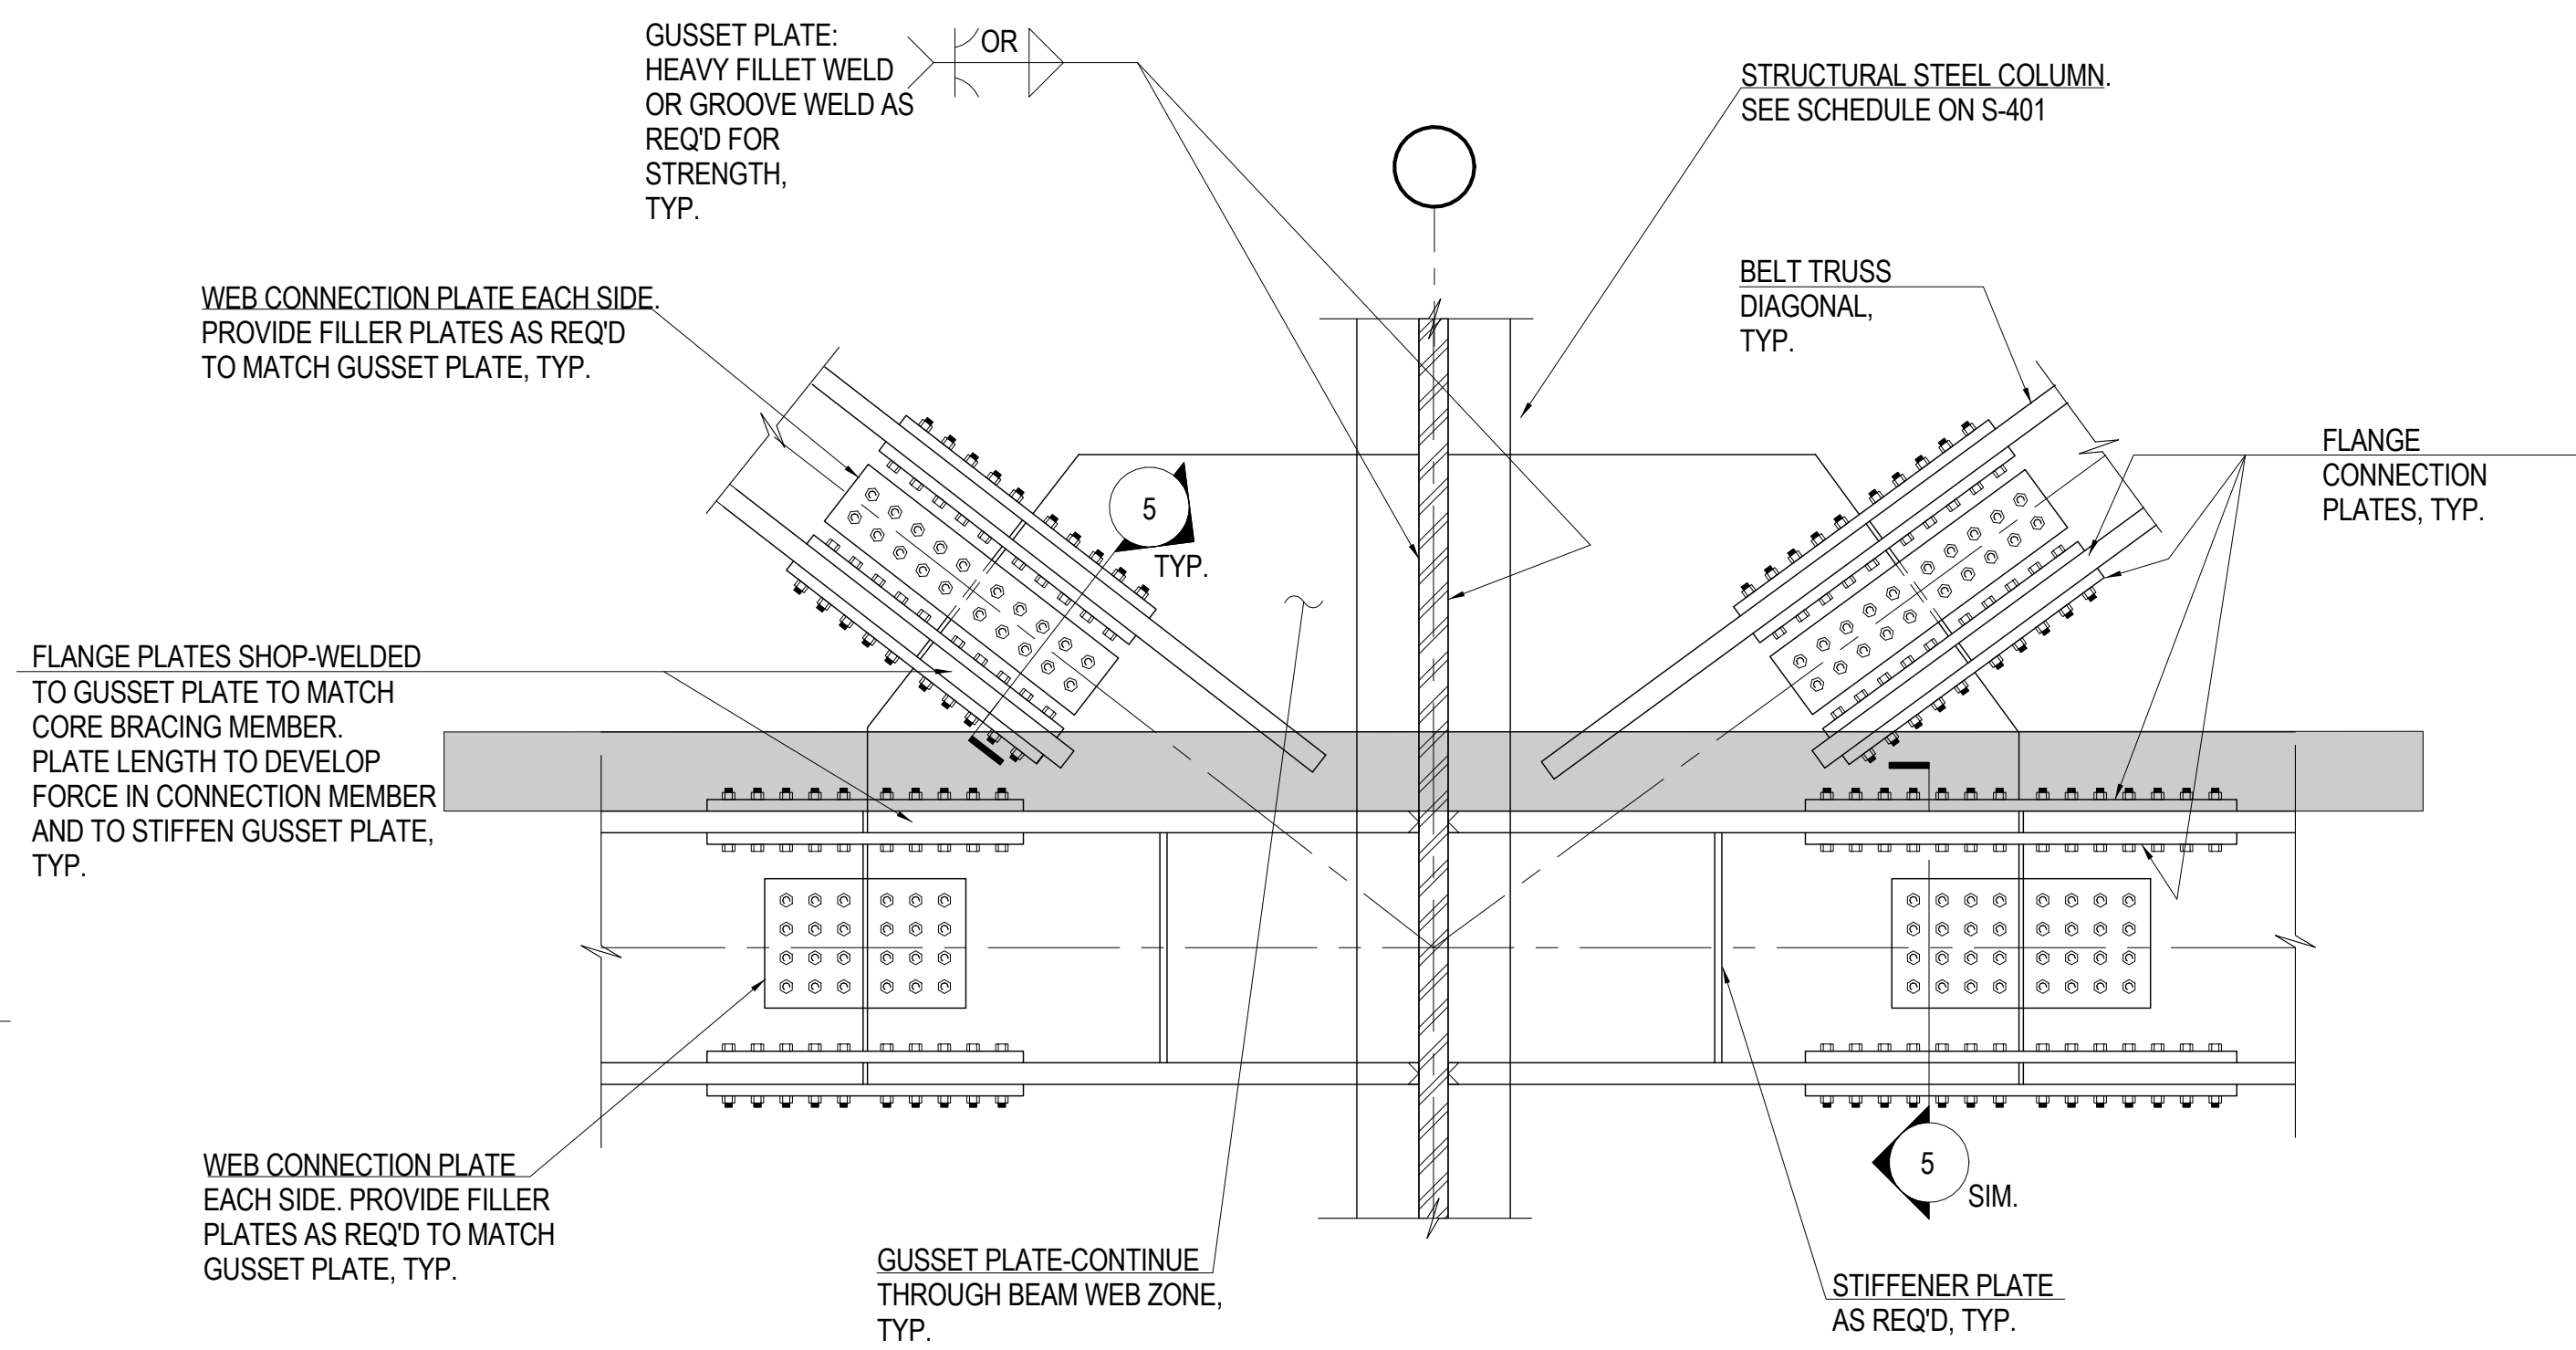
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**UPPER BELT
TRUSS
SCHEDULES,
SECTIONS &
DETAILS**


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Date: 20 JUN 2014	Sheet No.: S-416
Scale: As indicated	Page No.: 85 of 90
File No.: S-416	




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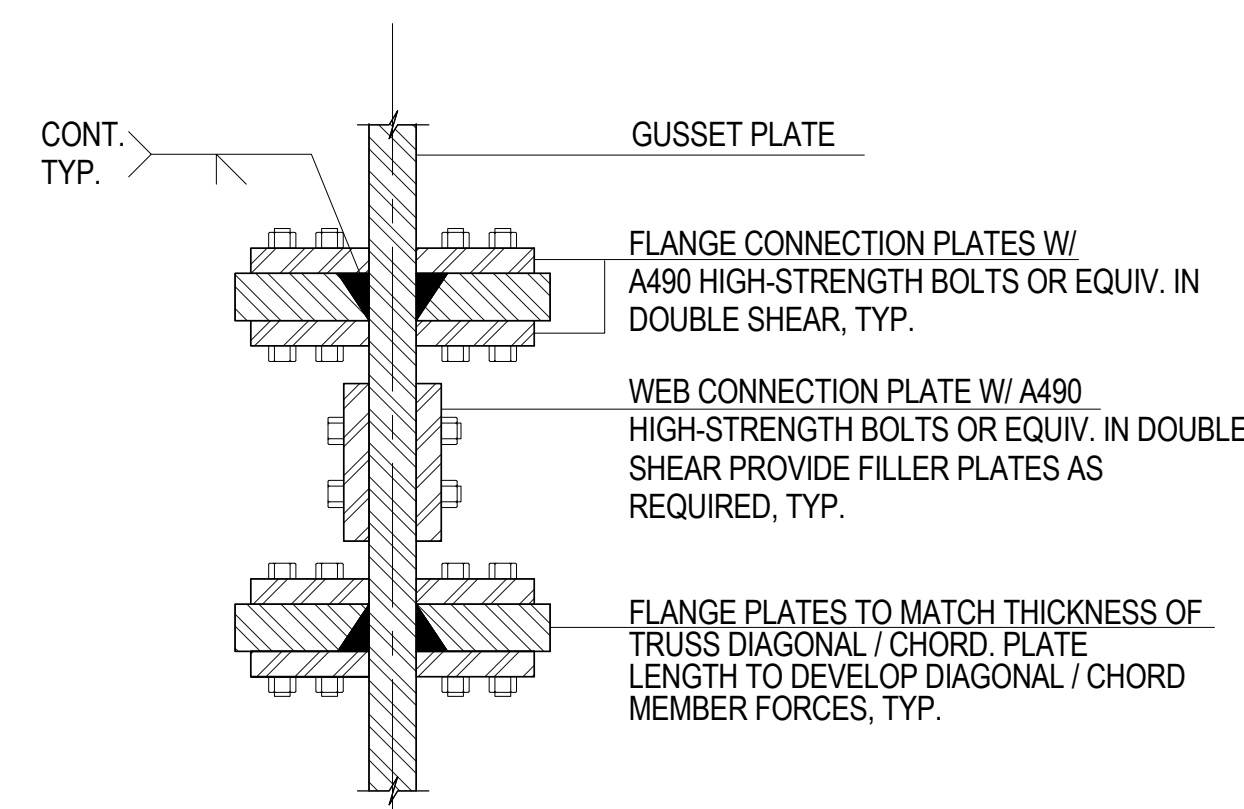
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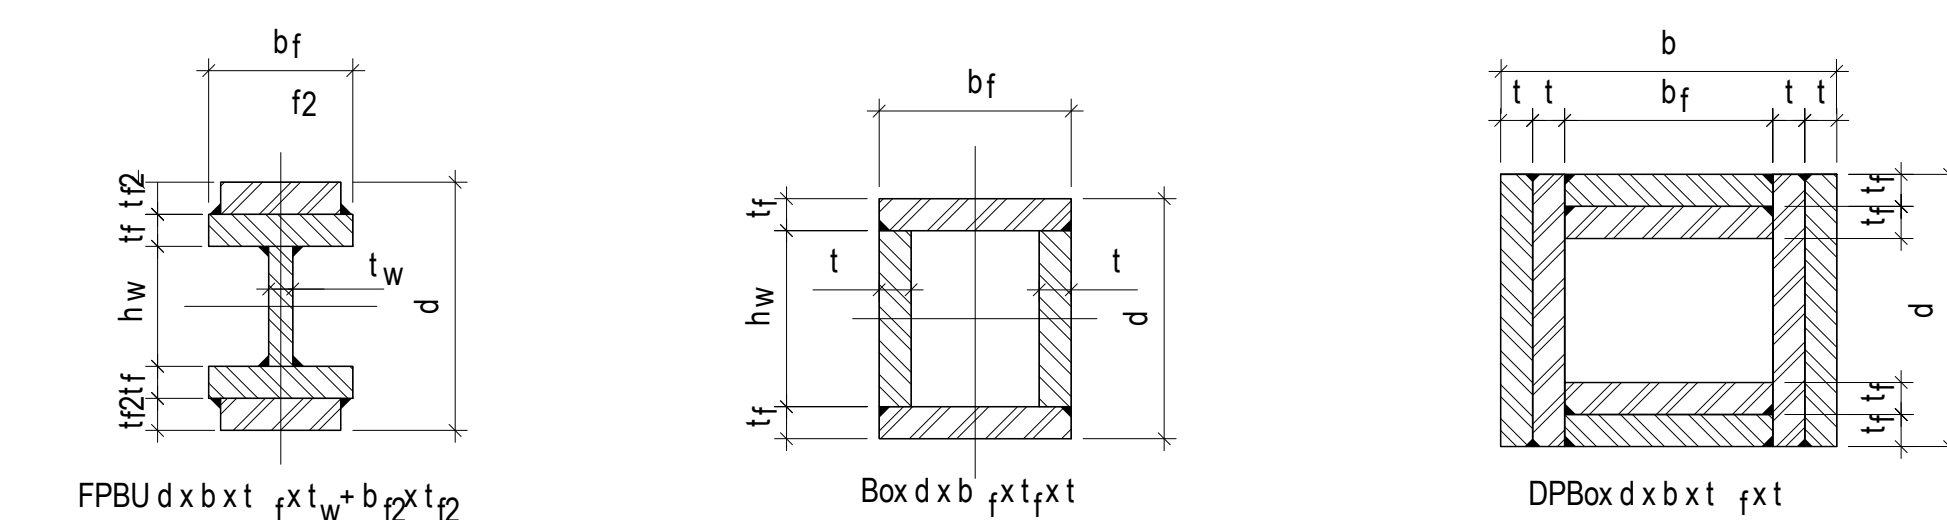
3 BELT TRUSS BRACING CONNECTION DETAIL

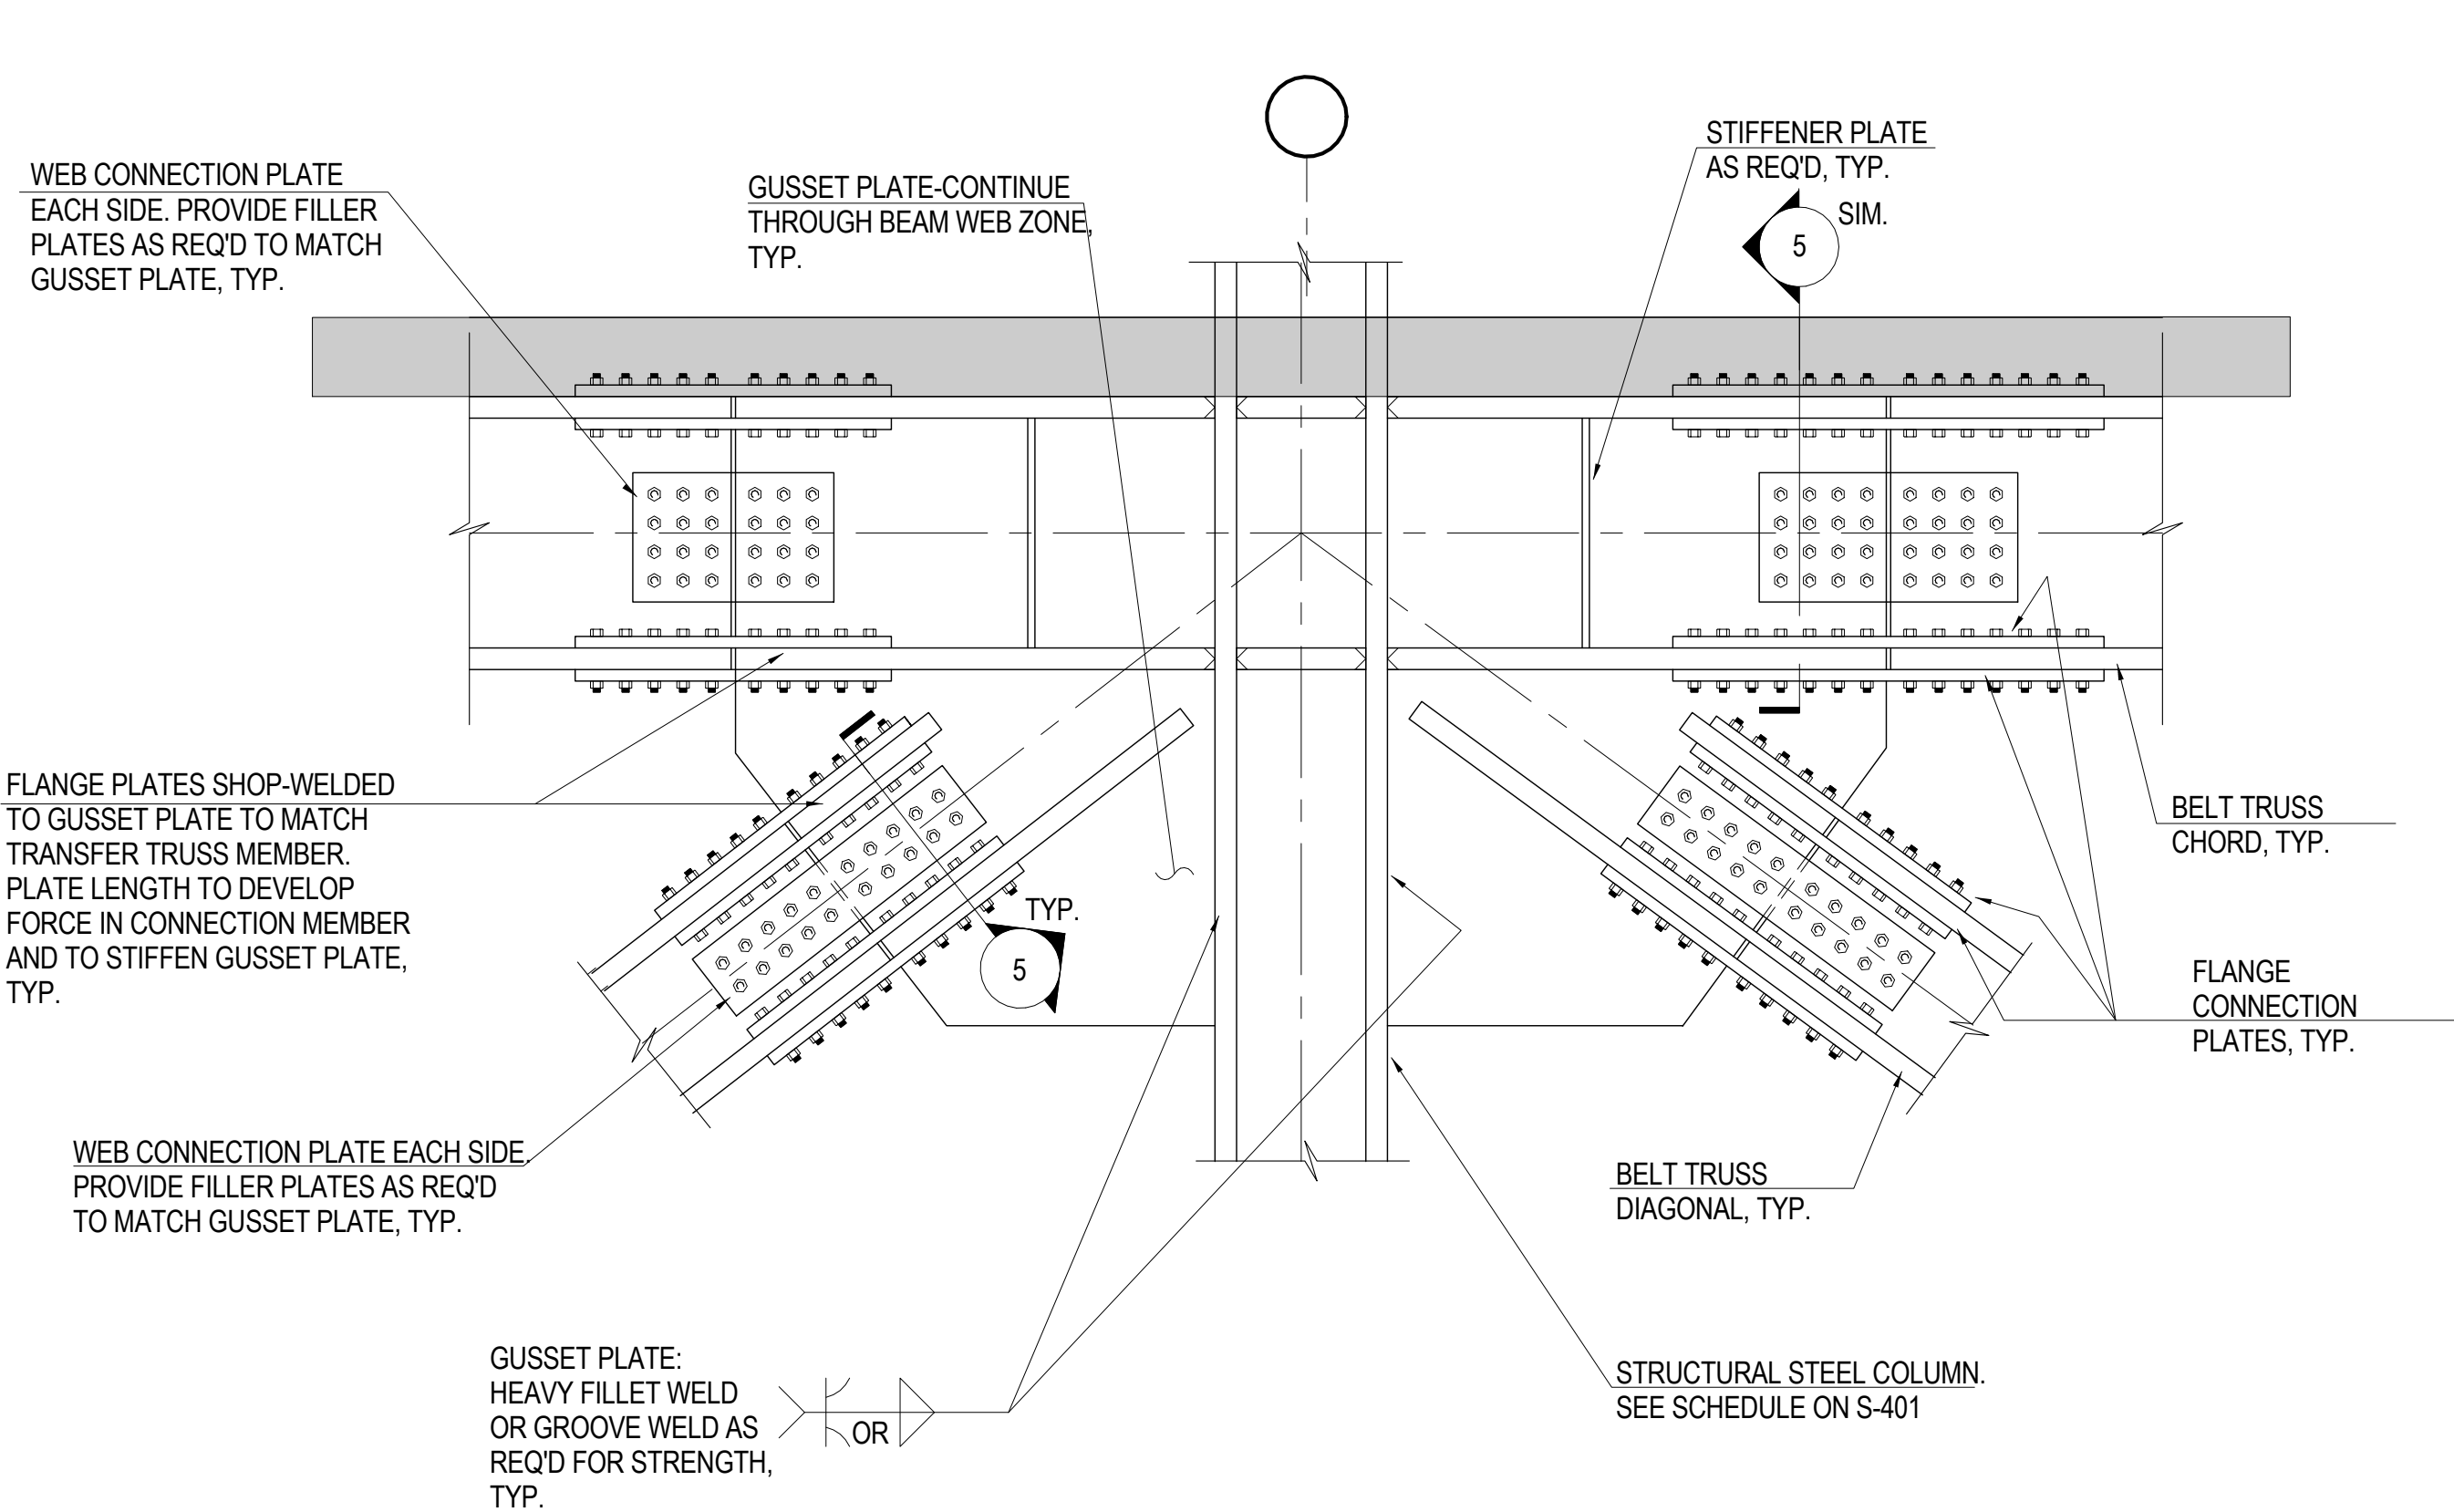

4 BELT TRUSS BRACING BOTTOM CONNECTION DETAIL

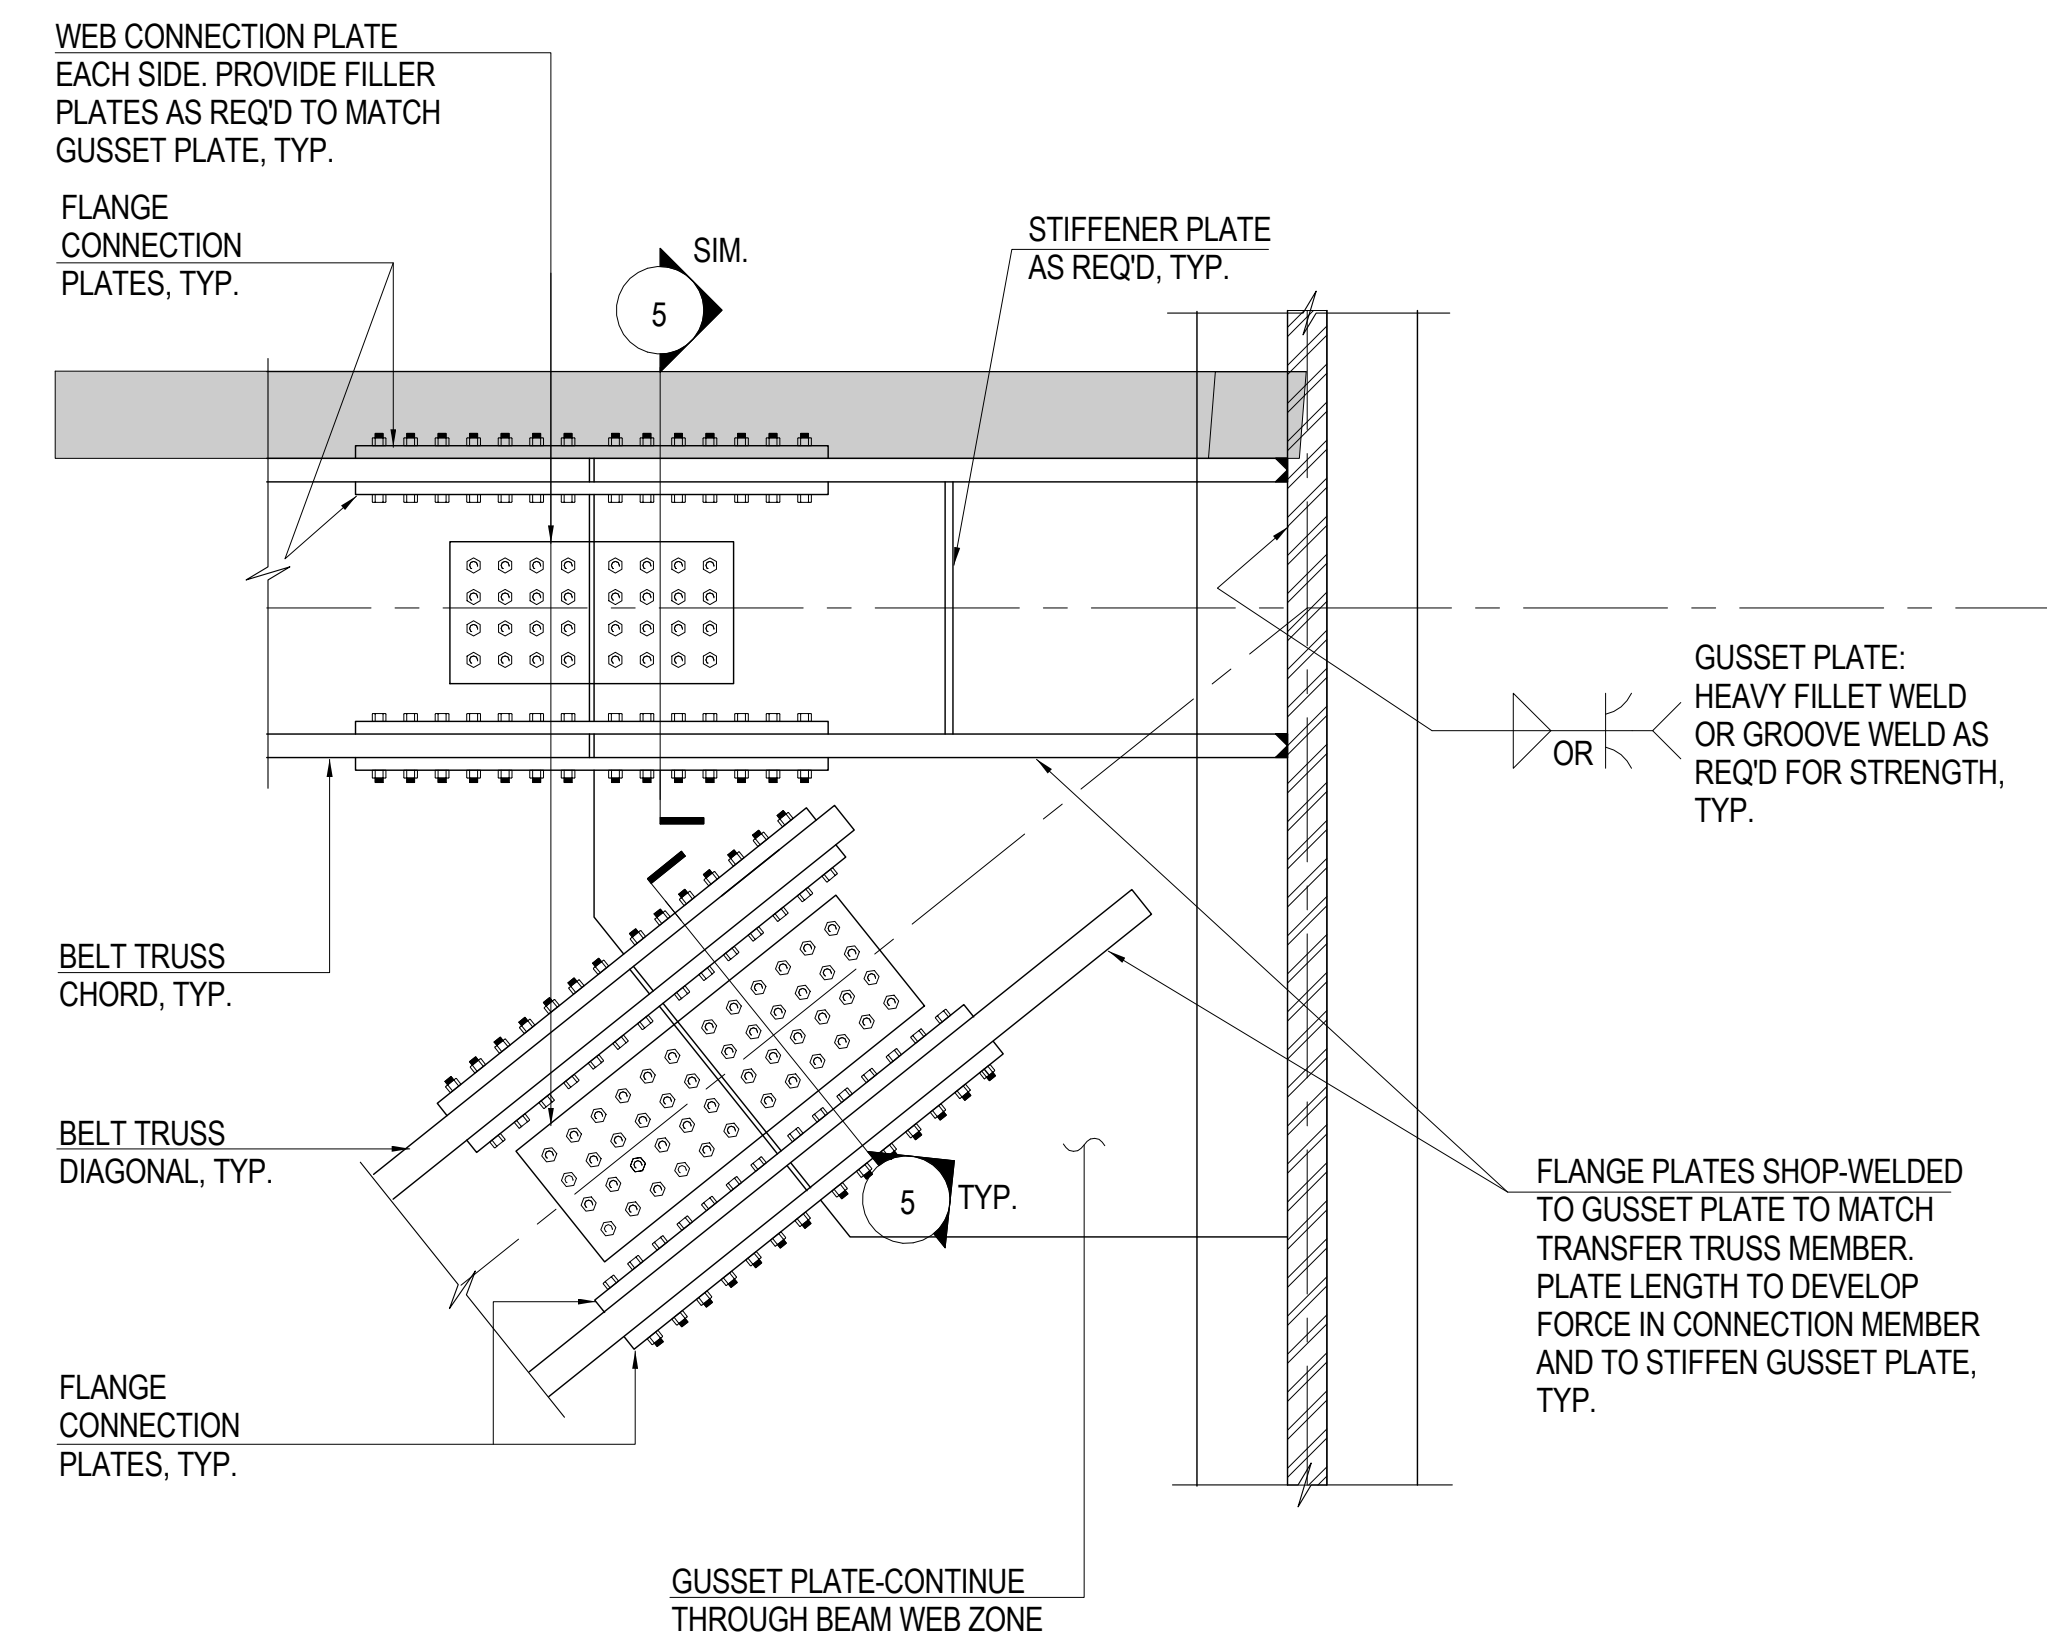

5 TYPICAL DIAGONAL / CHORD TO GUSSET PLATE CONNECTION

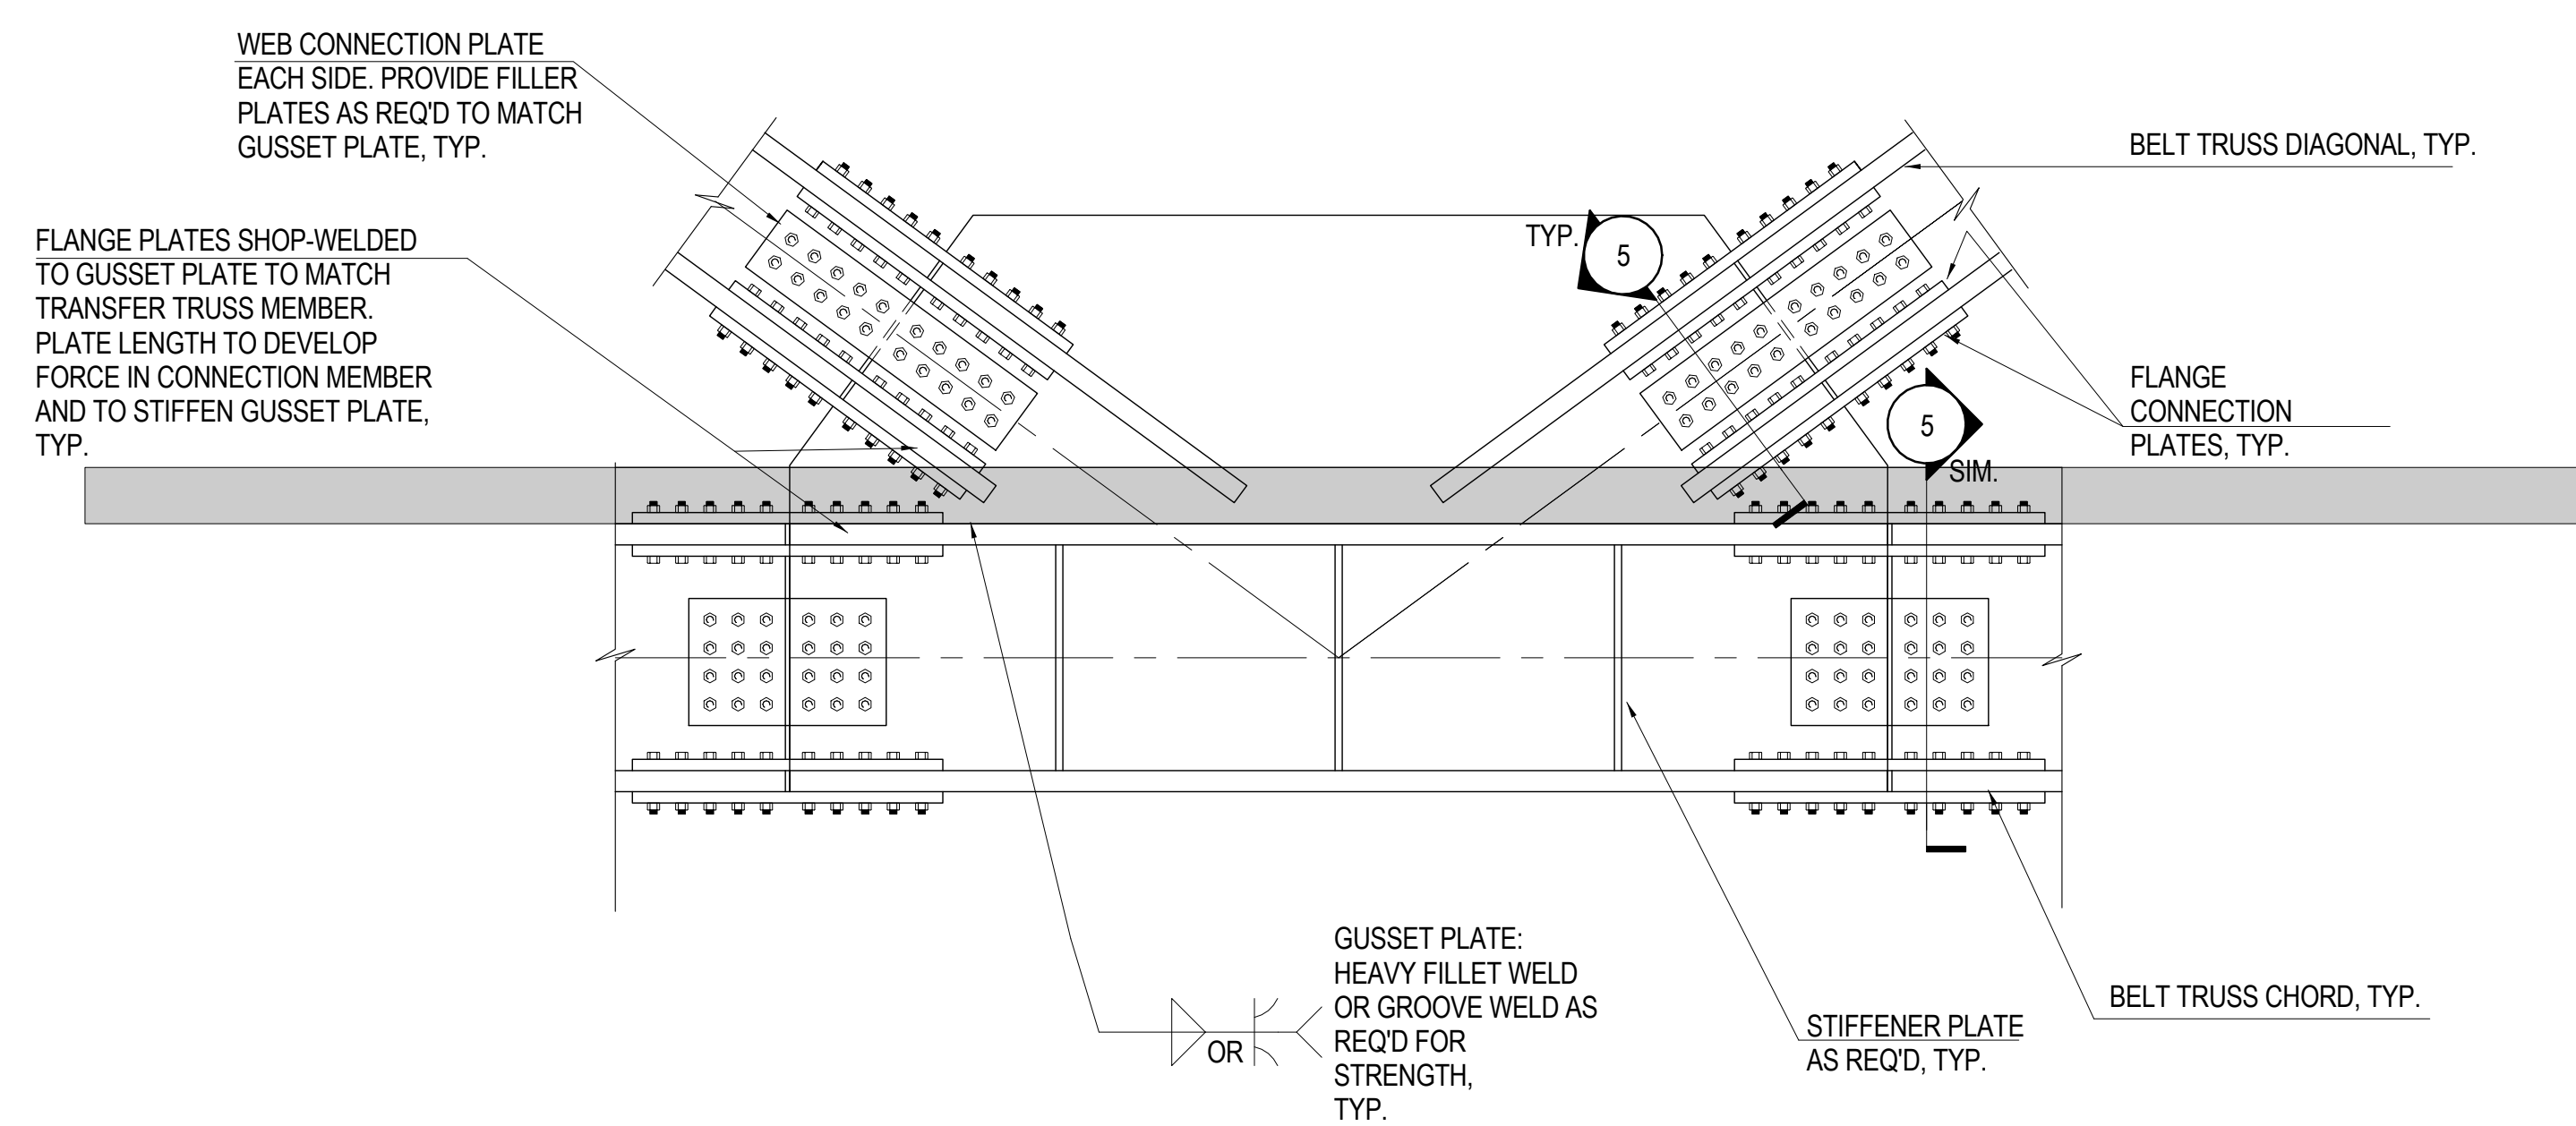

A FPBU- FLANGE
PLATED BUILT UP

B BOX

C DPBOX- DOUBLE
PLATED BOX

NOMENCLATURE FOR BUILT-UP SECTIONS



**MANHATTAN WEST:
NORTH TOWER**
375 Ninth Avenue, New York, NY 10001

Brookfield

Brockfield Place
250 Vesey Street, 15th Floor, New York, NY 10281

Architecture/Structural Engineering

Skidmore, Owings & Merrill LLP
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Civil Engineering
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MEP Engineering
Jaros Baum & Bolles
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Vertical Transportation
Edgett Williams Consulting Group, Inc.
102 East Blithedale Ave. Suite 1, Mill Valley, California 94941

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Mueser Rutledge Consulting Engineers
 14 Penn Plaza, 225 W. 34th Street #610,
 New York, NY 10122

Field Operations
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Ducibella, Ventor & Santore
250 State Street #F1, North Haven, CT 06473

Weidinger Associates, Inc.
40 Wall Street, New York, NY 10005

Cerami & Associates
404 Fifth Avenue #8, New York, NY 10018


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215 West 40th Street, 15th Floor, New York, NY 10018


Entek Engineering LLC
166 Ames Street, Hackensack, NJ 07601

Wind Tunnel Consultant

Rowan Williams Davies & Irwin Inc.
650 Woodlawn Road West, Guelph
Ontario, Canada N1K 1B8

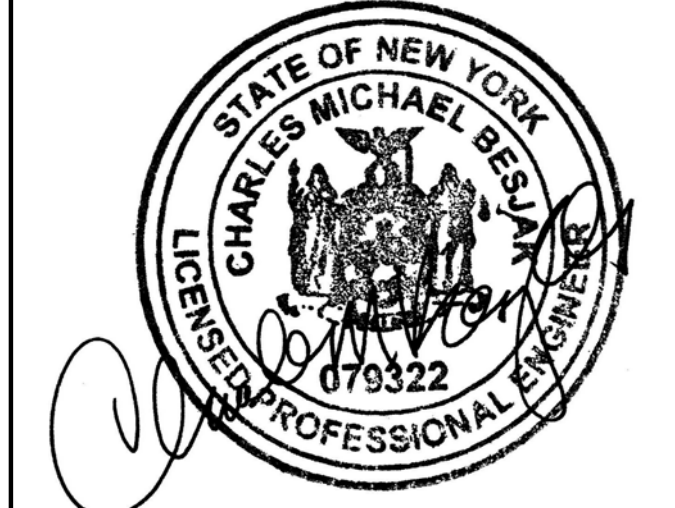

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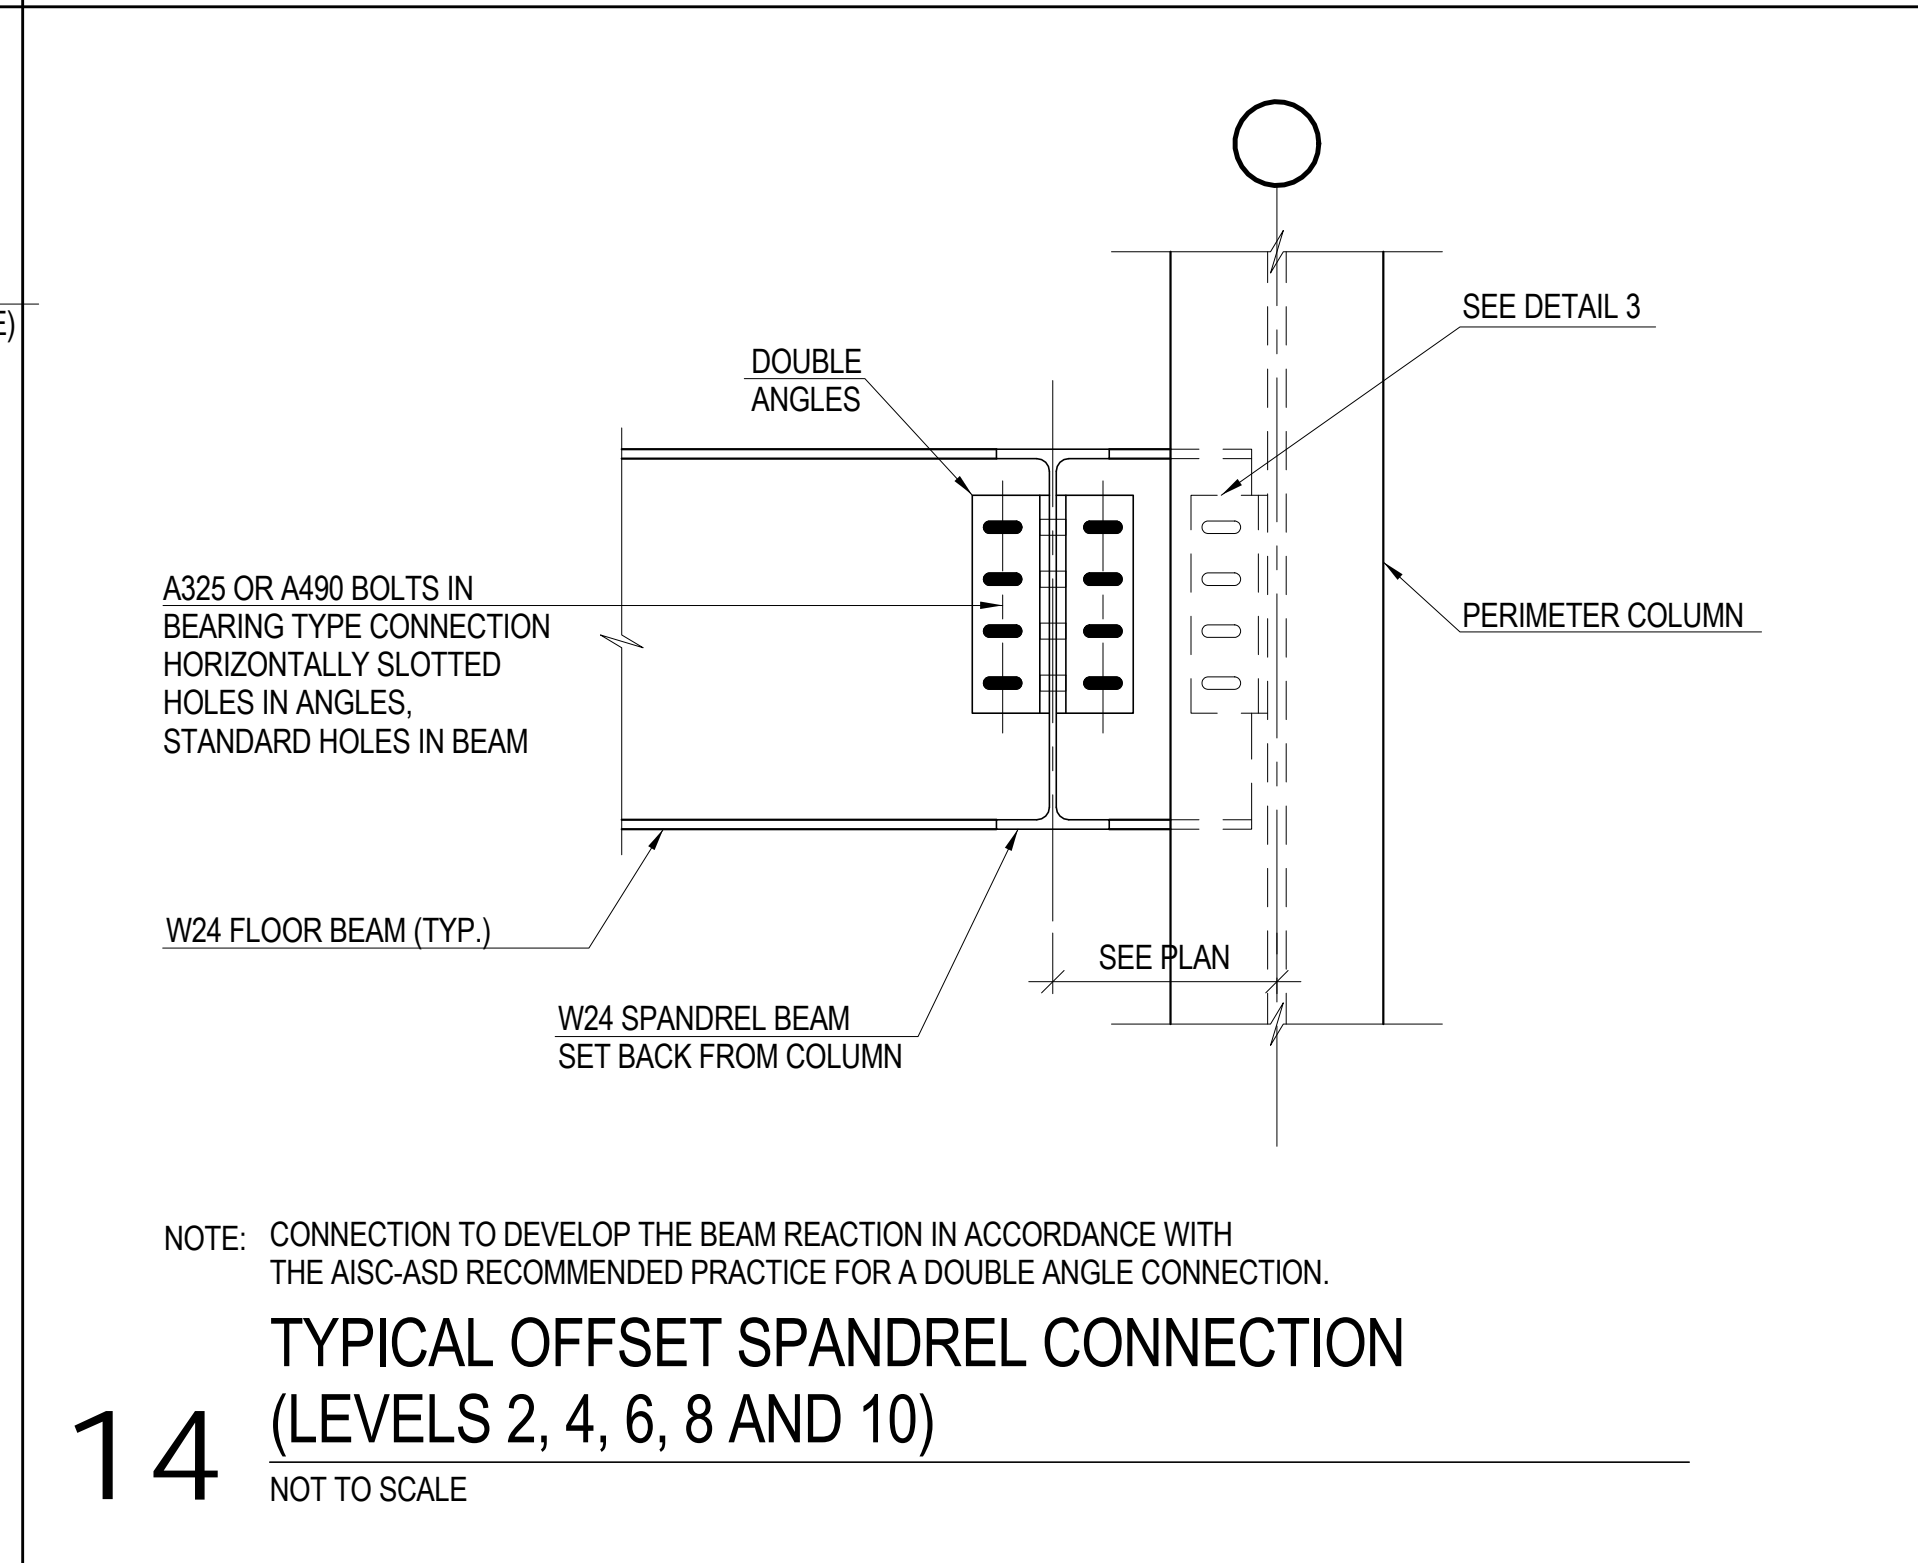
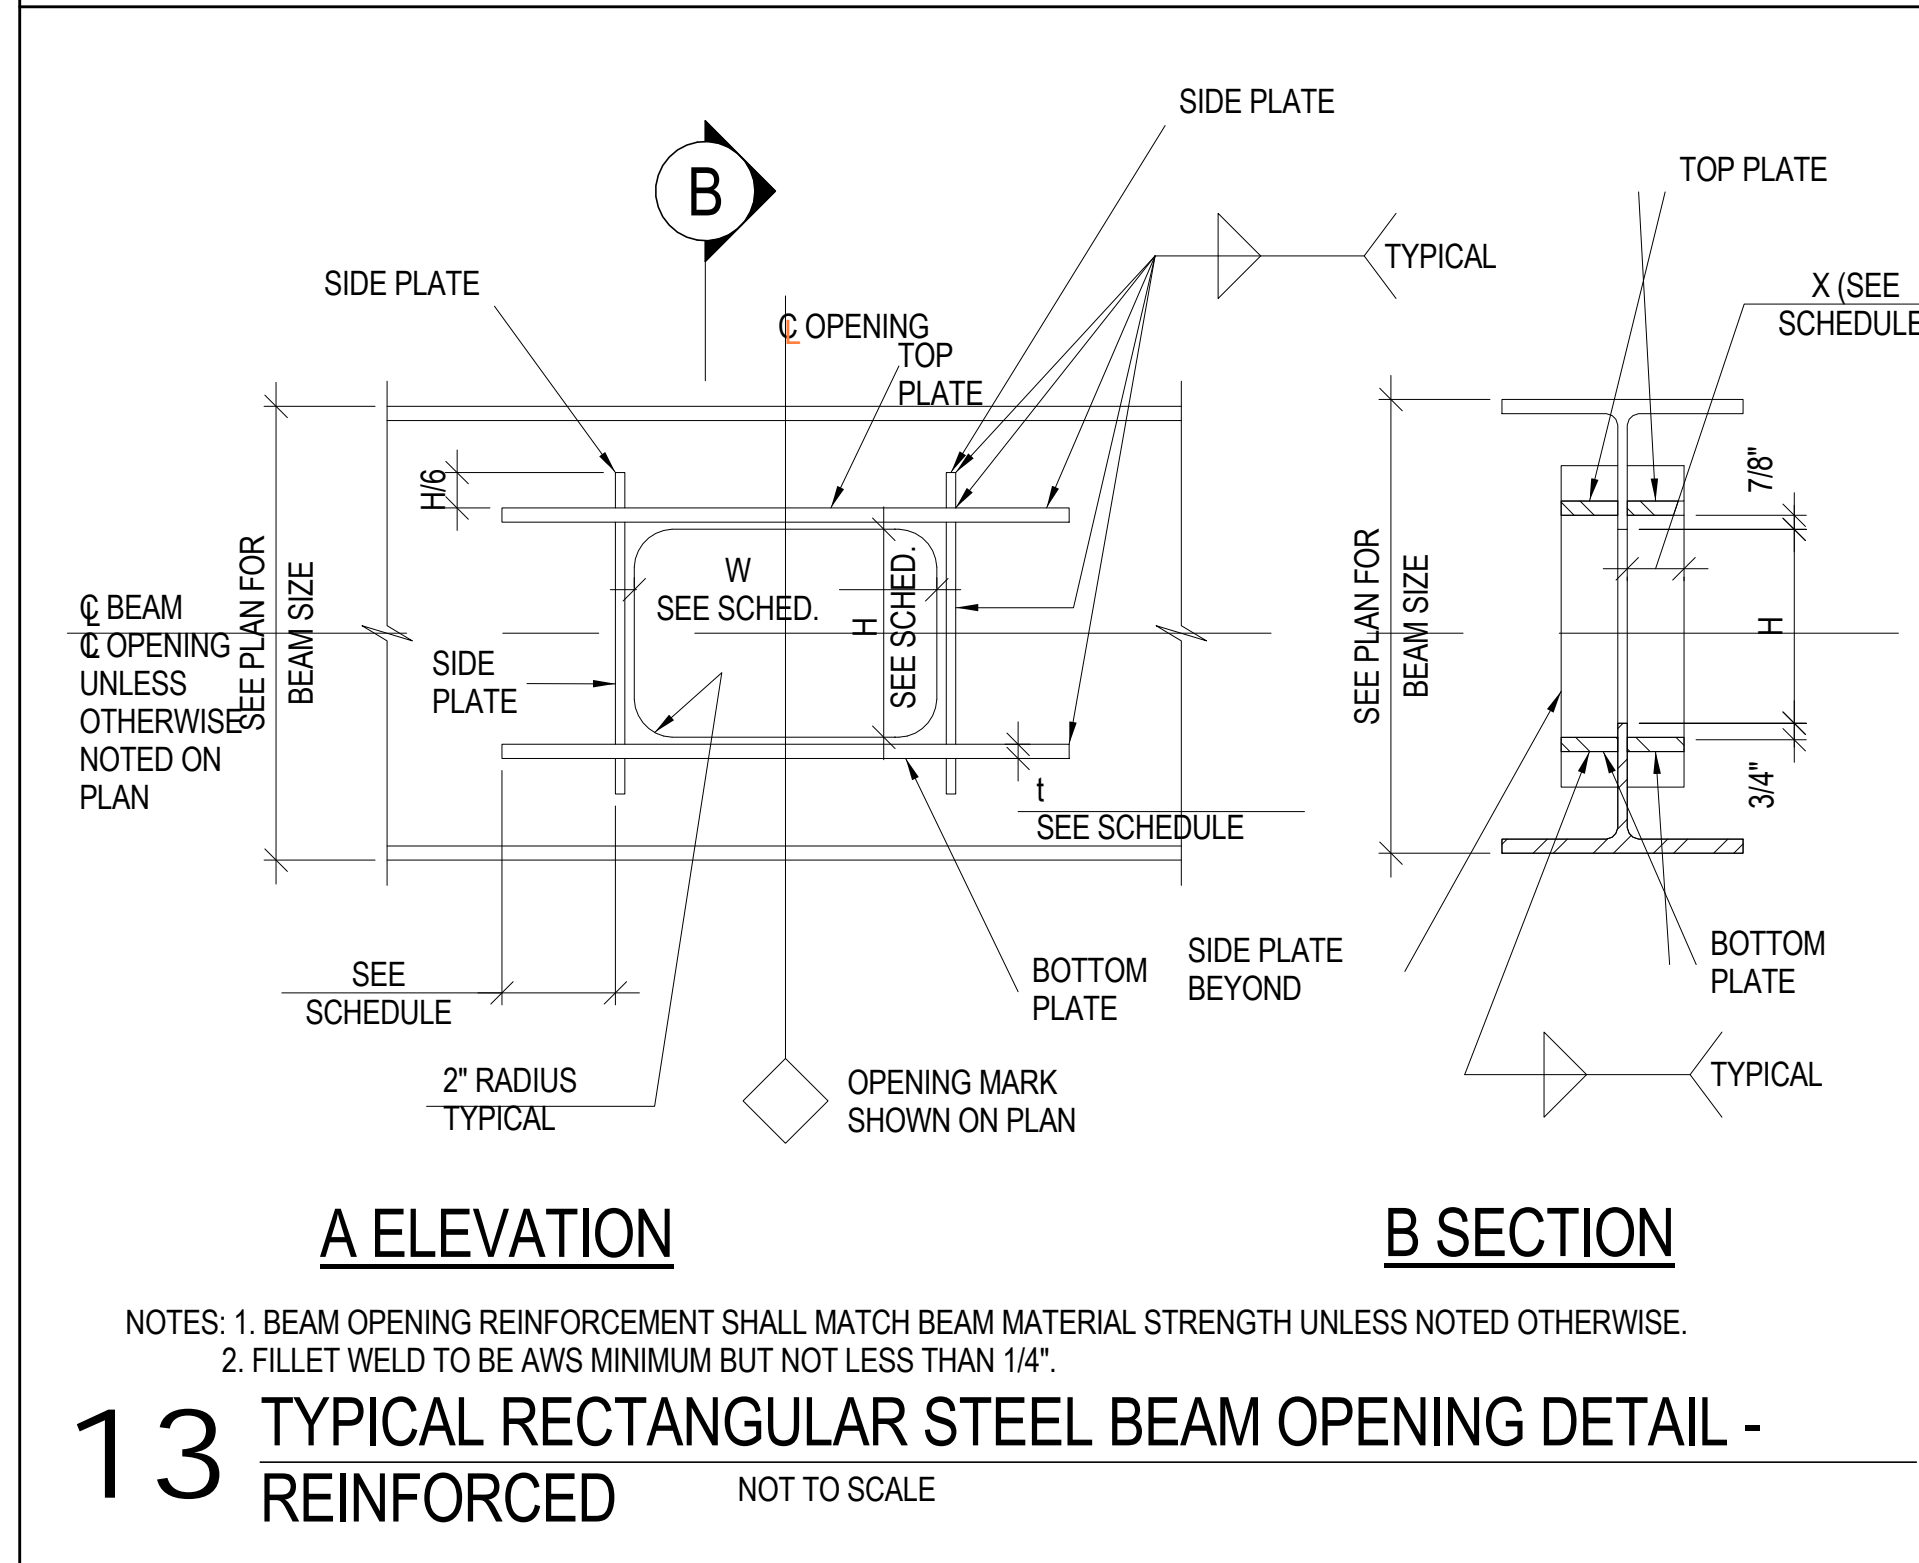
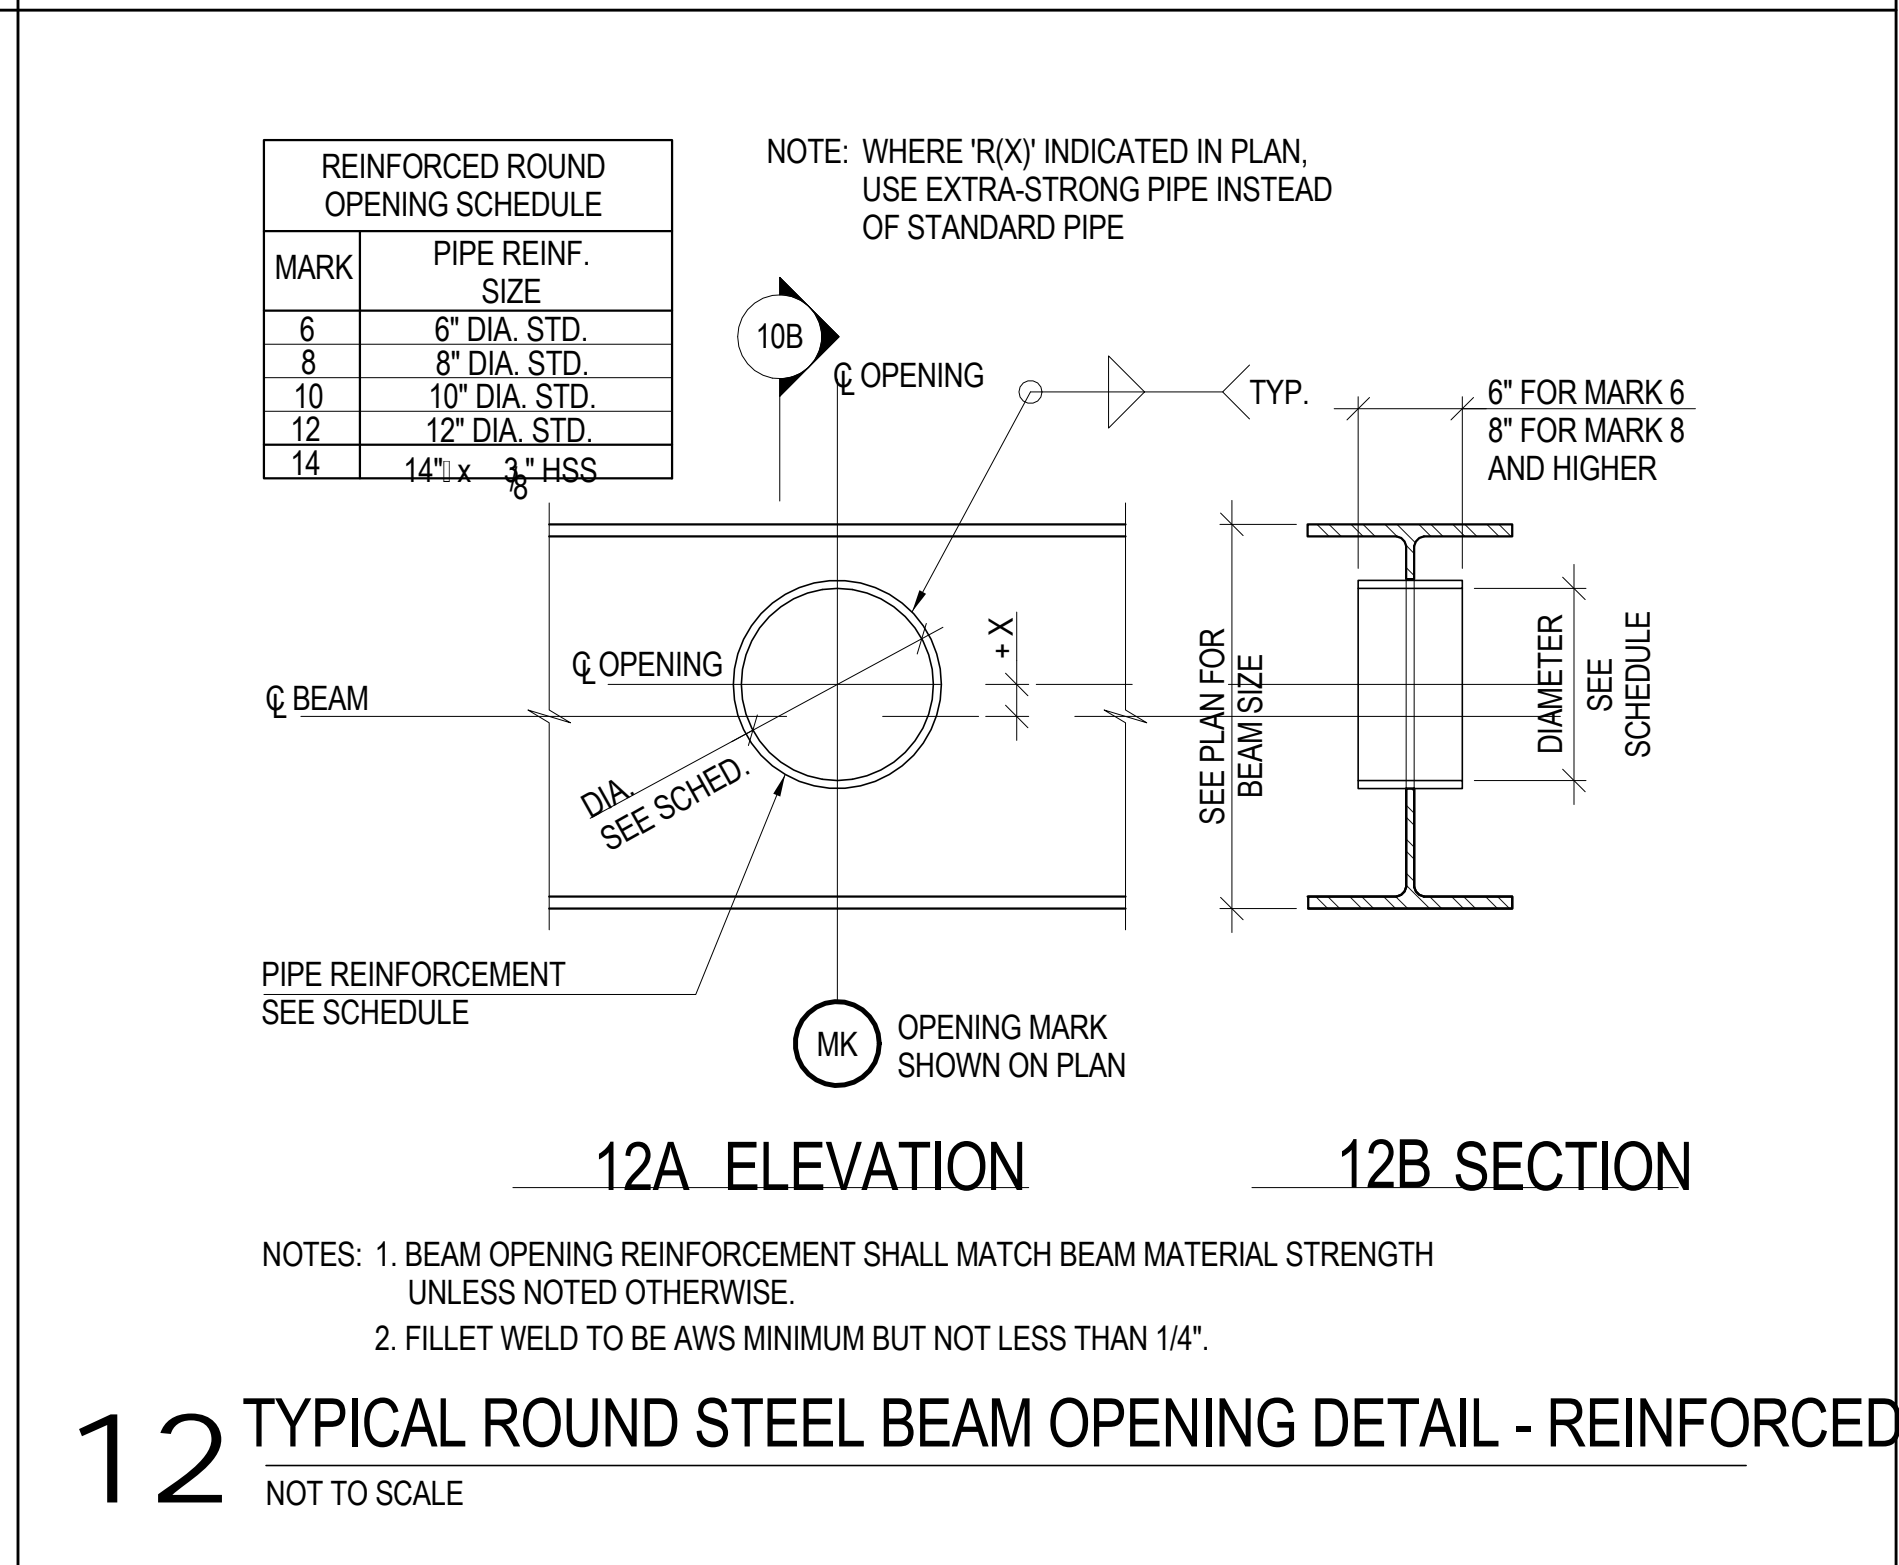
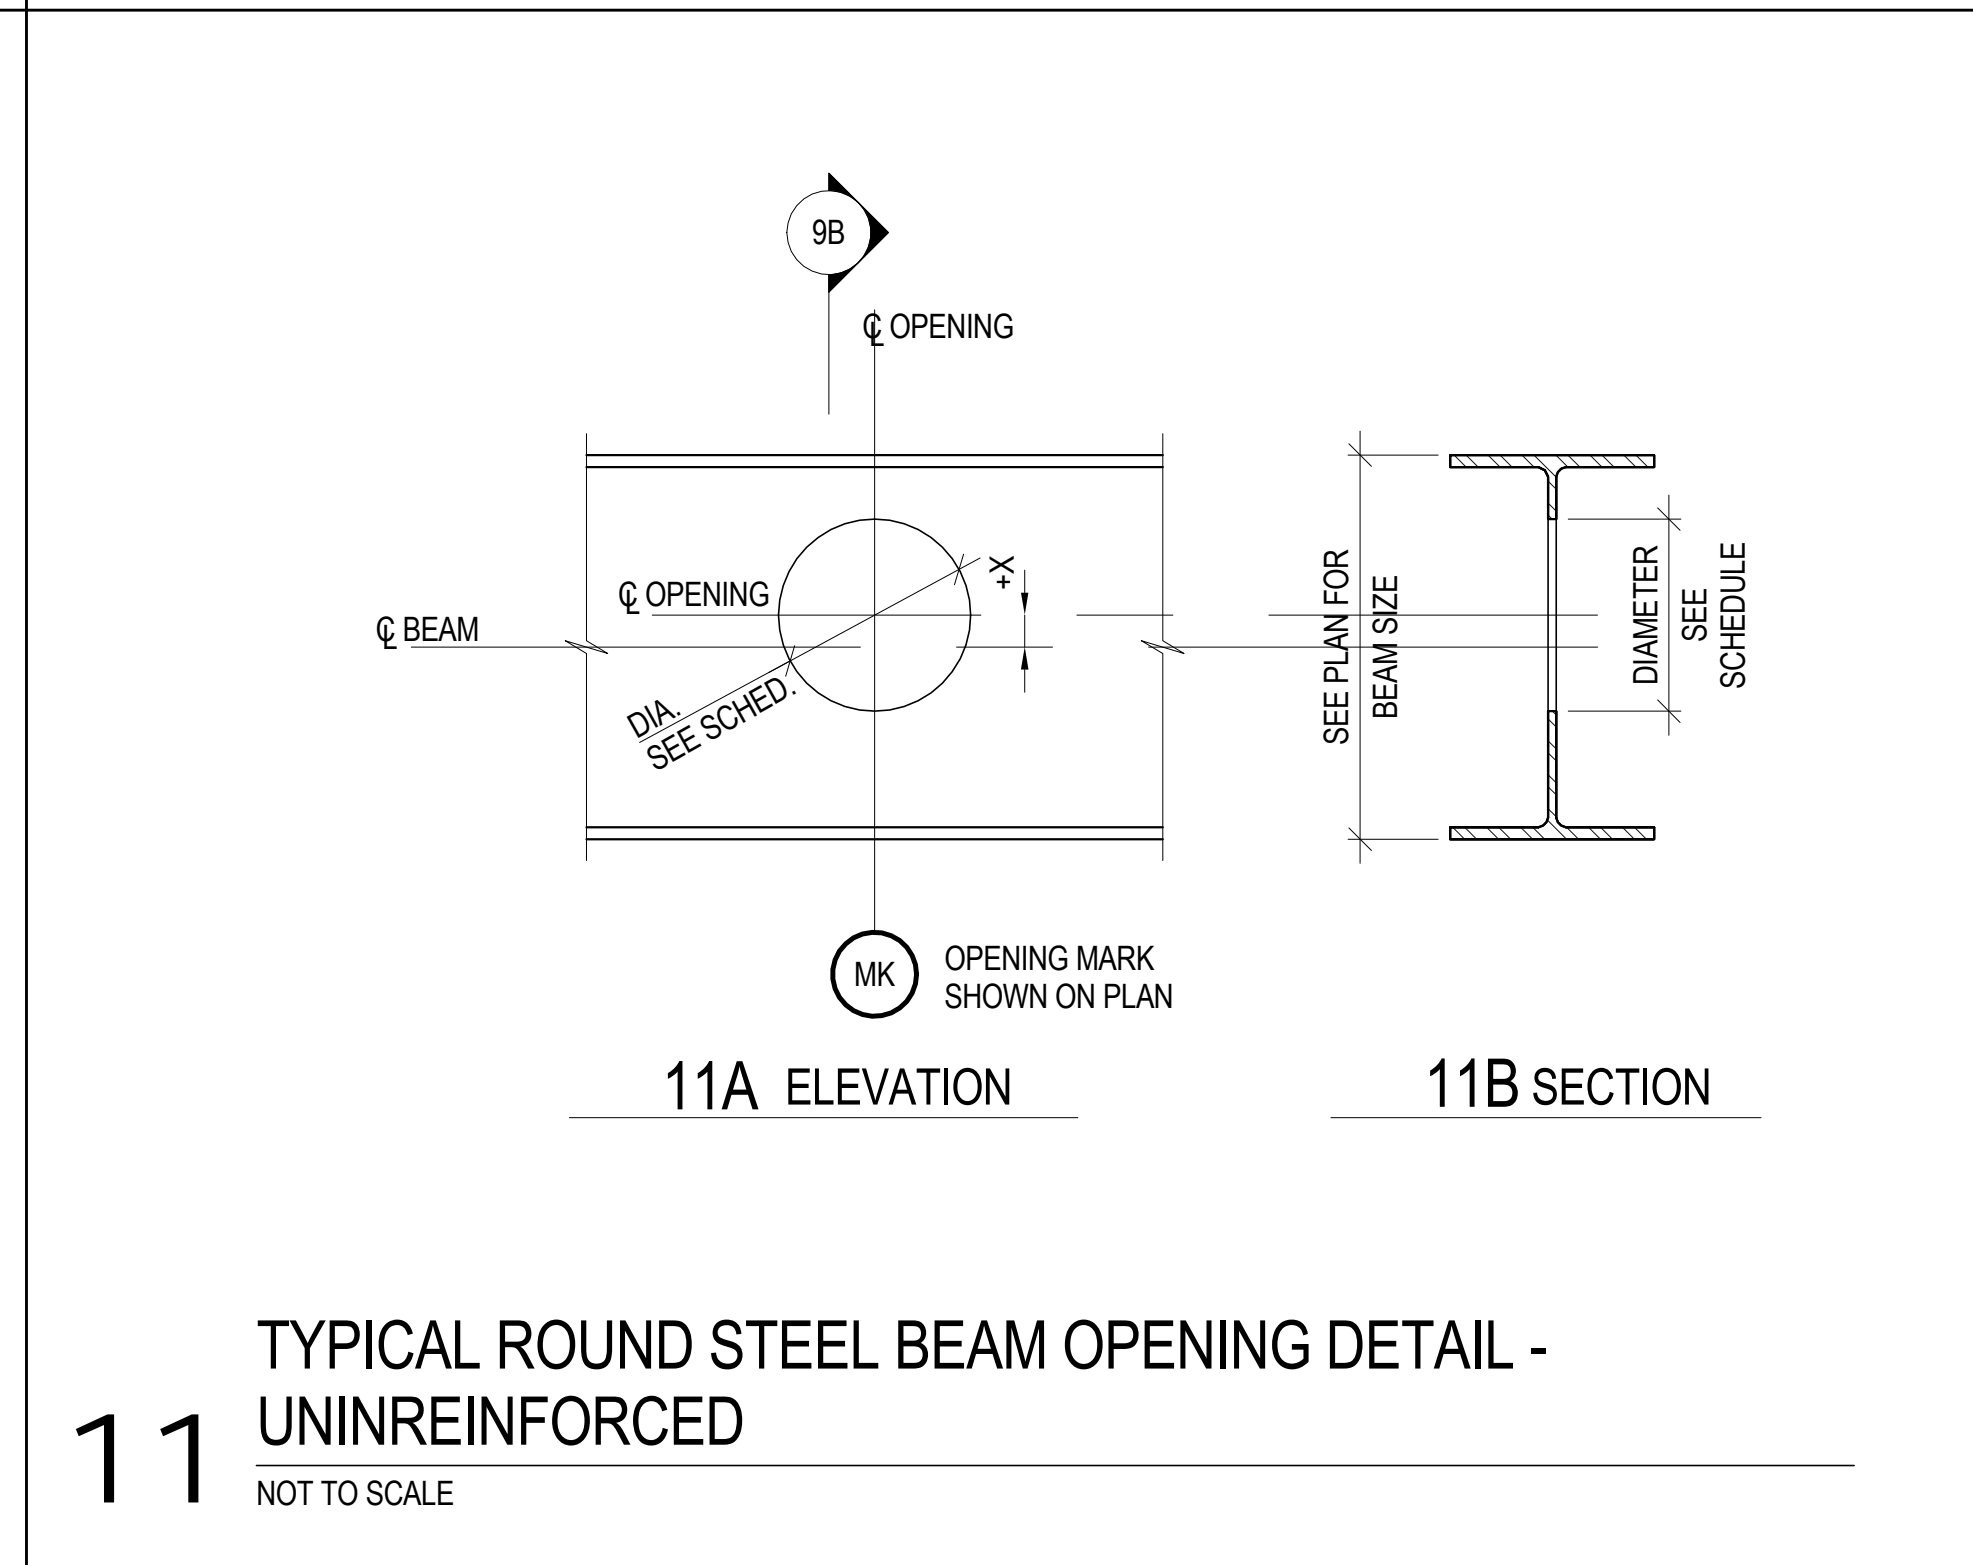
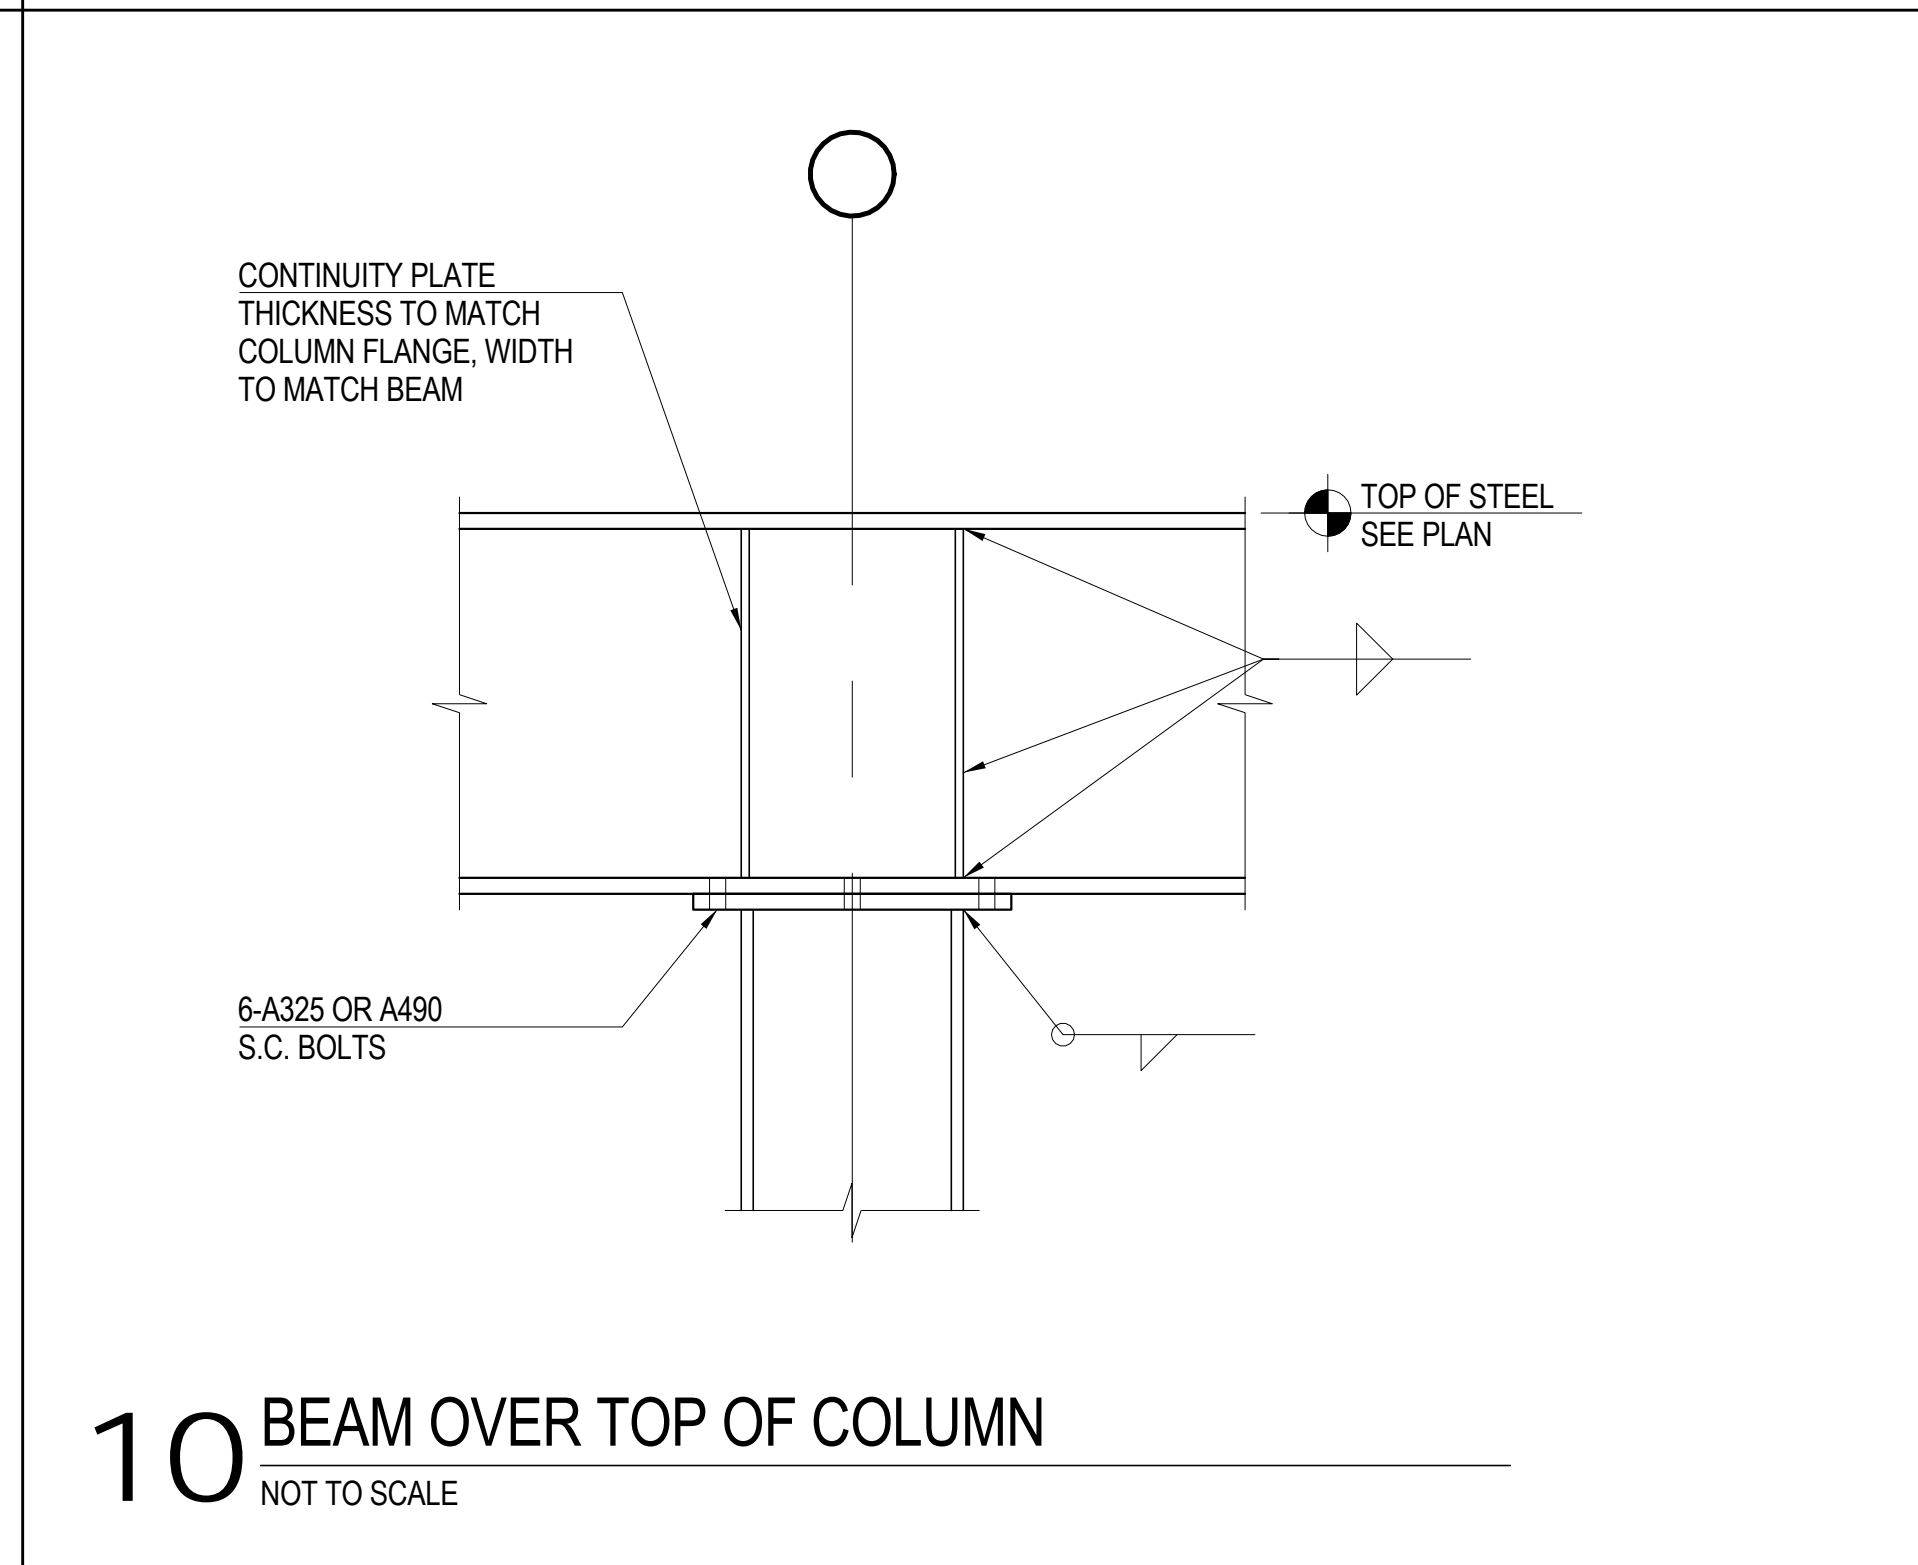
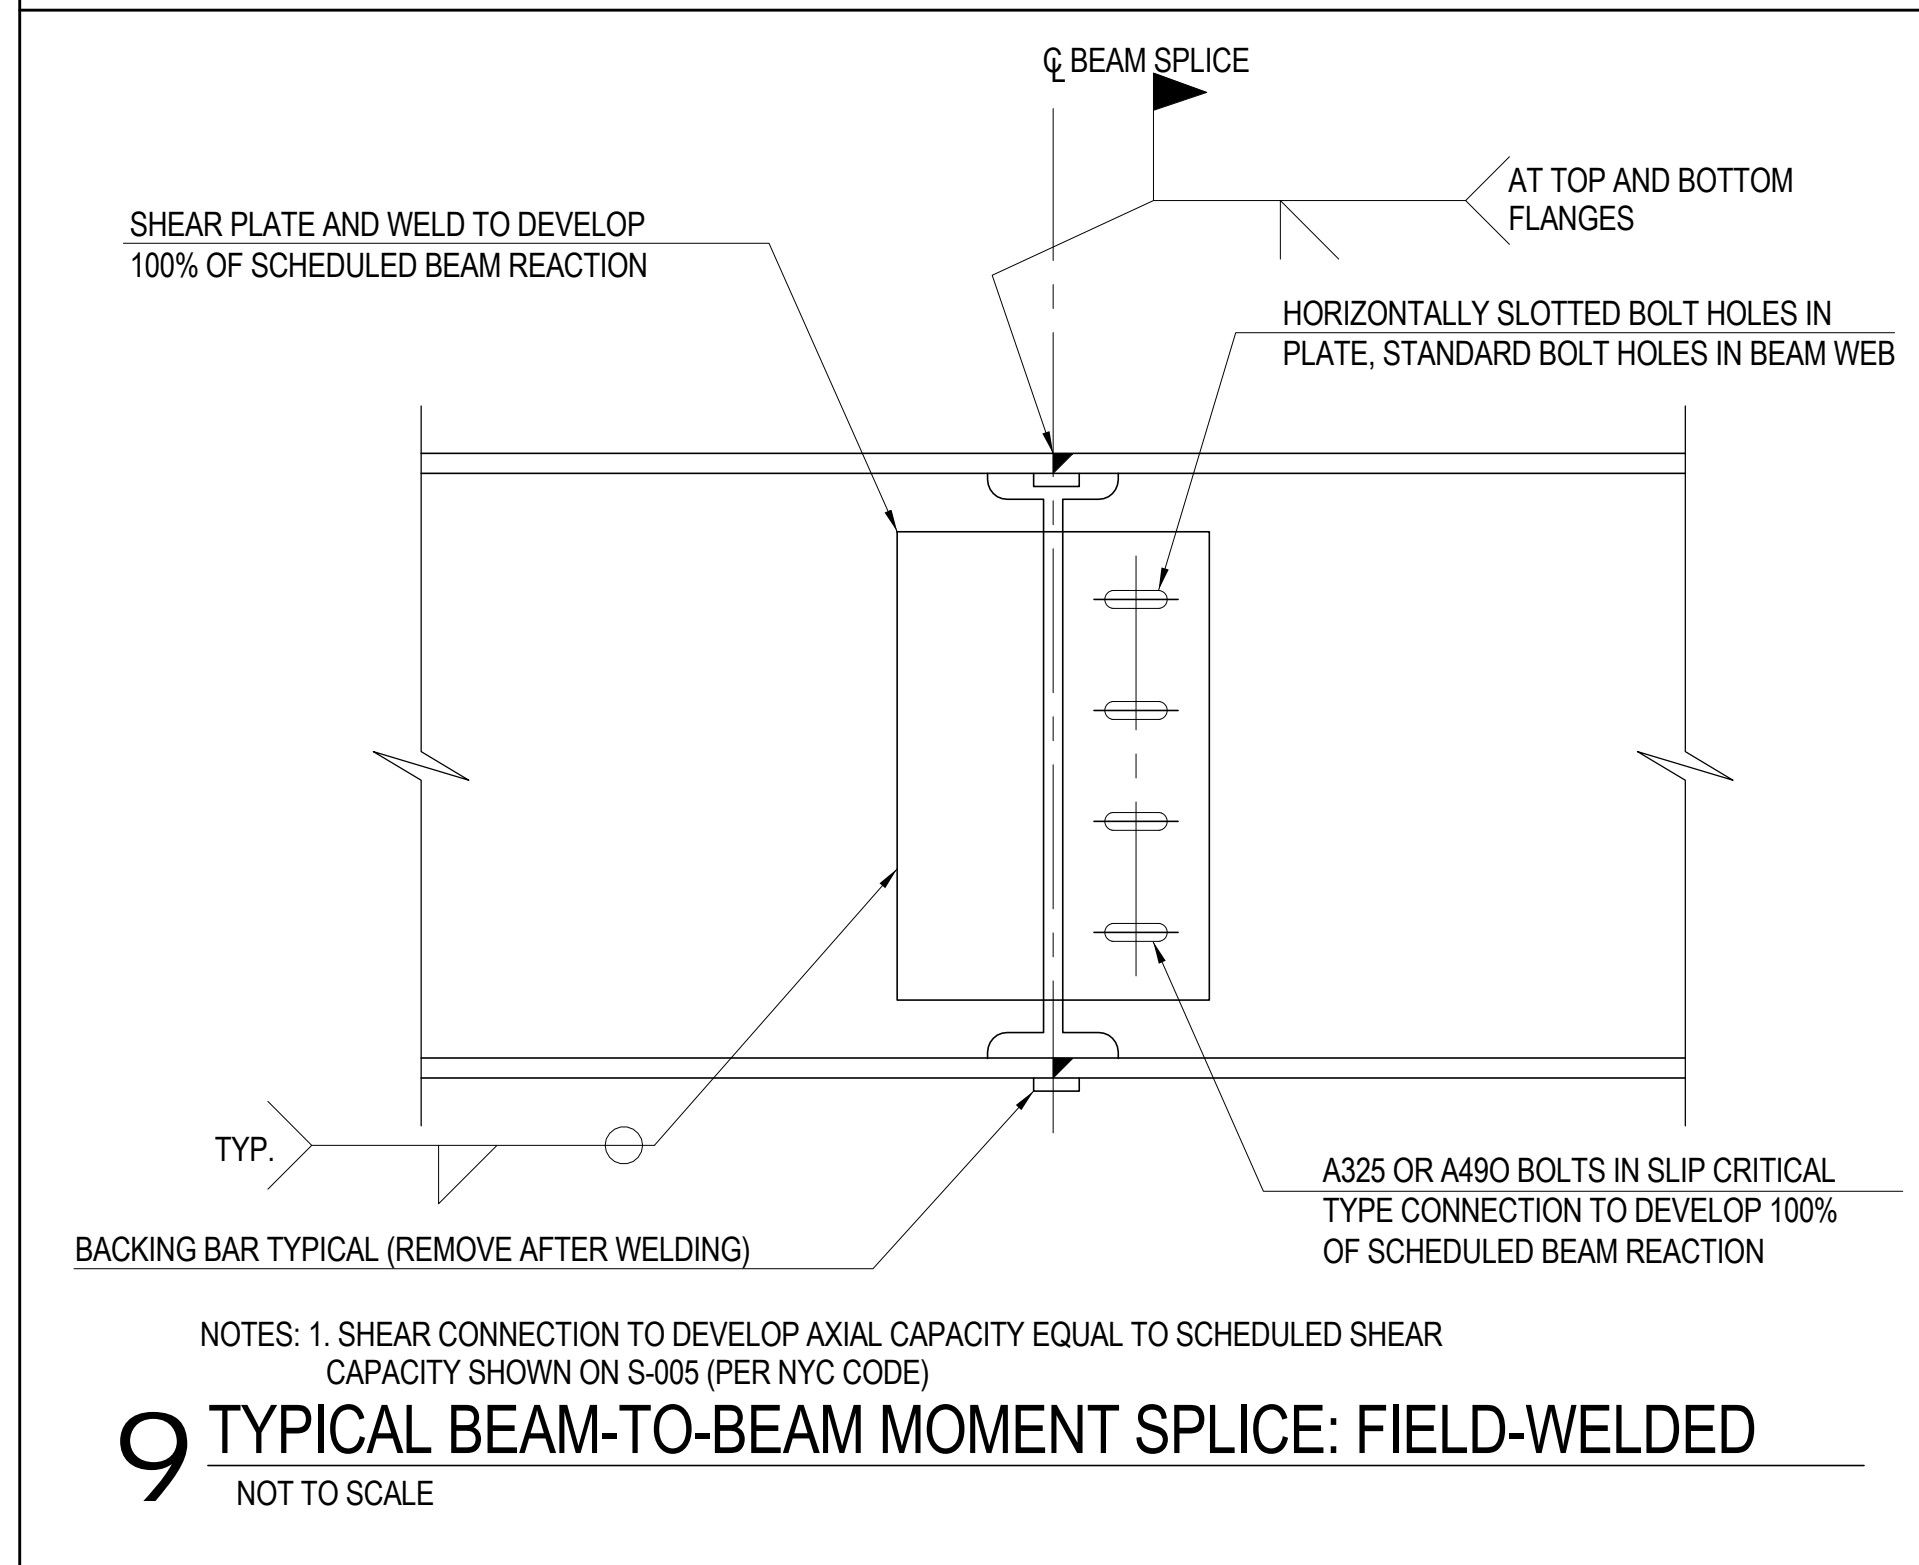
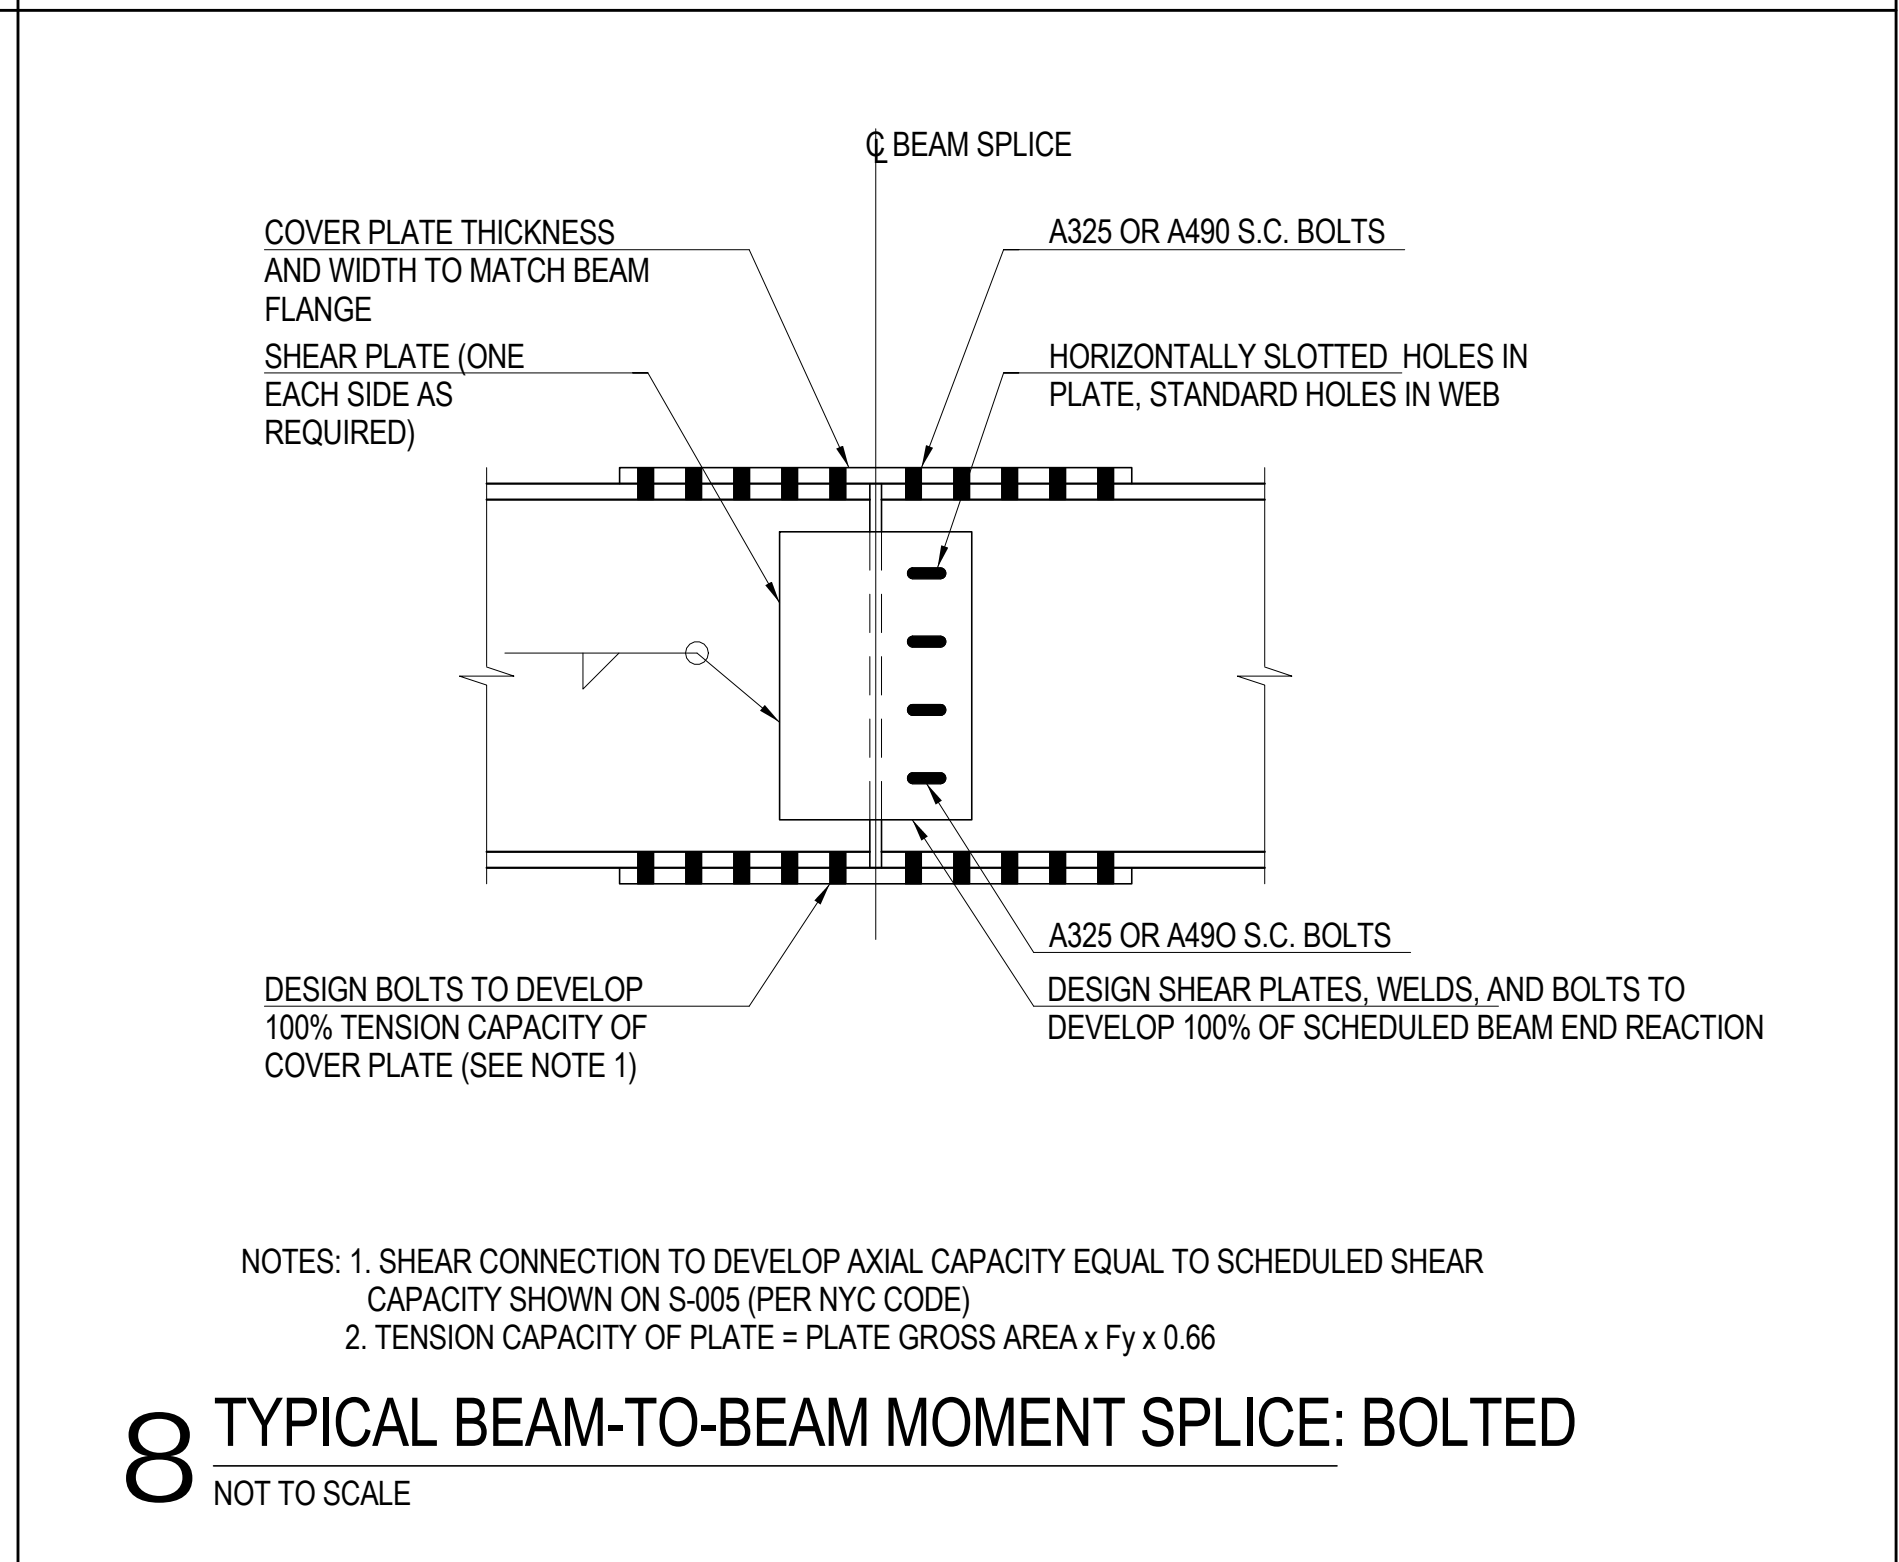
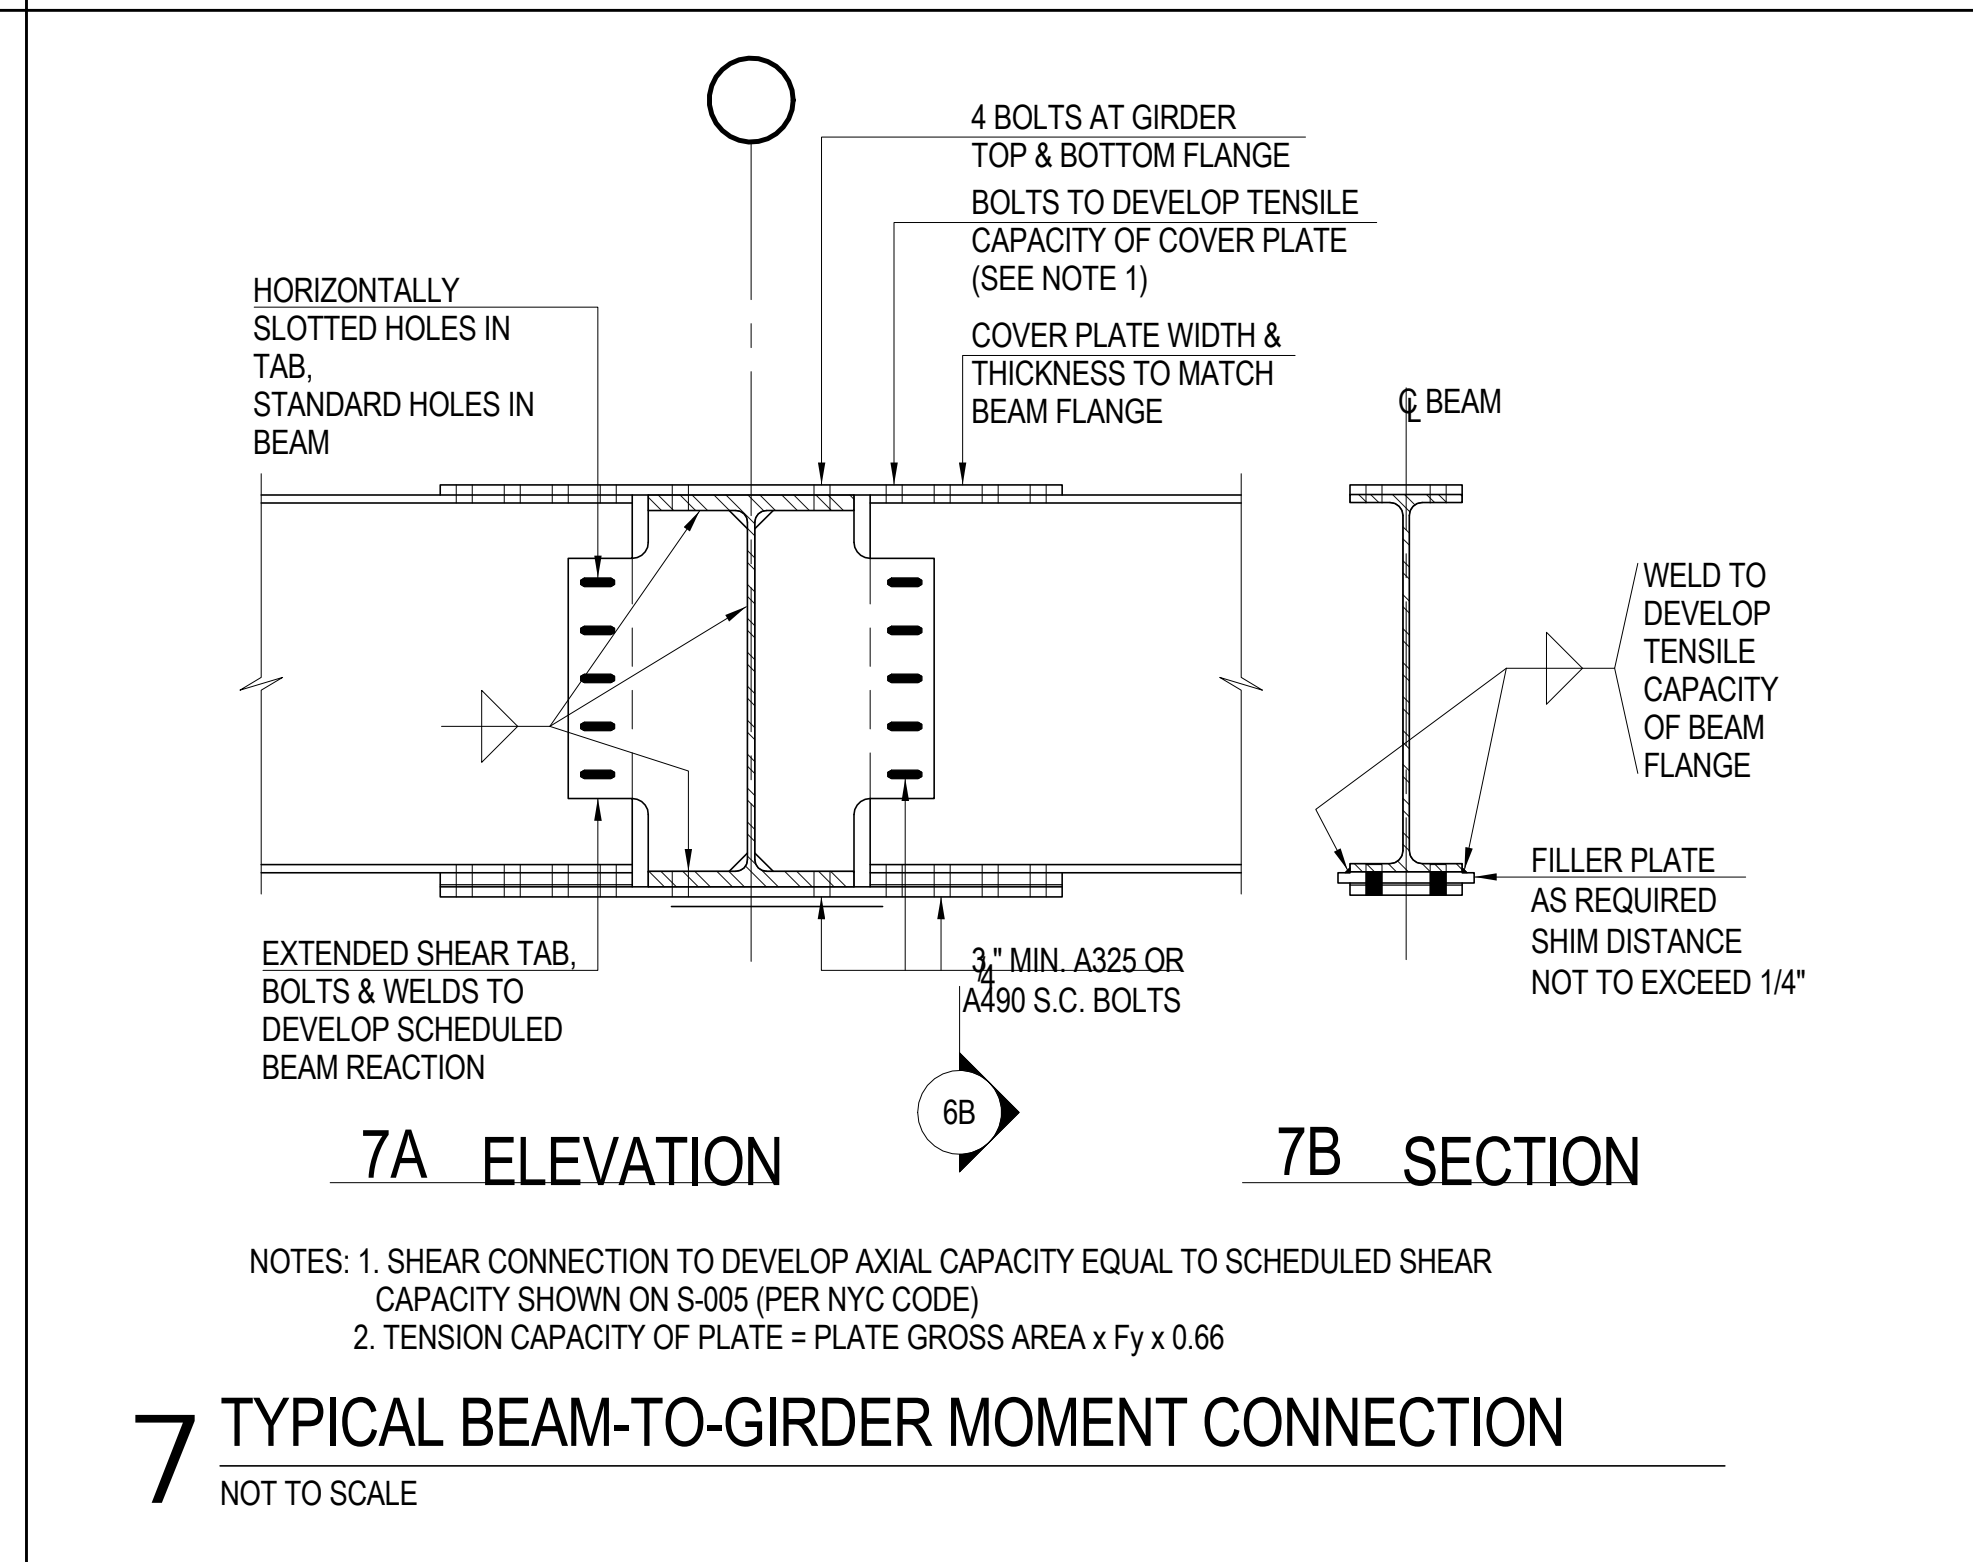
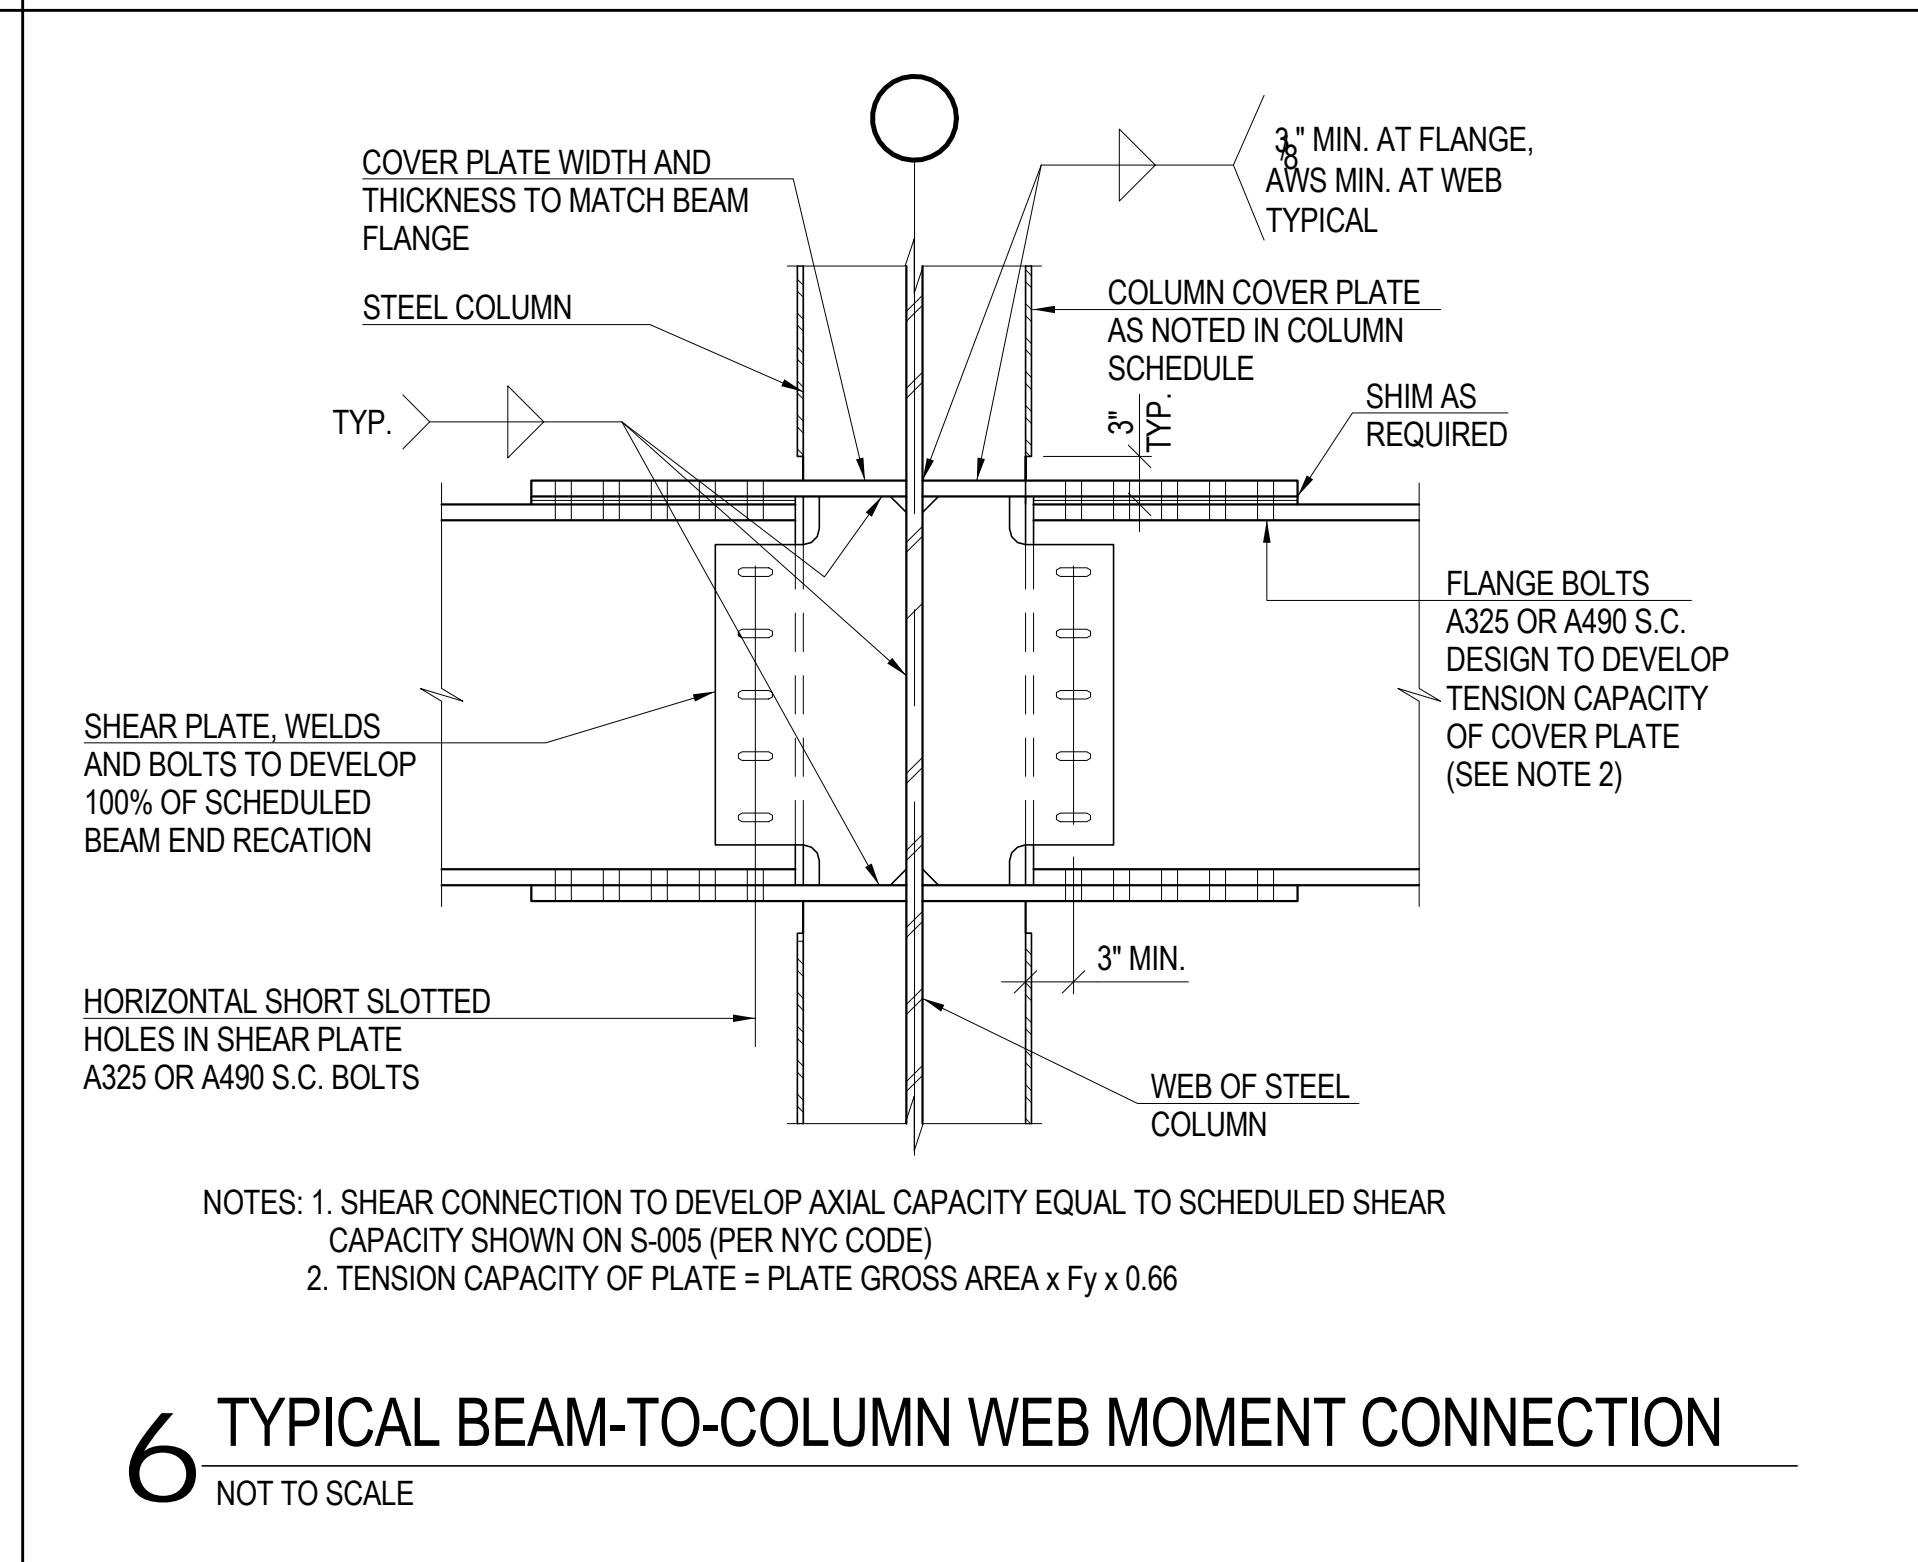
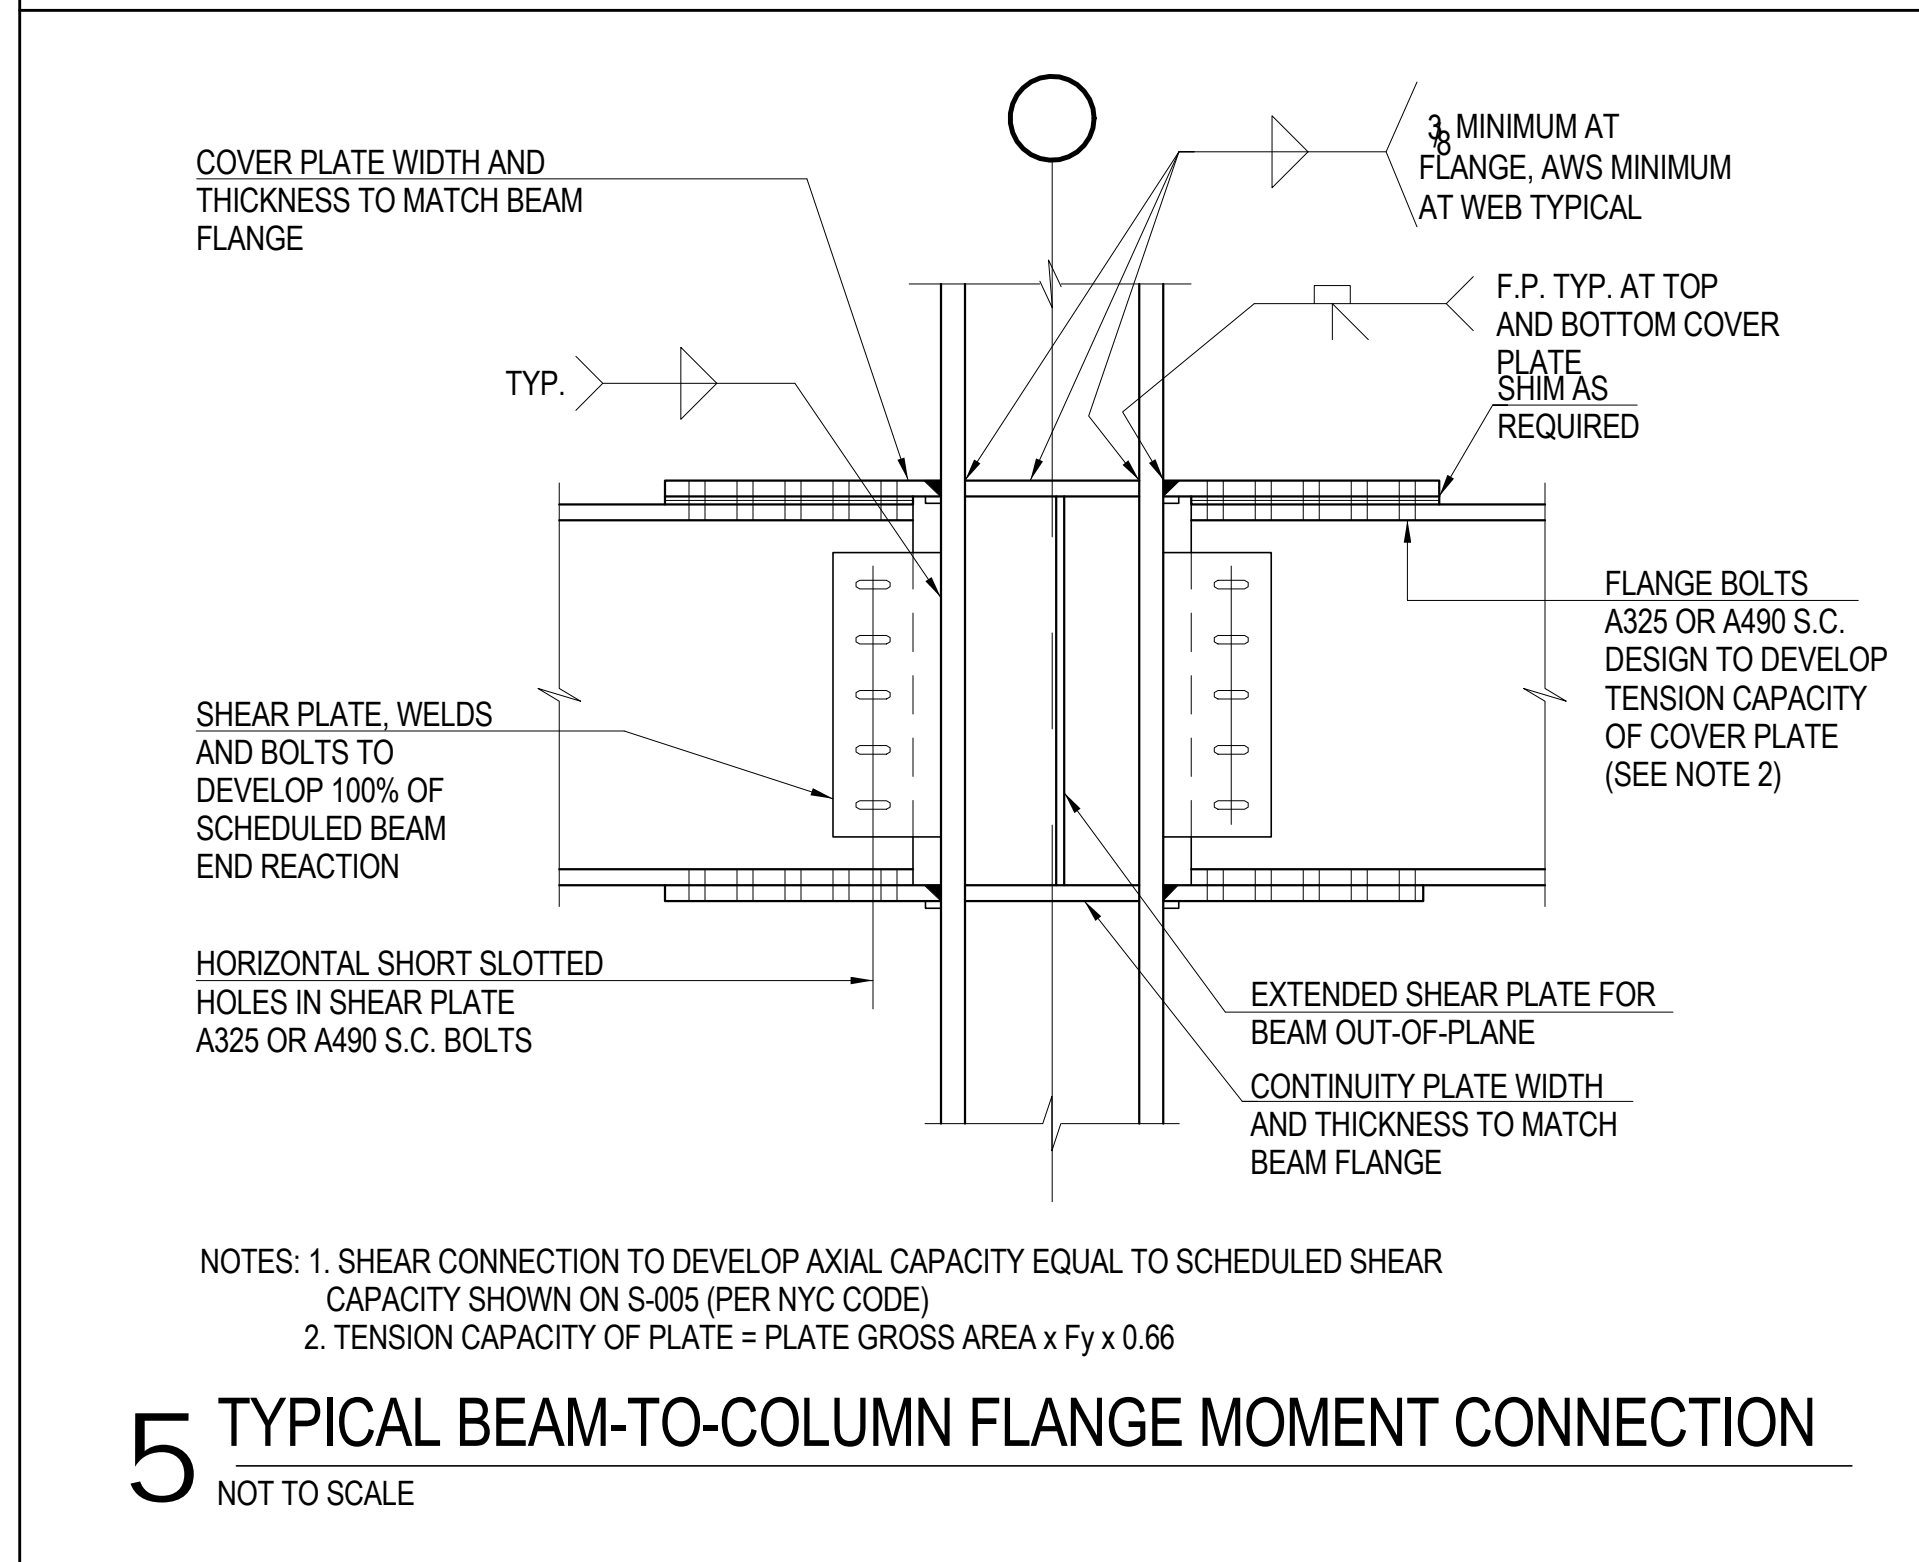
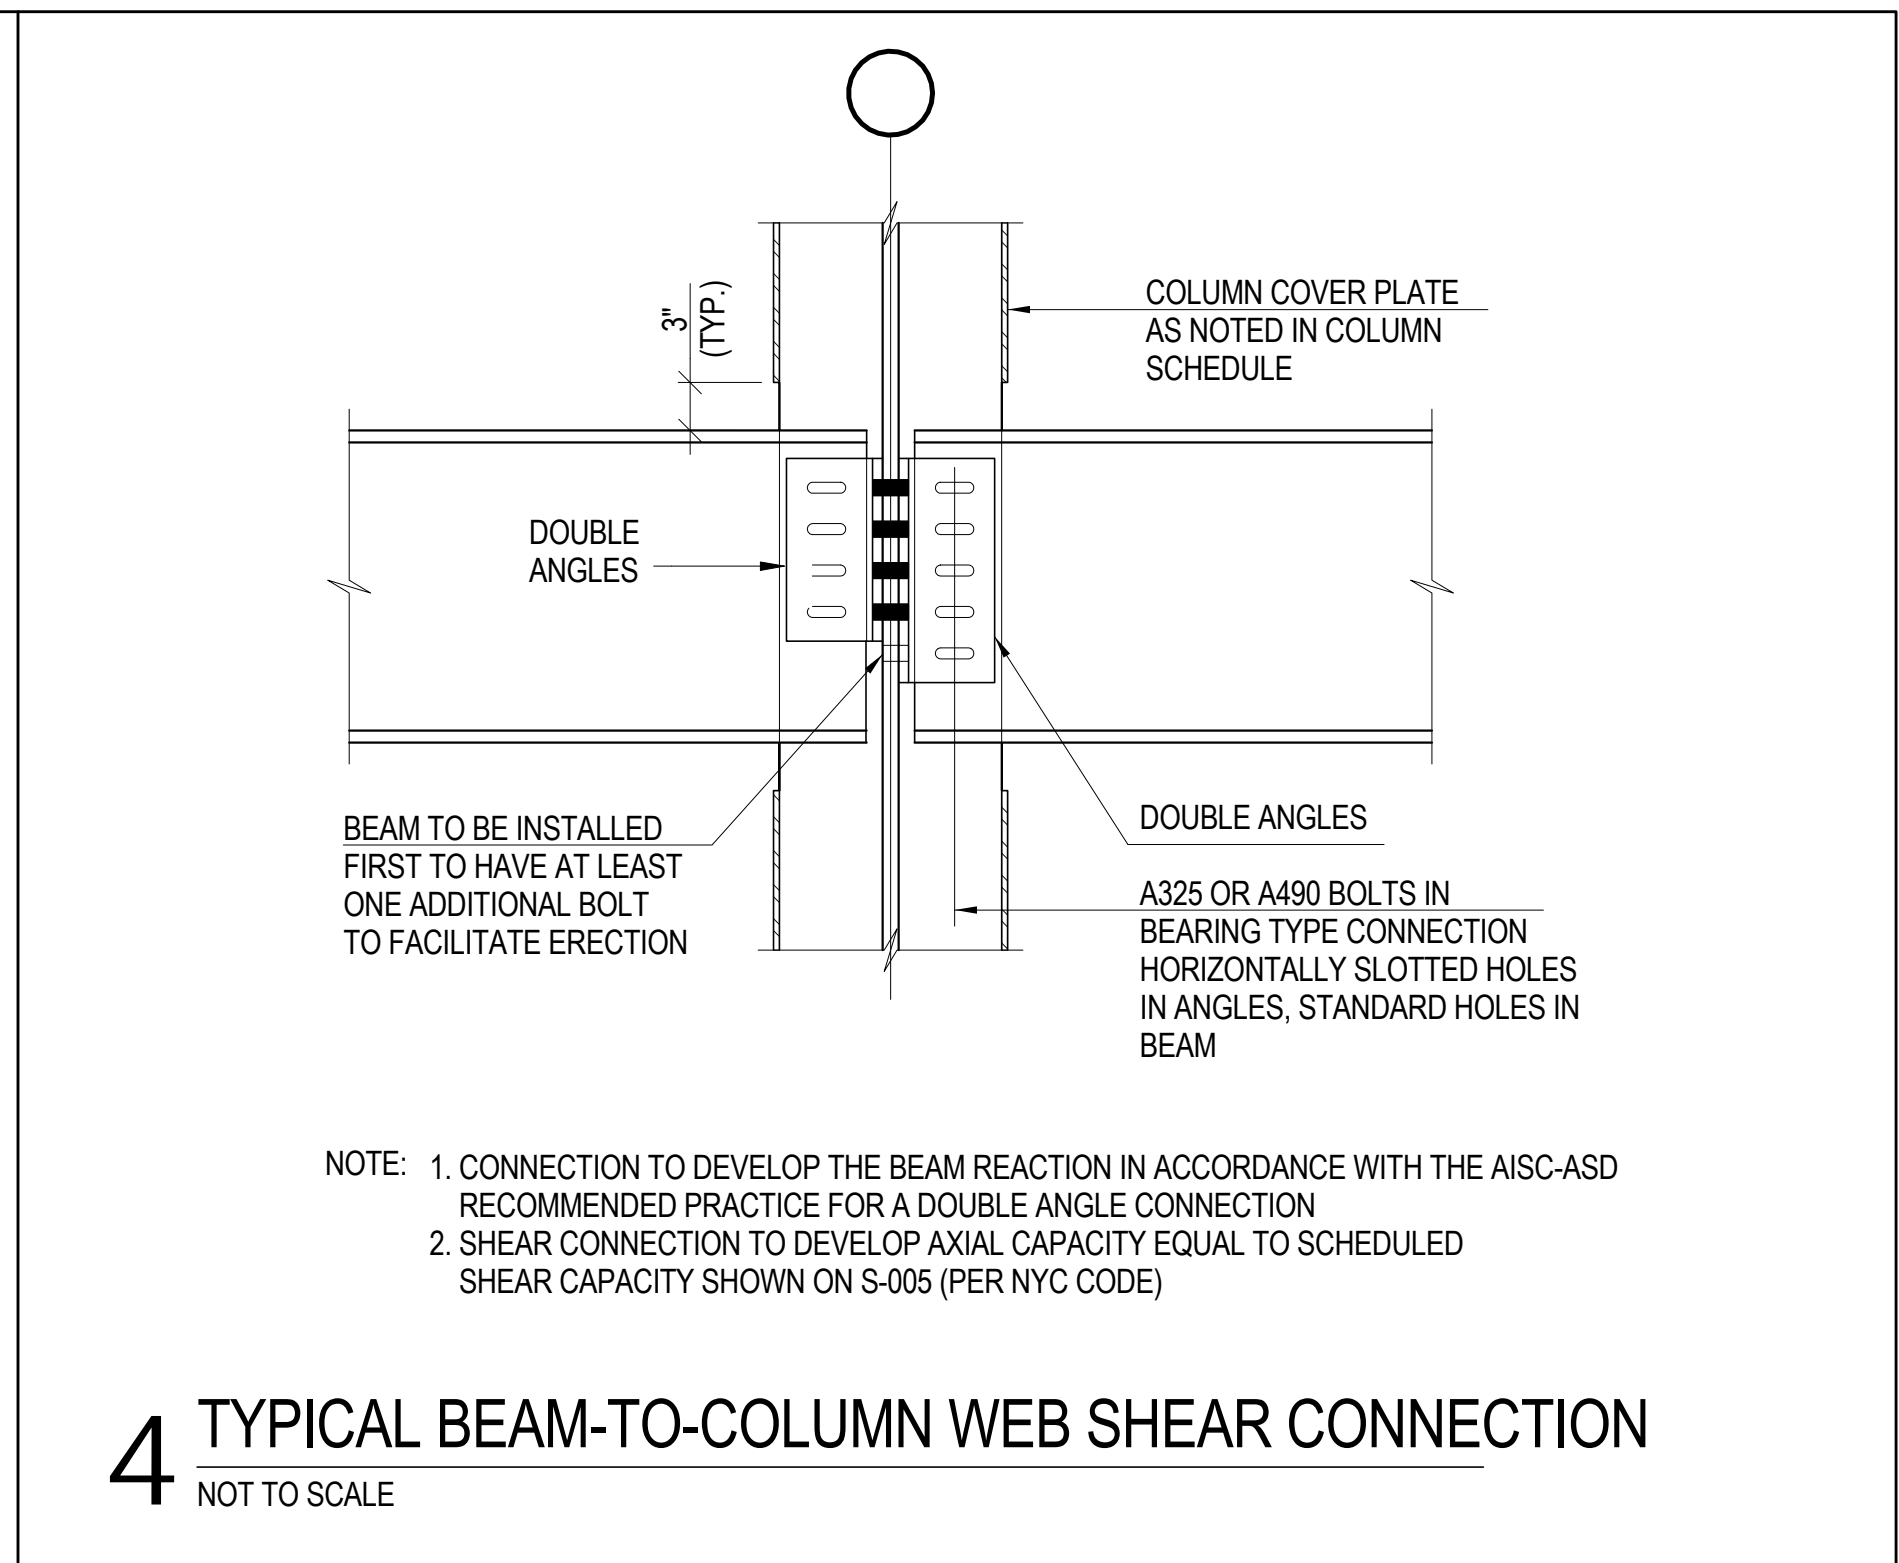
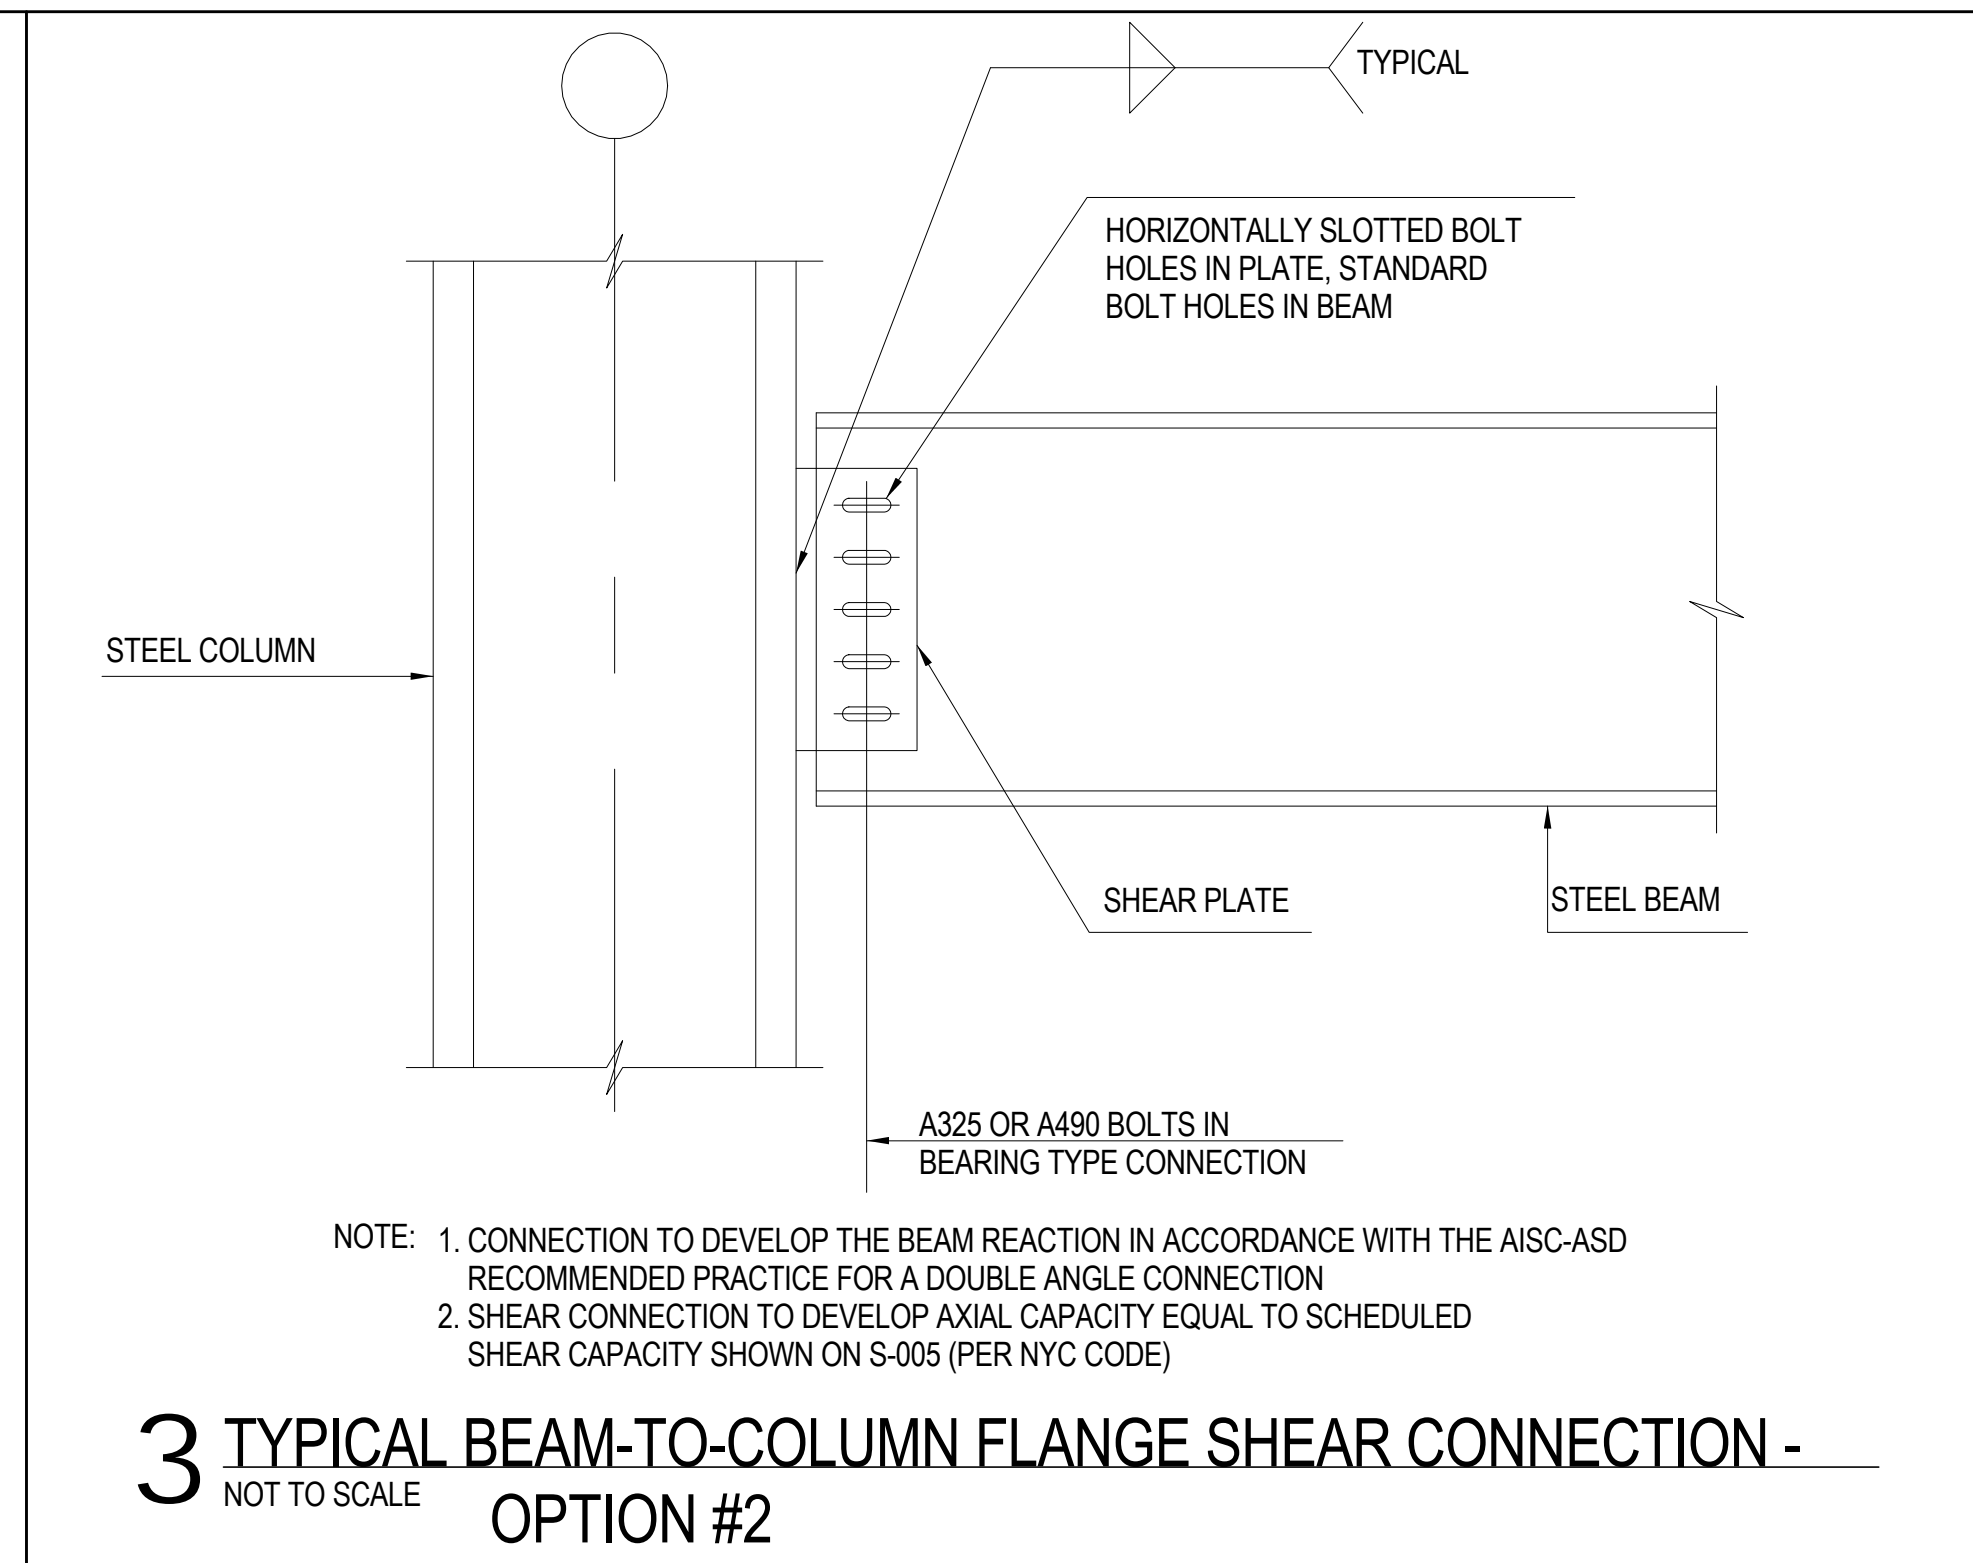
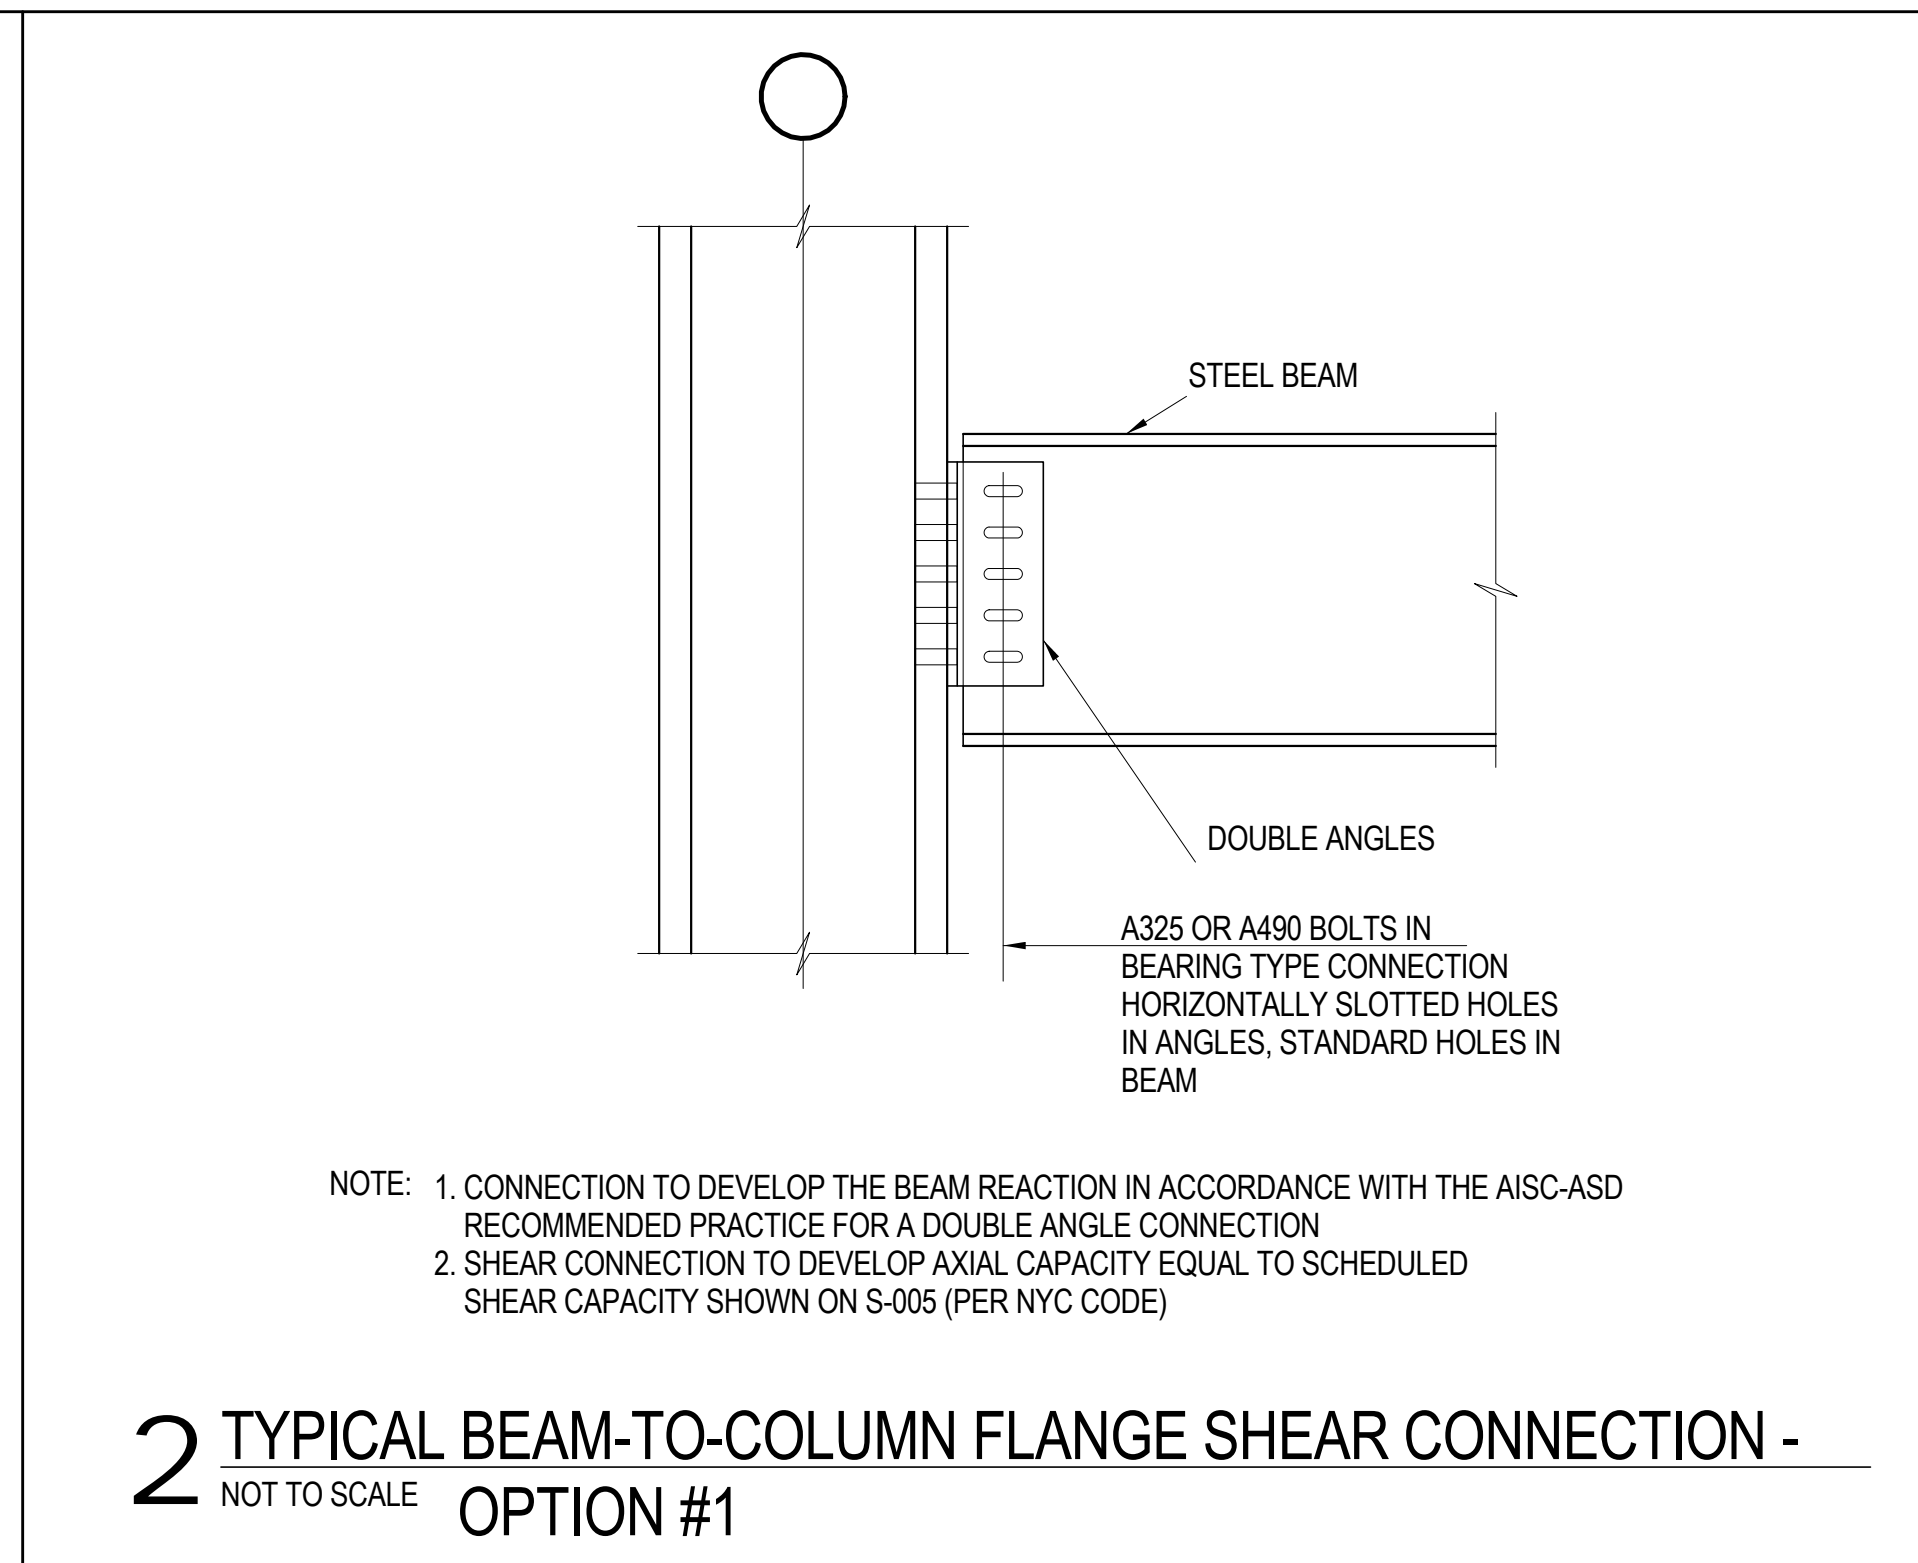
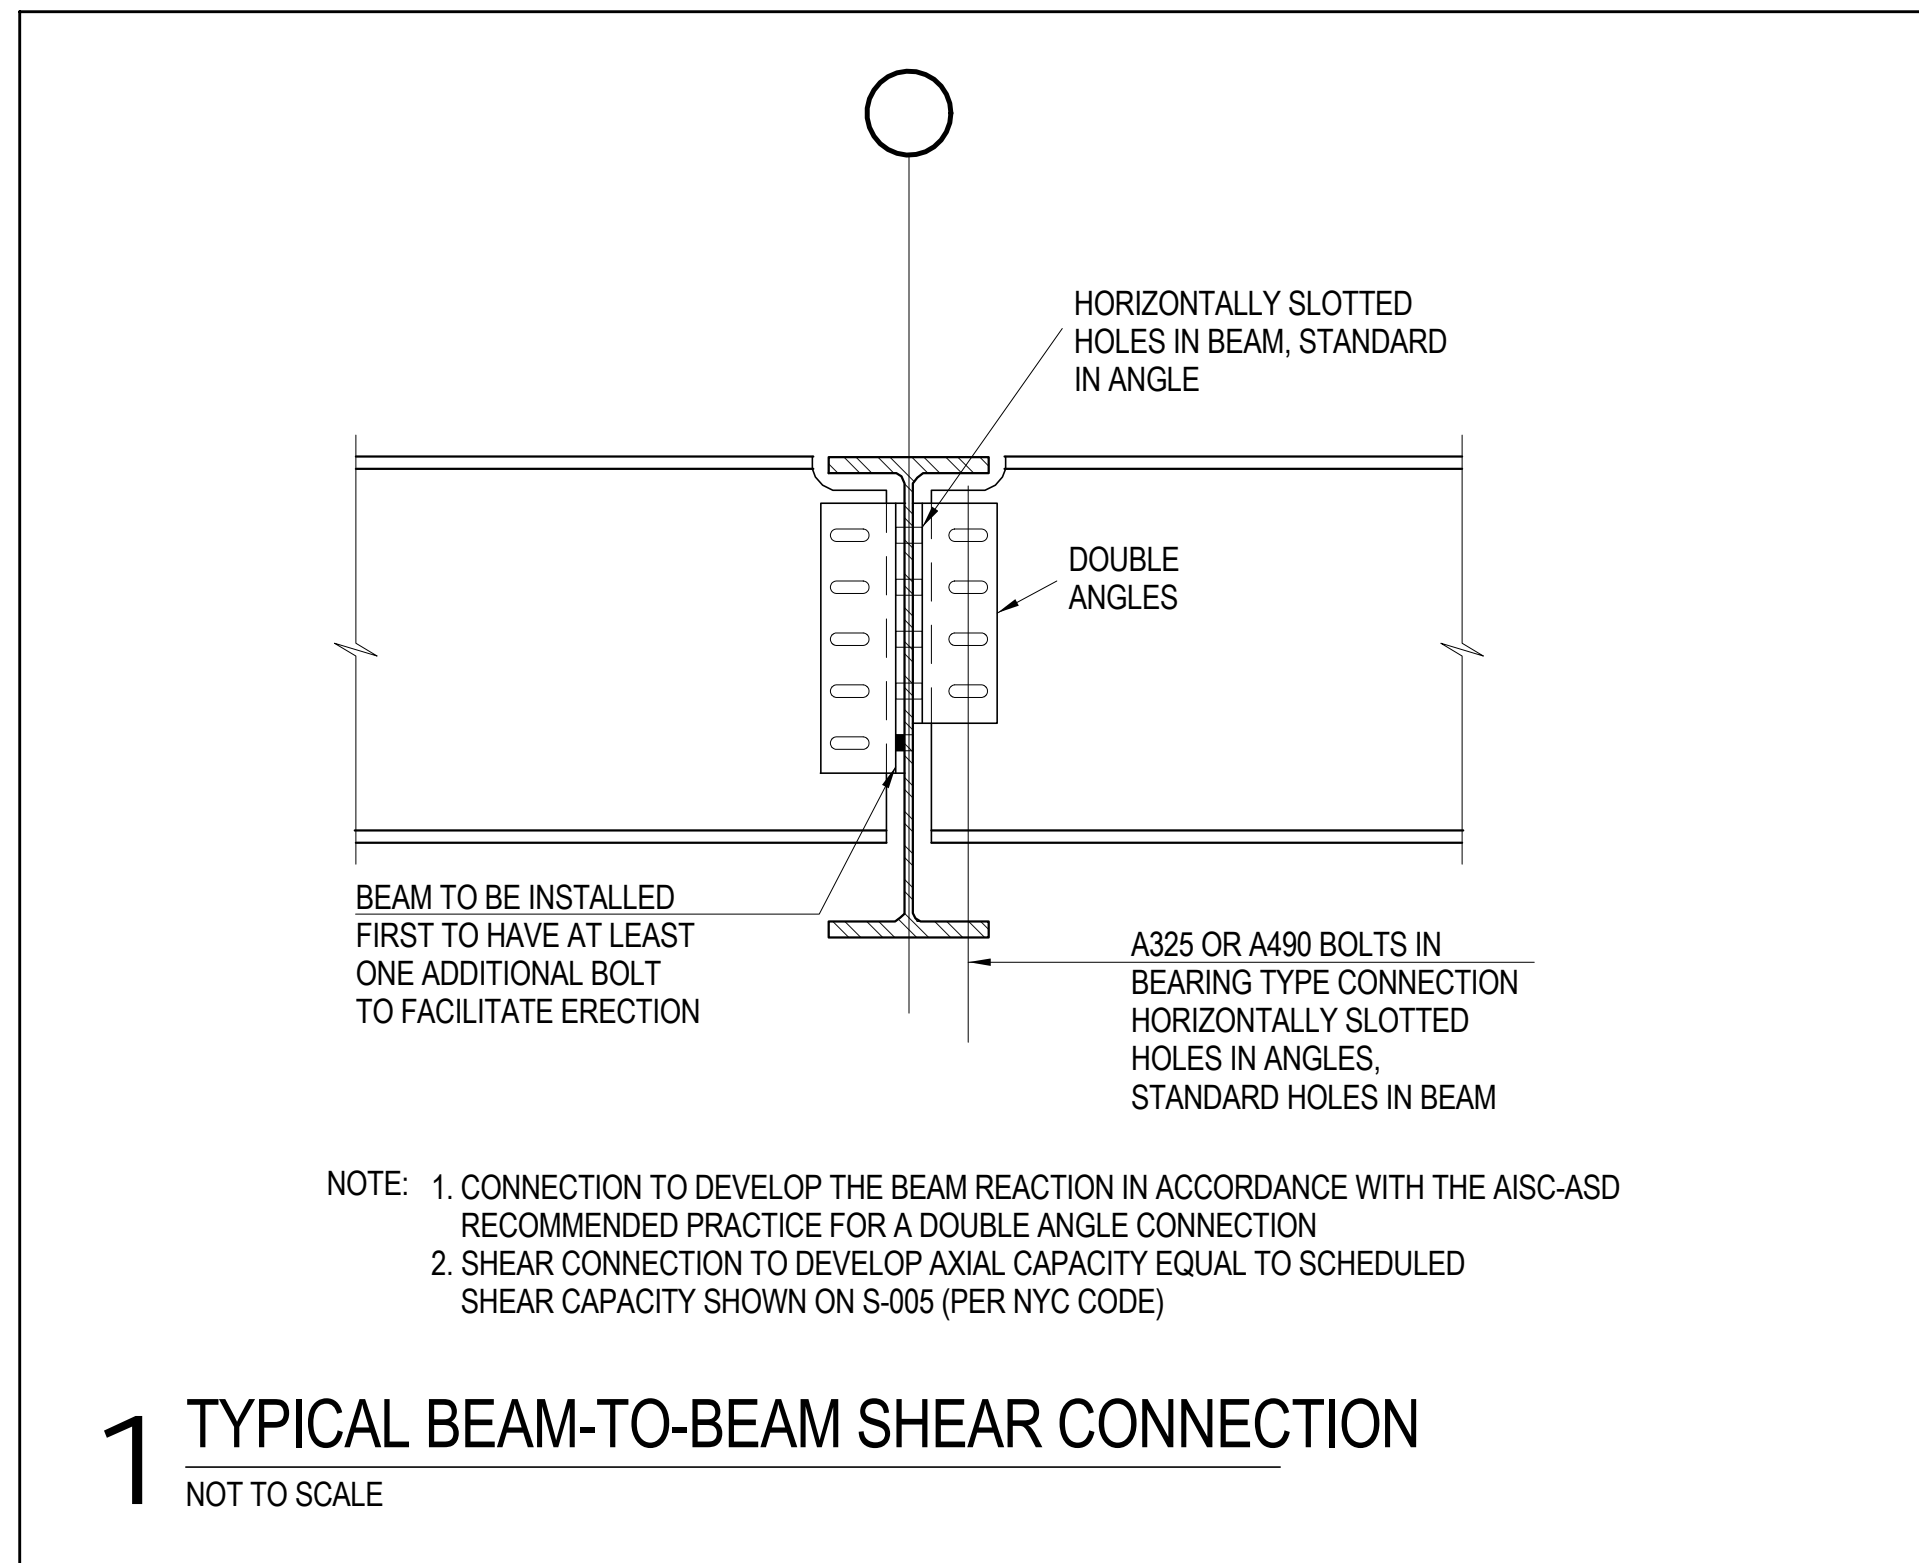
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Sheet Name: BELT TRUSS
SECTIONS &
DETAILS

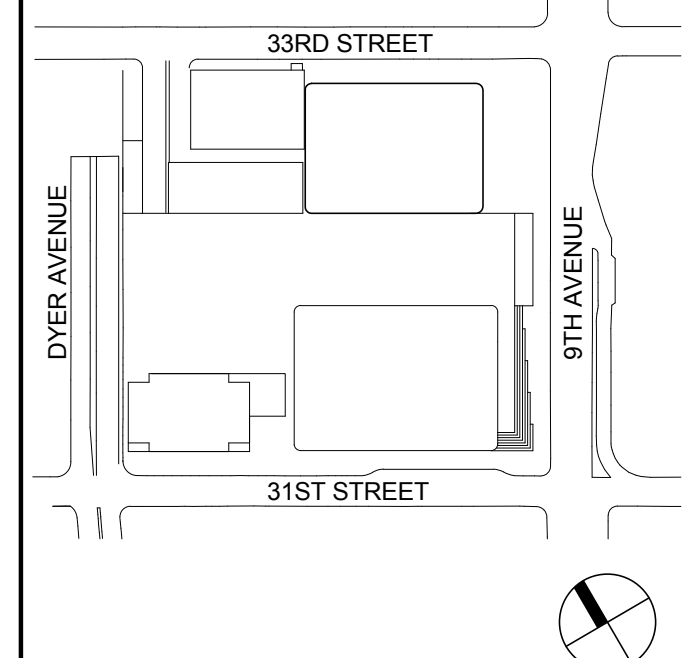Project No.: 211157	B-SCAN Sheet No.: S-417.00
Date: 20 JUN 2014	Sheet No.: S-417
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MANHATTAN WEST: NORTH TOWER
375 Ninth Avenue, New York, NY 10001
Client

Brookfield
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250 Vesey Street, 15th Floor, New York, NY 10021

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Vibration Consultant
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Code Consultants Professional Engineers PC
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Entek Engineering LLC
166 Ames Street, Hackensack, NJ 07601

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Rowan Williams Davies & Irwin Inc.
650 Woodlawn Road West, Guelph, Ontario, Canada N1K 1B8

Key Plan:


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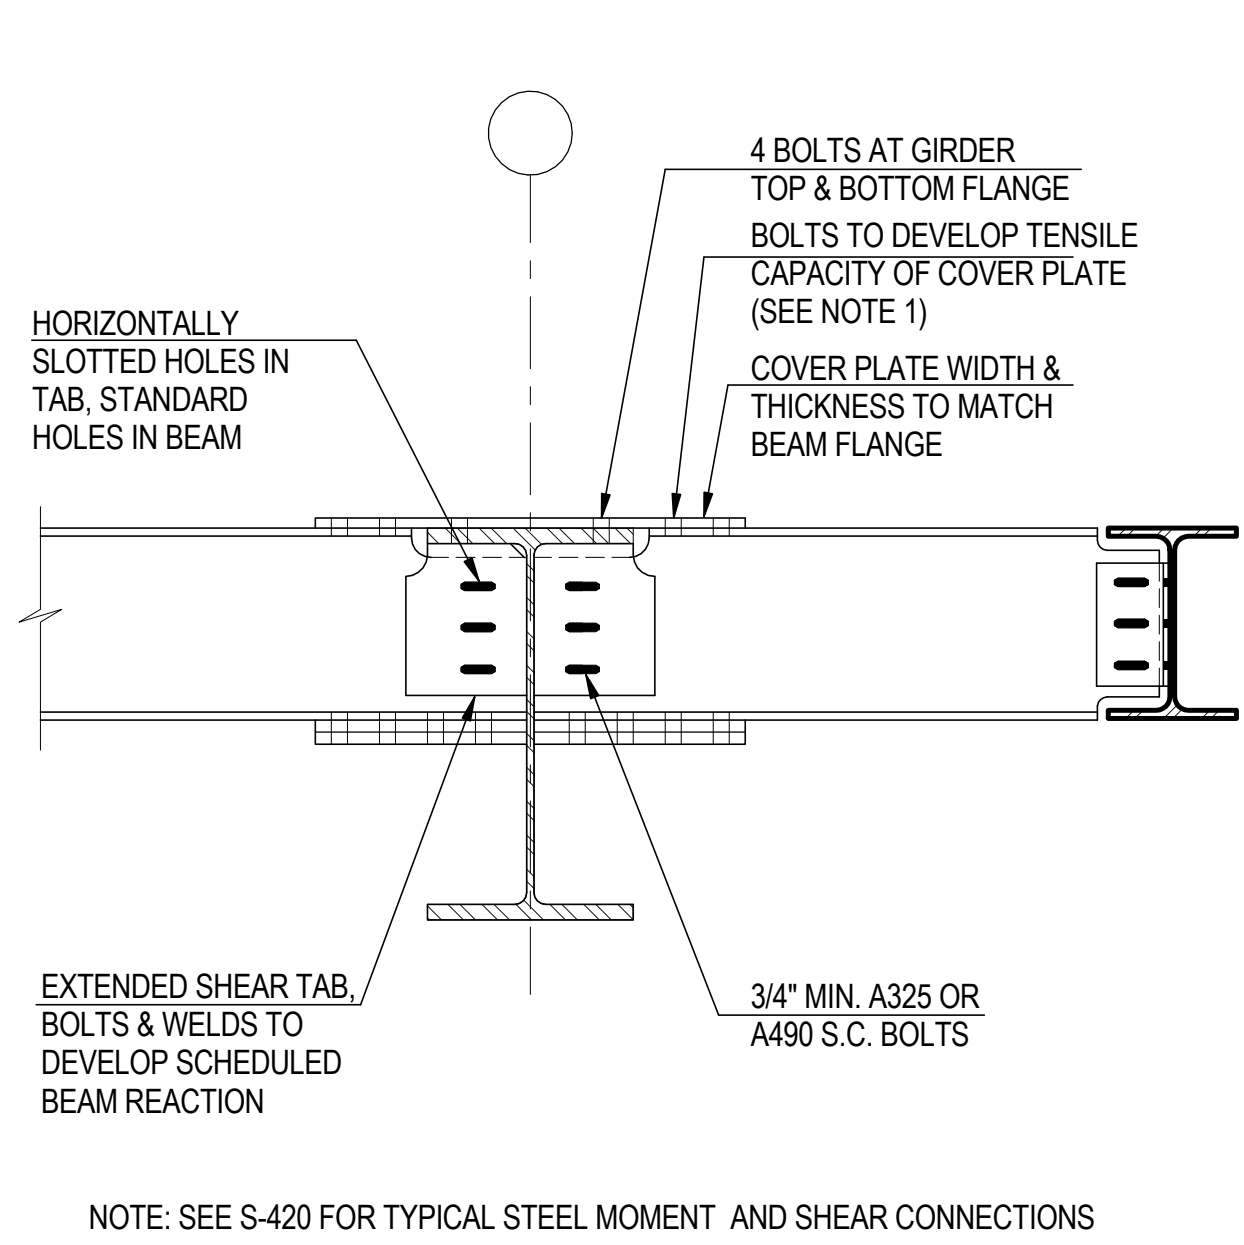
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B-SCAN Sheet No.: S-420.00
Date: 20 JUN 2014
Scale: 1" = 1'-0"
File No.: S-420
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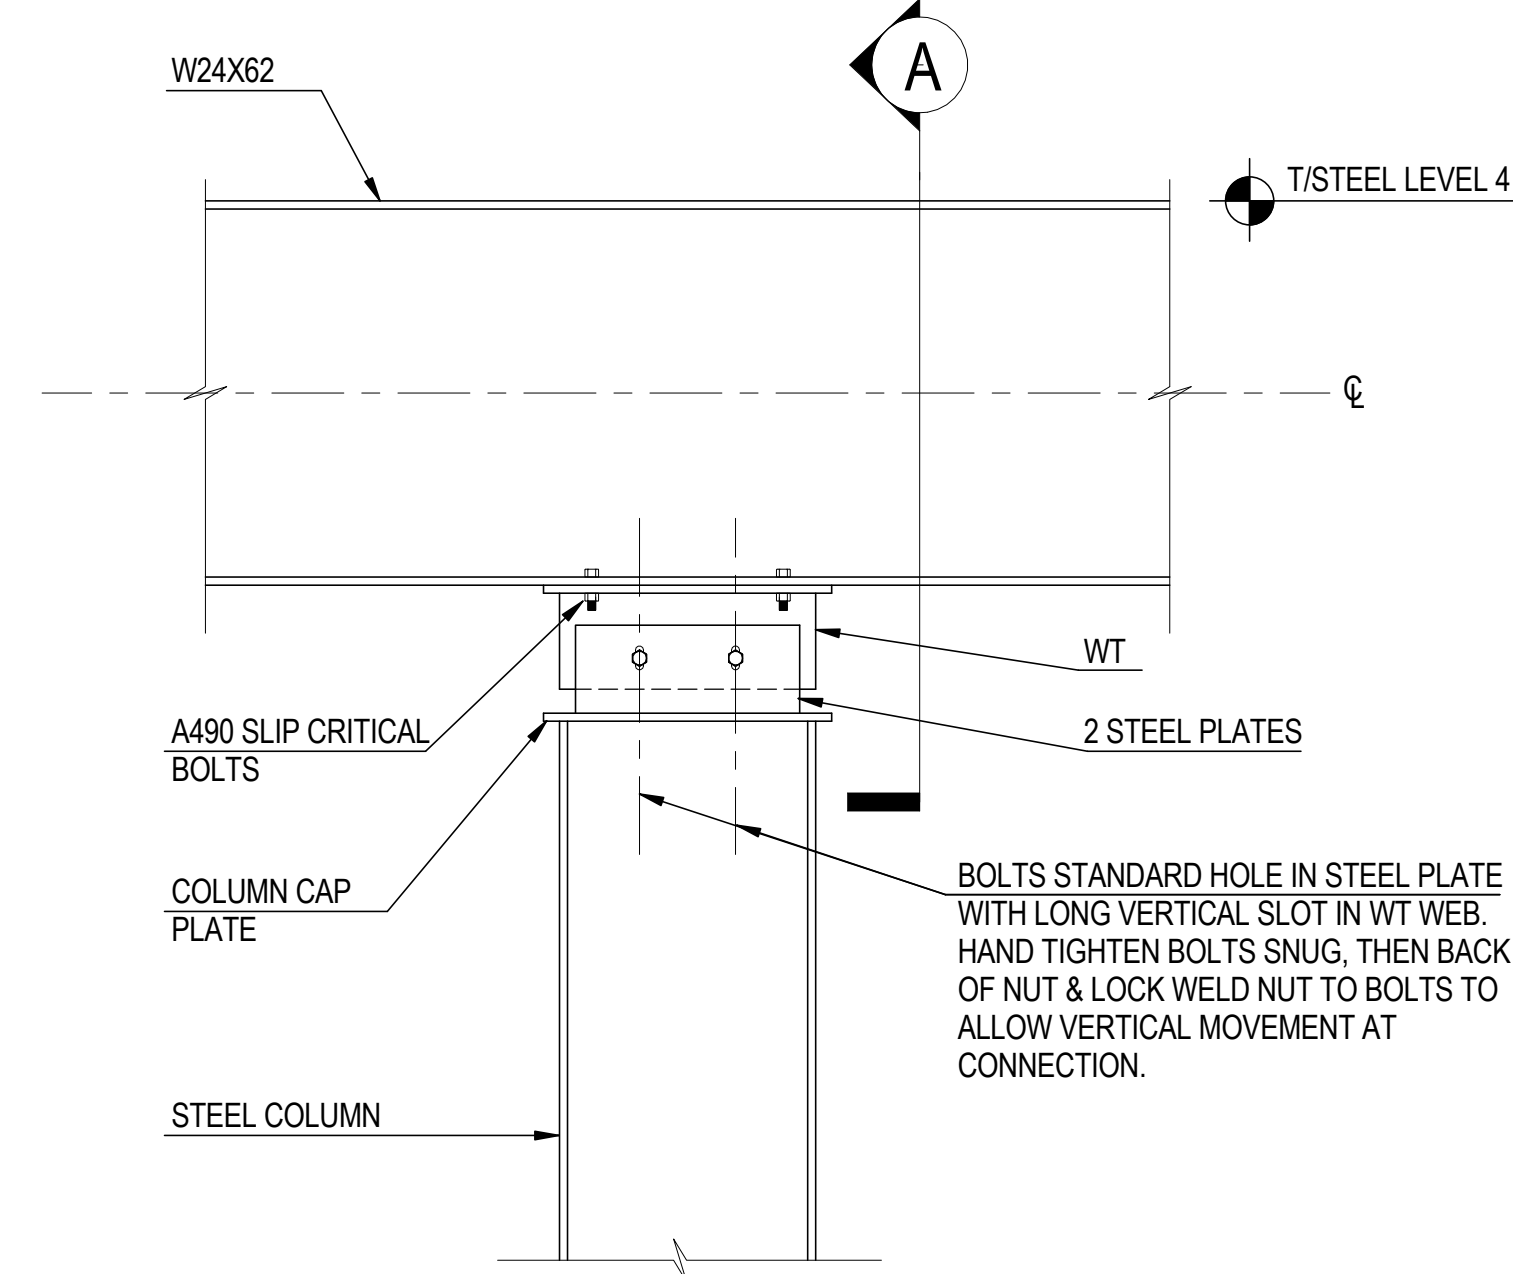
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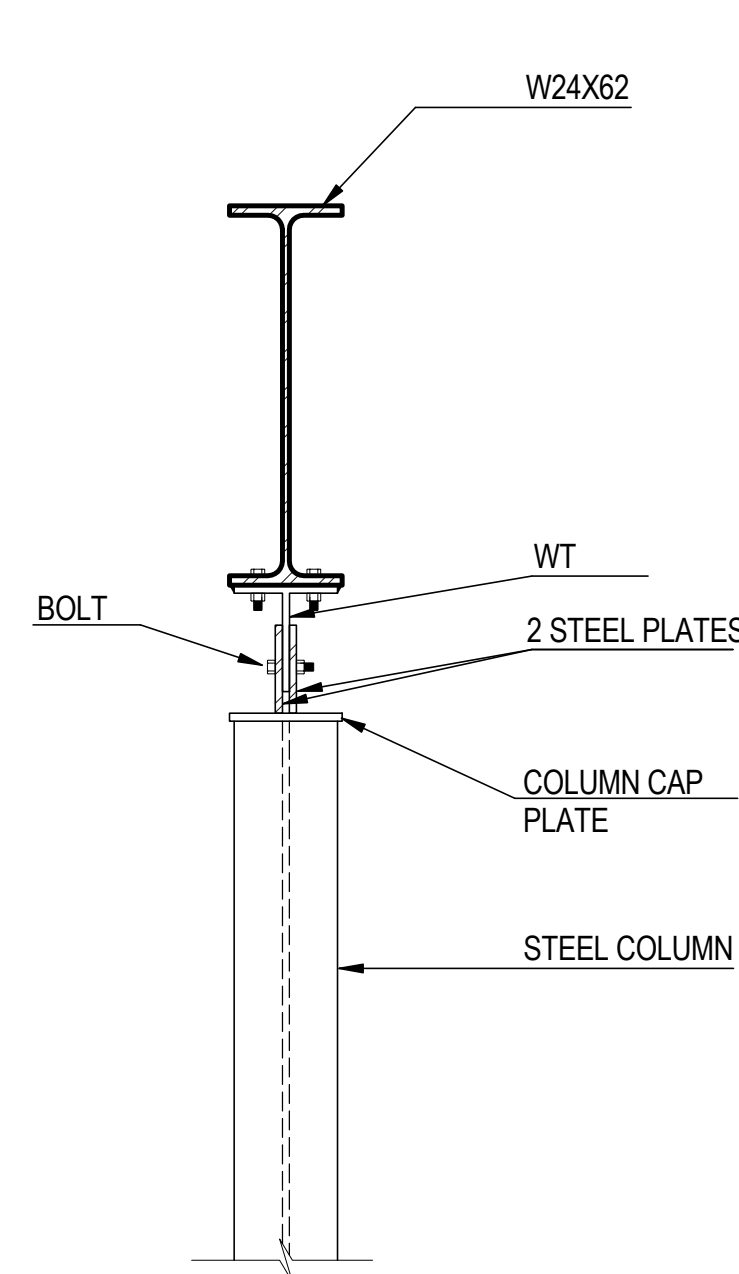
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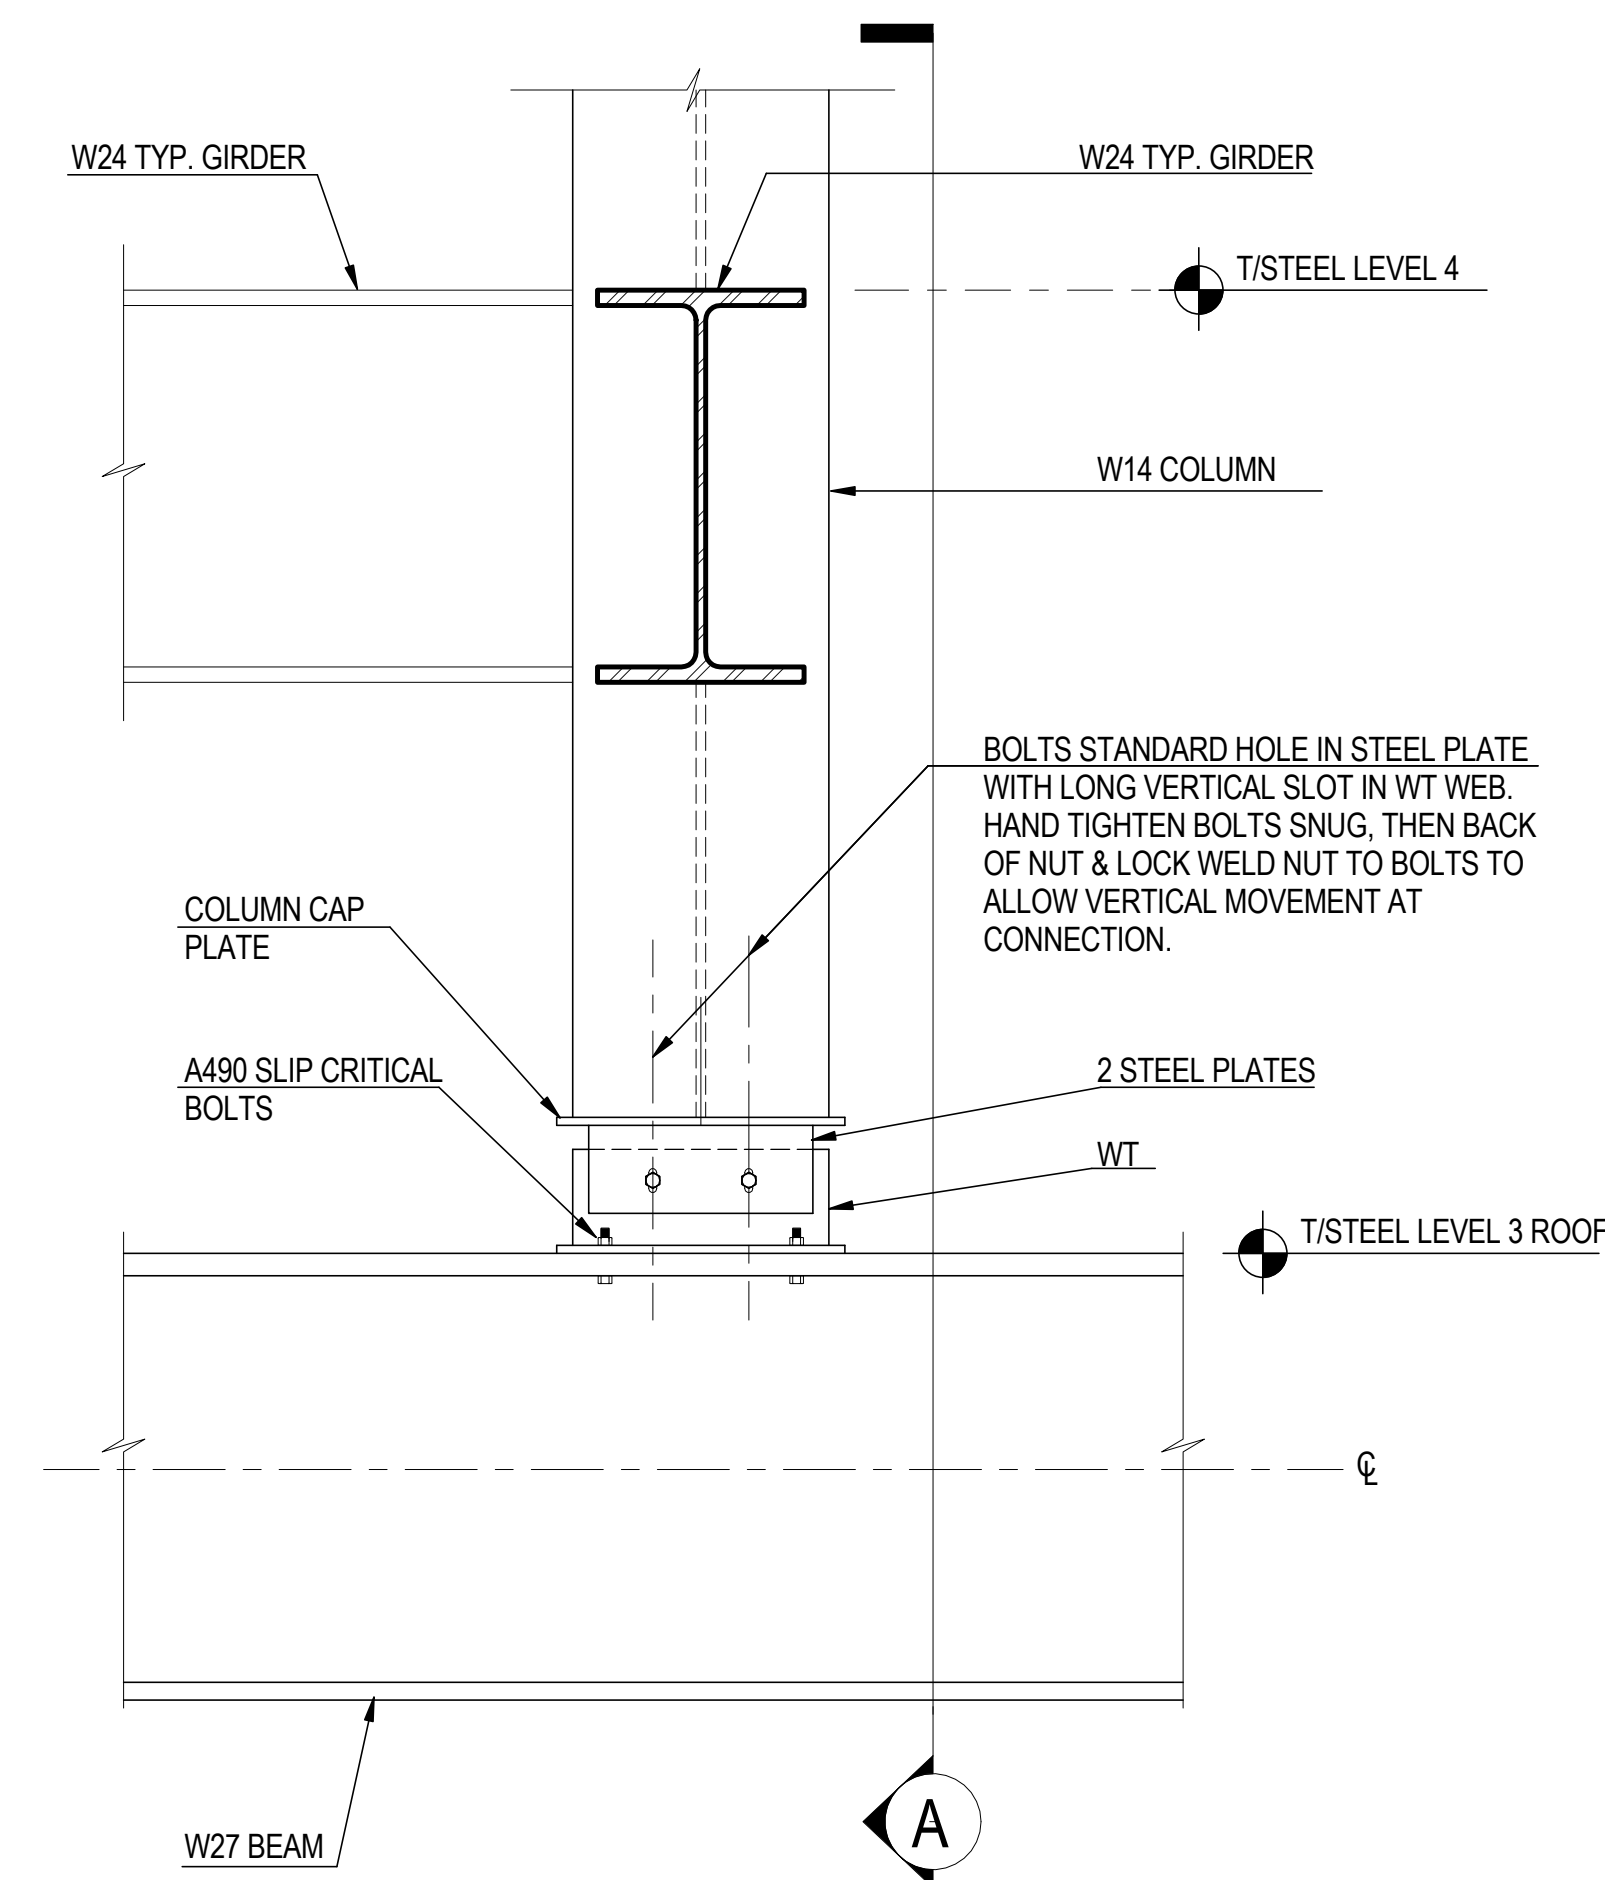
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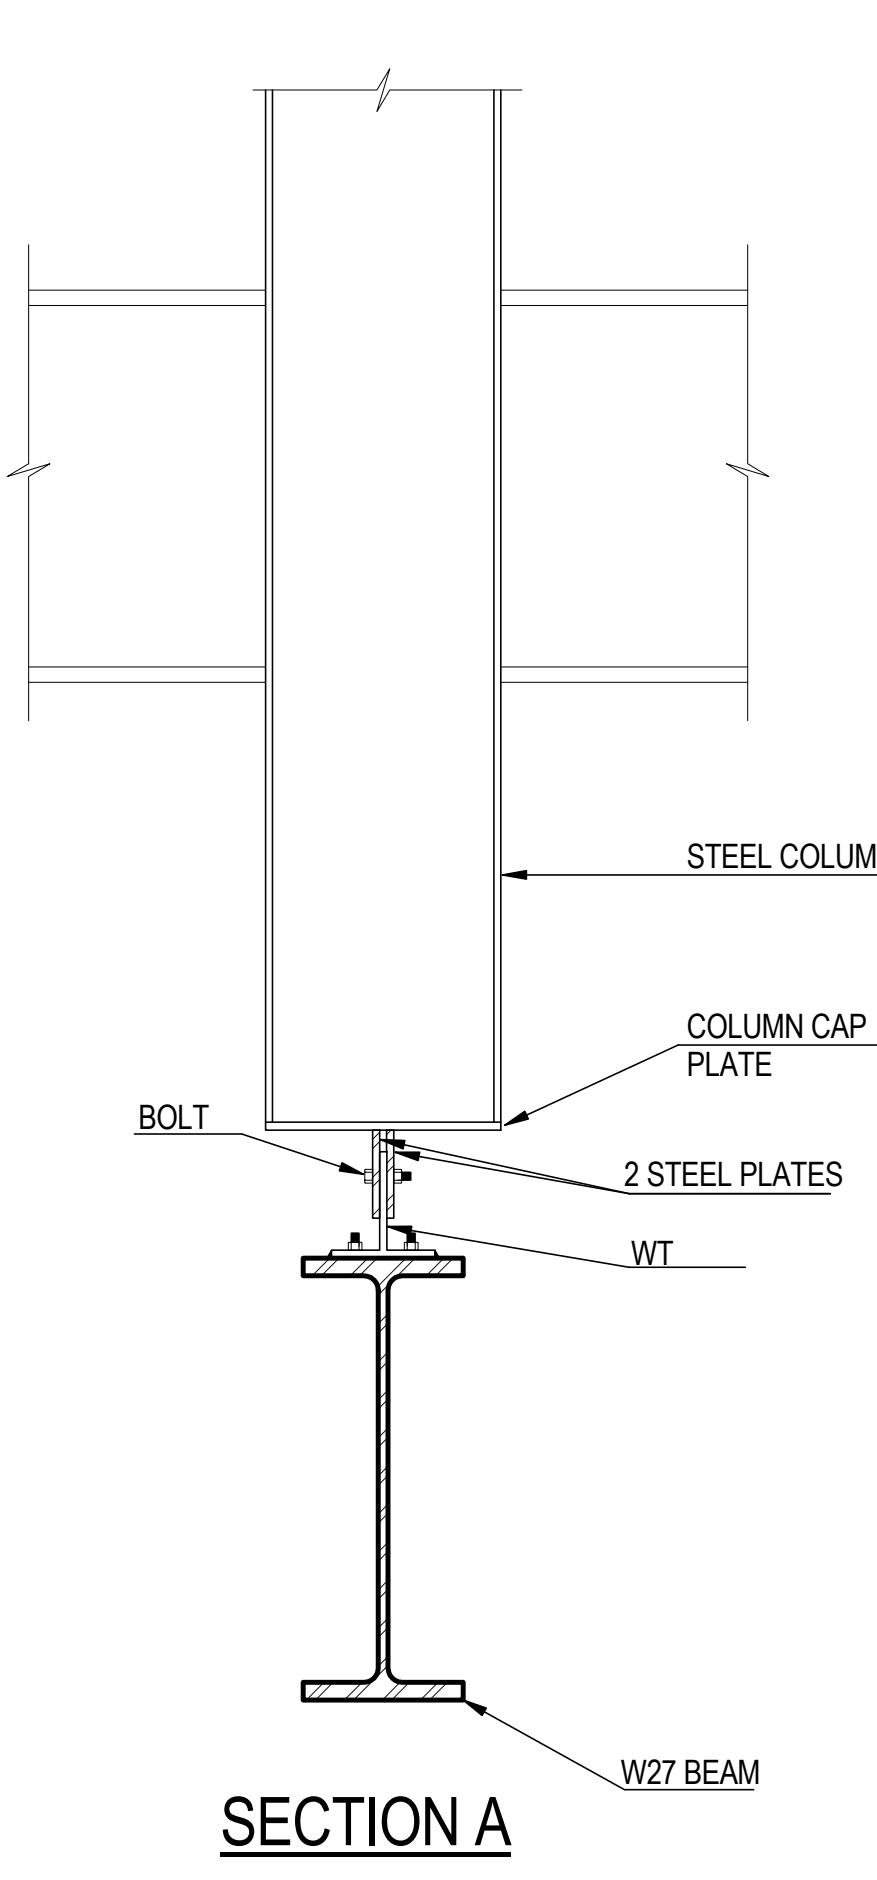
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NOT TO SCALE




SECTION A



4 DETAIL AT RETAIL BUILDING ROOF CONNECTION TO UNDERSIDE OF LEVEL 4
NOT TO SCALE

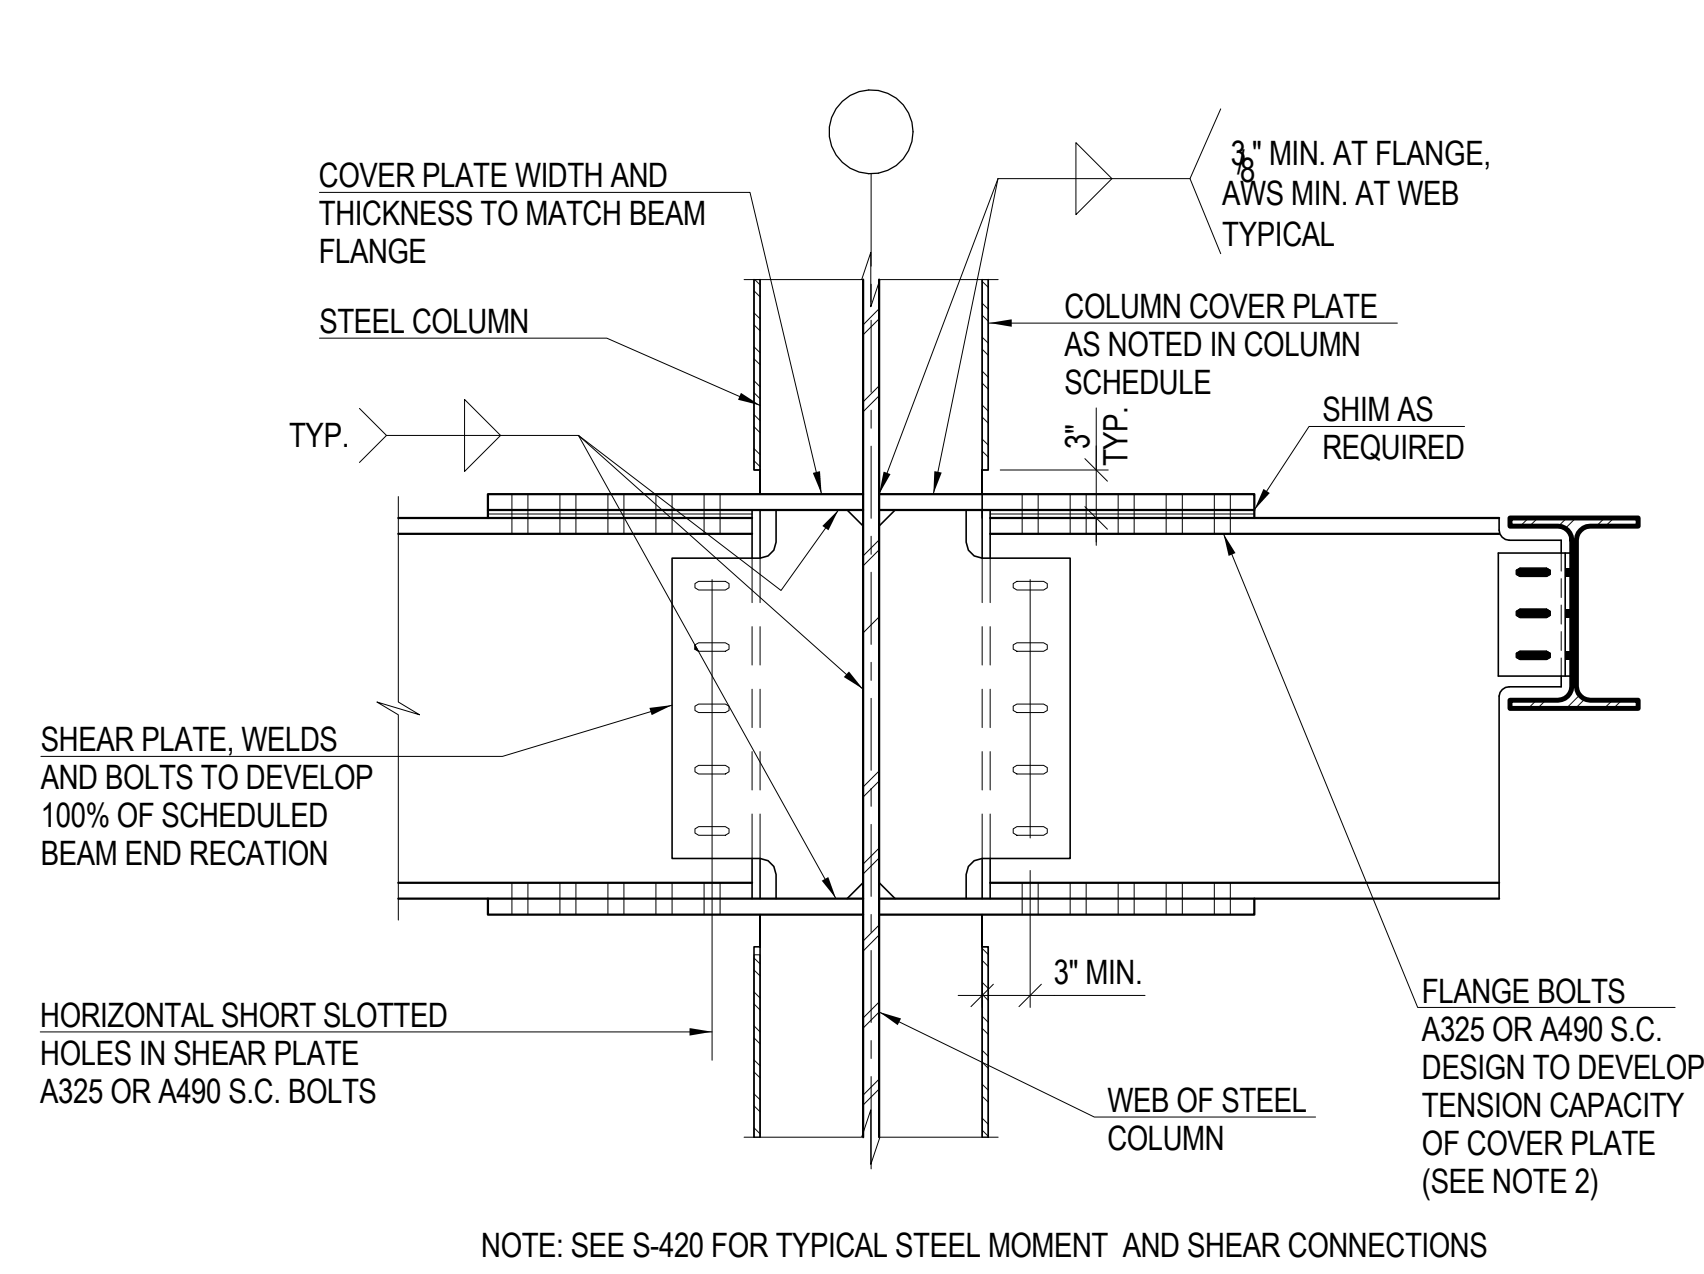

SECTION A



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375 Ninth Avenue, New York, NY 10001
Client

Brookfield
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
Acoustical Consultant
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404 Fifth Avenue #8, New York, NY 10018

Vibration Consultant
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65 Broadway, Suite 401, New York, NY 10006


Code Consultant
Code Consultants Professional Engineers PC
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166 Ames Street, Hackensack, NJ 07601

Wind Tunnel Consultant
Rowan Williams Davies & Irwin Inc.
650 Woodlawn Road West, Guelph
Ontario, Canada N1K 1B8



Key Plan:

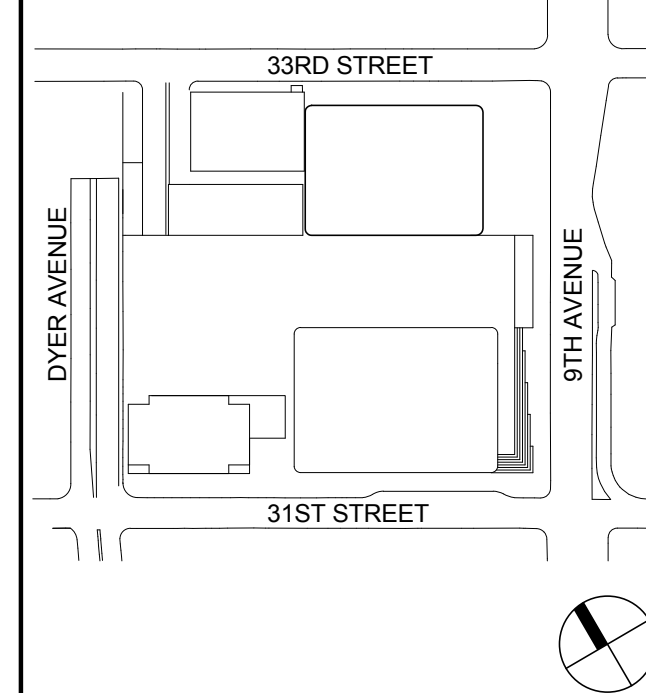

Seal & Signature:

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Sheet Name:

**TYPICAL
STRUCTURAL
STEEL SECTIONS
& DETAILS**

Project No.:	B-SCAN Sheet No.:
211157	S-421.00
Date:	Sheet No.:
20 JUN 2014	S-421
Scale:	Page No.:
1" = 1'-0"	88 of 90



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Brookfield
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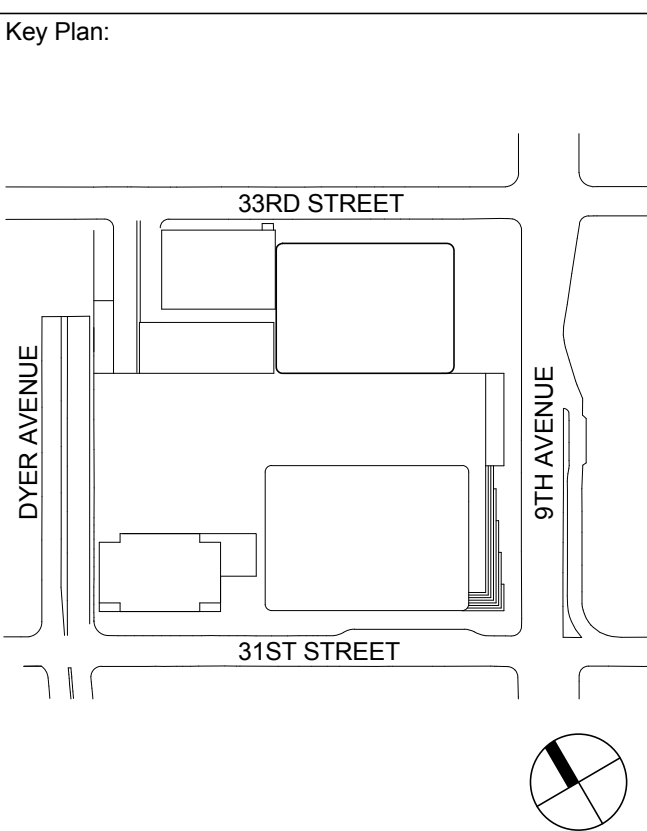
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Seal & Signature


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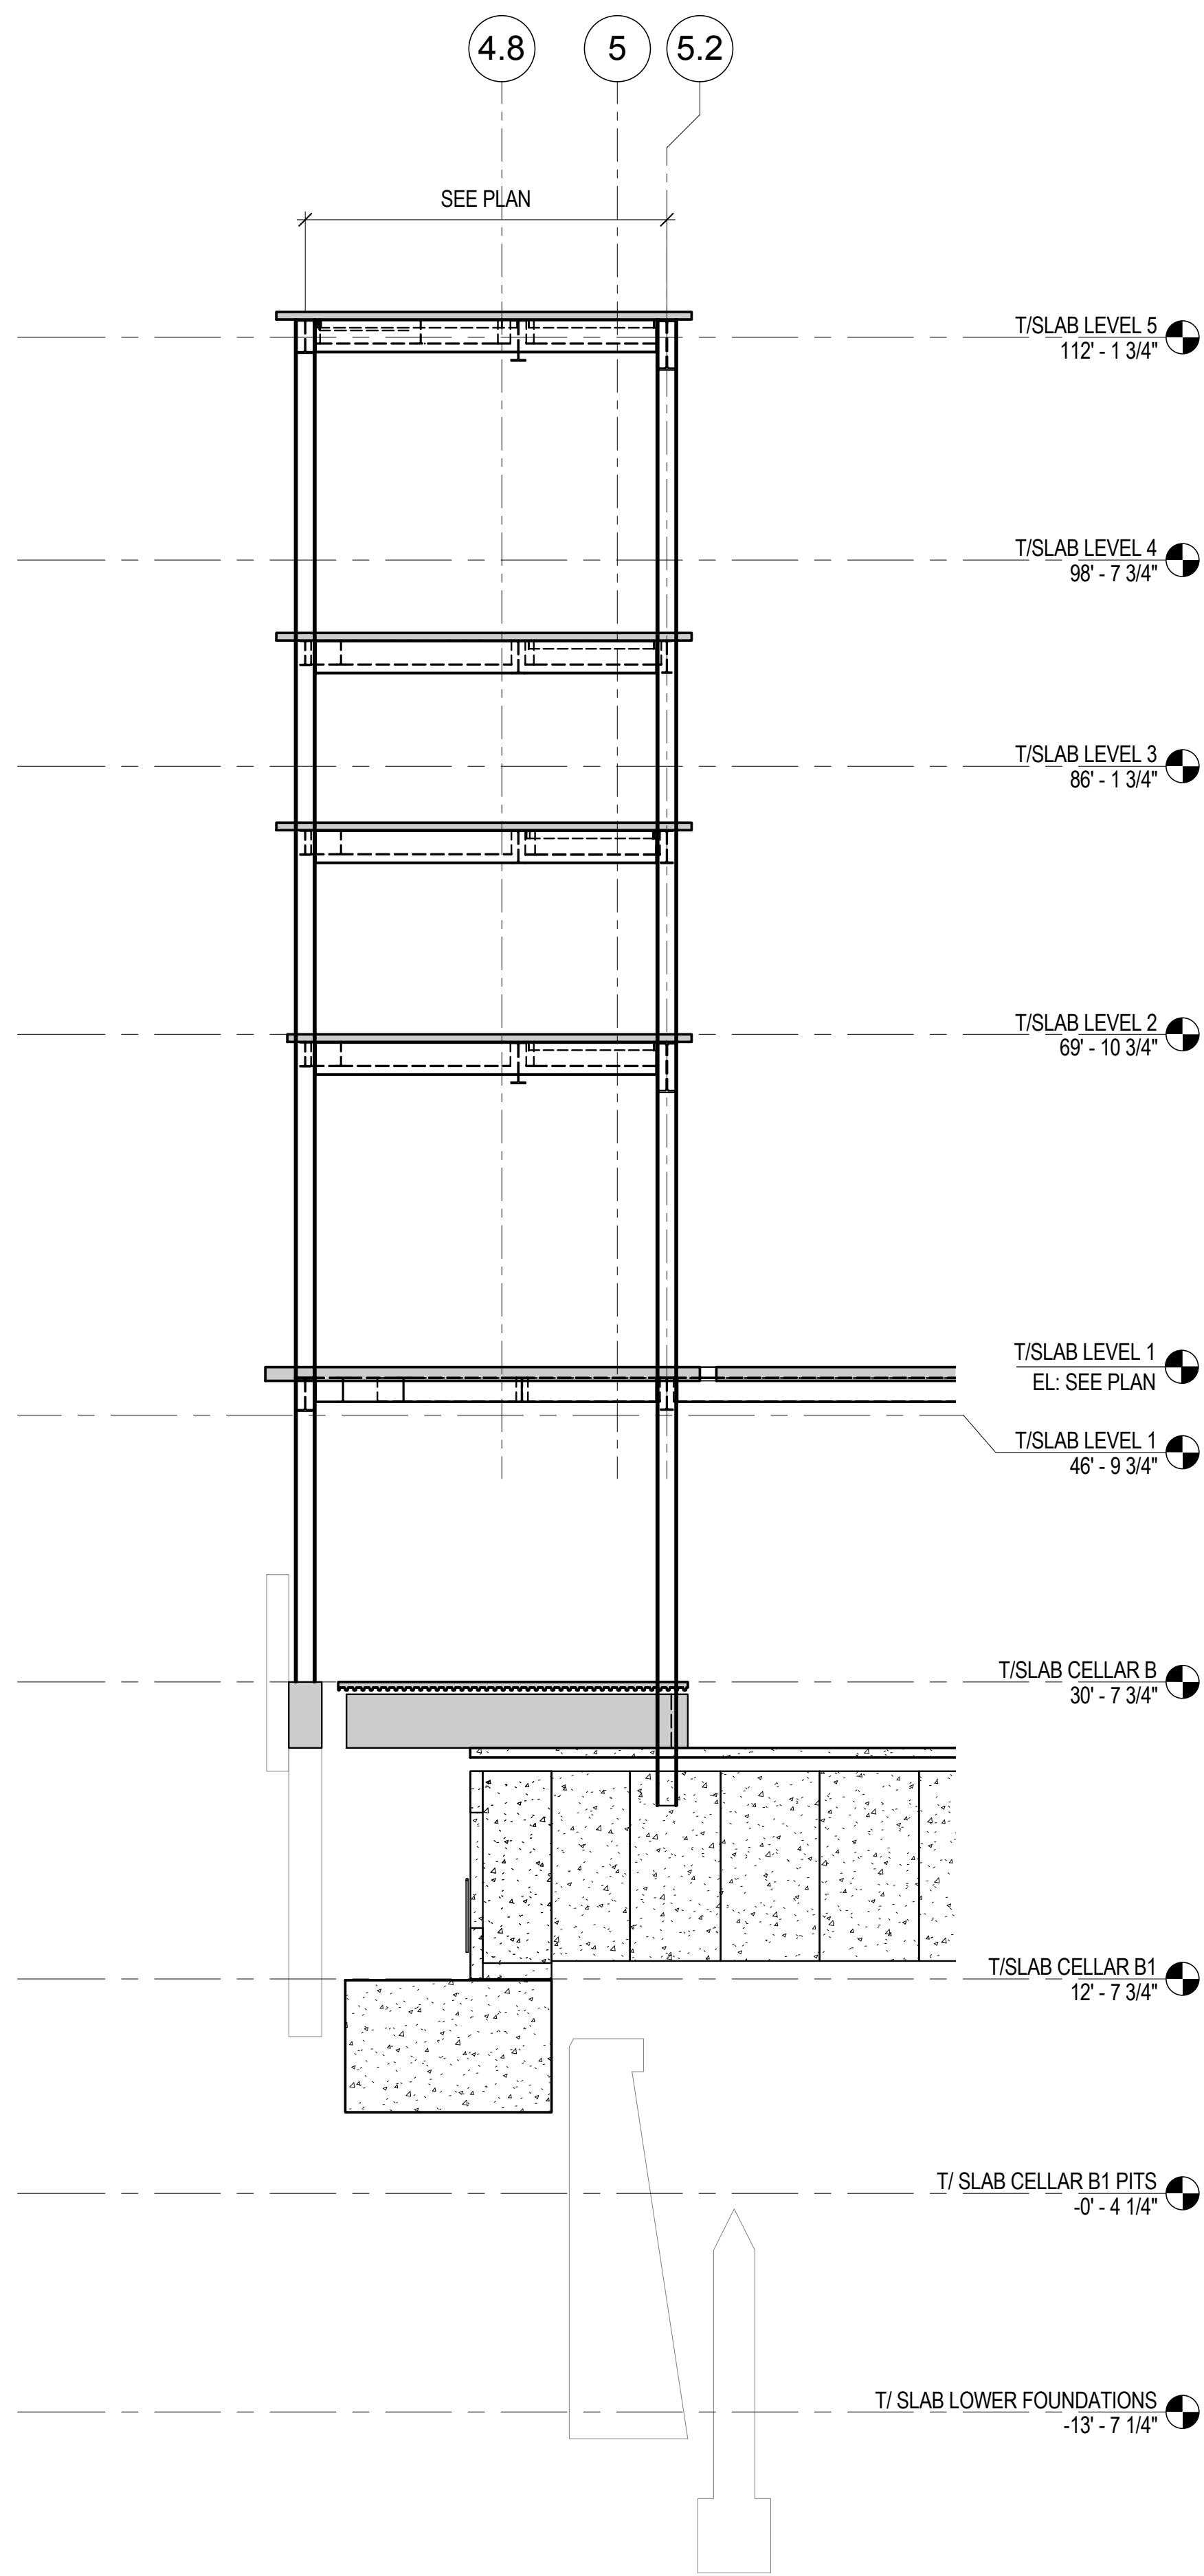
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Date: 20 JUN 2014
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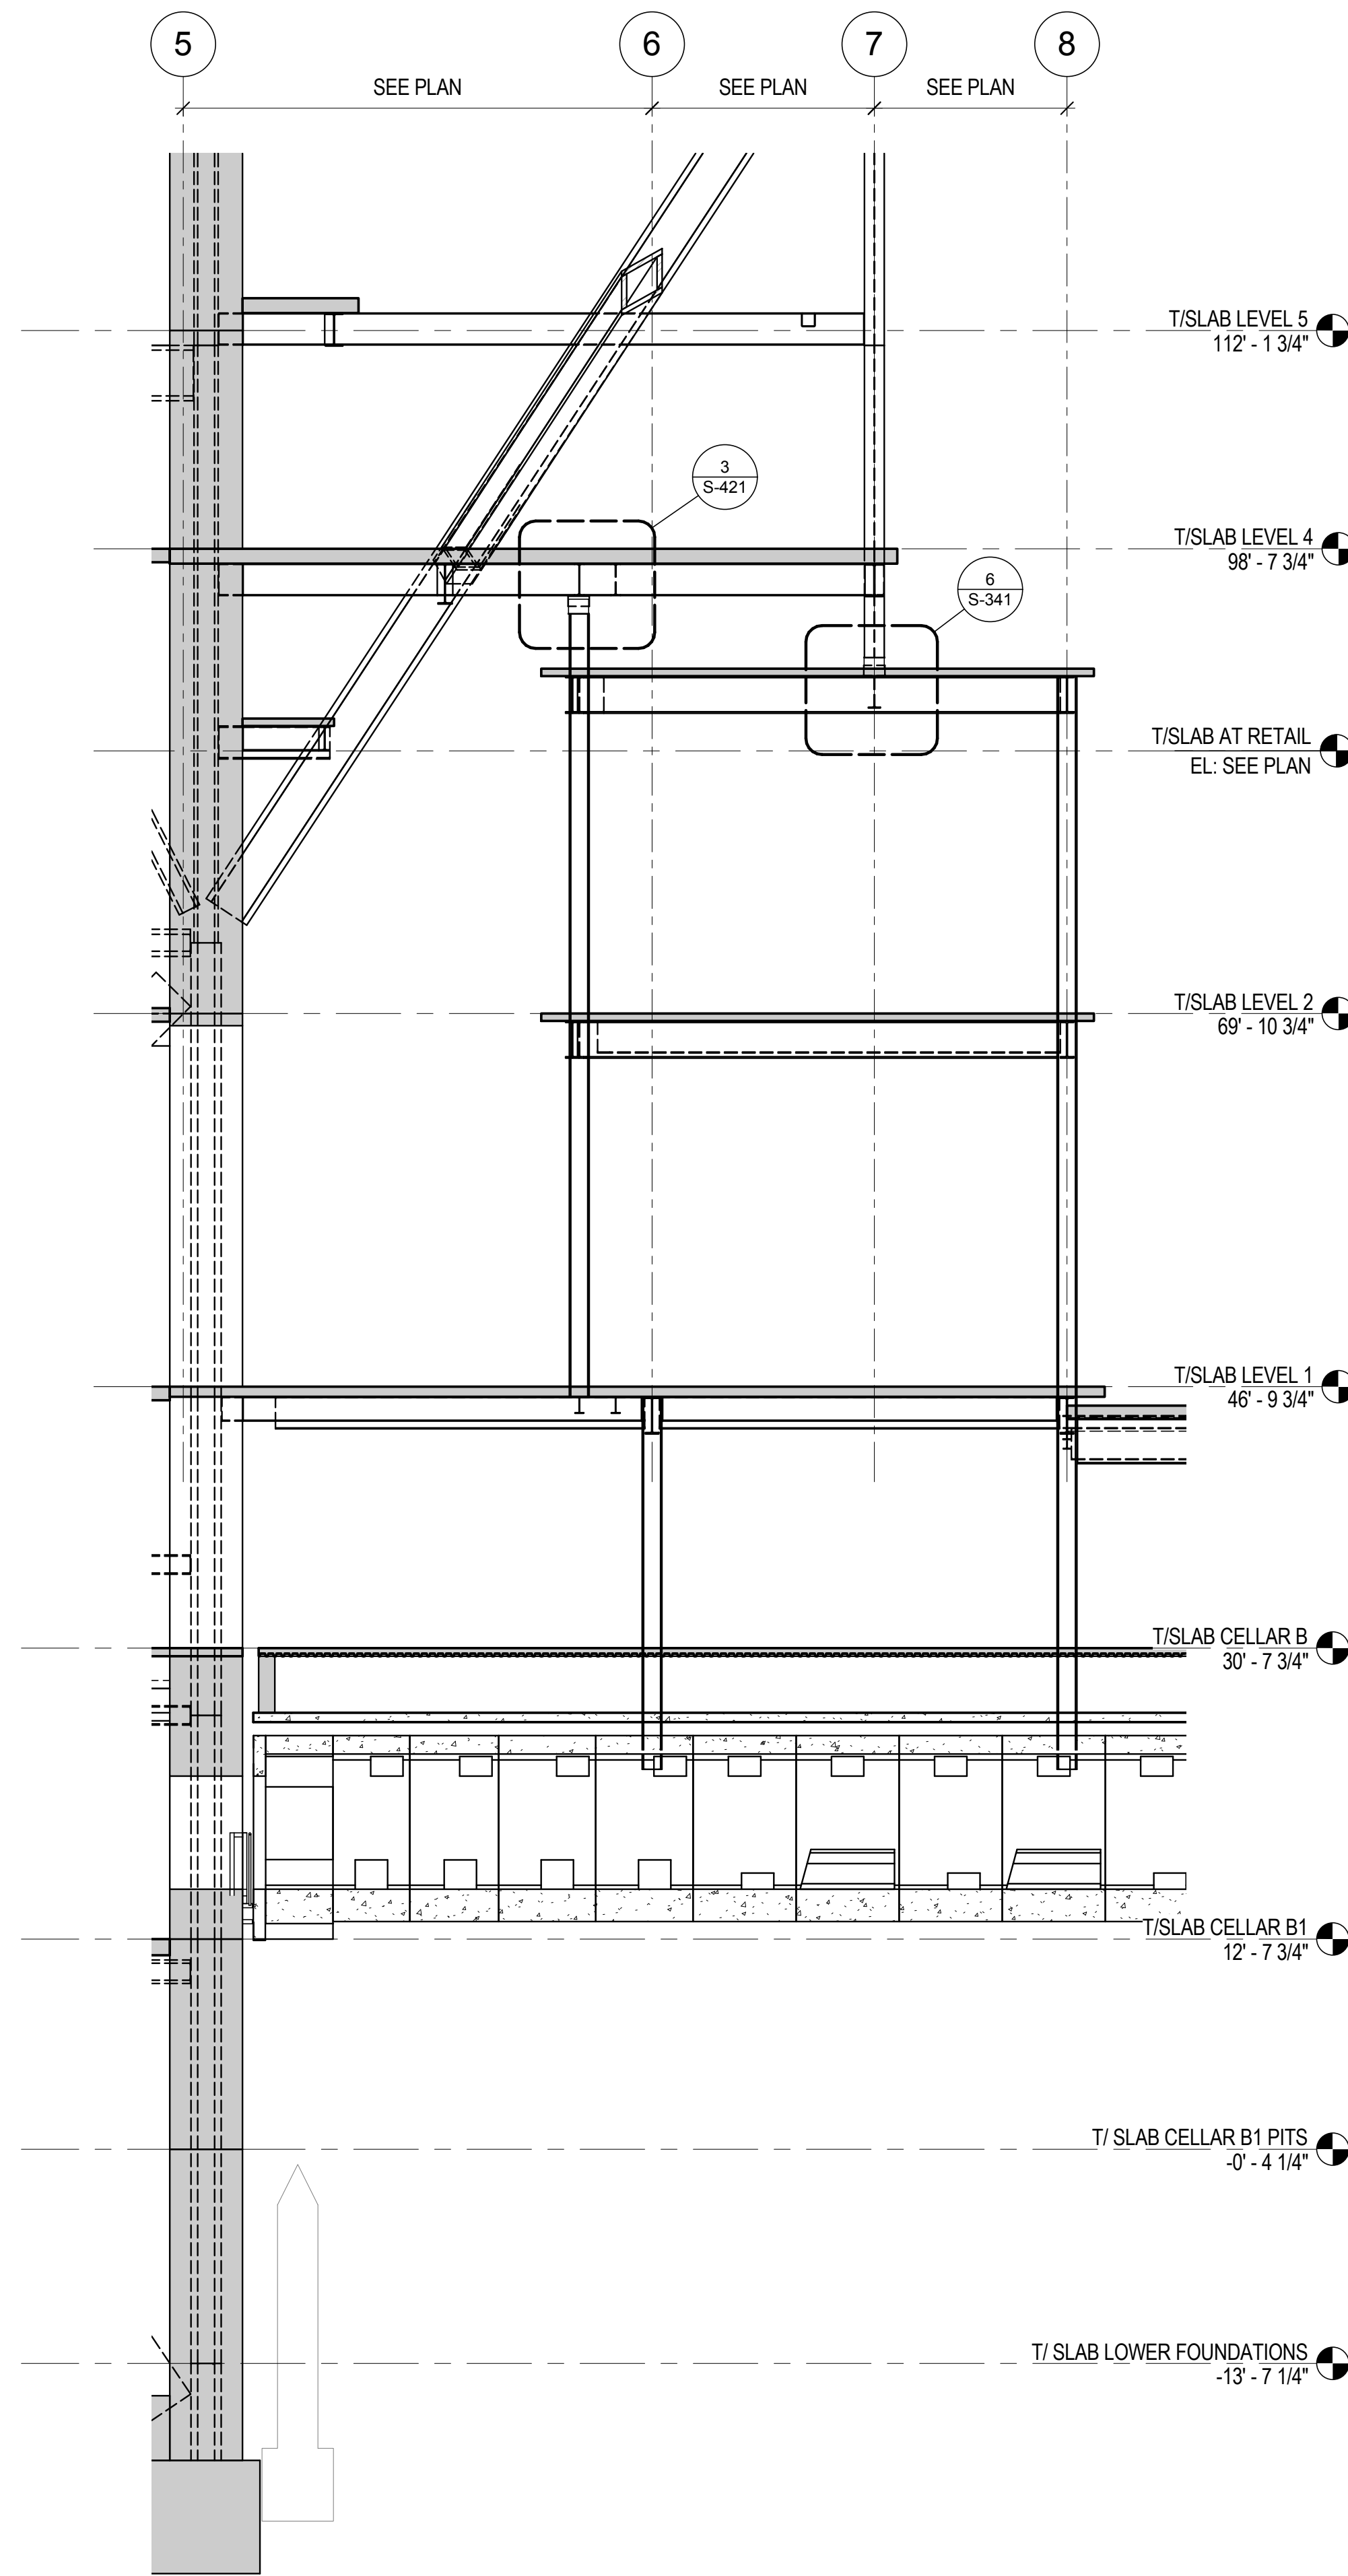
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Sheet No.: S-422
Page No.: 89 of 90




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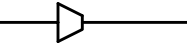

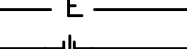

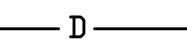




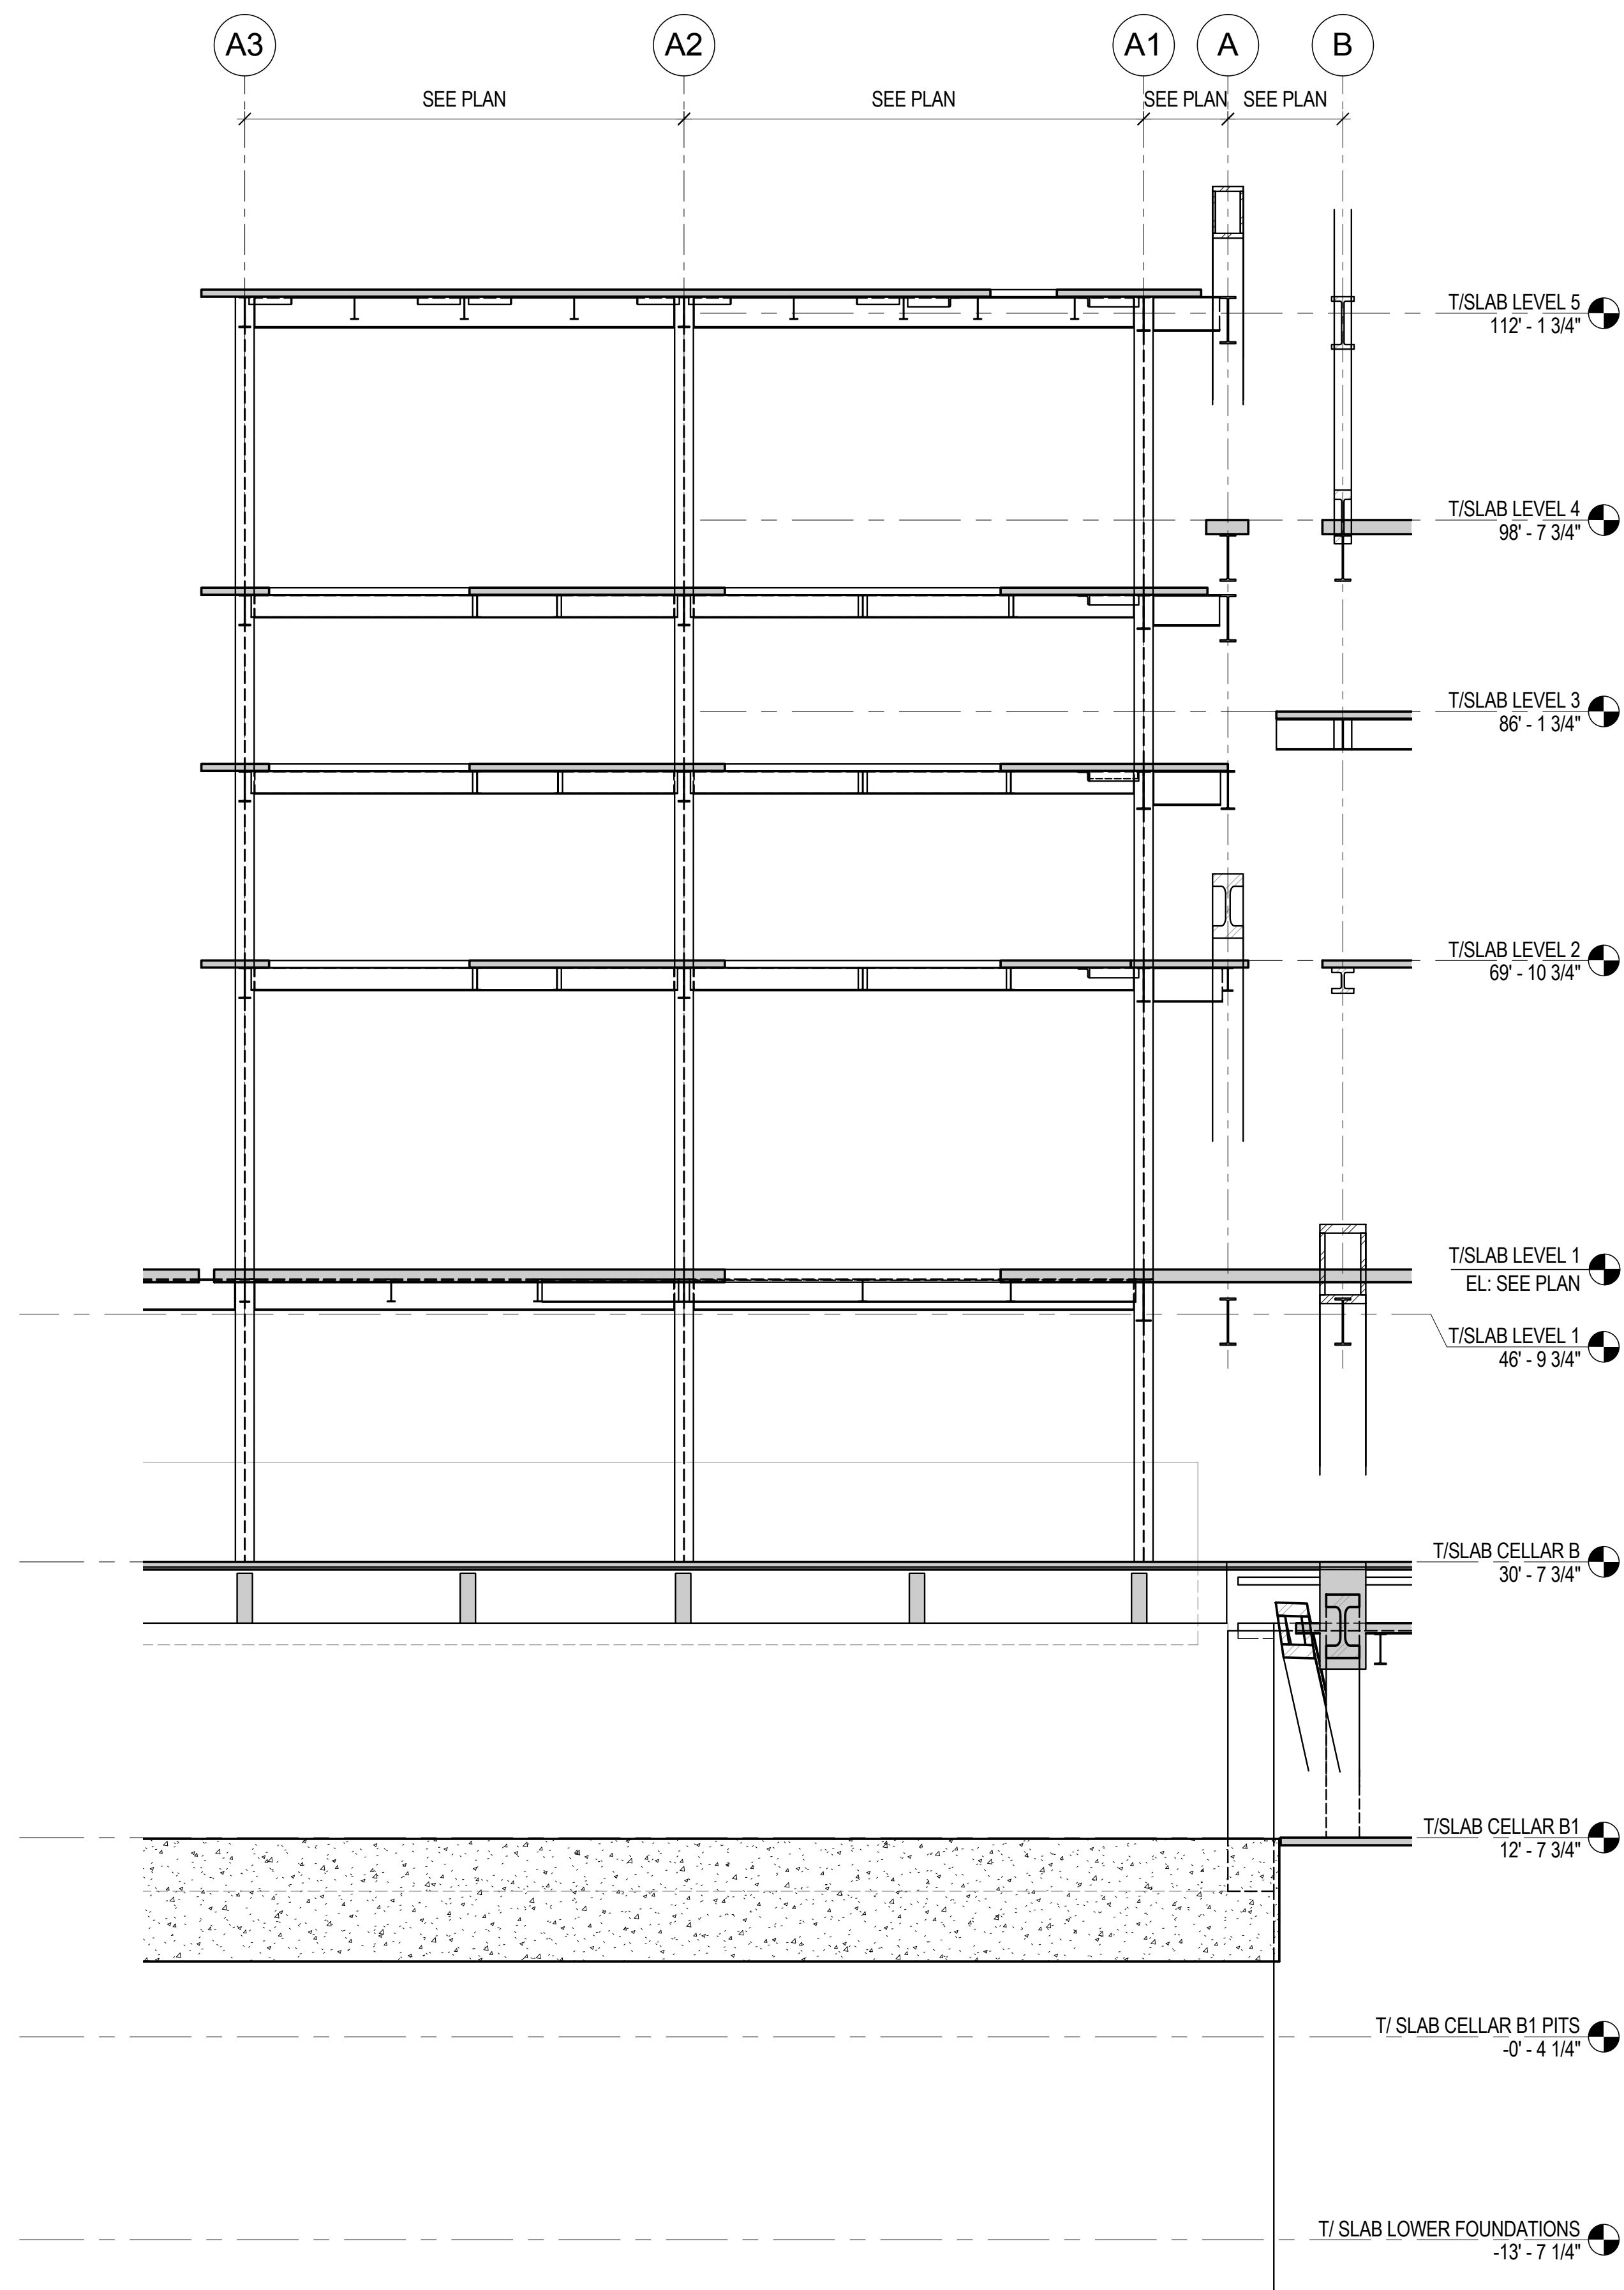


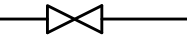




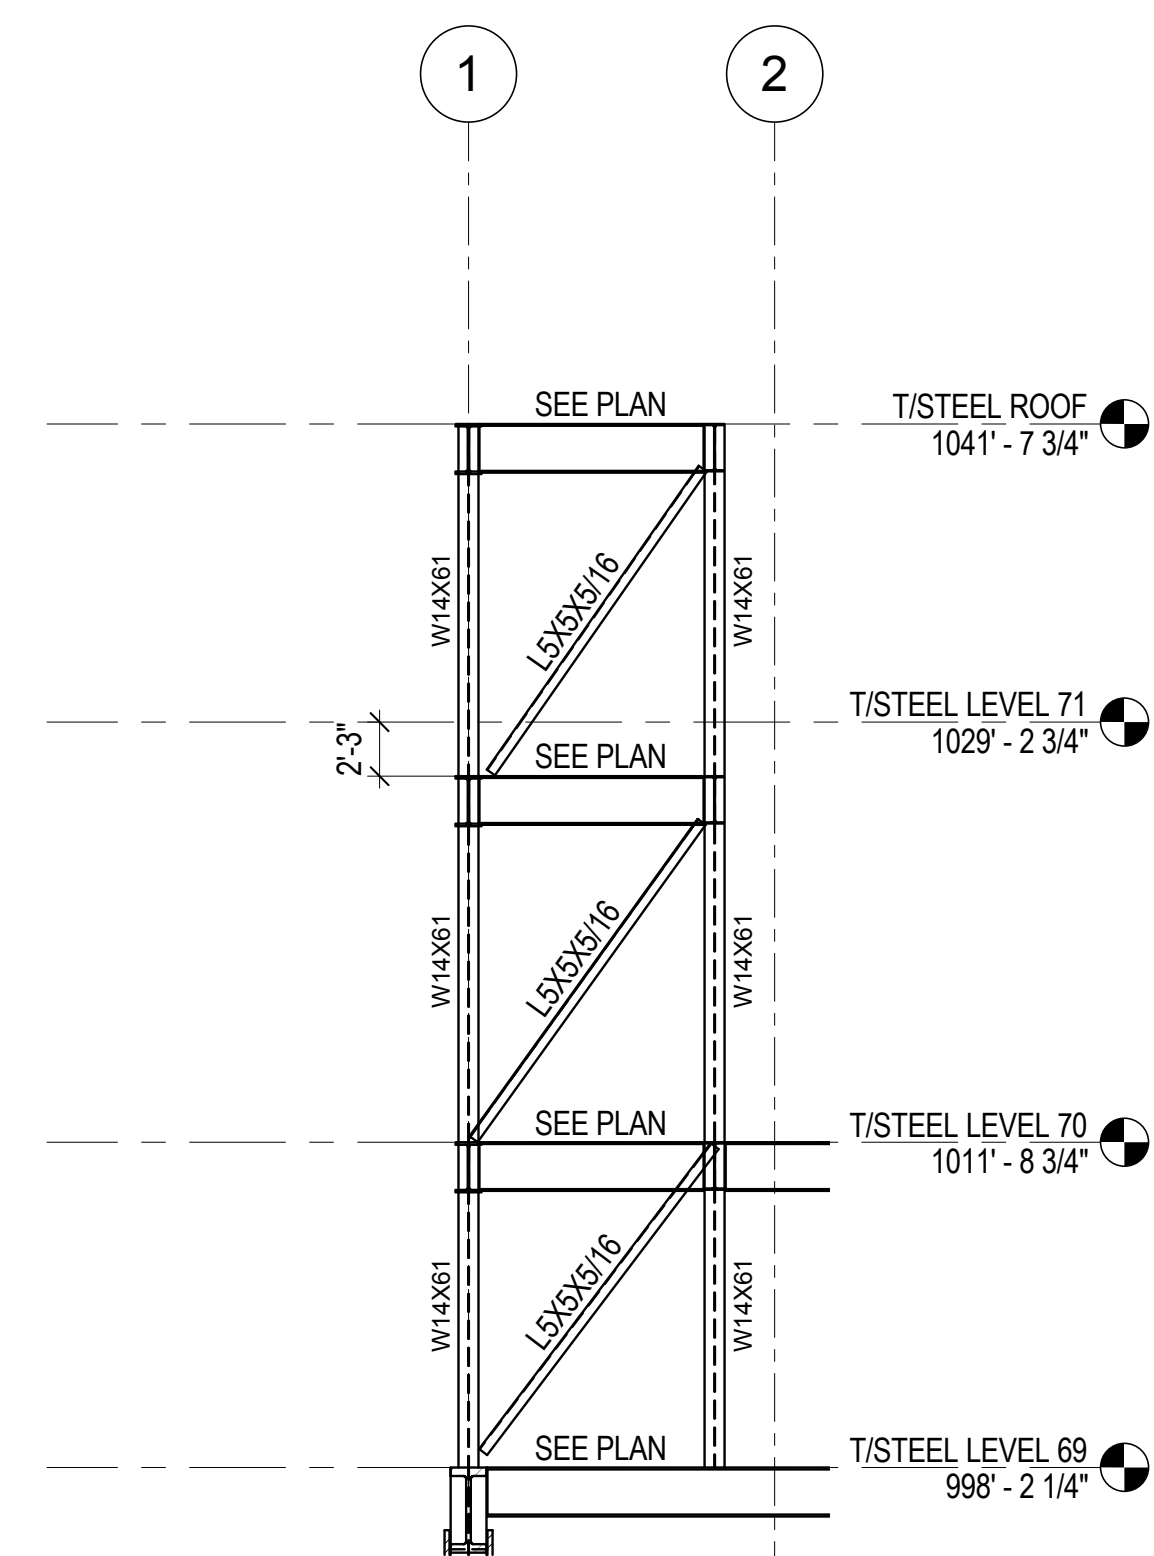




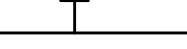

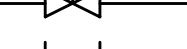

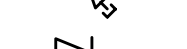

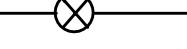
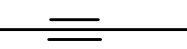
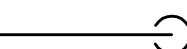

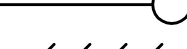
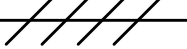
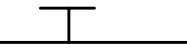




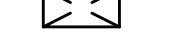
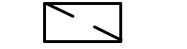
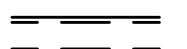
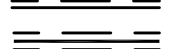



2 RETAIL SECTION LOOKING WEST
1/8" = 1'-0"



3 RETAIL SECTION NEAR BUILDING LOOKING WEST
1/8" = 1'-0"

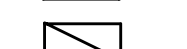

4 TYPICAL BRACING AT TOP OF TOWER
1/8" = 1'-0"

KEY TO SYMBOLS		
ABBREVIATIONS		SYMBOLS
AC AD AFF AHU AL ALD BDD BI BRD BR(G) CAV CC CD CHWR CHWS COD CR(G) CV CVR CWR CWS DB DSD DWBI E EAT EMR FAI FC FCU FD FL FLOR FLV FDR FDS FSD GSX GX HC HWR HWS HX ITF JDKTD KW KX LAT LPS LWT M MER MLWS MM MMS M NC NE ND NTS NW OAI OBD P PC PCHWR PCHWS PCWS PCWR PHC PHWR PHWS RA RR RSX RTX R/S S SA SCWS SCWR SD SE SF ST SWH SWH SX S/S TD TF TR(G) TX U UC UDN V VAV V VI VIV VR V VMS VP W/SQ. FT	AIR CONDITIONING UNIT ACCESS DOOR ABOVE FINISHED FLOOR AIR HANDLING UNIT ACUSTICAL LINING AUTOMATIC LOUVER DAMPER BACKDRAFT DAMPER BLACK IRON BAROMETRIC RELIEF DAMPER BOTTOM REGISTER DR GRILLE CONSTANT AIR VOLUME CODLING COIL CEILING DIFFUSER CHILLED WATER RETURN CHILLED WATER SUPPLY CLEAN OUT DOOR CEILING REGISTER DR GRILLE CONSTANT VOLUME SUPPLY BOX CONSTANT VOLUME RETURN BOX CONDENSER WATER RETURN CONDENSER WATER SUPPLY DRY BULB TEMPERATURE DUCT SMOKE DETECTOR DOUBLE WIDTH DOUBLE INLET EXHAUST / EXHAUST REGULATOR BOX ENTERING AIR TEMPERATURE ELEVATOR MACHINE ROOM FRESH AIR INTAKE FLEXIBLE CONNECTION FAN COIL UNIT FIRE DAMPER FIRE LIFT FUSIBLE LINK REGISTER FIRE LIFT VESTIBULE FUEL OIL RETURN FUEL OIL SUPPLY COMBINATION FIRE SMOKE DAMPER GARAGE SMOKE EXHAUST GARAGE EXHAUST HEATING COIL HOT WATER RADIATION RETURN HOT WATER RADIATION SUPPLY HEAT EXCHANGER (CONVERTER) MOTOR CONTROL CENTER JUMP DUCT (TRANSFER DUCT) KILOWATTS KITCHEN EXHAUST LEAVING AIR TEMPERATURE LOW PRESSURE STEAM LEAVING WATER TEMPERATURE MOTOR MECHANICAL EQUIPMENT ROOM METAL LOUVER WITH WIRE MESH SCREEN MILLIMETERS MASDRY DR WALL OPENING (1 SQ. FT UDN) MEDIUM PRESSURE STEAM NORTH NORMALLY CLOSED NORTHEAST NOT IN CONTRACT NECK SIZE NORMALLY OPEN NOT TO SCALE NORTHWEST OUTSIDE AIR INTAKE OPPOSED BLADE DAMPER PUMP PUMPED CONDENSATE PROCESS CHILLED WATER RETURN PROCESS CHILLED WATER SUPPLY PRIMARY CONDENSER WATER SUPPLY PRIMARY CONDENSER WATER RETURN PRE HEAT COIL PRIMARY HOT WATER RETURN PRIMARY HOT WATER SUPPLY RETURN AIR REFRIGERANT RELIEF RETAIL SMOKE EXHAUST RETAIL TOILET EXHAUST RETURN/SPILL SUPPLY SUPPLY AIR SECONDARY CONDENSER WATER SUPPLY SECONDARY CONDENSER WATER RETURN SOUTH SMOKE DAMPER SOUTHEAST SQUARE FEET SOUND TRAP SOUTHWEST SINGLE WIDTH SINGLE INLET SMOKE EXHAUST STAINLESS STEEL TRANSFER DUCT TRANSFER FAN TOP REGISTER DR GRILLE TOILET EXHAUST UNDER ANOTHER SECTION OF THE SPECIFICATION UNDERCUT DOOR (1 INCH) UNIT HEATER UNLESS OTHERWISE NOTED VENTILATION VARIABLE AIR VOLUME REGULATOR VOLUME DAMPER VIBRATION ISOLATOR VARIABLE INLET VANES VESTIBULE PRESSURIZATION VARIABLE AIR VOLUME BOX WITH REHEAT COIL WEST WET BULB TEMPERATURE WIRE MESH SCREEN WEATHER PROOF WATTS PER SQUARE FOOT	 REDUCER  DIRECTION OF FLOW  EXPANSION LINE  UNION  PUMPED CONDENSATE  DRAIN LINE  VENT  REFRIGERANT RELIEF  HIGH PRESSURE STEAM  MEDIUM PRESSURE STEAM  LOW PRESSURE STEAM  HIGH PRESSURE CONDENSATE  MEDIUM PRESSURE CONDENSATE  LOW PRESSURE CONDENSATE  SHUT OFF VALVE (NORMALLY OPEN)  SHUT OFF VALVE (NORMALLY CLOSED)  BALANCING VALVE  AUTOMATIC CONTROL VALVE  SOLENOID VALVE  DUCT SMOKE DETECTOR  PRESSURE GAUGE  SAFETY RELIEF VALVE  MOTORIZED BUTTERFLY VALVE  STRAINER WITH BLOW OFF VALVE AND HOSE ADAPTER  CHECK VALVE  PIPE ANCHOR  PIPE GUIDE  PIPE TURNING DOWN  PIPE TURNING UP  UNDERGROUND PIPE  PRESSURE TEMPERATURE PORT  SUPPLY AIR DUCT UP  EXHAUST OR RETURN AIR DUCT UP  SUPPLY AIR DUCT DOWN  EXHAUST OR RETURN AIR DUCT DOWN  DUCT WITH ACOUSTIC LINING (1/2" THICK UDN)  FIRE RATED DUCT CONSTRUCTION (1 1/2" THICK UDN)  OFFSET IN DUCT ELEVATION  SHEET METAL PLENUM WALL  SOUND TRAP  CEILING DIFFUSER (2-WAY BLOW)  CEILING DIFFUSER (3-WAY BLOW)  CEILING DIFFUSER (4-WAY BLOW)  CEILING GRILLE (CEILING REGISTER) WHERE NOTED AS CR)  THERMOSTAT  FAN START/STOP SWITCH W/ PILOT LIGHT AC UNIT START/STOP W/THERMOSTAT DOOR LOUVER (SQ. FEET) UNDERCUT DOOR (1") PRESSURE TRANSMITTER IT CABINET TEMPERATURE SENSOR DIFFERENTIAL PRESSURE TRANSMITTER DUCT MOUNTED SMOKE DETECTOR STATIC PRESSURE SENSOR HUMIDITY SENSOR FLOW TRANSMITTER CARBON DIOXIDE DETECTOR CARBON MONOXIDE DETECTOR BUTTON TEMPERATURE SENSOR FLEXIBLE DUCT FAN CONSTANT/VARIABLE AIR VOLUME BOX OR EXHAUST BOX CONSTANT/VARIABLE AIR VOLUME BOX WITH REHEAT COIL AUTOMATIC LOUVER DAMPER COMBINATION FIRE/SMOKE DAMPER COMBINATION FIRE DAMPER/ AUTOMATIC LOUVER DAMPER VOLUME DAMPER ACCESS DOOR DISCONNECT SWITCH HEATING COIL COOLING COIL PUMP THERMOMETER EXISTING DUCTWORK/EQUIPMENT/PIPING TO BE REMOVED CONNECT NEW WORK TO EXISTING BEAM CUT

NYC BLDG. CODE NOTES		
GENERAL N.Y.C. BUILDING CODE NOTES (BUILDING CODE CITY OF NEW YORK EFFECTIVE JULY 1, 2008, TO BE COMPLIED WITH) 1. MATERIALS AND EQUIPMENT SUBJECT TO SPECIAL INSPECTION A. MECHANICAL SYSTEMS - CODE/SECTION: BC 1704.15 B. SMOKE CONTROL SYSTEMS - CODE/SECTION: BC 1704.14 C. FUEL OIL PIPING/STORAGE SYSTEMS - CODE/SECTION: BC 1704.16 D. HIGH PRESSURE STEAM PIPING - CODE/SECTION: BC 1704.17 E. HEATING SYSTEMS - CODE/SECTION: BC 1704.23 - FINAL INSPECTION PER BC 109.5 AND DIRECTIVE 14 OF 1975 2. THE FOLLOWING WORK ITEMS, COMPONENTS, MATERIALS, CAPACITIES, ETC., TO COMPLY WITH THE FOLLOWING: ARTICLE OR REFERENCE: WORK ITEM OR MATERIAL(S) CHAPTER SUBPARAGRAPHS A. DUCT CONSTRUCTION MC603 603.1 THROUGH 603.18 INCLUSIVE B. AIR INLETS AND OUTLETS MC608 608.1 THROUGH 608.23 INCLUSIVE C. FILTERS MC605 605.1 THROUGH 605.5 INCLUSIVE D. MOTORS AND FANS MC503 503.1 THROUGH 503.5 INCLUSIVE E. ELEC. WIRING AND EQUIP. MC301 301.7 (REFERENCE TO NYCEC) F. REFRIGERATION SYSTEMS MC1102 1102.1 THROUGH 1102.2.5 INCLUSIVE G. SMOKE CONTROLS MC513 513.1 THROUGH 513.20.3 INCLUSIVE H. CONTROLS MC405 405.1 THROUGH 405.2.1 INCLUSIVE I. HEATING CAPACITY MC312 312.1 (BC 1204.1 THROUGH 1204.4 INCLUSIVE) J. NOISE CONTROL REQUIREMENTS MC326 326.1 THROUGH 326.2.9 INCLUSIVE K. HYDROIC PIPING MC1001 1201.1 THROUGH 1210.3.2 INCLUSIVE L. INTAKES AND EXHAUSTS MC401 401.5 THROUGH 401.6 INCLUSIVE M. FUEL OIL PIPING AND STORAGE MC1301 1301 THROUGH 1308.3 INCLUSIVE 3. REFER TO ARCHITECTURAL DRAWINGS FOR FIRE RATED WALL COMPOSITIONS. 4. MINIMUM TEMPERATURE TO BE MAINTAINED IN HABITABLE ROOMS: 68°F AT A POINT 3 FEET ABOVE FLOOR WHEN 0°F OUTSIDE WITH 15 MPH WIND. HEATING REQUIREMENTS PER BC 1204 (MC 309.1). 5. VENTILATION FOR ALL AREAS IS COMPLIANT WITH BC 1203 UNDER WHICH MECHANICAL VENTILATION SHALL COMPLY WITH MC 403 6. WHERE UNDER MECHANICAL VENTILATION, A STATEMENT WILL BE FILED (BY OWNER OR TENANT IN POSSESSION) THAT THE VENTILATING SYSTEM WILL BE KEPT IN CONTINUOUS OPERATION DURING NORMAL OCCUPANCY OF THE PREMISES. 7. DETAIL OF DUCT SUPPORTS: ANCHORS BSA 390.58 SM INSERTS SLAB SLAB A. SEE NOTE 2.A. ABOVE FOR HANGERS, BRACINGS, ETC. B. UNLESS OTHERWISE NOTED, ALL DUCTS SHALL BE CONSTRUCTED OF GALVANIZED IRON. 8. MECHANICAL EQUIPMENT LOCATED OUTSIDE OF THE BUILDING OR WHERE EQUIPMENT OPENS TO THE EXTERIOR OF THE BUILDING SHALL BE SUBJECT TO THE NOISE LIMITATIONS OF BC 1207 (MC 926) WHERE WINDOWS OF A DWELLING UNIT ARE WITHIN 100 FT. OF EQUIPMENT OPENING TO OR ON THE EXTERIOR OF THE BUILDING. 9. WHERE PIPING OR DUCTWORK HAS TO BE HUNG IN SPACES WHERE INSERTS ARE NOT PROVIDED, INSTALL TWO STAR NO. 7000 DOUBLE 3/8 IN. EXPANSION SHIELDS CONNECTED BY A 2 INCH X 2 INCH ANGLE, FROM WHICH SUSPENDS THE HANGAR RODS. THE NUMBER OF HANGERS WILL BE DOUBLE THAT ALLOWED FOR INSERTS. ALL METHODS OF ATTACHMENT TO THE BUILDING STRUCTURE MUST BE SUBMITTED TO THE ARCHITECT AND STRUCTURAL ENGINEER FOR APPROVAL PRIOR TO THEIR USE. ANGLE SIZE SHALL BE SUITABLE TO SUPPORT THE LOAD WHICH IS BEING SUPPORTED. 10. PLANS ARE IN COMPLIANCE WITH LOCAL LAW 17-95 11. THE PLANS AND SPECIFICATIONS ARE IN COMPLIANCE WITH THE 2007 ENERGY CONSERVATION CODE OF NEW YORK STATE CHAPTER 8 AND THE LATEST EDITION (2008) OF NYC BUILDING CODE		

GENERAL NOTES	
1. ALL LOW PRESSURE BRANCH DUCTWORK (SUPPLY AND RETURN) SHALL BE PROVIDED WITH VOLUME CONTROL, SPLITTER DAMPERS AND VOLUME DAMPERS RESPECTIVELY (PROVIDE LOCK NUT AT DAMPERS). 2. PROVIDE COMBINATION FIRE/SMOKE DAMPER AT BRANCH CONNECTIONS TO ALL RISERS AND AT ALL SLAB AND FIRE RATED WALL PENETRATIONS. 3. ALL DUCTWORK AND PIPING ENCLOSURES FOR HORIZONTAL OFFSETS SHALL BE OF 2HR RATED MINIMUM SHUTWALL CONSTRUCTION (TOP, BOTTOM AND SIDES) SHALL BE SUPPORTED INDEPENDENTLY OF THE DUCTWORK OR PIPING AND SHALL BE THE WORK OF ANOTHER CONTRACTOR. 4. EACH VARIABLE AIR VOLUME BOX (WITH AND WITHOUT REHEAT COIL) AND CONSTANT VOLUME BOX (WITH REHEAT COIL) SHALL BE PROVIDED WITH A THERMOSTAT FURNISHED AND INSTALLED UNDER THE B.A.T.C. SECTION OF THE SPECIFICATIONS. THERMOSTATS SHALL BE LOCATED AS SHOWN OR AS DIRECTED. 5. FOR SIZES OF THE MOTOR CONTROL CENTERS (MCC, INCLUDING VARIABLE SPEED DRIVE) AND ARRANGEMENT AND/OR GROUPING OF ISOLATED STARTERS REFER TO ELECTRICAL CONTRACT DOCUMENTS. 6. ALL GRATING, OUTWALKS AND STEEL RUNG ACCESS LADDERS WILL BE PROVIDED UNDER ANOTHER SECTION OF THE SPECIFICATIONS. EXCEPT AS NOTED ON PLANS. 7. VARIABLE AIR VOLUME AND CONSTANT AIR VOLUME BOXES AND SOUND TRAP SYMBOLS SHOWN ON DRAWINGS ARE SCHEMATIC. SEE DETAIL OF INSTALLATION ON DRAWING FOR ACTUAL TYPICAL ARRANGEMENT REQUIRED. 8. BORDER TYPES, COLOR, FINISHES, AND METHOD OF ATTACHMENT FOR ALL DIFFUSERS, GRILLES AND REGISTERS SHALL BE COORDINATED WITH THE ARCHITECTURAL CEILING DETAILS AND SPECIFICATIONS. 9. ALL LINEAR DIFFUSERS ARE TO BE COORDINATED WITH ARCHITECTURAL PLANS FOR EXACT LENGTHS AND LOCATIONS. ACTIVE PLENUM SECTIONS SHALL BE OF THE SIZES AS SHOWN ON PLANS. EACH BRANCH TAP SERVING THE LINEAR DIFFUSER SHALL BE PROVIDED WITH A VOLUME DAMPER WHICH SHALL BE OPERABLE THROUGH THE ROOM SIDE FACE OF THE DIFFUSER. (CABLE OPERATED DAMPER) ACTIVE SUPPLY SECTIONS OF THE LINEAR DIFFUSERS SHALL BE PROVIDED WITH PATTERNS CONTROL DEVICES AND EQUALIZING GRIDS. ACTIVE OR INACTIVE RETURN SECTIONS SHALL NOT BE FURNISHED WITH PATTERNS CONTROL OR EQUALIZING GRIDS. REFER TO SPECIFICATIONS FOR MODEL NUMBERS. ALL FINISH COLORS AND TYPES SHALL BE AS PER ARCHITECTURAL DRAWINGS AND SPECIFICATIONS. 10. THERMOSTAT SHOULD BE LOCATED 5'-0" A.F.F. AND 9" FROM EDGE OF DOOR U.D.N. FINAL LOCATIONS TO BE VERIFIED WITH THE ARCHITECT. FINISHED PAINT COLOR TO BE SELECTED BY THE OWNER. MANUFACTURER'S LOGO SHALL NOT BE EXPOSED. 11. WHERE PIPING CONNECTIONS FOR EQUIPMENT SUCH AS PUMPS, CHILLERS, HEAT EXCHANGERS, ETC. DIFFER FROM THE LINE SIZE PIPING, IT SHALL BE THE RESPONSIBILITY OF THE MECHANICAL CONTRACTOR TO FURNISH AND INSTALL THE NECESSARY REDUCER/EXPANDER FITTINGS TO ENABLE CONNECTION BETWEEN THE PIPING SYSTEM AND THE EQUIPMENT. 12. ALL PRESSURE AND TEMPERATURE GAUGES ARE SCHEMATICALLY SHOWN ON THE PLANS. REFER TO SPECIFICATIONS FOR EXACT TYPES. 13. REFER TO SCHEDULE SHEETS FOR THE DIFFUSER, GRILLE AND REGISTER SCHEDULES. 14. LOCATION OF DIRECT DIGITAL CONTROL (DDC) AND LOCAL (LCL) PANELS SHOWN ON PLANS ARE SUGGESTED. LOCATIONS ONLY FINAL LOCATION AND EXACT QUANTITY OF DDC/LCL PANELS WILL BE DEPENDENT ON SELECTION OF A.T.C. VENDOR AND SHALL BE SUBJECT TO SHOP DRAWING SUBMITTAL, REVIEW AND APPROVAL BY THE ENGINEER AND ARCHITECT. 15. ALL COMBINATION FIRE/SMOKE DAMPERS SHALL BE APPROVED FOR USE IN NEW YORK CITY (SHALL HAVE NEW YORK CITY M.E.A./B.S.A. NO.) DAMPERS SHALL BE INSTALLED IN ACCORDANCE WITH APPROVED U.L. LISTING REQUIREMENTS. DAMPERS SHALL BE RIGIDLY AS STD.	16. ALL FSD AND TERMINAL BOXES WITH REHEAT COILS SHALL BE PROVIDED WITH ACCESS DOORS. 17. ALL MEW FLOORS TO BE WATERPROOFED. (REFER TO ARCH. DRAWINGS) 18. ALL STEAM VALVES, CHILLED WATER, CONDENSER WATER AND HOT WATER PUMPS SHALL BE PROVIDED WITH INSULATED CUSTOM FITTED BLANKET/ENCLOSURES AS PER SPECIFICATION. 19. INSTALL INITIAL CROSS CONNECTION "FLUSH VALVES" AT THE BEGINNING AND END OF ALL WATER PIPE RUNS. VALVE SIZE SHALL NOT BE LESS THAN TWO PIPE SIZES SMALLER THAN THE LINE SIZE WITH A MINIMUM SIZE OF 2" WATER SYSTEMS INCLUDE: CHILLER WATER, SECONDARY CONDENSER, HOT WATER REHEAT, HOT WATER RADIATION, ETC. 20. ALL HEAT TRANSFER PACKAGED EQUIPMENT (PUMPS, HEAT EXCHANGERS, EXPANSION TANKS, CONDENSATE PUMPS, ETC.) SHALL BE VALVED AS SHOWN ON THE DETAIL SHEETS, AND/OR AS DESCRIBED IN THE SPECIFICATIONS. 21. ALL TERMINAL BOXES AND EQUIPMENT THAT REQUIRE ACCESS AND SERVICE SHALL BE CENTER LINE NO MORE THAN 11'-0" ABOVE FINISH FLOOR. 22. ALL ELEVATOR HOSTWAYS SHALL BE PROVIDED WITH A 3 SQUARE FOOT VENT TO THE EXTERIOR. REFER TO ARCHITECTURAL PLANS FOR VENTING REQUIREMENTS. 23. ALL VALVED OUTLETS FOR FUTURE USE AND DEAD LESS SHALL BE PROVIDED WITH A BYPASS LINE AND BALANCING VALVE (INCLUDING BUT NOT LIMITED TO THE VALVES FOR FUTURE PUMPS, VALVED OUTLETS ON FLOUT FLOORS) 24. ALL DUCTWORK LOCATED IN ELECTRICAL ROOMS SHALL BE INSTALLED 6'-0" ABOVE ALL ELECTRICAL EQUIPMENT. 25. ALL PIPING RUNNING THROUGH OR SERVING ELECTRICAL ROOMS SHALL BE LOCATED 6'-0" ABOVE ALL ELECTRICAL EQUIPMENT. PIPING SHALL BE PROVIDED WITH A DRAIN PAN AND LEAK DETECTION TIED INTO THE DMS SYSTEM. 26. ALL CHILLED WATER VALVES SHALL BE RATED FOR ANSI CLASS 300. 27. ALL MOTORS SHALL BE INVERTER DUTY RATED. 28. PER NYC BUILDING CODE AND THE SEISMIC CATEGORY C ASSIGNED TO THIS BUILDING, MECHANICAL SYSTEMS ARE REQUIRED TO BE SEISMICALLY RESTRAINED. REFER TO COMPONENT SEISMIC IMPORTANCE FACTORS IP SCHEDULE ON THIS DRAWING. 29. ALL METAL LOUVERS, AND ALL BLANK OFF PANELS (INSULATED OR NOT INSULATED, ACTIVE OR INACTIVE) FOR LOUVERS SHALL BE PROVIDED UNDER ANOTHER SECTION OF THE SPECIFICATIONS. WIRE MESH SCREENS FOR LOUVERS SHALL BE PROVIDED BY THE LOUVER MANUFACTURER. ALL OTHER WIRE MESH SCREENS SHALL BE PROVIDED UNDER THIS SECTION OF THE SPECIFICATIONS. 30. ALL HORIZONTAL S.A. DUCTWORK UPSTREAM OF TERMINAL UNITS SHALL BE LEAK TESTED. 31. DIFFUSERS LOCATED IN INACCESSIBLE CEILINGS SHALL HAVE CORD OPERATED VOLUME DAMPERS IN ITS RESPECTIVE BRANCH DUCTS OPERABLE THROUGH FACE OF THE DIFFUSER. 32. PROVIDE CLEANOUTS FOR CONDENSATE DRAIN PIPING AT EACH CHANGE OF DIRECTION AS REQUIRED. 33. CONTRACTOR MUST SIZE REFRIGERANT LINES ONCE AN ACCURATE PIPING LAYOUT HAS BEEN DONE DURING THE SHOP DRAWING COORDINATION PHASE. REFRIGERANT PIPING SHALL BE SIZED IN ACCORDANCE WITH MANUFACTURER'S REQUIREMENTS AND RECOMMENDATIONS. 34. ALL REQUIRED SPECIAL INSPECTIONS SHALL BE CONDUCTED BY A SPECIAL INSPECTOR IN ACCORDANCE WITH REQUIREMENTS OF THE NEW YORK CITY BUILDING CODE. SERVICES OF THE SPECIAL INSPECTORS SHALL BE RETAINED BY THE OWNER UNDER A SEPARATE CONTRACT. 35. ALL HVAC SYSTEMS SHALL BE BALANCED. BALANCING REPORTS SHALL BE PROVIDED TO THE OWNER.

COMPONENT SEISMIC IMPORTANCE FACTORS Ip		
COMPONENT	TAG NO.	Ip
EMERGENCY GENERATOR VENTILATION FANS	TAG, TBD REFER TO PLANS	1.5
EMERGENCY GENERATOR EXHAUST STACK	TAG, TBD REFER TO PLANS	1.5
STAIR PRESSURIZATION FANS (SMOKE CONTROL)	TAG, TBD REFER TO PLANS	1.5
GENERAL SMOKE CONTROL FANS (MAKE UP AND EXHAUST)	TAG, TBD REFER TO PLANS	1.5
HOSTWAY EXHAUST FANS (SMOKE CONTROL, IF USED IN LIEU OF VENTING PER BC 3004.6.1)	TAG, TBD REFER TO PLANS	1.5
BASEMENT COMPARTMENTS	TAG, TBD REFER TO PLANS	1.5
FUEL OIL TANK ROOM EXHAUST FANS	TAG, TBD REFER TO PLANS	1.5
GAS METER ROOM EXHAUST FANS	TAG, TBD REFER TO PLANS	1.5
DUCT SYSTEMS FOR FANS WITH Ip=1.5	TAG, TBD REFER TO PLANS	1.5
BOILERS - GAS AND OIL FIRED	NA	1.5
APPLIANCES - GAS AND OIL FIRED (INCLUDING ROOFTOP UNITS)	NA	1.5
FUEL/DIESEL OIL TANKS	TAG, TBD REFER TO PLANS	1.5
FUEL/DIESEL OIL PUMPS	TAG, TBD REFER TO PLANS	1.5
FUEL/DIESEL OIL PIPING	TAG, TBD REFER TO PLANS	1.5
STEAM PIPING	TAG, TBD REFER TO PLANS	1.5
STEAM HEAT EXCHANGERS	TAG, TBD REFER TO PLANS	1.5
STEAM UNIT HEATERS	TAG, TBD REFER TO PLANS	1.5
AHU/H&V UNITS WITH STEAM COILS	TAG, TBD REFER TO PLANS	1.5
APPLIANCES CONNECTED TO STEAM	TAG, TBD REFER TO PLANS	1.5
CONTROL SYSTEMS SERVING EQUIPMENT WITH Ip=1.5	TAG, TBD REFER TO PLANS	1.5
COMPONENTS CONTAINING HAZARDOUS OR FLAMMABLE MATERIAL IN EXCESS OF MAXIMUM ALLOWABLE QUANTITIES LISTED IN SECTION BC 307	TAG, TBD REFER TO PLANS	1.5
COMPONENTS WITH Ip =1.0 LOCATED ABOVE OR IN PROXIMITY TO COMPONENTS WITH Ip=1.5 WHICH COULD DAMAGE COMPONENTS WITH I =1.5	NOTE 4	1.5
REMARKS: FOR ALL ITEMS THAT ARE REQUIRED TO HAVE SEISMIC BRACING OR RESTRAINTS, SEISMIC PLANS AND SEISMIC BRACING CALCULATIONS SHALL BE PREPARED, SEALED, AND SUBMITTED BY A PROFESSIONAL ENGINEER LICENSED IN THE STATE OF NEW YORK ENGAGED BY THE CONTRACTOR. THE ENGINEER SHALL PROVIDE INSTALLATION SUPERVISION OF ALL SEISMIC BRACING AND RESTRAINTS. THE CONTRACTOR'S REGISTERED PROFESSIONAL ENGINEER SHALL SUBMIT SIGNED AND SEALED AFFIDAVIT AND AS BUILTS STATING THAT THE INSTALLATION IS IN FULL COMPLIANCE WITH THE SIGNED/SEALED SHOP DRAWINGS. NOTES: 1. THE DEFAULT FOR TYPICAL COMPONENTS IN NORMAL SERVICE IS Ip=1.0 2. SEISMIC DESIGN CATEGORY B IS ASSIGNED TO THE NEW ADDITION PROJECT. 3. THE FUNCTION AND PHYSICAL INTERRELATIONSHIP OF COMPONENTS AND THEM EFFECT ON EACH OTHER SHALL BE DESIGNED SO THAT FAILURE OF AN ESSENTIAL OR NONESSENTIAL BUILDING COMPONENTS SHALL NOT CAUSE THE FAILURE OF A NEARBY ESSENTIAL BUILDING COMPONENTS. 4. REFER TO DETAIL DRAWINGS FOR TYPICAL SEISMIC BRACING. 5. PENDANT SUPPORTED EQUIPMENT SHALL NOT CONTACT ANY OTHER OBJECT AT A 45° ANGLE TO VERTICAL.		

ALTERNATES	
NUMBER	DESCRIPTION
23000.1	PROVIDE AN ADD ALTERNATE PRICE TO FURNISH AND INSTALL AN ACOUSTIC RETURN AIR PLENUM SECTION ON EACH LOCAL FLOOR AIR CONDITIONING UNIT. THE PLENUM WILL BE OF SIMILAR CONSTRUCTION AS THE LOCAL FLOOR AIR CONDITIONING UNIT CASING WITH A PERFORATED INNER LINER. REFER TO M-200 FOR TYPICAL FAN ROOM DETAILS.
23000.2	PROVIDE AN ADD ALTERNATE PRICE TO FURNISH AND INSTALL THE 1200 F.W CO-GENERATION SYSTEM. THE ALTERNATE WOULD INCLUDE ALL SPECIALTIES AND ALL REQUIRED AUXILIARIES FOR THE CO-GEN MODULES, SUPPORTING SYSTEMS FOR EXHAUST FUELS, VENTILATION MAKE-UP AIR, PIPING, INSULATION AND CONTROLS. ALSO INCLUDED WOULD BE ALL EQUIPMENT AND PIPING ASSOCIATED WITH THE HEAT RECOVERY AND ABSORPTION COOLING SYSTEMS. REFER TO M-166, 403, 404, 600, 601, 603, FOR THE 68TH FLOOR MECHANICAL PLAN AND ASSOCIATED PIPING RISER DIAGRAMS AND FLOW DIAGRAM.
23000.3	PROVIDE AN ADD ALTERNATE PRICE TO FURNISH AND INSTALL ELECTRIC CLOSEST EXHAUST FANS AND MAKE-UP AIR TRANSFER DUCTS. FANS WOULD SERVE THE TYPICAL A & B ELECTRIC CLOSETS ON THE TOWER OFFICE FLOOR 6 THRU 17. REFER TO TYPICAL TOWER OFFICE FLOOR PLANS AND M-501 FOR THE EXHAUST FAN SCHEDULE.
23000.4	PROVIDE AN ADD ALTERNATE PRICE TO FURNISH AND INSTALL UPGRADED FILTERS FOR LOBBY AND BACK OF HOUSE AIR CONDITIONING UNITS. UPGRADE FINAL FILTRATION ON THESE SYSTEM TO MEET 17 FILTERS. UNITS FOR THE FILTER UPGRADE ARE LISTED: -LOBBY SYSTEMS (ACU-4-1,2) -BASEMENT OUTSIDE AIR (M-2-3) -SECURITY CONSOLE ROOM (AC-2-1) -VISITORS CENTER (AC-1-1) -BACK OF HOUSE SYSTEMS ON B LEVEL (AC-8-1 THRU AC-8-8) -BACK OF HOUSE SYSTEMS ON B, B2, B3 (AC-81-1, AC-82-1, AC-83-1)
23000.5	PROVIDE AN ADD ALTERNATE PRICE TO FURNISH AND INSTALL ELECTRIC RADIANT FLOOR HEATER IN THE MAIN LOBBY. REFER TO ELECTRICAL DRAWINGS AND M-101A FOR THE LOCATION AND FLOOR AREAS FOR RADIANT FLOOR HEATING.
23000.6	PROVIDE AN ADD ALTERNATE PRICE TO FURNISH AND INSTALL TEMPORARY HEATING ON PER FLOOR BASIS FOR SHEELED FLOORS AWAITING TENANCY (NOT FOR CONSTRUCTION PHASE HEATING). THE HEATING WOULD BE PROVIDED BY A SERIES OF FAN-POWERED BOXES (FPBS) MOUNTED, PIPED, TRIMMED, WIRED AND CONTROLLED. REFER TO SCHEMATIC LAYOUT OF FPBS FOR TEMPORARY HEATING INDICATED ON M-106.



**MANHATTAN WEST:
NORTH TOWER**
375 Ninth Avenue, New York, NY 10001

Client

Brookfield

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Architecture/Structural Engineering

SOM

Skidmore, Owings & Merrill LLP
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Code Consultants Professional Engineers PC
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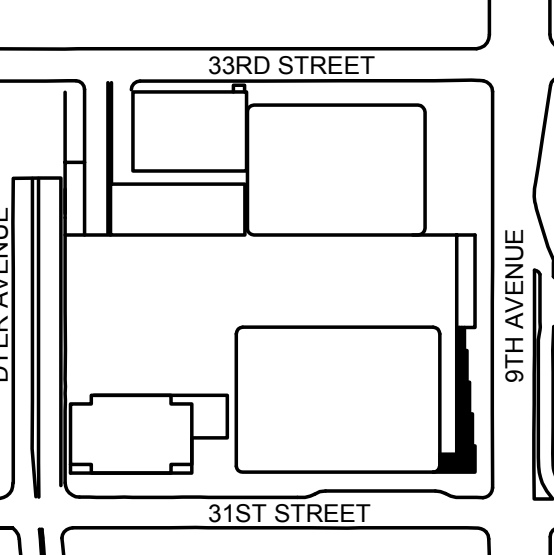
Facade Maintenance Consultant

Entek Engineering LLC
166 Ames Street, Hackensack, NJ 07601

Wind Tunnel Consultant

Rowan Williams Davies & Irwin Inc.
650 Woodlawn Road West, Guelph
Ontario, Canada N1K 1S8

Key Plan:



Seal & Signature:



No.	Date	Description
1	20 JUN 2014	ISSUED FOR FOUNDATION PERMIT
2	20 DEC 2013	ISSUED FOR FOUNDATION PERMIT
3	13 NOV 2013	ISSUED FOR FOUNDATION PERMIT
4	12 JUL 2013	ISSUED FOR 50% DESIGN DEVELOPMENT
5	12 JUL 2013	ISSUED FOR REVISION

Sheet Name:

**MECHANICAL
TITLE SHEET**

Project No:
14830.A.000

Date:
20 JUN 2014

Scale:
NTS

File No.:

B-SCAN Sheet No:
M-002.00

Sheet No.:
M-002

Page No.:



MANHATTAN WEST:
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375 Ninth Avenue, New York, NY 10001

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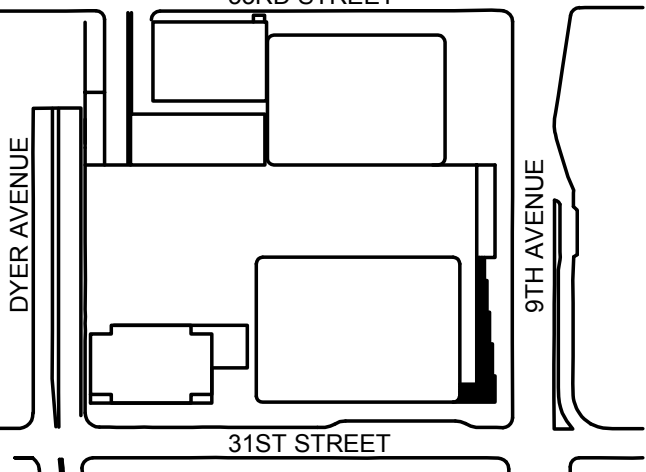
Vibration Consultant
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650 Woodlawn Road West, Guelph
Ontario, Canada N1K 1S8

Key Plan:



Seal & Signature:



A1 A B B.7 C C.8 D D.6 E E.3 F F.2 G G.5 H J J.3 K K.2 K.7 L

PROPERTY LINE

0.5

1

2

3

4

4.8

5

5.2

6

7

8

9

12x9 TD

W/1" A.L.

150

10x6

20

8

150

10x6



MANHATTAN WEST:
NORTH TOWER
375 Ninth Avenue, New York, NY 10001

Client

Brookfield

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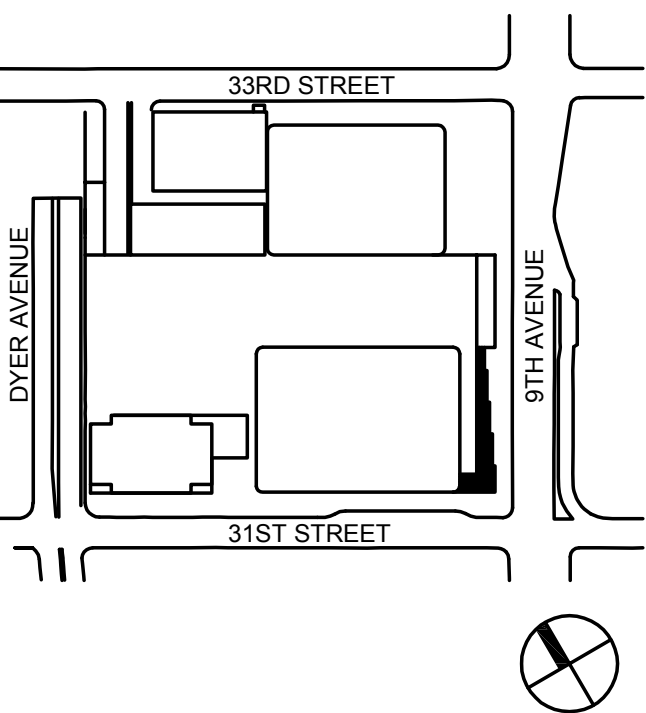
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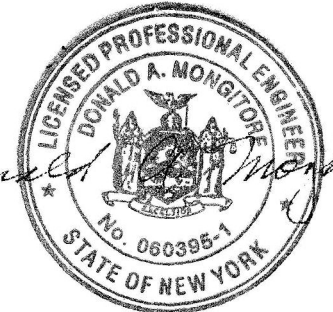
Wind Tunnel Consultant

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Ontario, Canada N1K 1S8

Key Plan:



Seal & Signature:



1	20 JUN 2014	ISSUED FOR FOUNDATION PERMIT
2	20 DEC 2013	ISSUED FOR FOUNDATION PERMIT
3	13 NOV 2013	ISSUED FOR OLD PROJECTS REVIEW
4	12 JUL 2013	ISSUED FOR 50% DESIGN DEVELOPMENT
5	18 MAR 2013	ISSUED FOR RECONFIGURATION

No. Date Description

Sheet Name:

MECHANICAL
CELLAR B1
FLOOR PLAN -
PART B

Project No:
14830.A.000

Date:
20 JUN 2014

Scale:
1/8"=1'-0"

File No.:

B-SCAN Sheet No.:

M-096.00

Sheet No.:

M-096

Page No.:

A4

A3

A2

A1

A

B

PROPERTY LINE
375 9TH AVENUE
N 375 9TH AVENUE

0.5

1

2

3

4

4.8

5

5.2

6

7

8

9

NO HVAC SCOPE
IN THIS AREA

SCOPE LINE

Client

Brookfield Place
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Accounting Consultant

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404 Fifth Avenue #8, New York, NY 10018

Identification Consultant

Wilson, Uhrig & Associates, Inc.
85 Broadway, Suite 601, New York, NY 10005

	1999	2000	2001	2002	2003
1. <i>Chlamydia trachomatis</i>	1.0	1.0	1.0	1.0	1.0
2. <i>Neisseria meningitidis</i>	1.0	1.0	1.0	1.0	1.0
3. <i>Streptococcus pneumoniae</i>	1.0	1.0	1.0	1.0	1.0
4. <i>Haemophilus influenzae</i>	1.0	1.0	1.0	1.0	1.0
5. <i>Legionella pneumophila</i>	1.0	1.0	1.0	1.0	1.0
6. <i>Yersinia enterocolitica</i>	1.0	1.0	1.0	1.0	1.0
7. <i>Salmonella enteritidis</i>	1.0	1.0	1.0	1.0	1.0
8. <i>Escherichia coli</i>	1.0	1.0	1.0	1.0	1.0
9. <i>Shigella flexneri</i>	1.0	1.0	1.0	1.0	1.0
10. <i>Staphylococcus aureus</i>	1.0	1.0	1.0	1.0	1.0
11. <i>Streptococcus pyogenes</i>	1.0	1.0	1.0	1.0	1.0
12. <i>Neisseria gonorrhoeae</i>	1.0	1.0	1.0	1.0	1.0
13. <i>Haemophilus ducreyi</i>	1.0	1.0	1.0	1.0	1.0
14. <i>Chlamydia pneumoniae</i>	1.0	1.0	1.0	1.0	1.0
15. <i>Mycoplasma pneumoniae</i>	1.0	1.0	1.0	1.0	1.0
16. <i>Legionella pneumophila</i>	1.0	1.0	1.0	1.0	1.0
17. <i>Yersinia enterocolitica</i>	1.0	1.0	1.0	1.0	1.0
18. <i>Salmonella enteritidis</i>	1.0	1.0	1.0	1.0	1.0
19. <i>Escherichia coli</i>	1.0	1.0	1.0	1.0	1.0
20. <i>Shigella flexneri</i>	1.0	1.0	1.0	1.0	1.0
21. <i>Staphylococcus aureus</i>	1.0	1.0	1.0	1.0	1.0
22. <i>Streptococcus pyogenes</i>	1.0	1.0	1.0	1.0	1.0
23. <i>Neisseria gonorrhoeae</i>	1.0	1.0	1.0	1.0	1.0
24. <i>Haemophilus ducreyi</i>	1.0	1.0	1.0	1.0	1.0
25. <i>Chlamydia pneumoniae</i>	1.0	1.0	1.0	1.0	1.0
26. <i>Mycoplasma pneumoniae</i>	1.0	1.0	1.0	1.0	1.0
27. <i>Legionella pneumophila</i>	1.0	1.0	1.0	1.0	1.0
28. <i>Yersinia enterocolitica</i>	1.0	1.0	1.0	1.0	1.0
29. <i>Salmonella enteritidis</i>	1.0	1.0	1.0	1.0	1.0
30. <i>Escherichia coli</i>	1.0	1.0	1.0	1.0	1.0
31. <i>Shigella flexneri</i>	1.0	1.0	1.0	1.0	1.0
32. <i>Staphylococcus aureus</i>	1.0	1.0	1.0	1.0	1.0
33. <i>Streptococcus pyogenes</i>	1.0	1.0	1.0	1.0	1.0
34. <i>Neisseria gonorrhoeae</i>	1.0	1.0	1.0	1.0	1.0
35. <i>Haemophilus ducreyi</i>	1.0	1.0	1.0	1.0	1.0
36. <i>Chlamydia pneumoniae</i>	1.0	1.0	1.0	1.0	1.0
37. <i>Mycoplasma pneumoniae</i>	1.0	1.0	1.0	1.0	1.0
38. <i>Legionella pneumophila</i>	1.0	1.0	1.0	1.0	1.0
39. <i>Yersinia enterocolitica</i>	1.0	1.0	1.0	1.0	1.0
40. <i>Salmonella enteritidis</i>	1.0	1.0	1.0	1.0	1.0
41. <i>Escherichia coli</i>	1.0	1.0	1.0	1.0	1.0
42. <i>Shigella flexneri</i>	1.0	1.0	1.0	1.0	1.0
43. <i>Staphylococcus aureus</i>	1.0	1.0	1.0	1.0	1.0
44. <i>Streptococcus pyogenes</i>	1.0	1.0	1.0	1.0	1.0
45. <i>Neisseria gonorrhoeae</i>	1.0	1.0	1.0	1.0	1.0
46. <i>Haemophilus ducreyi</i>	1.0	1.0	1.0	1.0	1.0
47. <i>Chlamydia pneumoniae</i>	1.0	1.0	1.0	1.0	1.0
48. <i>Mycoplasma pneumoniae</i>	1.0	1.0	1.0	1.0	1.0
49. <i>Legionella pneumophila</i>	1.0	1.0	1.0	1.0	1.0
50. <i>Yersinia enterocolitica</i>	1.0	1.0	1.0	1.0	1.0
51. <i>Salmonella enteritidis</i>	1.0	1.0	1.0	1.0	1.0
52. <i>Escherichia coli</i>	1.0	1.0	1.0	1.0	1.0
53. <i>Shigella flexneri</i>	1.0	1.0	1.0	1.0	1.0
54. <i>Staphylococcus aureus</i>	1.0	1.0	1.0	1.0	1.0
55. <i>Streptococcus pyogenes</i>	1.0	1.0	1.0	1.0	1.0
56. <i>Neisseria gonorrhoeae</i>	1.0	1.0	1.0		

Code Consultants Professional Engineers PC
215 West 10th Street, 15th Floor, New York, NY 10018

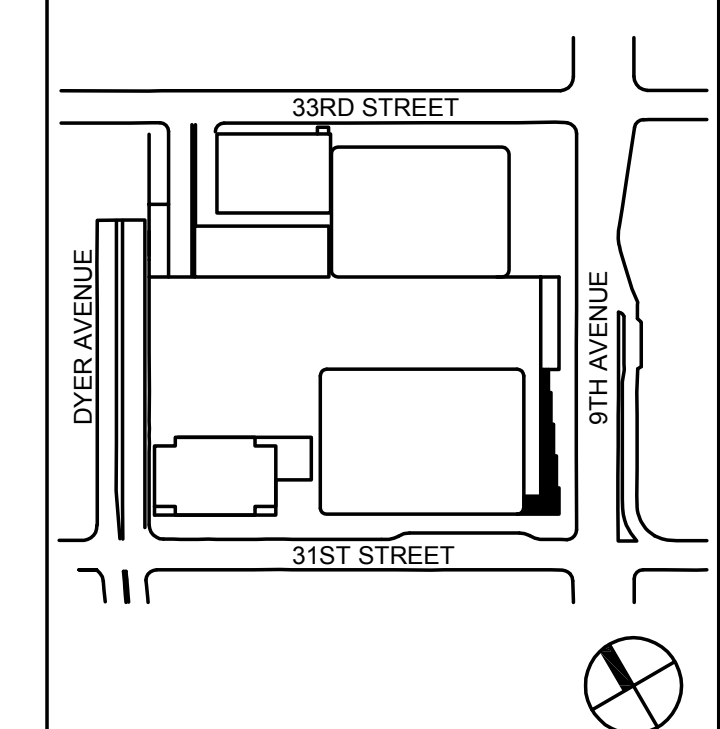
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Entek Engineering LLC


Figure 1 is a line graph showing the percentage of respondents who believe that the use of force is justified in various circumstances. The x-axis represents the percentage of respondents who believe that the use of force is justified, ranging from 0 to 100. The y-axis represents the percentage of respondents who believe that the use of force is justified, ranging from 0 to 100. The graph shows a positive correlation between the two variables, with a regression line and a confidence interval.

Wind Tunnel Consultant
Rowan Williams Davies & Irwin Inc.

Key Plan:



Seal & Signature:

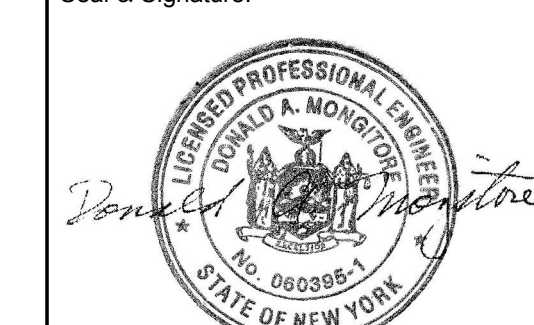

5	20 JUN 2014	ISSUED FOR FOUNDATION PERMIT
4	20 DEC 2013	ISSUED FOR FOUNDATION PERMIT
3	15 NOV 2013	ISSUED FOR DD PROGRESS PRICING
2	12 JUL 2013	ISSUED FOR 50% DESIGN DEVELOPMENT
1	15 MAR 2013	ISSUED FOR RECONCILIATION
No.	Date	Description

Sheet Name:

MECHANICAL
CELLAR B
FLOOR PLAN -
PART B

Project No. :

14830.A.000

Date: 30 JUN 2014


Scale:

SCAN Sheet No. :

14 000 00

M-098

Sheet No.:

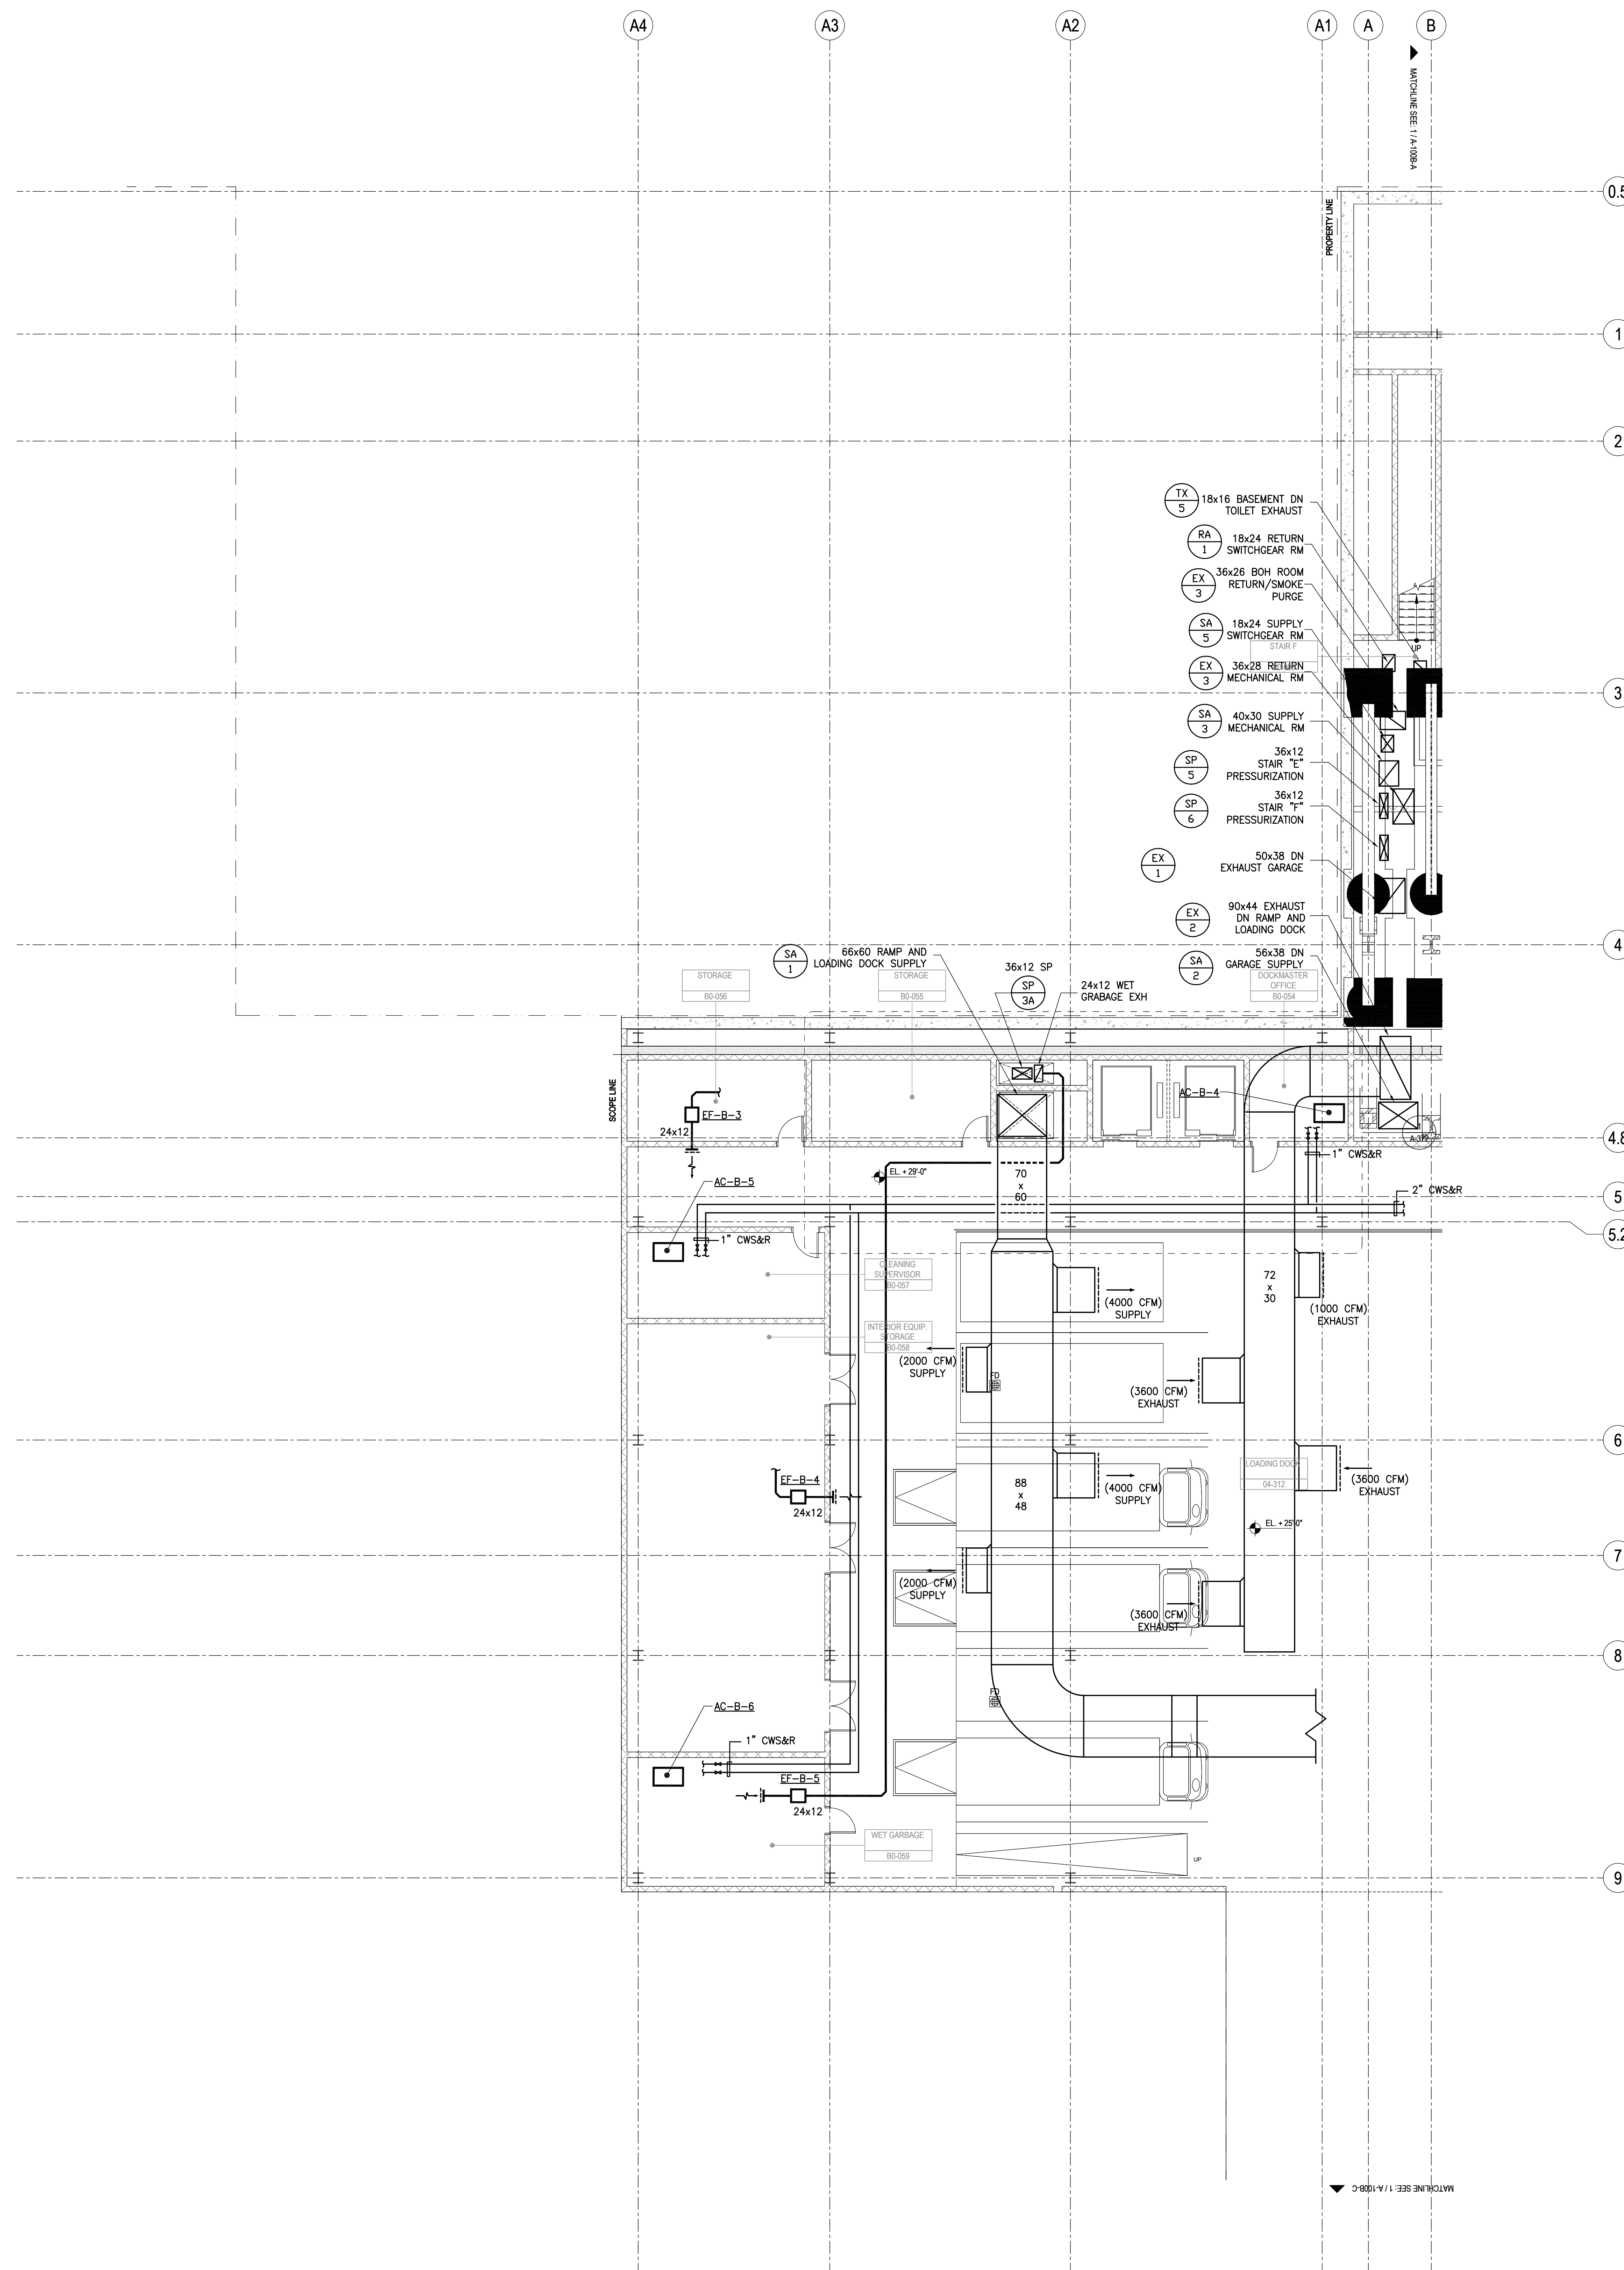



**MANHATTAN WEST:
NORTH TOWER**
375 Ninth Avenue, New York, NY 10001

Client
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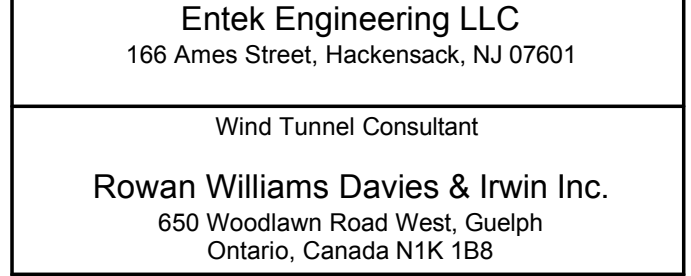
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Key Plan:



Seal & Signature:



Project No:
14830-A.000

Date:
20 JUN 2014

Scale:
1/8"=1'-0"

File No.:

B-SCAN Sheet No.:

M-100.00

Sheet No.:

M-100

Page No.:

MECHANICAL
GROUND
FLOOR PLAN -
PART A

Project No:
14830-A.000

Date:
20 JUN 2014

Scale:
1/8"=1'-0"

File No.:


B-SCAN Sheet No.:

M-100.00

Sheet No.:

M-100

Page No.:

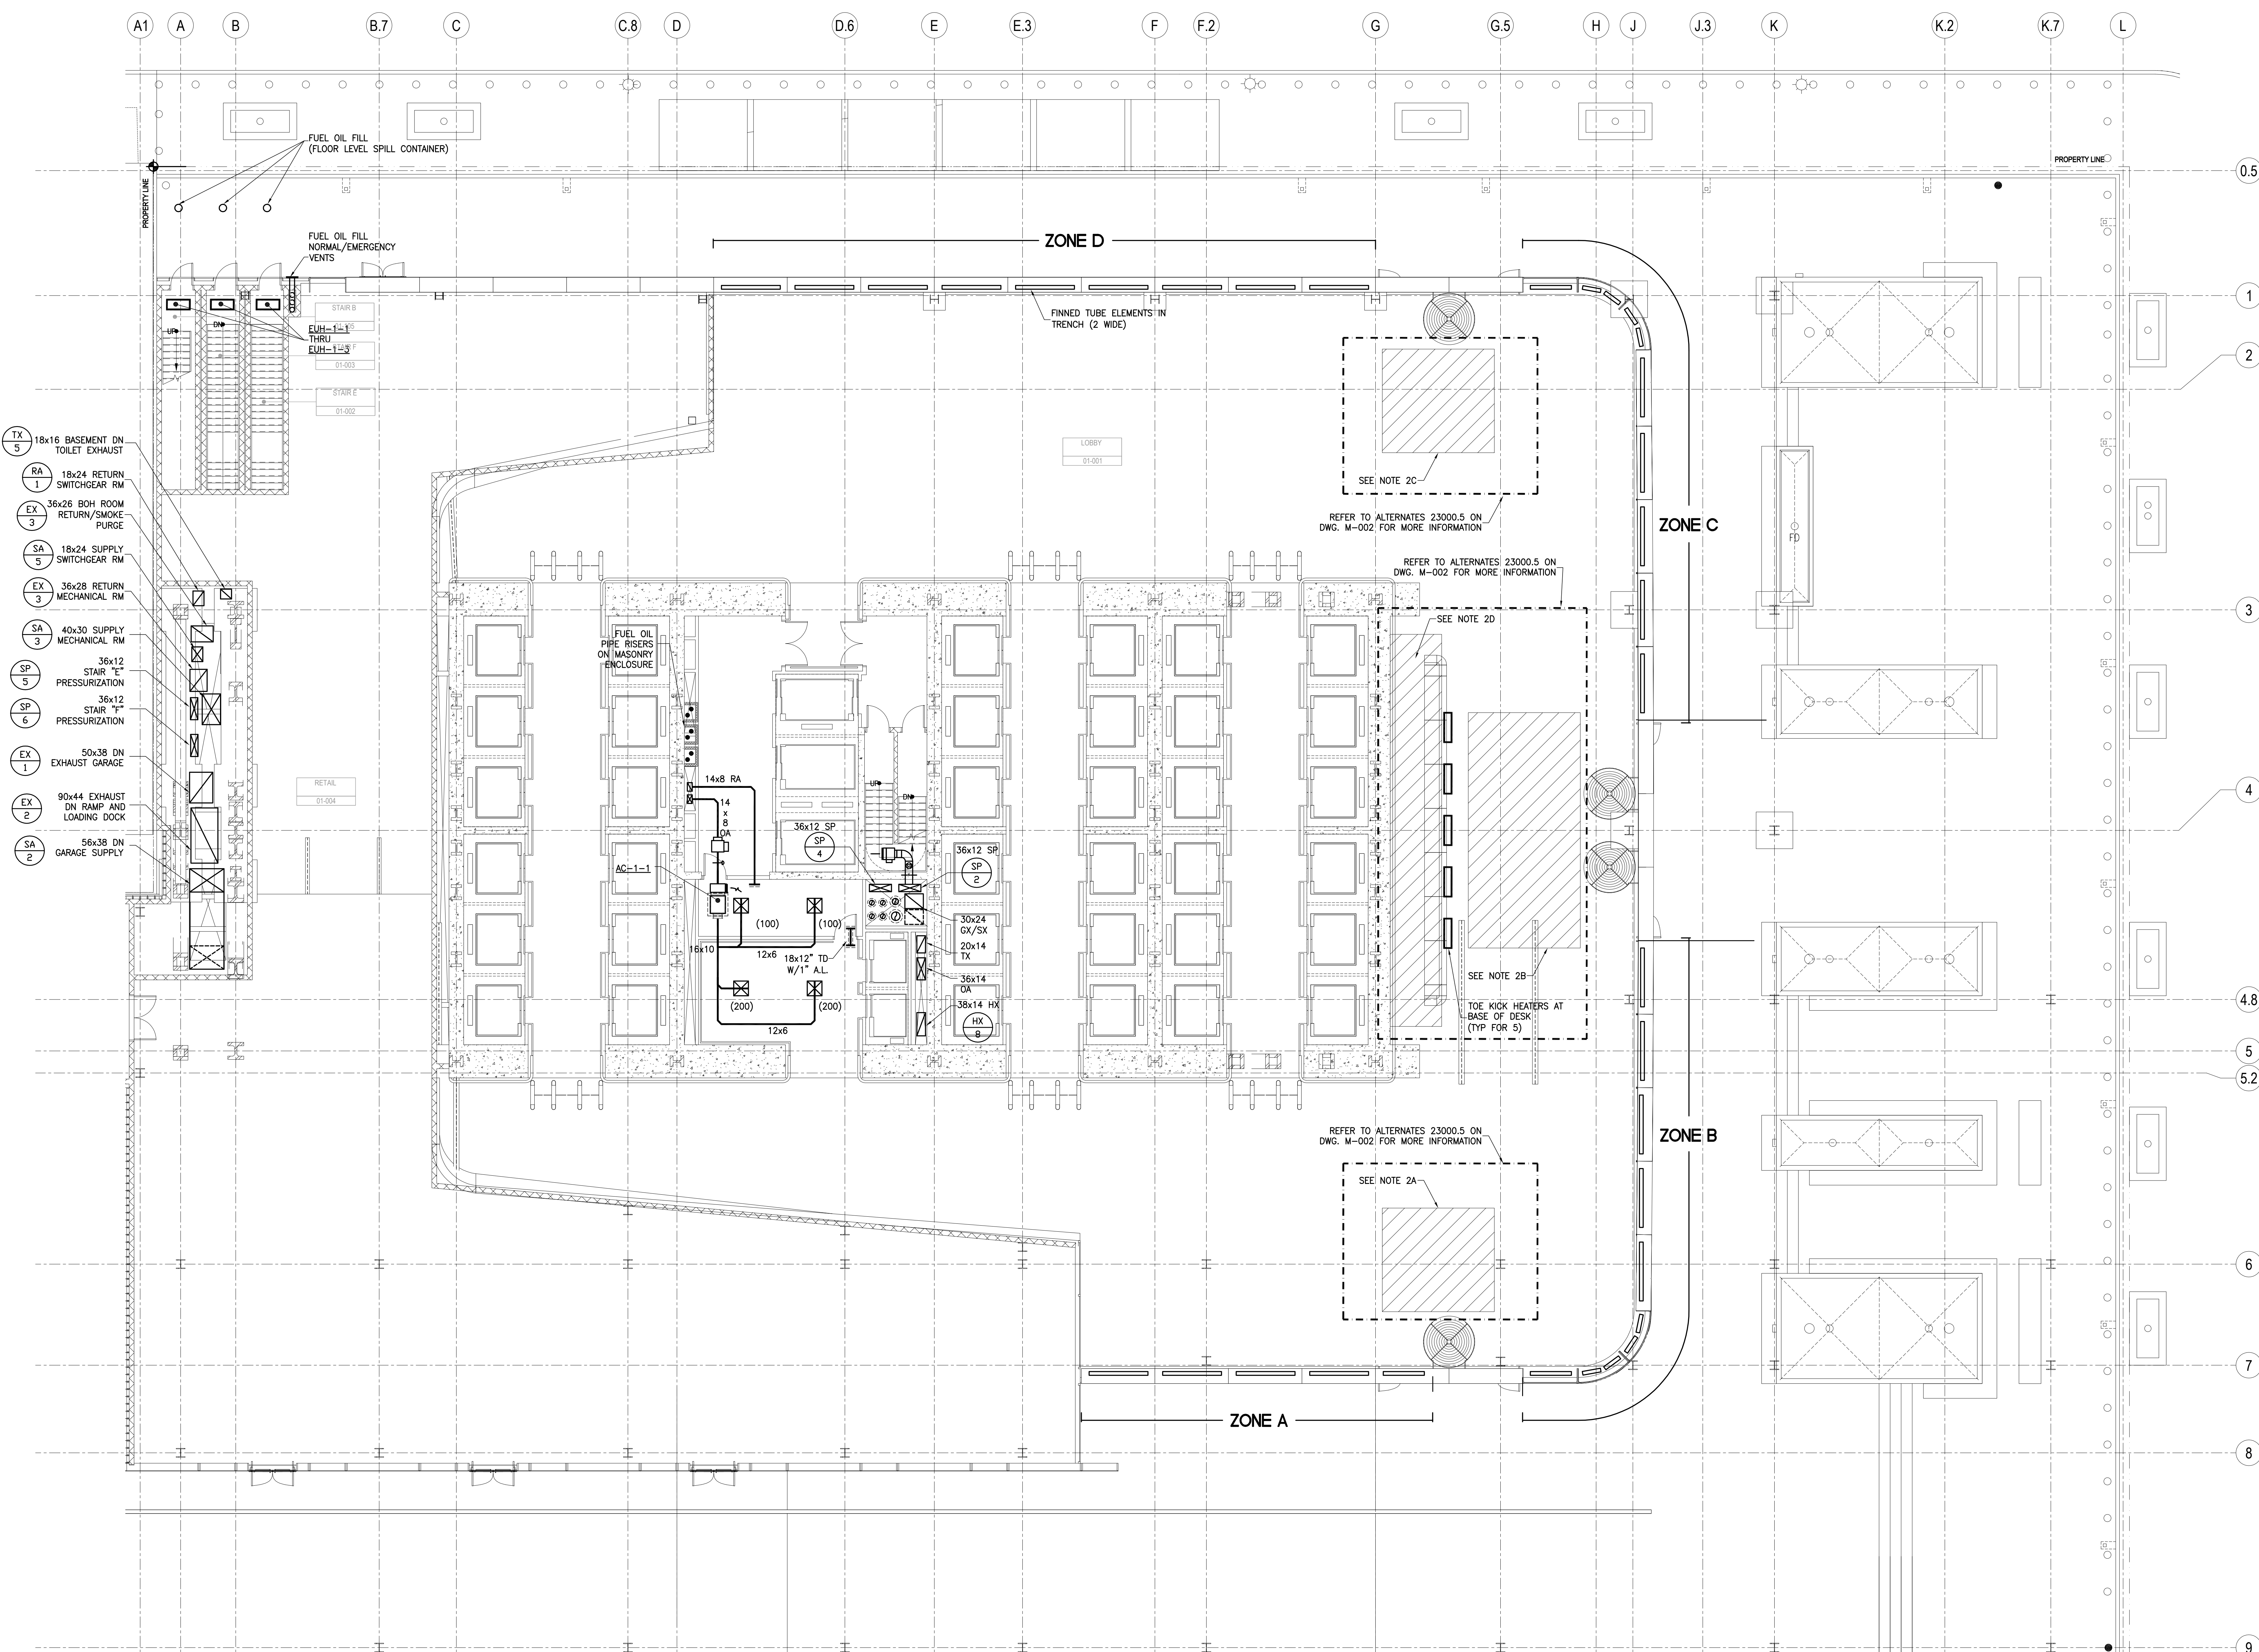

- TX 5 18x16 BASEMENT DN TOILET EXHAUST
- RA 1 18x24 RETURN SWITCHGEAR RM
- EX 3 36x26 BOH ROOM RETURN/SMOKE PURGE
- SA 5 18x24 SUPPLY SWITCHGEAR RM
- EX 3 36x28 RETURN MECHANICAL RM
- SA 3 40x30 SUPPLY MECHANICAL RM
- SP 5 36x12 STAIR "E" PRESSURIZATION
- SP 6 36x12 STAIR "F" PRESSURIZATION
- EX 1 50x38 DN EXHAUST GARAGE
- EX 2 90x44 EXHAUST DN RAMP AND LOADING DOCK
- SA 2 56x38 DN GARAGE SUPPLY

NOTES:

1. LOBBY HEATING AT PERIMETER WILL CONSIST OF HOT WATER FINNED TUBE ELEMENTS IN PERIMETER TRENCH PROVIDE 2-WIDE FINNED TUBE ELEMENTS. IN SOFFIT PROVIDE SINGLE ROW FINNED TUBE ELEMENTS. REFER TO LOBBY HOT WATER FLOW DIAGRAM FOR PIPING AND ZONING REQUIREMENTS.

2. FLOOR AREA IN FRONT OF ENTRY DOOR TO BE PROVIDED WITH ELECTRICAL RADIANT FLOOR HEATING. (REFER TO ELECTRICAL DRAWINGS).

A. RADIANT FLOOR AREA APPROXIMATELY 15'x15'

B. RADIANT FLOOR AREA APPROXIMATELY 30'x15'

C. RADIANT FLOOR AREA APPROXIMATELY 15'x15'

D. RADIANT FLOOR AREA APPROXIMATELY 54'x7'



MANHATTAN WEST:
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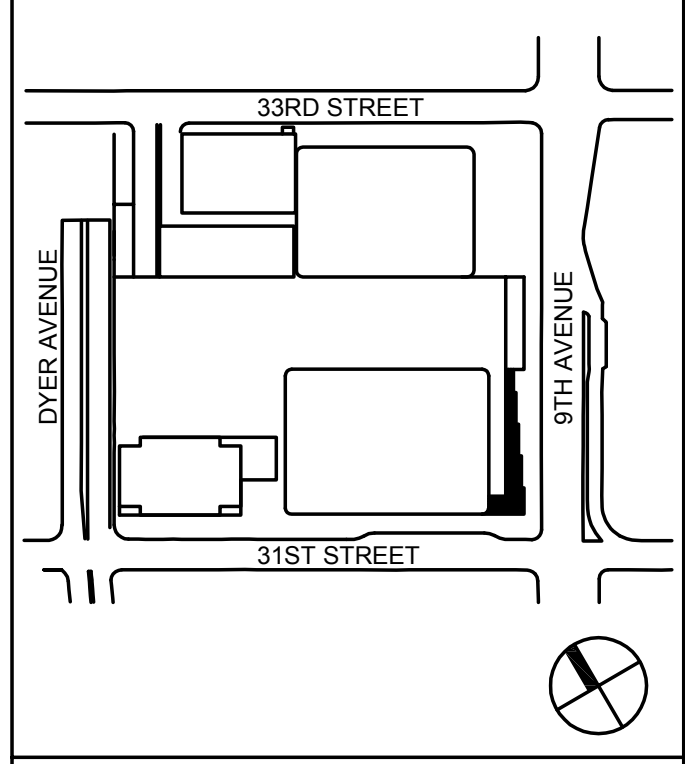
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No.	Date	Description

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MECHANICAL
GROUND
FLOOR PLAN -
PART B

Project No.: 14830.A.000	B-SCAN Sheet No.: M-101.00
Date: 20 JUN 2014	Sheet No.: M-101
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Key Plan:

33RD STREET
31ST STREET
DIXIE AVENUE
5TH AVENUE

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State of New York
14830.A.000
20 JUN 2014
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MECHANICAL
LEVEL 5
FLOOR PLAN -
MECHANICAL
MEZZANINE

Project No:
14830.A.000

Date:
20 JUN 2014


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M-105

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MECHANICAL LOUVER REQUIREMENTS

ZONES	FREE AREA REQUIRED	UNITS
ZONE A	600	SQFT
ZONE B	838	SQFT
ZONE C	500	SQFT
ZONE D	574	SQFT
ZONE E	668	SQFT
ZONE F	813	SQFT

FREE AREA SQUARE FOOTAGE ARE BASED ON 45% MINIMUM FREE AREA.
LOUVERS TO BE STORM CLASS, AMCA-CERTIFIED, LAB TESTED AND RATED IN ACCORDANCE WITH AMCA 500-L, (LABORATORY METHODS OF TESTING LOUVERS FOR RATING, LATEST EDITION) AND AMCA 511 (CERTIFIED RATINGS PROGRAM - PRODUCT RATING MANUAL FOR AIR CONTROL DEVICES, LATEST EDITION)
STORM CLASS LOUVERS SHALL HAVE AN AMCA CERTIFIED CLASS 'A' RATING FOR WIND-DRIVEN RAIN AT 29MPH, AND 3.0" RAINFALL PER HOUR; AND SHALL HAVE NOT LESS THAN AN AMCA CERTIFIED CLASS 'B' RATING FOR WIND-DRIVEN RAIN AT 50MPH, AND 6.0" RAINFALL PER HOUR.

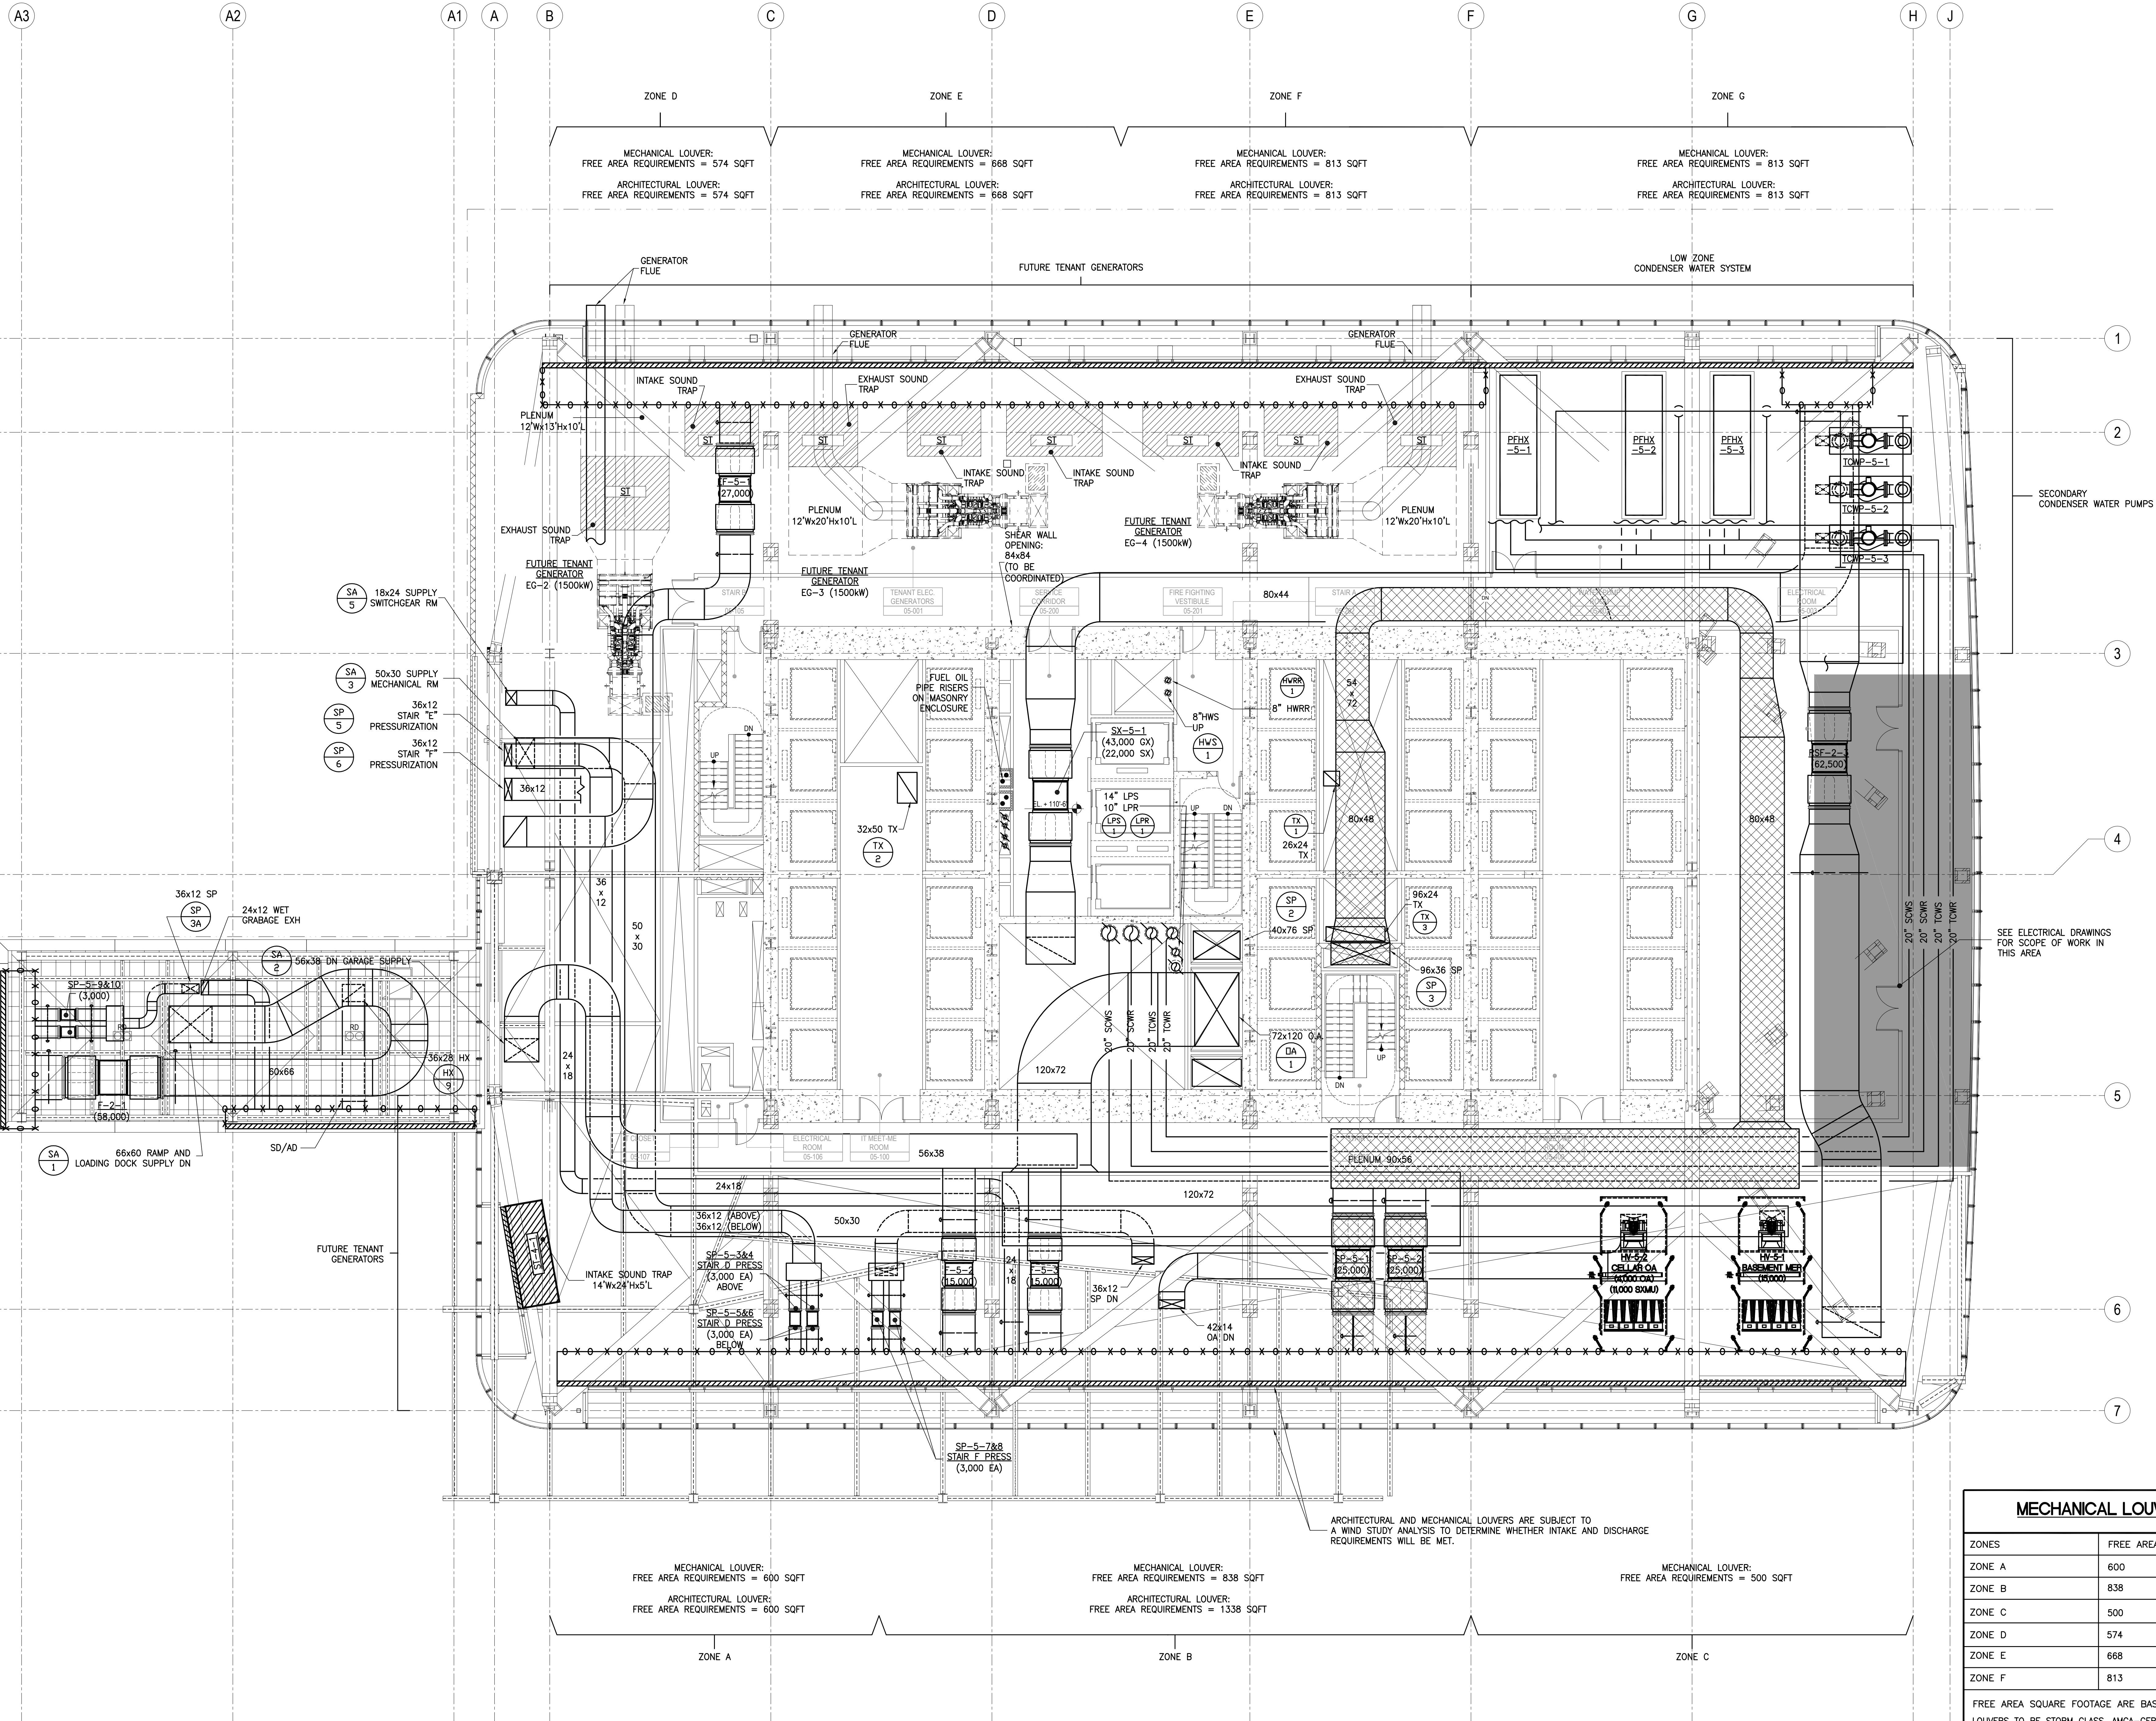

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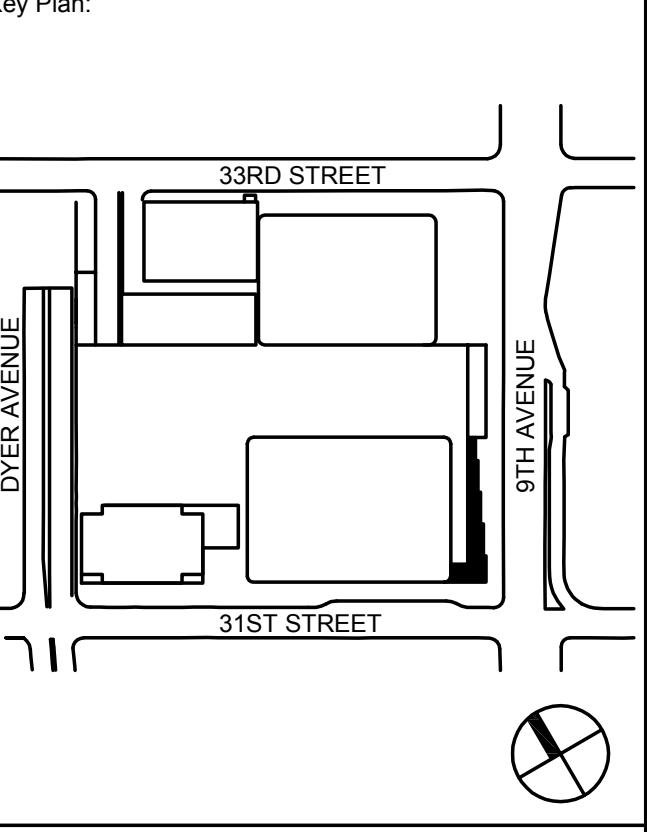
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5	13 MAR 2013	ISSUED FOR RECONSTRUCTION

Sheet Name:

**MECHANICAL
LEVEL 6-16
FLOOR
PLAN - TYPICAL
LOW-RISE**

Project No:
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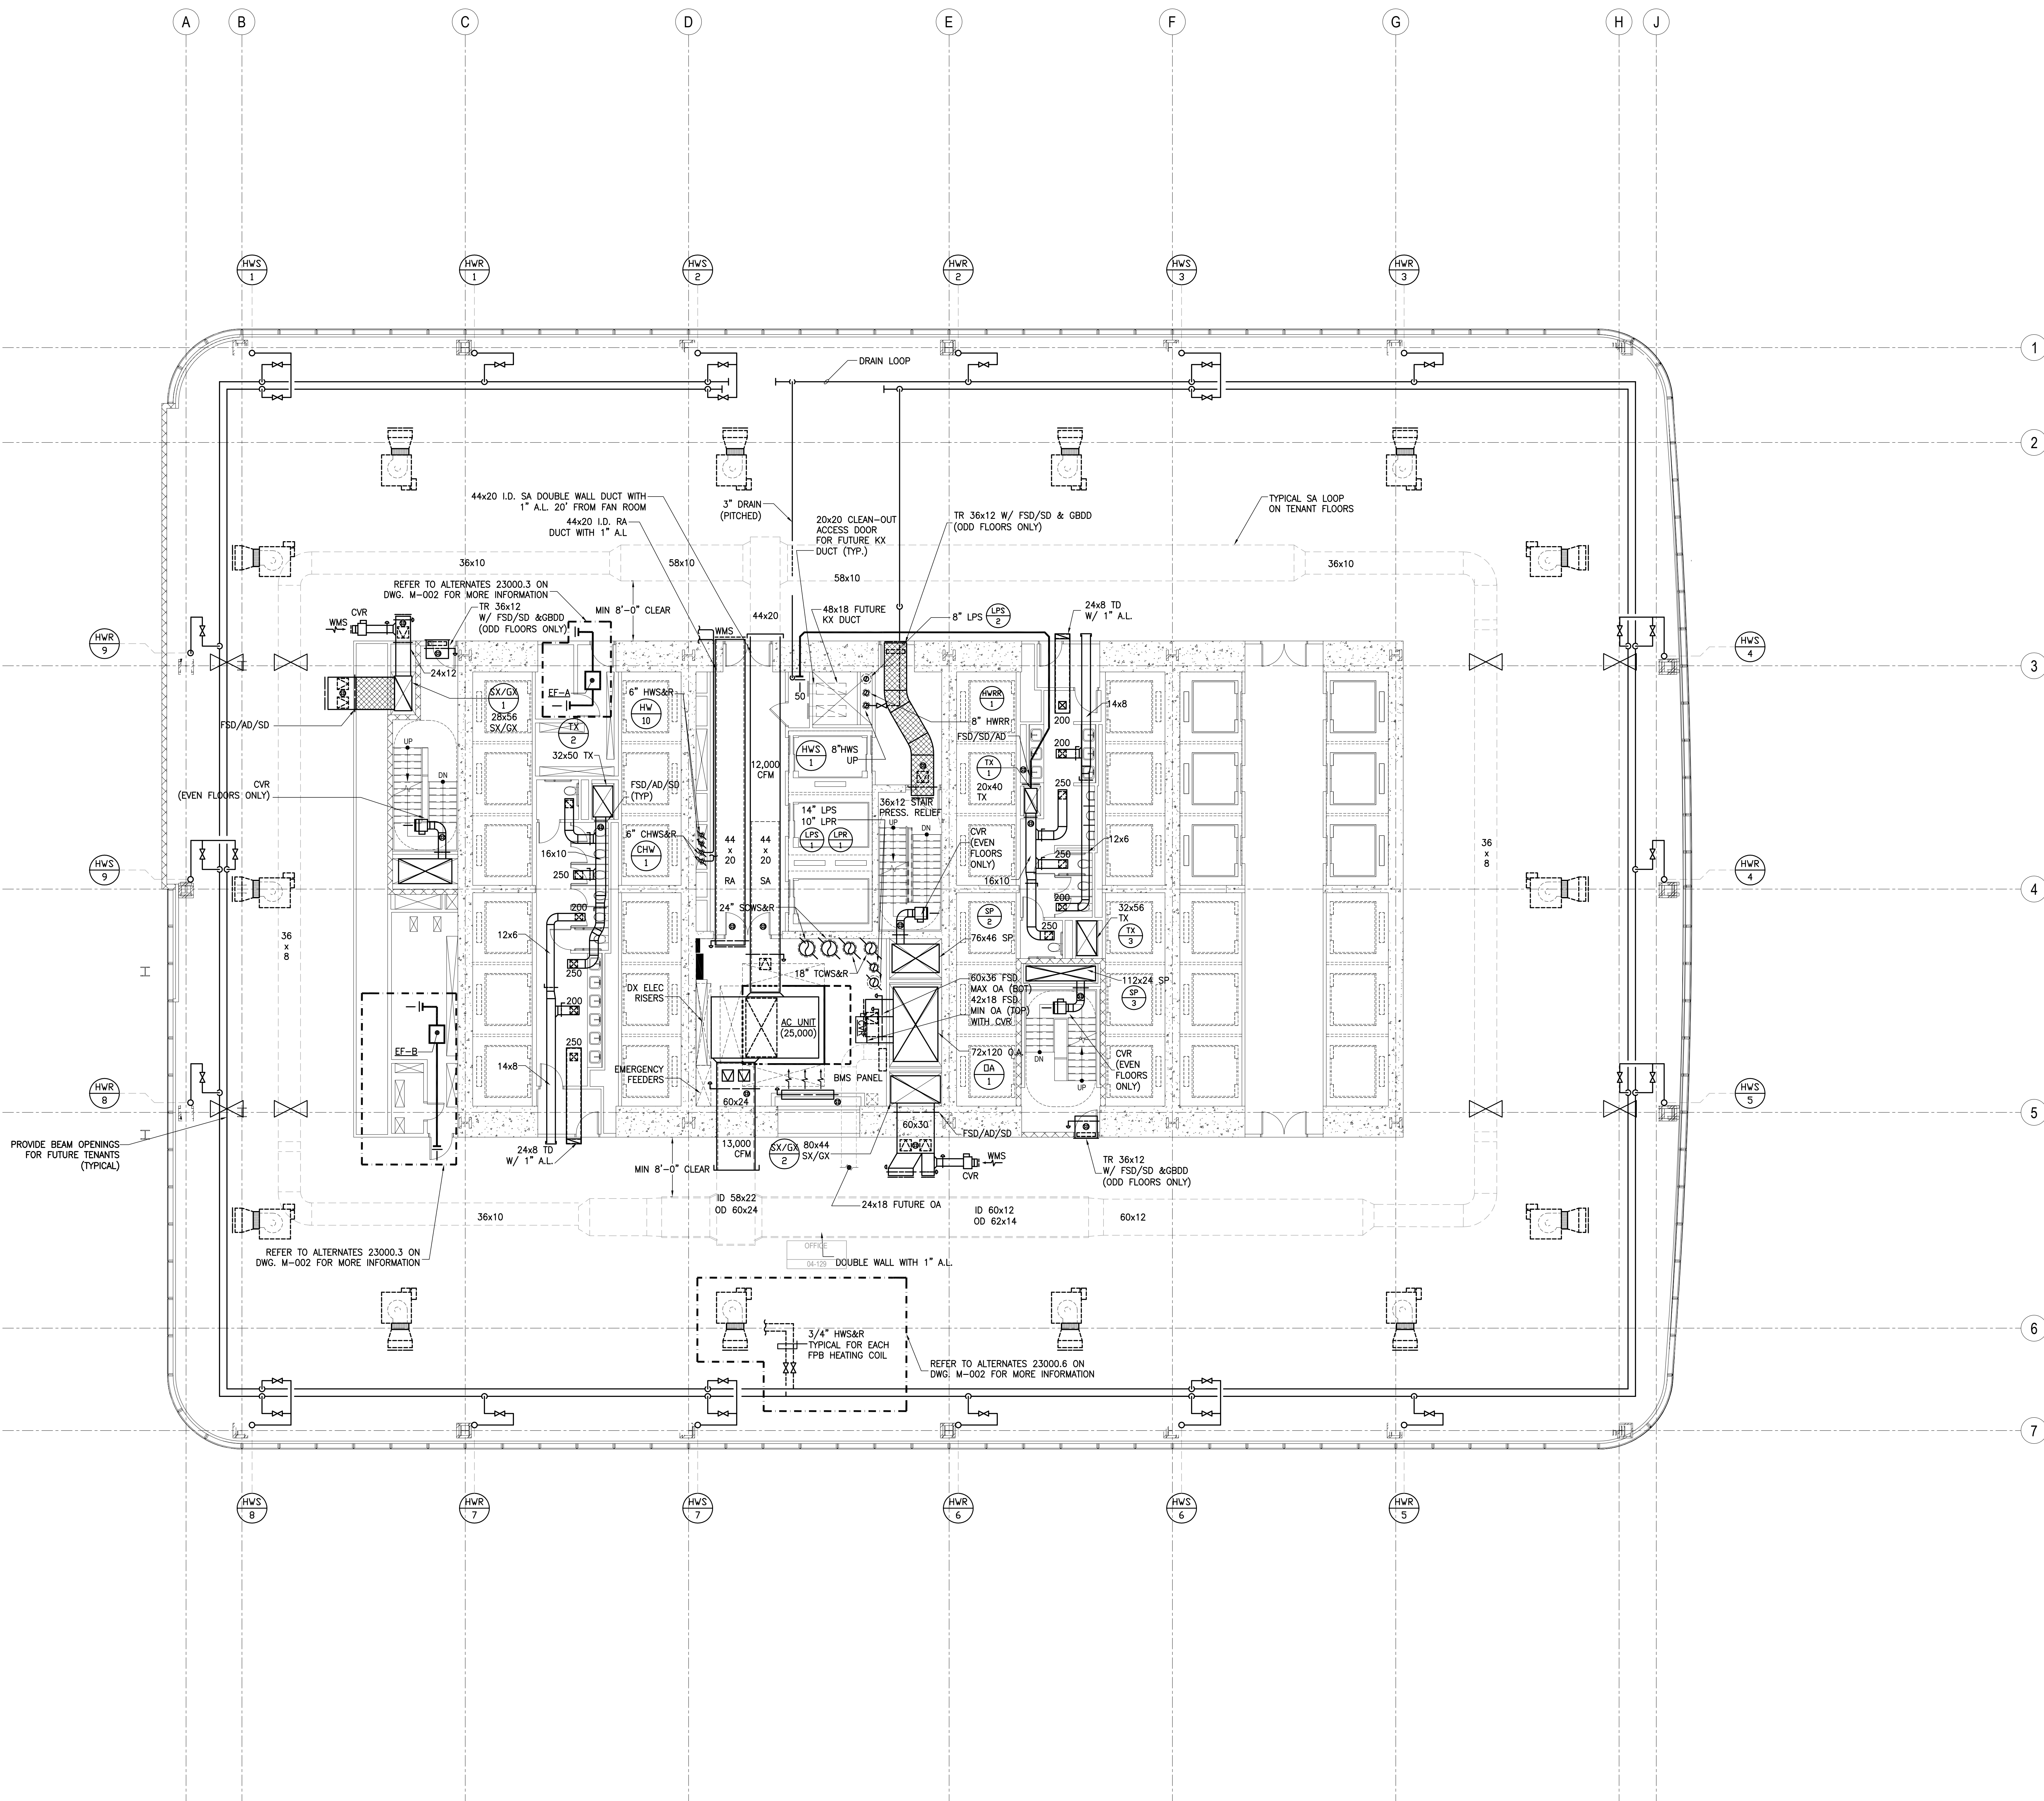
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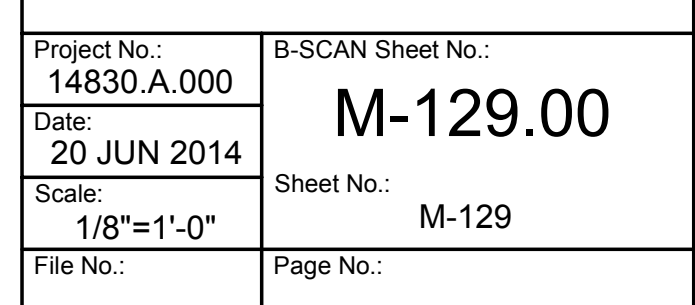
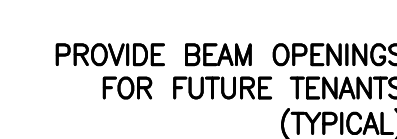
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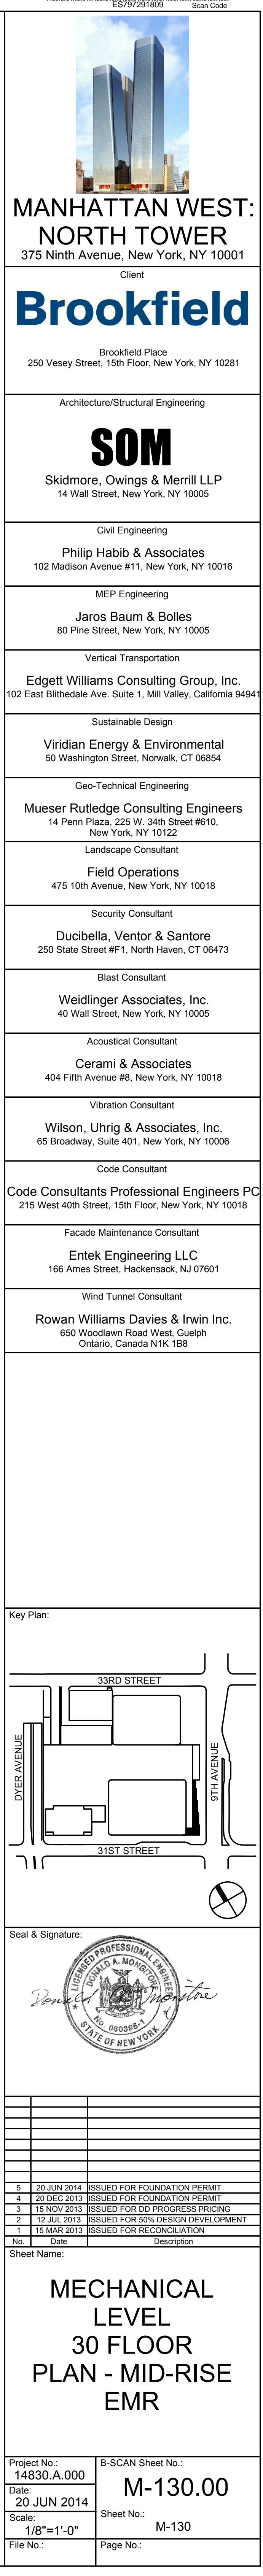
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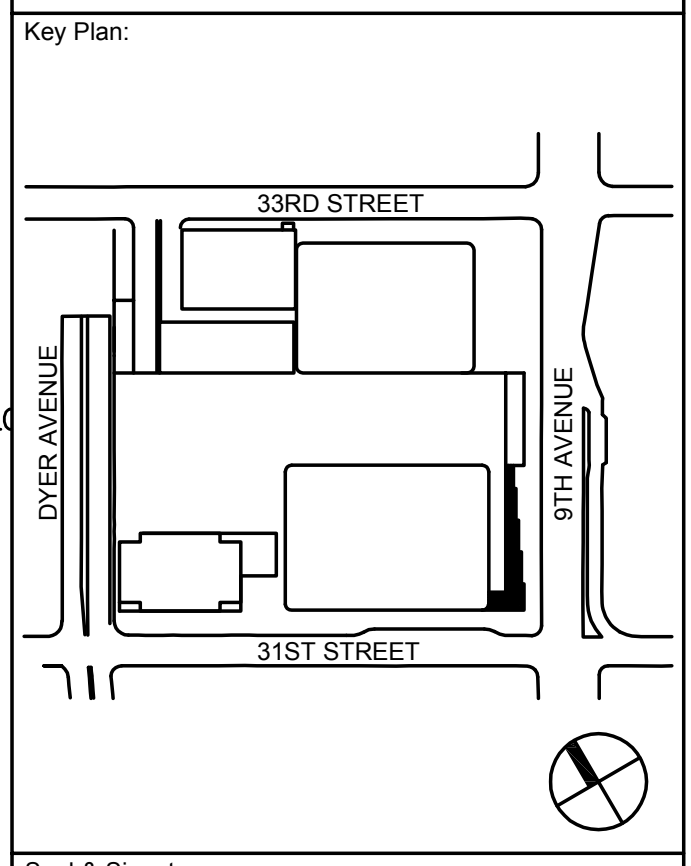
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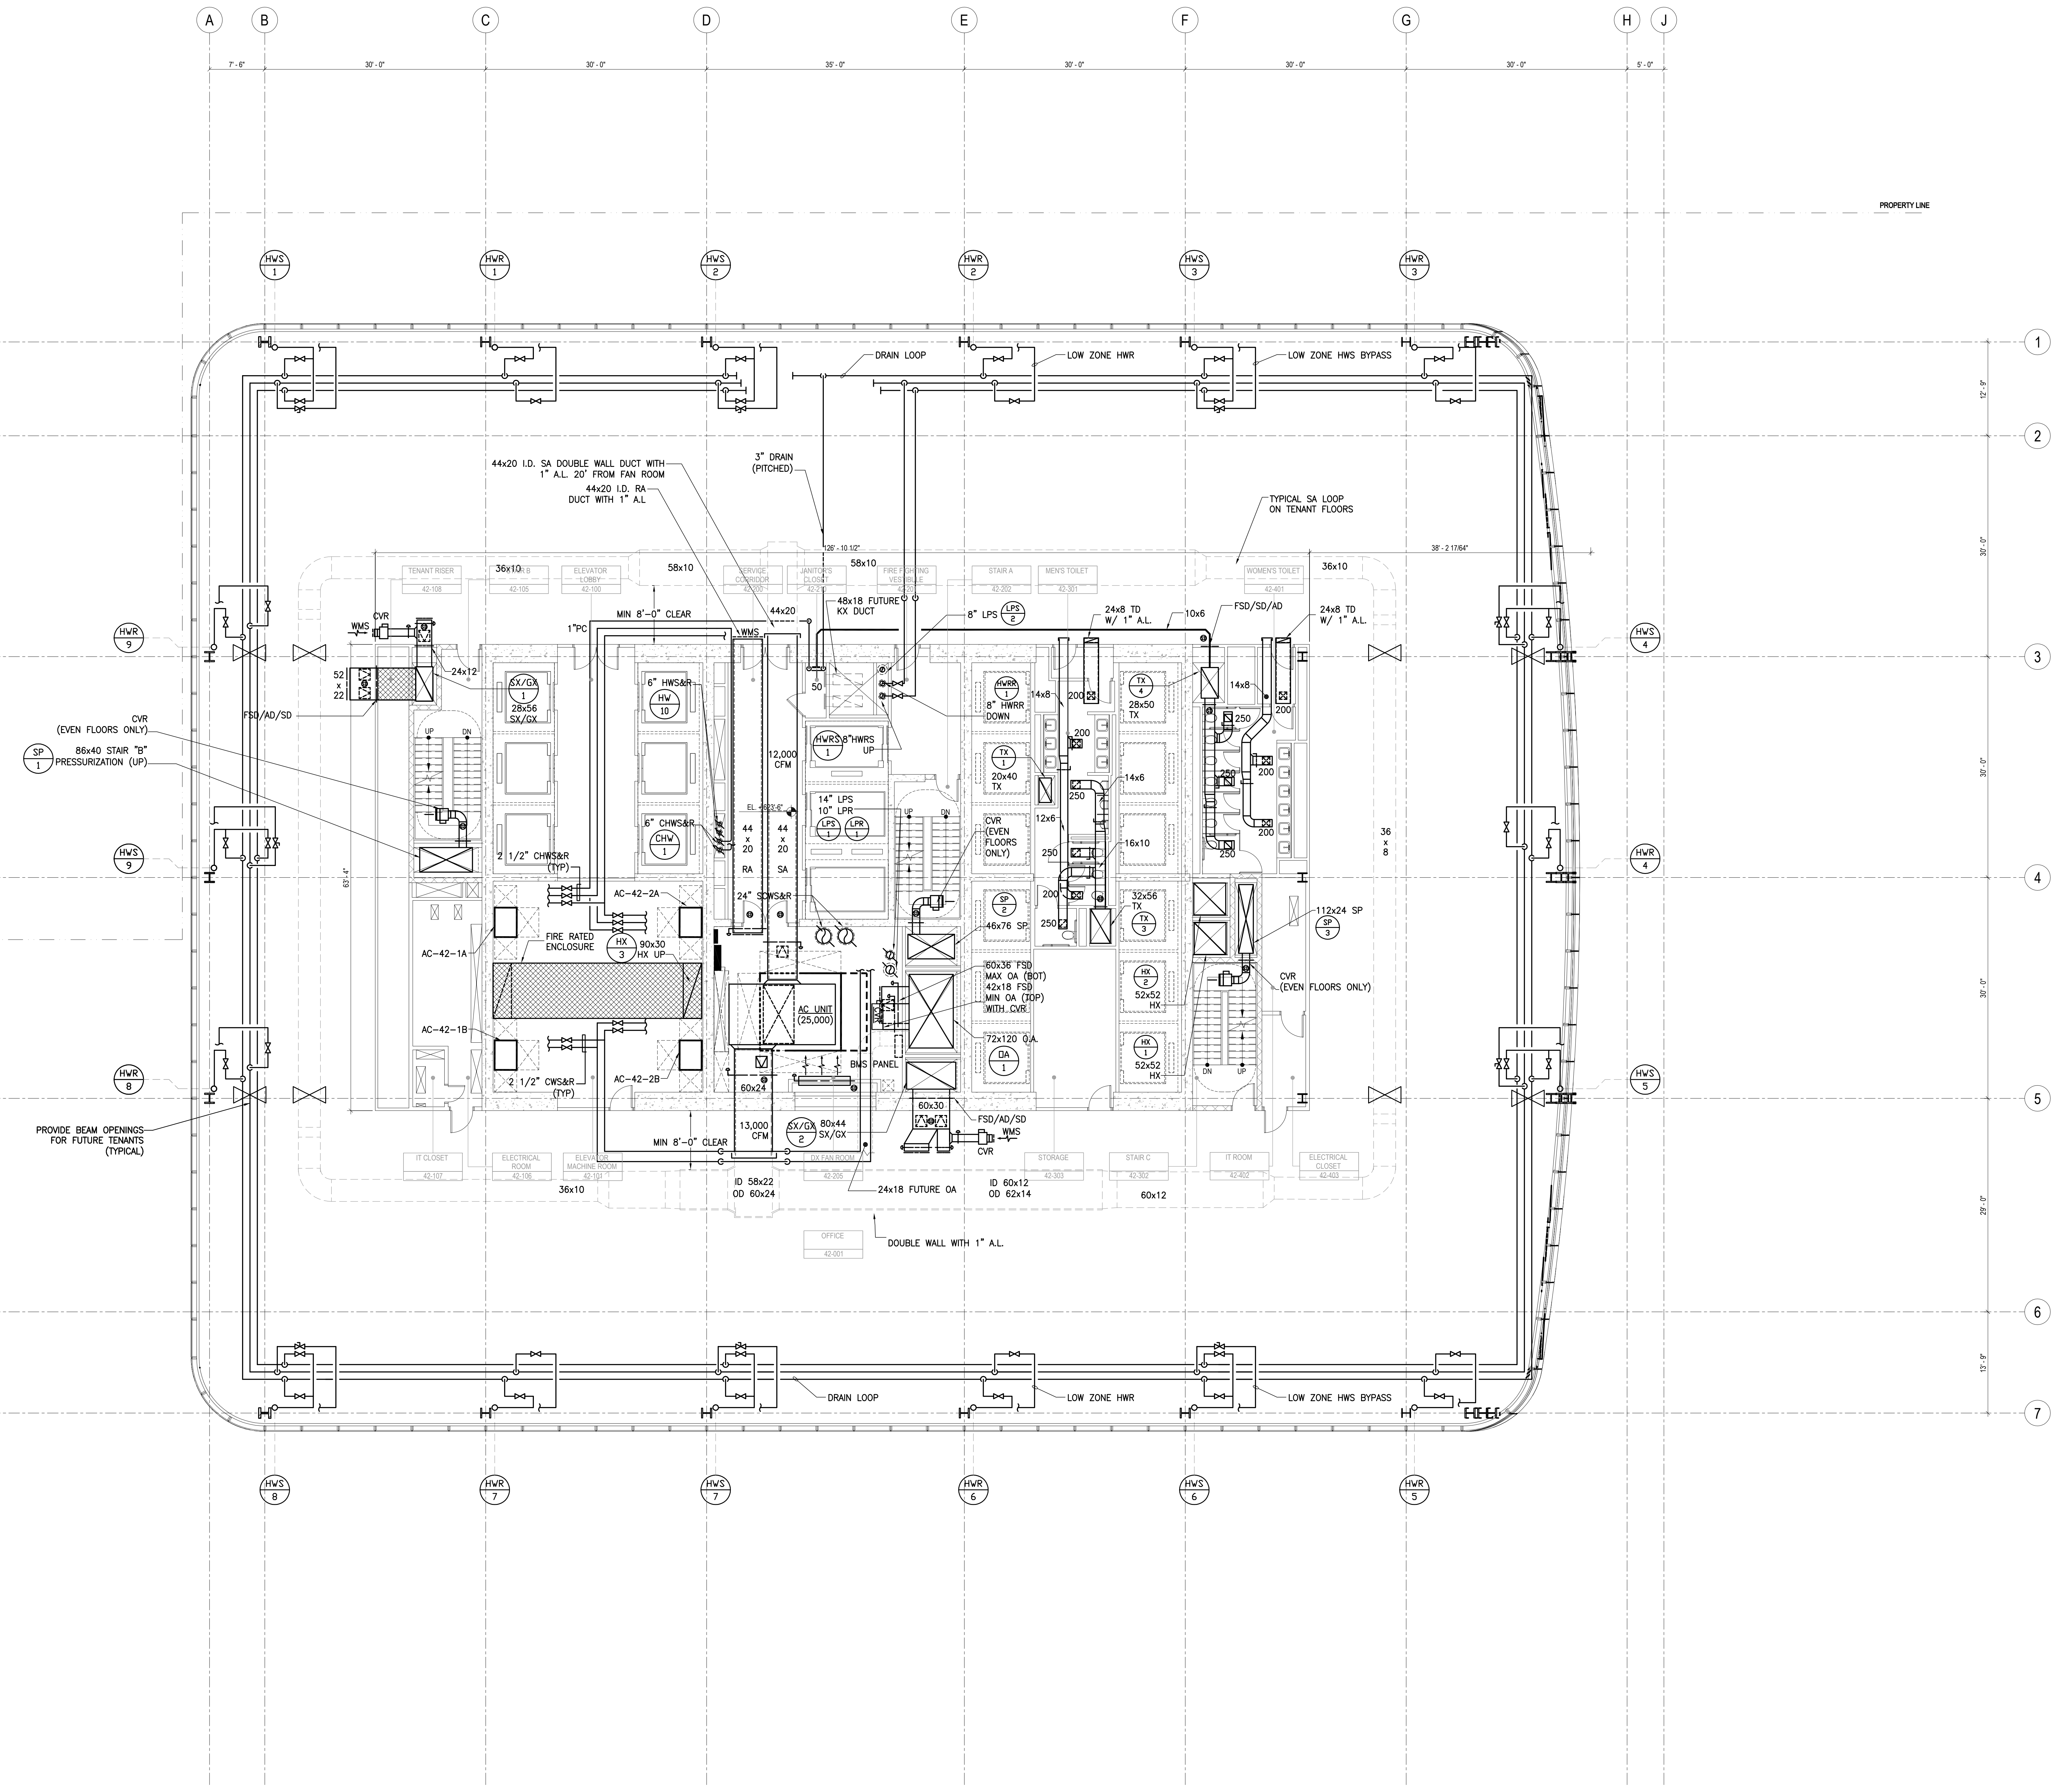


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**MECHANICAL
LEVEL
42 FLOOR
PLAN - MID-RISE
EMR**

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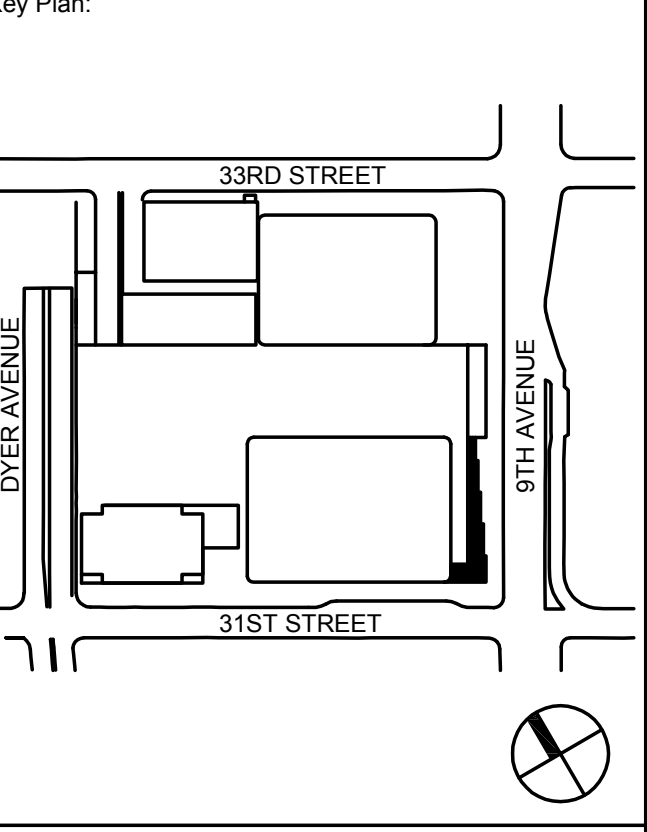
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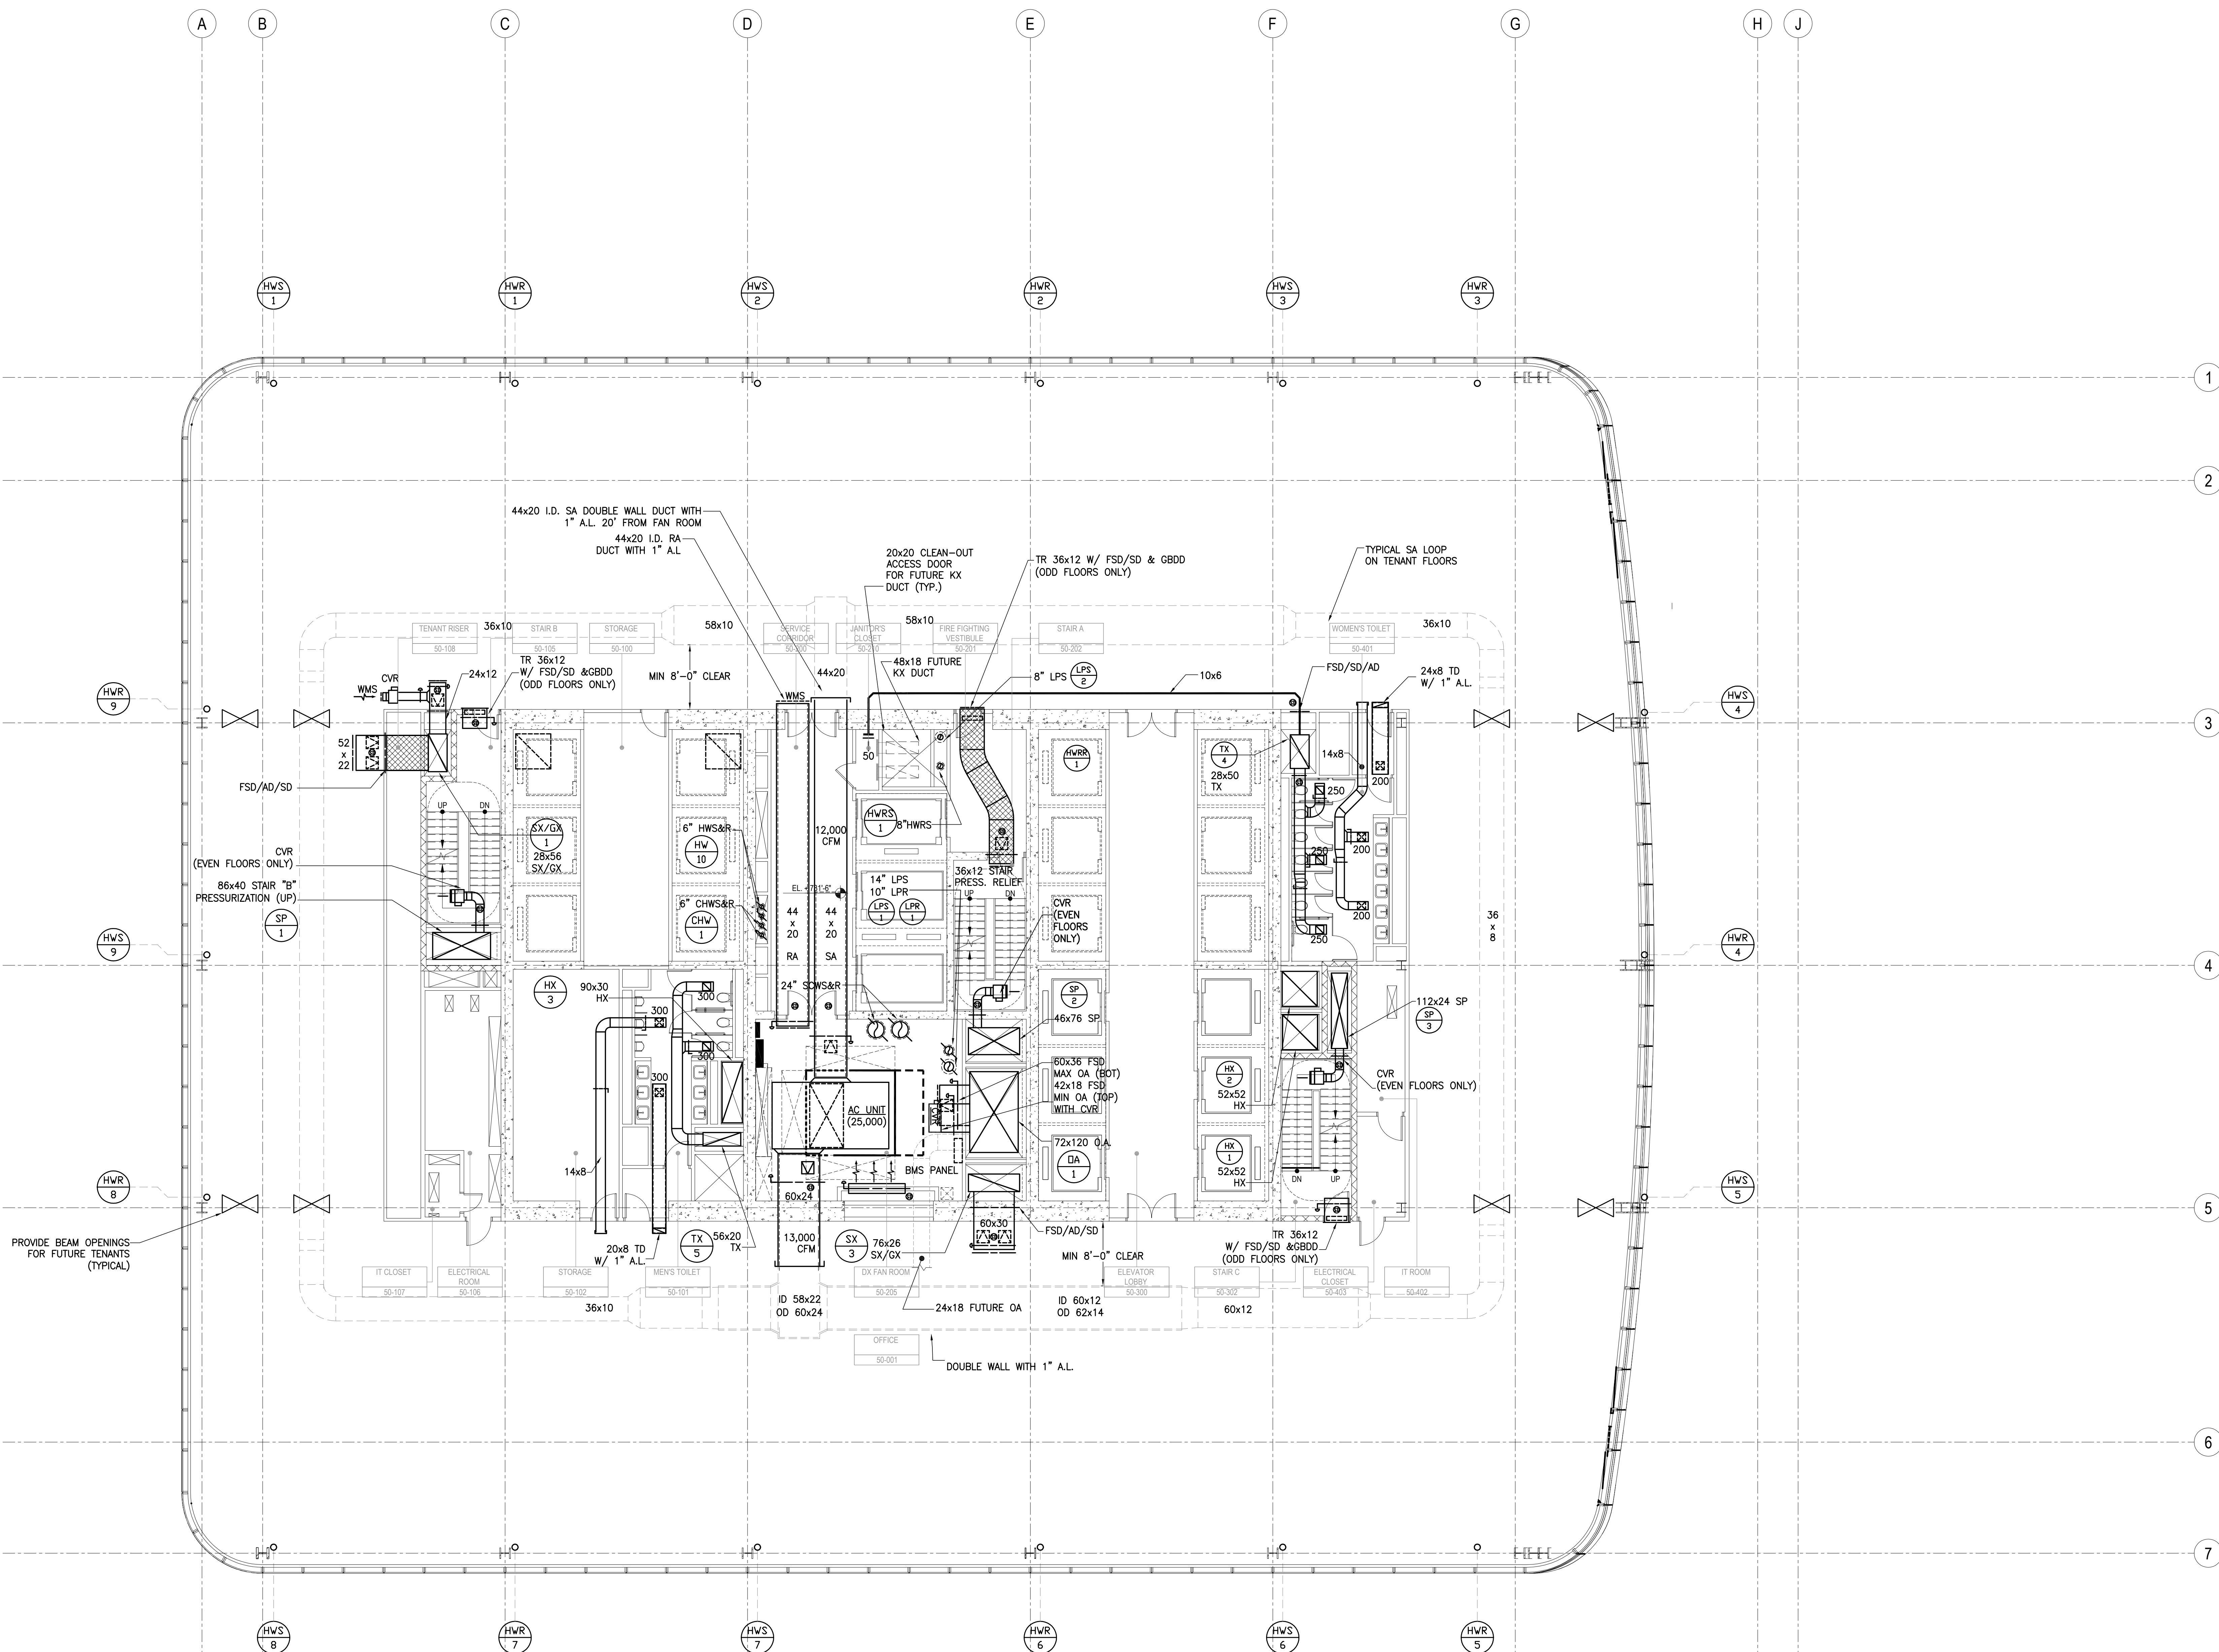



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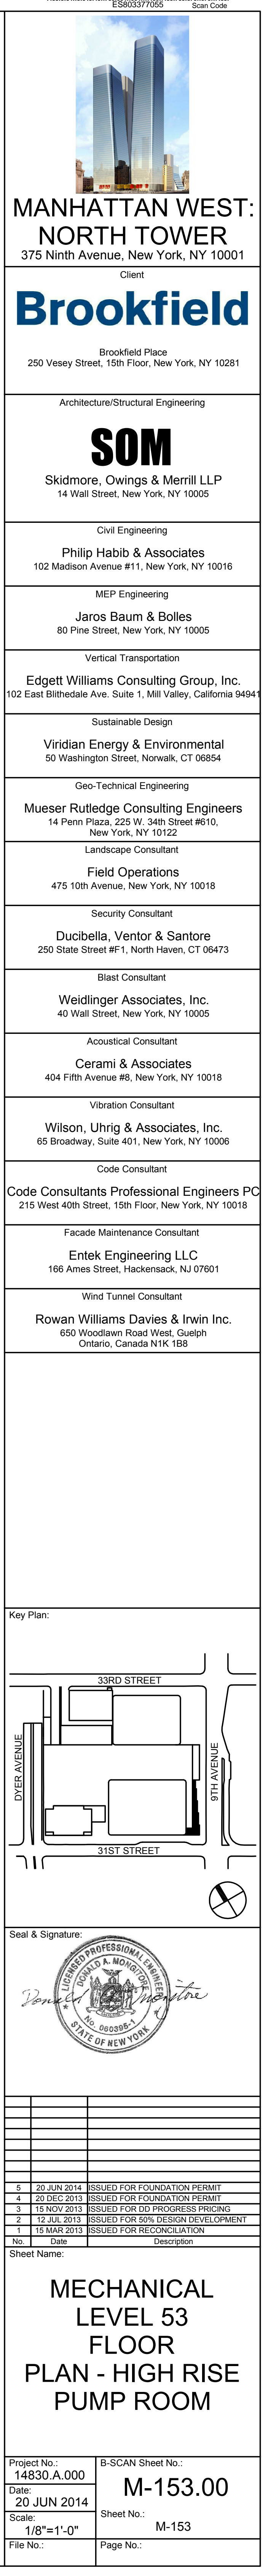
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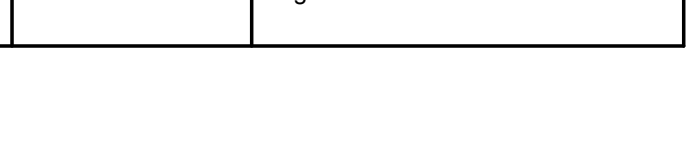
**MECHANICAL
LEVEL
50-51 FLOOR
PLAN - HIGH-RISE
OVERRUN**


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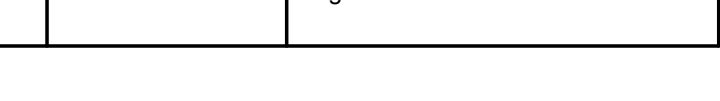


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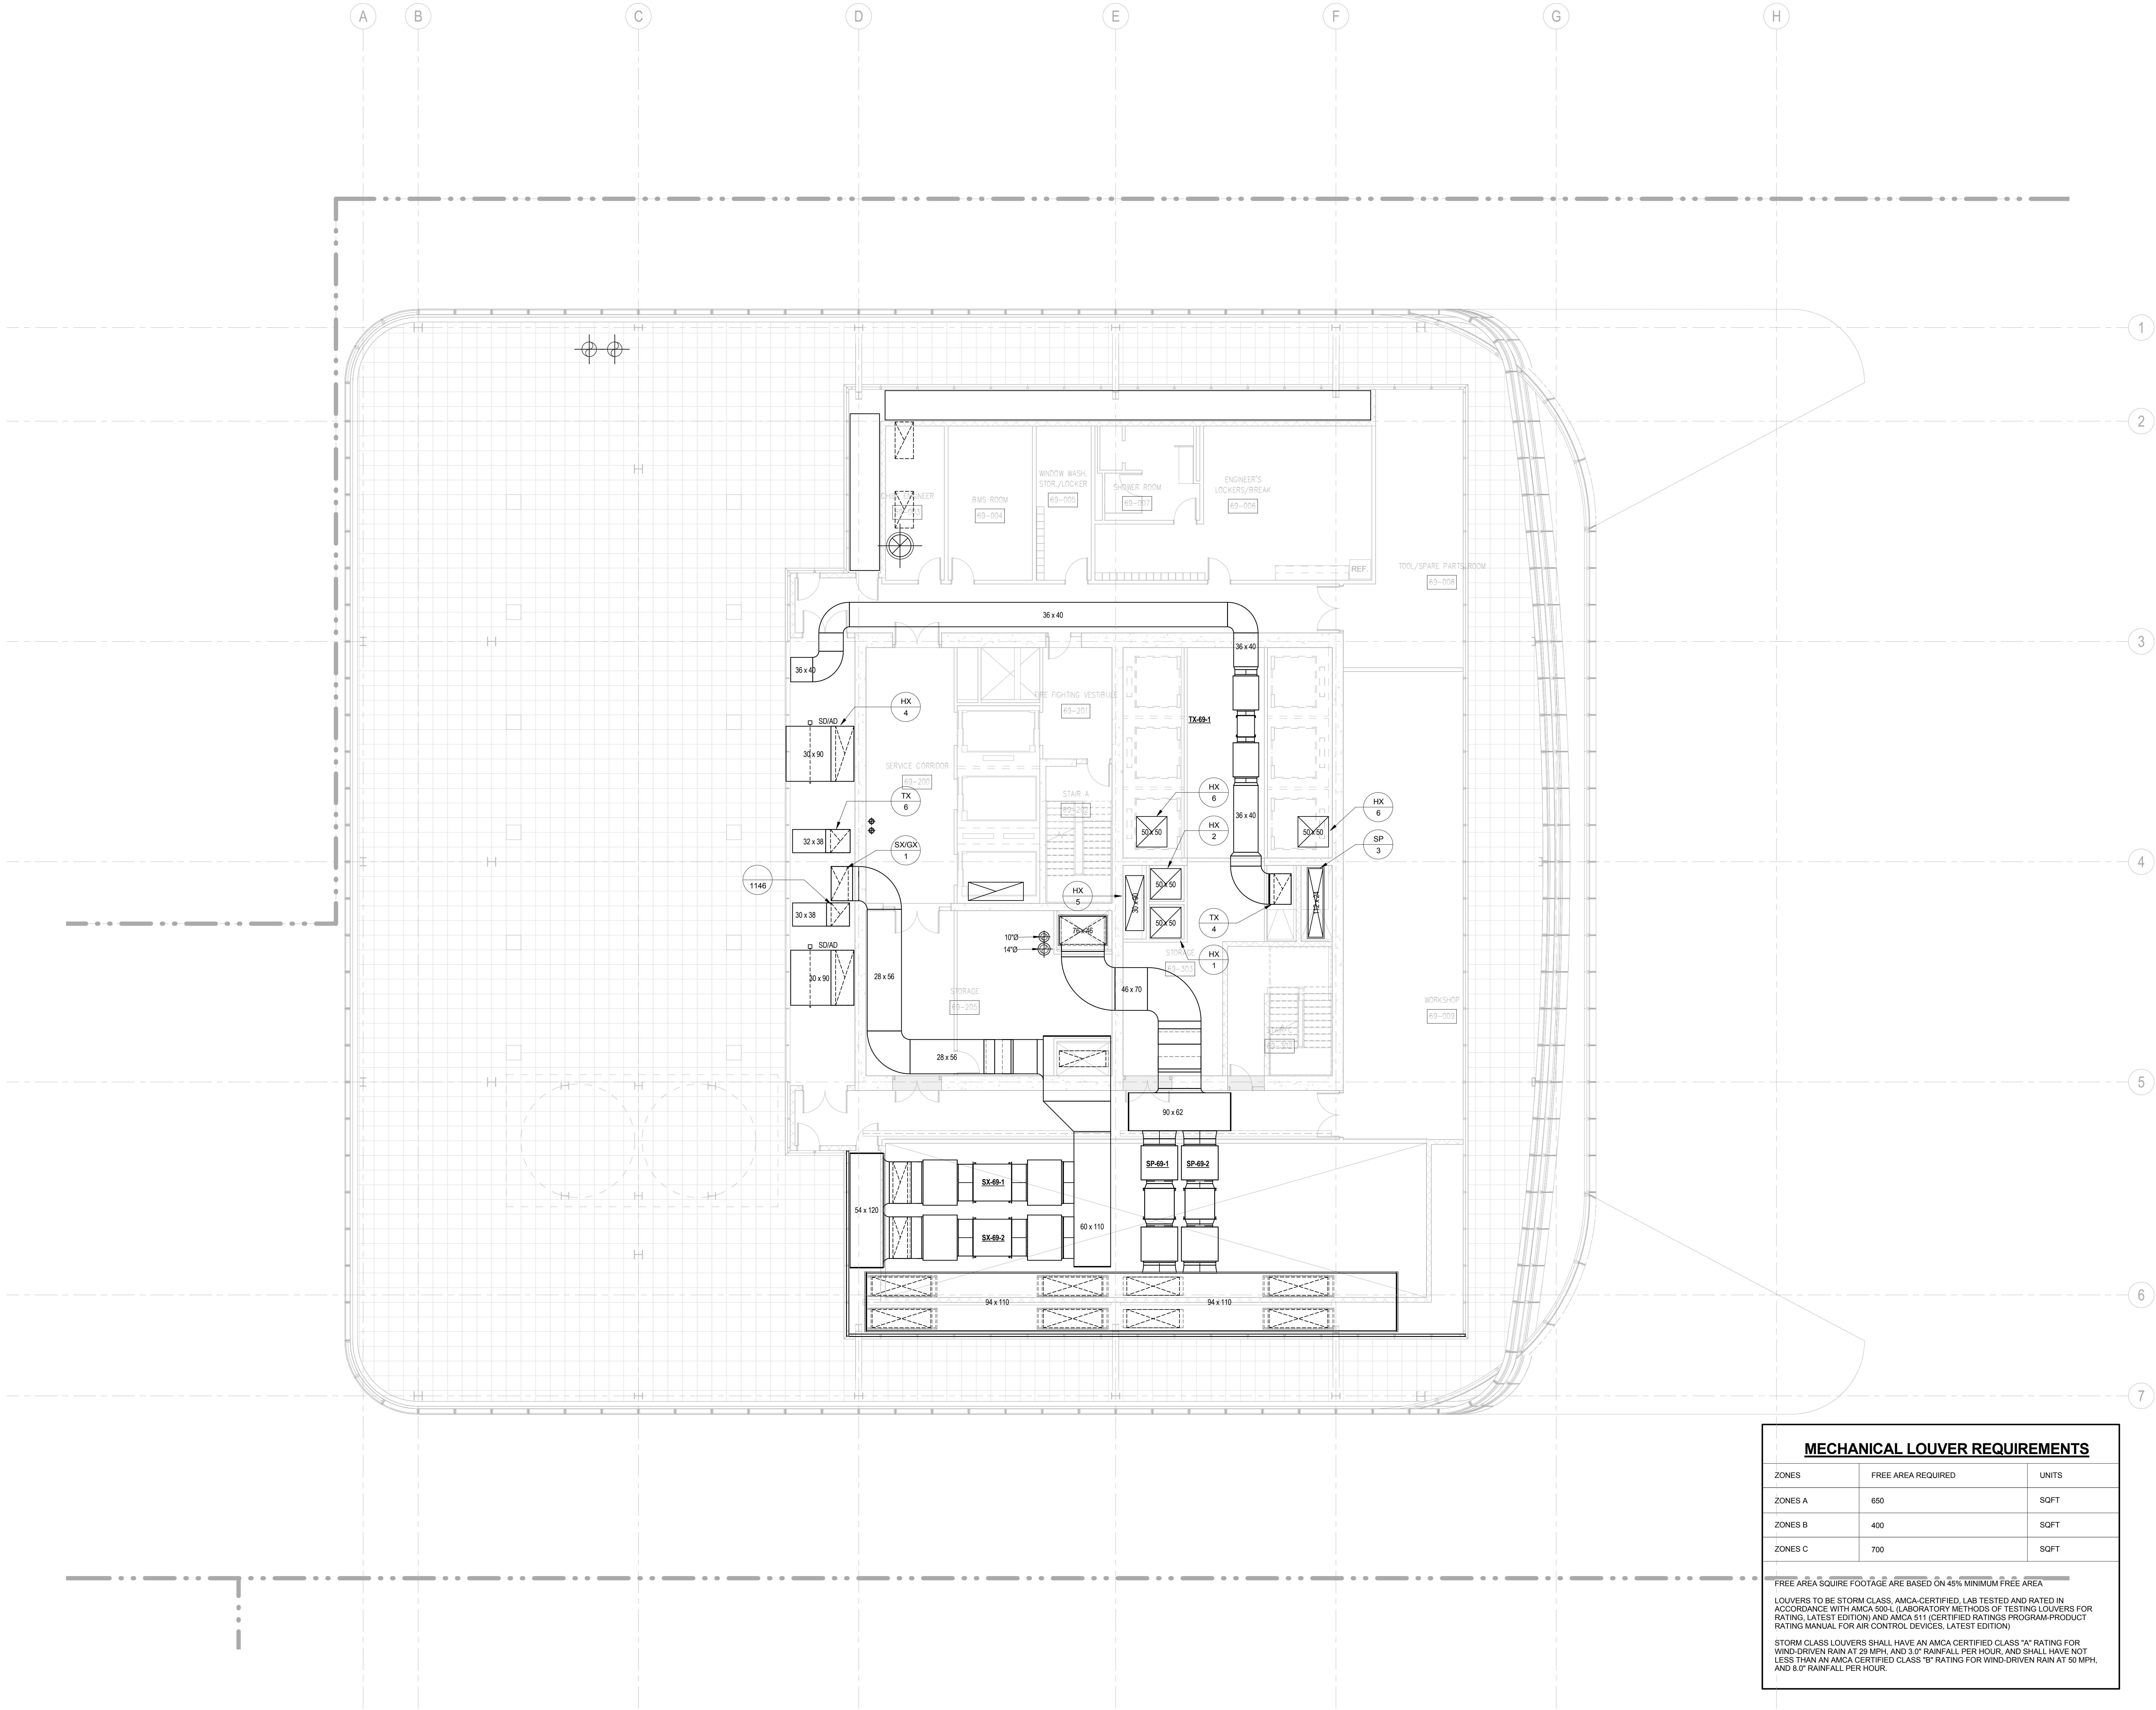
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Project No.: 14030 A.000

Date: 20 JUN 2014


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MECHANICAL LOUVER REQUIREMENTS		
ZONES	FREE AREA REQUIRED	UNITS
ZONES A	650	SQFT
ZONES B	400	SQFT
ZONES C	700	SQFT
FREE AREA SQUIRE FOOTAGE ARE BASED ON 45% MINIMUM FREE AREA		
LOUVERS TO BE STORM CLASS, AMCA-CERTIFIED, LAB TESTED AND RATED IN ACCORDANCE WITH AMCA 500-L (LABORATORY METHODS OF TESTING LOUVERS FOR RATING, LATEST EDITION) AND AMCA 511 (CERTIFIED RATINGS PROGRAM-PRODUCT RATING MANUAL FOR AIR CONTROL DEVICES, LATEST EDITION)		
STORM CLASS LOUVERS SHALL HAVE AN AMCA CERTIFIED CLASS "A" RATING FOR WIND-DRIVEN RAIN AT 20 MPH, AND 3.0" RAINFALL PER HOUR, AND SHALL HAVE NOT LESS THAN AN AMCA-CERTIFIED CLASS "B" RATING FOR WIND-DRIVEN RAIN AT 50 MPH, AND 8.0" RAINFALL PER HOUR.		

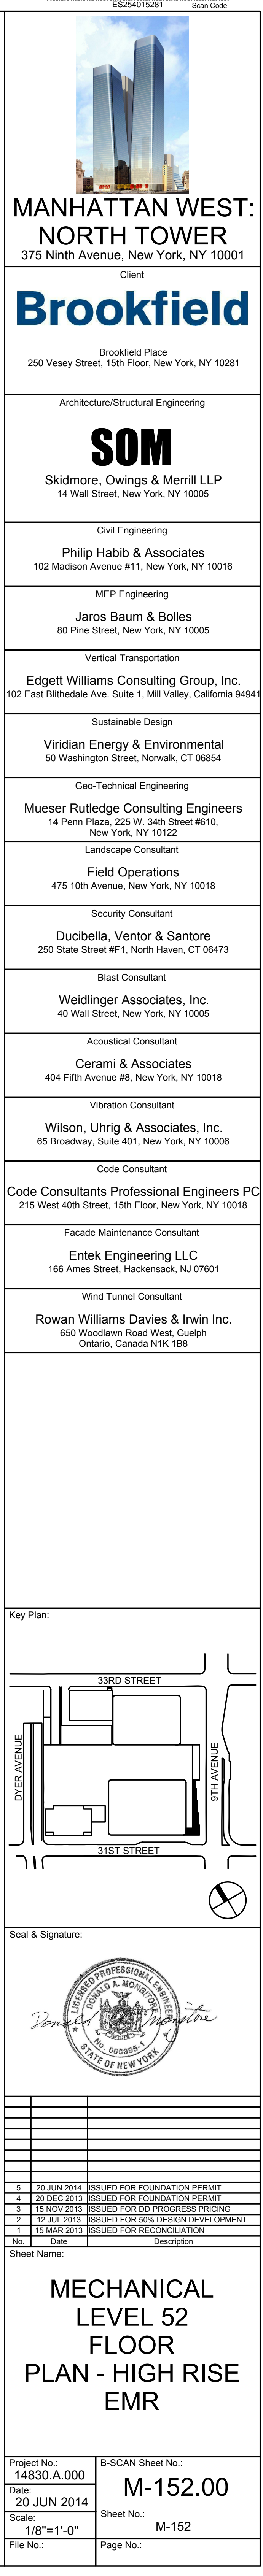SHEET NOTES
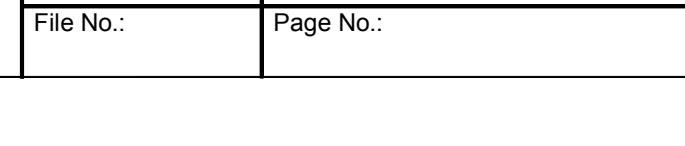
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Blast Consultant
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404 Fifth Avenue #8, New York, NY 10016


Vibration Consultant
Wilson, Uhrig & Associates, Inc.
65 Broadway, Suite 401, New York, NY 10006

Code Consultant
Code Consultants Professional Engineers PC
215 West 40th Street, 15th Floor, New York, NY 10018


Facade Maintenance Consultant
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Rowan Williams Davies & Irwin Inc.
680 Woodlawn Road West, Guelph
Ontario, Canada N1K 1B8

Key Plan:



Seal & Signature:

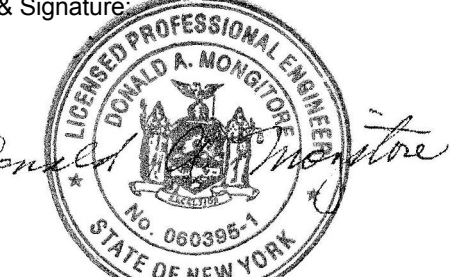


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4	20 DEC 2013	ISSUED FOR FOUNDATION PERMIT
3	15 NOV 2013	ISSUED FOR SD PROGRESS PRICING
2	12 JUL 2013	ISSUED FOR REDDESIGN DEVELOPMENT
1	19 MAR 2012	ISSUED FOR RECONCILIATION

No. _____ Date _____ Description _____
Sheet Name: _____

**MECHANICAL
LEVEL 69 FLOOR
PLAN -
MECHANICAL
MEZZANINE**

Project No.: 14830 A-000
Date: 20 JUN 2014
Scale: 1/8" = 1'-0"
File No.: M-169

B-SCAN Sheet No.:
M-169.00
Sheet No.:
M-169
Page No.: 45 OF 77

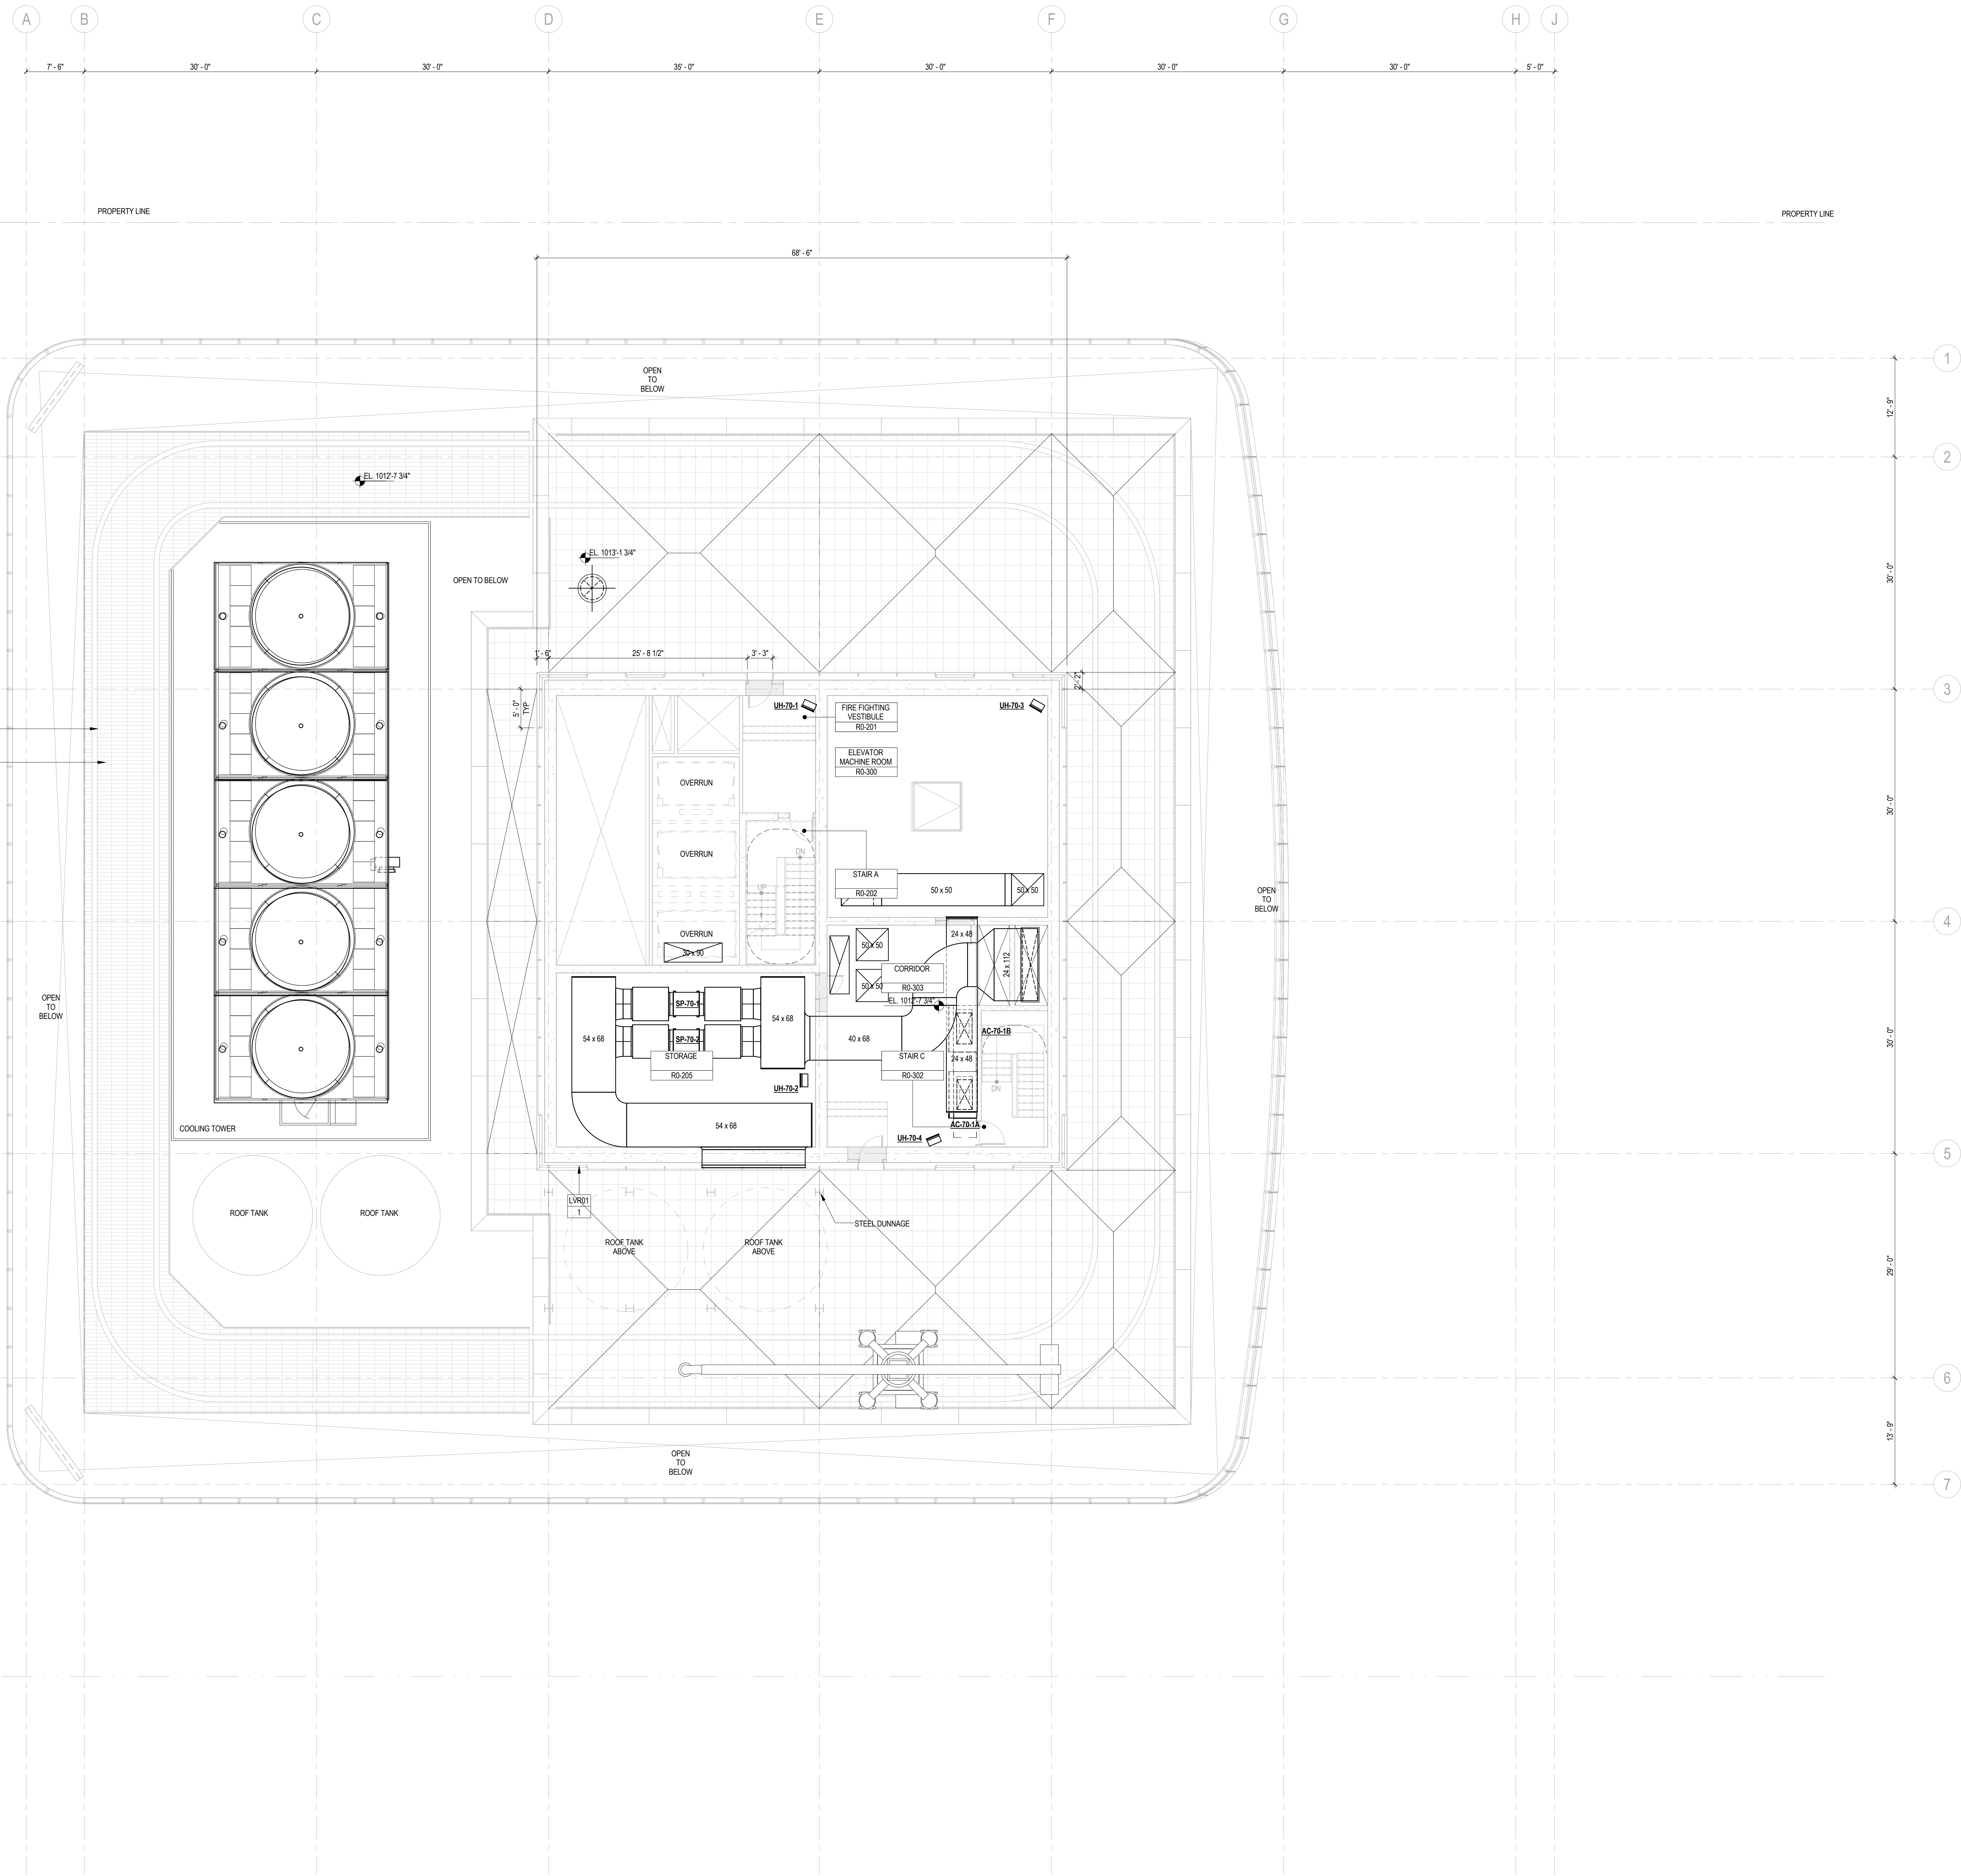

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Project No.: 14830 A-000
Date: 20 JUN 2014
Scale: 1/8" = 1'-0"
File No.: M-170
B-SCAN Sheet No.: M-170.00
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Page No.: 46 OF 177

MECHANICAL
ROOF PLAN -
MECHANICAL
PENTHOUSE


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1	19 MAR 2012	ISSUED FOR RECONCILIATION



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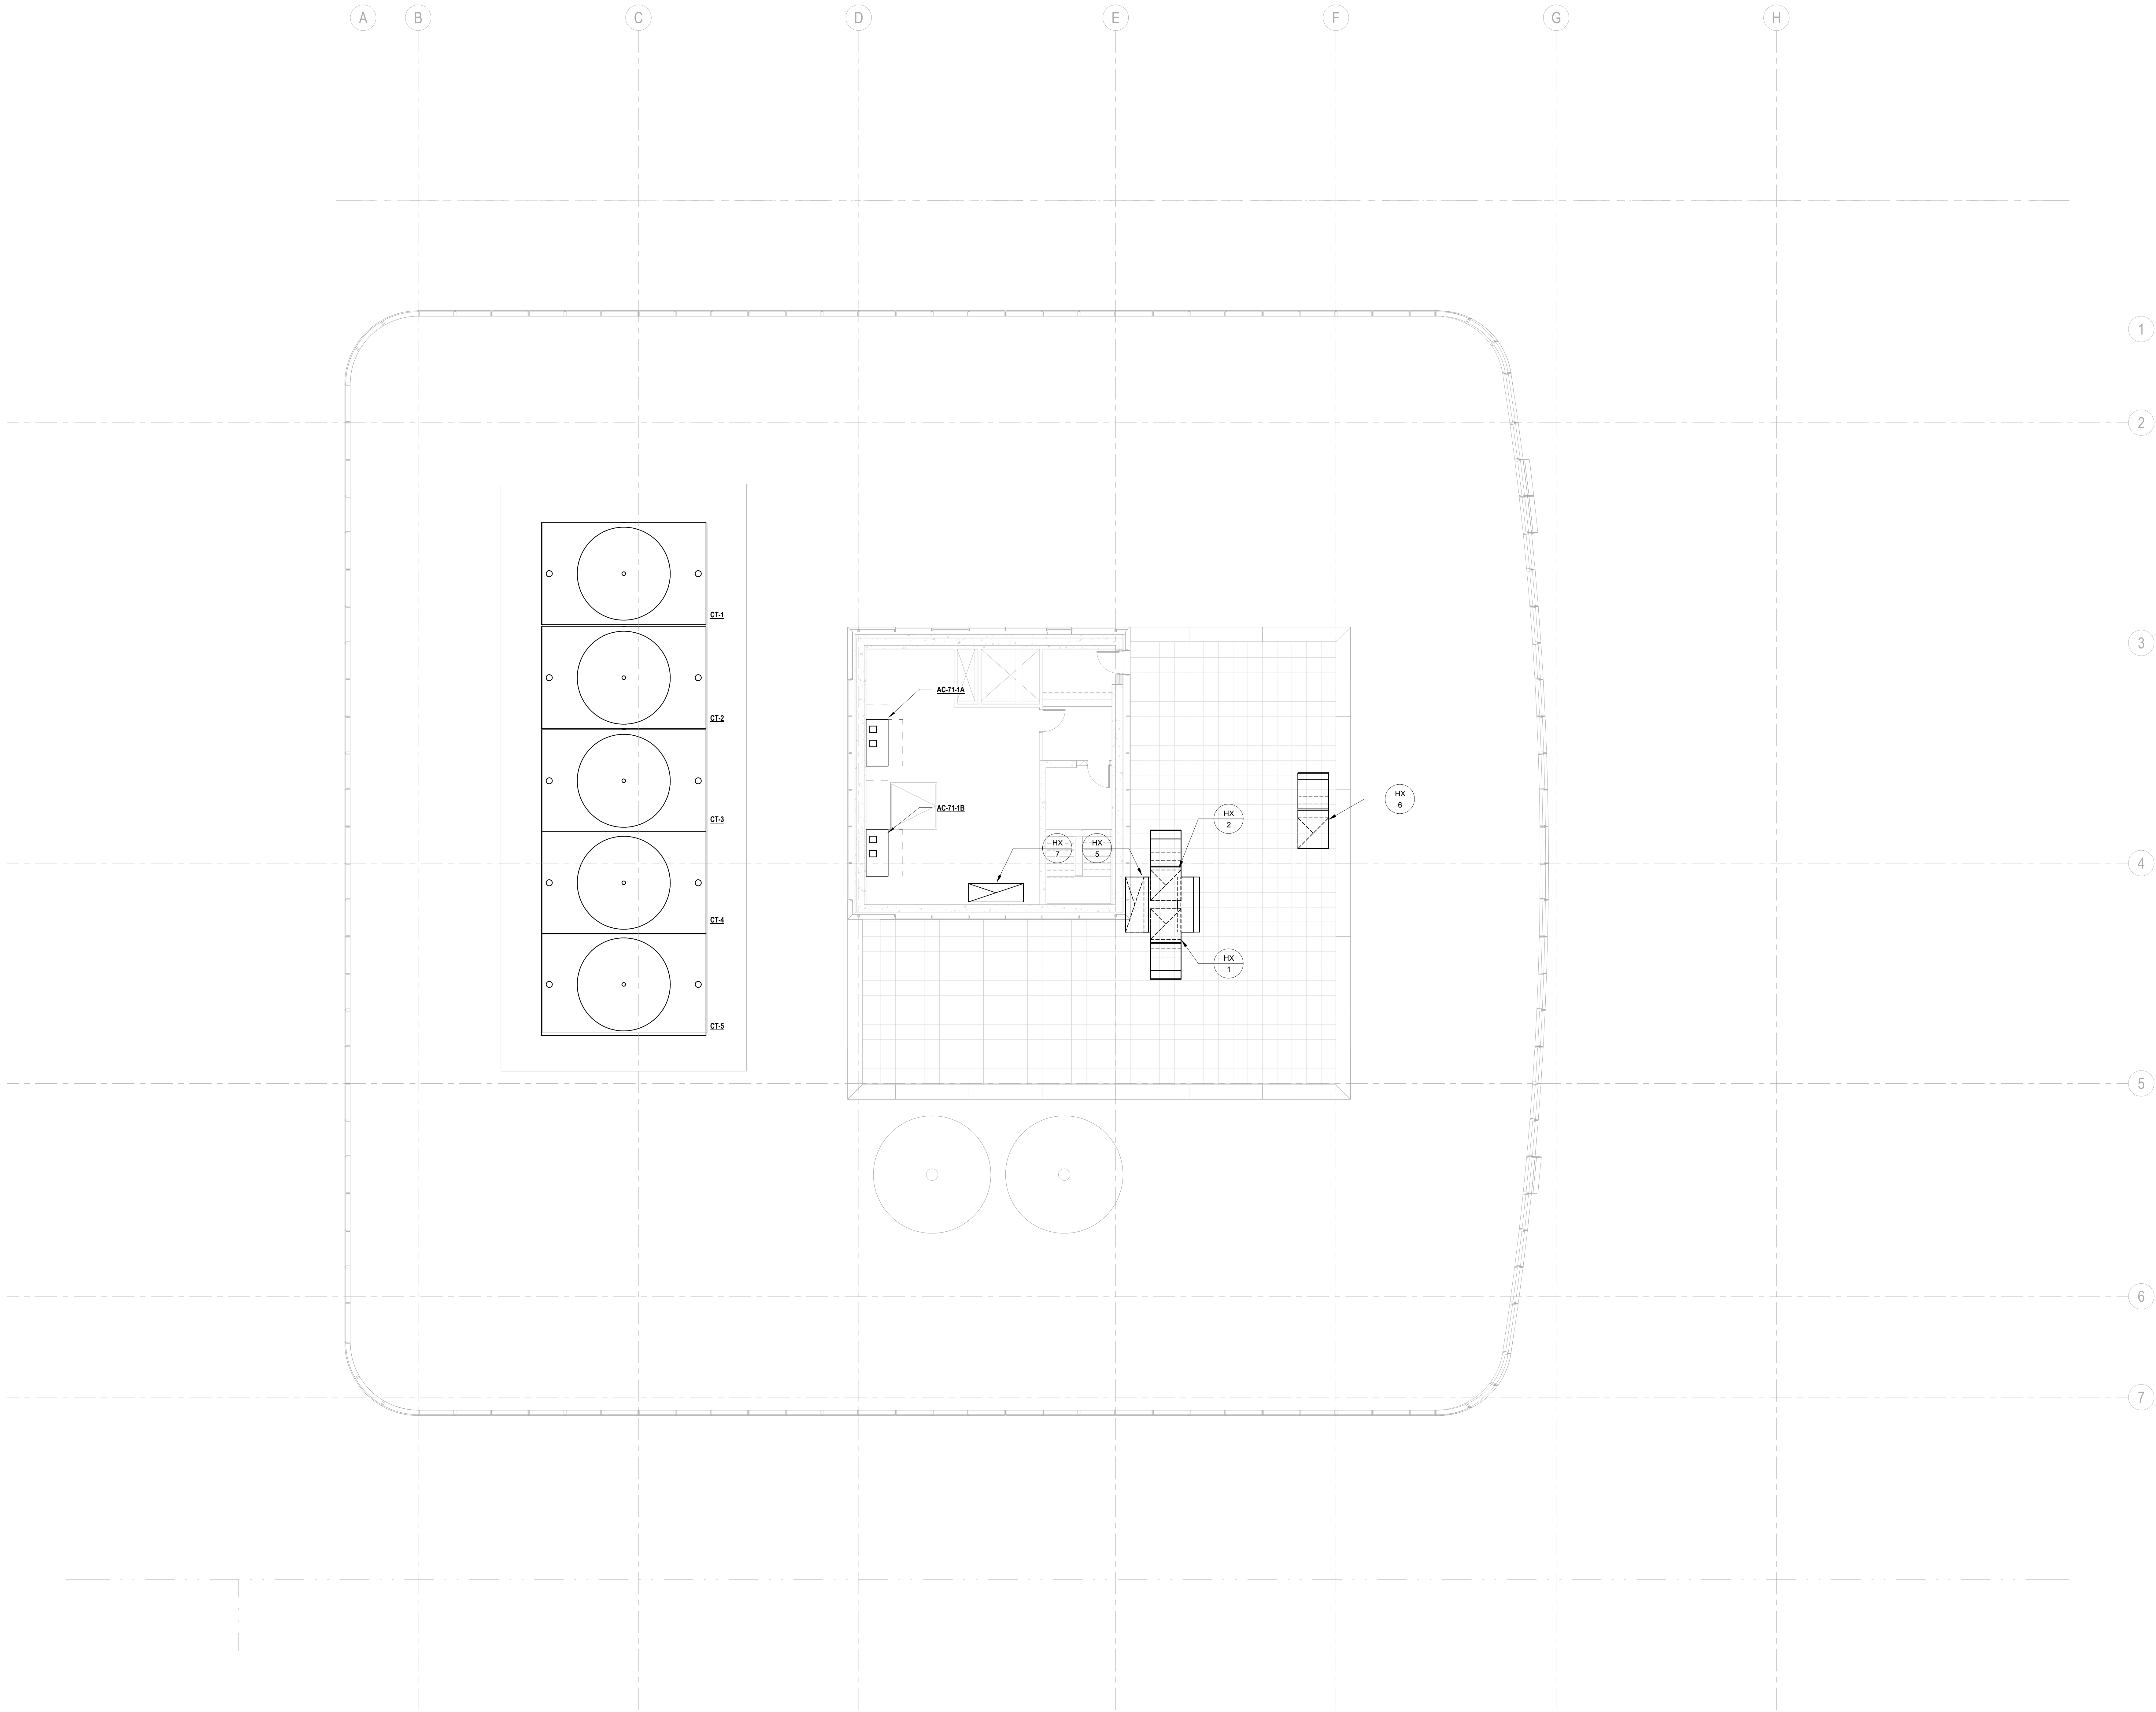
Architecture/Structural Engineering
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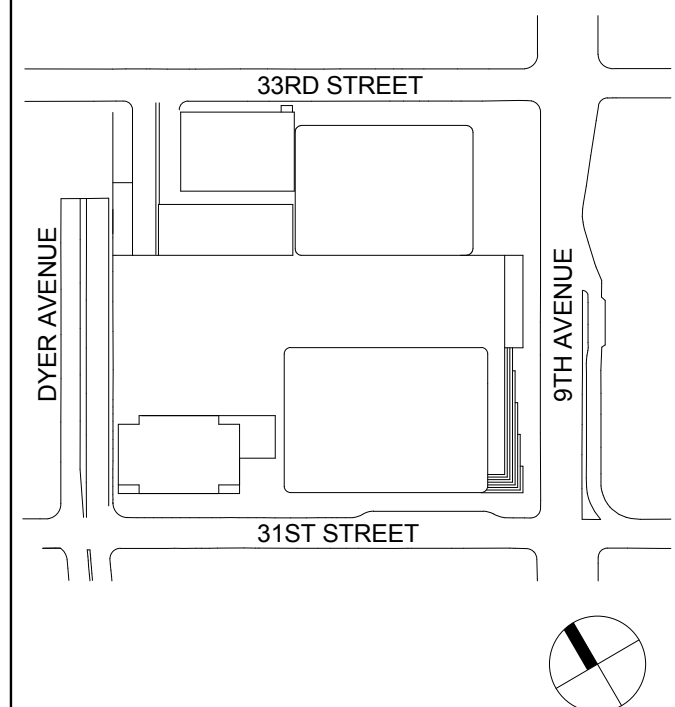
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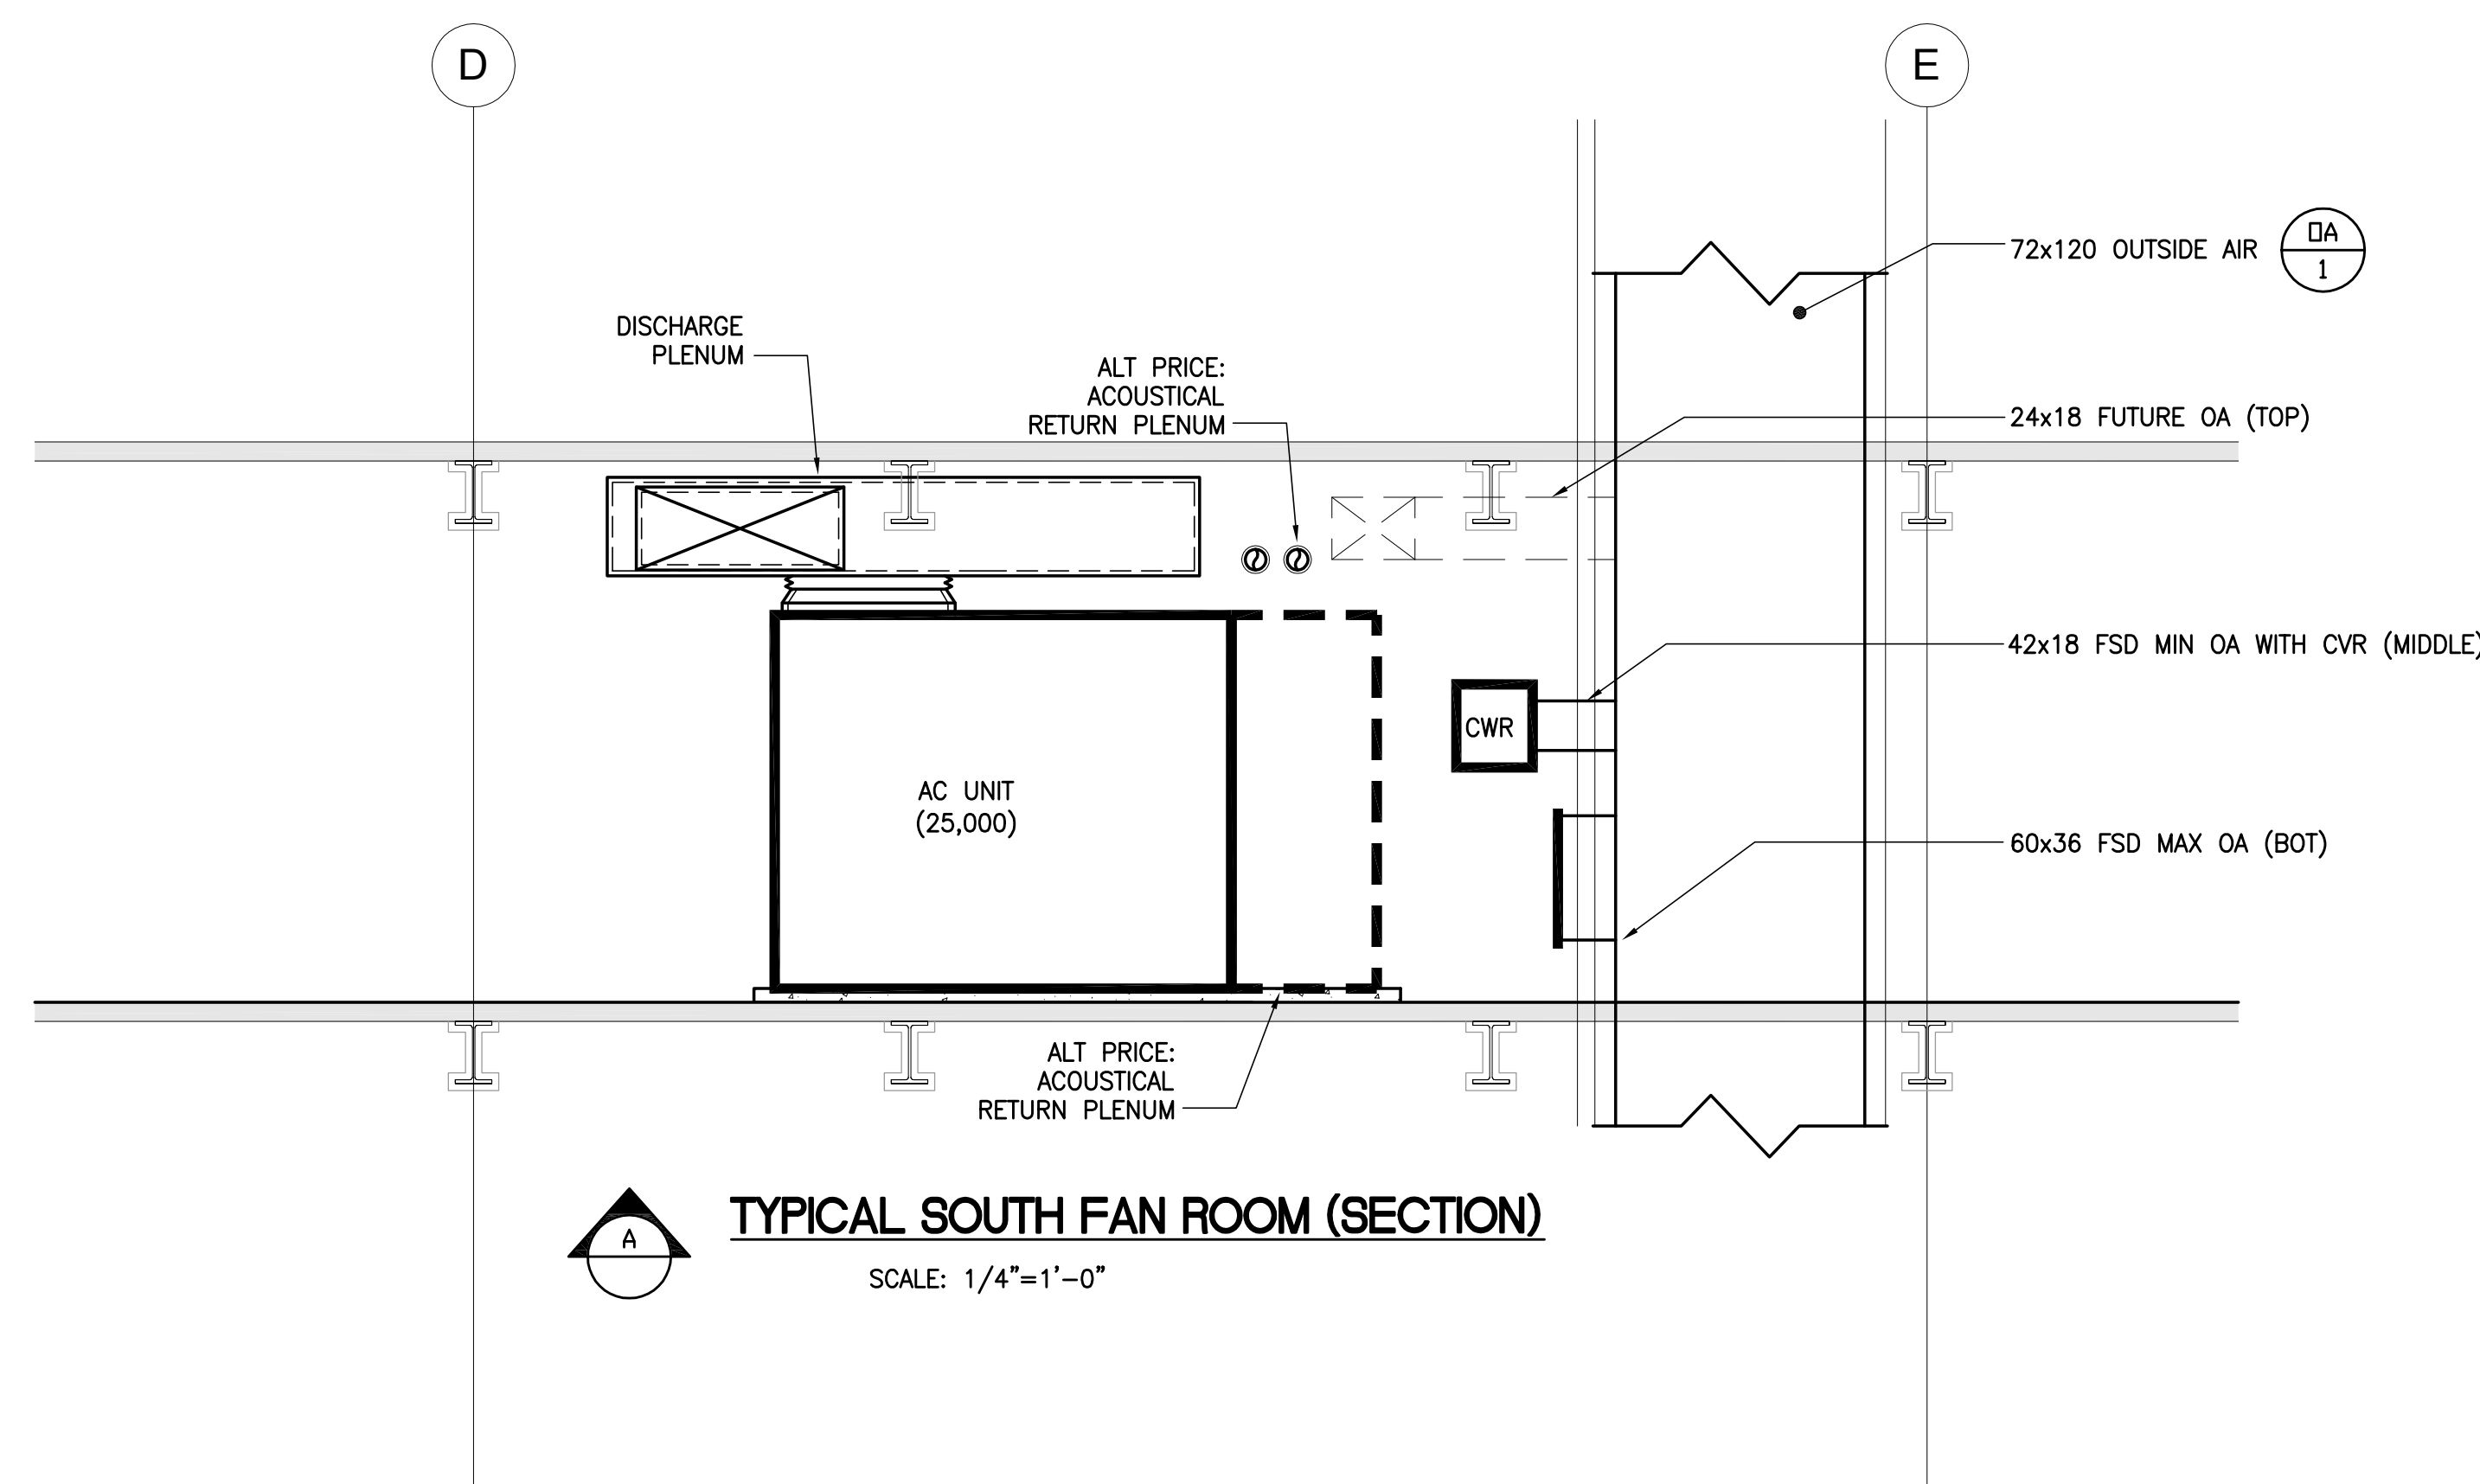


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4	20 DEC 2013	ISSUED FOR FOUNDATION PERMIT
3	15 NOV 2013	ISSUED FOR 3D PROGRESS PRICING
2	12 JUL 2013	ISSUED FOR REDESIGN DEVELOPMENT
1	19 MAR 2012	ISSUED FOR RECONCILIATION


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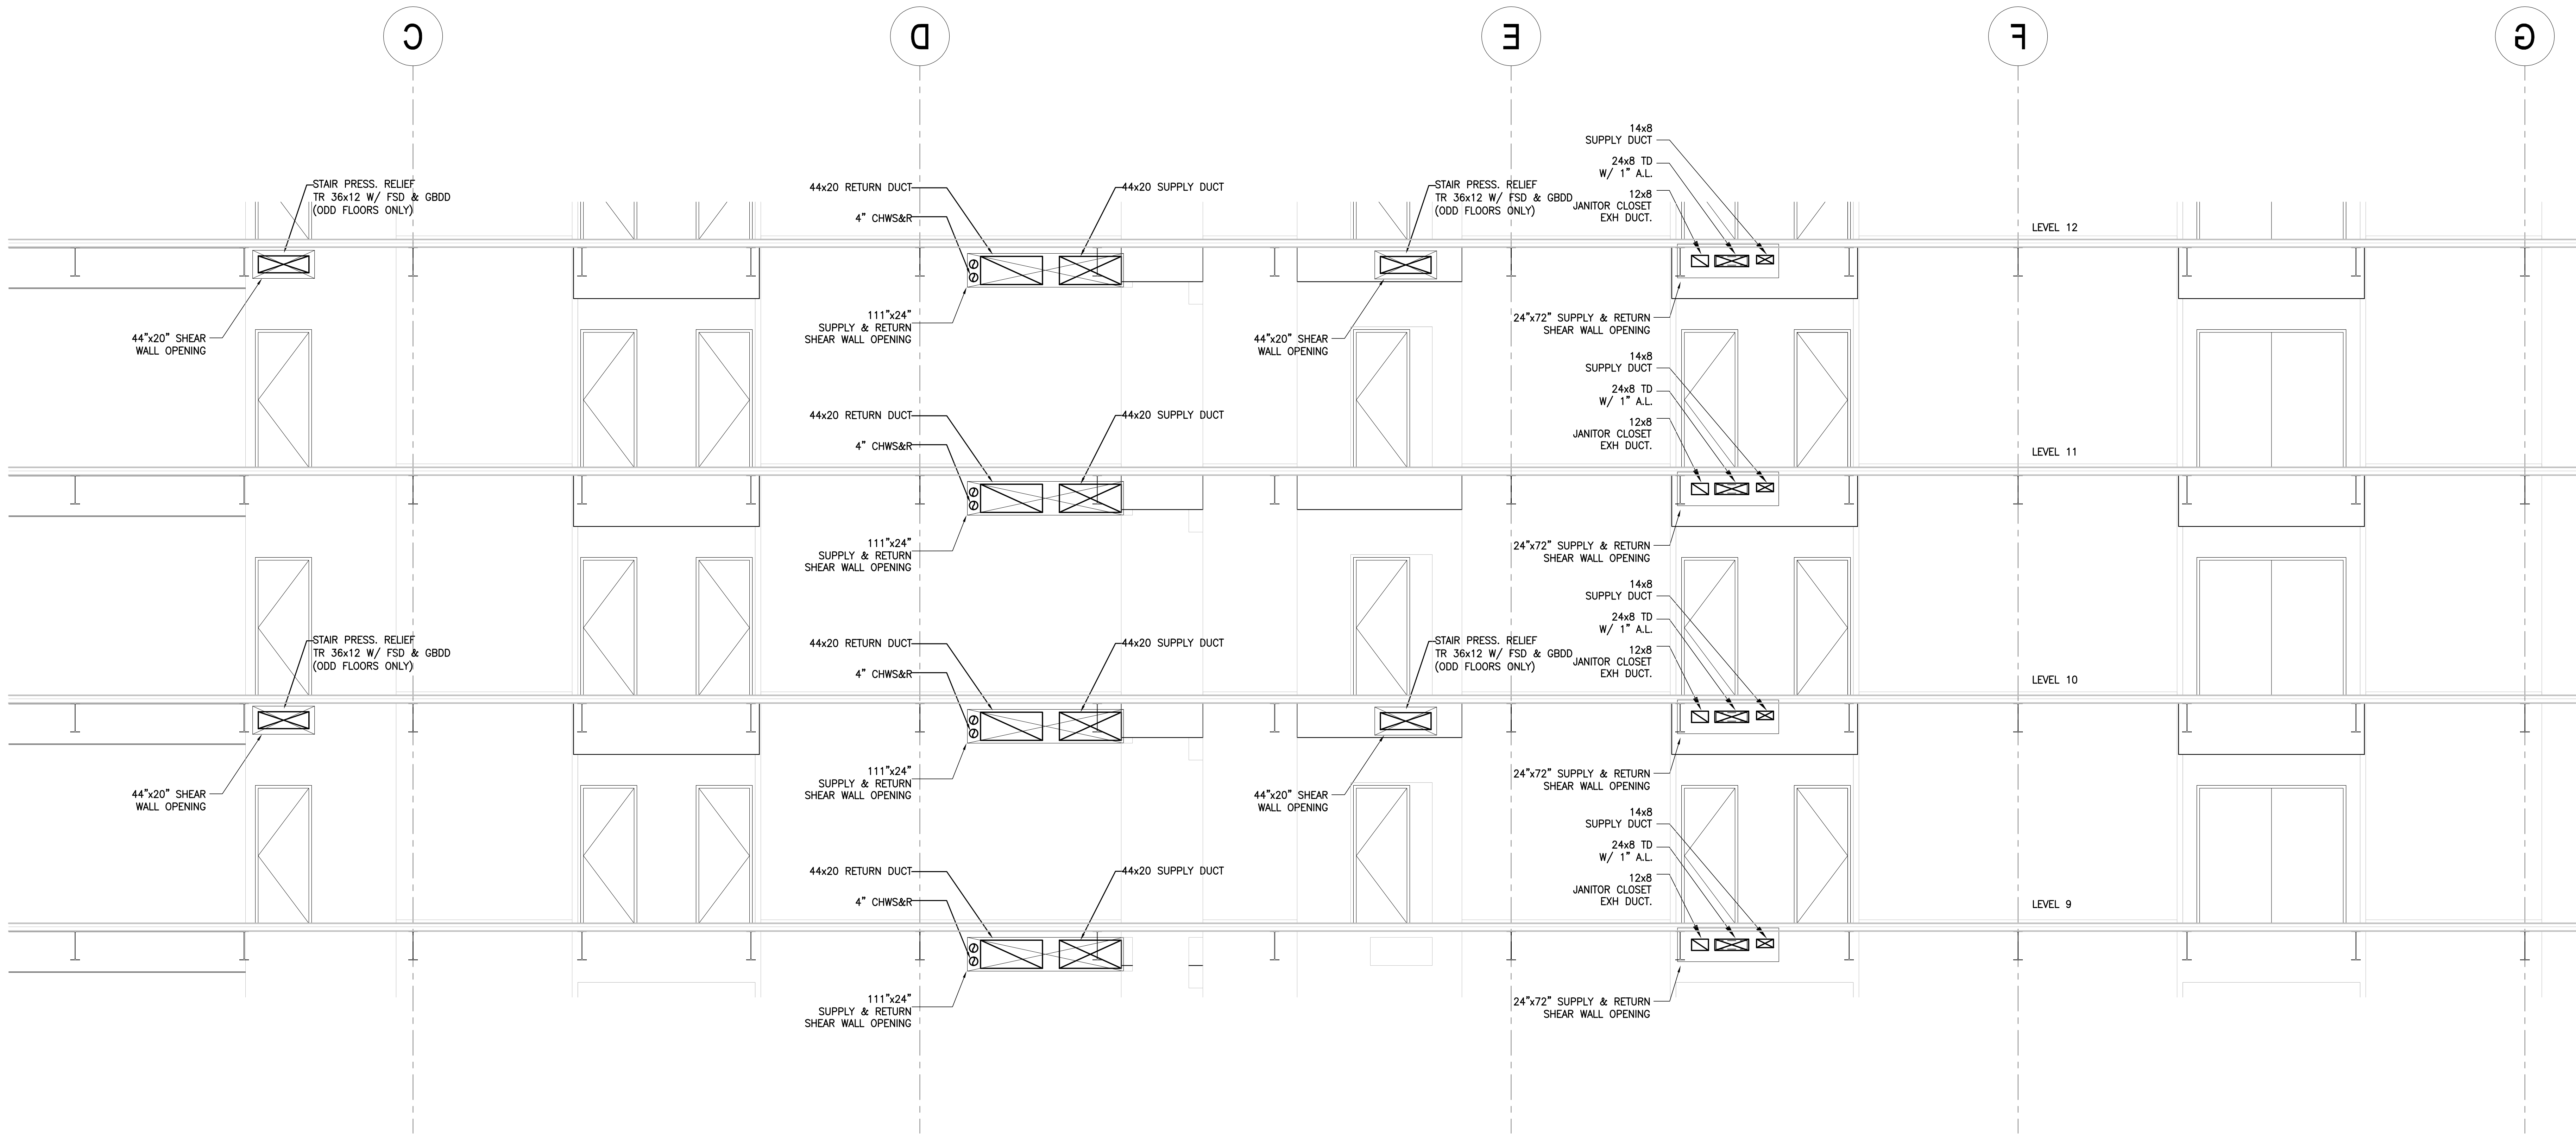
**MECHANICAL
ROOF PLAN -
MECHANICAL
PENTHOUSE
ROOF**

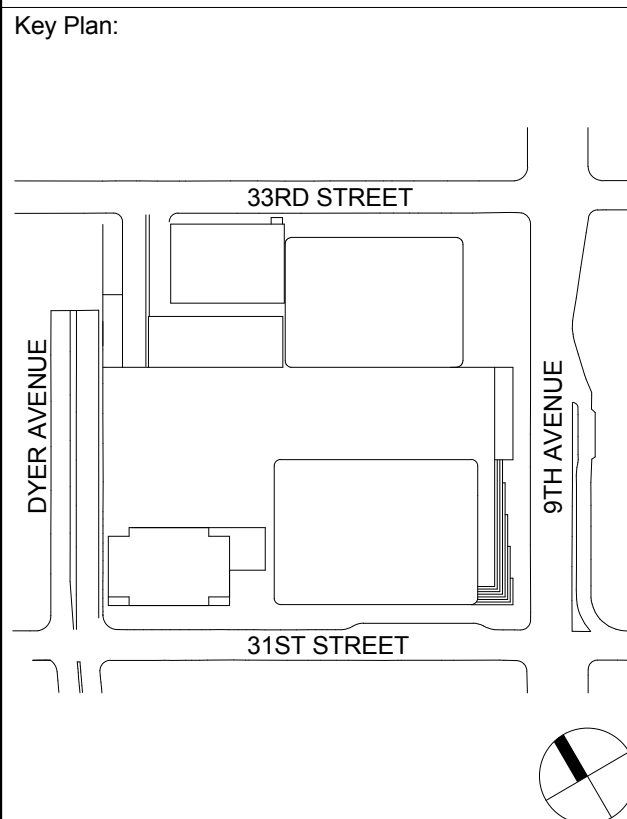Project No.: 14830 A-000	B-SCAN Sheet No.: M-171.00
Date: 20 JUN 2014	Sheet No.: M-171
Scale: 1/8" = 1'-0"	Page No.: 47 OF 77
File No.: M-171	




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NORTH SHEAR WALL SECTIONS
SCALE: 1/4"=1'-0"

SHEET NOTES

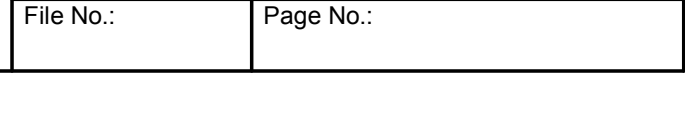

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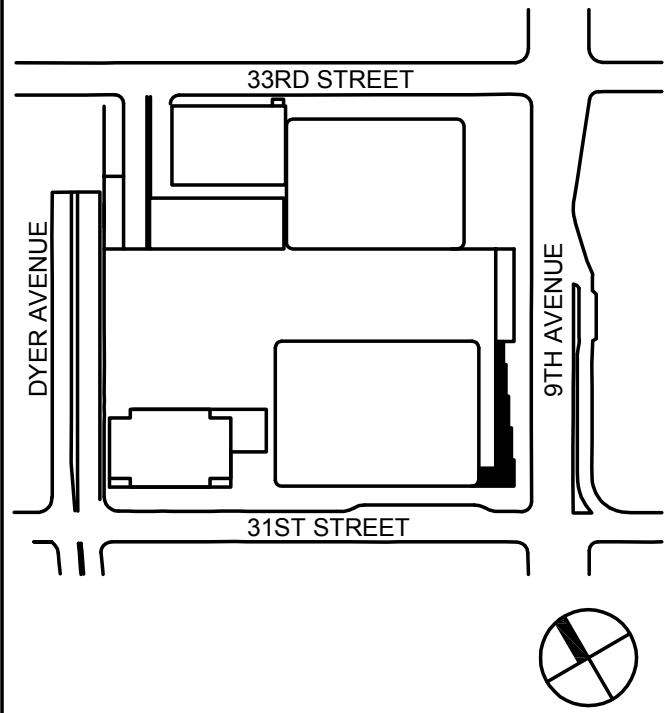
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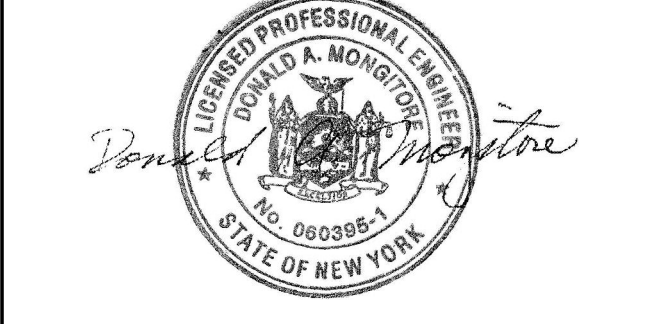
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Rowan Williams Davies & Irwin Inc.
650 Woodlawn Road West, Guelph
Ontario, Canada N1K 1S8

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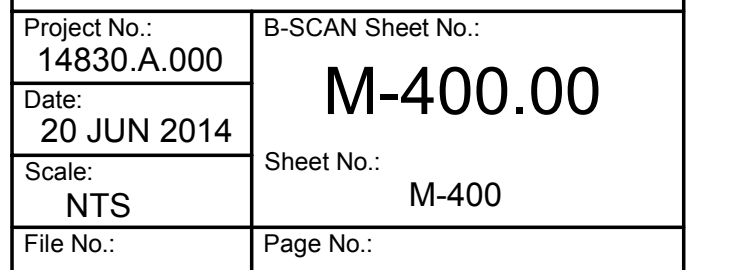



No.	Date	Description
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2	20 DEC 2010	ISSUED FOR FOUNDATION PERMIT
3	13 NOV 2013	ISSUED FOR DD PROJECT SUBMITTING
4	12 JUL 2013	ISSUED FOR 50% DESIGN DEVELOPMENT
5	13 MAR 2010	ISSUED FOR RECONFIGURATION

Sheet Name:

**MECHANICAL
NORTH SHEAR
WALL SECTIONS**

Project No:	B-SCAN Sheet No.:
14830.A.000	M-300.00
Date: 20 JUN 2014	Sheet No.:
Scale: 1/4"=1'-0"	M-300
File No.:	Page No.:



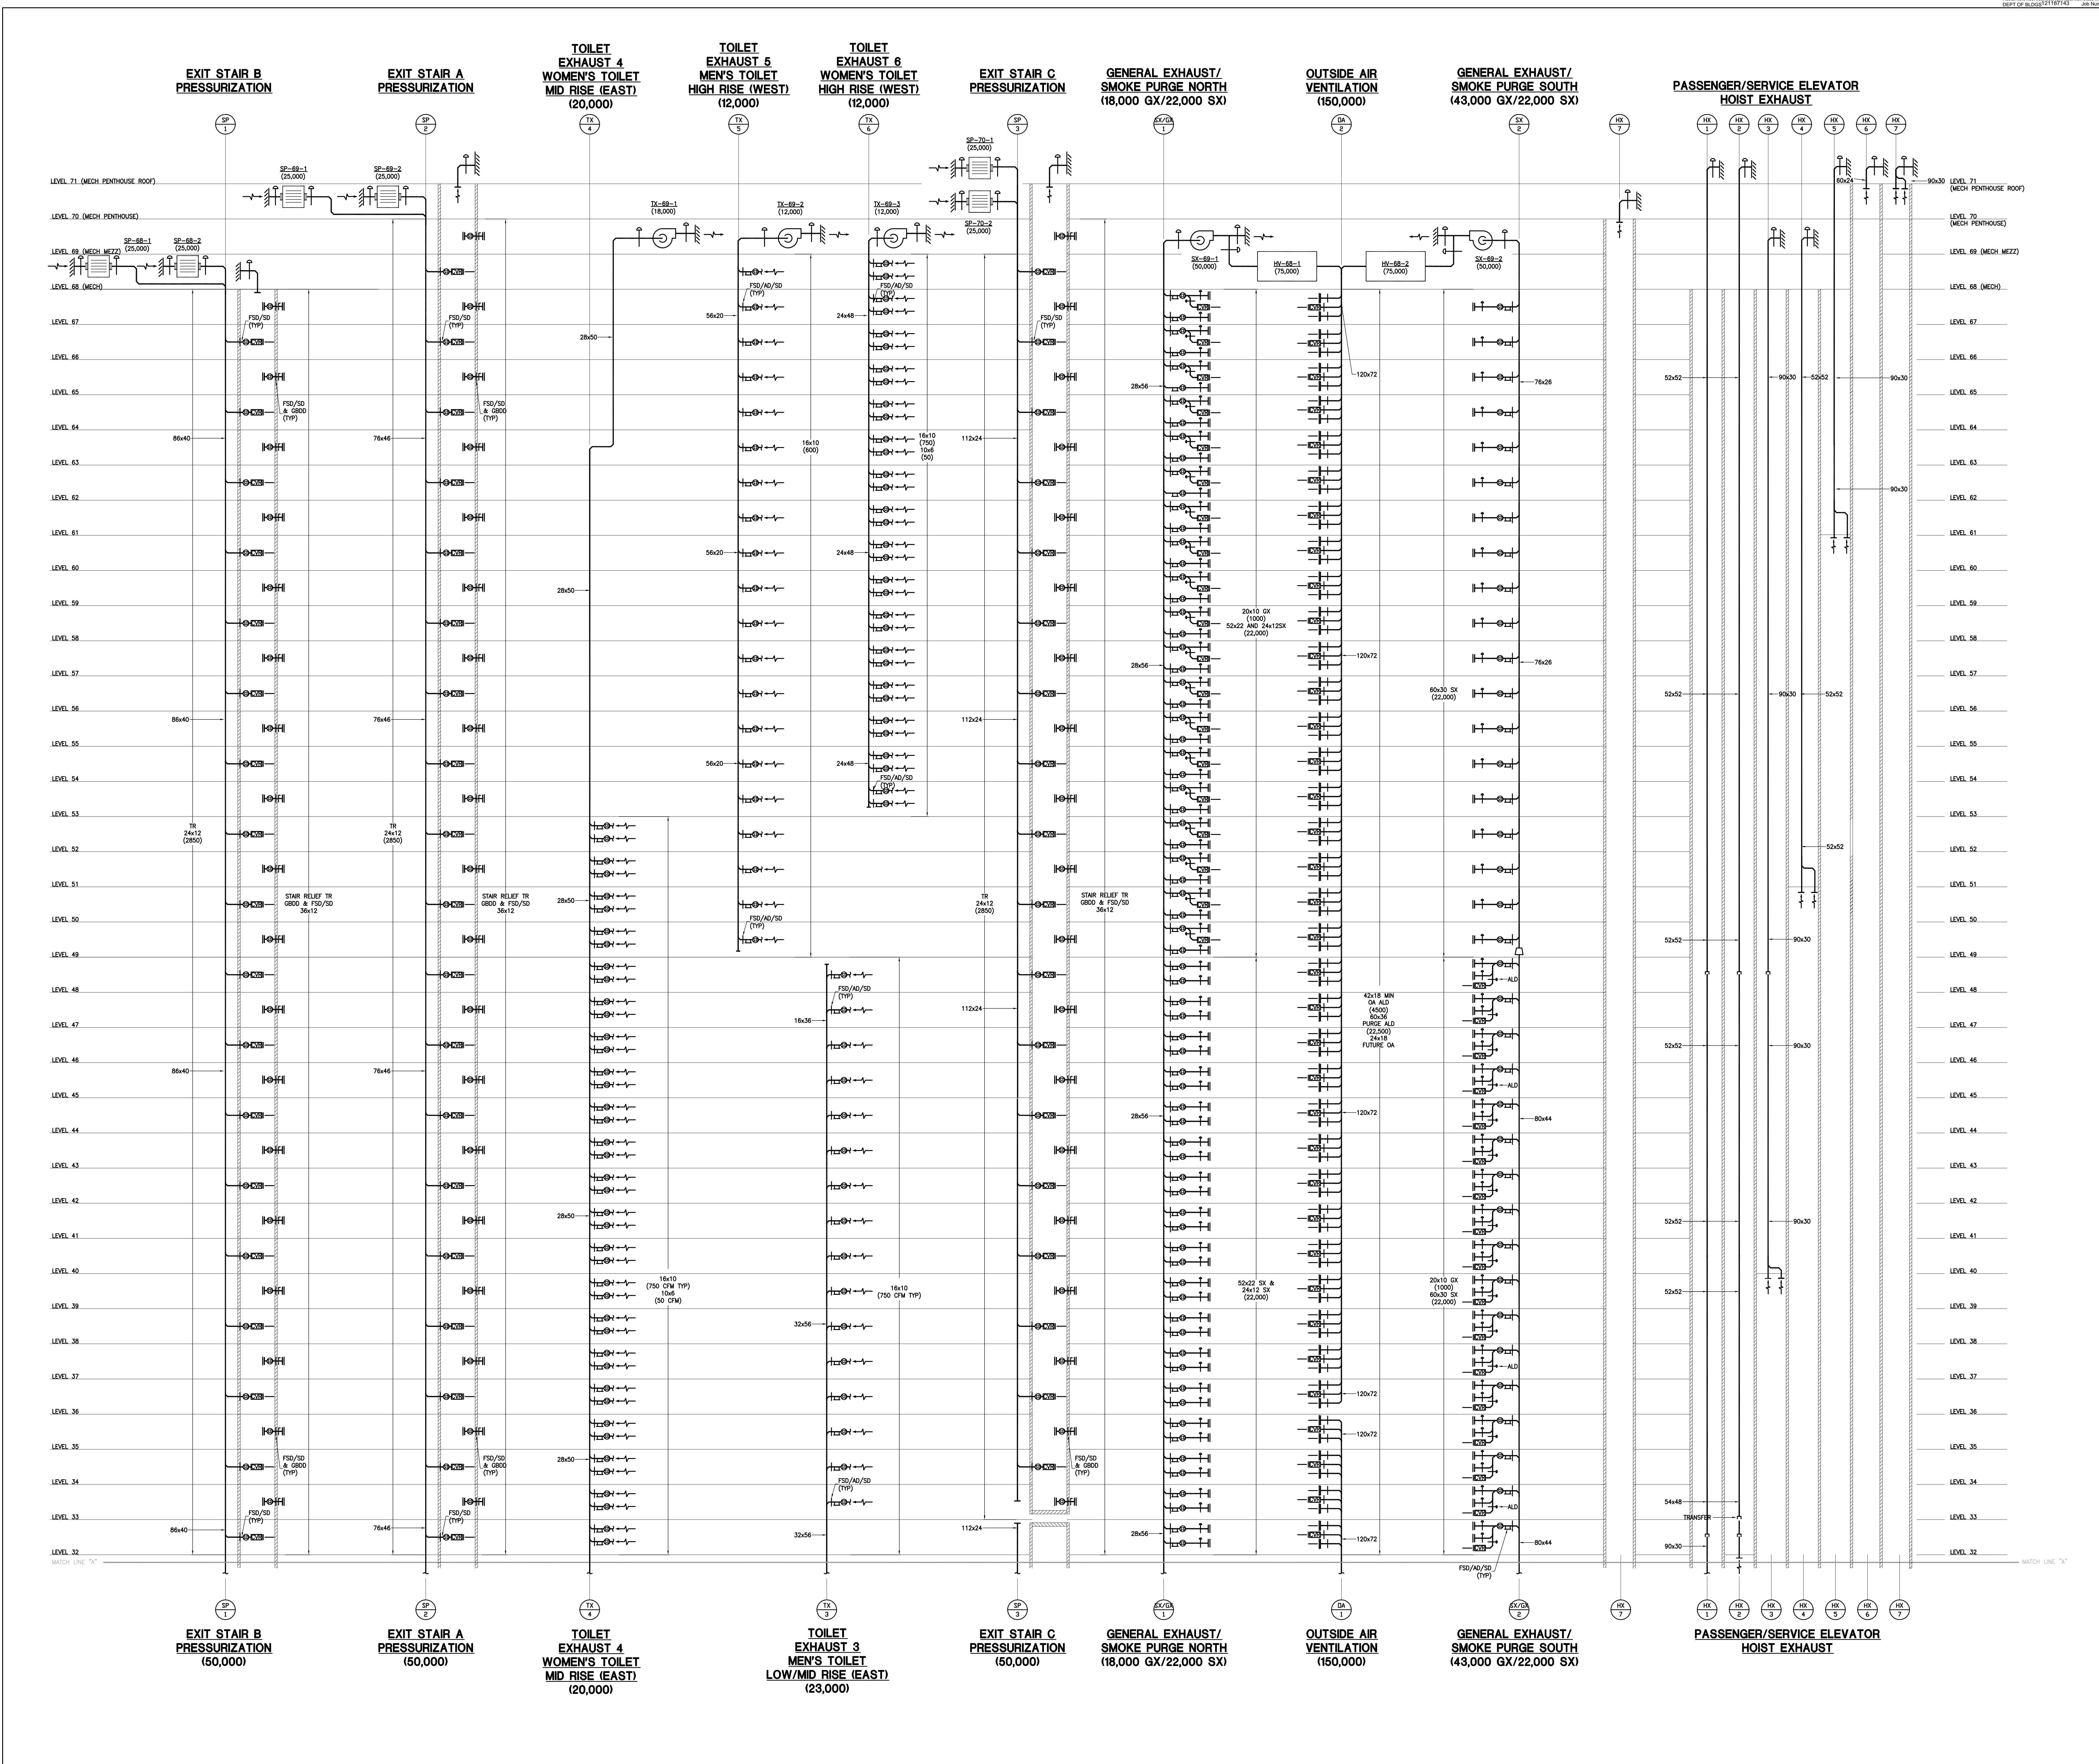

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Key Plan:


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2	20 DEC 2013	ISSUED FOR FOUNDATION PERMIT
3	13 NOV 2013	ISSUED FOR FOUNDATION PERMIT
4	12 JUL 2013	ISSUED FOR 50% DESIGN DEVELOPMENT
5	13 MAR 2013	ISSUED FOR RECONSTRUCTION

No. _____ Date _____ Description _____
Sheet Name: _____

**MECHANICAL
HIGH-RISE
AIR RISER
DIAGRAM**

Project No: 14830.A.000	B-SCAN Sheet No.: M-402.00
Date: 20 JUN 2014	Sheet No.: M-402
Scale: NTS	Page No.: _____
File No.: _____	_____



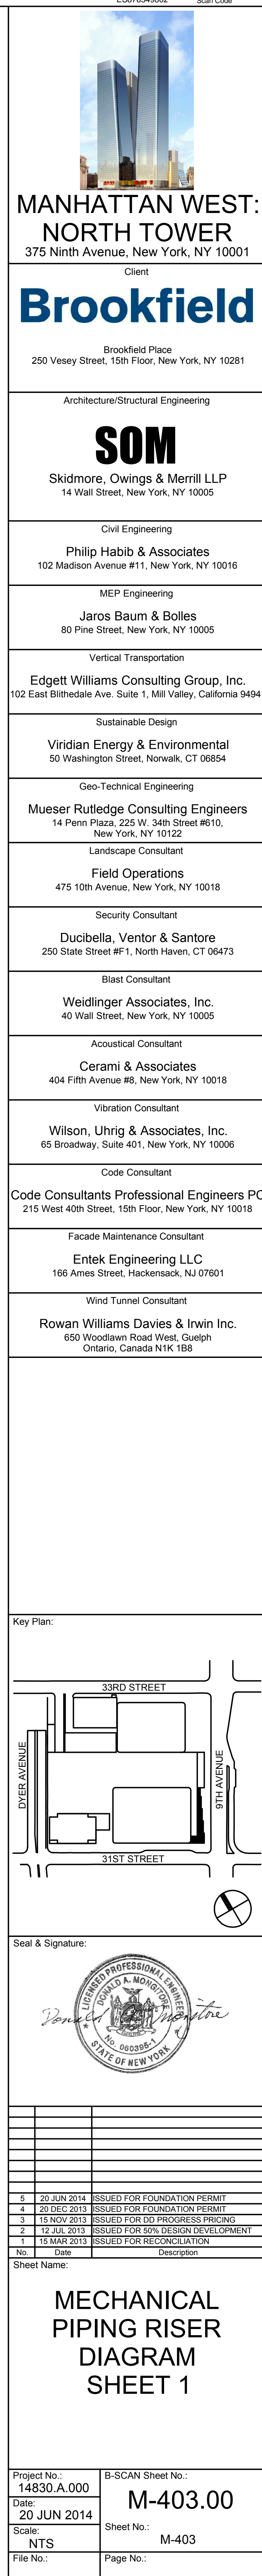

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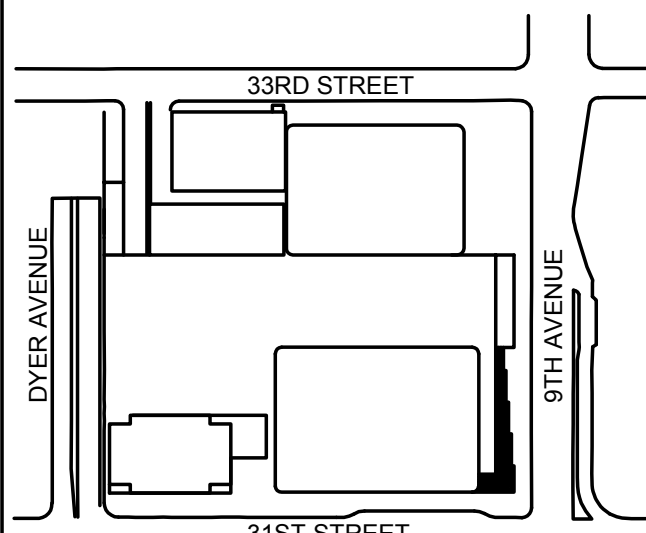
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3	13 NOV 2013	ISSUED FOR 10% DESIGN DEVELOPMENT
4	12 JUL 2013	ISSUED FOR 50% DESIGN DEVELOPMENT
5	1 MAR 2013	ISSUED FOR RECONFIGURATION

No.

Date

Description

Sheet Name:

**MECHANICAL
HOT WATER
RISER DIAGRAM
SHEET 2**

Project No:

14830.A.000

Date:

20 JUN 2014

Scale:

NTS

File No.:


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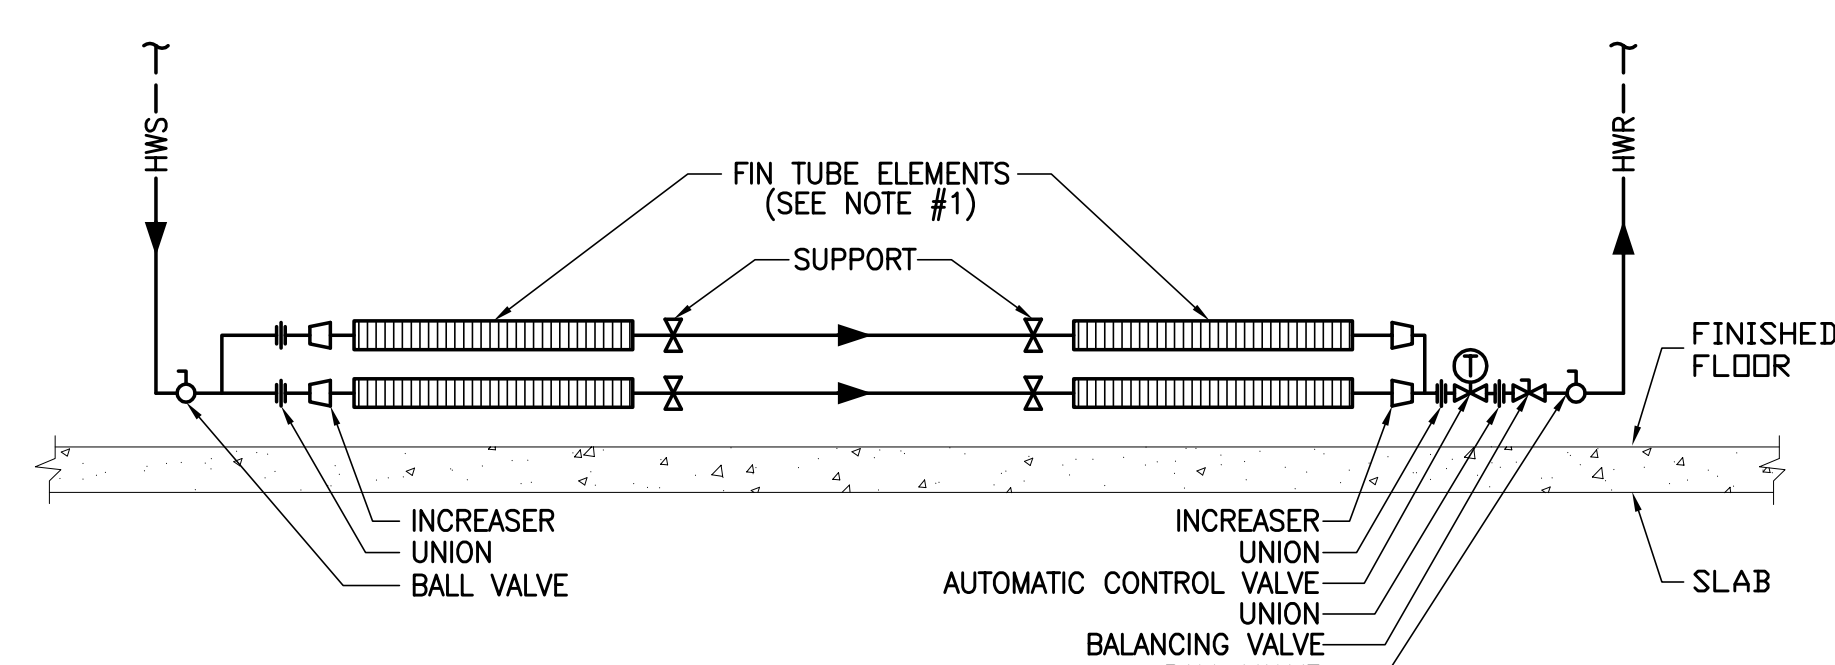
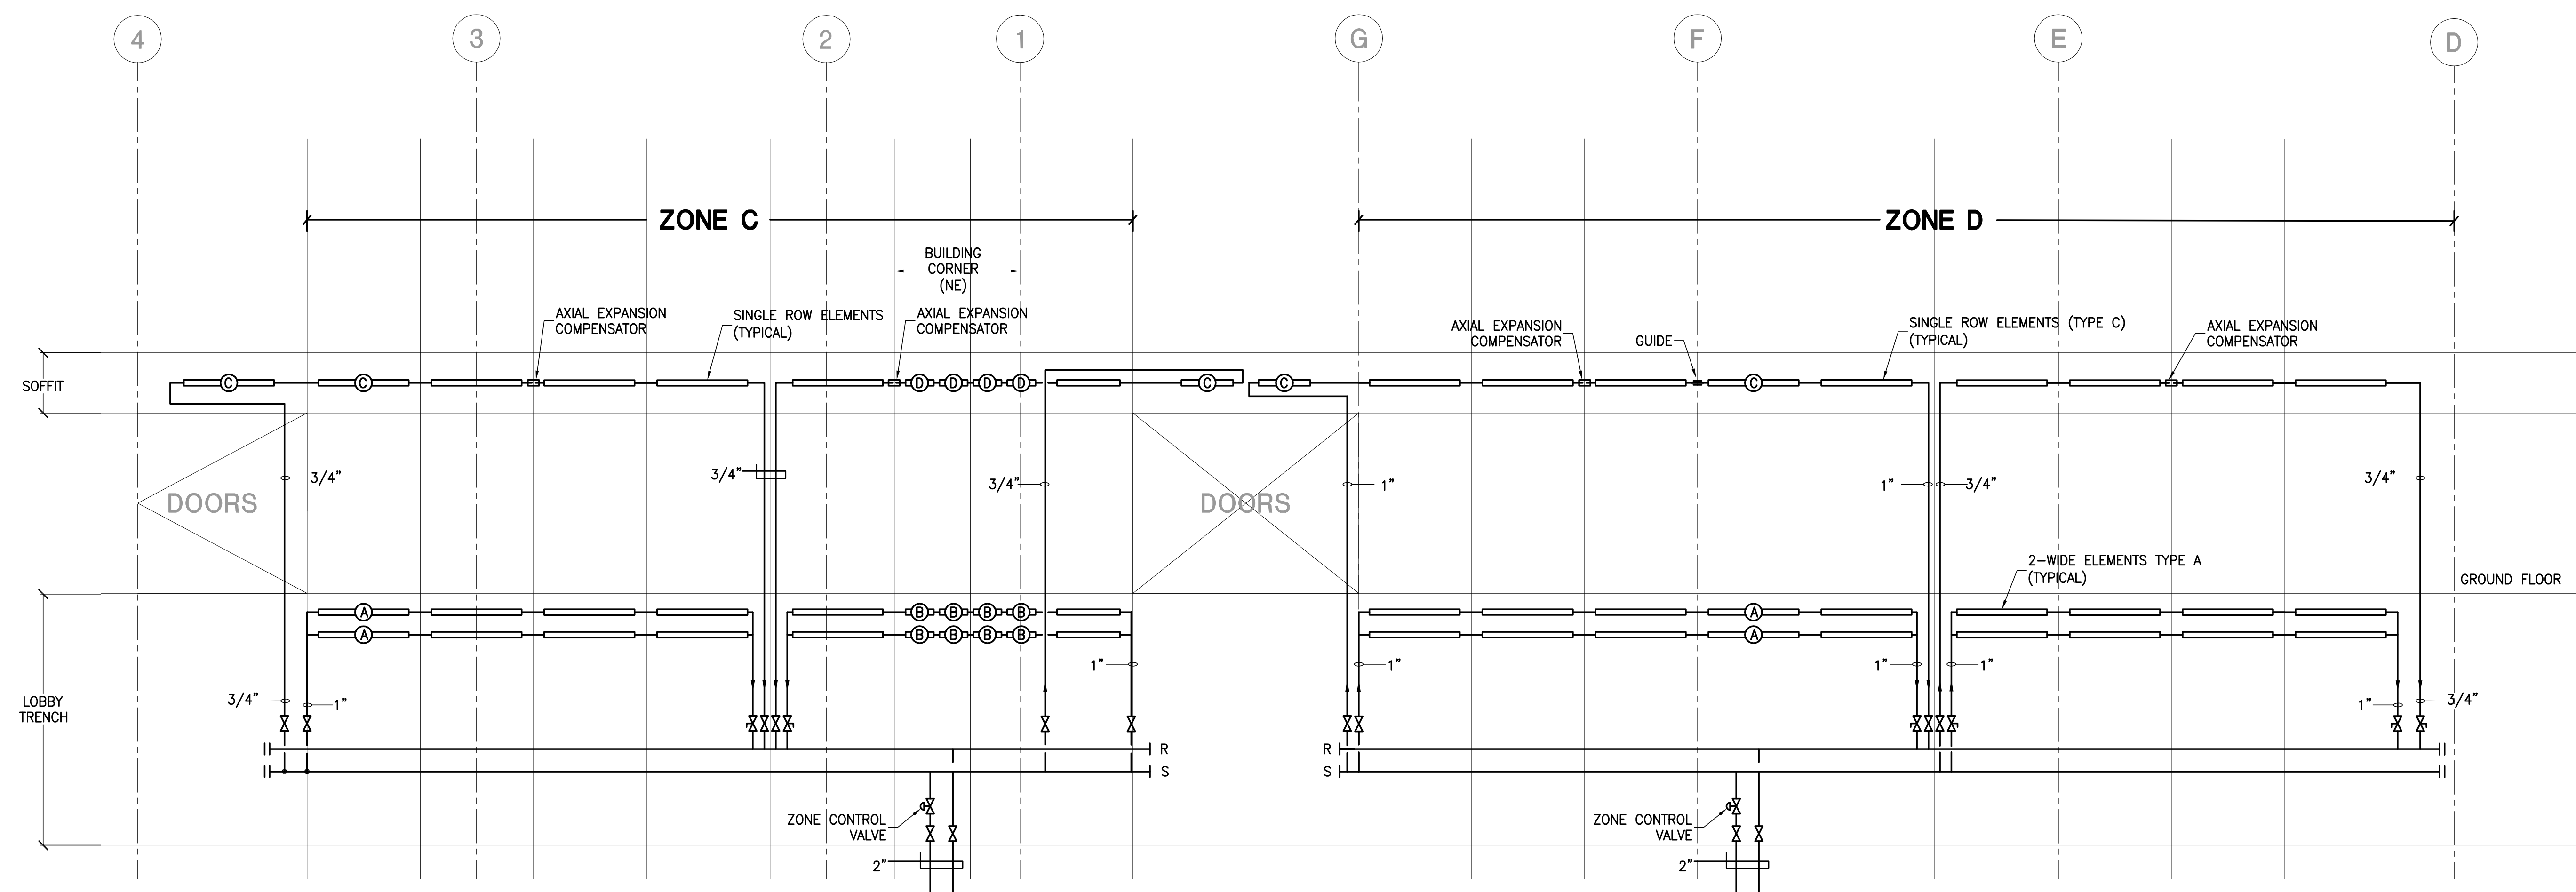
Sheet No.:

M-406

Page No.:



OFFICE HIGH ZONE HOT WATER HEATING RISERS

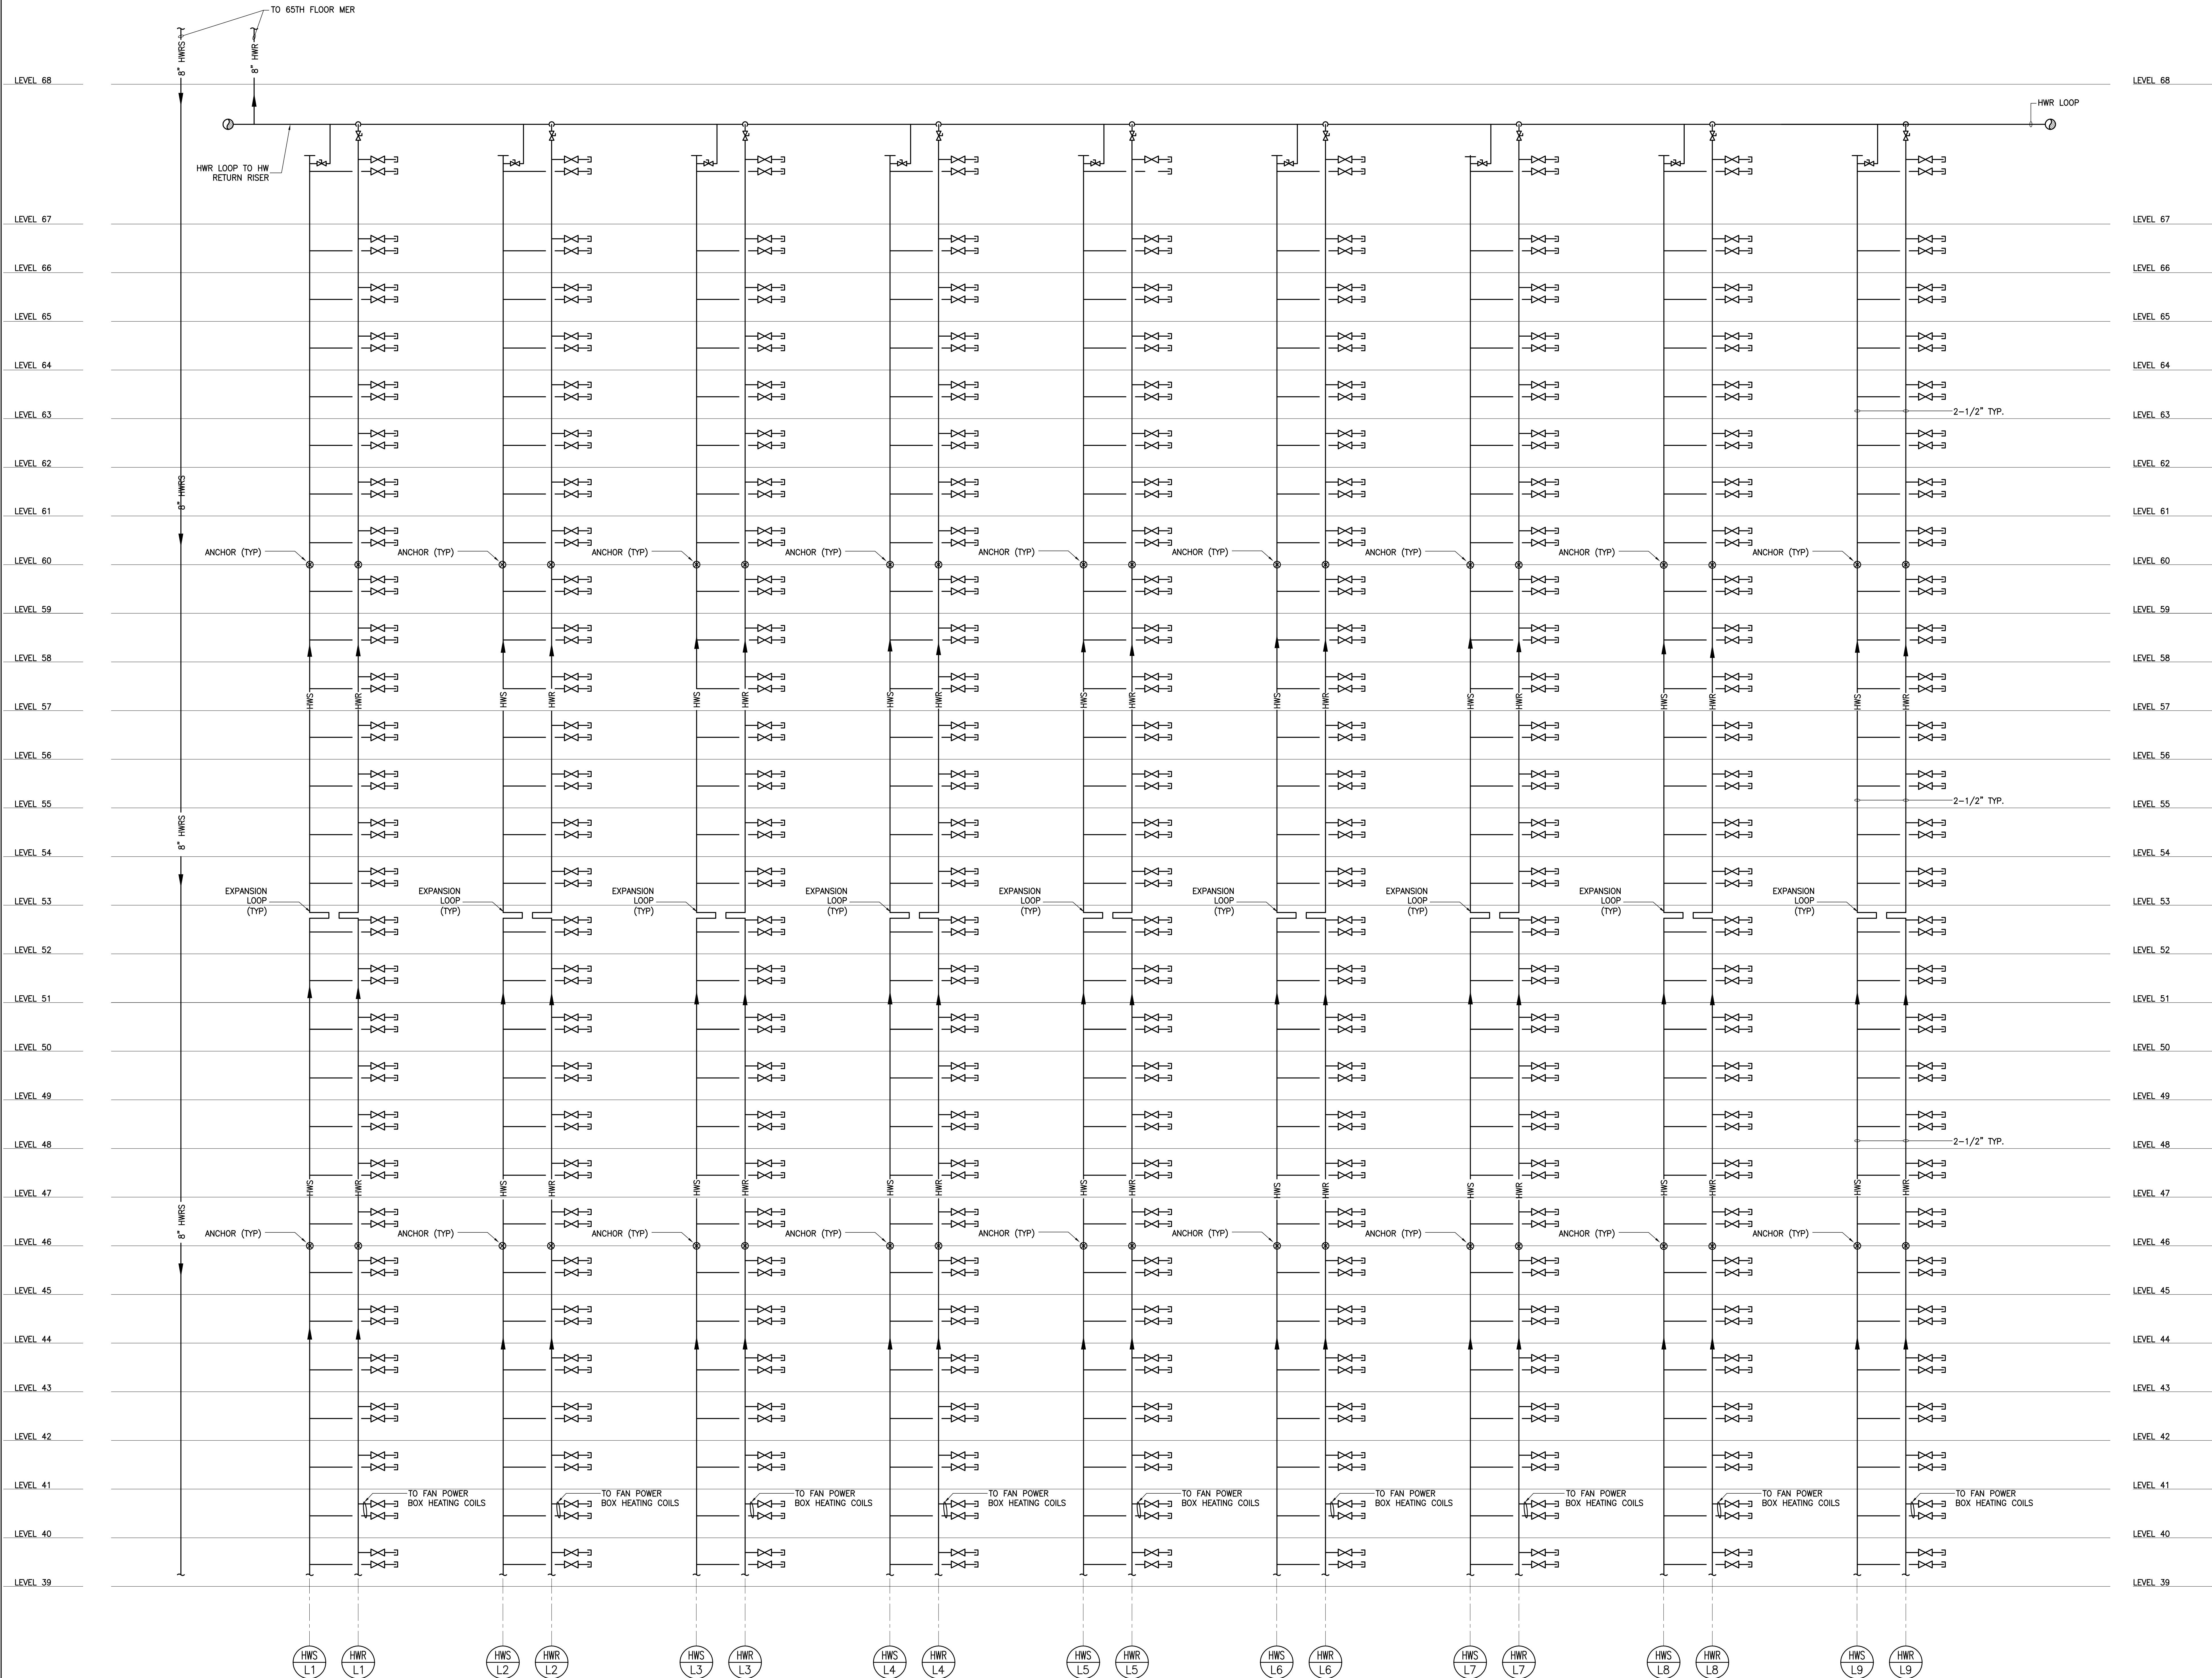

TWO ROW HOT WATER FINNED TUBE PIPING DETAIL

NOTES:
1. REFER TO PLANS FOR QUANTITY AND ORIENTATION OF FINNED TUBE ROWS.

CONVECTOR ELEMENTS									
DESIGNATION	CONVECTOR ELEMENT FINNED LENGTH PER ROW	TUBE SIZE (N.)	ELEMENT SIZE (N.)	FIN THICKNESS (N.)	FINS PER FOOT	PERFORMANCE RATING PER ACTIVE FINNED LENGTH (BTU/H/°F) @ 170°F AWT @ 70°F EAT			
						BARRE ELEMENTS (2 WIDE)	WALL MOUNTED WITHIN SOFFIT (SINGLE)	RECESSED TRENCH (2 WIDE)	
A	8"-0"	1	4-1/4" x 4-1/4"	0.02	50	—	1350	—	TBD
B	3"-0"	1	4-1/4" x 4-1/4"	0.02	50	—	1350	—	TBD
C	8"-0"	1	4-1/4" x 4-1/4"	0.02	50	750	—	TBD	—
D	3"-0"	1	4-1/4" x 4-1/4"	0.02	50	750	—	TBD	—

SHEET NOTES



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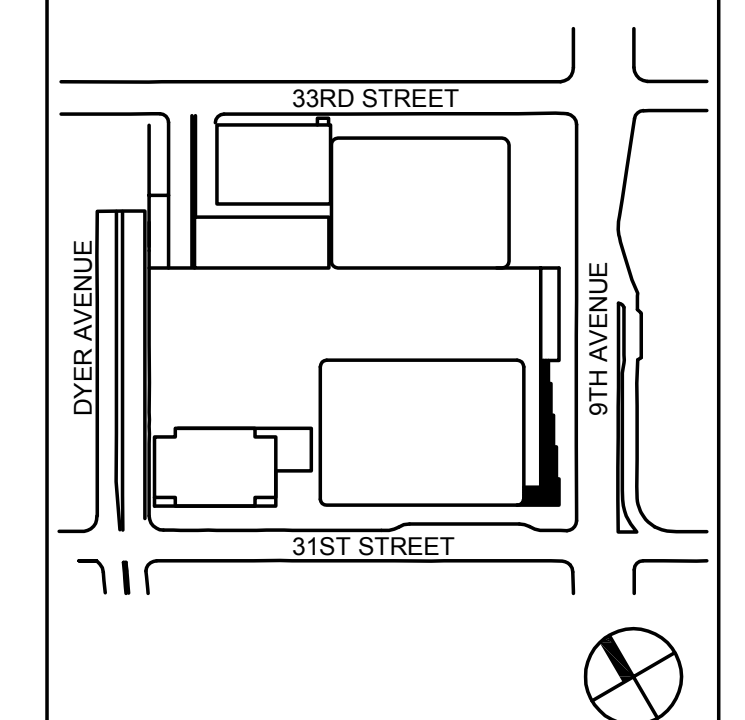
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850 Woodlawn Road West, Suite 100

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No.	Date	Description

Sheet Name:

MECHANICAL
HOT WATER RISER
DIAGRAM
LOBBY
SHEET 3

Project No.: 14830.A.000	B-SCAN Sheet No.: M-407.00
Date: 20 JUN 2014	Sheet No.: M-407
Scale: NTS	
File No.:	Page No.:



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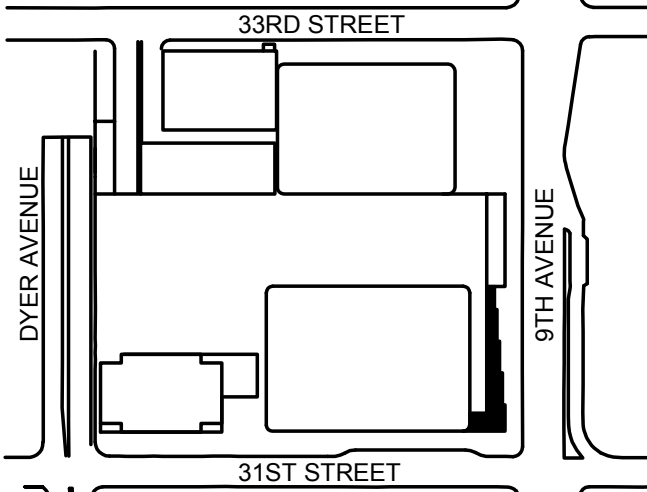
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650 Woodlawn Road West, Guelph
Ontario, Canada N1K 1S8

Key Plan:



Seal & Signature:



1	20 JUN 2014	ISSUED FOR FOUNDATION PERMIT
2	20 DEC 2013	ISSUED FOR FOUNDATION PERMIT
3	13 NOV 2013	ISSUED FOR DD PROCESSING PERMIT
4	12 JUL 2013	ISSUED FOR 50% DESIGN DEVELOPMENT
5	13 MAR 2013	ISSUED FOR RECONFIGURATION

Sheet Name:

MECHANICAL
SCHEDULE
SHEET
4 OF 6

Project No:
14830.A.000

Date:
20 JUN 2014

Scale:
1/8"=1'-0"

File No.:

B-SCAN Sheet No.:

M-503.00

Sheet No.:

M-503

Page No.:

CONSTANT / VARIABLE VOLUME BOXES

(TITUS TYPE 'DES' AS STD)

BOX SIZES (SEE DWGS)	MAXIMUM SET POINT CFM RANGE		MIN. SET POINT OF CFM SHOWN ON PLANS	MIN. SP @ BOX MAX. CFM	INLET AND OUTLET SIZES		BOXES WITH HEATING COIL							SOUND TRAP		REMARKS	
	LOW	HIGH			IN	OUT	ENTERING AIR TEMP. (°F)	LEAVING AIR TEMP.(°F)	ENTERING WATER TEMP.(°F)	LEAVING WATER TEMP.(°F)	No. OF ROWS	CFM	MAX. COIL PRESSURE DROP (PSIG)	MIN. SP @ BOX @ MAX CFM (BOX + COIL)	IAC TYPE AND DIMENSIONS (WidthxL)		PRESS. DROP INCH. WG.
7	90	500	65	0.14	7"ø	12x10	55	VARIES	140	VARIES	1	SEE NOTES	.10	.19	3HL 12x12x36	.01	
8	245	800	120	0.20	8"ø	12x10	55	VARIES	140	VARIES	1	SEE NOTES	.10	.27	3HL 18x12x36	.01	
10	385	1000	195	0.12	10"ø	14x12.5	55	VARIES	140	VARIES	1	SEE NOTES	.10	.19	3HL 18x12x36	.02	
12	550	1500	280	0.15	12"ø	16x15	55	VARIES	140	VARIES	1	SEE NOTES	.10	.22	5HL 24x12x60	.04	
14	880	2000	400	0.16	14"ø	20x17.5	55	VARIES	140	VARIES	1	SEE NOTES	.10	.22	5HL 24x12x60	.06	
16	1000	2500	530	0.15	16"ø	24x18	55	VARIES	140	VARIES	1	SEE NOTES	.10	.22	5HL 30x12x60	.06	

NOTES:

- REFER TO SPECIFICATIONS FOR ACOUSTICAL PERFORMANCE.
- ALL COILS SHALL BE ONE ROW UNLESS NOTED, REFER TO PLANS FOR LOCATIONS. HEATING PERFORMANCE OF ALL COILS SHALL BE BASED ON 2.0 GPM FLOW RATE.
- ALL COILS SHALL BE SUITABLE FOR A MINIMUM OF 250 PSIG. WATER WORKING PRESSURE.
- V = VARIABLE VOLUME
VR = VARIABLE VOLUME WITH HEATING COIL
C = CONSTANT VOLUME
CR = CONSTANT VOLUME WITH HEATING COIL
- EACH VAV BOX SHALL BE PROVIDED WITH DUCT MOUNTED SOUND TRAP AS SCHEDULED ABOVE.
- ALL BOXES SHALL BE PROVIDED WITH BOTTOM ACCESS DOOR, FOR INTERNAL ACCESS TO CONTROLS & TO HEATING COIL.

CONSTANT VOLUME REGULATORS

(TITUS TYPE AQCV/DQCV AS STD.)

BOX SIZES (SEE DWGS)	CFM RANGE		DAMPER SIZE (IN)	MIN. SP @ BOX MAX. CFM	DISCHARGE NC RATING FOR 1/2" INLET PRESSURE	RADIANT NC RATING FOR 2" WG INLET PRESSURE	REMARKS
	LOW	HIGH					
F	250	500	14x8	0.155	26	35	
H	435	1000	18x10	0.172	22	37	
K	725	2000	20x14	0.165	22	38	
M	970	3500	22x16	0.165	25	43	
N	1220	5000	24x18	0.165	26	44	
P	1860	6000	30x20	0.162	24	42	
R	2750	8000	40x20	0.152	24	42	
R	8001	10,000	40x20	0.210	25	43	

NOTES:

- THE 5000 CFM SERVICE ELEVATOR LOBBY PRESSURIZATION CVR SHALL HAVE A MAXIMUM SIZE OF 16"Wx36"H AS INDICATED ON PLANS.
- THE MECHANICAL CONTRACTOR SHALL PROVIDE A PLENUM LENGTH OF 5'-0" OF STRAIGHT DUCT RUN DOWN STREAM OF EACH CVR.

FAN POWERED TERMINAL UNITS

(TITUS TYPE DTQS STD)

BOX SIZES (SEE DWGS)	MAX. SET POINT CFM RANGE OF VALVE 49°F EAT		MINIMUM SET POINT CFM OF VALVE	SET POINT OF FAN		MIN. MOTOR H.P. HIGH SPEED	DISCHARGE S.P. OF DOWNSTREAM OF FPTU (INCLUDING HEATING COIL)	INLET SIZES	BOXES WITH HEATING COIL						SOUND TRAP		REMARKS	
	LOW	HIGH		LOW	OFFICE HIGH				TRADING	ENTERING AIR TEMP. (°F)	LEAVING AIR TEMP. (°F)	ENTERING WATER TEMP. (°F)	LEAVING WATER TEMP. (°F)	GPM	MAX. COIL PRESSURE DROP (FT. H ₂ O)	MIN. SP @ BOX (COIL & BOX)		ELECTRICAL CHGR. (VOLTS/PHASE HERTZ)
2	145	335	145	150	400 535	1/6	.40	8"ø	60	VARIES	170	140	SEE NOTE 2	.66 .08	.277/1/60	3HL 12x12x36	.01	
3	200 336	480 900	160 260	401	1050 1150	1/4	.40	8"ø 10"ø	60	VARIES	170	140	SEE NOTE 2	.18 .20 .26	.277/1/60	3HL 18x12x36	.03	
5	801	1130	375	951	1350 1600	1/3	.40	12"ø	60	VARIES	170	140	SEE NOTE 2	.43 .16	.277/1/60	5HL 24x12x60	.04	
6	1131	1350	470	1351	1650 2000	3/4	.40	14"ø	60	VARIES	170	140	SEE NOTE 2	.93 .22	.277/1/60	5HL 24x12x60	.06	

NOTES:

- REFER TO FLOOR PLANS FOR ACTUAL QUANTITY OF FAN POWERED BOXES WITH AND WITHOUT HOT WATER HEATING COILS AND UNIT LEFT/RIGHT HAND ARRANGEMENT.
- ALL COILS SHALL BE ONE ROW UNLESS NOTED, REFER TO PLANS FOR LOCATIONS. COILS ON FLOORS 15 THRU 69 SHALL HAVE 2.5 GPM FLOW RATE.
- KEY TO SYMBOL: FAN CFM
(MAX. VALVE CFM)
(MIN. VALVE CFM)
- REFER TO SPECIFICATIONS FOR ACOUSTICAL PERFORMANCE.
- FAN POWERED TERMINAL UNITS BASED ON MAXIMUM OF 1.5 INCHES INLET STATIC PRESSURE.
- ALL COILS SHALL BE SUITABLE FOR A MINIMUM OF 250 PSIG. WATER WORKING PRESSURE.
- FPB = FAN POWERED BOX
FPBH = FAN POWERED BOX WITH HEATING COIL
- EACH FPB BOX SHALL BE PROVIDED WITH DUCT MOUNTED SOUND TRAP AS SCHEDULED ABOVE.
- ALL FANS PROVIDED WITH THE FPB'S SHALL BE SET TO PROVIDE A MINIMUM ESP OF .4 INCH W.G. AT THE MAXIMUM AIRFLOW RATES NOTED IN THE SCHEDULE.
- ALL FAN POWERED BOXES LOCATED BELOW THE 15TH FLOOR (LEVEL B4 THRU 14) SHALL BE SELECTED FOR 140°F EWT AND 120°F LWT. MAXIMUM WATER FLOW FOR THE LARGEST SIZE BOX SHALL BE 2.0 GPM.

NOTES:
1. UNLESS OTHERWISE NOTED THERMOSTATS FOR ALL UNIT HEATERS SHALL BE UNIT MOUNTED

[illegible]

MECHANICAL
SCHEDULE
SHEET
5 OF 6



MANHATTAN WEST:
NORTH TOWER
375 Ninth Avenue, New York, NY 10001

Client
Brookfield

Brookfield Place
250 Vesey Street, 15th Floor, New York, NY 10281

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Skidmore, Owings & Merrill LLP
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MEP Engineering
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Sustainable Design
Viridian Energy & Environmental
50 Washington Street, Norwalk, CT 06854

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475 10th Avenue, New York, NY 10018

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Vibration Consultant
Wilson, Uhrig & Associates, Inc.
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Code Consultant
Code Consultants Professional Engineers PC
215 West 40th Street, 15th Floor, New York, NY 10018

Facade Maintenance Consultant
Entek Engineering LLC
166 Ames Street, Hackensack, NJ 07601

Wind Tunnel Consultant
Rowan Williams Davies & Irwin Inc.
650 Woodlawn Road West, Guelph
Ontario, Canada N1K 1S8

Key Plan:
33RD STREET
31ST STREET
DYER AVENUE
STANLEY AVENUE

Seal & Signature:

Project No.: 14830.A.000
Date: 20 JUN 2014
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File No.:

B-SCAN Sheet No.: M-602.00
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MECHANICAL
FUEL OIL FLOW
DIAGRAM

Project No.: 14830.A.000
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DIAGRAM

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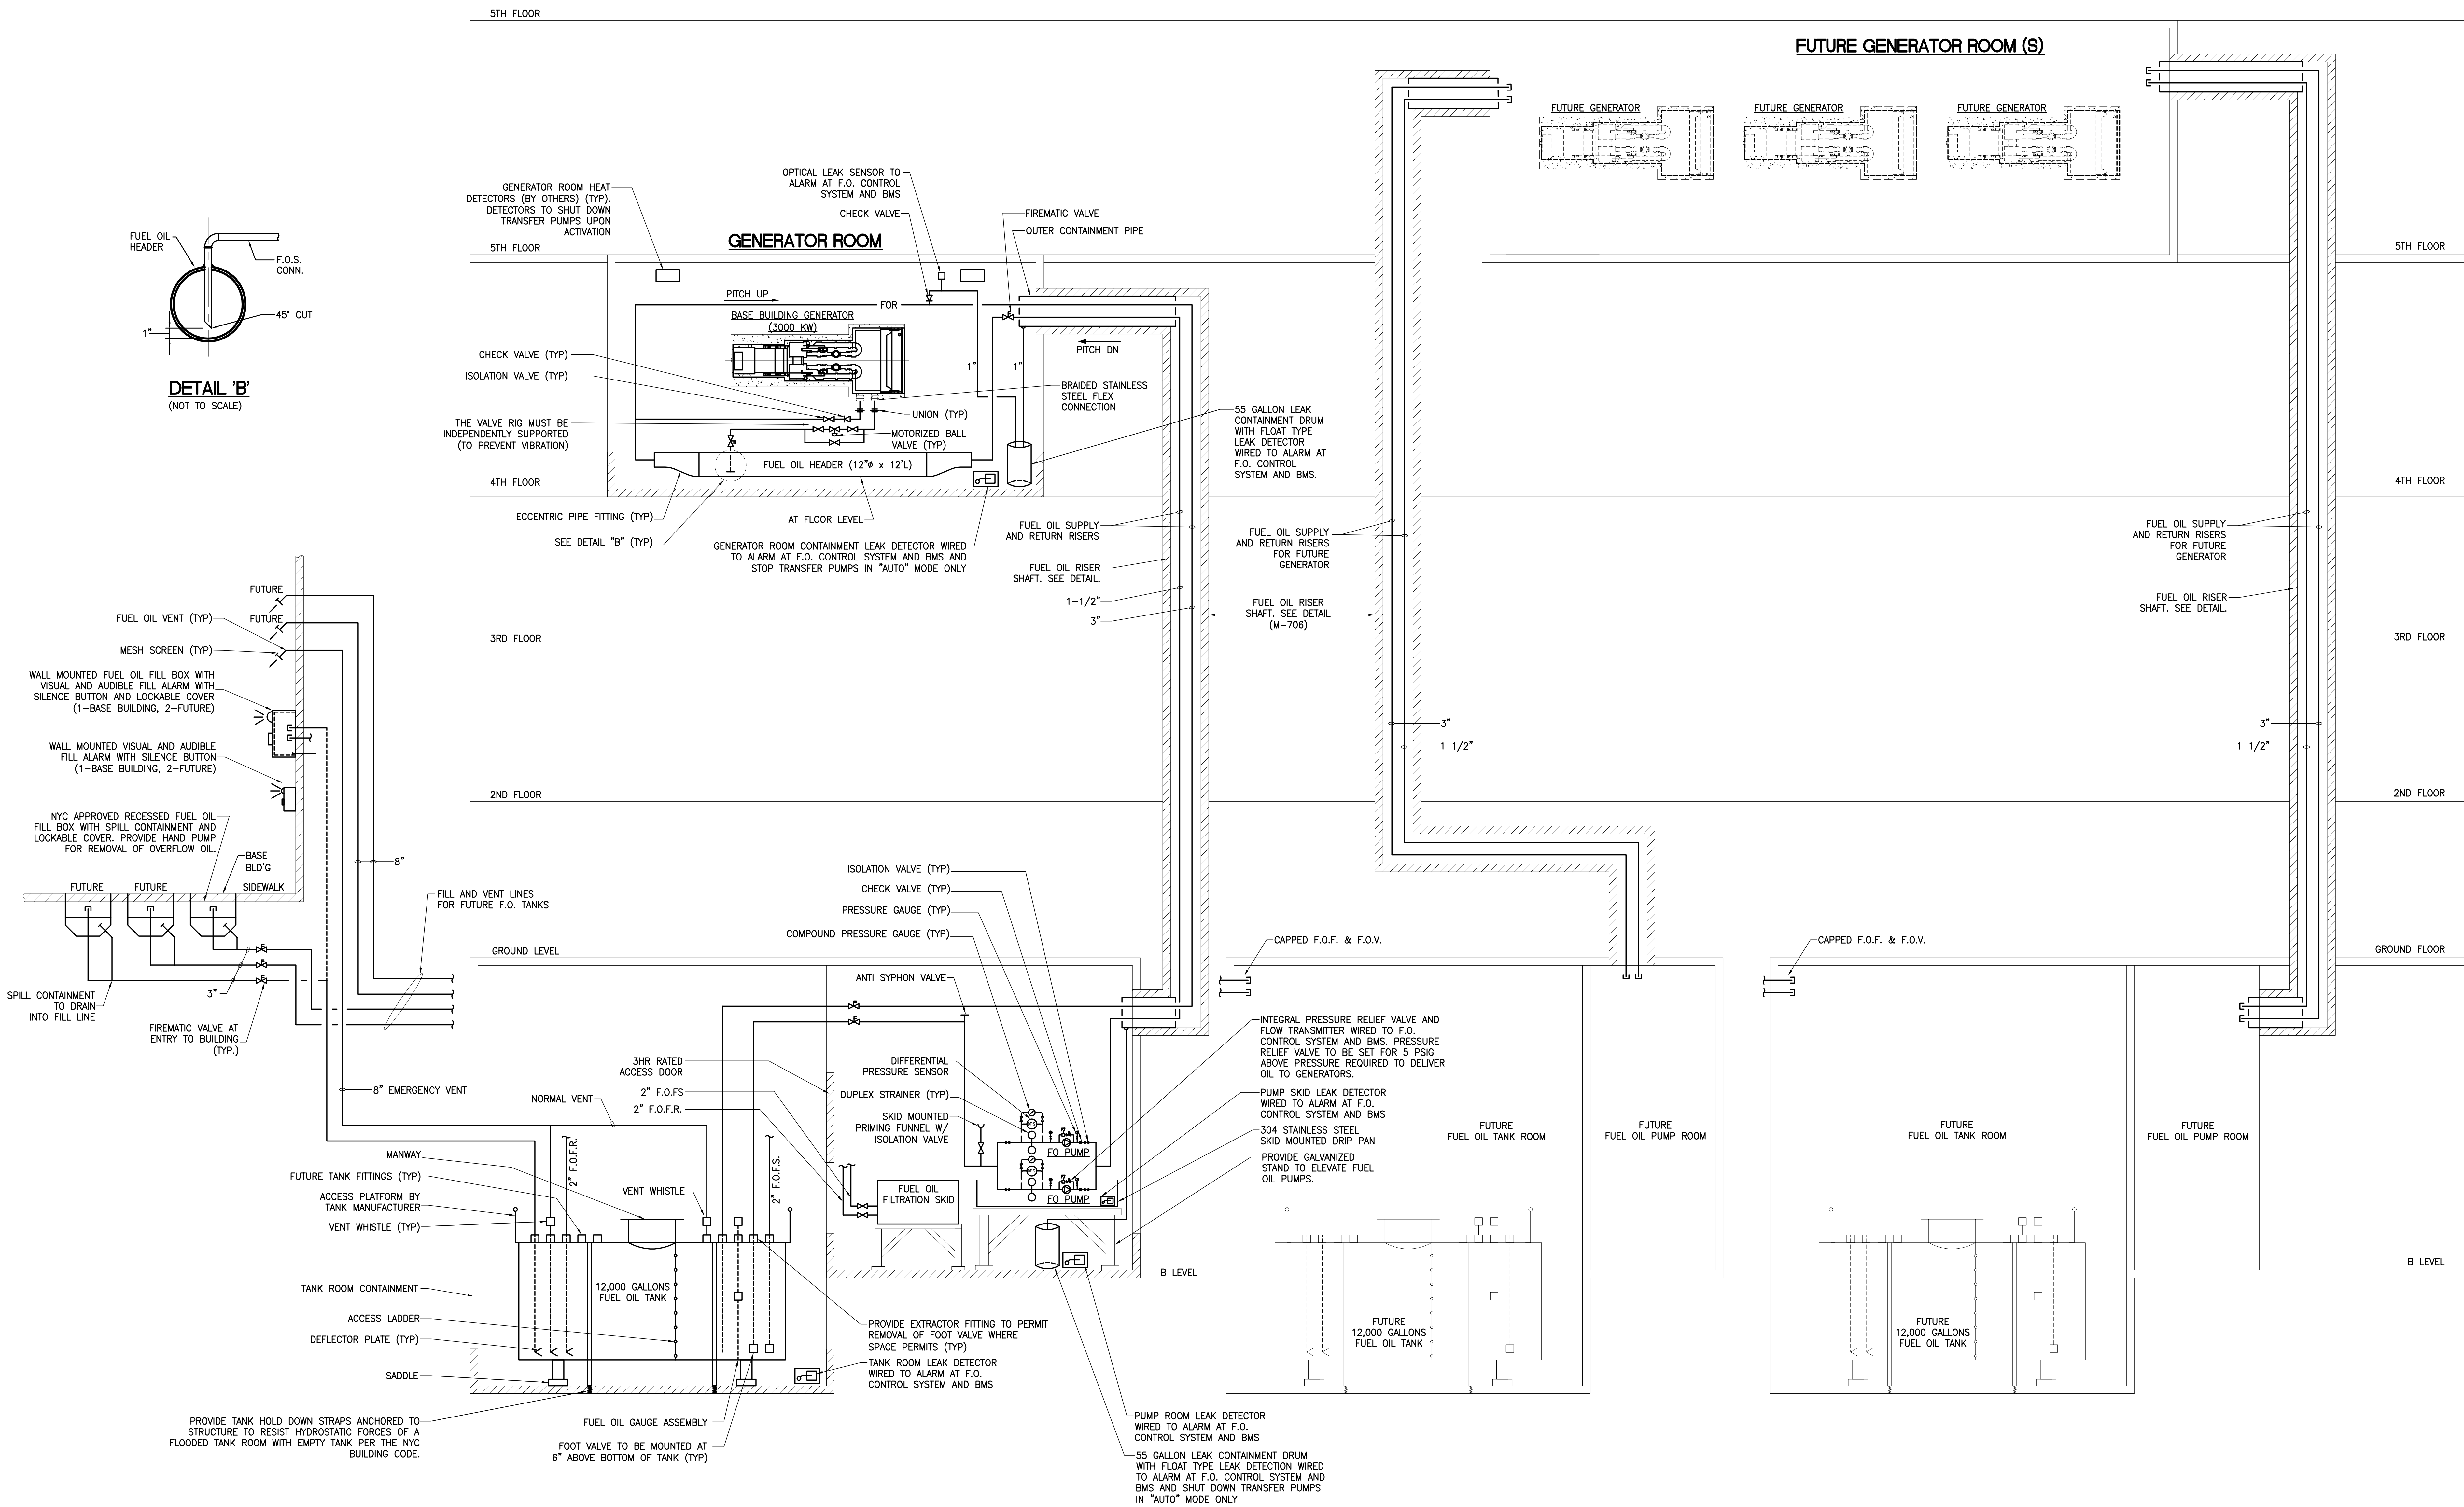
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FUEL OIL FLOW
DIAGRAM


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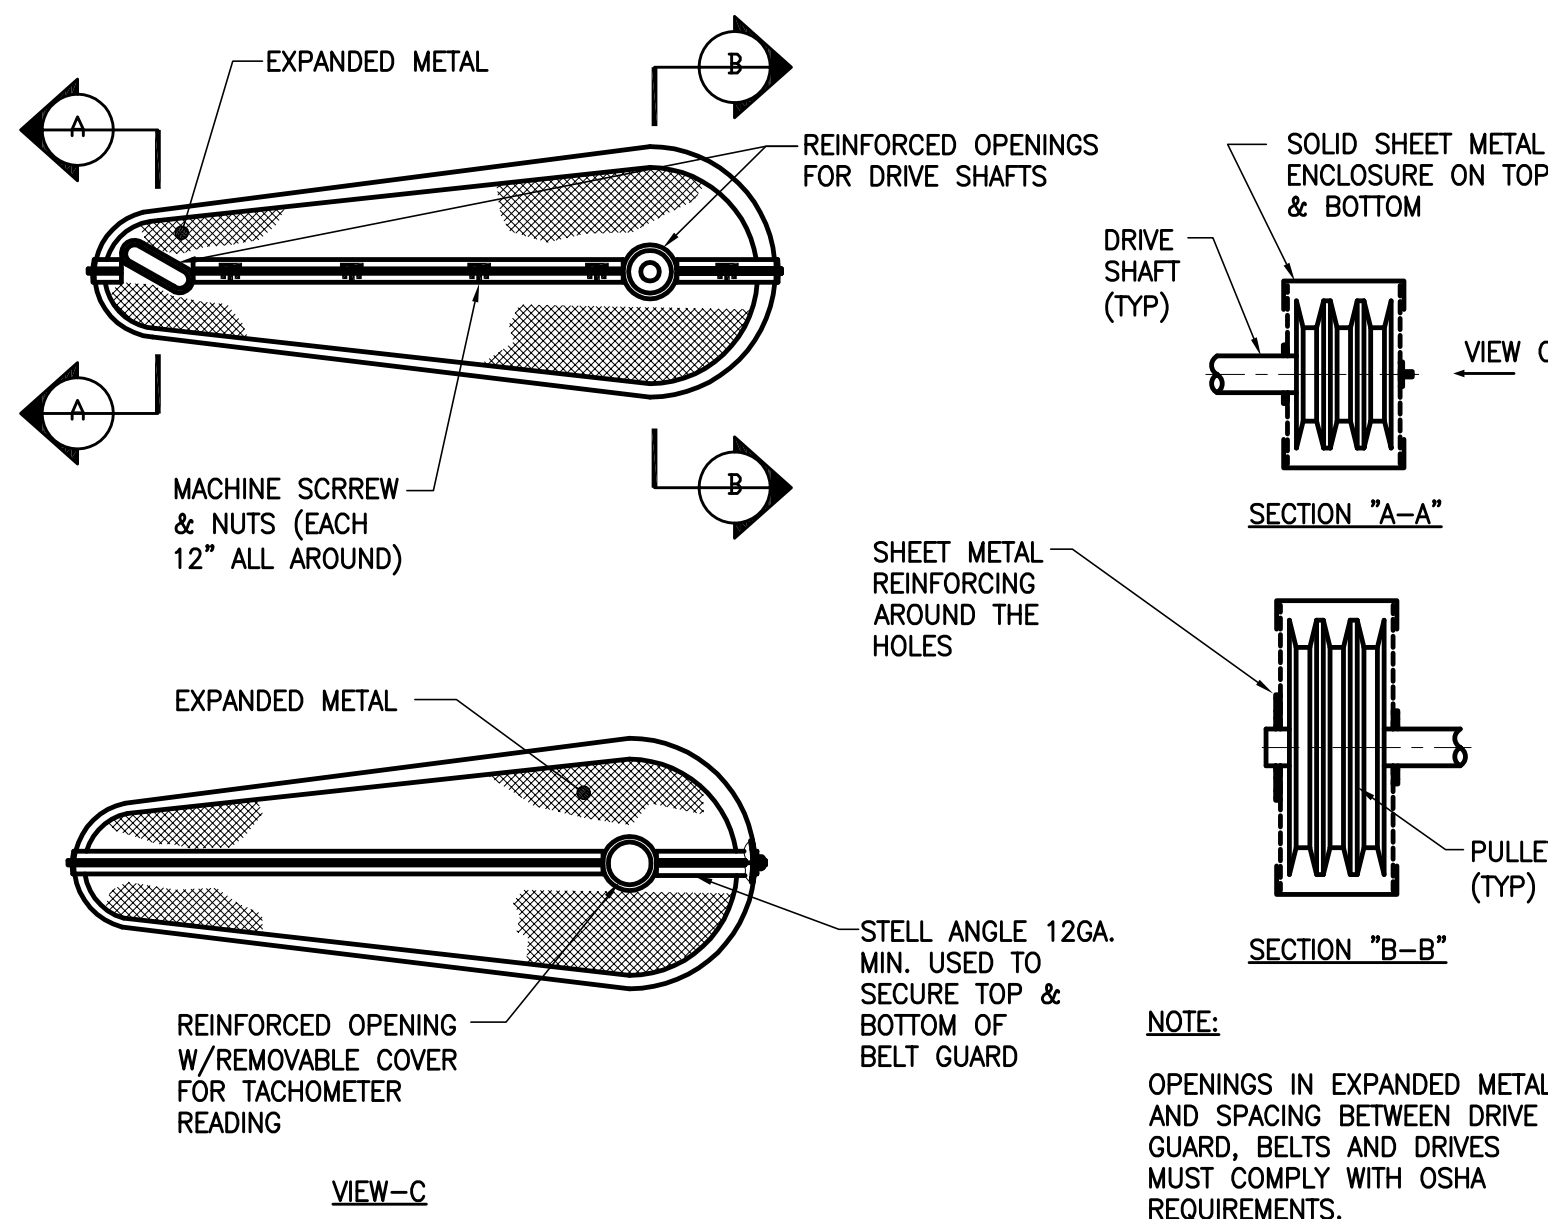
MECHANICAL
FUEL OIL FLOW
DIAGRAM




- NOTES:
1. ALL F.O. PIPING FROM THE F.O. PUMP ROOM TO THE UNDERSIDE OF THE MASONRY F.O. SHAFTS AND FROM THEIR RESPECTIVE MASONRY SHAFTS TO THE GENERATOR EQUIPMENT ROOM SHALL BE PIPE-WITHIN-A-PIPE CONSTRUCTION. IN ADDITION, THE PIPING SHALL BE ENCLOSED WITHIN A TWO (2) HOUR RATED ENCLOSURE (AS DETAILED ABOVE).
 2. EACH SET OF F.O. SUPPLY AND RETURN RISERS SHALL BE INSTALLED WITHIN SEPARATE DEDICATED 4" MASONRY RISER SHAFTS.
 3. ALL FUEL OIL ISOLATION, BALANCING, BRIDGE AND/OR FIREMATIC VALVES SHALL BE PROVIDED WITH INTEGRAL TAMPER SWITCHES, WIRED TO THE BMS SYSTEM FOR ANNUNCIATION.
 4. ALL LEAK DETECTORS SHALL BE OPTICAL TYPE AND SHALL BE CAPABLE OF DISTINGUISHING BETWEEN OIL AND WATER.




TYPICAL CENTRIFUGAL FAN BASE MOUNTING DETAIL

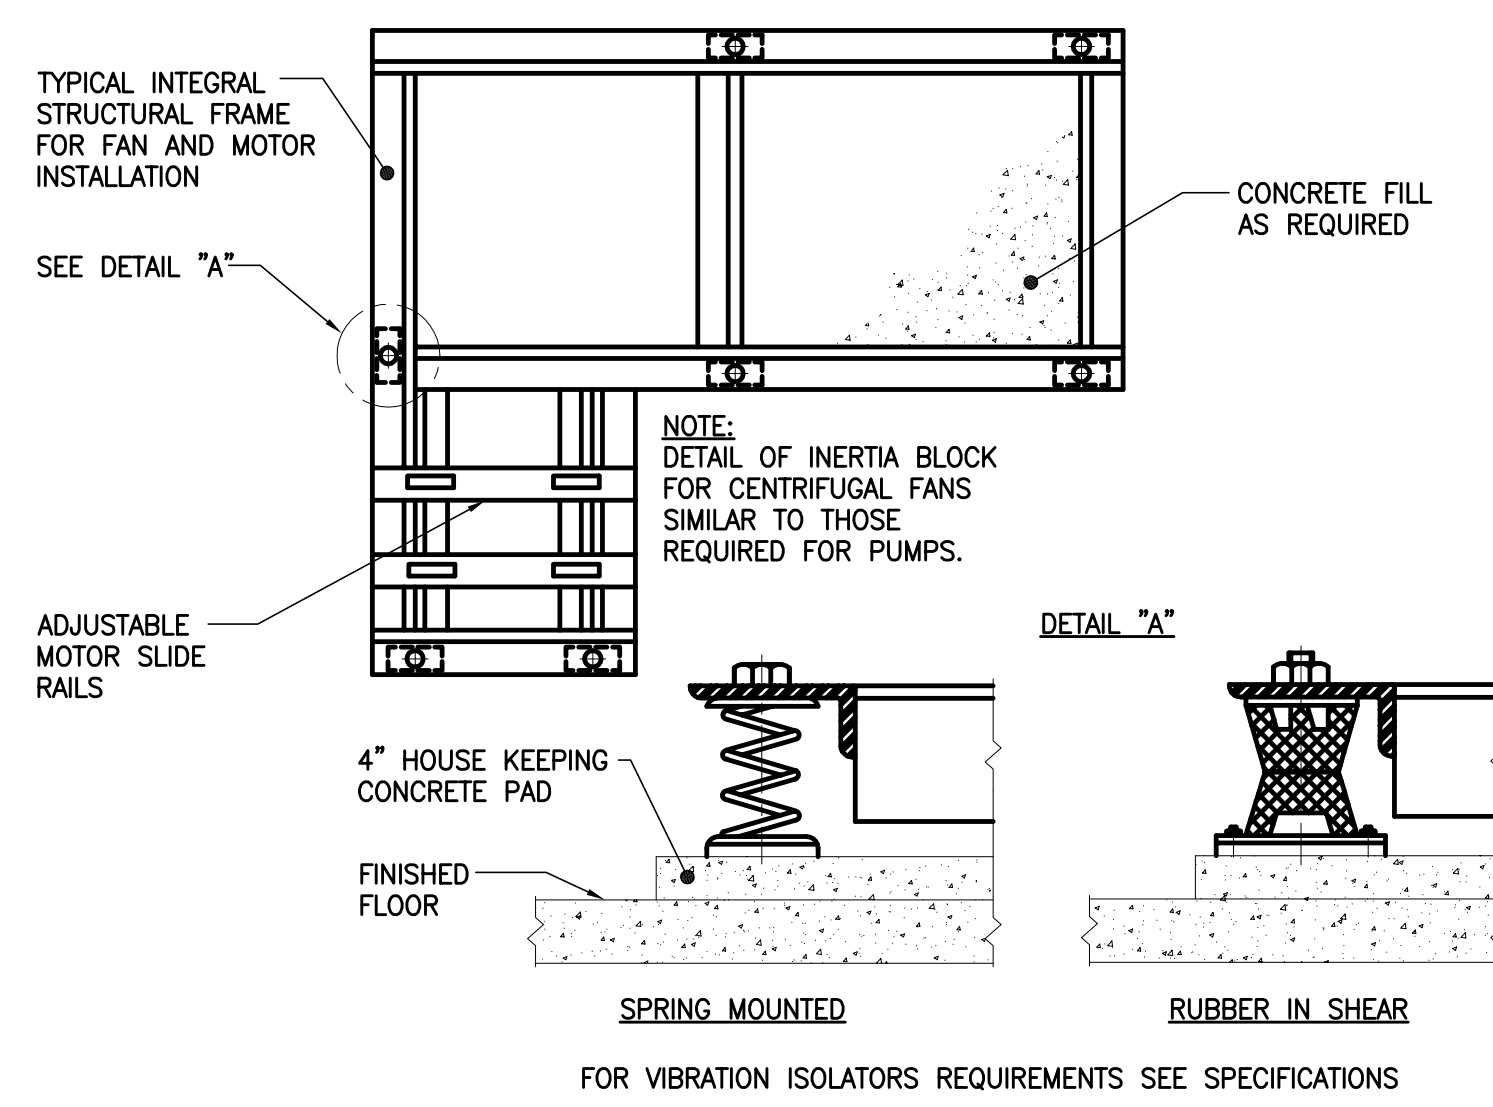


DRIVE GUARD DETAILS

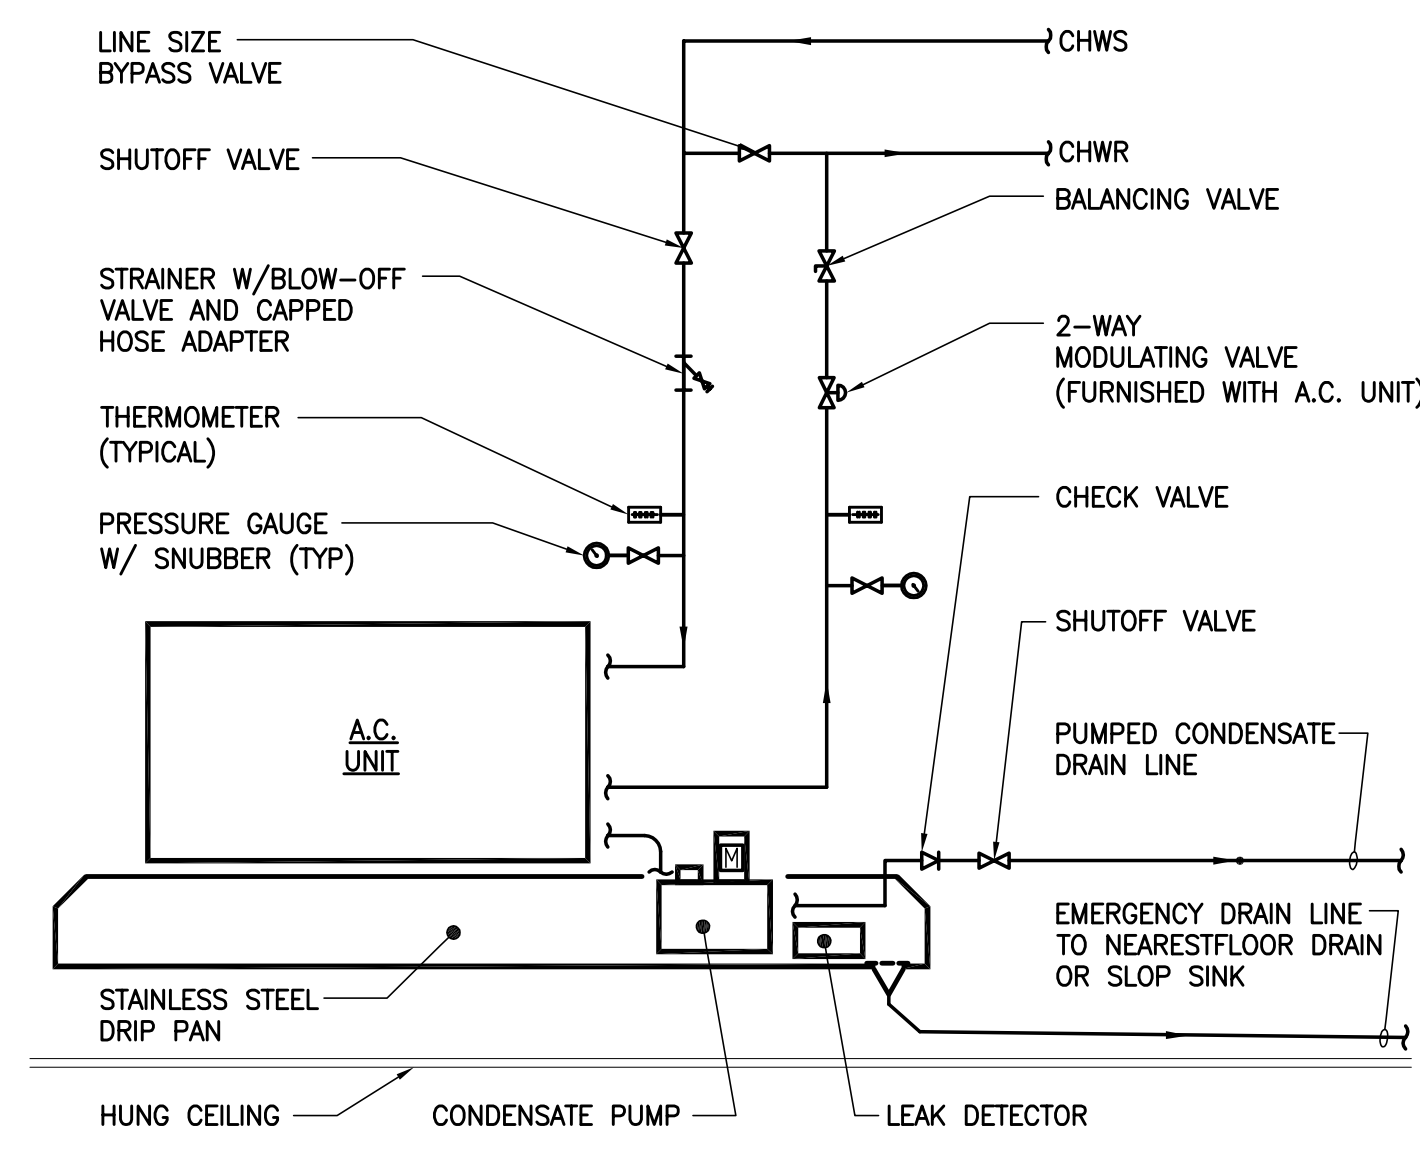


CEILING MOUNTED A.C. UNIT, CHILLED WATER PIPING CONNECTION DETAIL

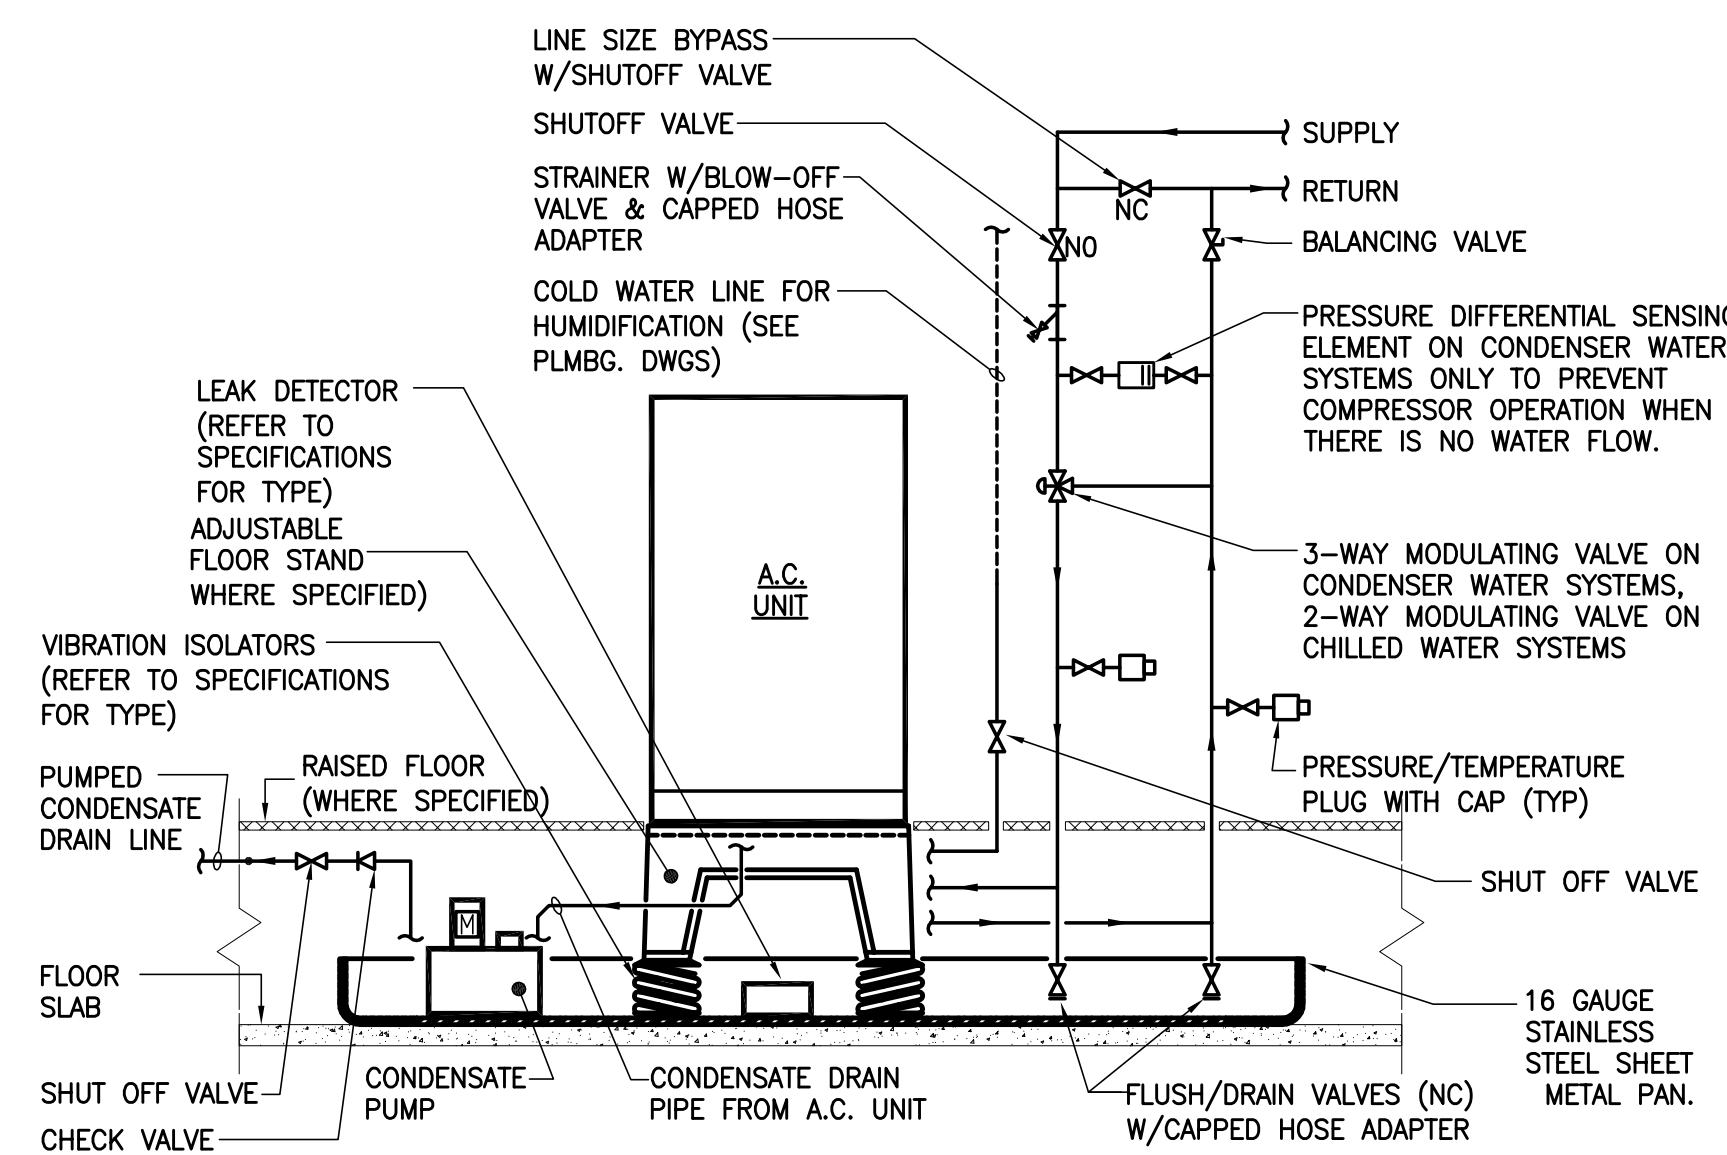


FLOOR MOUNTED A.C. UNIT, OVERHEAD WATER PIPING CONNECTION DETAIL

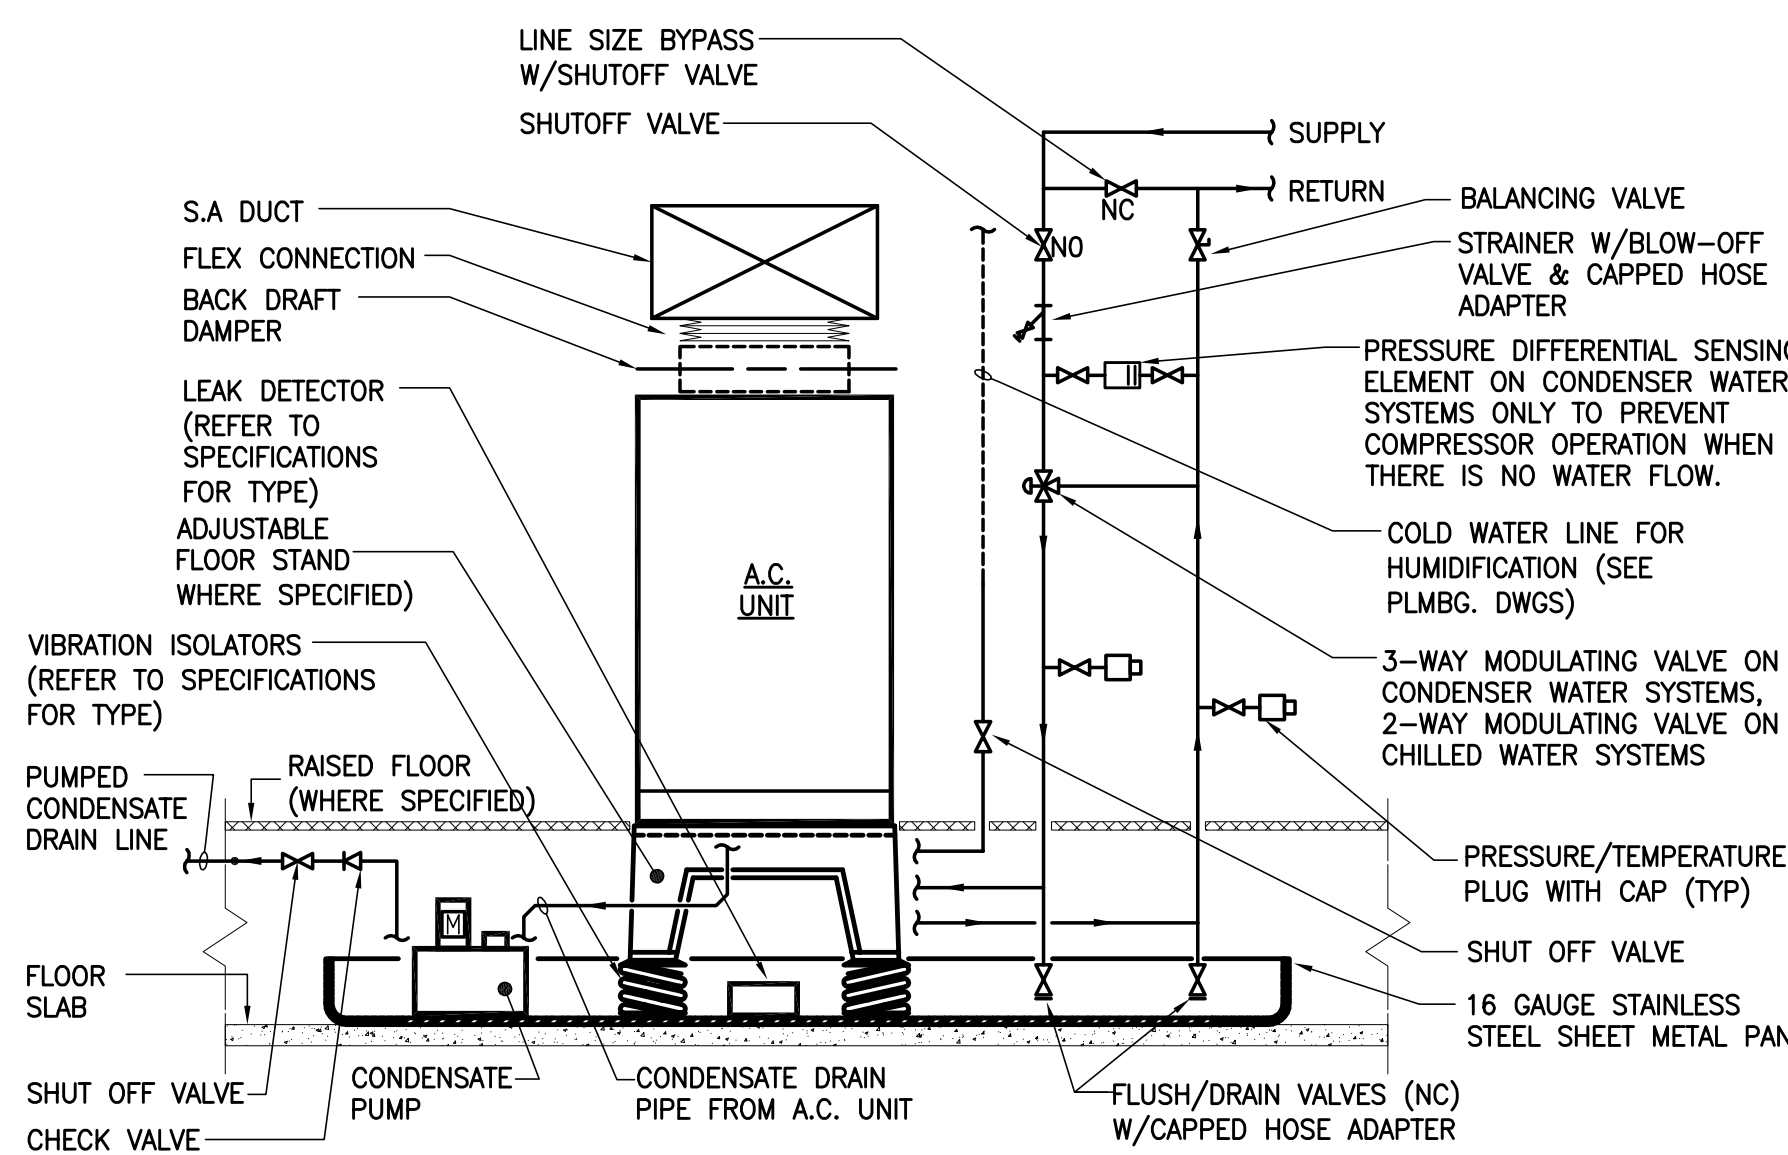


FLOOR MOUNTED TOP DISCHARGE A.C. UNIT, OVERHEAD WATER PIPING CONNECTION DETAIL

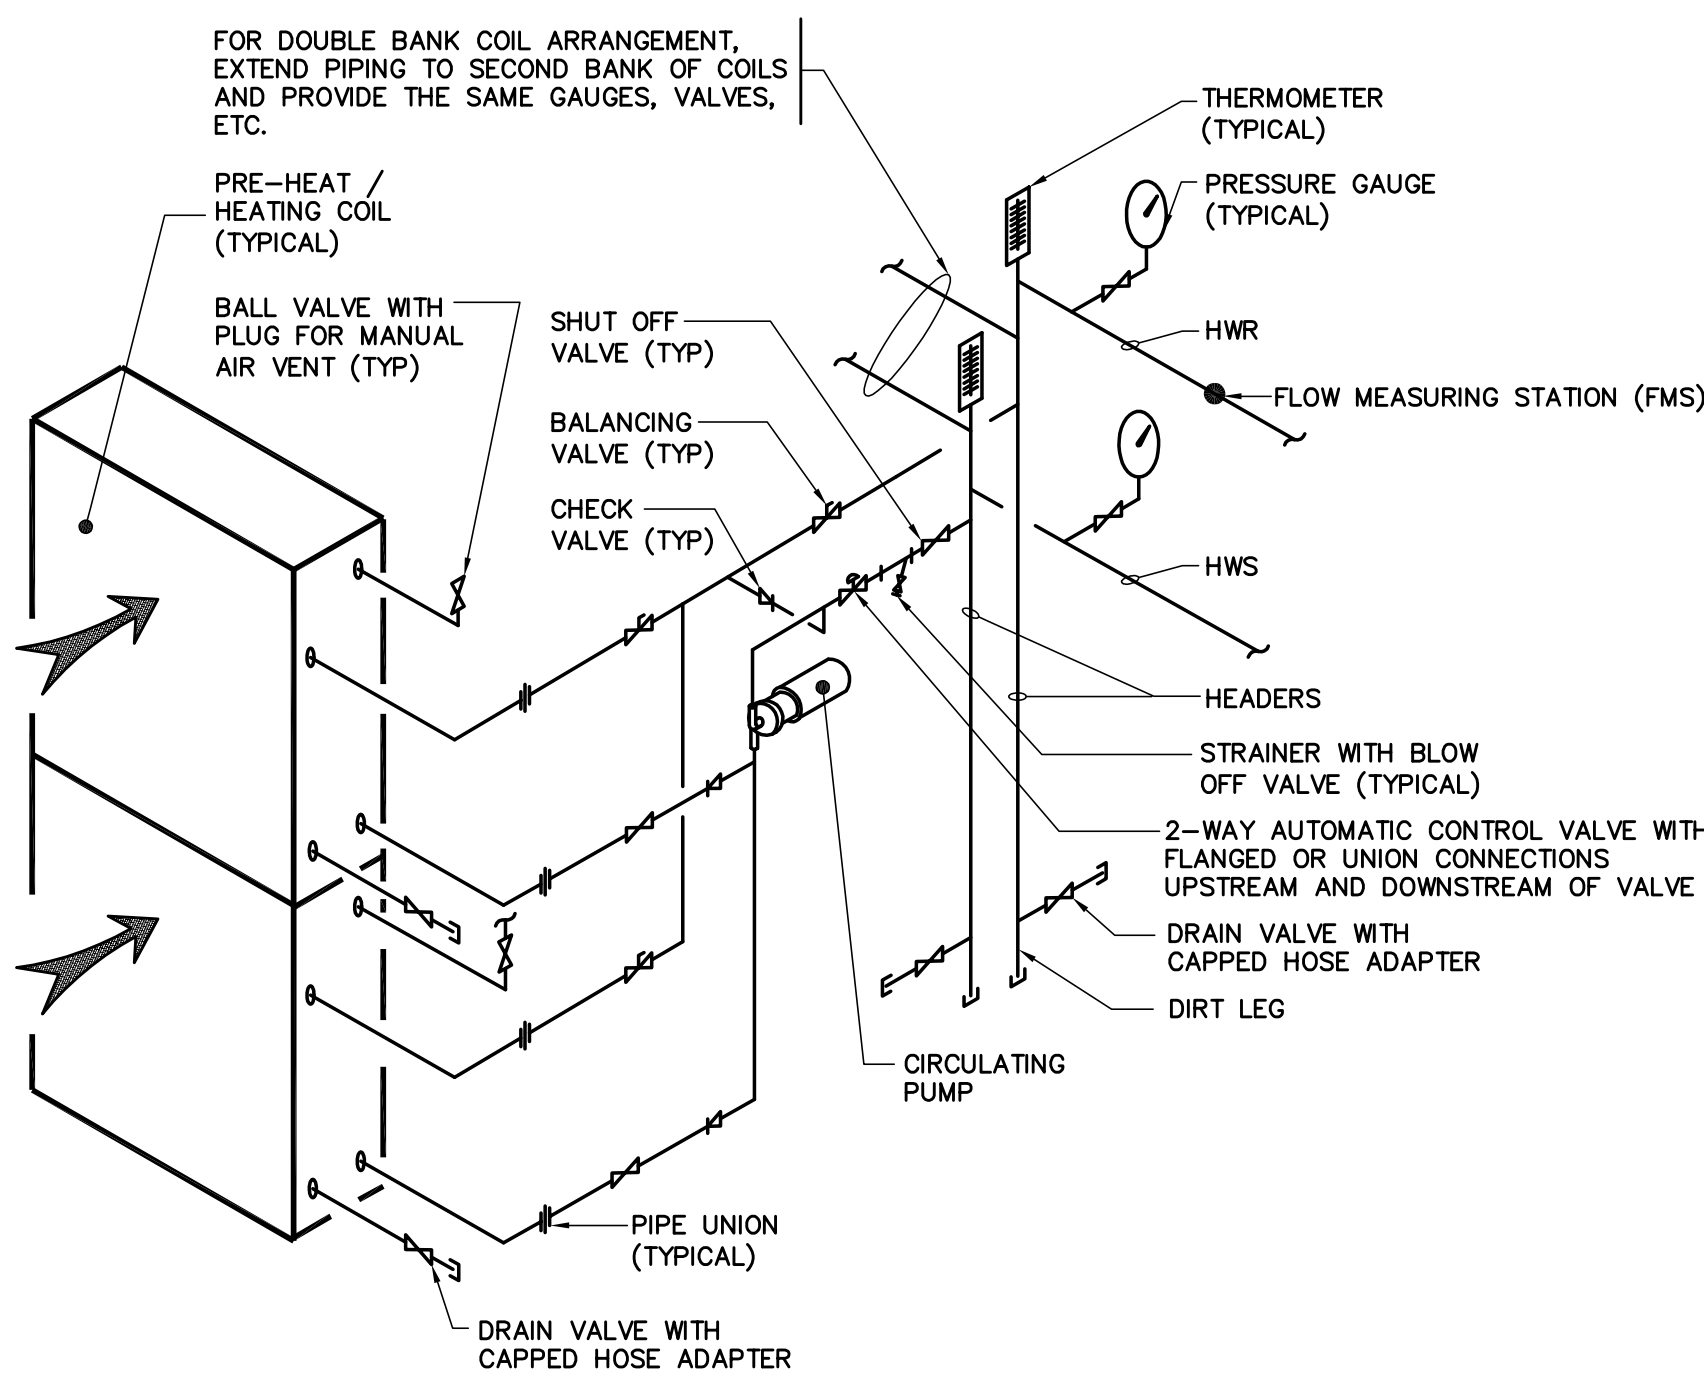


HOT WATER PRE-HEAT / HEATING COIL PIPING CONNECTION DETAIL

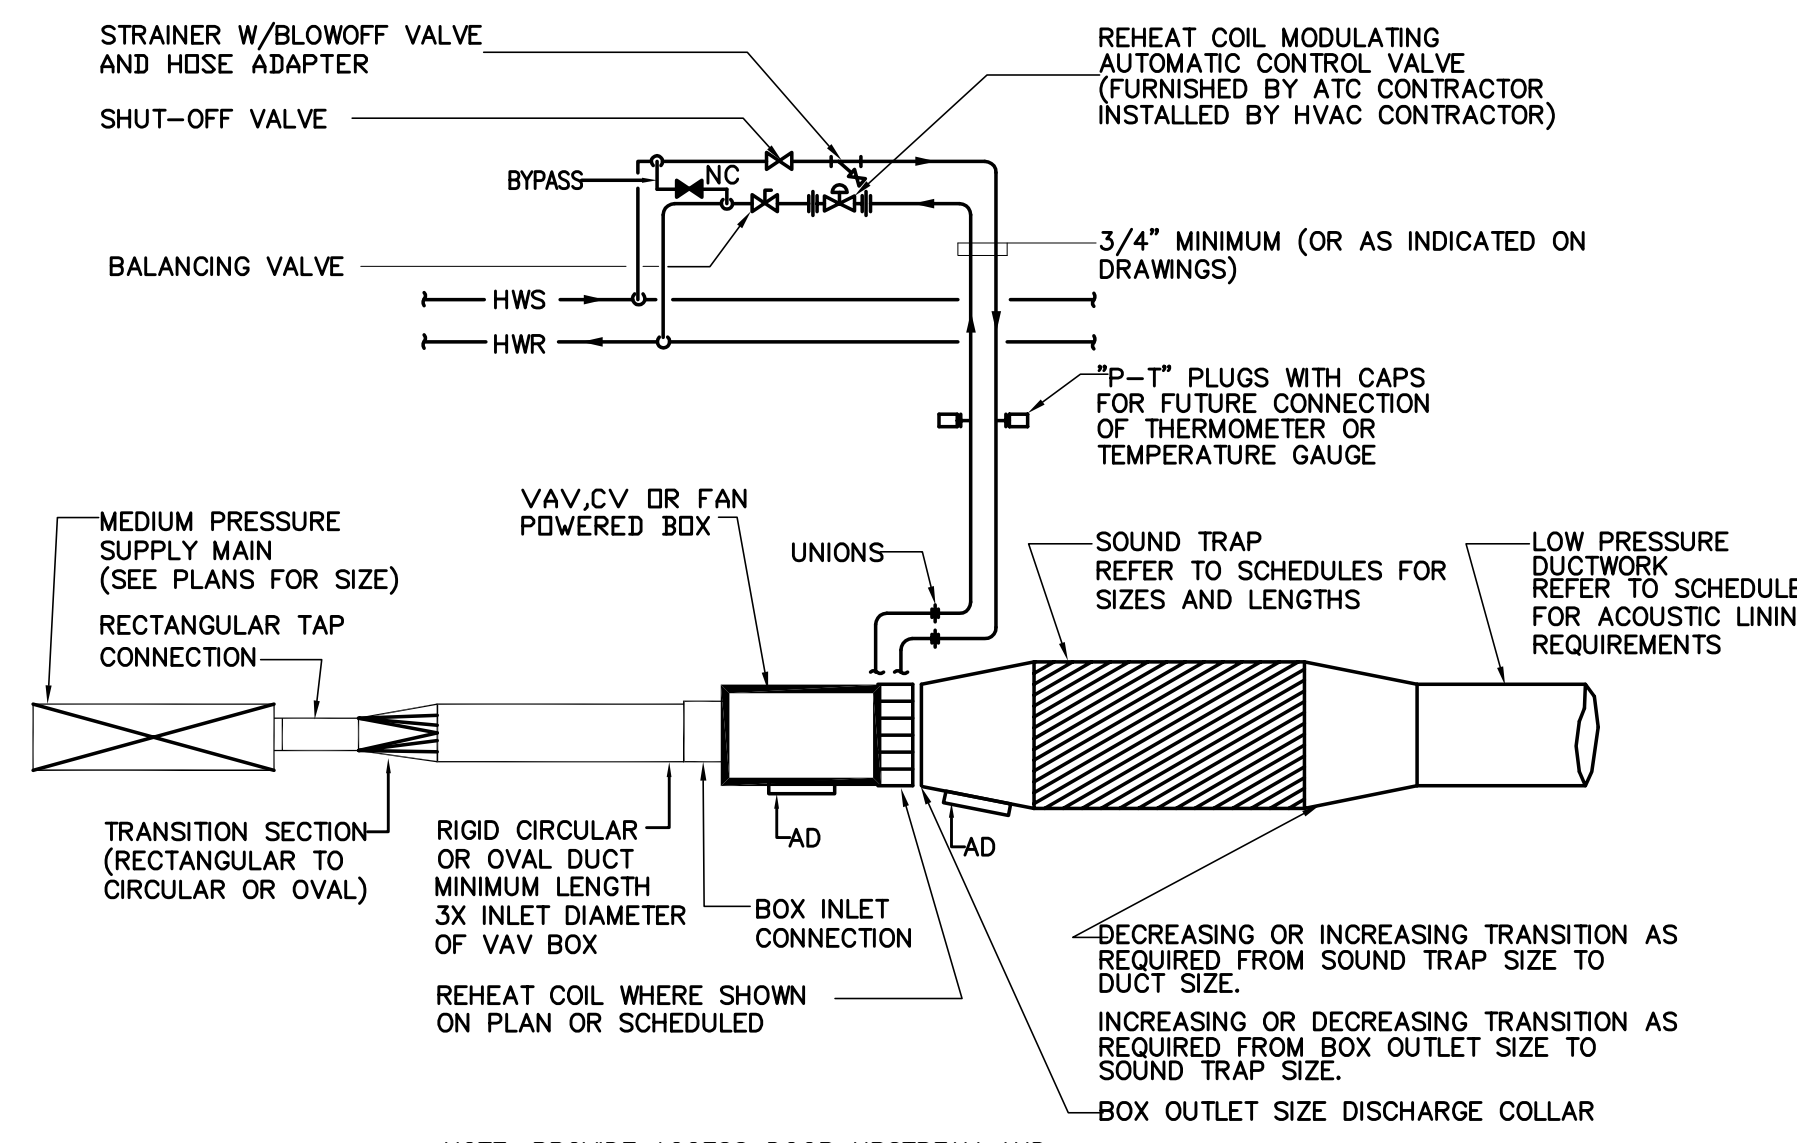

CVR, VAV, FPB or TERMINAL UNIT WITH REHEAT COIL CONNECTION DETAIL

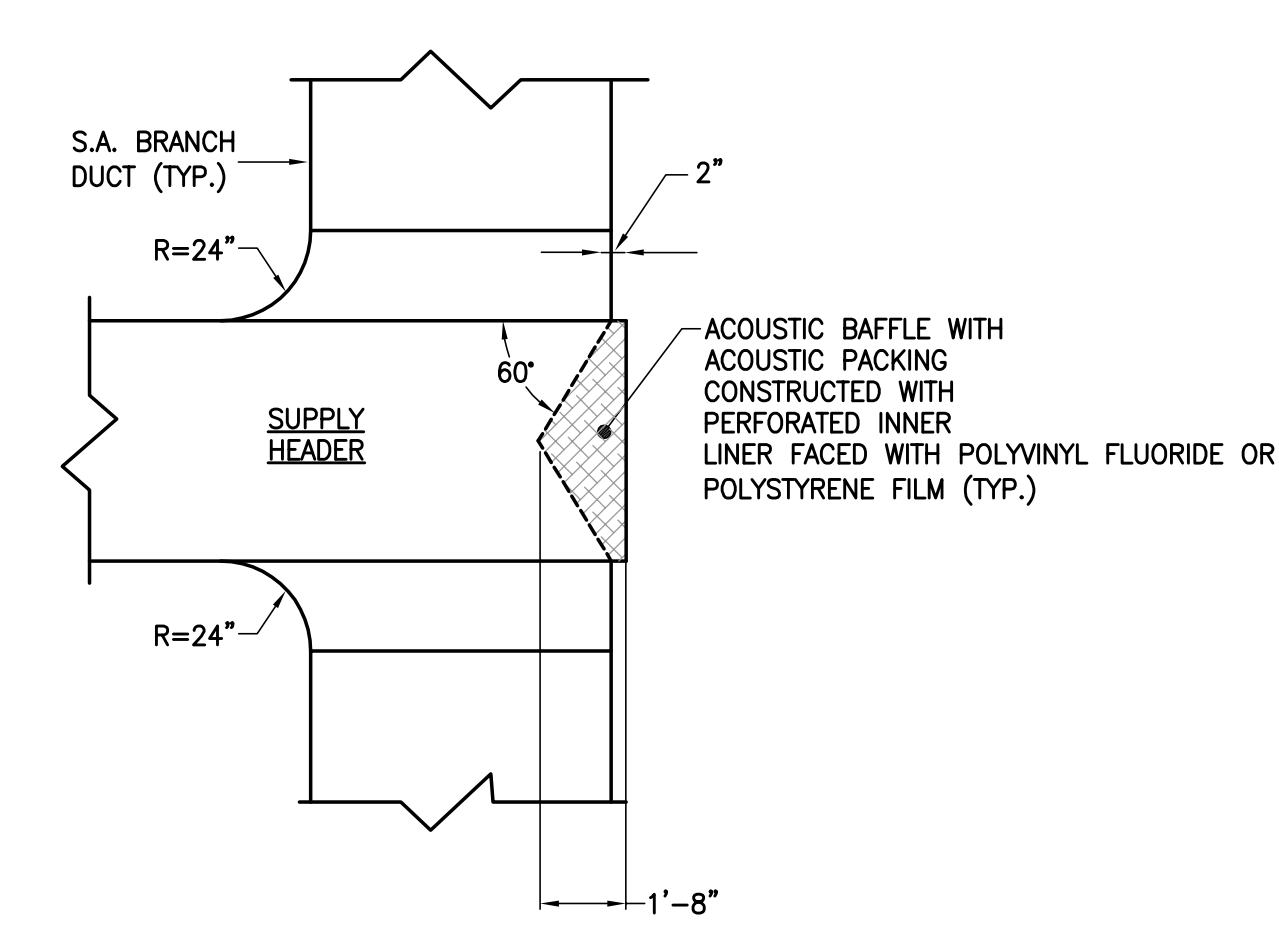

TYPICAL MEDIUM PRESSURE TAP-OFF WITH INTERNAL ACOUSTICAL BAFFLE



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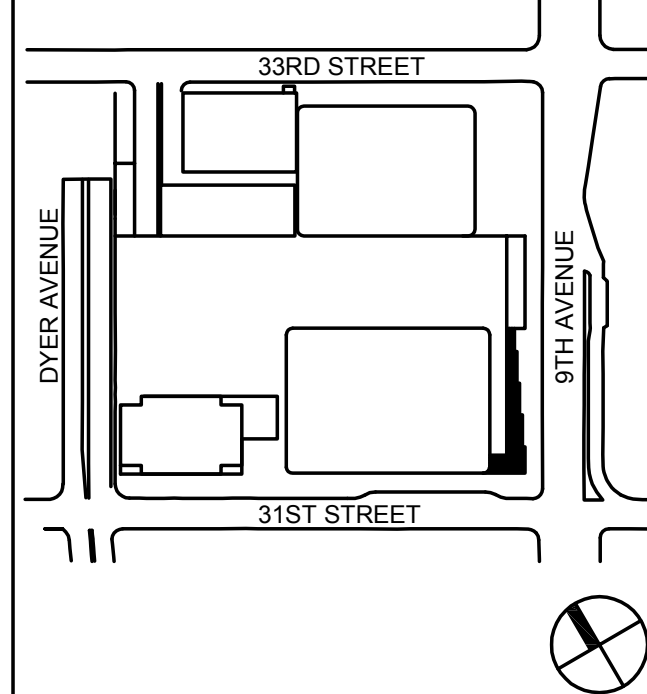
Vibration Consultant
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65 Broadway, Suite 401, New York, NY 10006

Code Consultants Professional Engineers PC
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
Facade Maintenance Consultant
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166 Ames Street, Hackensack, NJ 07601

Wind Tunnel Consultant
Rowan Williams Davies & Irwin Inc.
650 Woodlawn Road West, Guelph
Ontario, Canada N1K 1S8

Key Plan:




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<p>1. 20 JUN 2014 ISSUED FOR FOUNDATION PERMIT</p> <p>2. 20 DEC 2013 ISSUED FOR FOUNDATION PERMIT</p> <p>3. 13 NOV 2013 ISSUED FOR PRELIMINARY ENGINEERING</p> <p>4. 12 JUL 2013 ISSUED FOR 50% DESIGN DEVELOPMENT</p> <p>5. 14 MAR 2013 ISSUED FOR REVISION</p>	<p>No. _____ Date _____ Description _____</p> <p>Sheet Name: _____</p>
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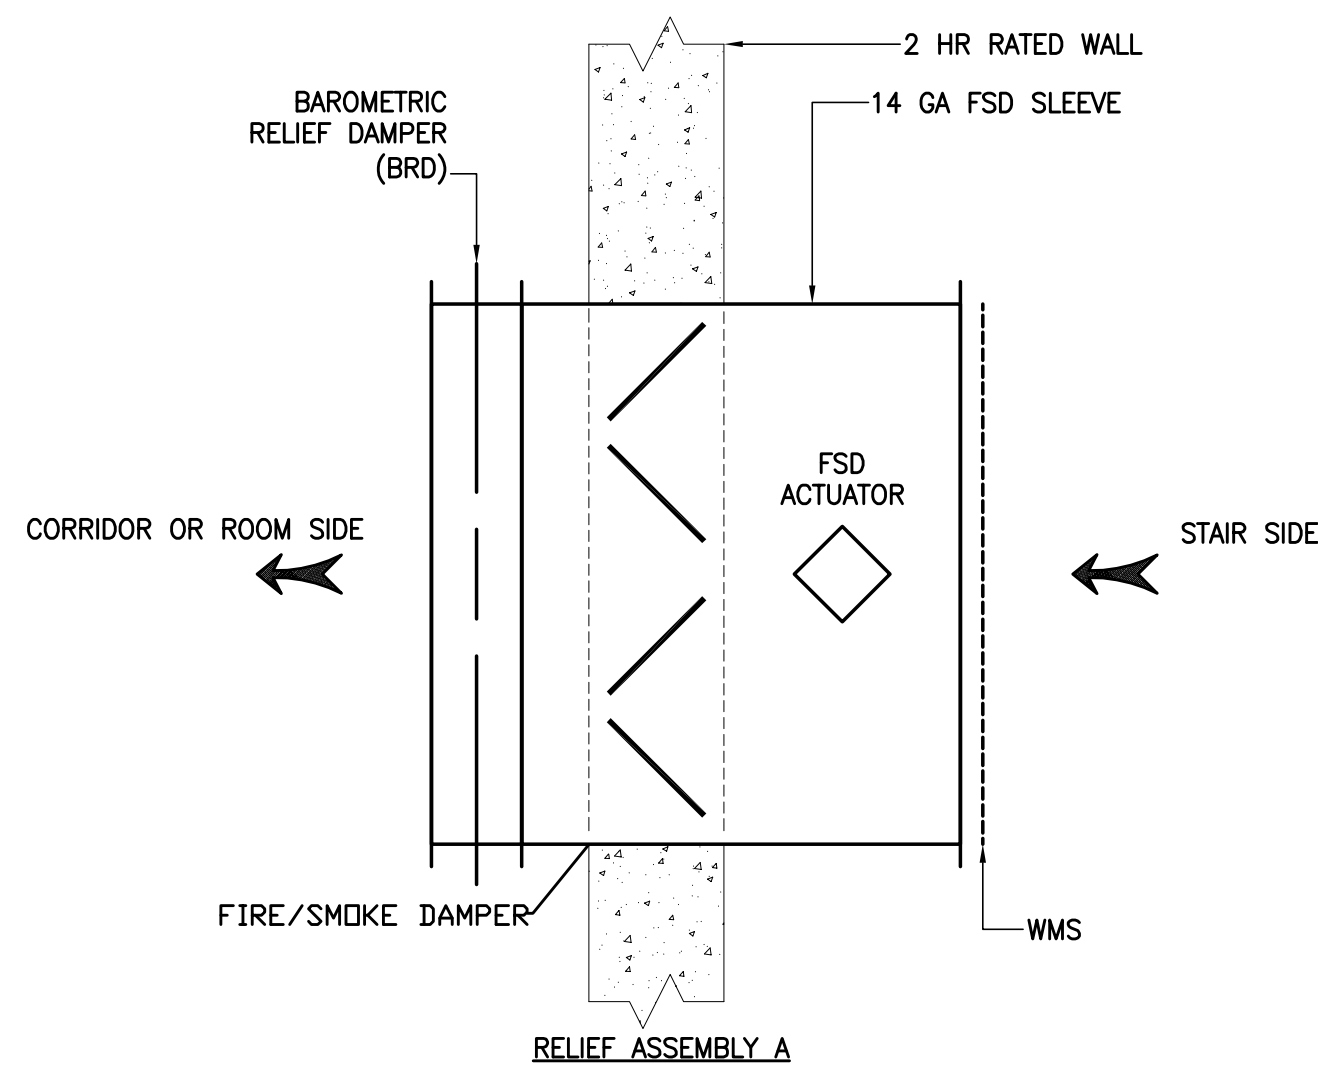
**MECHANICAL
DETAIL
SHEET
NO. 1**

<p>Project No: 14830.A.000</p> <p>Date: 20 JUN 2014</p> <p>Scale: NTS</p> <p>File No.: _____</p>	<p>B-SCAN Sheet No.: M-700.00</p> <p>Sheet No.: M-700</p> <p>Page No.: _____</p>
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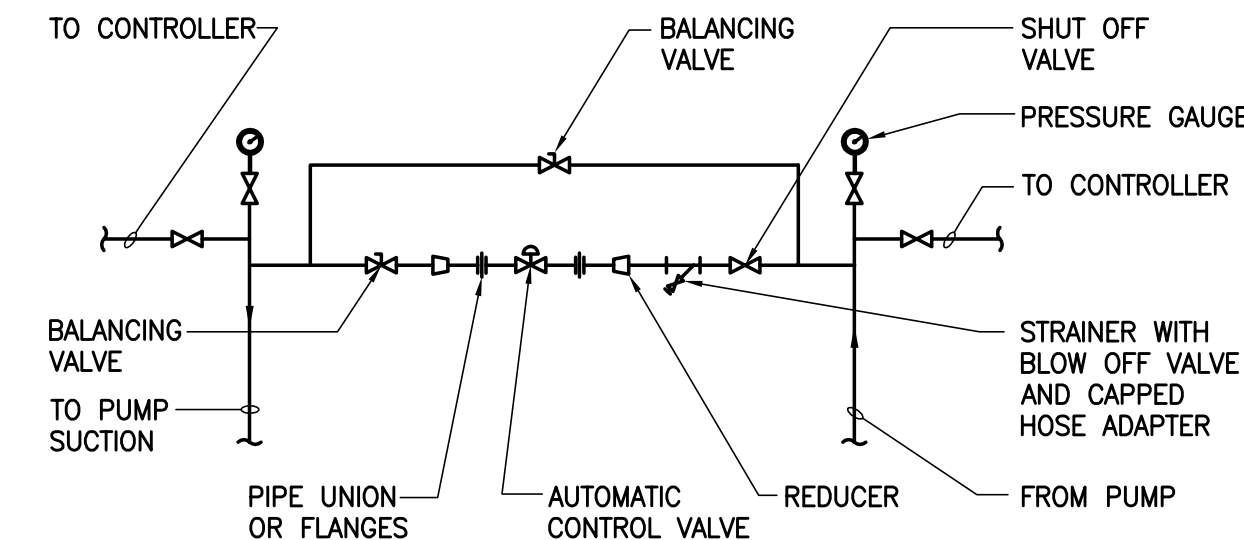


- NOTES:
1. ALL PIPING AND EQUIPMENT SHALL BE RESILIENTLY SUPPORTED AS PER SPECIFICATIONS.
 2. REFER TO DETAIL FOR CYCLONE SEPARATOR PIPING ARRANGEMENT.


INLINE PUMP ASSEMBLY DETAIL

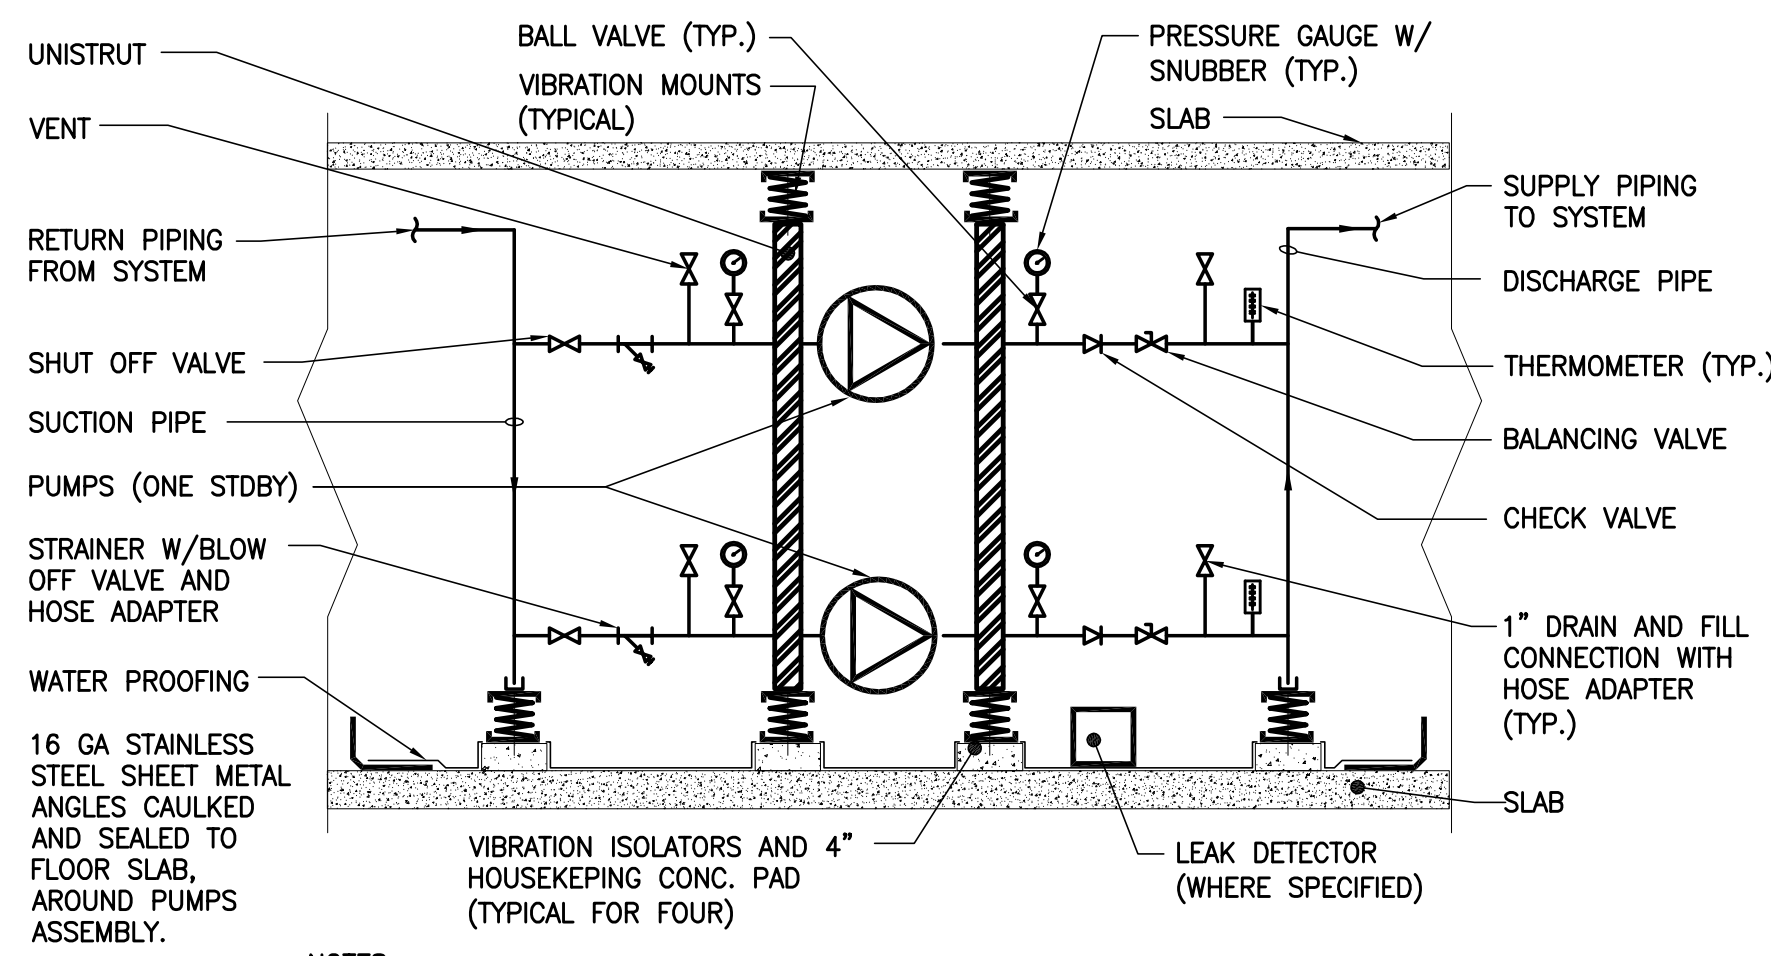


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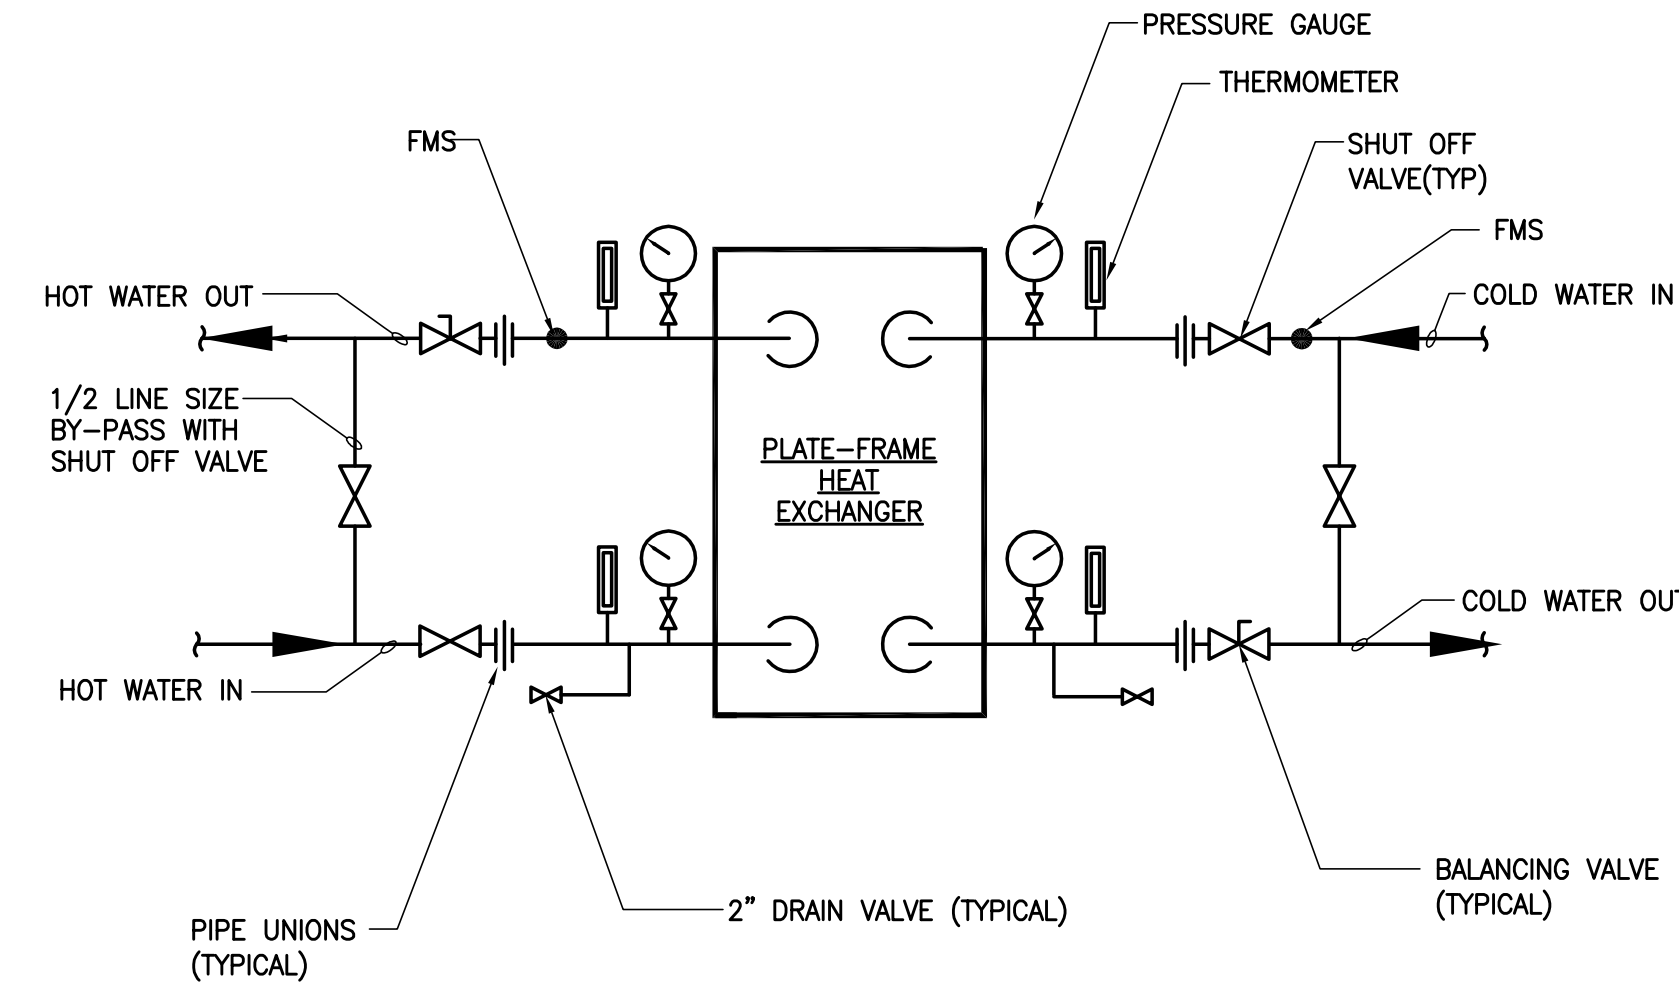
PRESSURE DIFFERENTIAL BYPASS OR INJECTION CONTROL VALVE ARRANGEMENT




COOLING TOWER FILTRATION SYSTEM BACKWASH AND RETENTION TANK DETAIL

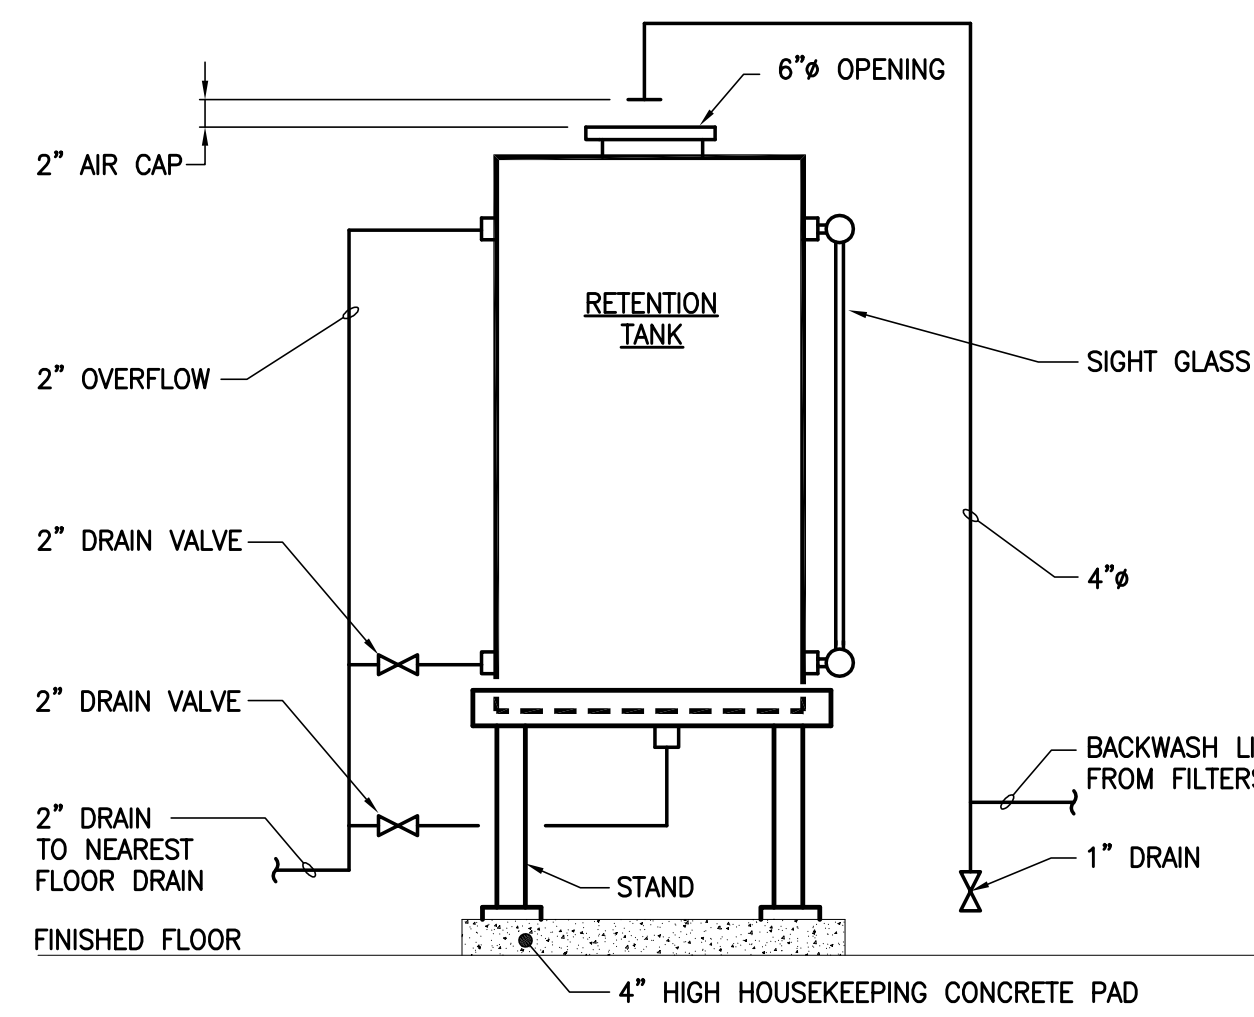


DETAIL OF PLATE-AND-FRAME HX WITH REVERSING VALVE AND CONTROL VALVE (OPEN CONDENSER WATER SIDE)

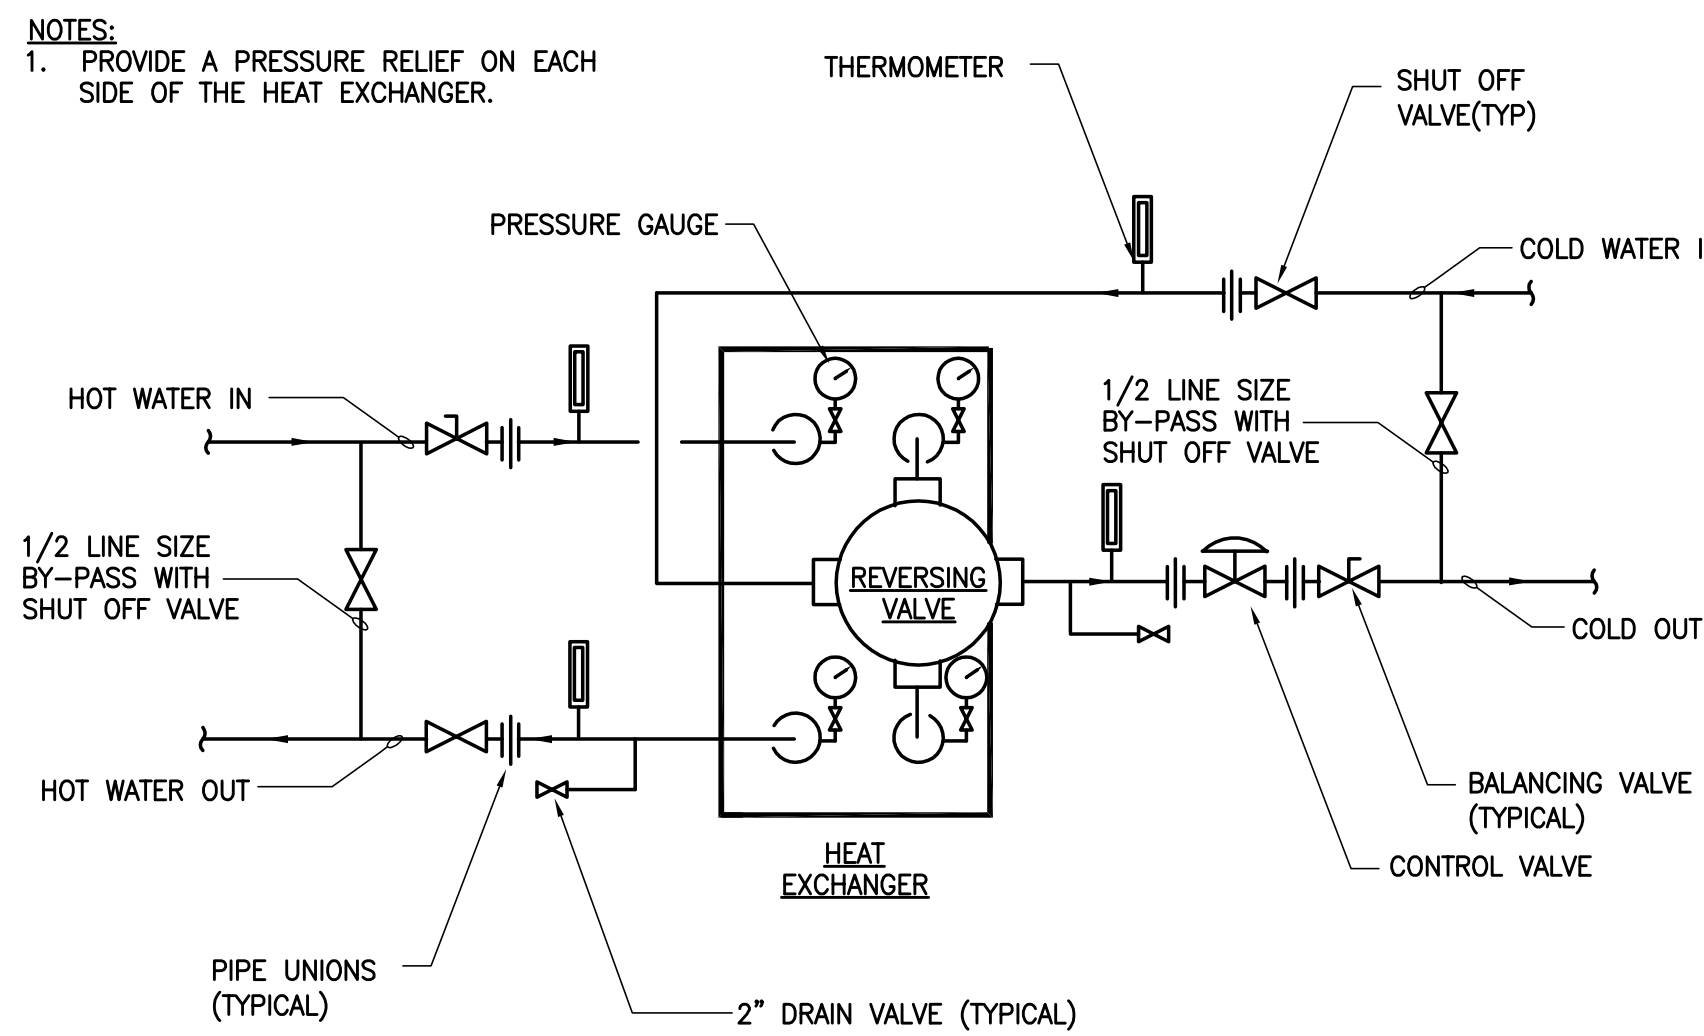


TYPICAL PLATE-AND-FRAME HX PIPING CONNECTION DETAIL (CLOSED SYSTEM)

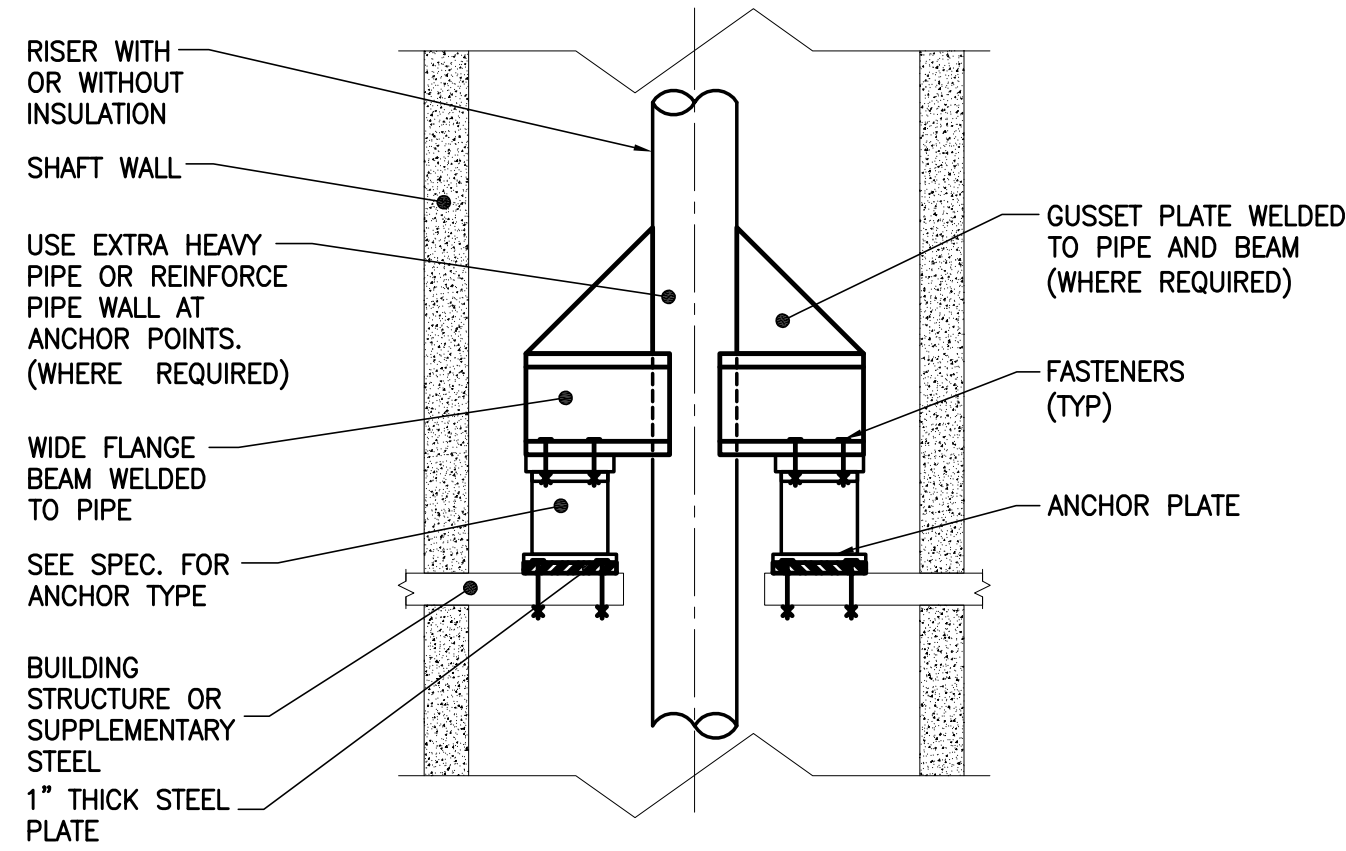

TYPICAL ANCHOR AND GUIDE SUPPORT DETAILS FOR PIPE RISERS

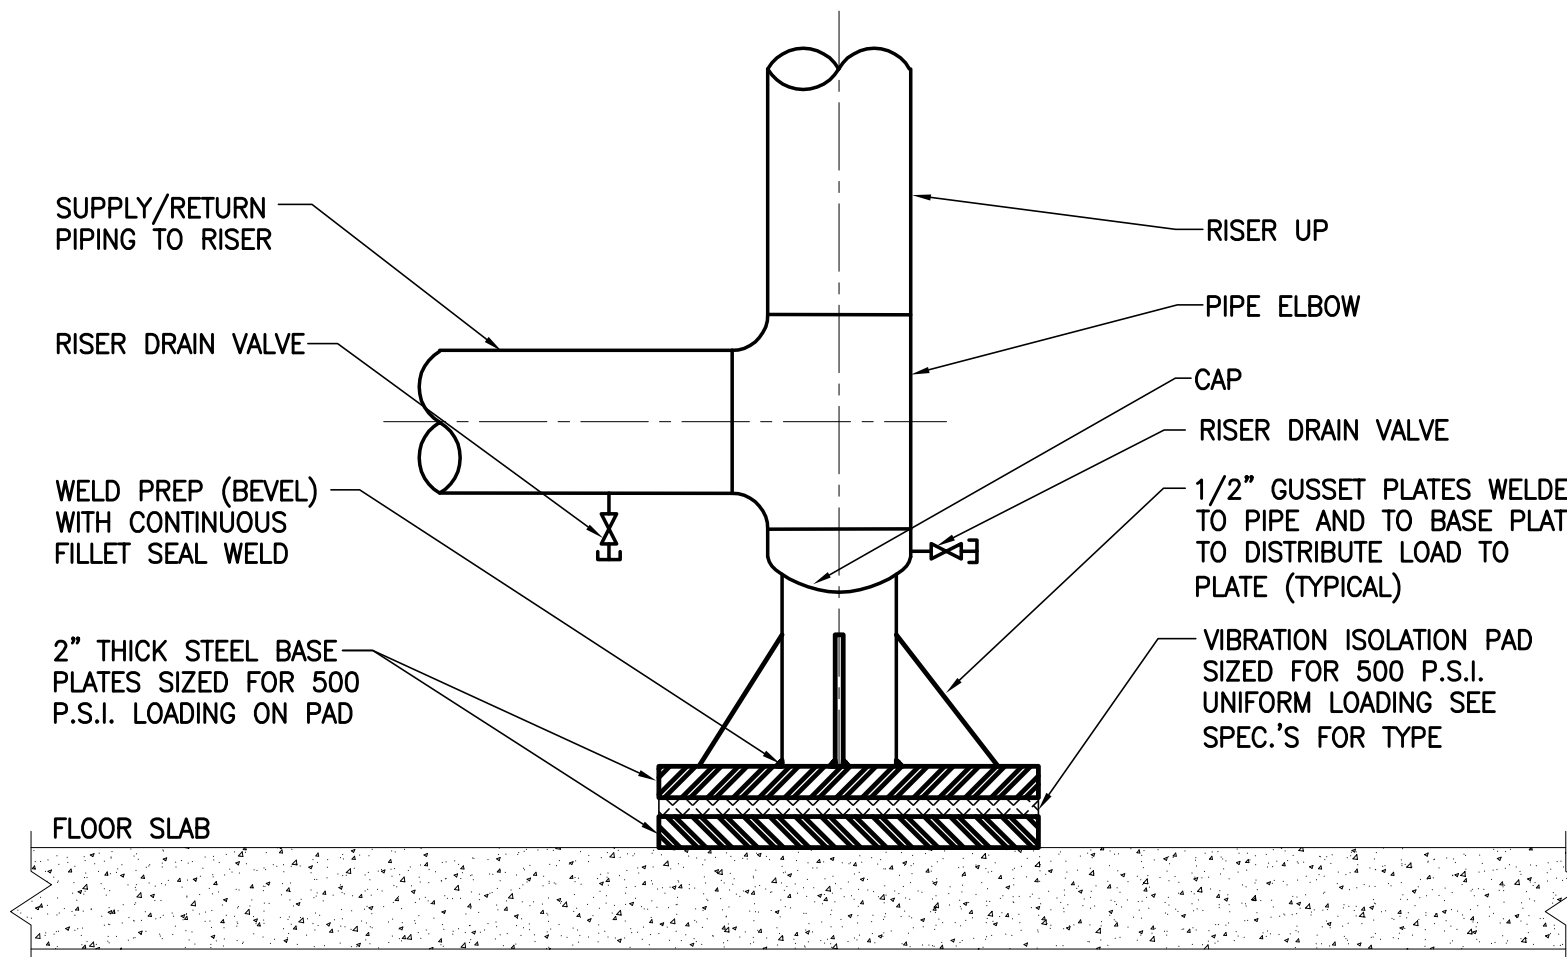


TYPICAL BASE SUPPORT DETAIL FOR PIPE RISERS

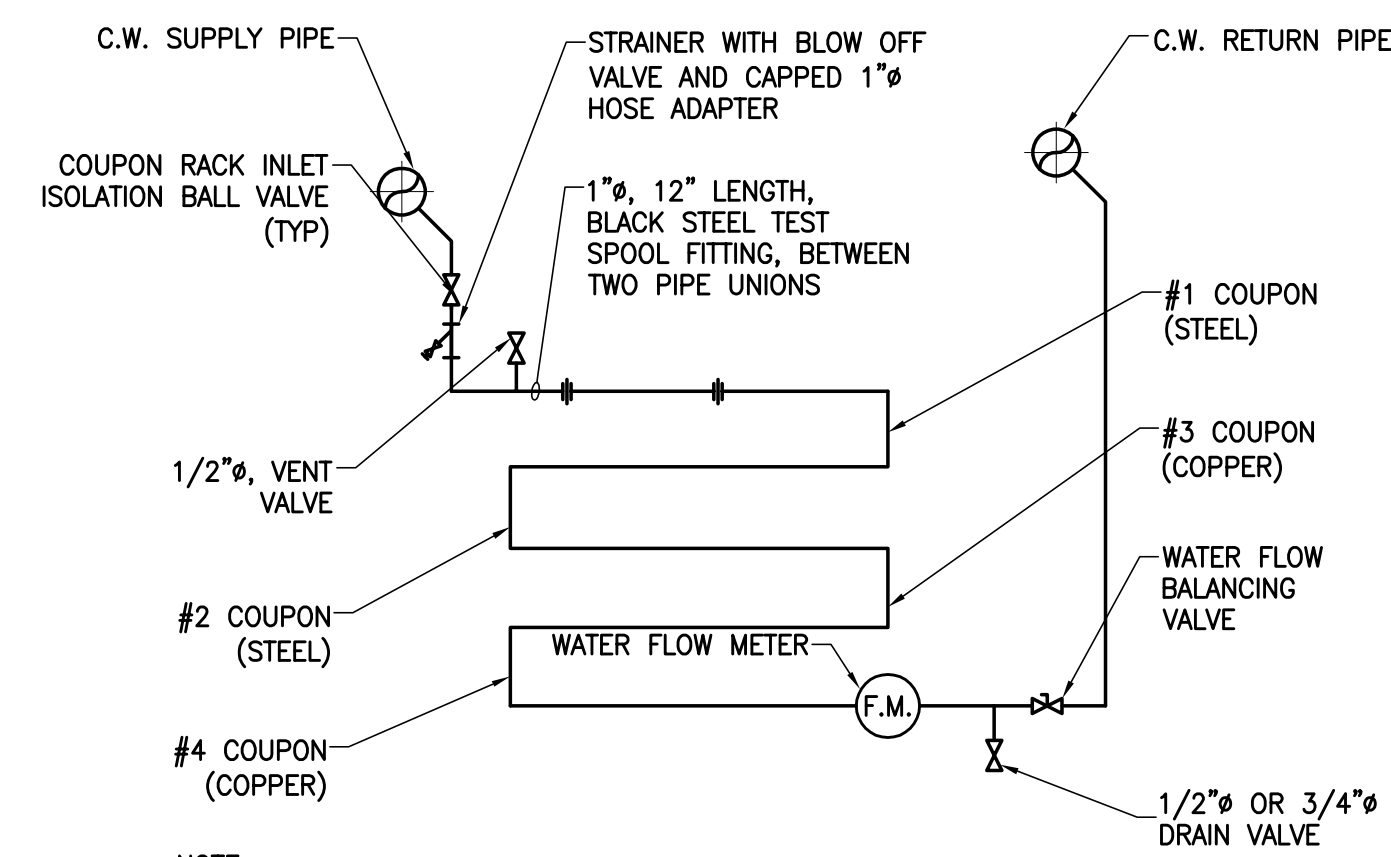

- NOTE:
- METERED WATER FLOW THROUGH 1\"/>

OPEN C.W. SYSTEM 1\"/>

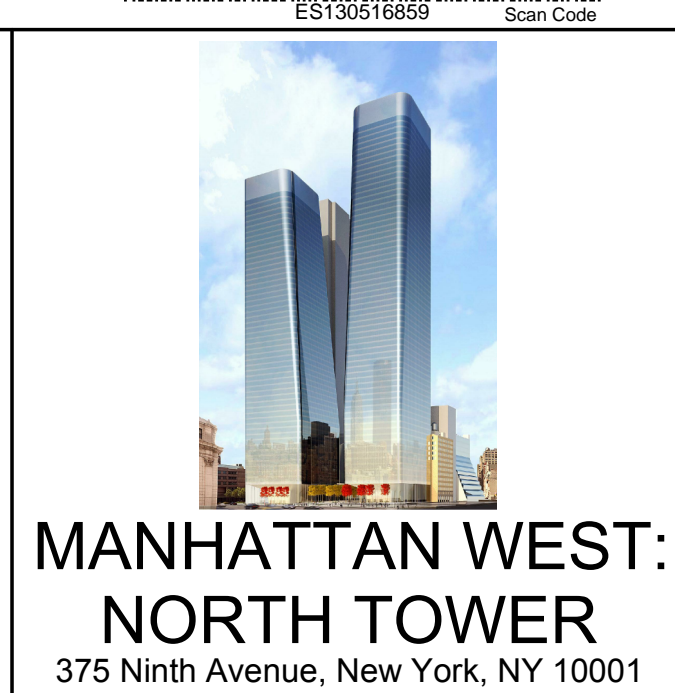

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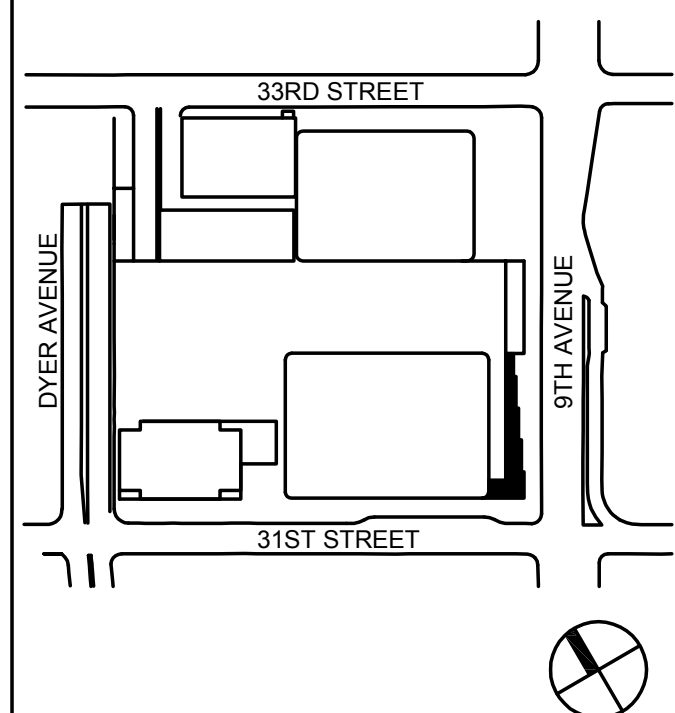
Facade Maintenance Consultant

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Key Plan:




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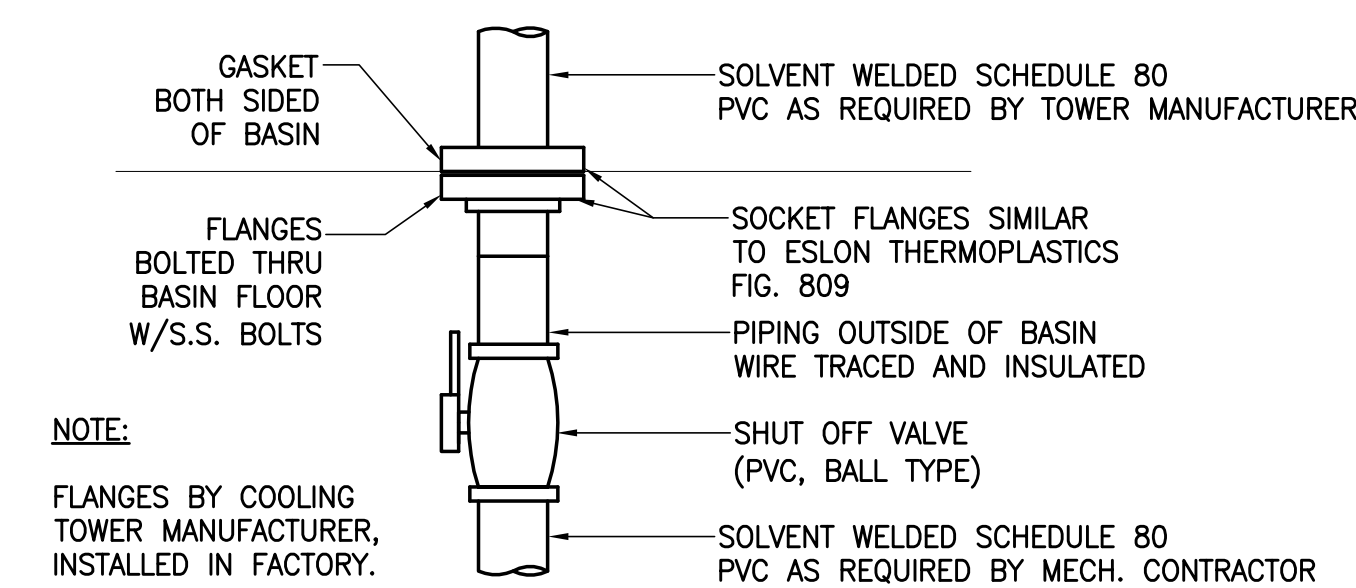
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Sheet Name:		

**MECHANICAL
DETAIL
SHEET
NO. 3**

Project No: 14830.A.000	B-SCAN Sheet No.: M-702.00
Date: 20 JUN 2014	Sheet No.: M-702
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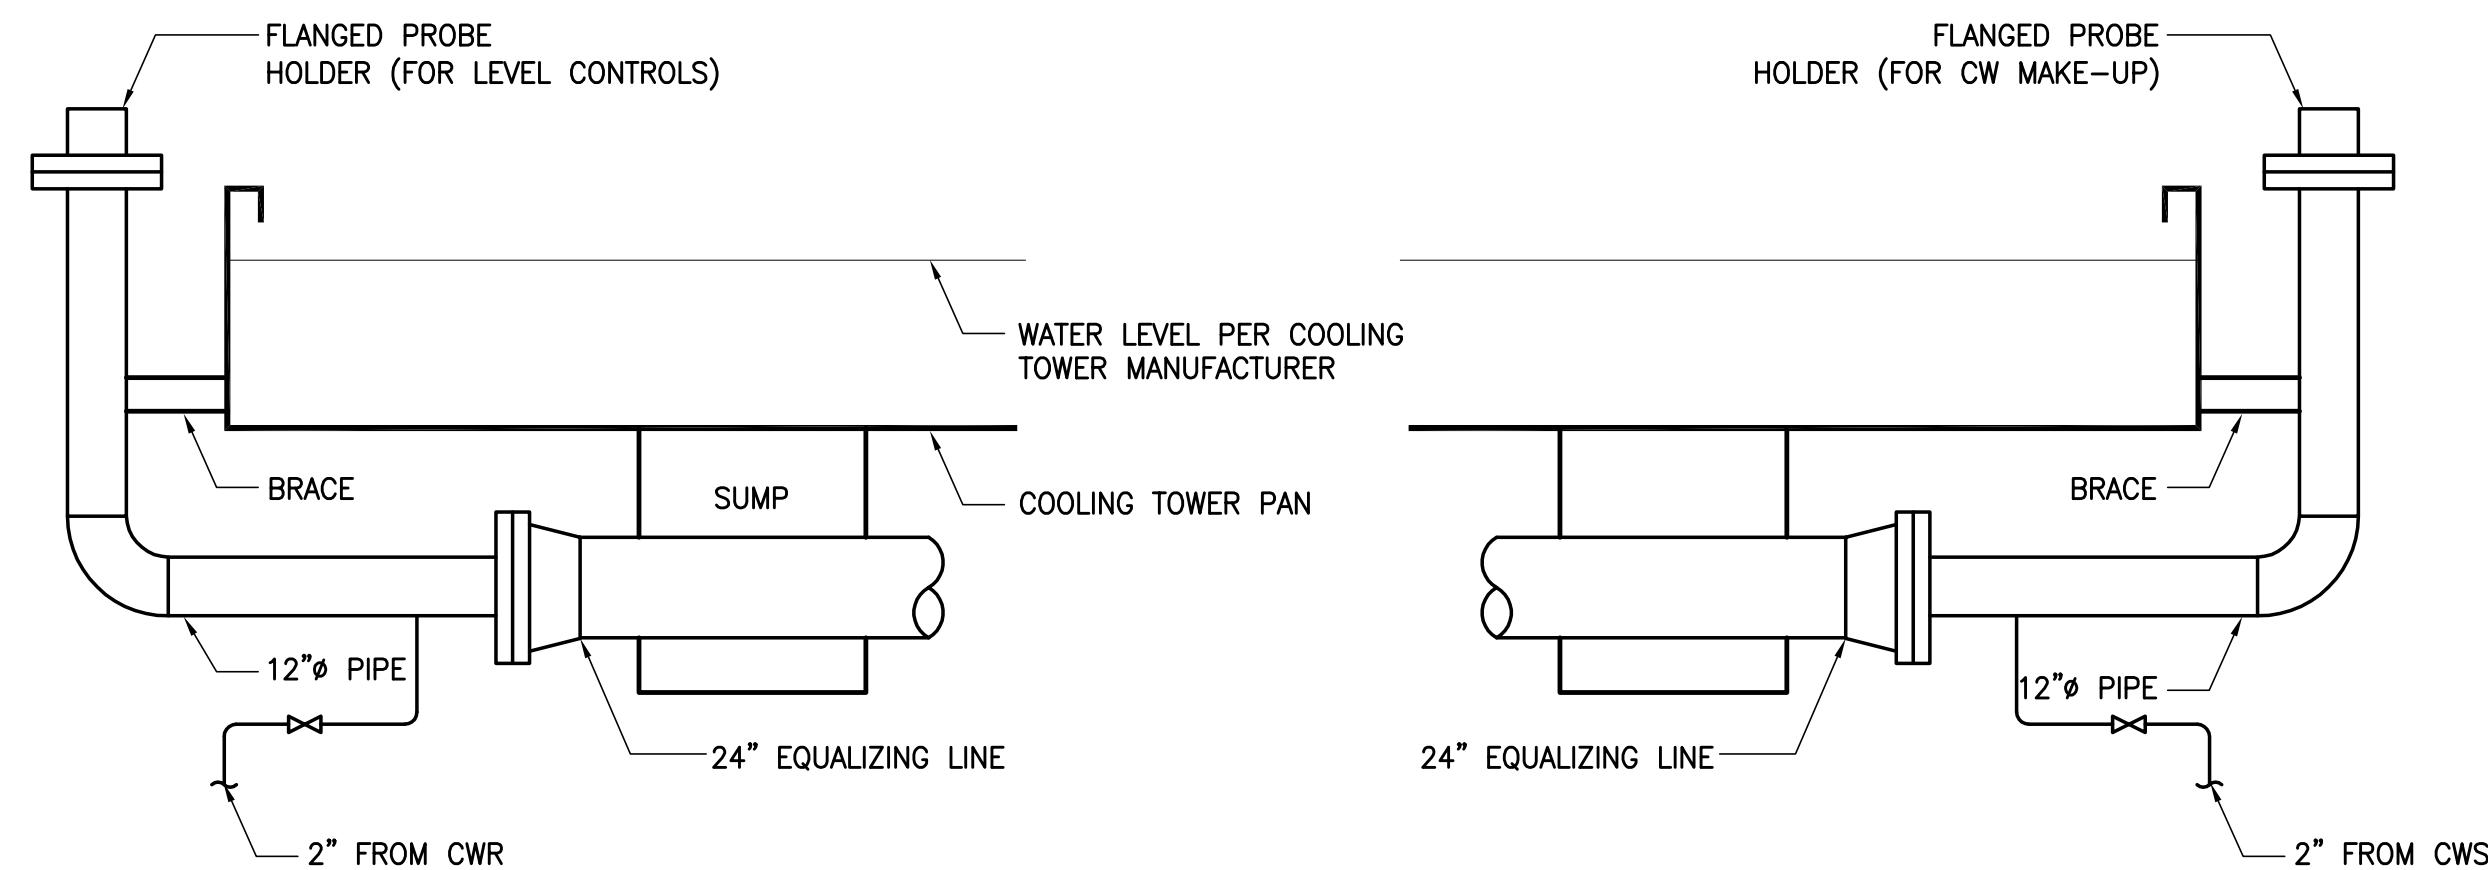


COOLING TOWER - ROOF LEVEL

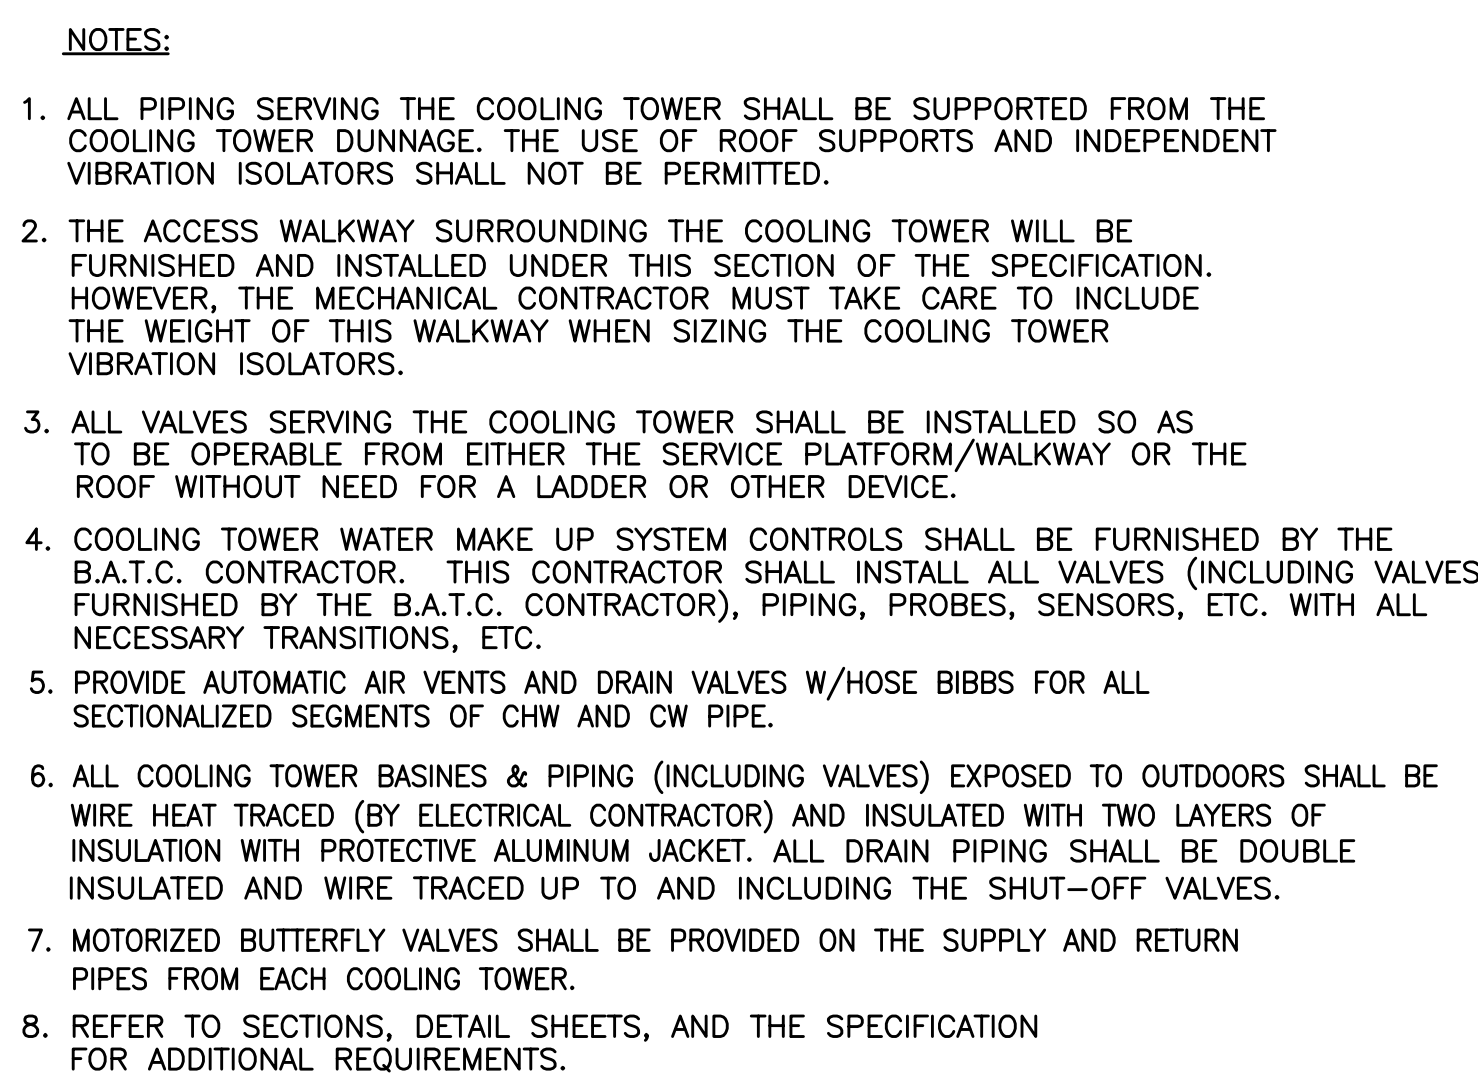


CONDENSER WATER SIDESTREAM FILTRATION PIPING 24"


COOLING TOWER BASIN FILTRATION SYSTEM BASIN CONNECTION DETAIL



COOLING TOWER MAKE-UP PROBE ARRANGEMENT

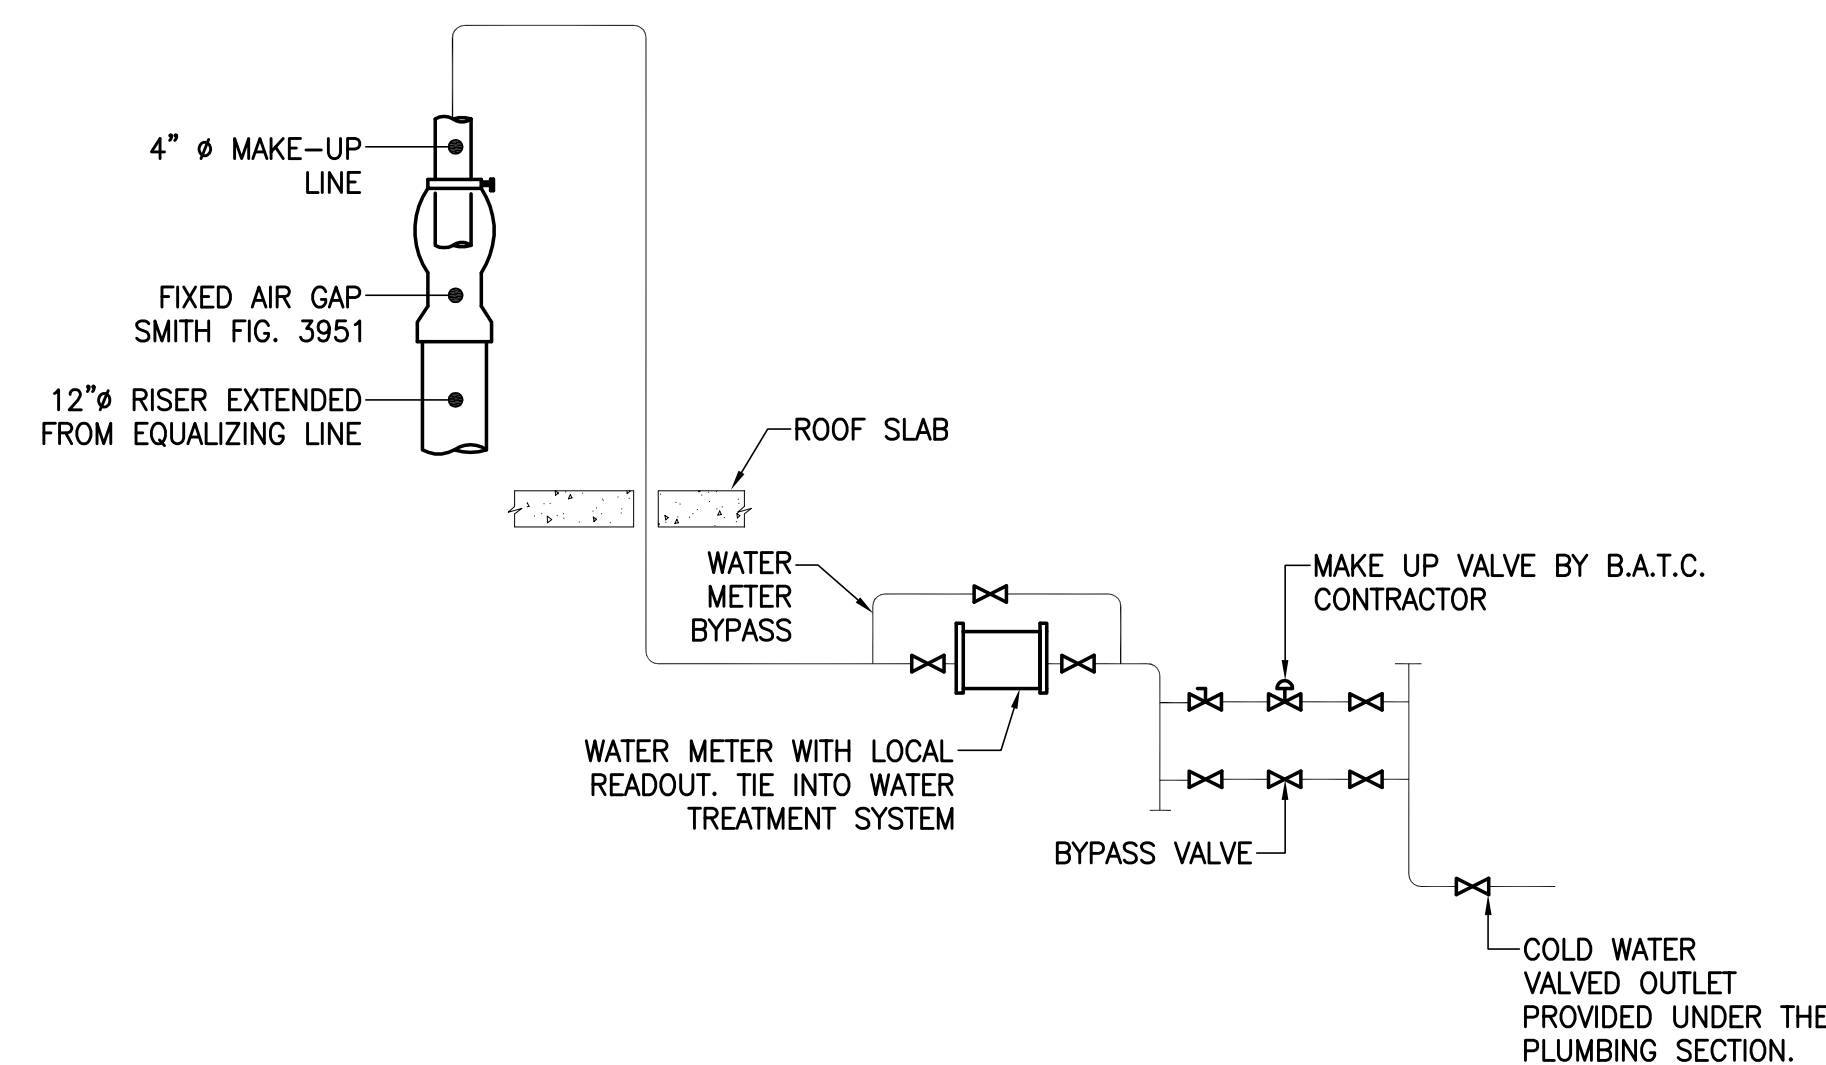

COOLING TOWER MAKE-UP SCHEMATIC

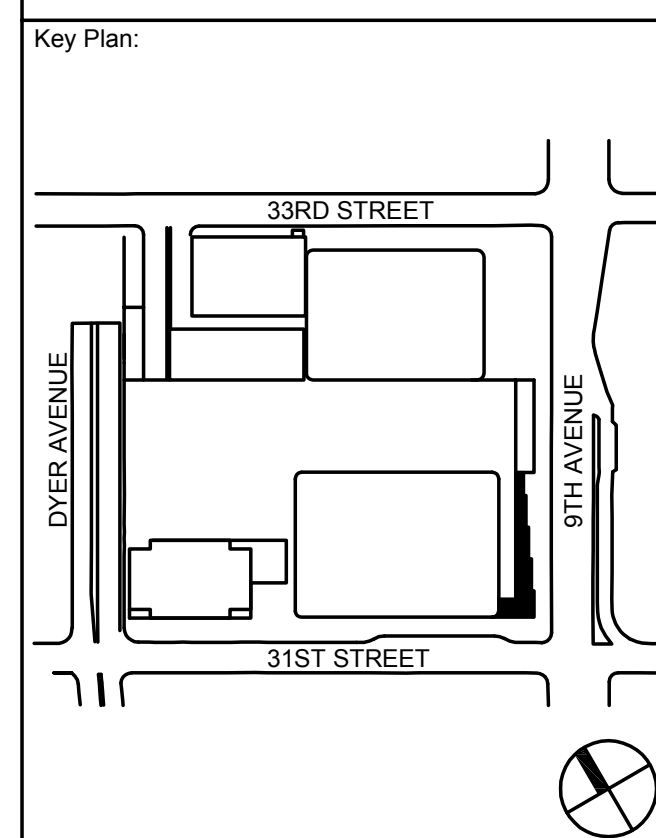


Seal & Signature



5	20 JUN 2014	ISSUED FOR FOUNDATION PERMIT
4	20 DEC 2013	ISSUED FOR FOUNDATION PERMIT
3	15 NOV 2013	ISSUED FOR DD PROGRESS PRICING
2	12 JUL 2013	ISSUED FOR 50% DESIGN DEVELOPMENT
1	15 MAR 2013	ISSUED FOR RECONCILIATION
No.	Date	Description
Sheet Name:		

MECHANICAL
DETAIL
SHEET
NO. 6

Project No.: 14830.A.000	B-SCAN Sheet No.: M-705.00
Date: 20 JUN 2014	
Scale: NTS	
File No.:	Sheet No.: M-705
	Page No.:

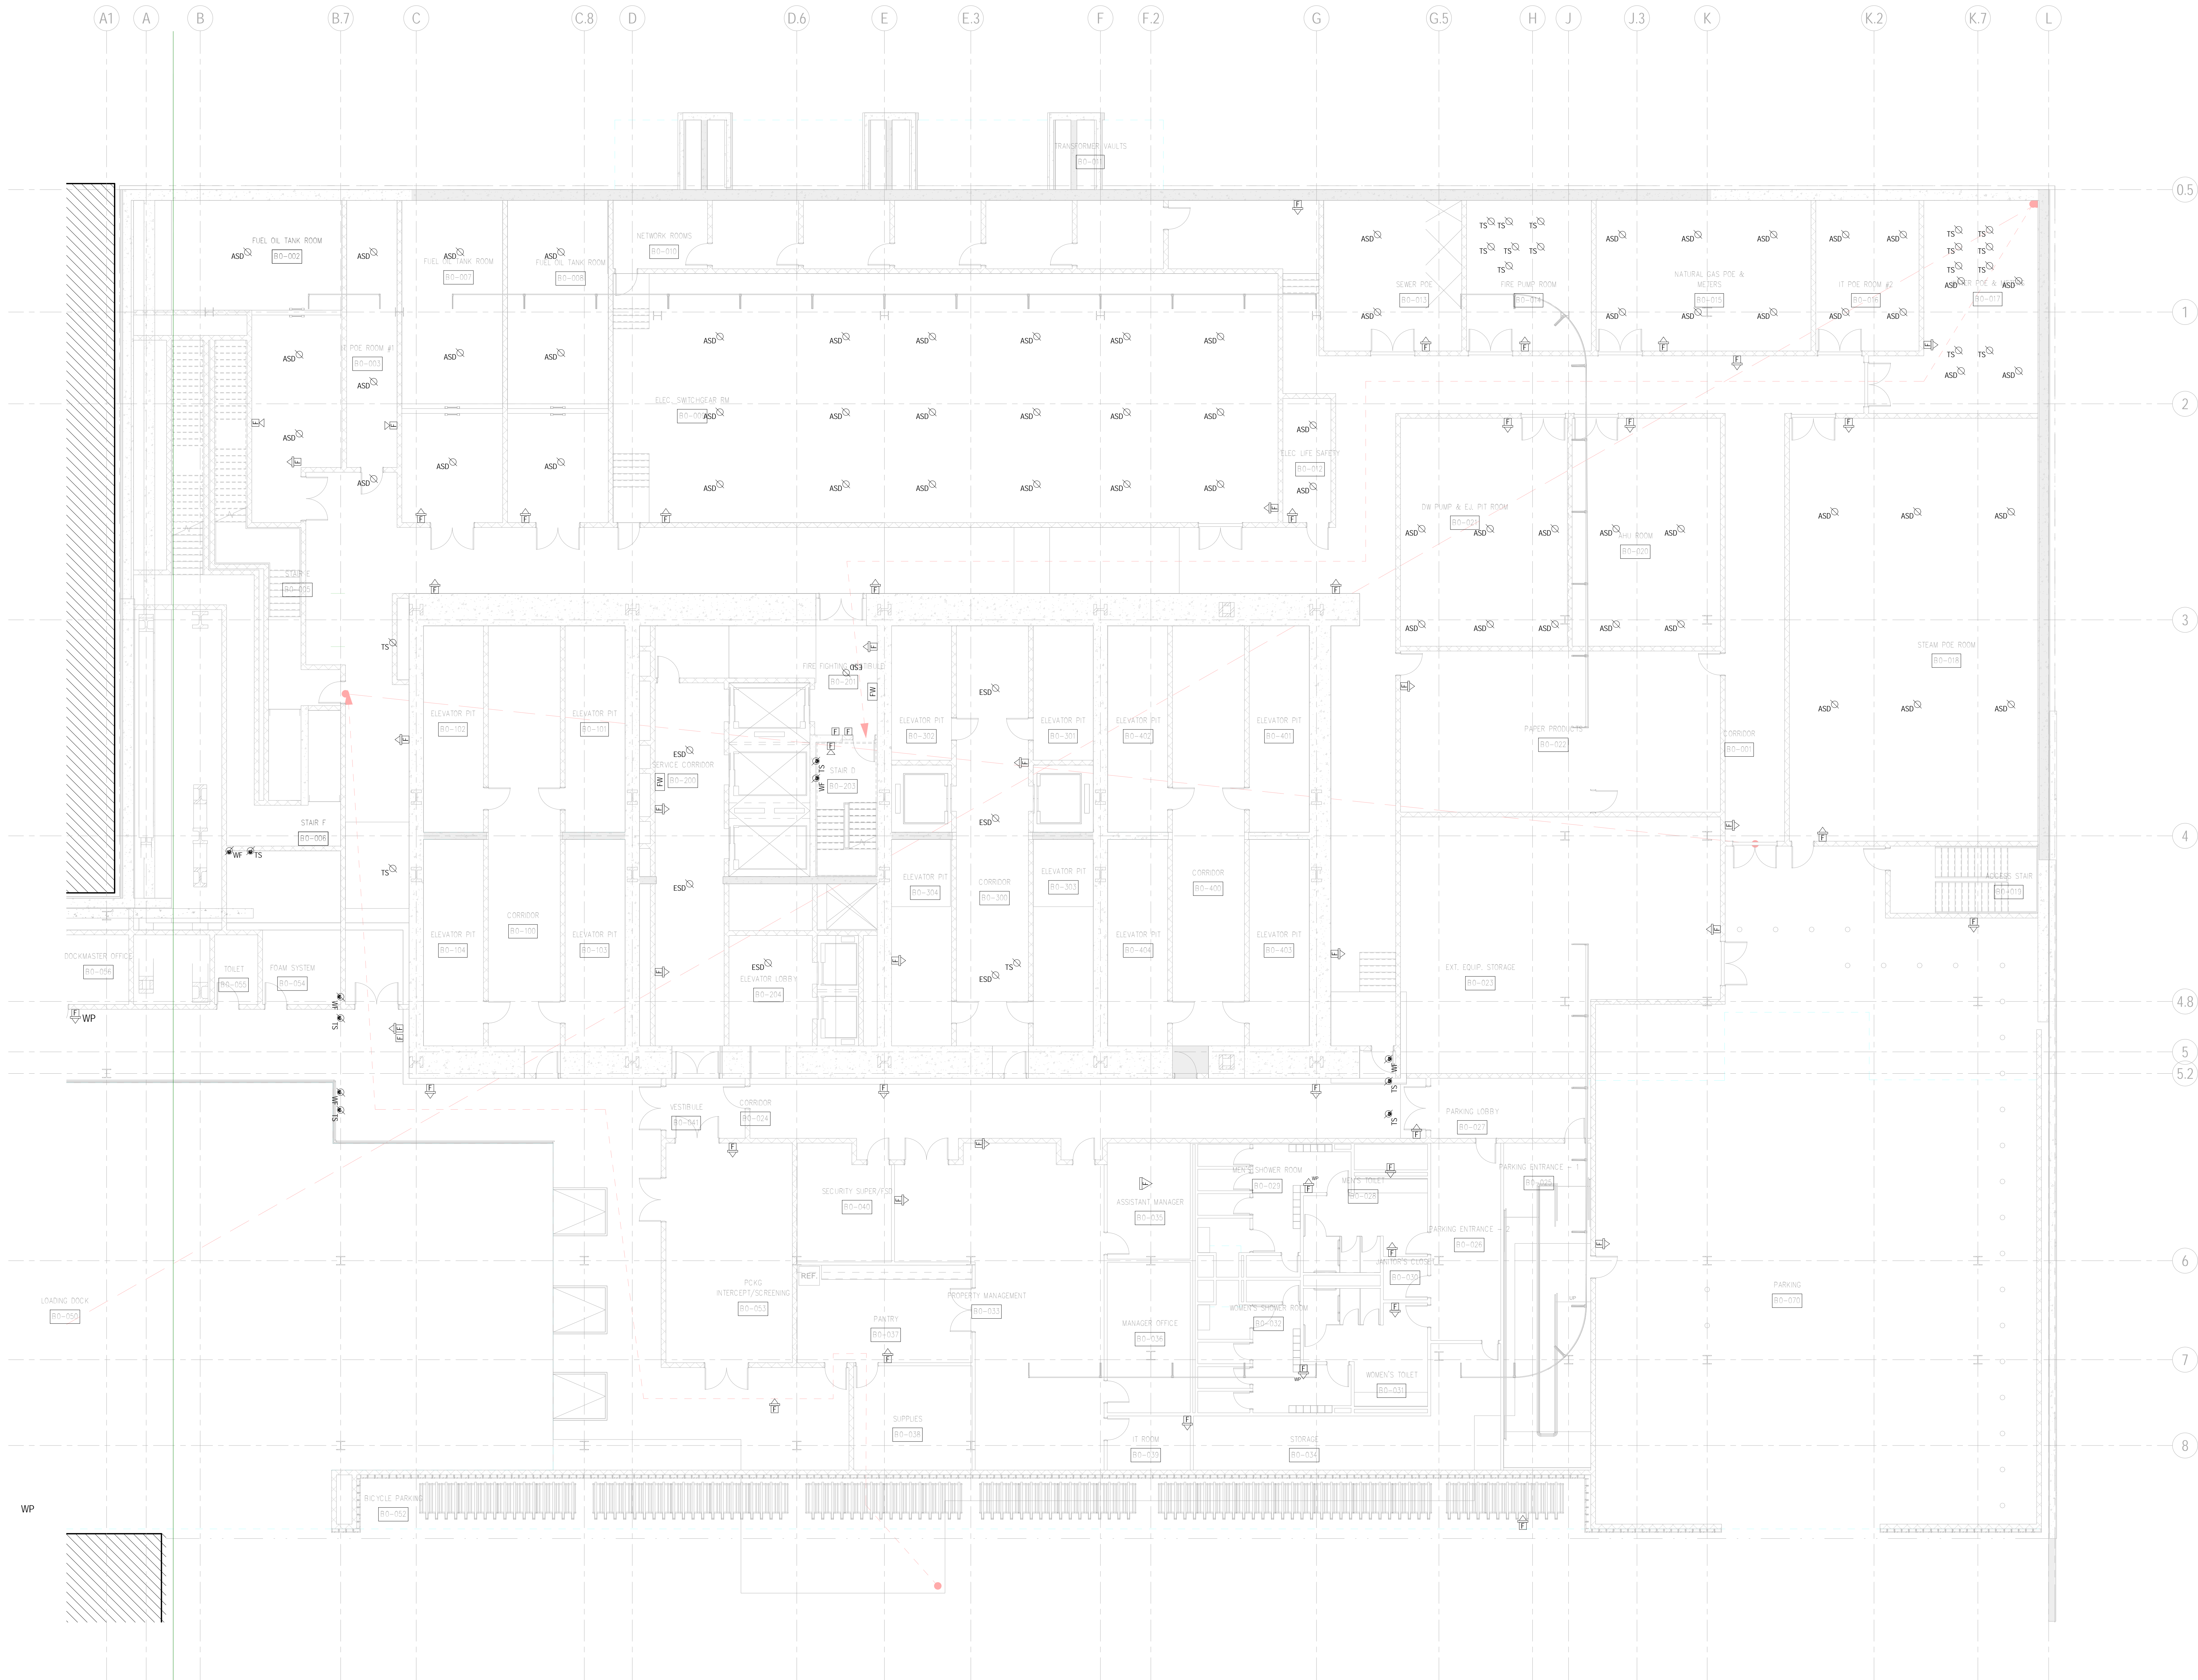


SHEET NOTES

FIRE ALARM NOTES

1. PROVIDE ADDITIONAL SMOKE DETECTORS AS REQUIRED BY NFPA72 IN ALL MECHANICAL ROOMS AND NON SPRINKLERED AREAS WHICH WILL PROVIDE ADDITIONAL SMOKE DETECTION COVERAGE WHEN POCKETS ARE CREATED DUE TO ARCHITECTURAL CEILING AND STRUCTURAL BEAMS.
2. PROVIDE WATER FLOW AND TAMPER SWITCHES AT EVERY FIRE PROTECTION RISER CONTROL VALVE AND ON EVERY RISER TAKE OFF FOR THE FLOOR SPRINKLER LOOPS.
3. PROVIDE FIRE WARDEN PHONES ON THE INSIDE OF EVERY EGRESS STAIR ON EVERY FLOOR.
4. PROVIDE SPEAKERS WITHIN ENCLOSED EGRESS STAIRS. ONE SPEAKER SHALL BE LOCATED EVERY THIRD FLOOR. THE SPEAKERS SHALL BE LOCATED ON THE OPPOSITE STAIR LANDING WHERE THE FIRE WARDEN PHONES ARE BEING INSTALLED.
5. PROVIDE A SMOKE DETECTOR AT EVERY FIRE SMOKE DAMPER OR SMOKE ONLY LOCATION. REFER TO MECHANICAL RISER DIAGRAMS FOR QUANTITIES AND LOCATIONS OF DAMPERS.
6. PROVIDE AN ELEVATOR SMOKE DETECTOR AT THE TOP OF EACH ELEVATOR HOISTWAY.
7. PROVIDE AN AREA SMOKE DETECTOR AT THE TOP OF EACH STAIRWELL.
8. PROVIDE AN AREA SMOKE DETECTOR JUST OUTSIDE THE ENTRANCE TO EACH EGRESS STAIR (TYPICAL FOR EVERY ENTRANCE INTO THE STAIR)

BUILDING DEPARTMENT FIRE ALARM NOTES
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Acoustical Consultant
Cerami & Associates
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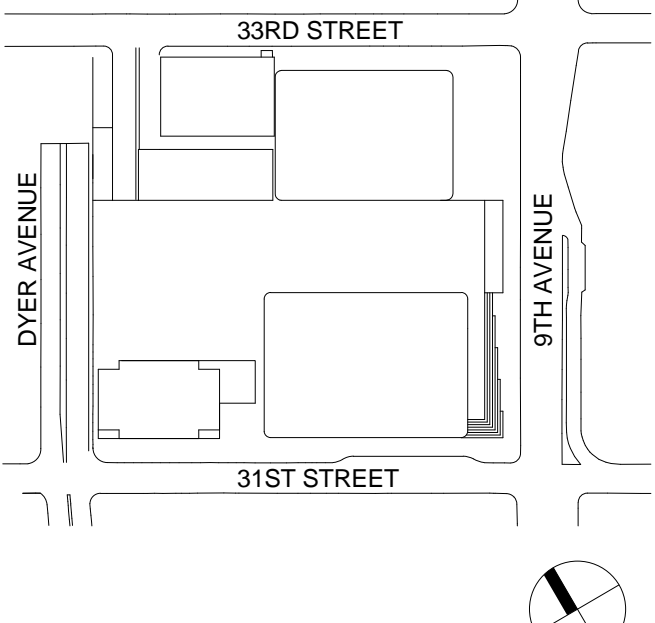
Vibration Consultant
Wilson, Uhrig & Associates, Inc.
65 Broadway, Suite 401, New York, NY 10006

Code Consultant
Code Consultants Professional Engineers PC
215 West 40th Street, 15th Floor, New York, NY 10018


Facade Maintenance Consultant
Entek Engineering LLC
166 Ames Street, Hackensack, NJ 07601

Wind Tunnel Consultant
Rowan Williams Davies & Irwin Inc.
650 Woodlawn Road West, Guelph
Ontario, Canada N1K 1B8


Key Plan:



Seal & Signature:



Project No.:	14800-A-000	Sheet No.:	FA-097.00
Date:	20 JUN 2014	B-SCAN Sheet No.:	
Scale:	1/8" = 1'-0"	Page No.:	
File No.:	FA-097.00		

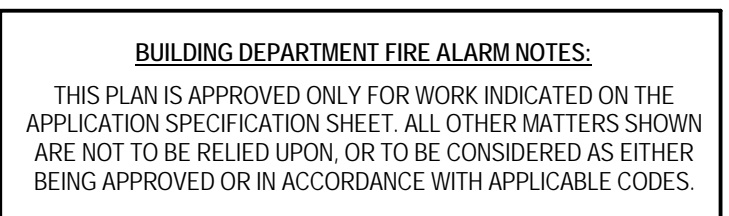

3. PROVIDE ADDITIONAL SMOKE DETECTORS AS REQUIRED BY NFPA72 IN ALL MECHANICAL ROOMS AND NON SPINNING ELEVATOR SHAFTS WHICH HAVE ELEVATOR HOISTWAYS. DETECTOR LOCATIONS IN MECHANICAL ROOMS ARE CREATED TO DETECT SMOKE FROM MECHANICAL ROOMS. DETECTOR LOCATIONS IN ELEVATOR SHAFTS ARE CREATED TO DETECT SMOKE FROM ELEVATOR HOISTWAYS.
4. PROVIDE WATER FLOW AND RASER SWITCHES AT EVERY FIRE FIGHTER COMPARTMENT VALVE AND ONE EVERIS Riser Tack-Off for the floor sprinkler loops.
5. PROVIDE FIRE WARDEN POSITIONS at the INSIDE of EVERY EGRESS STAIR on EVERY FLOOR.
6. PROVIDE SPEAKERS WITH ENCLOSED EGRESS STAIRS. ONE SPEAKER SHALL BE LOCATED EVERY THIRD FLOOR. THE SPEAKERS SHALL BE LOCATED ON THE OUTSIDE OF EACH EGRESS STAIR AND THE FIRE WARDEN POSITIONS ARE BEING INSTALLED.
7. PROVIDE A DUCT SMOKE DETECTOR AT EVERY FIRE SMOKE DAMPER OR SMOKE TAIL OUT. REFER TO THE PROJECT DESIGN DRAWINGS FOR QUANTITIES AND LOCATIONS OF DAMPERS.
8. PROVIDE AN ELEVATOR SMOKE DETECTOR AT THE TOP OF EACH ELEVATOR HOISTWAY.
9. PROVIDE AN AREA SMOKE DETECTOR AT THE TOP OF EACH STAIRWELL.
10. PROVIDE AN AREA SMOKE DETECTOR AT JUST OUTSIDE THE ENTRANCE TO EACH EGRESS STAIR (TYPICAL FOR EVERY ENTRANCE INTO THE STAIR)



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Wind Tunnel Consultant
Rowan Williams Davies & Irwin Inc.
650 Woodlawn Road West, Guelph
Ontario, Canada N1K 1B6

Key Plan:



Seal & Signature:



FIRE ALARM NOTES

1. PROVIDE ADDITIONAL SMOKE DETECTORS AS REQUIRED BY NFPA72 IN ALL MECHANICAL ROOMS AND NON-SPRINKLERED AREAS WHICH WILL PROVIDE ADDITIONAL SMOKE DETECTION COVERAGE WHEN POCKETS ARE CREATED DUE TO ARCHITECTURAL, CEILING AND STRUCTURAL BEAMS.
2. PROVIDE WATER FLOW AND TAMPER SWITCHES AT EVERY FIRE PROTECTION RISER CONTROL VALVE AND ON EVERY RISER TAKE-OFF FOR THE FLOOR SPRINKLER LOOPS.
3. PROVIDE FIRE WARDEN PHONES ON THE INSIDE OF EVERY EGRESS STAIR ON EVERY FLOOR.
4. PROVIDE SPEAKERS WITHIN ENCLOSED EGRESS STAIRS. ONE SPEAKER SHALL BE LOCATED EVERY THIRD FLOOR. THE SPEAKERS SHALL BE LOCATED ON THE OPPOSITE STAIR LANDING WHERE THE FIRE WARDEN PHONES ARE BEING INSTALLED.
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BUILDING DEPARTMENT FIRE ALARM NOTES:
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Project No.: 14001A.000
Date: 20 JUN 2014
Scale: 1/8" = 1'-0"
File No.: FA-104.00
Sheet No.: FA-104.00
B-SCAN Sheet No.:
Page No.:

FIRE ALARM
LEVEL 4 FLOOR
PLAN -
MECHANICAL

1	19 NOV 2013	ISSUED FOR 3D PROGRESS PRICING
2	20 JUN 2014	ISSUED FOR FOUNDATION PERMIT



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250 State Street #F1, North Haven, CT 06473

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40 Wall Street, New York, NY 10005


Acoustical Consultant
Cerami & Associates
404 Fifth Avenue #8, New York, NY 10016

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Rowan Williams Davies & Irwin Inc.
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Ontario, Canada N1K 1B8



FIRE ALARM NOTES

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Project No.: 14001A.000		Sheet No.: FA-105.00	
Date: 20 JUN 2014		B-SCAN Sheet No.:	
Scale: 1/8" = 1'-0"		Page No.:	
File No.: FA-105.00			

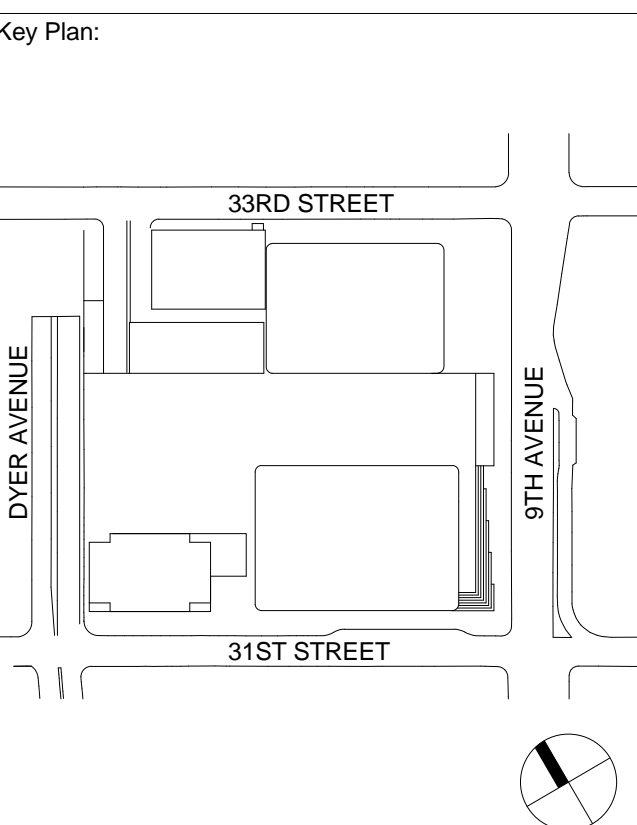SHEET NOTES



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65 Broadway, Suite 401, New York, NY 10006

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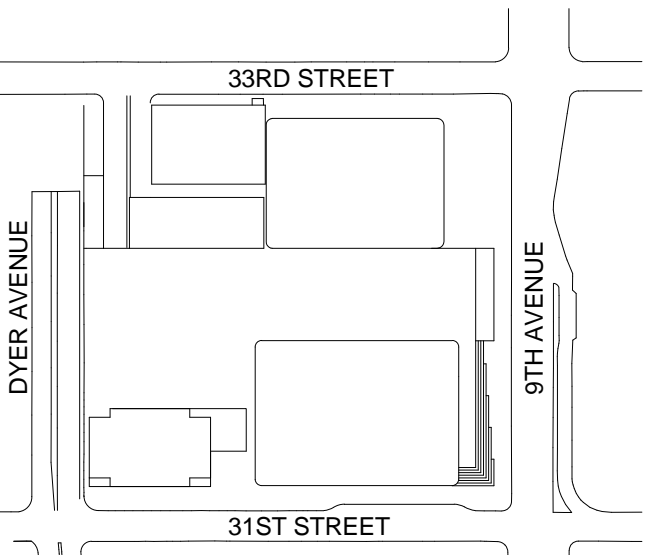
Facade Maintenance Consultant

Entek Engineering LLC
166 Ames Street, Hackensack, NJ 07601


Wind Tunnel Consultant

Rowan Williams Davies & Irwin Inc.
650 Woodlawn Road West, Guelph
Ontario, Canada N1K 1B8

Key Plan:



Seal & Signature:

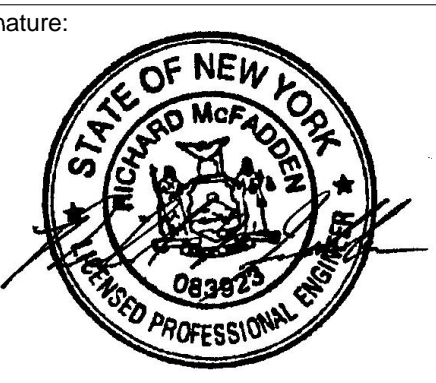

FIRE ALARM NOTES

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BUILDING DEPARTMENT FIRE ALARM NOTES:
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FIRE ALARM
LEVEL 6-67
FLOOR PLAN -
TYPICAL OFFICE
FLOOR

Project No.:

14801-A-000

Date:

20 JUN 2014

Scale:

1/8" = 1'-0"

File No.:

FA-106.00

Sheet No.:


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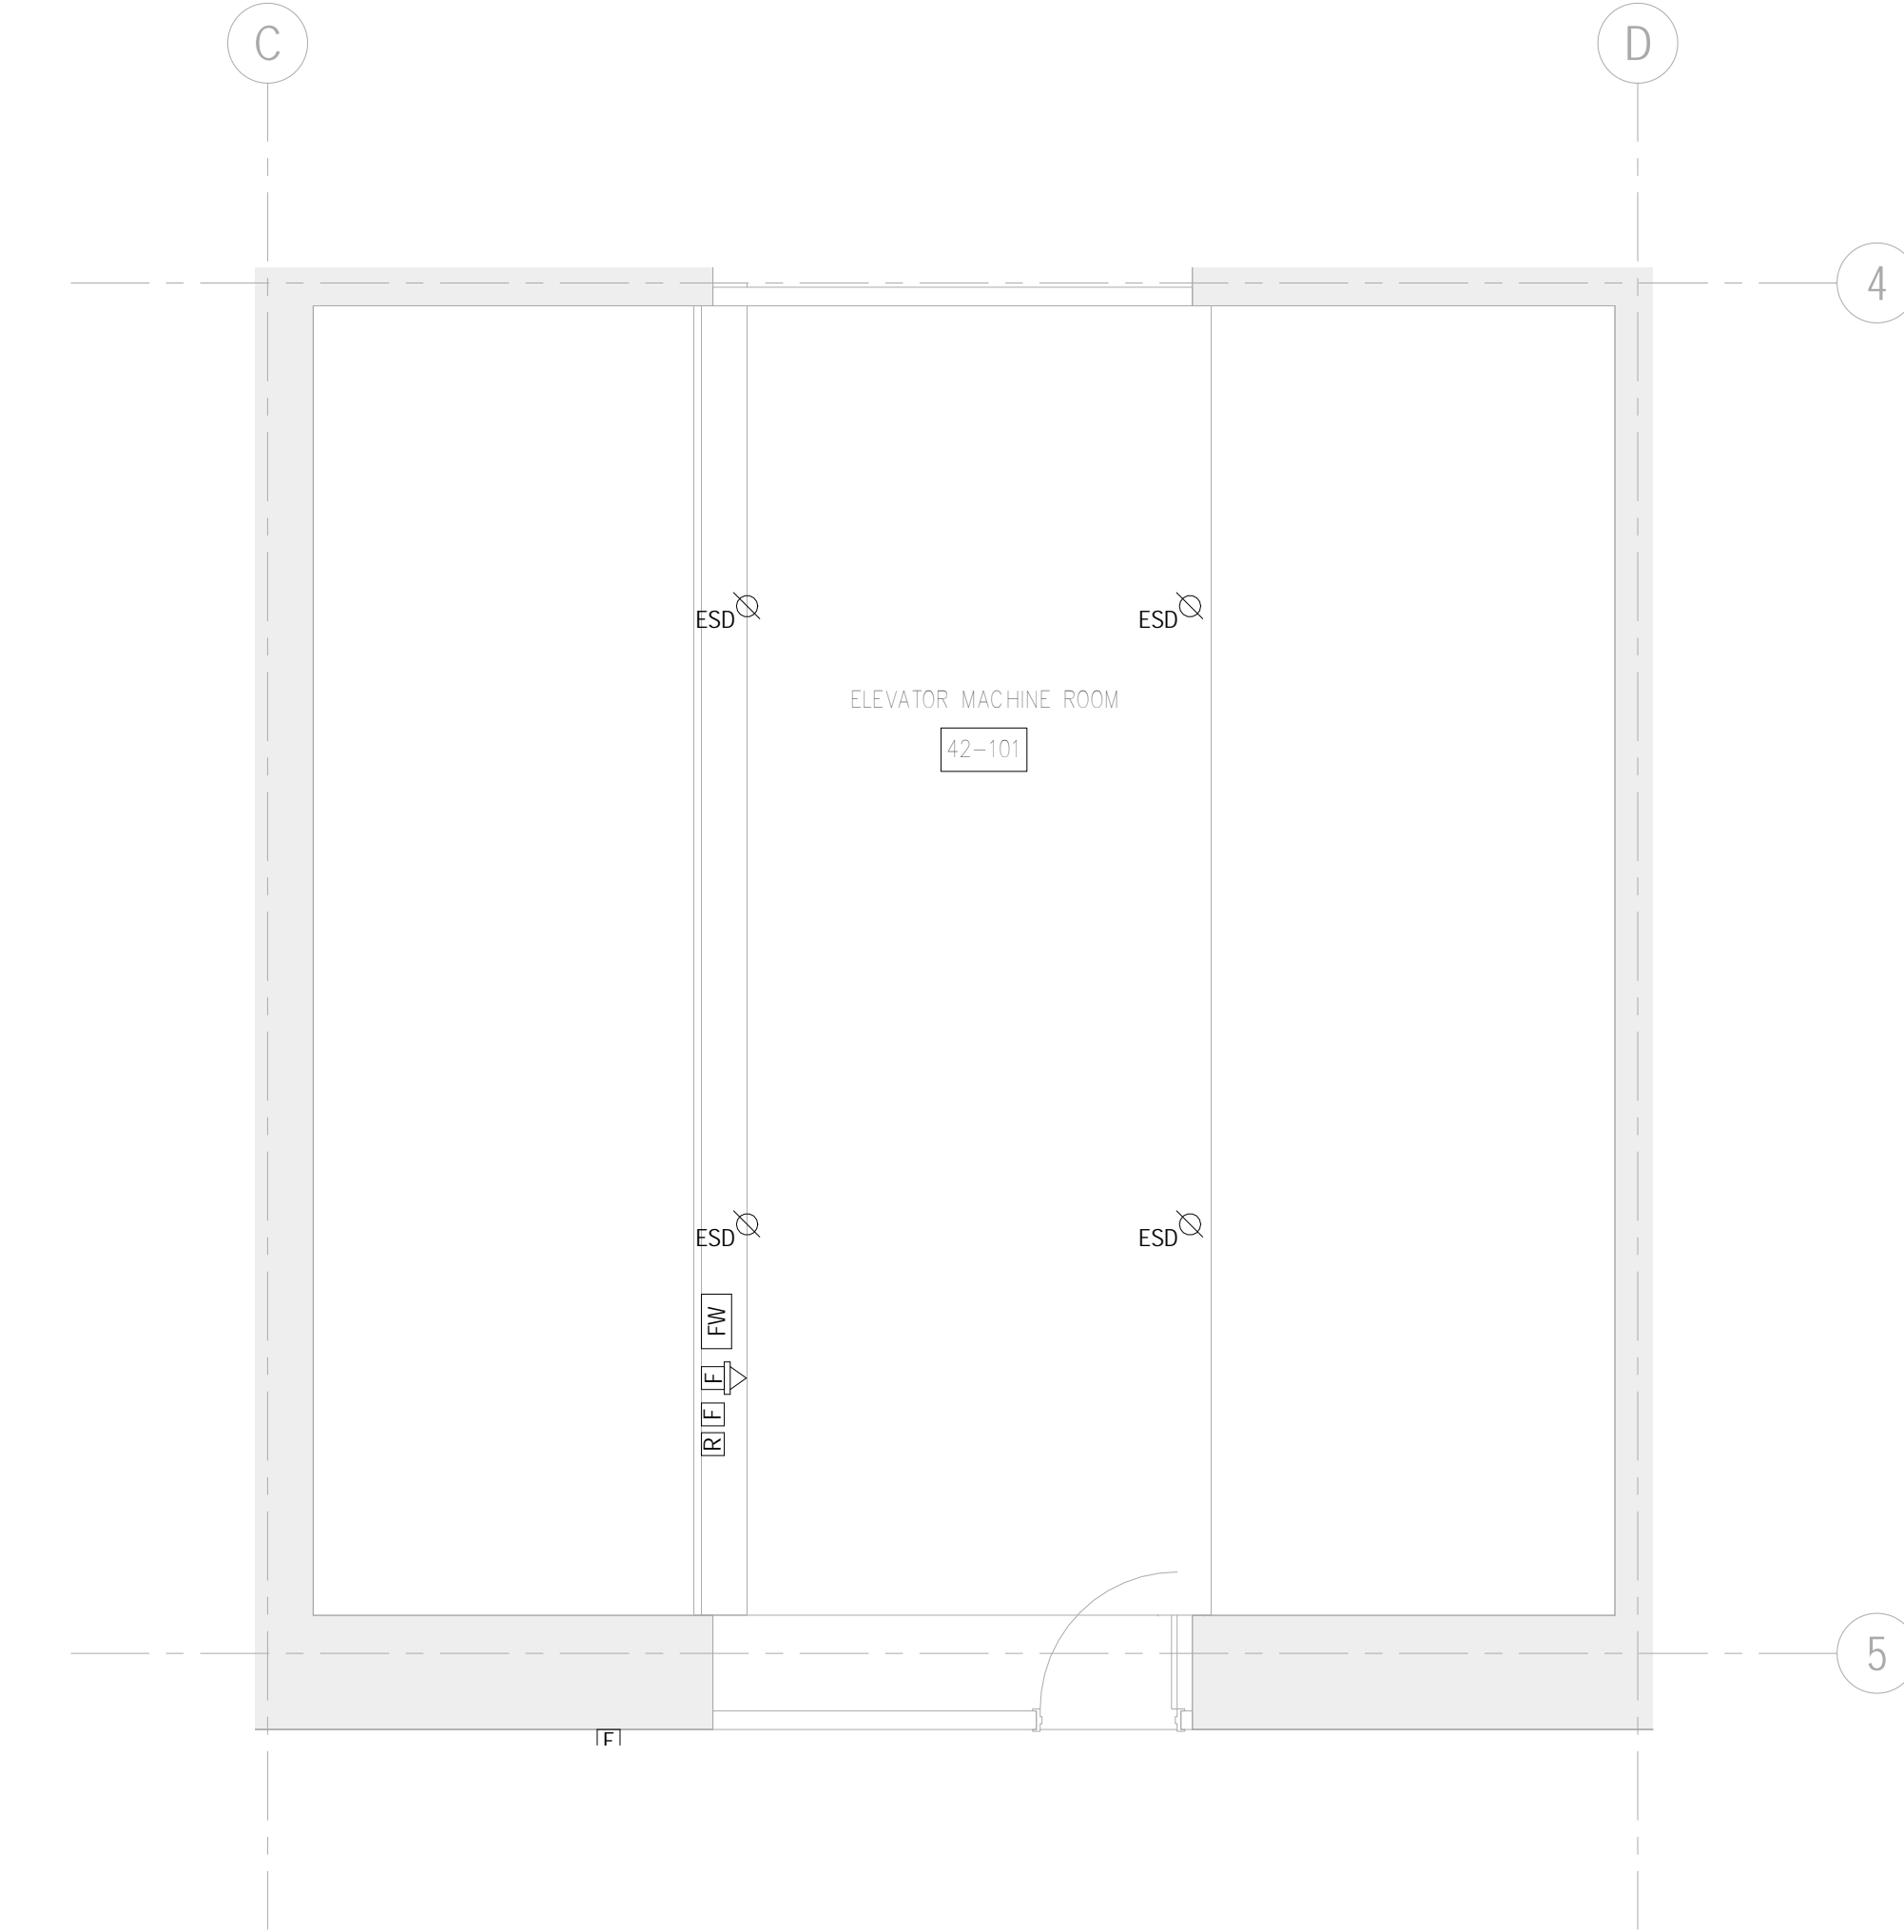
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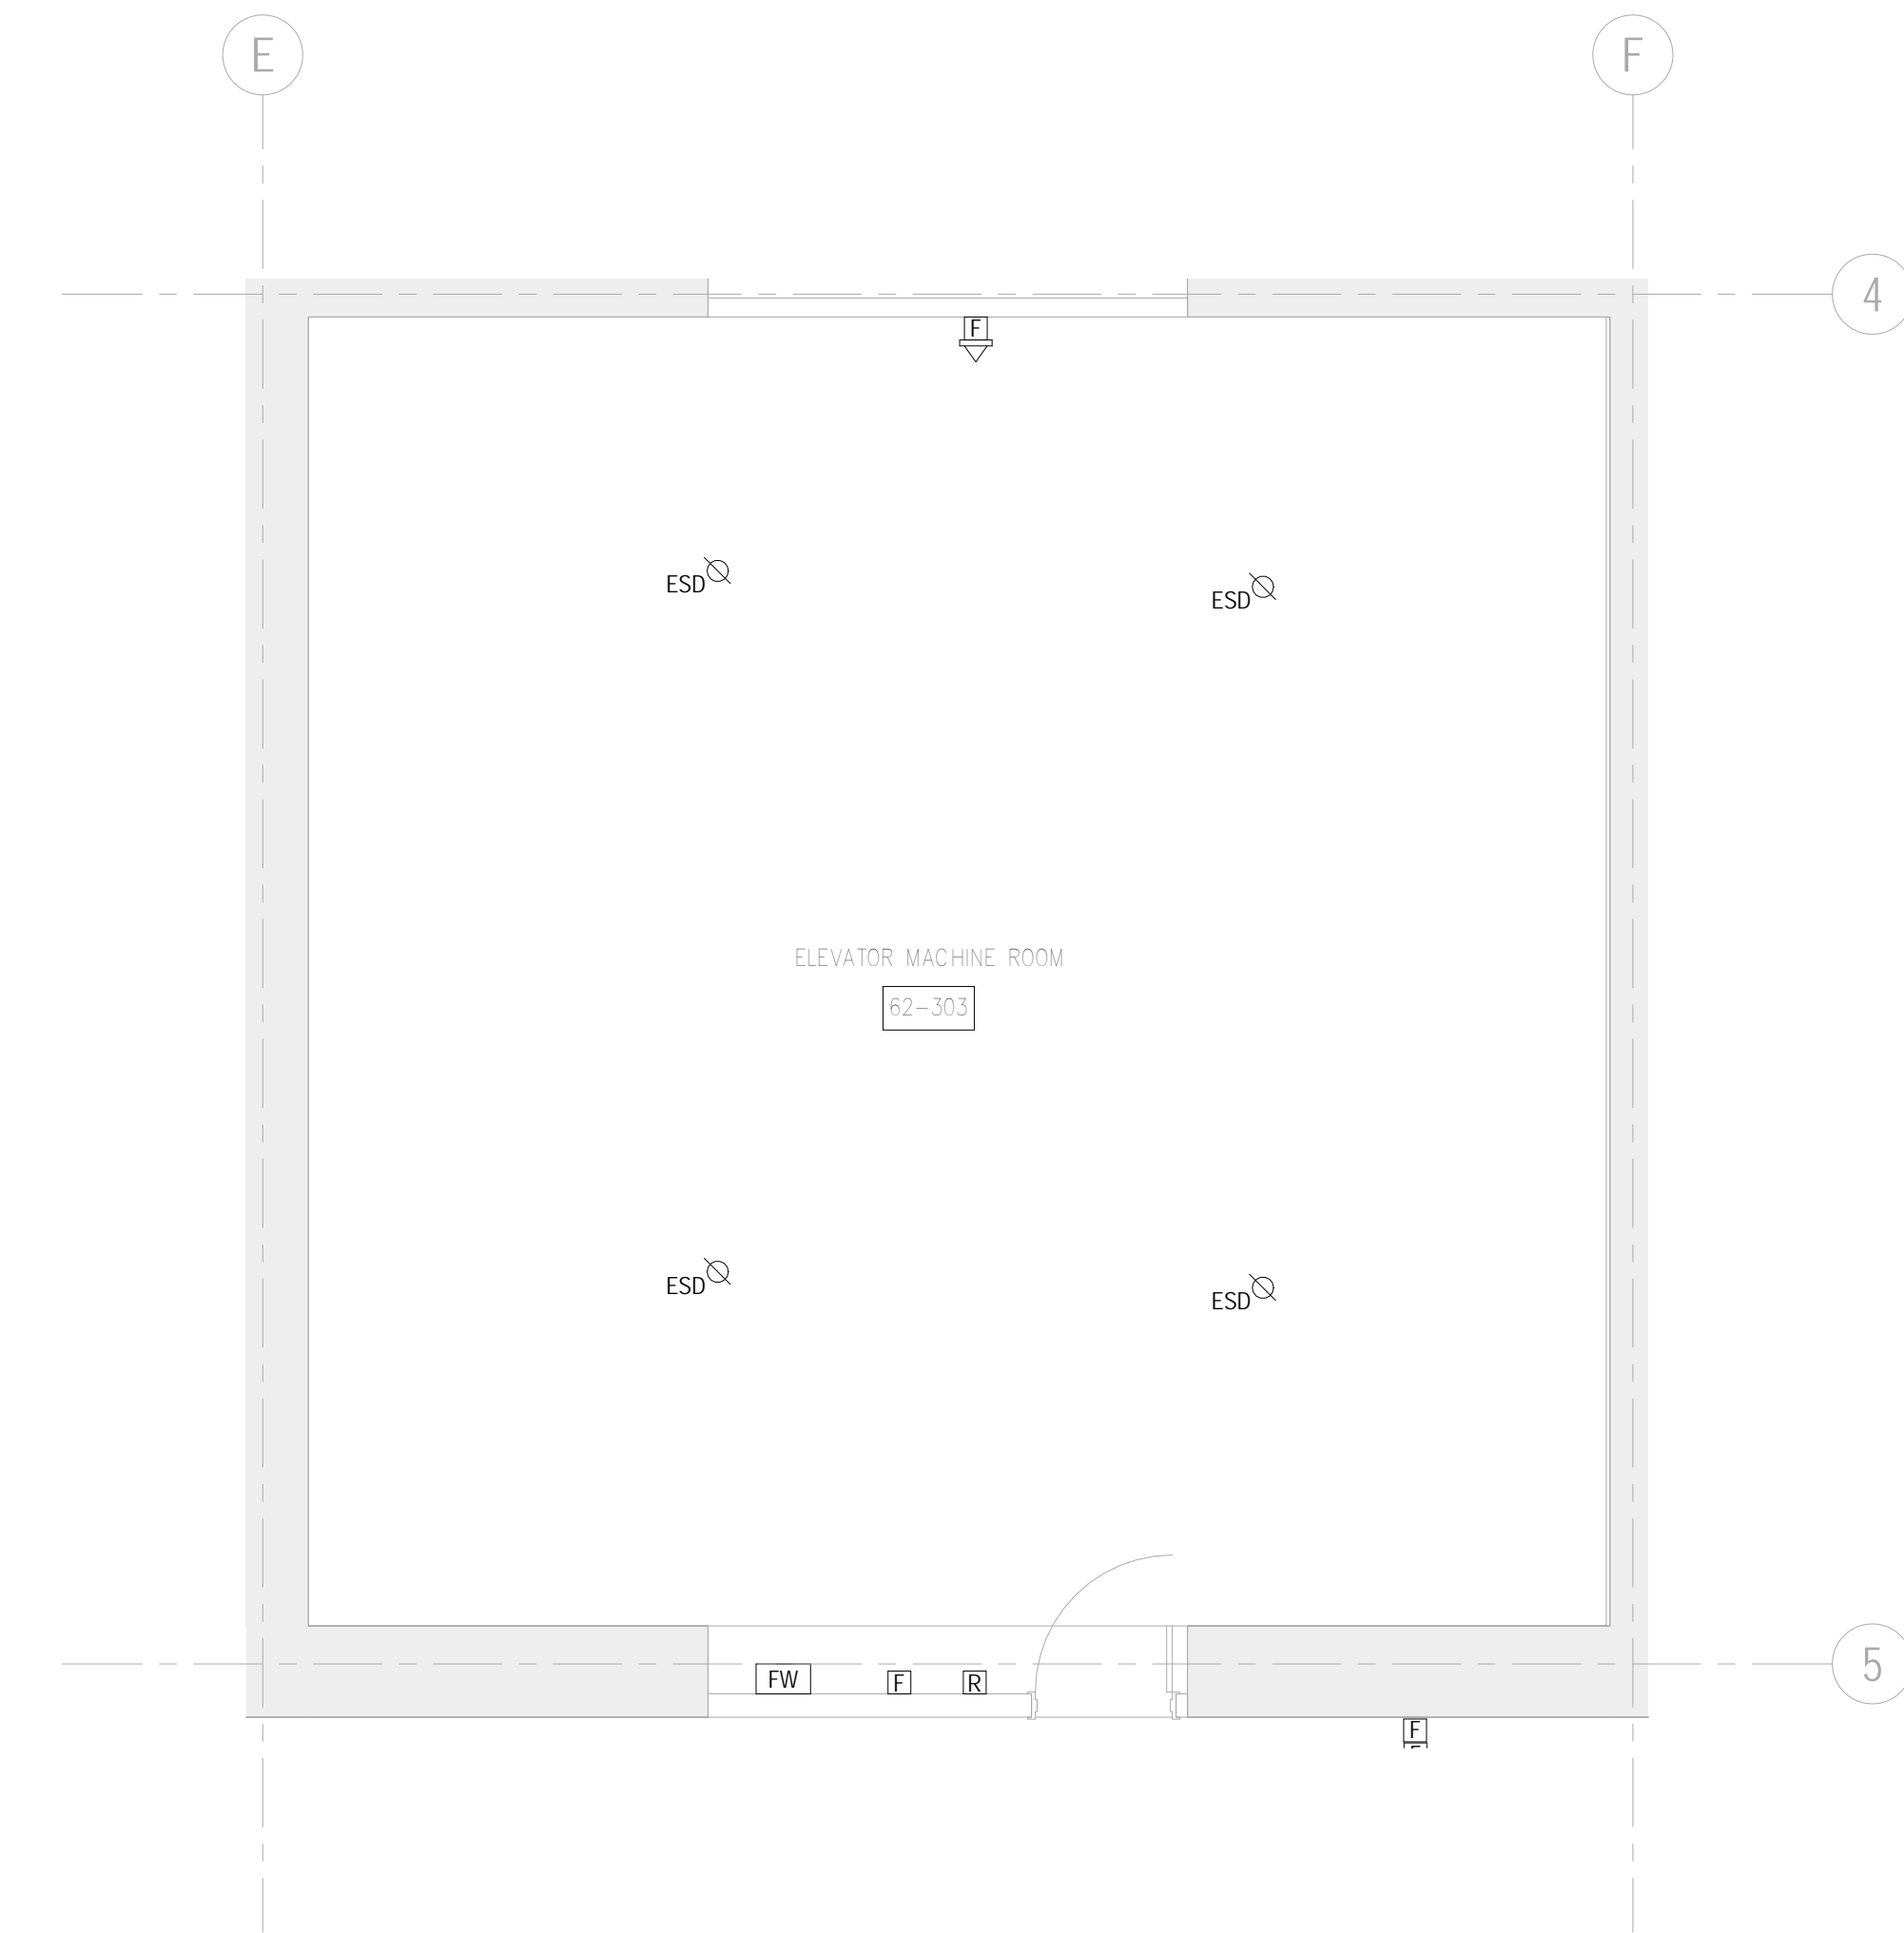
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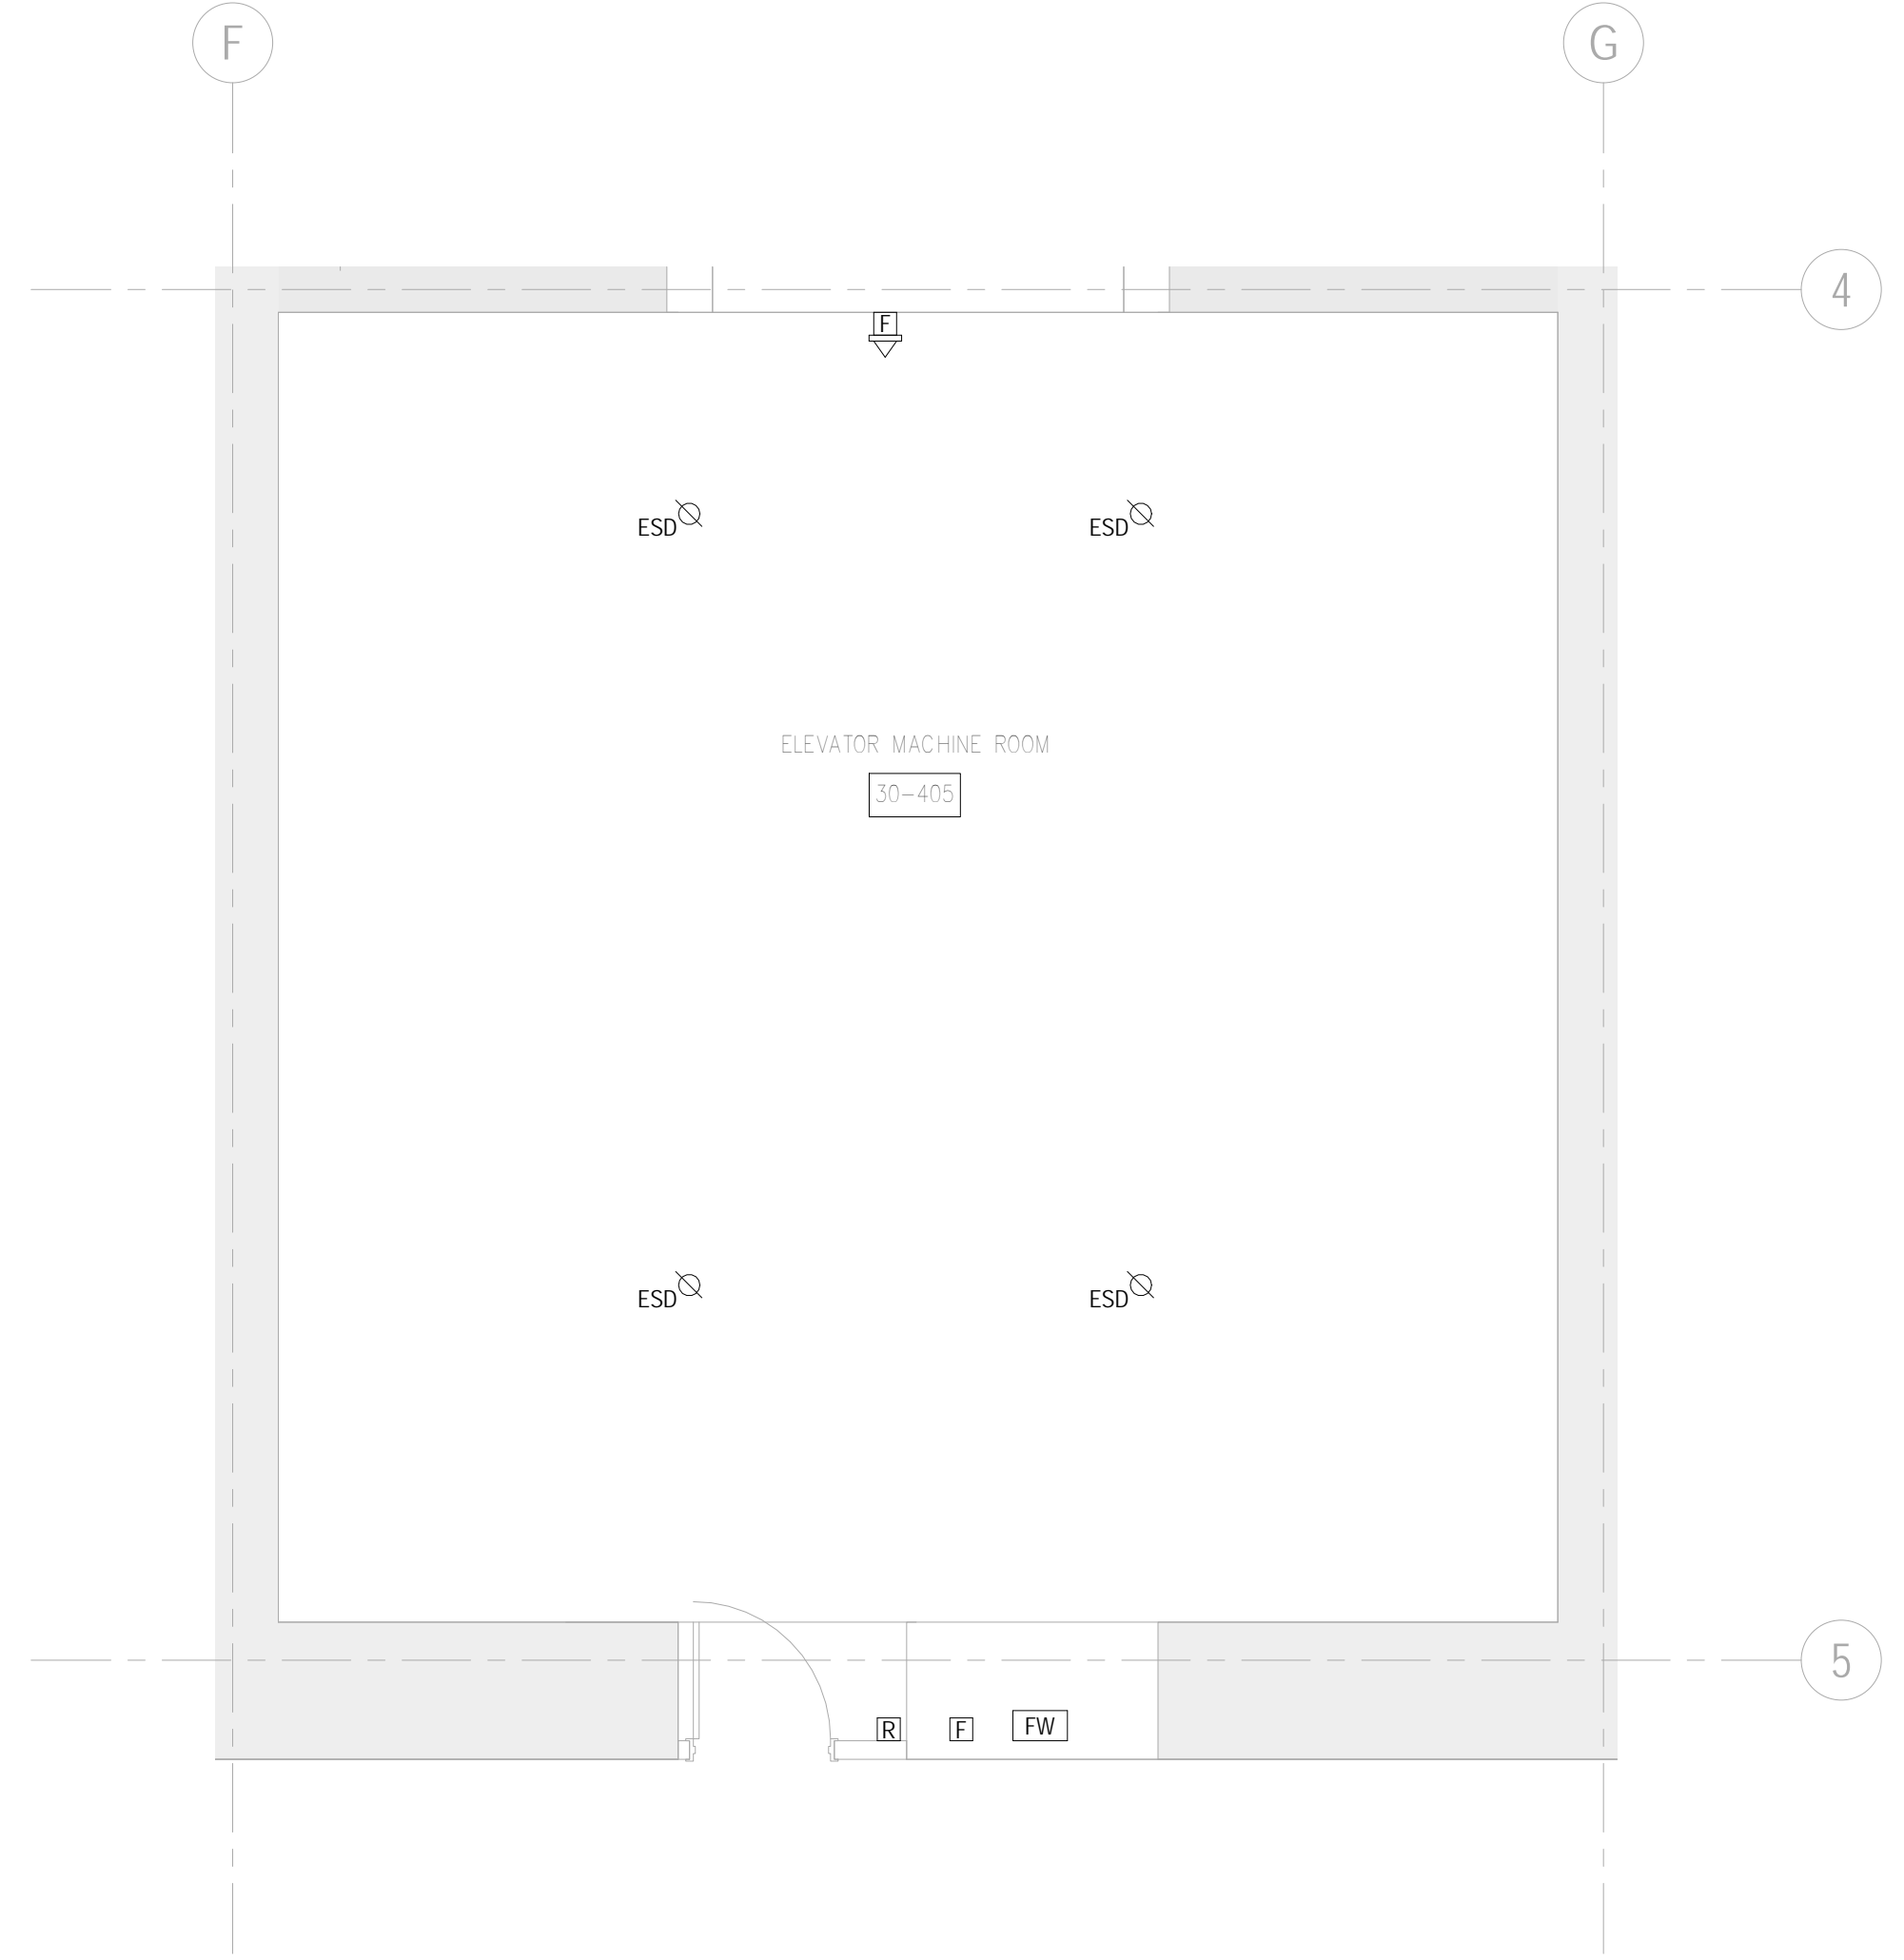
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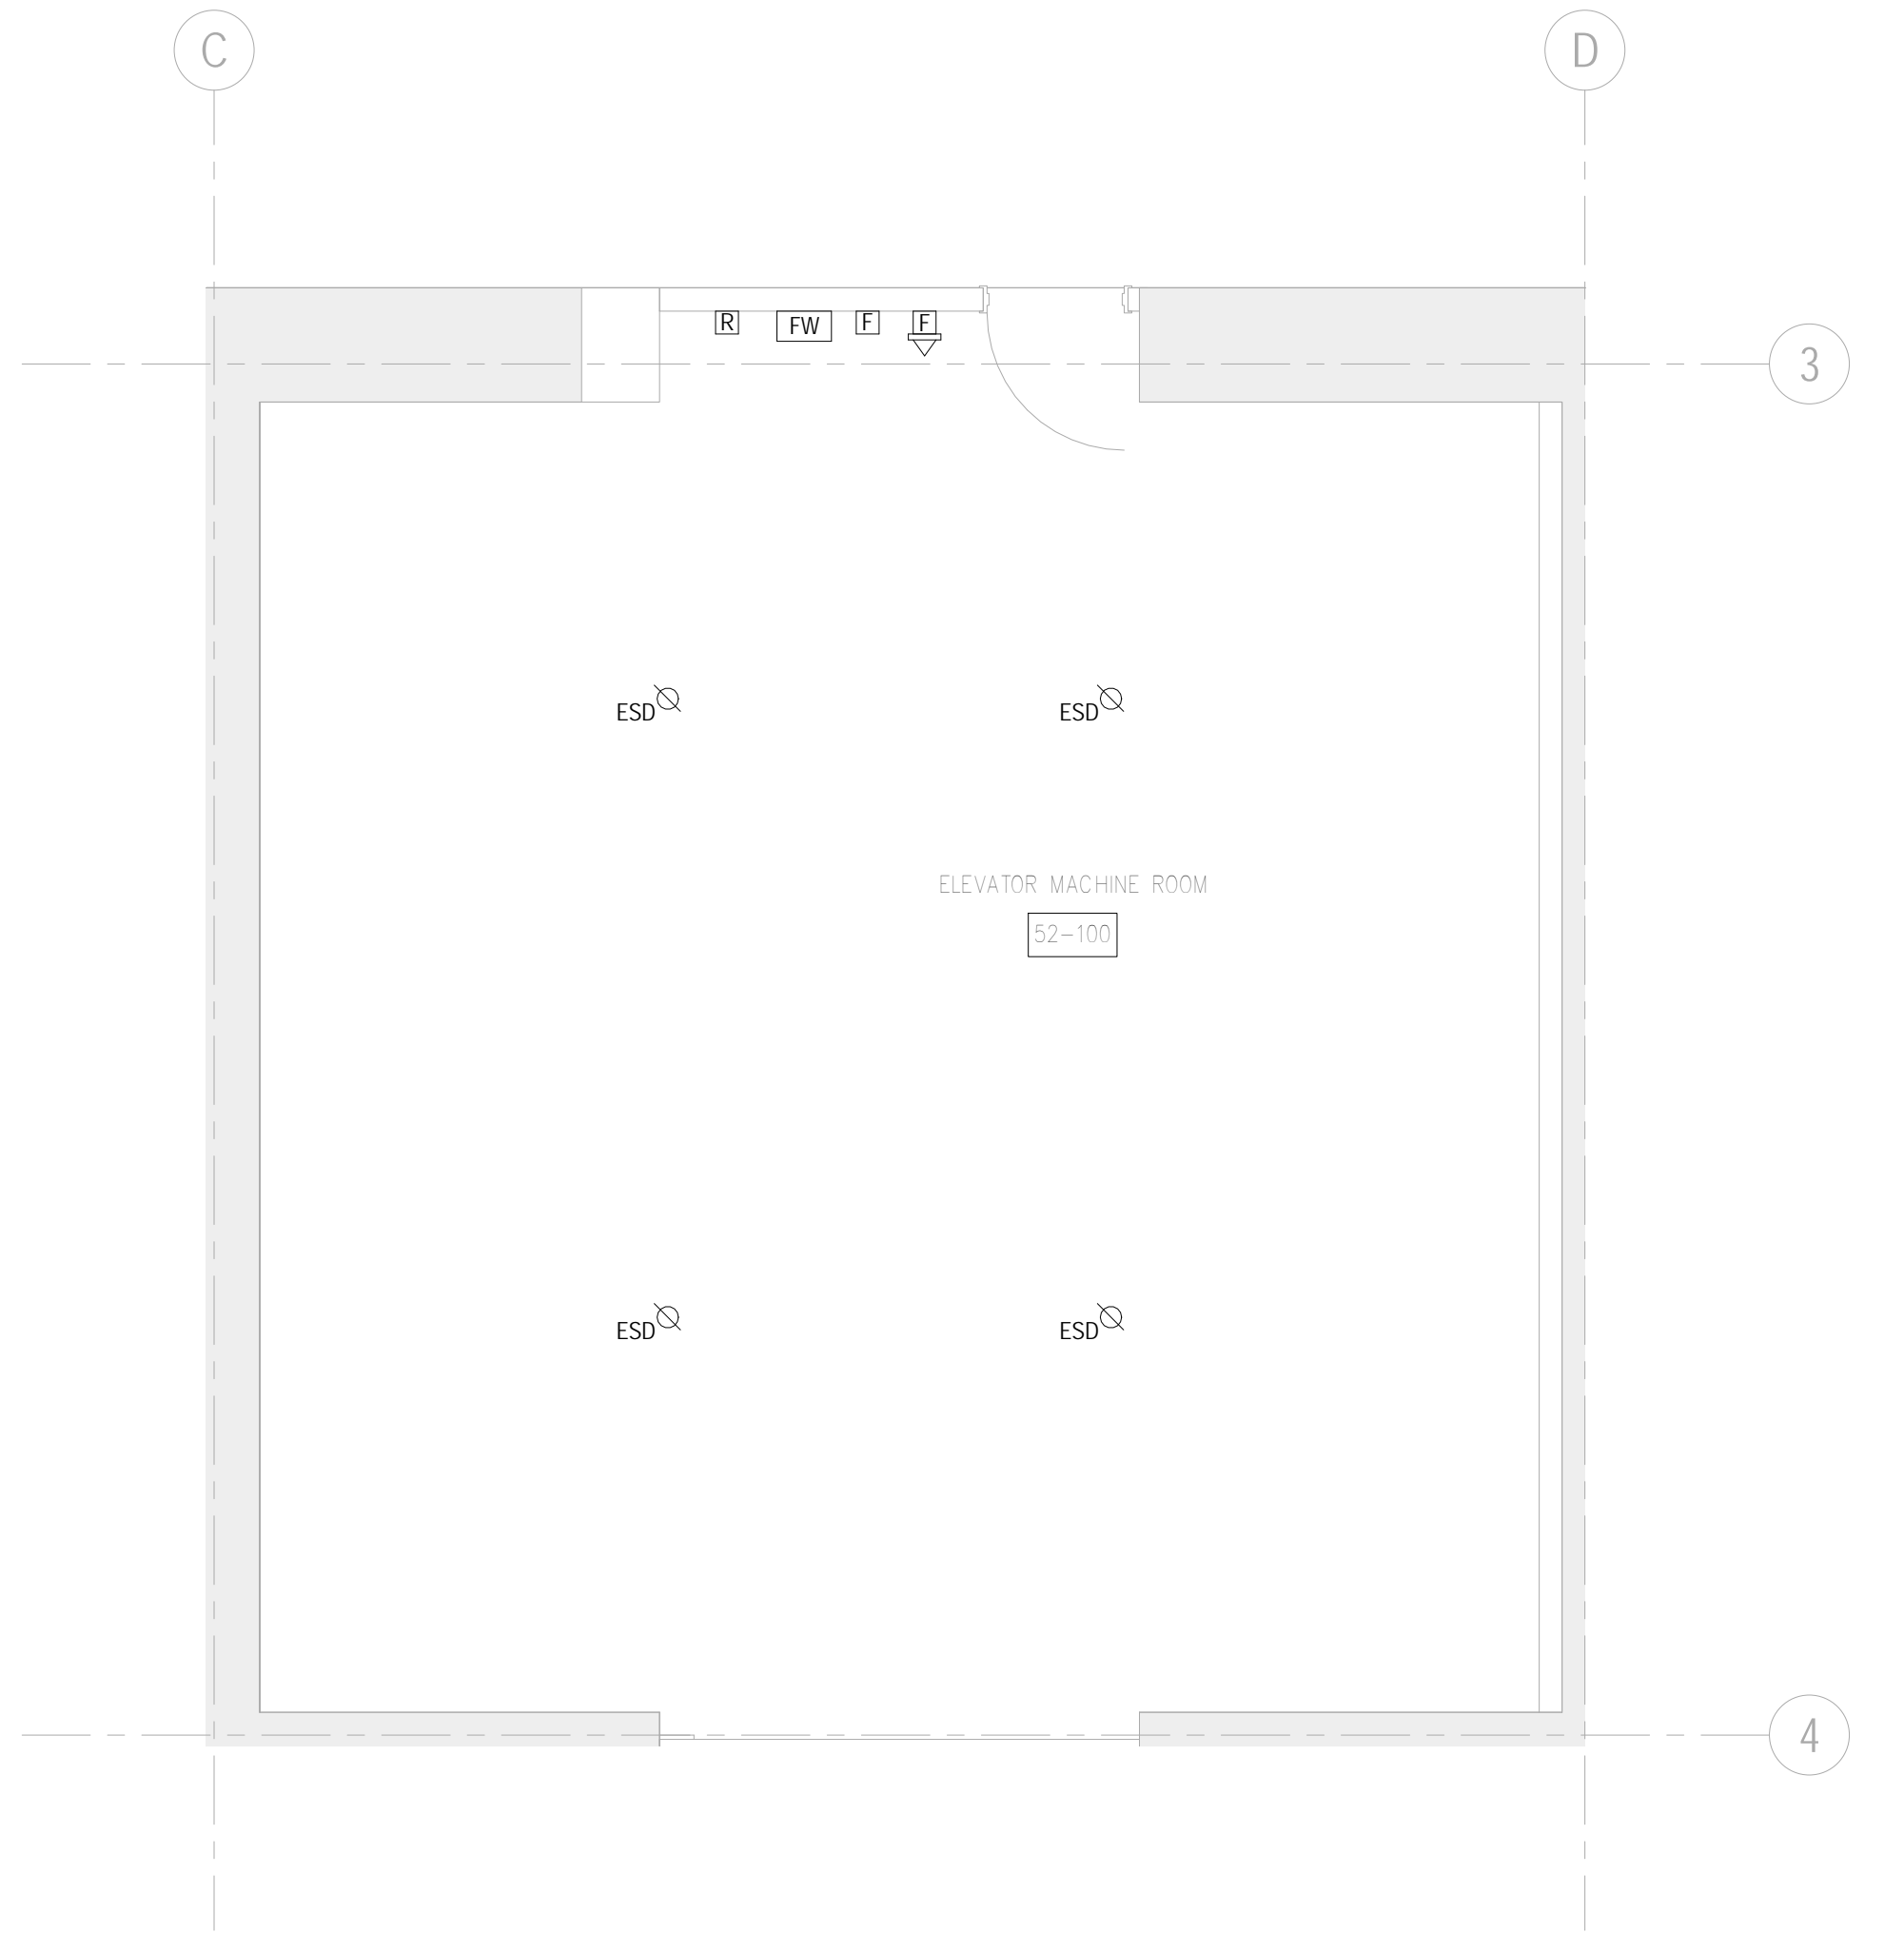
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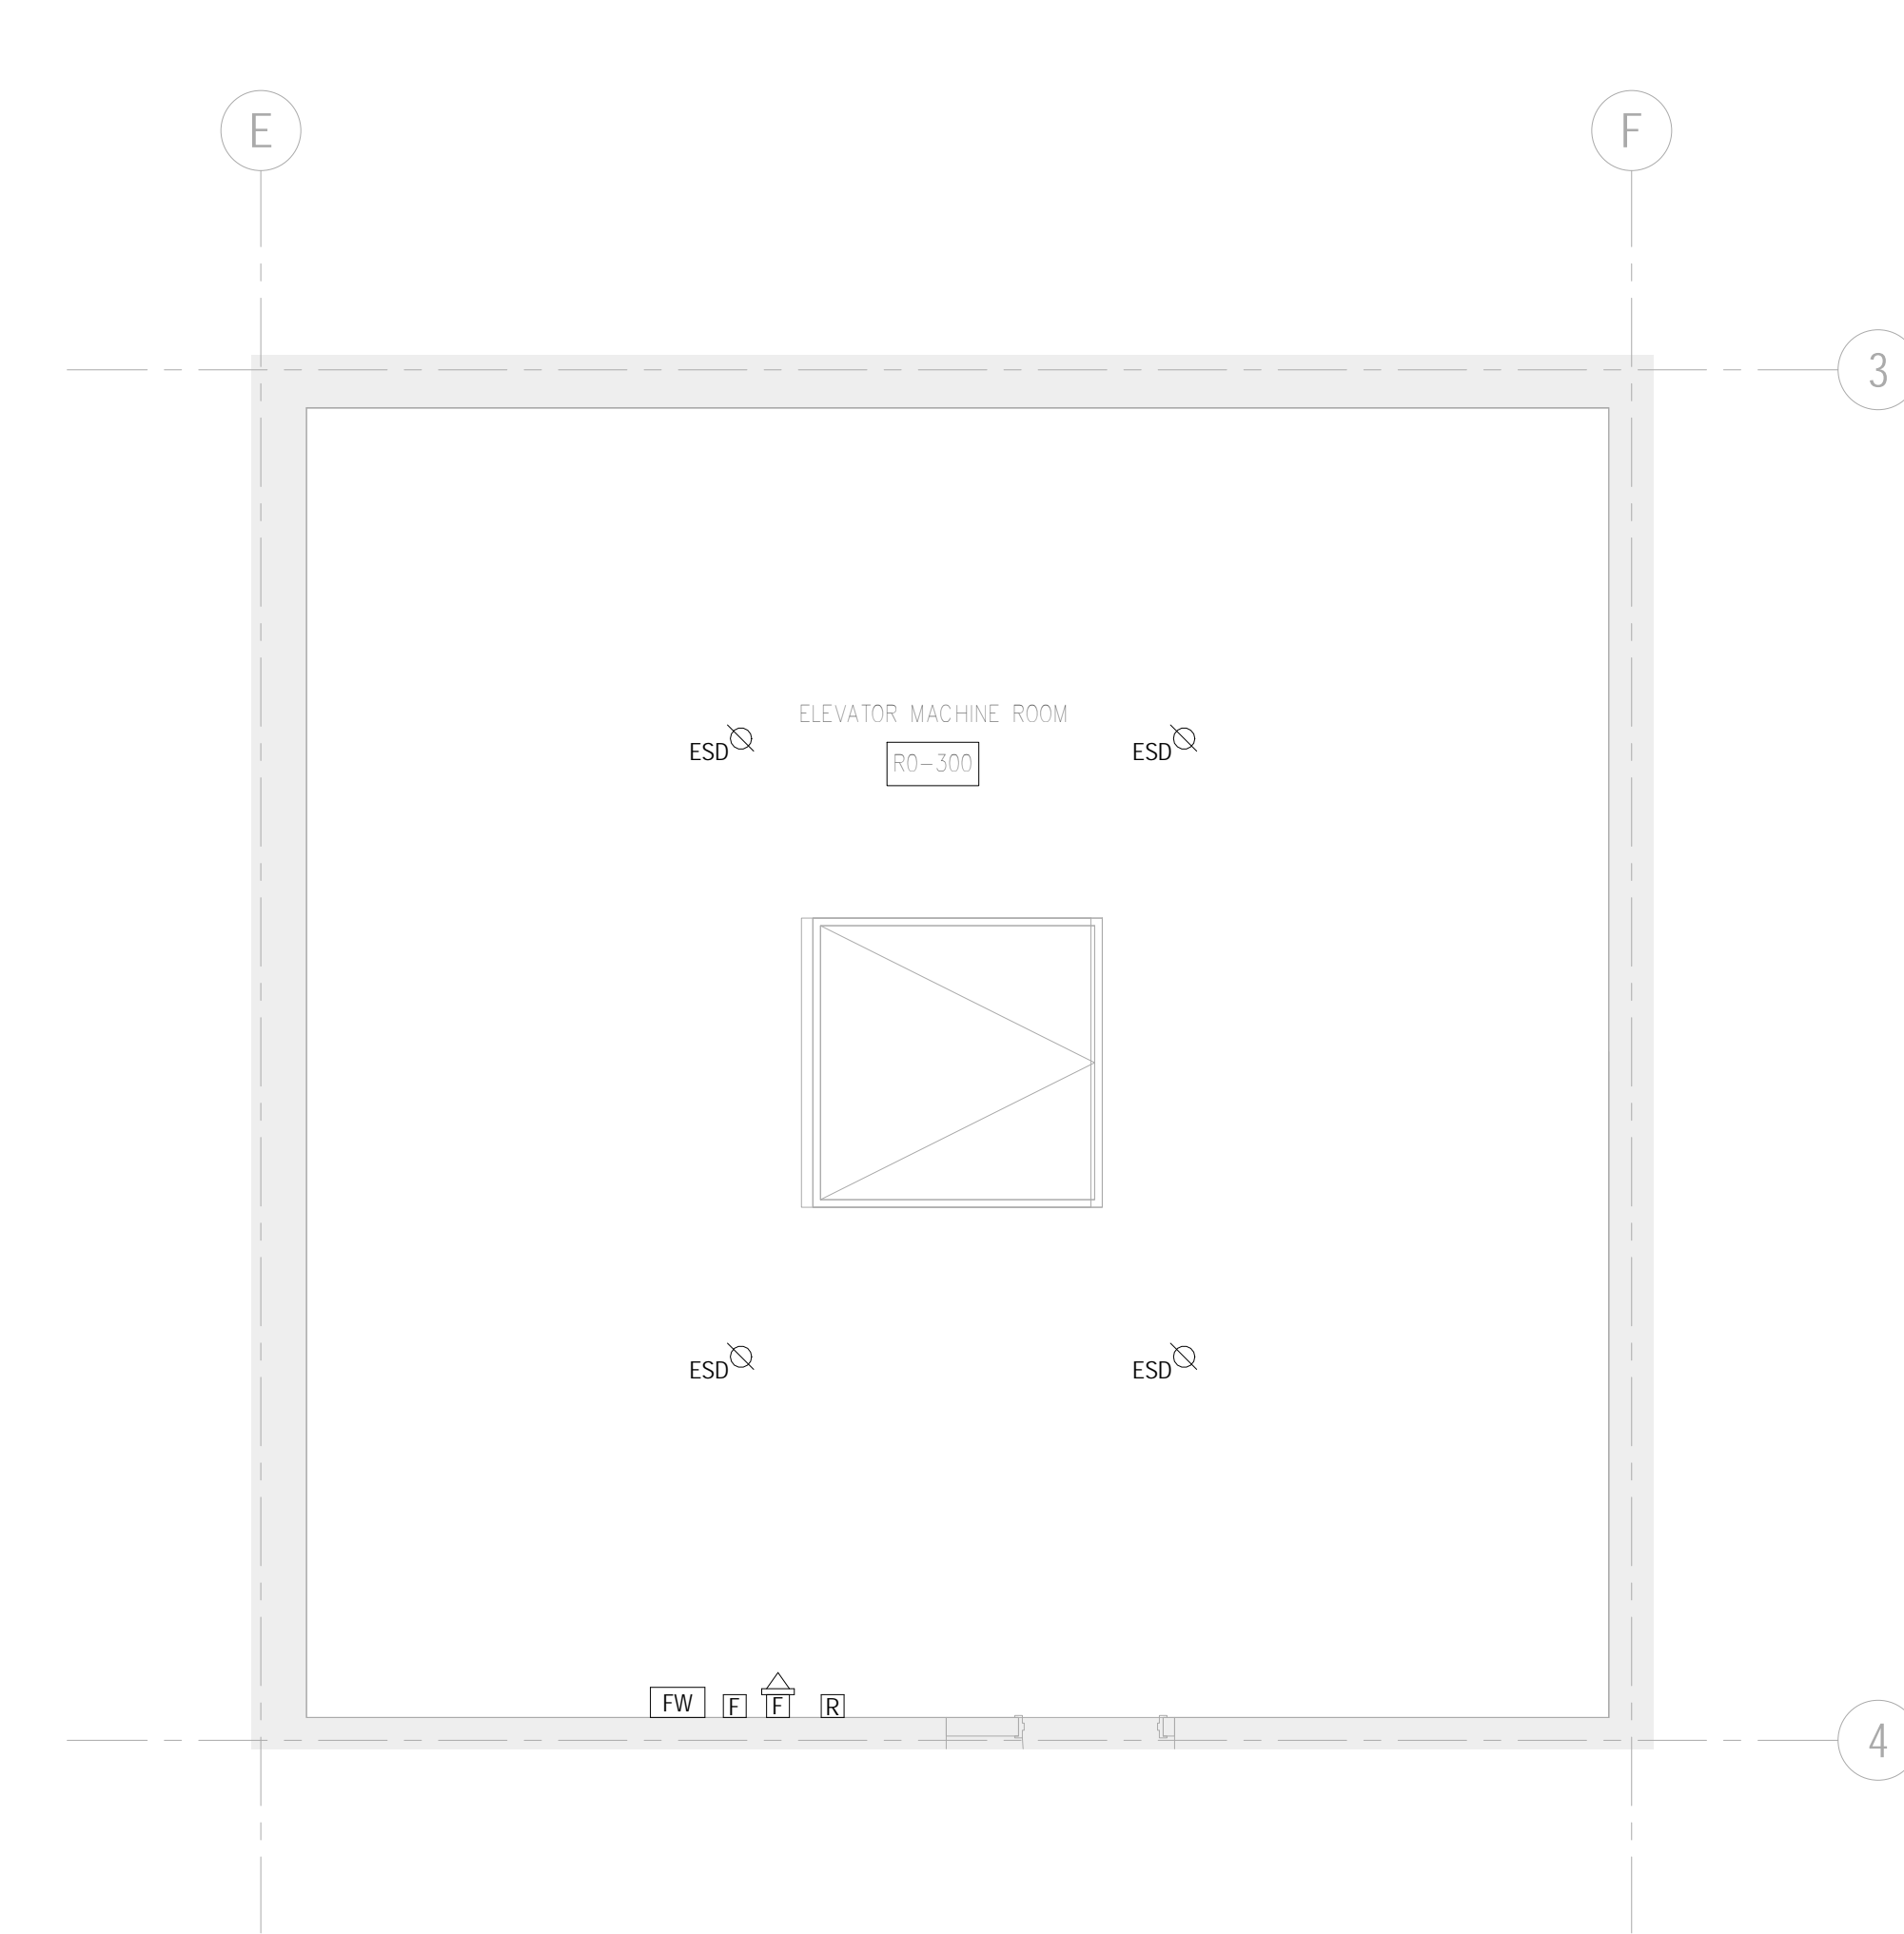
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2 FA LEVEL 30 EMR
1/4" = 1'-0"



4 FA LEVEL 62 EMR
1/4" = 1'-0"



6 FA MECH. PENTHOUSE EMR
1/4" = 1'-0"

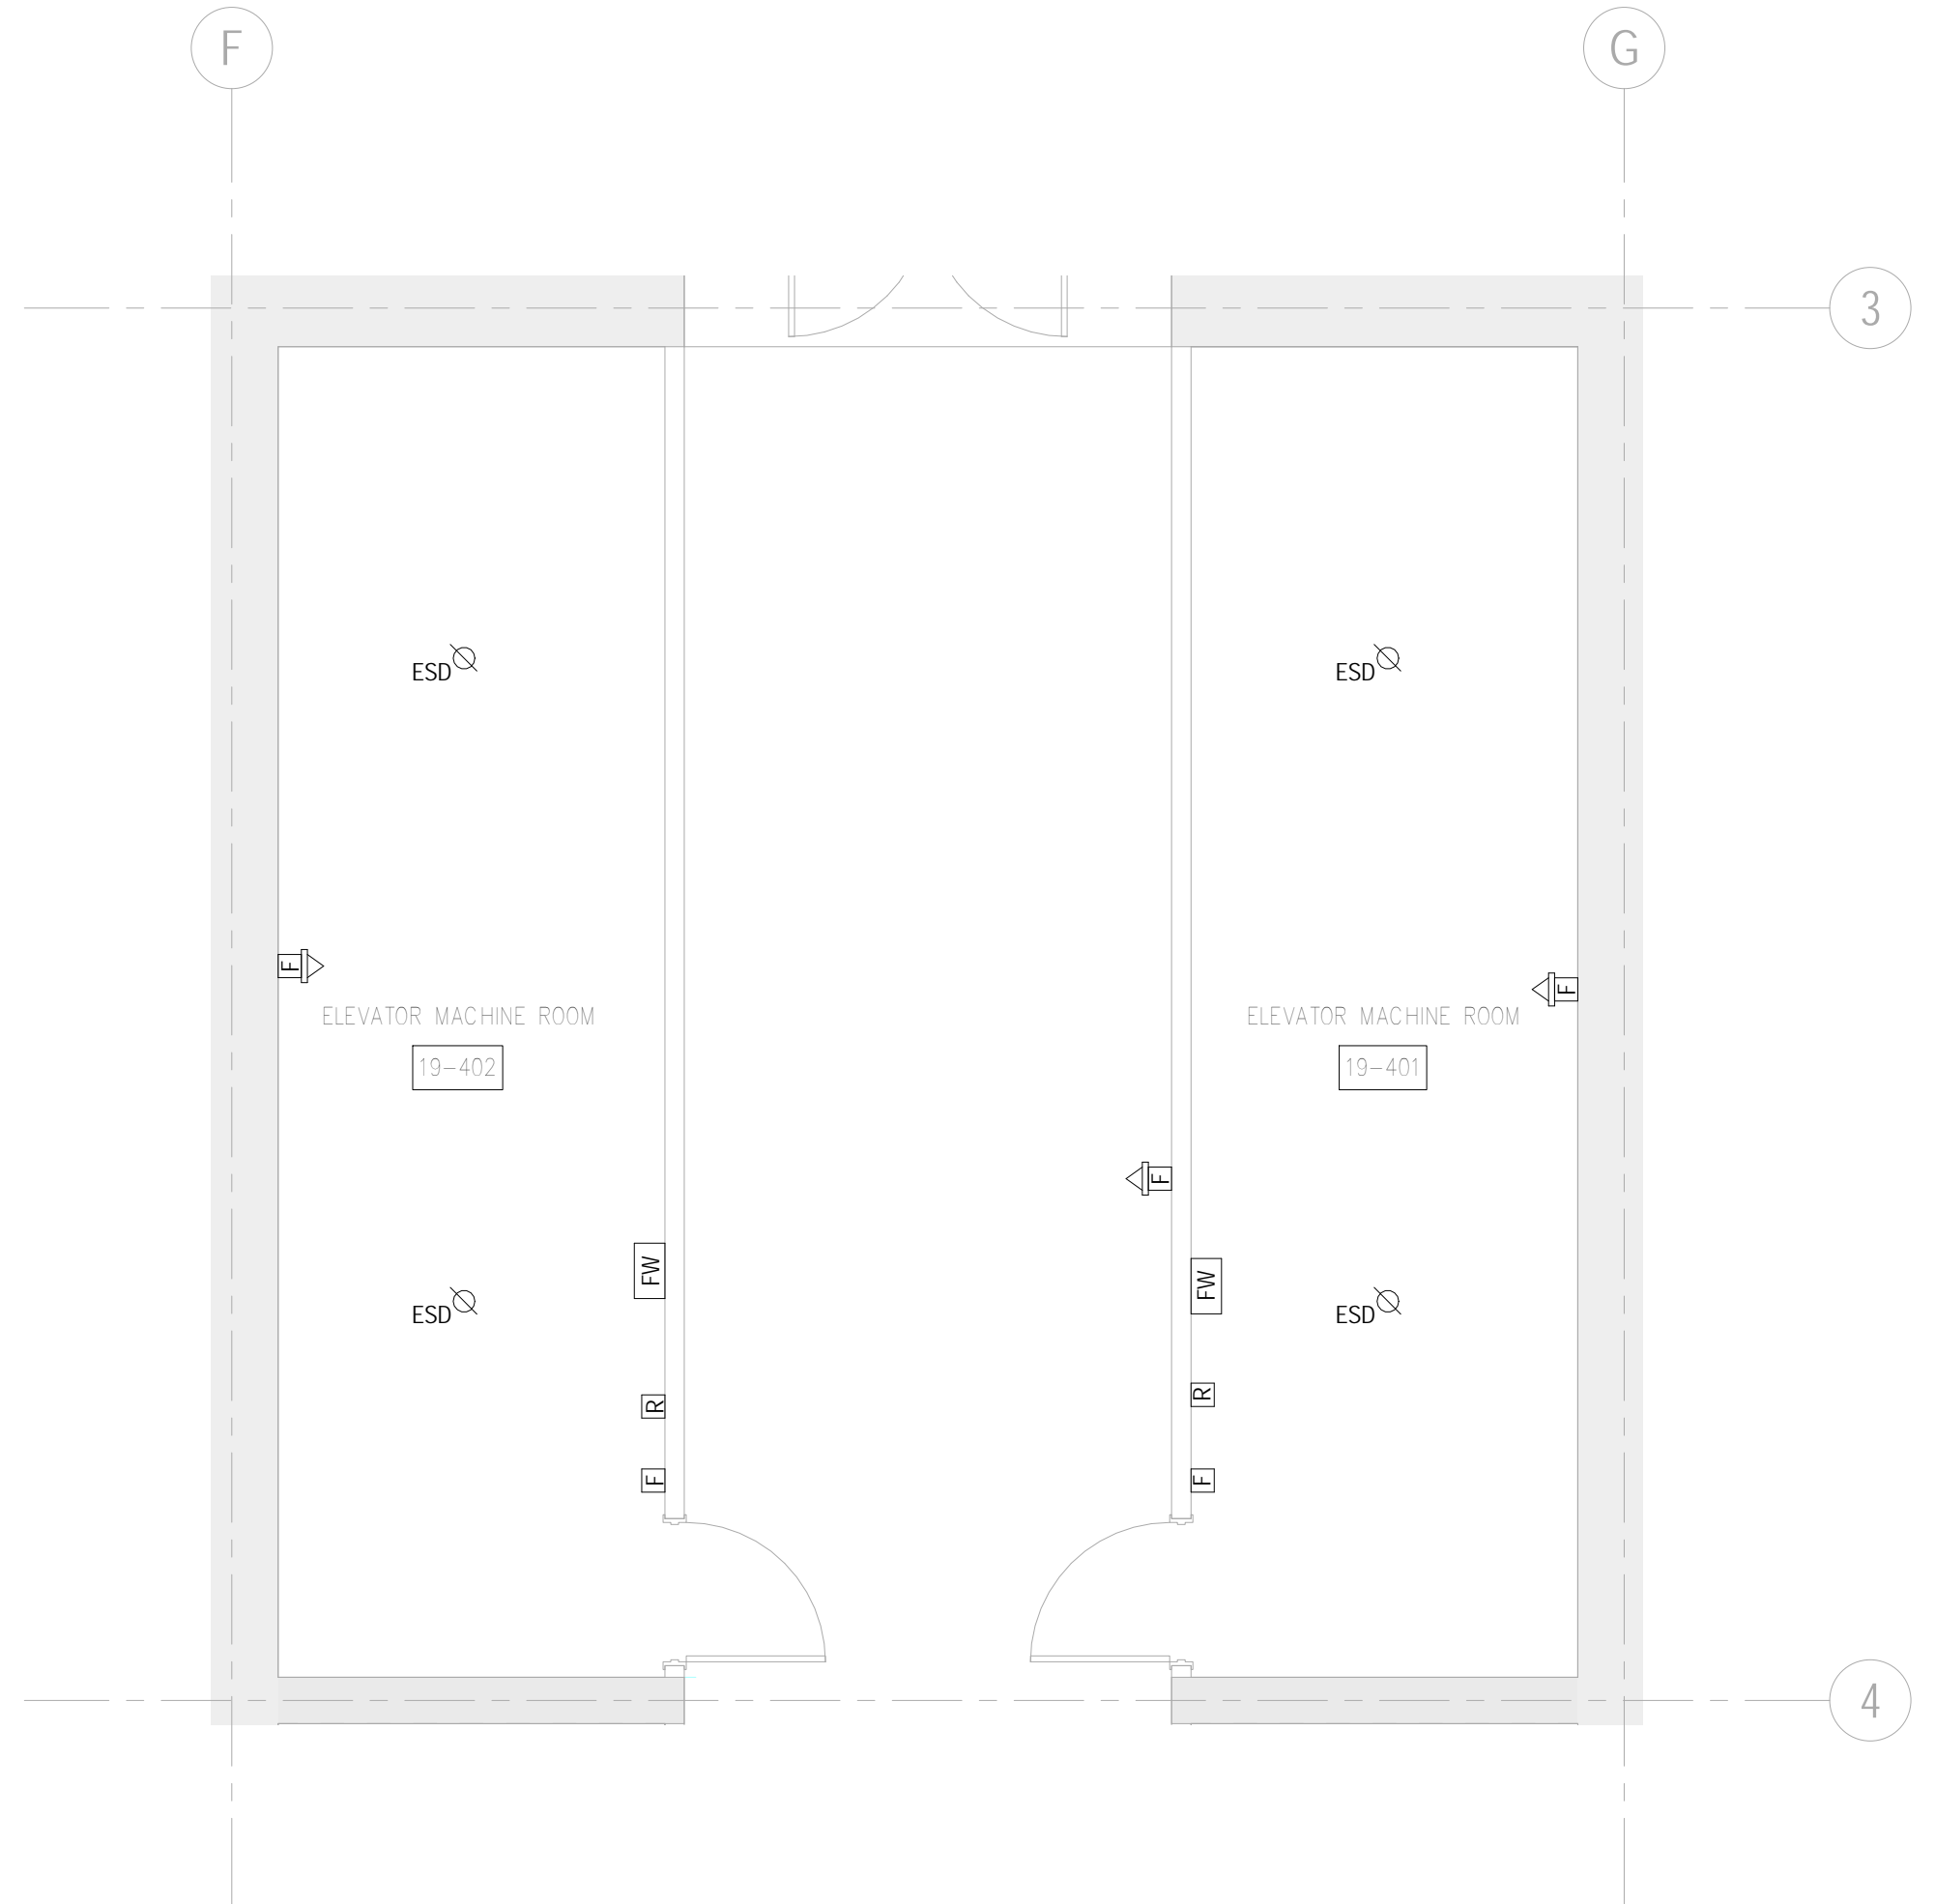BUILDING DEPARTMENT FIRE ALARM NOTES:
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SHEET NOTES



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650 Woodlawn Road West, Guelph
Ontario, Canada N1K 1B8

Key Plan:



Seal & Signature:



No. Date Description


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**FIRE ALARM EMR
PART PLAN**

Project No.: 14830.A.000 Sheet No.: **FA-300.00**


Date: Scale: 1/4" = 1'-0"

File No.: FA-300.00 Page No.: OF

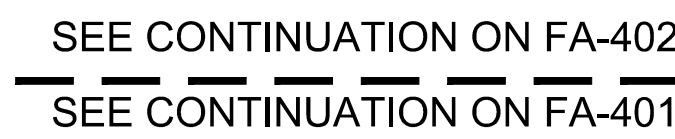

the 1990s, the number of people in the United States who are 65 years of age or older has increased by 50 percent. The number of people 75 years of age or older has increased by 100 percent. The number of people 85 years of age or older has increased by 200 percent. The number of people 95 years of age or older has increased by 400 percent. The number of people 100 years of age or older has increased by 1,000 percent.


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FIRE ALARM RISED
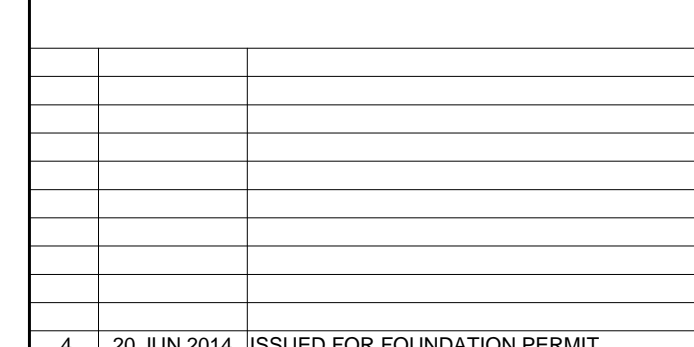
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Project No.: 14530	Sheet No.: FA-401.00
Date: 20 JUN 2014	
Scale: 1/8"=1'-0"	
File No.: FA-401.00	Page No.:



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Project No.: 14830
Date: 20 JUN 2014
Scale: 1/8"=1'-0"
File No.: FA-402.00
Sheet No.: FA-402.00
Page No.:


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Sheet Name:
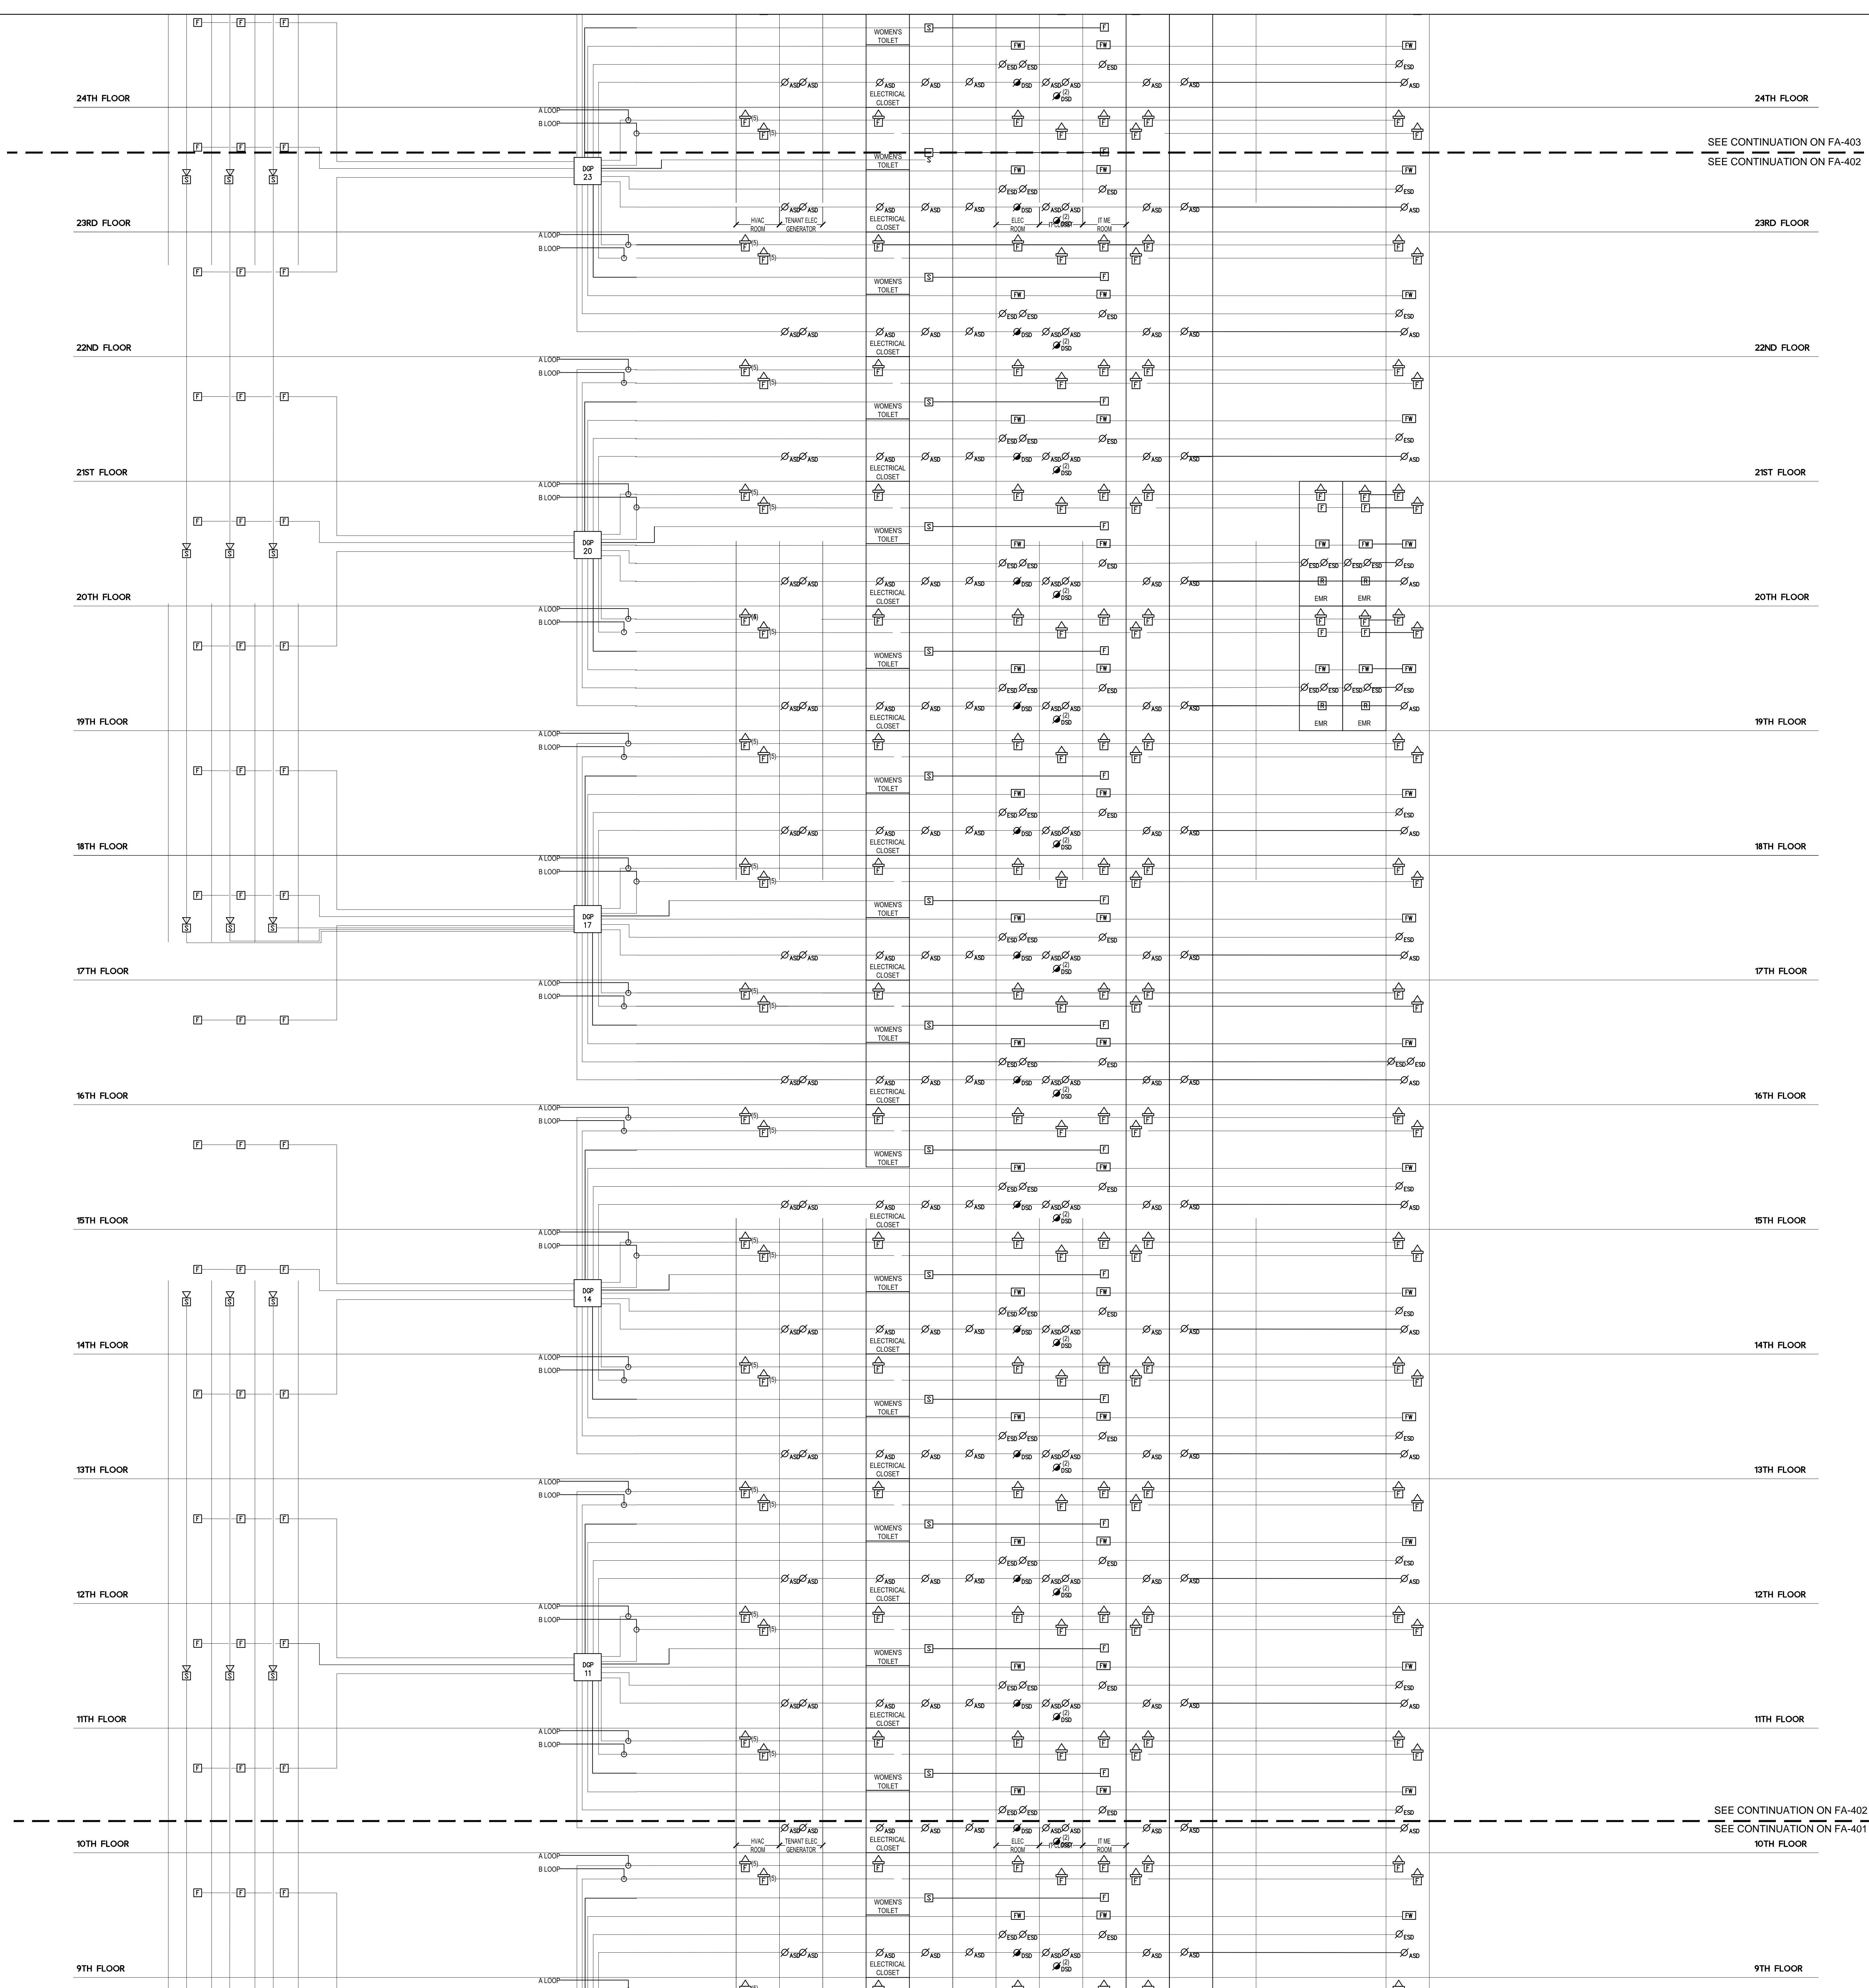
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3	10 NOV 2013	ISSUED FOR DD PROGRESS PRICING
2	12 JUL 2013	ISSUED FOR SPL DESIGN DEVELOPMENT
1	15 MAR 2013	ISSUED FOR RECONCILIATION



Seal & Signature:

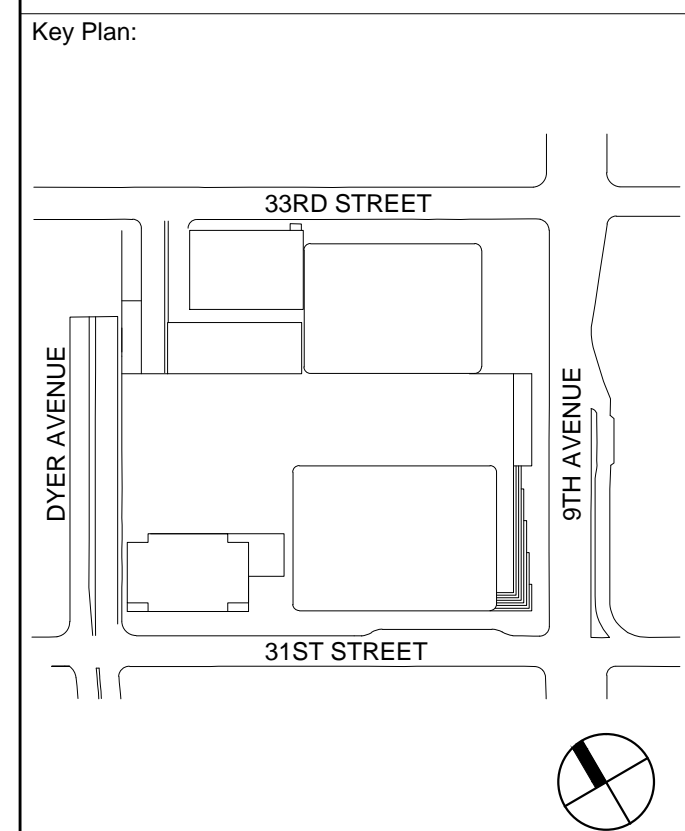

Key Plan:

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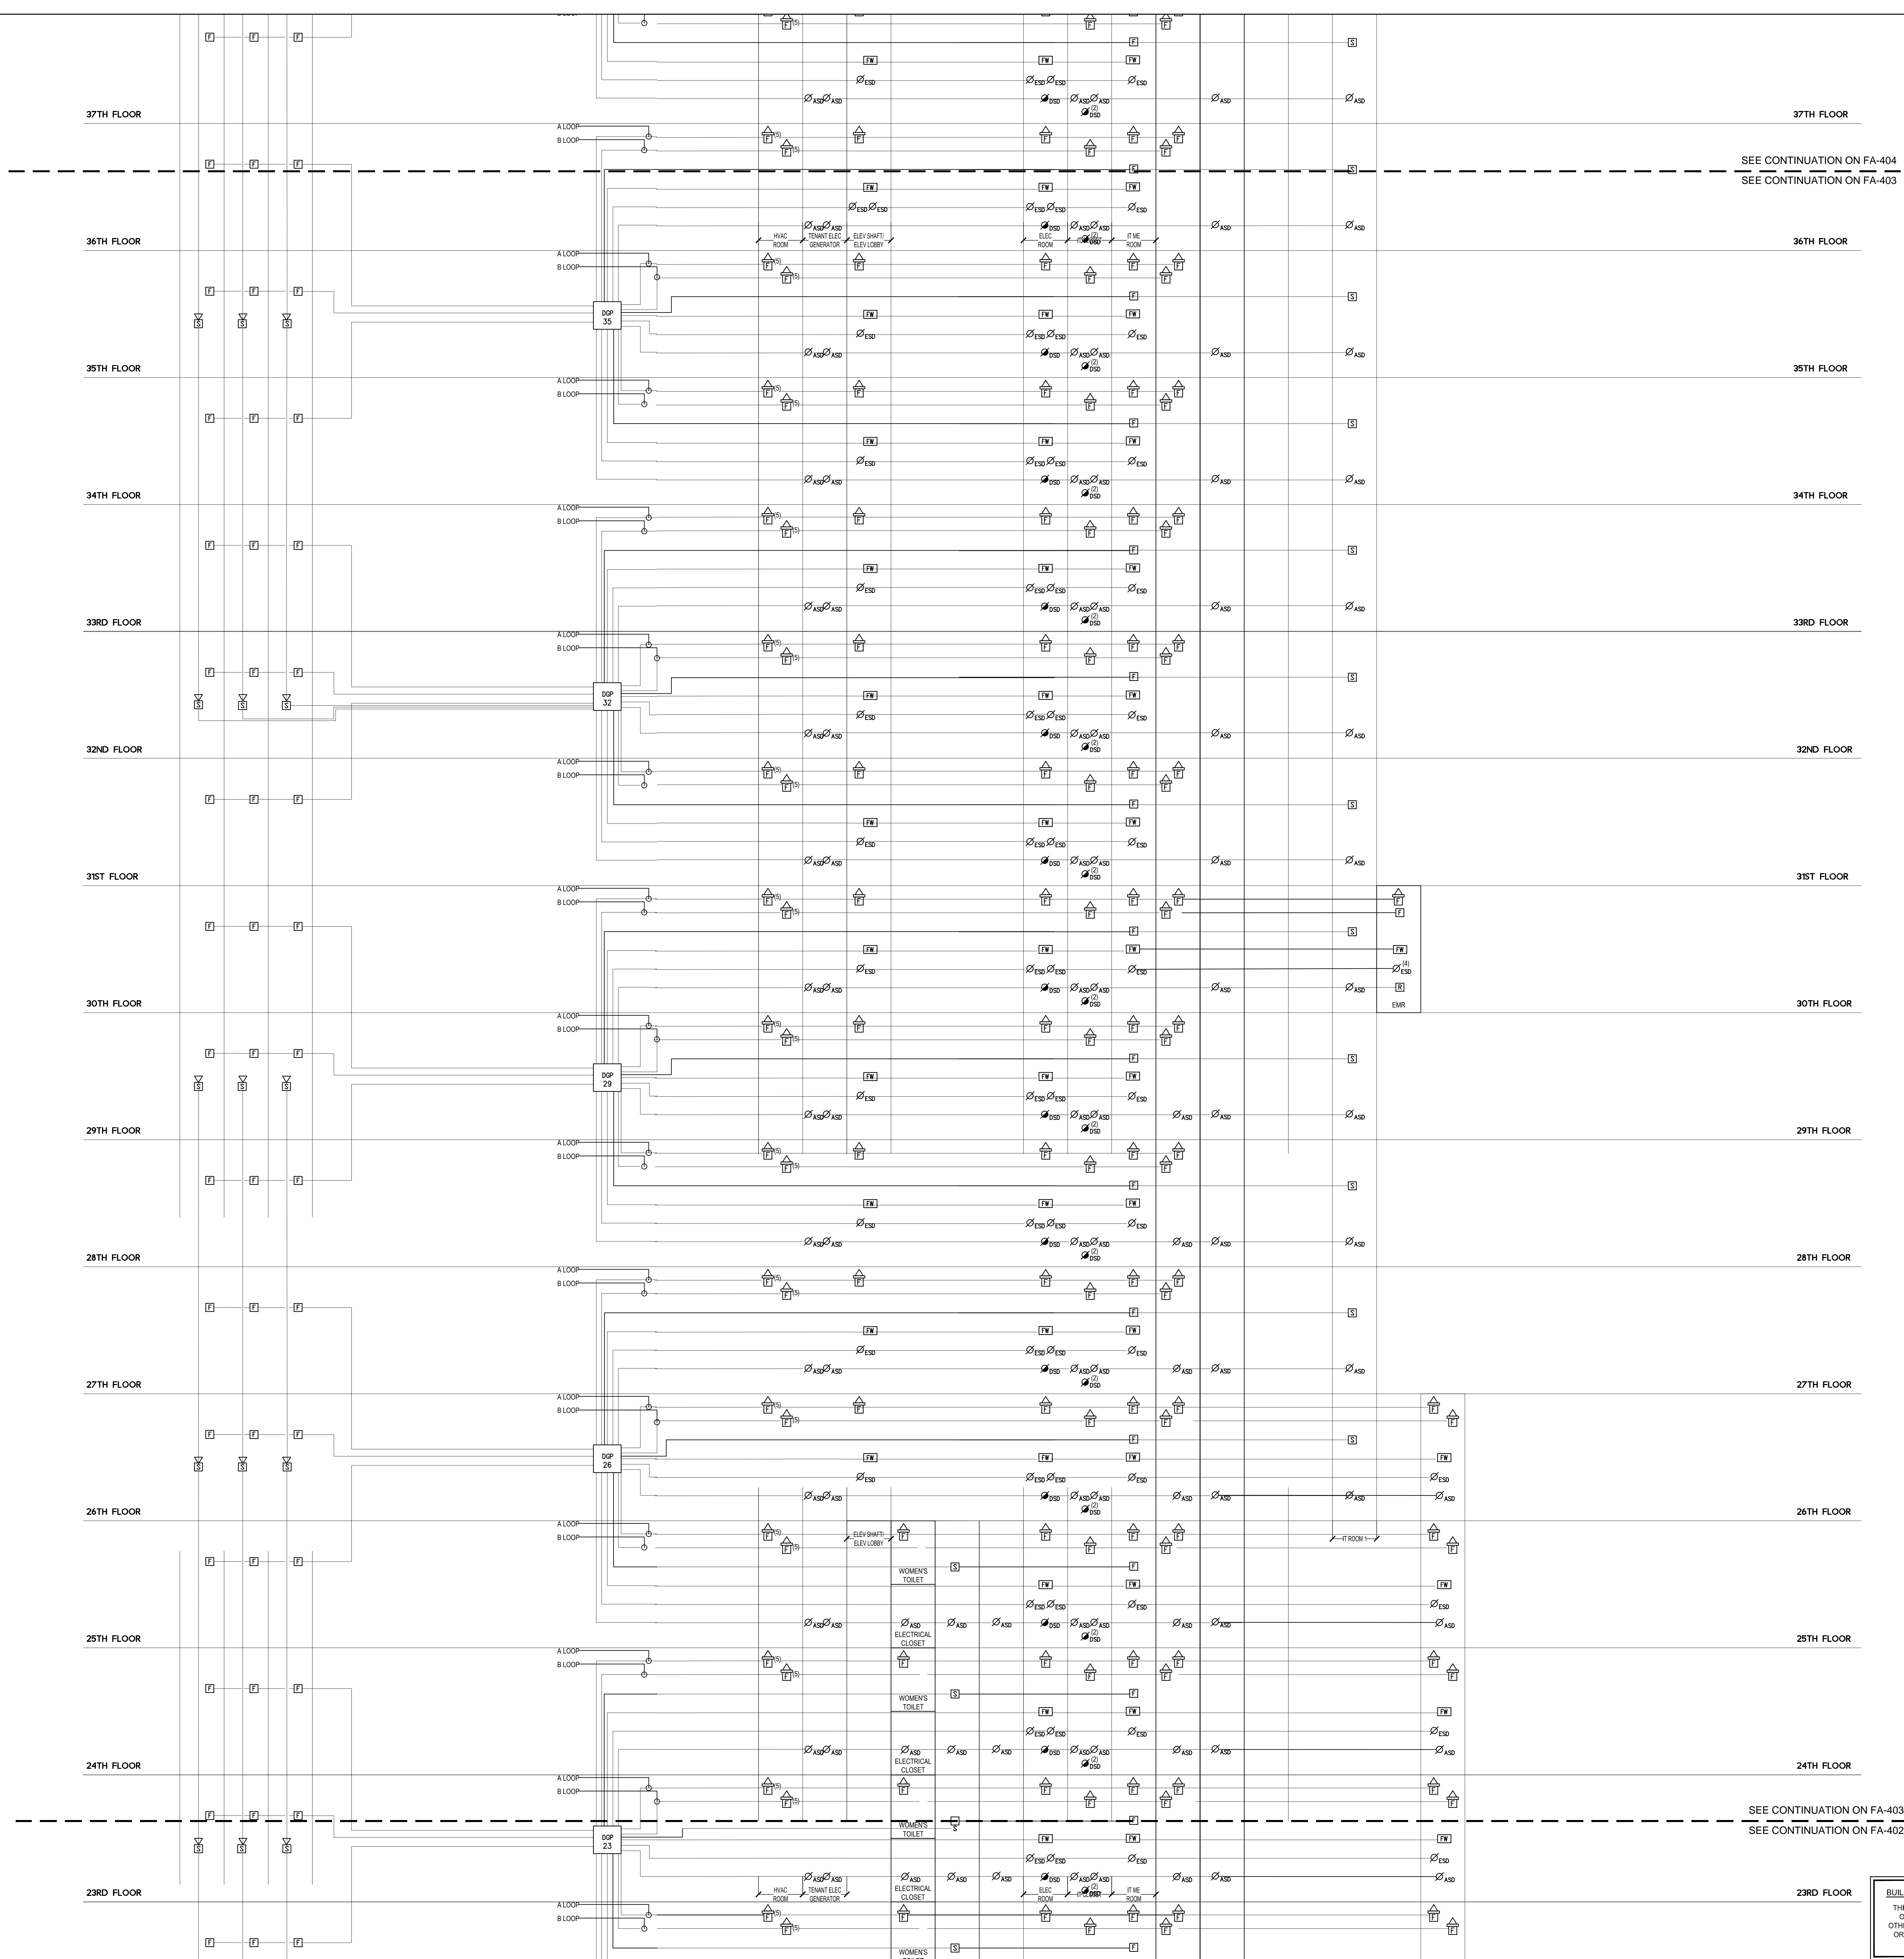
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MANHATTAN WEST: NORTH TOWER
375 Ninth Avenue, New York, NY 10001




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
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NORTH TOWER**
375 Ninth Avenue, New York, NY 10001
Client



Brookfield Place
250 Vesey Street, 15th Floor, New York, NY 10021

Architecture/Structural Engineering

SOM
Skidmore, Owings & Merrill LLP
14 Wall Street, New York, NY 10005

Civil Engineering
Philip Habib & Associates
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MEP Engineering
Jaros Baum & Bolles
80 Pine Street, New York, NY 10005

Vertical Transportation
Edgett Williams Consulting Group, Inc.
102 East Bimedale Ave., Suite 1, Mill Valley, California 94941

Sustainable Design
Viridian Energy & Environmental
50 Washington Street, Norwalk, CT 06854

Geo-Technical Engineering
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14 Penn Plaza, 225 W, 34th Street #610,
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Landscape Consultant
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475 10th Avenue, New York, NY 10018

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Ducibella, Vantor & Santoro
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Blast Consultant
Weidinger Associates, Inc.
40 Wall Street, New York, NY 10005

Acoustical Consultant
Cerami & Associates
404 Fifth Avenue #6, New York, NY 10016


Vibration Consultant
Wilson, Uhrig & Associates, Inc.
65 Broadway, Suite 401, New York, NY 10006

Code Consultant
Code Consultants Professional Engineers PC
215 West 40th Street, 15th Floor, New York, NY 10018


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Entek Engineering LLC
166 Ames Street, Hackensack, NJ 07601

Wind Tunnel Consultant
Rowan Williams Davies & Irwin Inc.
650 Woodlawn Road West, Guelph
Ontario, Canada N1K 1B6

Key Plan:

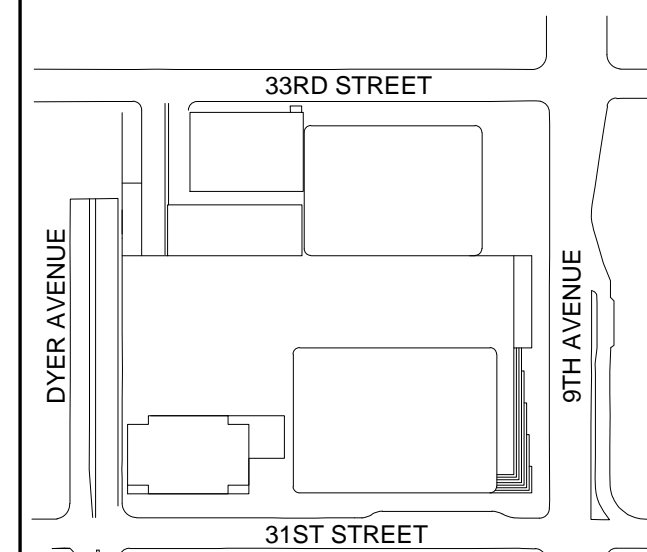

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3	18 NOV 2013	ISSUED FOR DD PROGRESS PRICING
2	12 JUL 2013	ISSUED FOR SPL DESIGN DEVELOPMENT
1	15 MAR 2013	ISSUED FOR RECONCILIATION


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**FIRE ALARM RISER
DIAGRAM
NO. 3**

Project No.:	14830	Sheet No.:	FA-403.00
Date:	20 JUN 2014	Scale:	1/8"=1'-0"
File No.:	FA-403.00	Page No.:	

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


SEE CONTINUATION ON FA-405
SEE CONTINUATION ON FA-404


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Date: 20 JUN 2014
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Sheet No.: FA-404.00
Page No.: 1

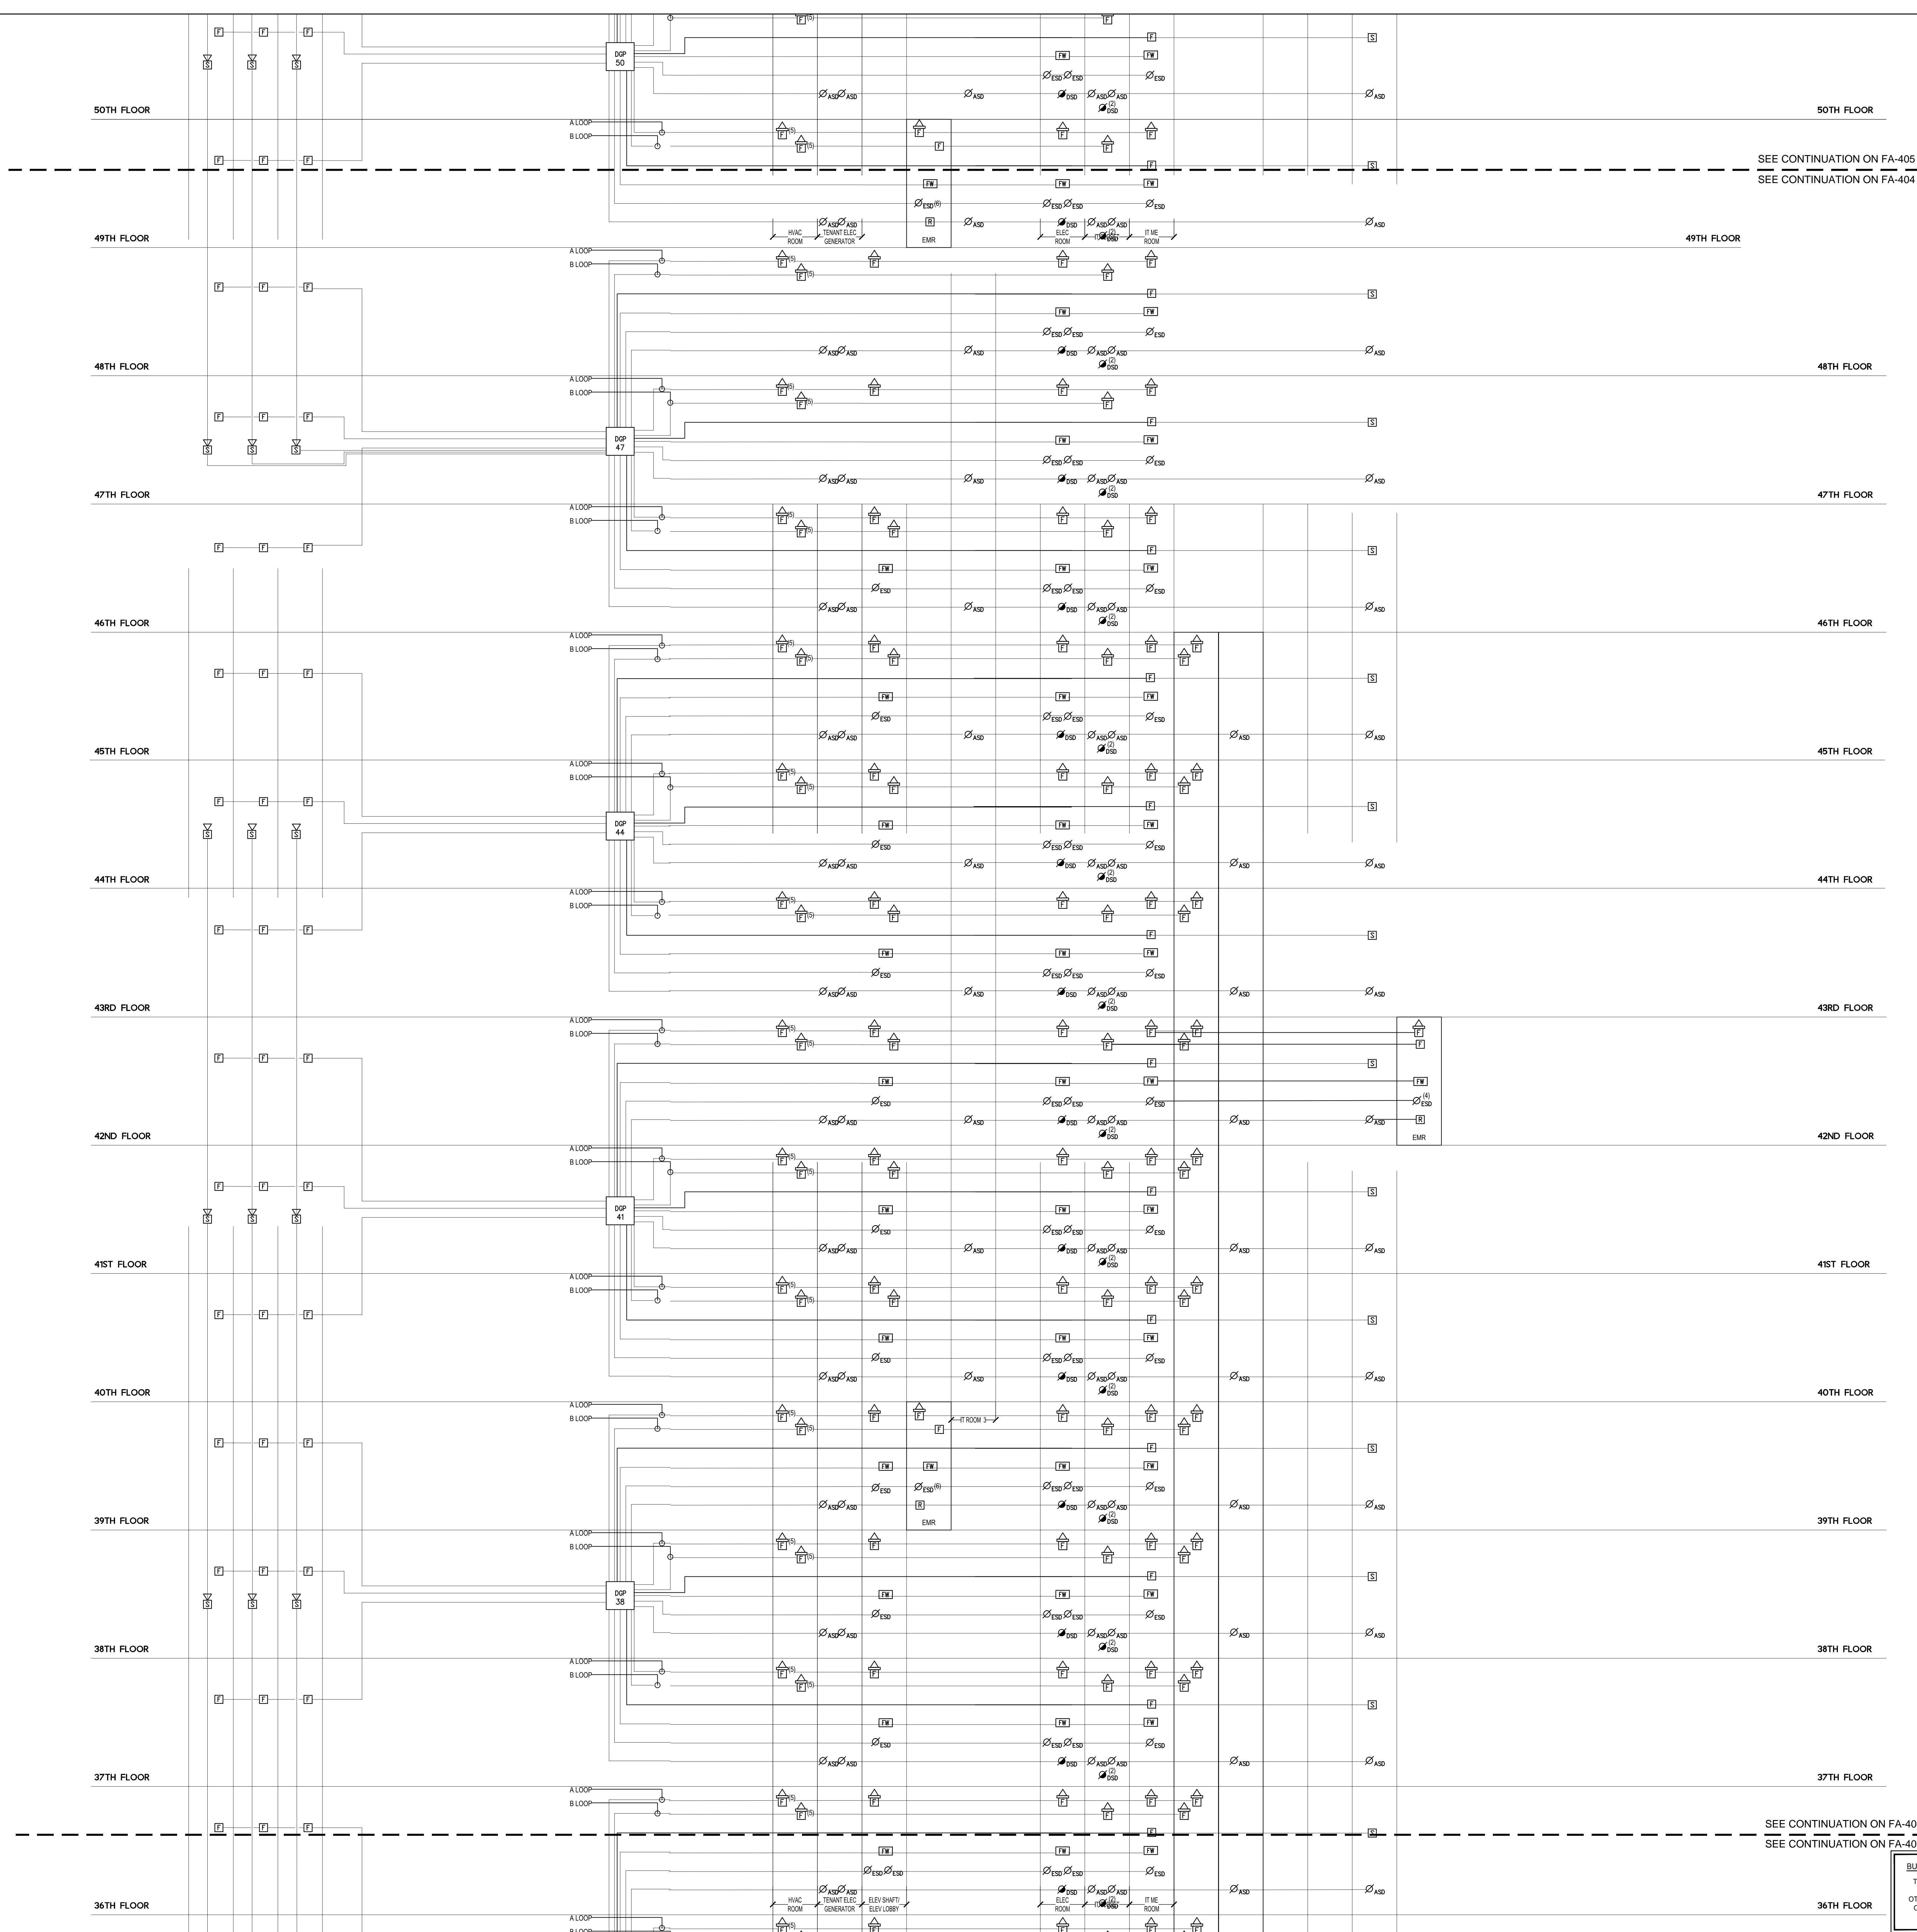

**MANHATTAN WEST:
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40 Wall Street, New York, NY 10005

Acoustical Consultant
Cerami & Associates
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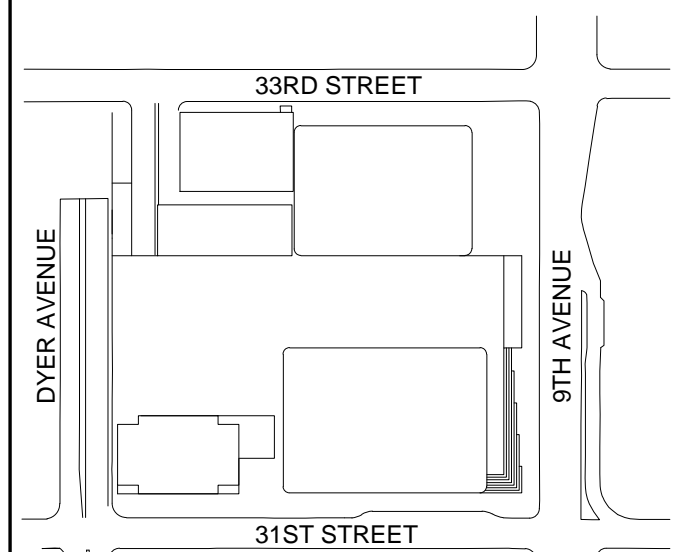
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Code Consultants Professional Engineers PC
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
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166 Ames Street, Hackensack, NJ 07601

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650 Woodlawn Road West, Guelph, Ontario, Canada N1K 1B6

Key Plan:



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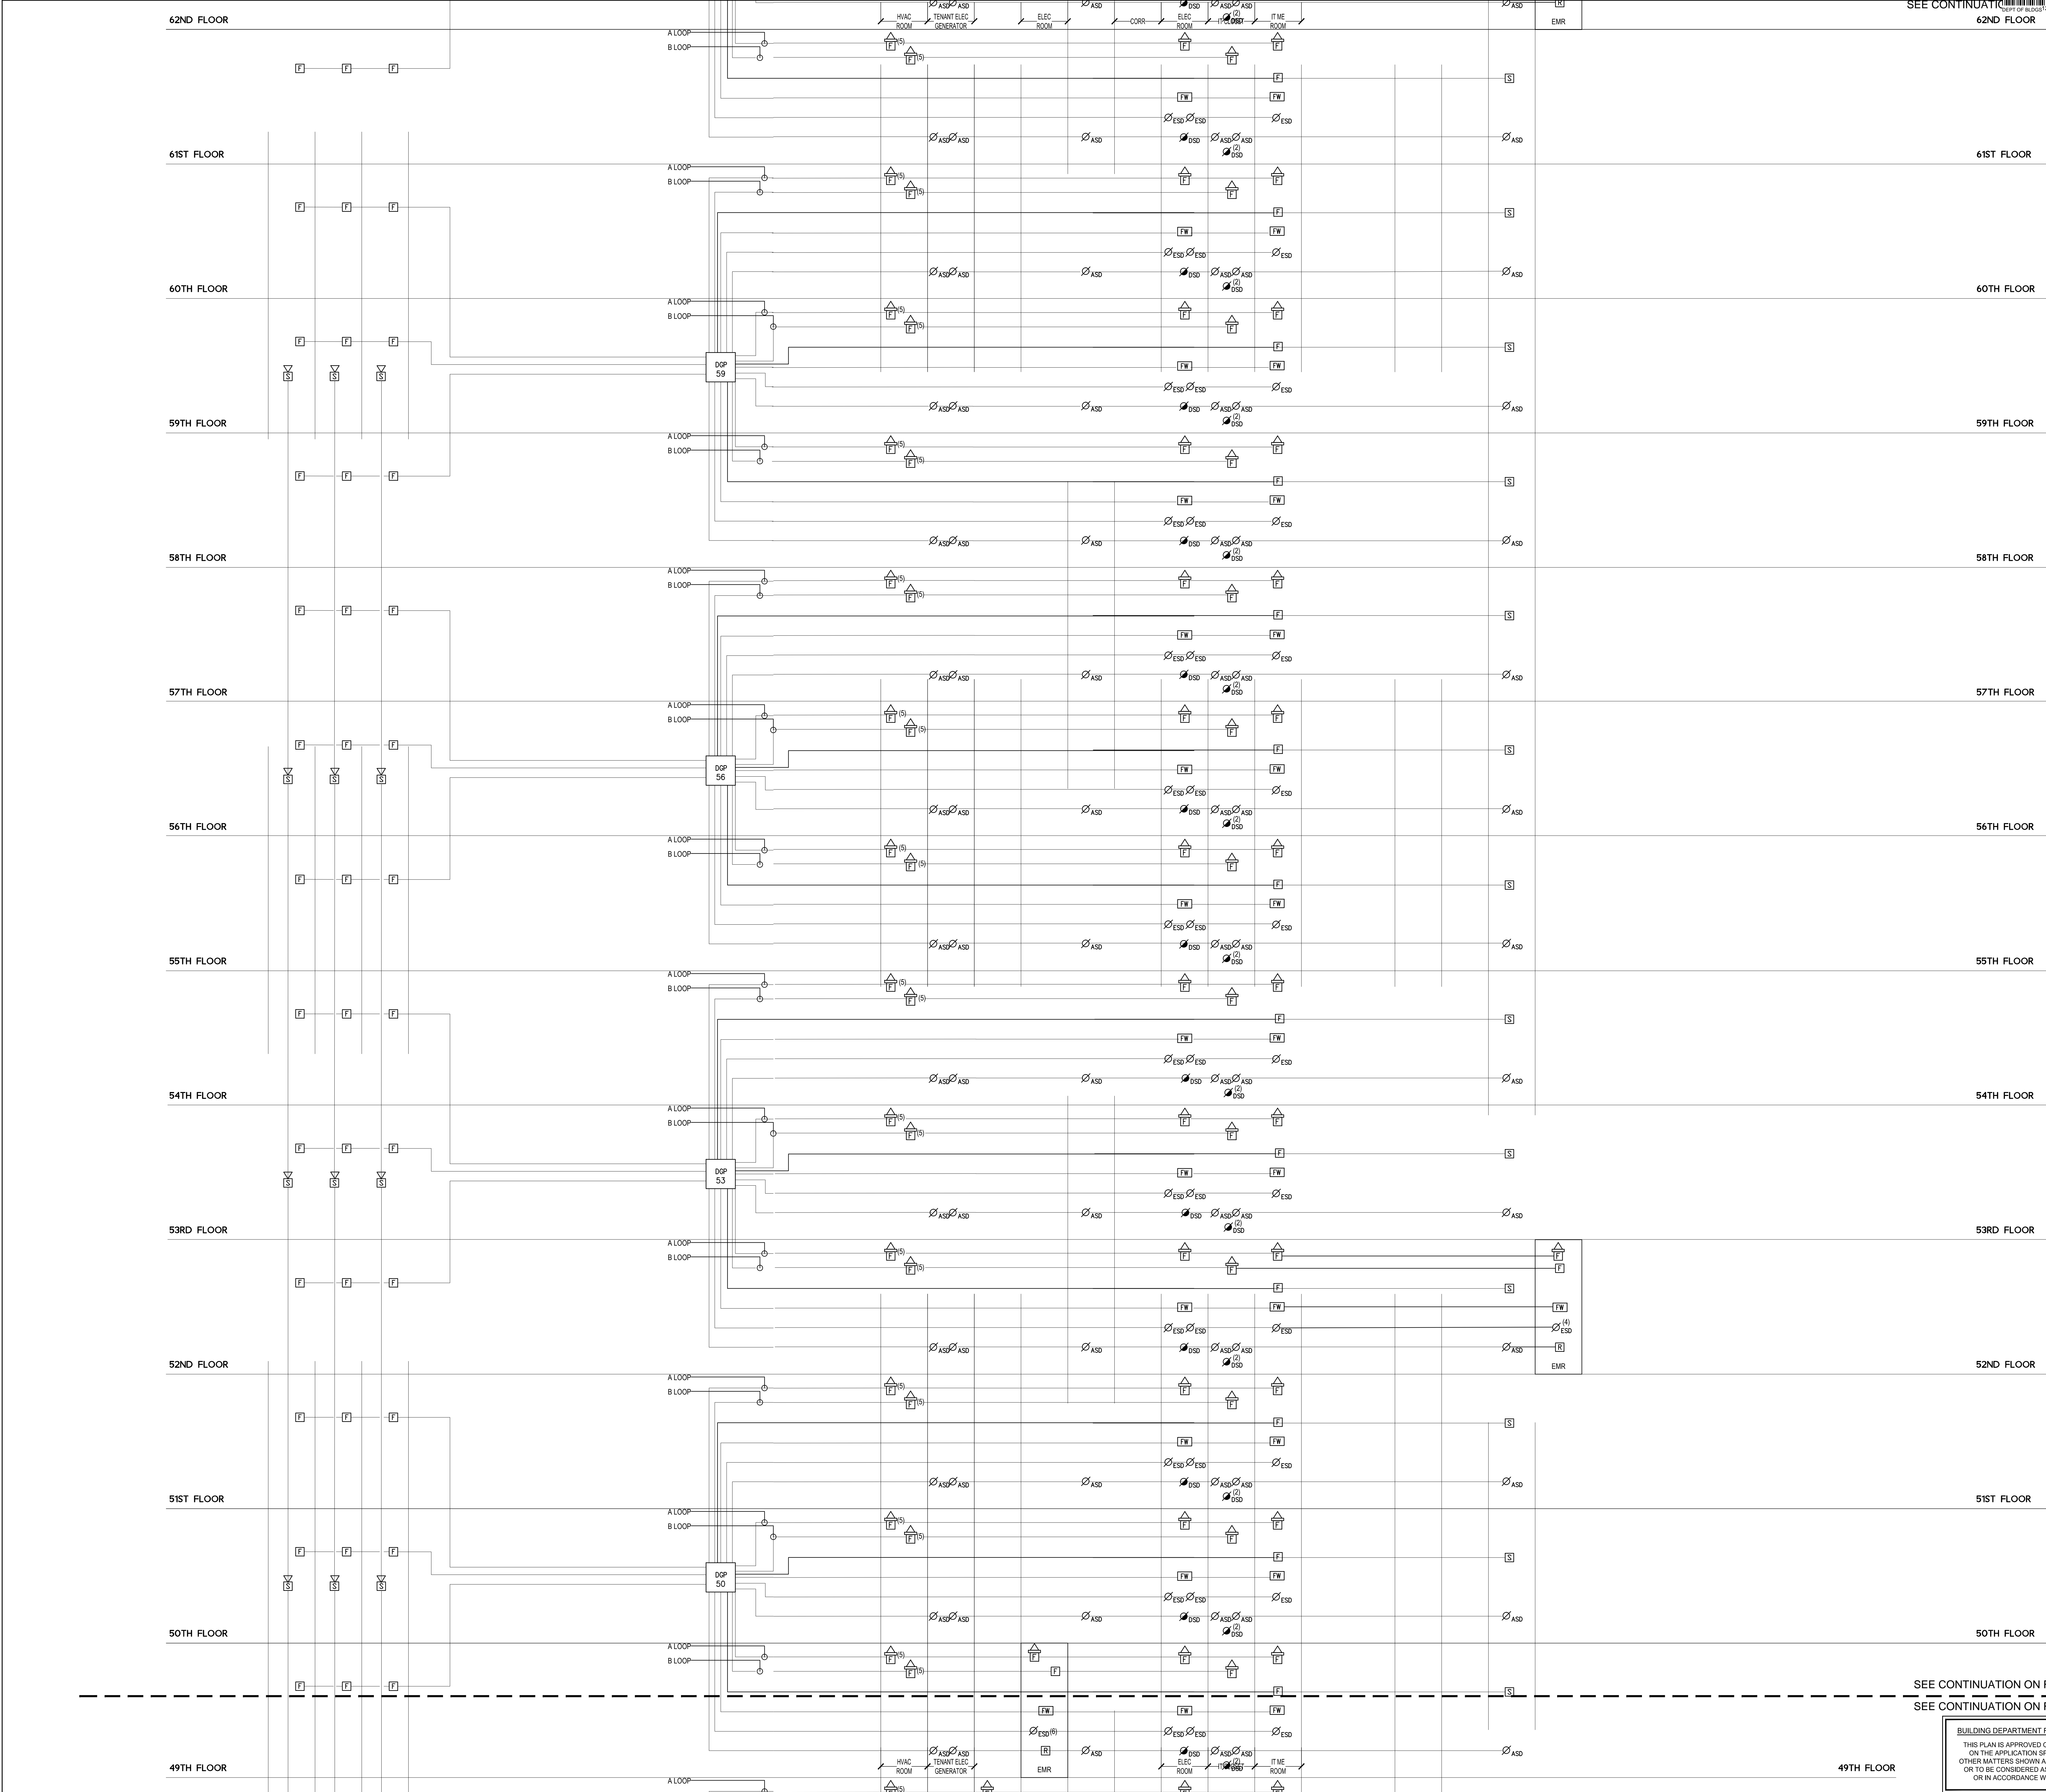


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**FIRE ALARM RISER
DIAGRAM
NO. 4**

Project No.:	14830	Sheet No.:	FA-404.00
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Date: 20 JUN 2014

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File No.: FA-405.00

Page No.:

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Wind Tunnel Consultant

Rowan Williams Davies & Irwin Inc.

650 Woodtown Road West, Guelph Ontario, Canada N1K 1B8

Key Plan:

33RD STREET

31ST STREET

DYER AVENUE

8TH AVENUE

Seal & Signature:

STATE OF NEW YORK

SEAL OF THE STATE OF NEW YORK

OFFICE OF THE STATE ENGINEER

EXPIRATION DATE: 06/20/15

4

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3

10 NOV 2013

ISSUED FOR DD PROGRESS PRICING

2

12 JUL 2013

ISSUED FOR SPL DESIGN DEVELOPMENT

1

15 MAR 2013

ISSUED FOR RECONCILIATION

Sheet Name:

FIRE ALARM RISER DIAGRAM NO. 5



MANHATTAN WEST:
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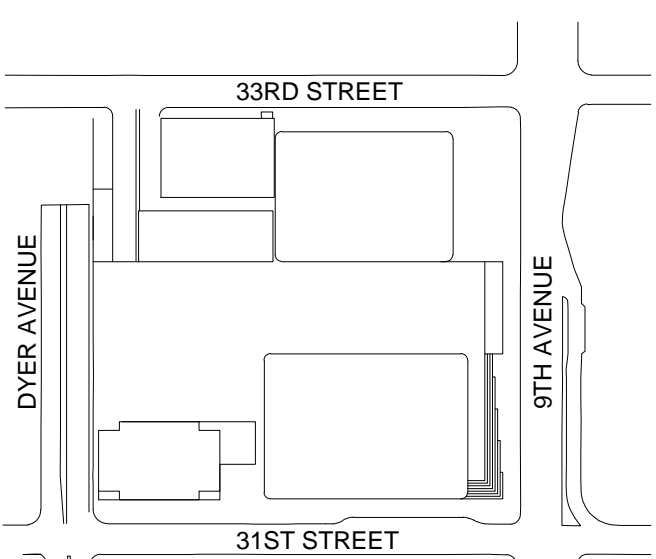
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650 Woodtown Road West, Guelph
Ontario, Canada N1K 1B8

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**FIRE ALARM RISER
DIAGRAM
NO. 6**

Project No.:

14830

Date:

20 JUN 2014

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File No.:

FA-406.00

Sheet No.:

FA-406.00

Page No.:

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70TH FLOOR

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66TH FLOOR

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64TH FLOOR

63RD FLOOR

62ND FLOOR

SEE CONTINUATION ON FA-406

SEE CONTINUATION ON FA-405

62ND FLOOR

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22 00 - Plumbing Sheet Matrix - DOB FILING						
DOB Sheet Number	Sheet Number	Sheet Name	12 JUL 2013 50% DD	15 NOV 2013 DD PROGRESS	20 DEC 2013 FOUNDATION PERMIT	20 JUN 2014 FOUNDATION PERMIT
000 - Cover Sheet, General Notes, Legends						
P-001.00	P-001	PLUMBING DRAWING INDEX	•	•	•	•
P-002.00	P-002	PLUMBING ABBREVIATIONS AND SYMBOLS LIST	•	•	•	•
100 - Floor Plans						
P-093.00	P-098B1-A	B1 PIT PART FLOOR PLAN - PART A		•	•	•
P-094.00	P-099B1-A	PLUMBING CELLAR B1 FLOOR PLAN - PART A	•	•	•	•
P-095.00	P-099B1-B	PLUMBING CELLAR B1 FLOOR PLAN - PART B		•	•	•
P-096.00	P-099B1-C	PLUMBING CELLAR B1 FLOOR PLAN - PART C		•	•	•
P-097.00	P-100B-A	PLUMBING CELLAR B FLOOR PLAN - PART A	•	•	•	•
P-098.00	P-100B-B	PLUMBING CELLAR B FLOOR PLAN - PART B		•	•	•
P-099.00	P-100B-C	PLUMBING CELLAR B FLOOR PLAN - PART C		•	•	•
P-100.00	P-101-A	PLUMBING GROUND FLOOR PLAN - PART A	•	•	•	•
P-101.00	P-101-B	PLUMBING GROUND FLOOR PLAN - PART B		•	•	•
P-102.00	P-102	PLUMBING LEVEL 2 FLOOR PLAN - RETAIL	•	•	•	•
P-103.00	P-103	PLUMBING LEVEL 3 FLOOR PLAN - STAIR TRANSFER	•	•	•	•
P-104.00	P-104	PLUMBING LEVEL 4 FLOOR PLAN - MECHANICAL	•	•	•	•
P-105.00	P-105	PLUMBING LEVEL 5 FLOOR PLAN - MECHANICAL MEZZANINE		•	•	•
P-106.00	P-106	PLUMBING LEVEL 6-15 FLOOR PLAN - TYPICAL LOW-RISE		•	•	•
P-116.00	P-116	PLUMBING LEVEL 16 FLOOR PLAN - TYPICAL LOW-RISE		•	•	•
P-117.00	P-117	PLUMBING LEVEL 17 FLOOR PLAN - LOW-RISE		•	•	•
P-118.00	P-118	PLUMBING LEVEL 18 FLOOR PLAN - LOW-RISE OVERRUN		•	•	•
P-119.00	P-119	PLUMBING LEVEL 19-20 FLOOR PLAN - LOW-RISE EMR	•	•	•	•
P-121.00	P-121	PLUMBING LEVEL 21-27 FLOOR PLAN - TYPICAL LOW-RISE		•	•	•
P-128.00	P-128	PLUMBING LEVEL 28 FLOOR PLAN - LOW-RISE & MID-RISE		•	•	•
P-129.00	P-129	PLUMBING LEVEL 29 FLOOR PLAN - MID-RISE OVERRUN	•	•	•	•
P-130.00	P-130	PLUMBING LEVEL 30 FLOOR PLAN - MID-RISE EMR	•	•	•	•
P-131.00	P-131	PLUMBING LEVEL 31 FLOOR PLAN - MID-RISE PUMP ROOM	•	•	•	•
P-132.00	P-132	PLUMBING LEVEL 32 FLOOR PLAN - MID-RISE WATER TANK		•	•	•
P-133.00	P-133	PLUMBING LEVEL 33-35 FLOOR PLAN - TYPICAL MID-RISE		•	•	•
P-136.00	P-136	PLUMBING LEVEL 36 FLOOR PLAN - TYPICAL MID-RISE		•	•	•
P-137.00	P-137	PLUMBING LEVEL 37-38 FLOOR PLAN - TYPICAL MID-RISE		•	•	•
P-139.00	P-139	PLUMBING LEVEL 39 FLOOR PLAN - MID-RISE		•	•	•
P-140.00	P-140	PLUMBING LEVEL 40-41 FLOOR PLAN - MID-RISE OVERRUN		•	•	•
P-142.00	P-142	PLUMBING LEVEL 42 FLOOR PLAN - MID-RISE EMR		•	•	•
P-143.00	P-143	PLUMBING LEVEL 43-46 FLOOR PLAN - TYPICAL MID-RISE		•	•	•
P-147.00	P-147	PLUMBING LEVEL 47-48 FLOOR PLAN - TYPICAL MID-RISE		•	•	•
P-149.00	P-149	PLUMBING LEVEL 49 FLOOR PLAN - MID-RISE & HIGH-RISE		•	•	•
P-150.00	P-150	PLUMBING LEVEL 50-51 FLOOR PLAN - HIGH-RISE OVERRUN	•	•	•	•
P-152.00	P-152	PLUMBING LEVEL 52 FLOOR PLAN - HIGH-RISE EMR	•	•	•	•
P-153.00	P-153	PLUMBING LEVEL 53 FLOOR PLAN - HIGH-RISE PUMP ROOM	•	•	•	•
P-154.00	P-154	PLUMBING LEVEL 54 FLOOR PLAN - HIGH-RISE WATER TANK		•	•	•
P-155.00	P-155	PLUMBING LEVEL 55 FLOOR PLAN - HIGH-RISE		•	•	•
P-156.00	P-156	PLUMBING LEVEL 56 FLOOR PLAN - HIGH-RISE		•	•	•
P-157.00	P-157	PLUMBING LEVEL 57-58 FLOOR PLAN - TYPICAL HIGH-RISE		•	•	•
P-159.00	P-159	PLUMBING LEVEL 59 FLOOR PLAN - HIGH-RISE		•	•	•
P-160.00	P-160	PLUMBING LEVEL 60-61 FLOOR PLAN - HIGH-RISE OVERRUN		•	•	•
P-162.00	P-162	PLUMBING LEVEL 62 FLOOR PLAN - HIGH-RISE EMR		•	•	•
P-163.00	P-163	PLUMBING LEVEL 63 FLOOR PLAN - HIGH-RISE		•	•	•
P-164.00	P-164	PLUMBING LEVEL 64-66 FLOOR PLAN - TYPICAL HIGH-RISE	•	•	•	•
P-167.00	P-167	PLUMBING LEVEL 67 FLOOR PLAN - TYPICAL HIGH-RISE		•	•	•
P-168.00	P-168	PLUMBING LEVEL 68 FLOOR PLAN - MECHANICAL		•	•	•
P-169.00	P-169	PLUMBING LEVEL 69 FLOOR PLAN - MECHANICAL MEZZANINE		•	•	•
P-170.00	P-170	PLUMBING ROOF PLAN - MECHANICAL PENTHOUSE		•	•	•
P-171.00	P-171	PLUMBING ROOF PLAN - MECHANICAL PENTHOUSE ROOF		•	•	•
P-172.00	P-172	PLUMBING ROOF PLAN		•	•	•
400 - Risers & One Line Diagrams						
P-400.00	P-400	PLUMBING DOMESTIC WATER RISER DIAGRAM	•	•	•	•
P-401.00	P-401	PLUMBING SANITARY RISER DIAGRAM - SHEET 1	•	•	•	•
P-402.00	P-402	PLUMBING SANITARY RISER DIAGRAM - SHEET 2		•	•	•
P-403.00	P-403	PLUMBING STORM & NATURAL GAS RISER DIAGRAMS	•	•	•	•
500 - Schedules						
P-500.00	P-500	PLUMBING SCHEDULE SHEET	•	•	•	•
600 - Details						
P-600.00	P-600	PLUMBING DETAILS - SHEET 1	•	•	•	•
P-601.00	P-601	PLUMBING DETAILS - SHEET 2	•	•	•	•

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SHEET NOTES



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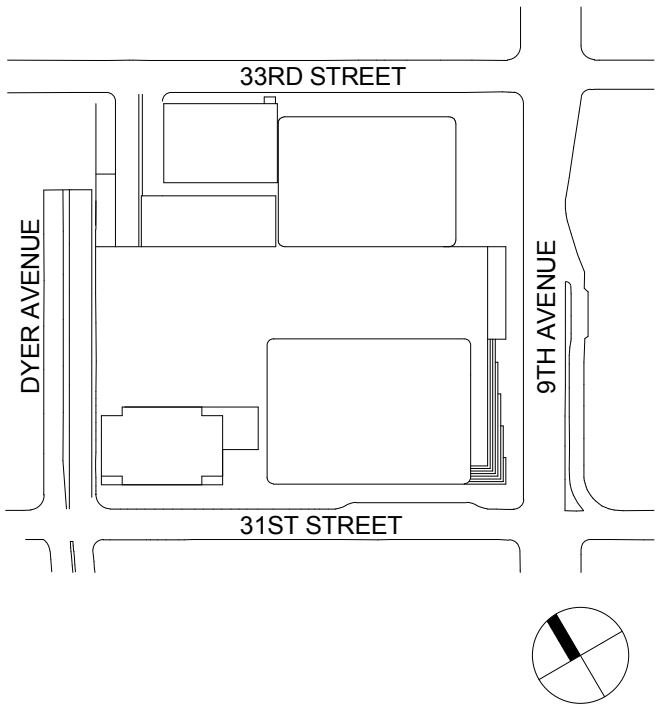
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2	12 JUL 2013	ISSUED FOR 60% DESIGN DEVELOPMENT
1	19 MAR 2013	ISSUED FOR RECONCILIATION

No. Date Description
Sheet Name:

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DRAWING INDEX

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14830-A-000

Date:
20 JUN 2014

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File No.:
P-001


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P-001.00

Sheet No.:

P-001

Page No.:
1 OF 6

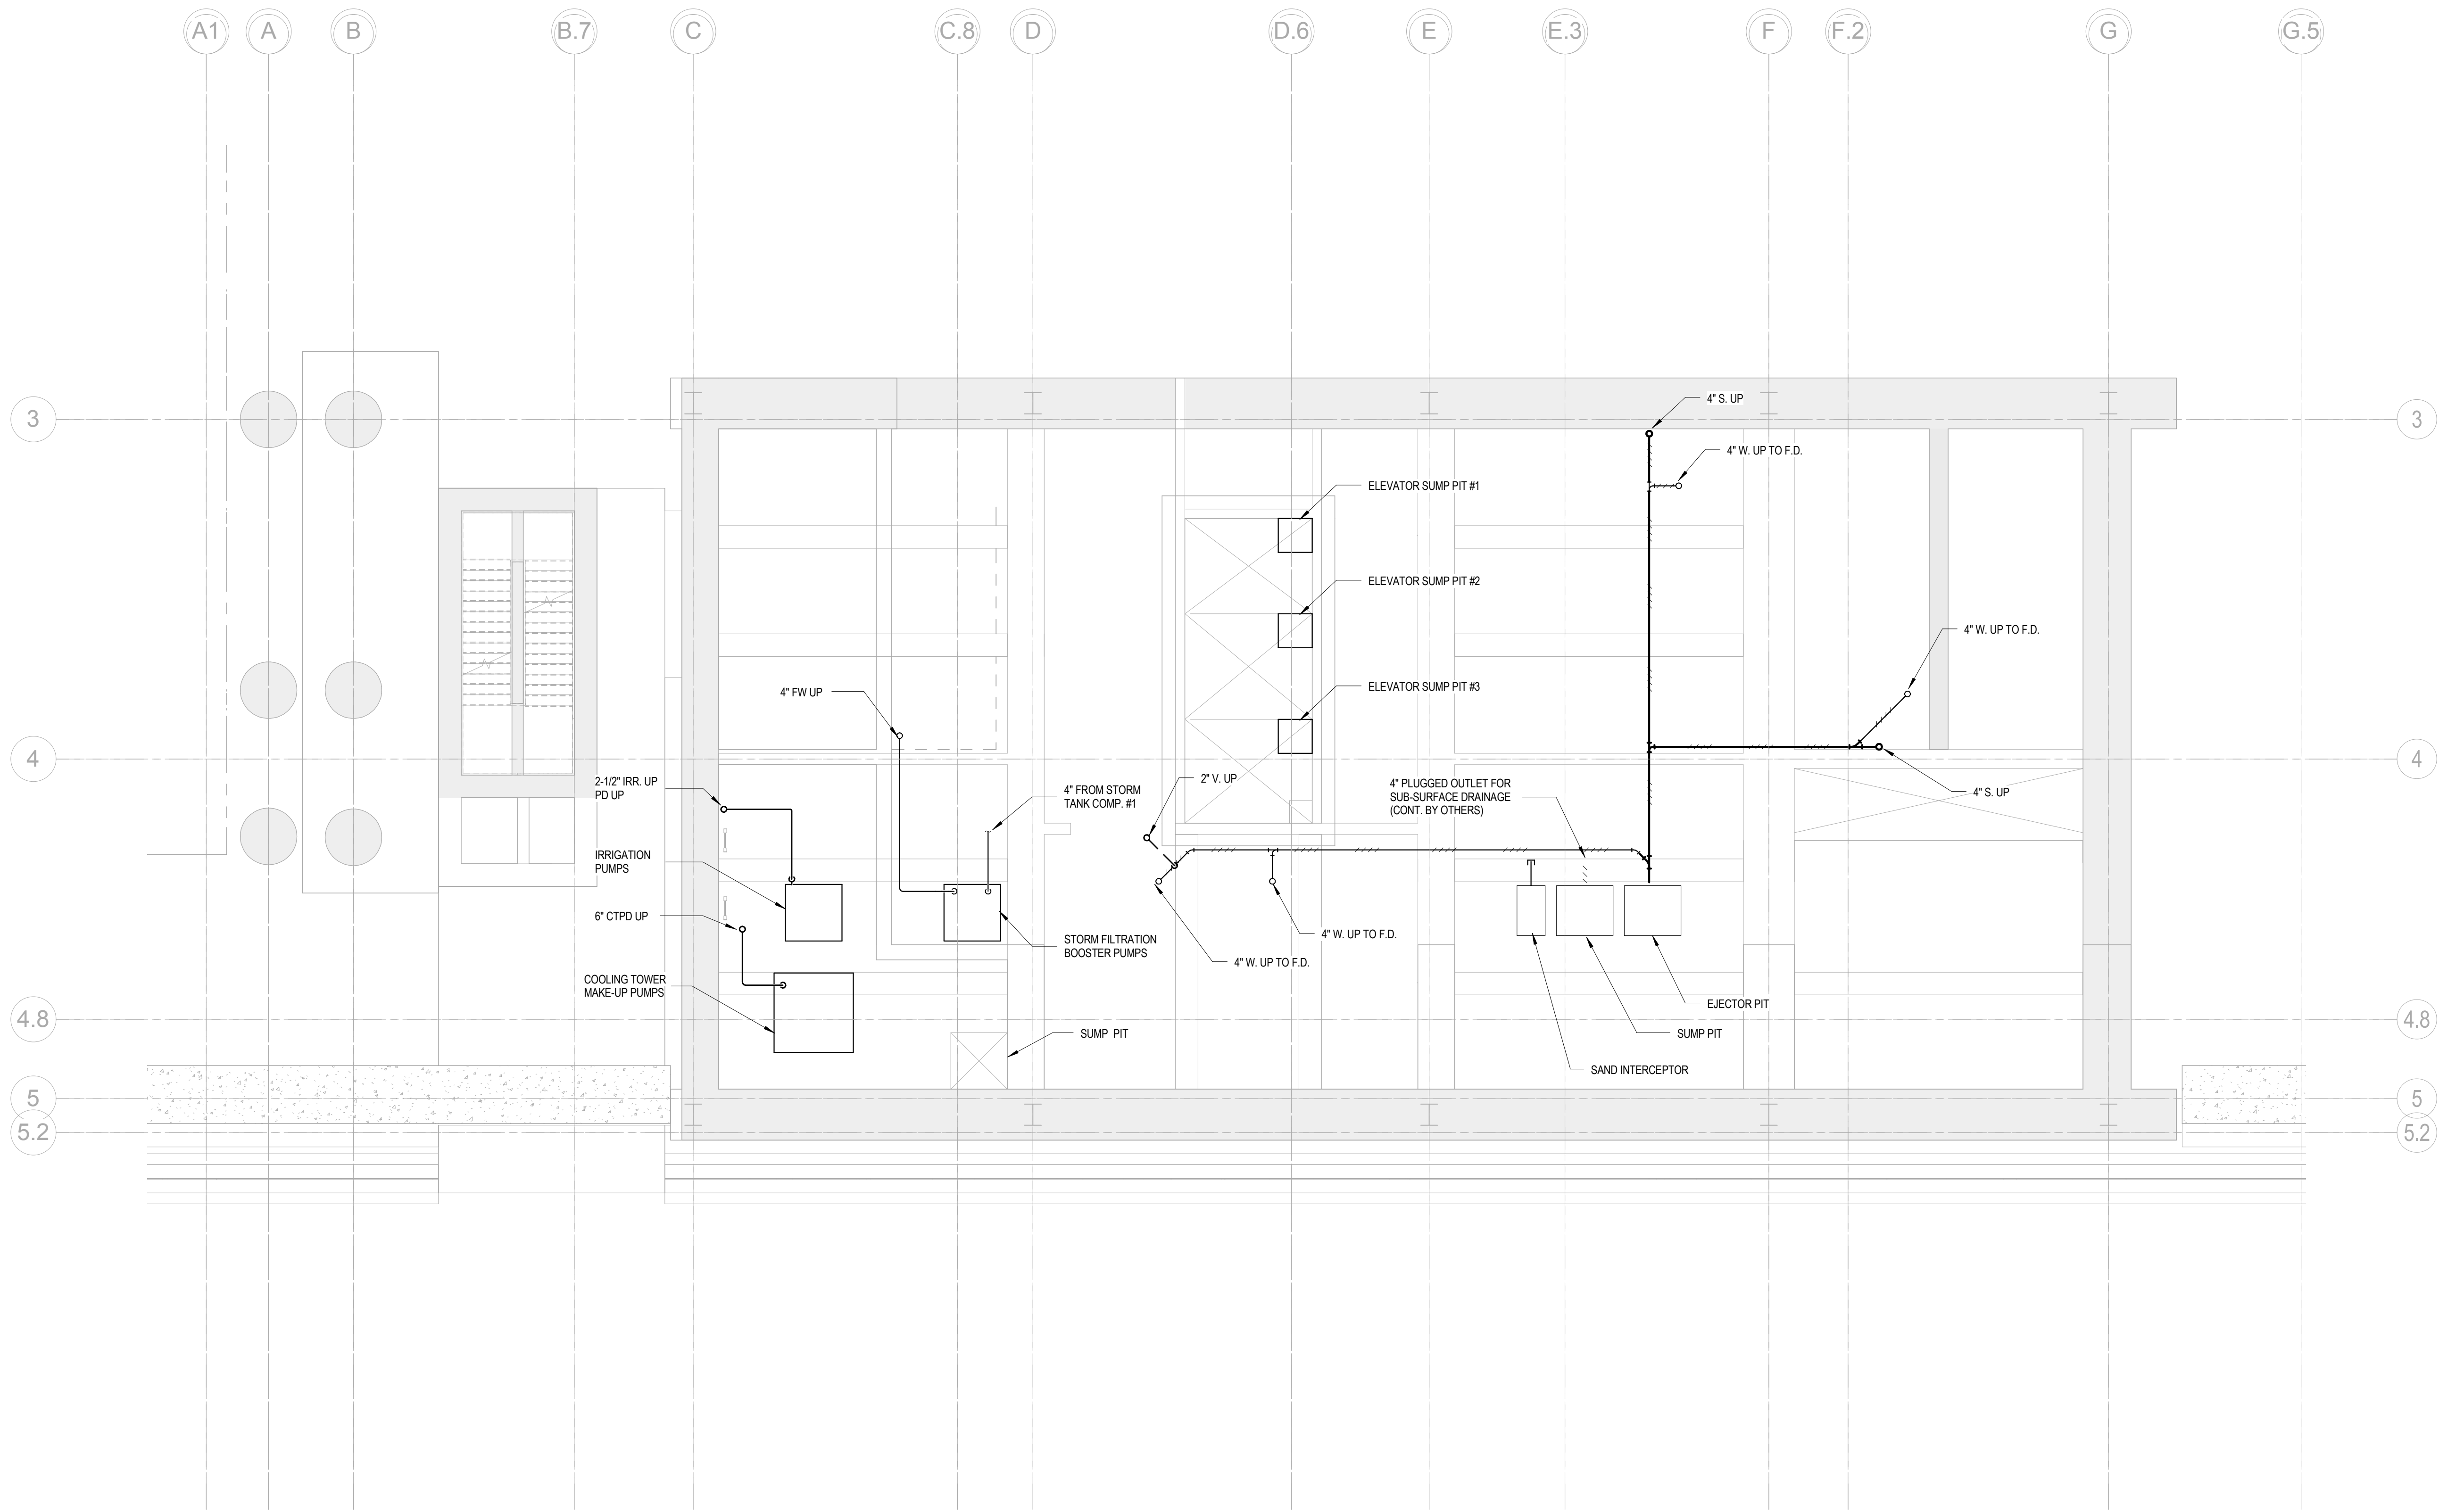

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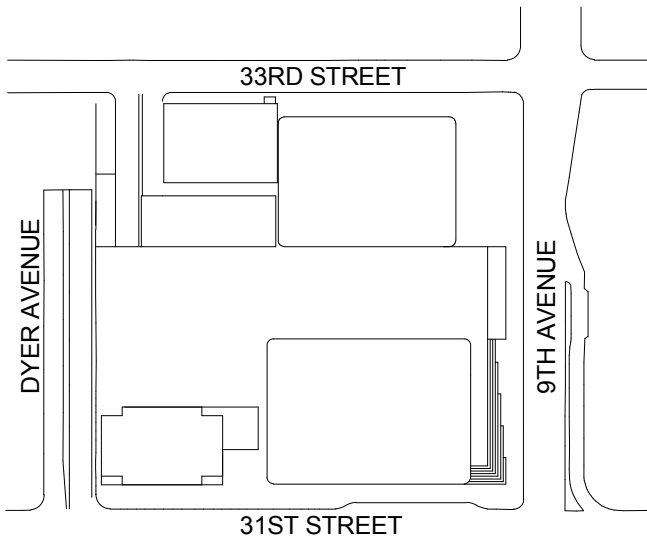
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Code Consultant
Code Consultants Professional Engineers PC
215 West 40th Street, 15th Floor, New York, NY 10018

Facade Maintenance Consultant
Entek Engineering LLC
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Rowan Williams Davies & Irwin Inc.
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**PLUMBING
CELLAR B1 PIT
PART PLAN -
PART A**

Project No.: 14830-A-000
Date: 20 JUN 2014
Scale: 1/8" = 1'-0"
File No.: P-098B1-A
B-SCAN Sheet No.: P-093.00
Sheet No.: P-098B1-A
Page No.: 5 OF 6



Client

ent

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Brookfield Place
250 Vesey Street, 15th Floor, New York, NY 10281

Architecture/Structural Engineering

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by Michael A. Bane

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hrig & Associate

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ts Professional E

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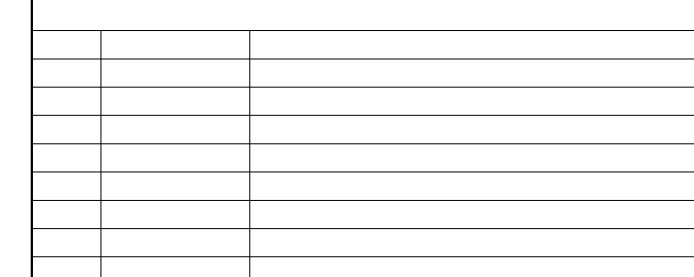
Maintenance Consult

Entek Engineering LLC
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d Tunnel Consultant

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No.	Date	Description

Sheet Name:

PLUMBING
CELLAR B1
FLOOR PLAN -
PART B

Project No.:	14830.A.000
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Date:	20 JUN 2014
Scale:	

B-SCAN Sheet No.:
B 095 00

Sheet No.:

File No.:	P-000B1-B
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Page No.: 7 OF 6

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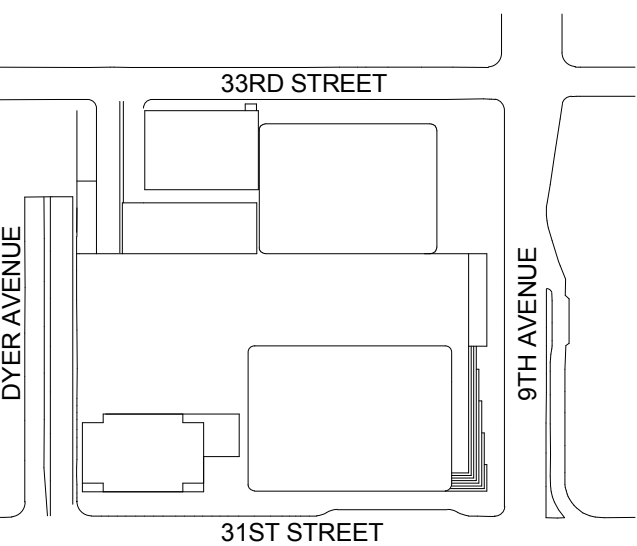
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Ontario, Canada N1K 1S8

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1	19 NOV 2013	ISSUED FOR 60 PROGRESS PRICINGS

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**PLUMBING
CELLAR B FLOOR
PLAN - PART B**

Project No.:
14830-A-000

Date:
20 JUN 2014

Scale:
1/8" = 1'-0"

File No.:
P-1008-B

B-SCAN Sheet No.:

P-098.00

Sheet No.:

P-1008-B

Page No.:

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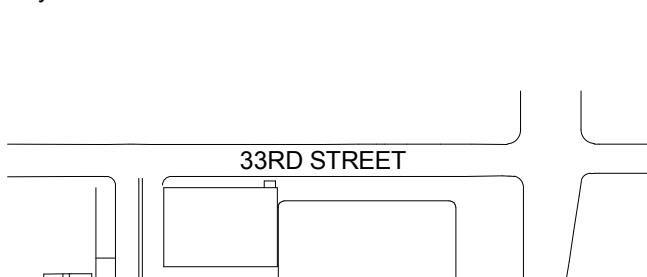
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No. Date Description

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Date: 20 JUN 2014

Scale: 1/8" = 1'-0"

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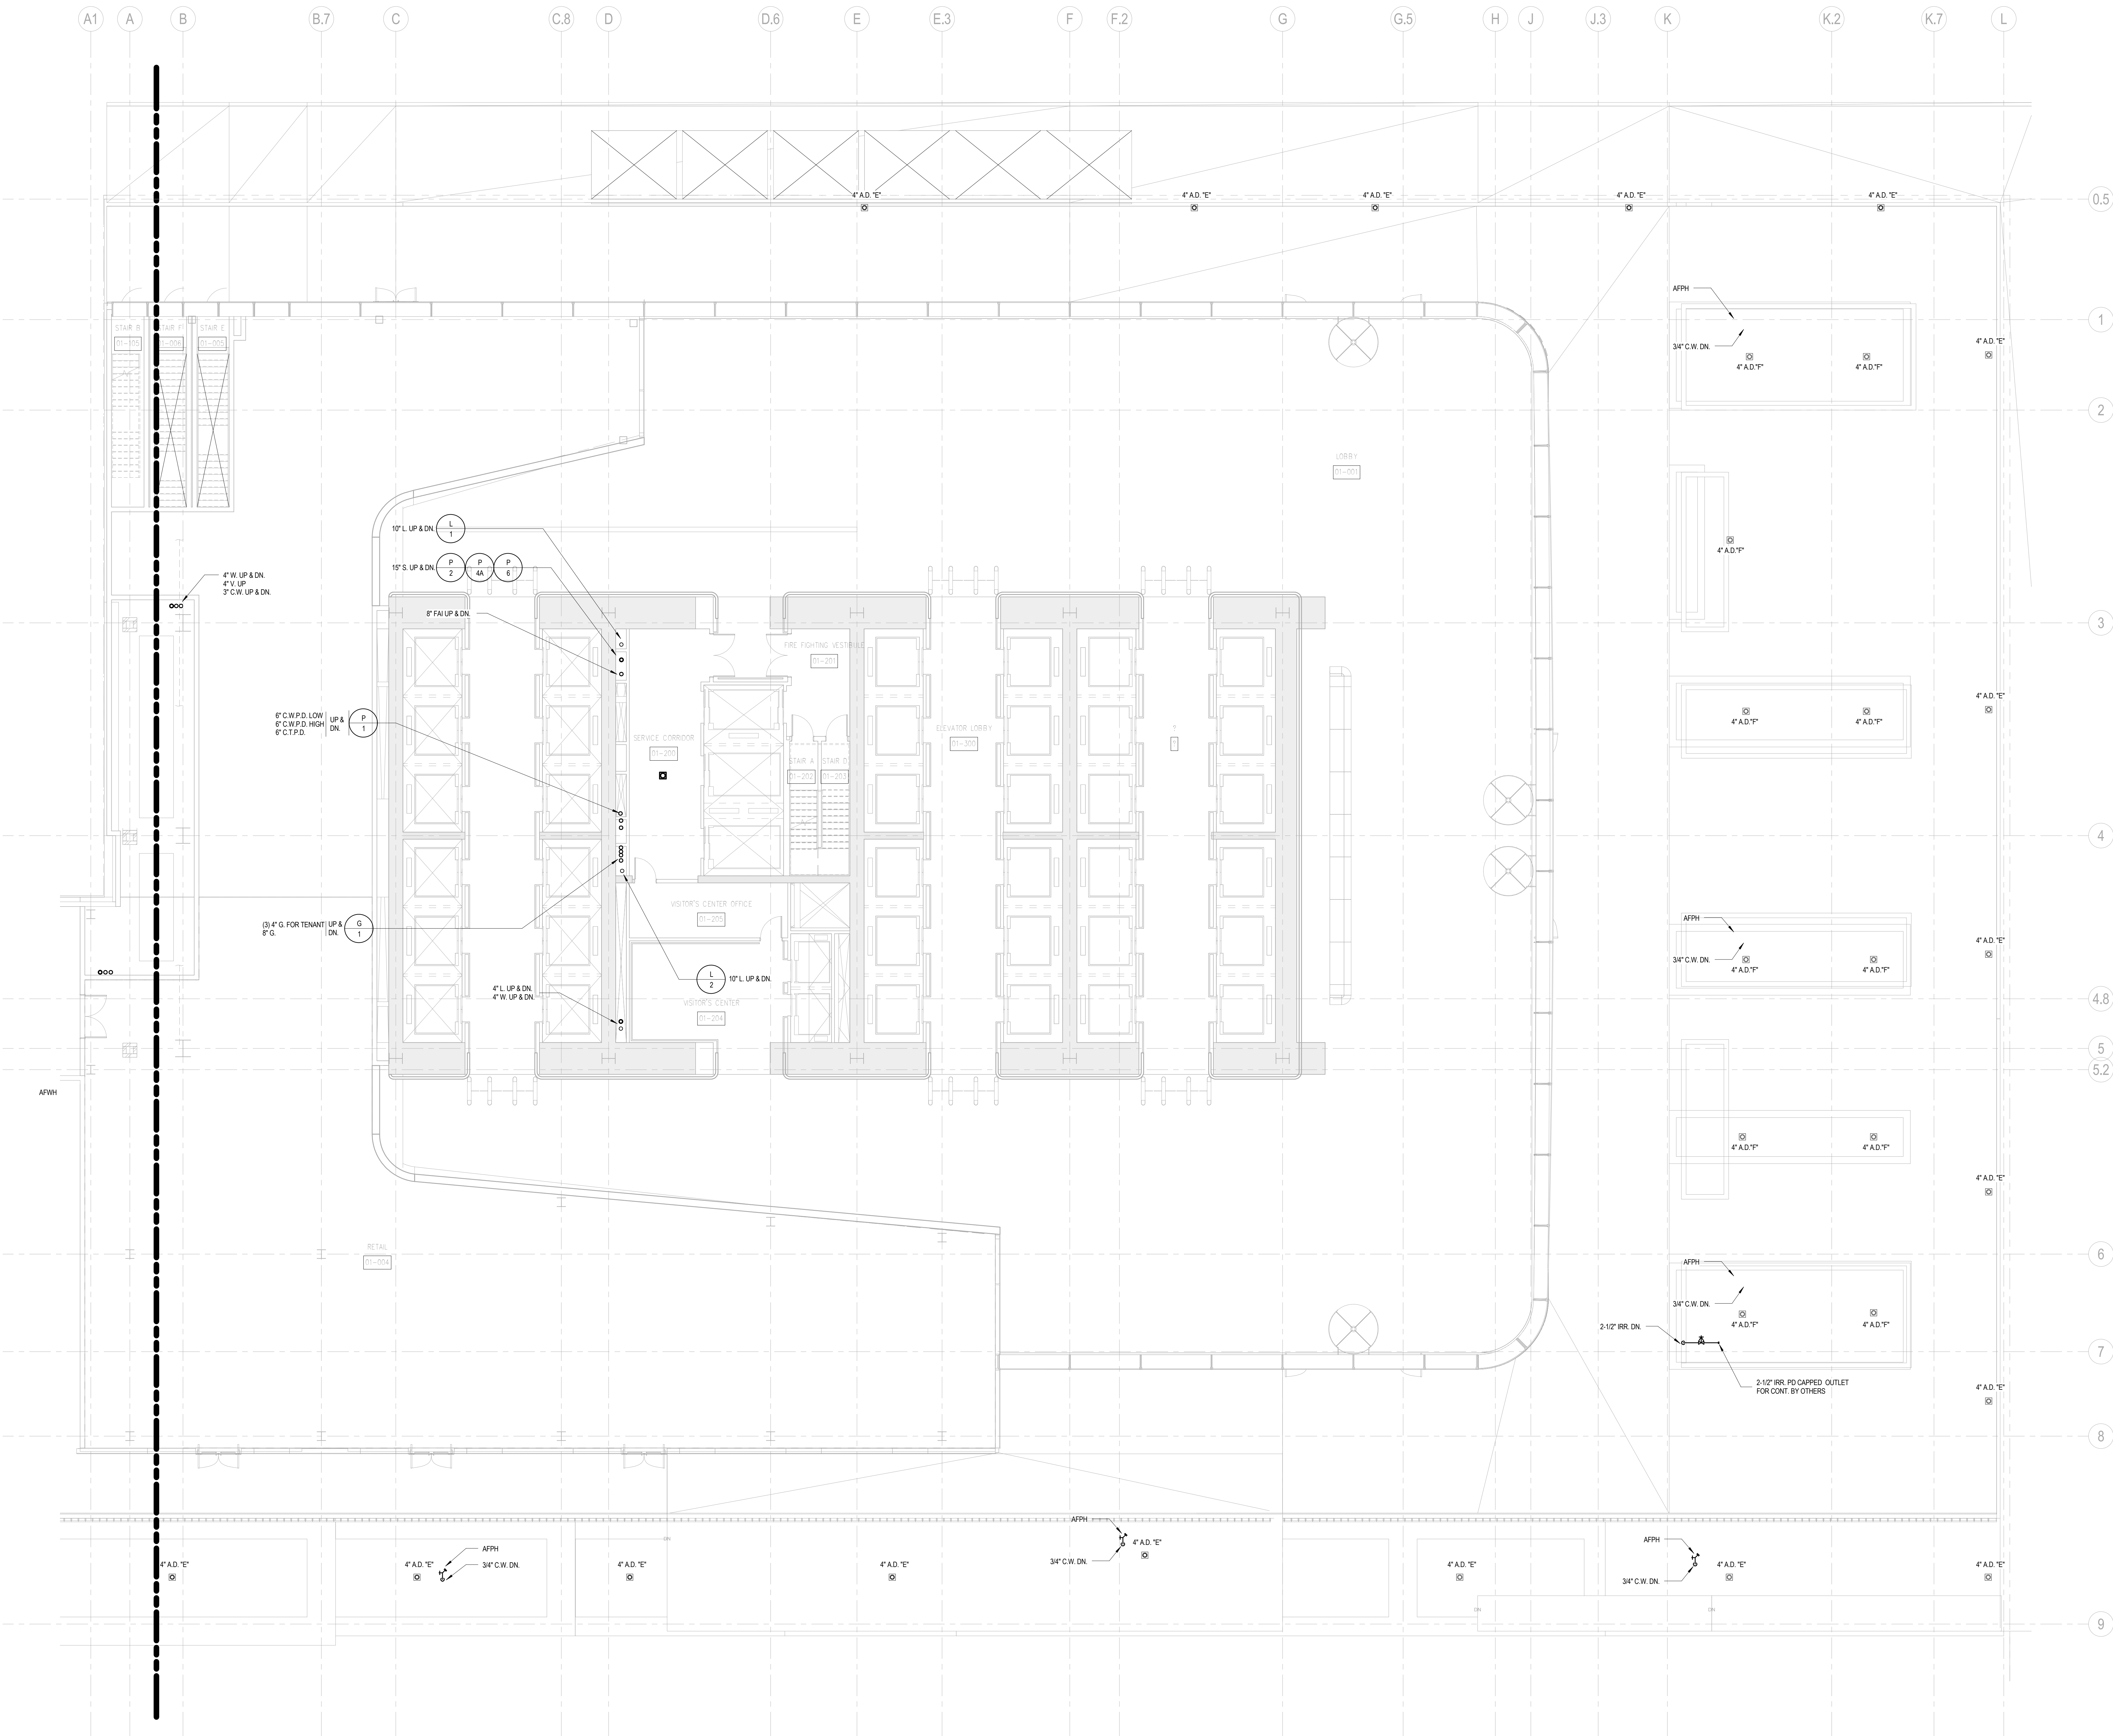
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Page No.: 12 OF 6

PLUMBING


GROUND FLOOR

PLAN - PART A



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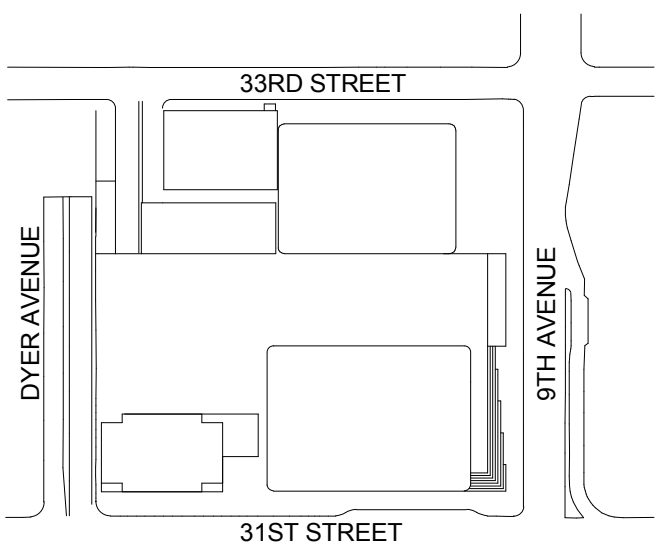
Facade Maintenance Consultant

Entek Engineering LLC
188 Ames Street, Hackensack, NJ 07601
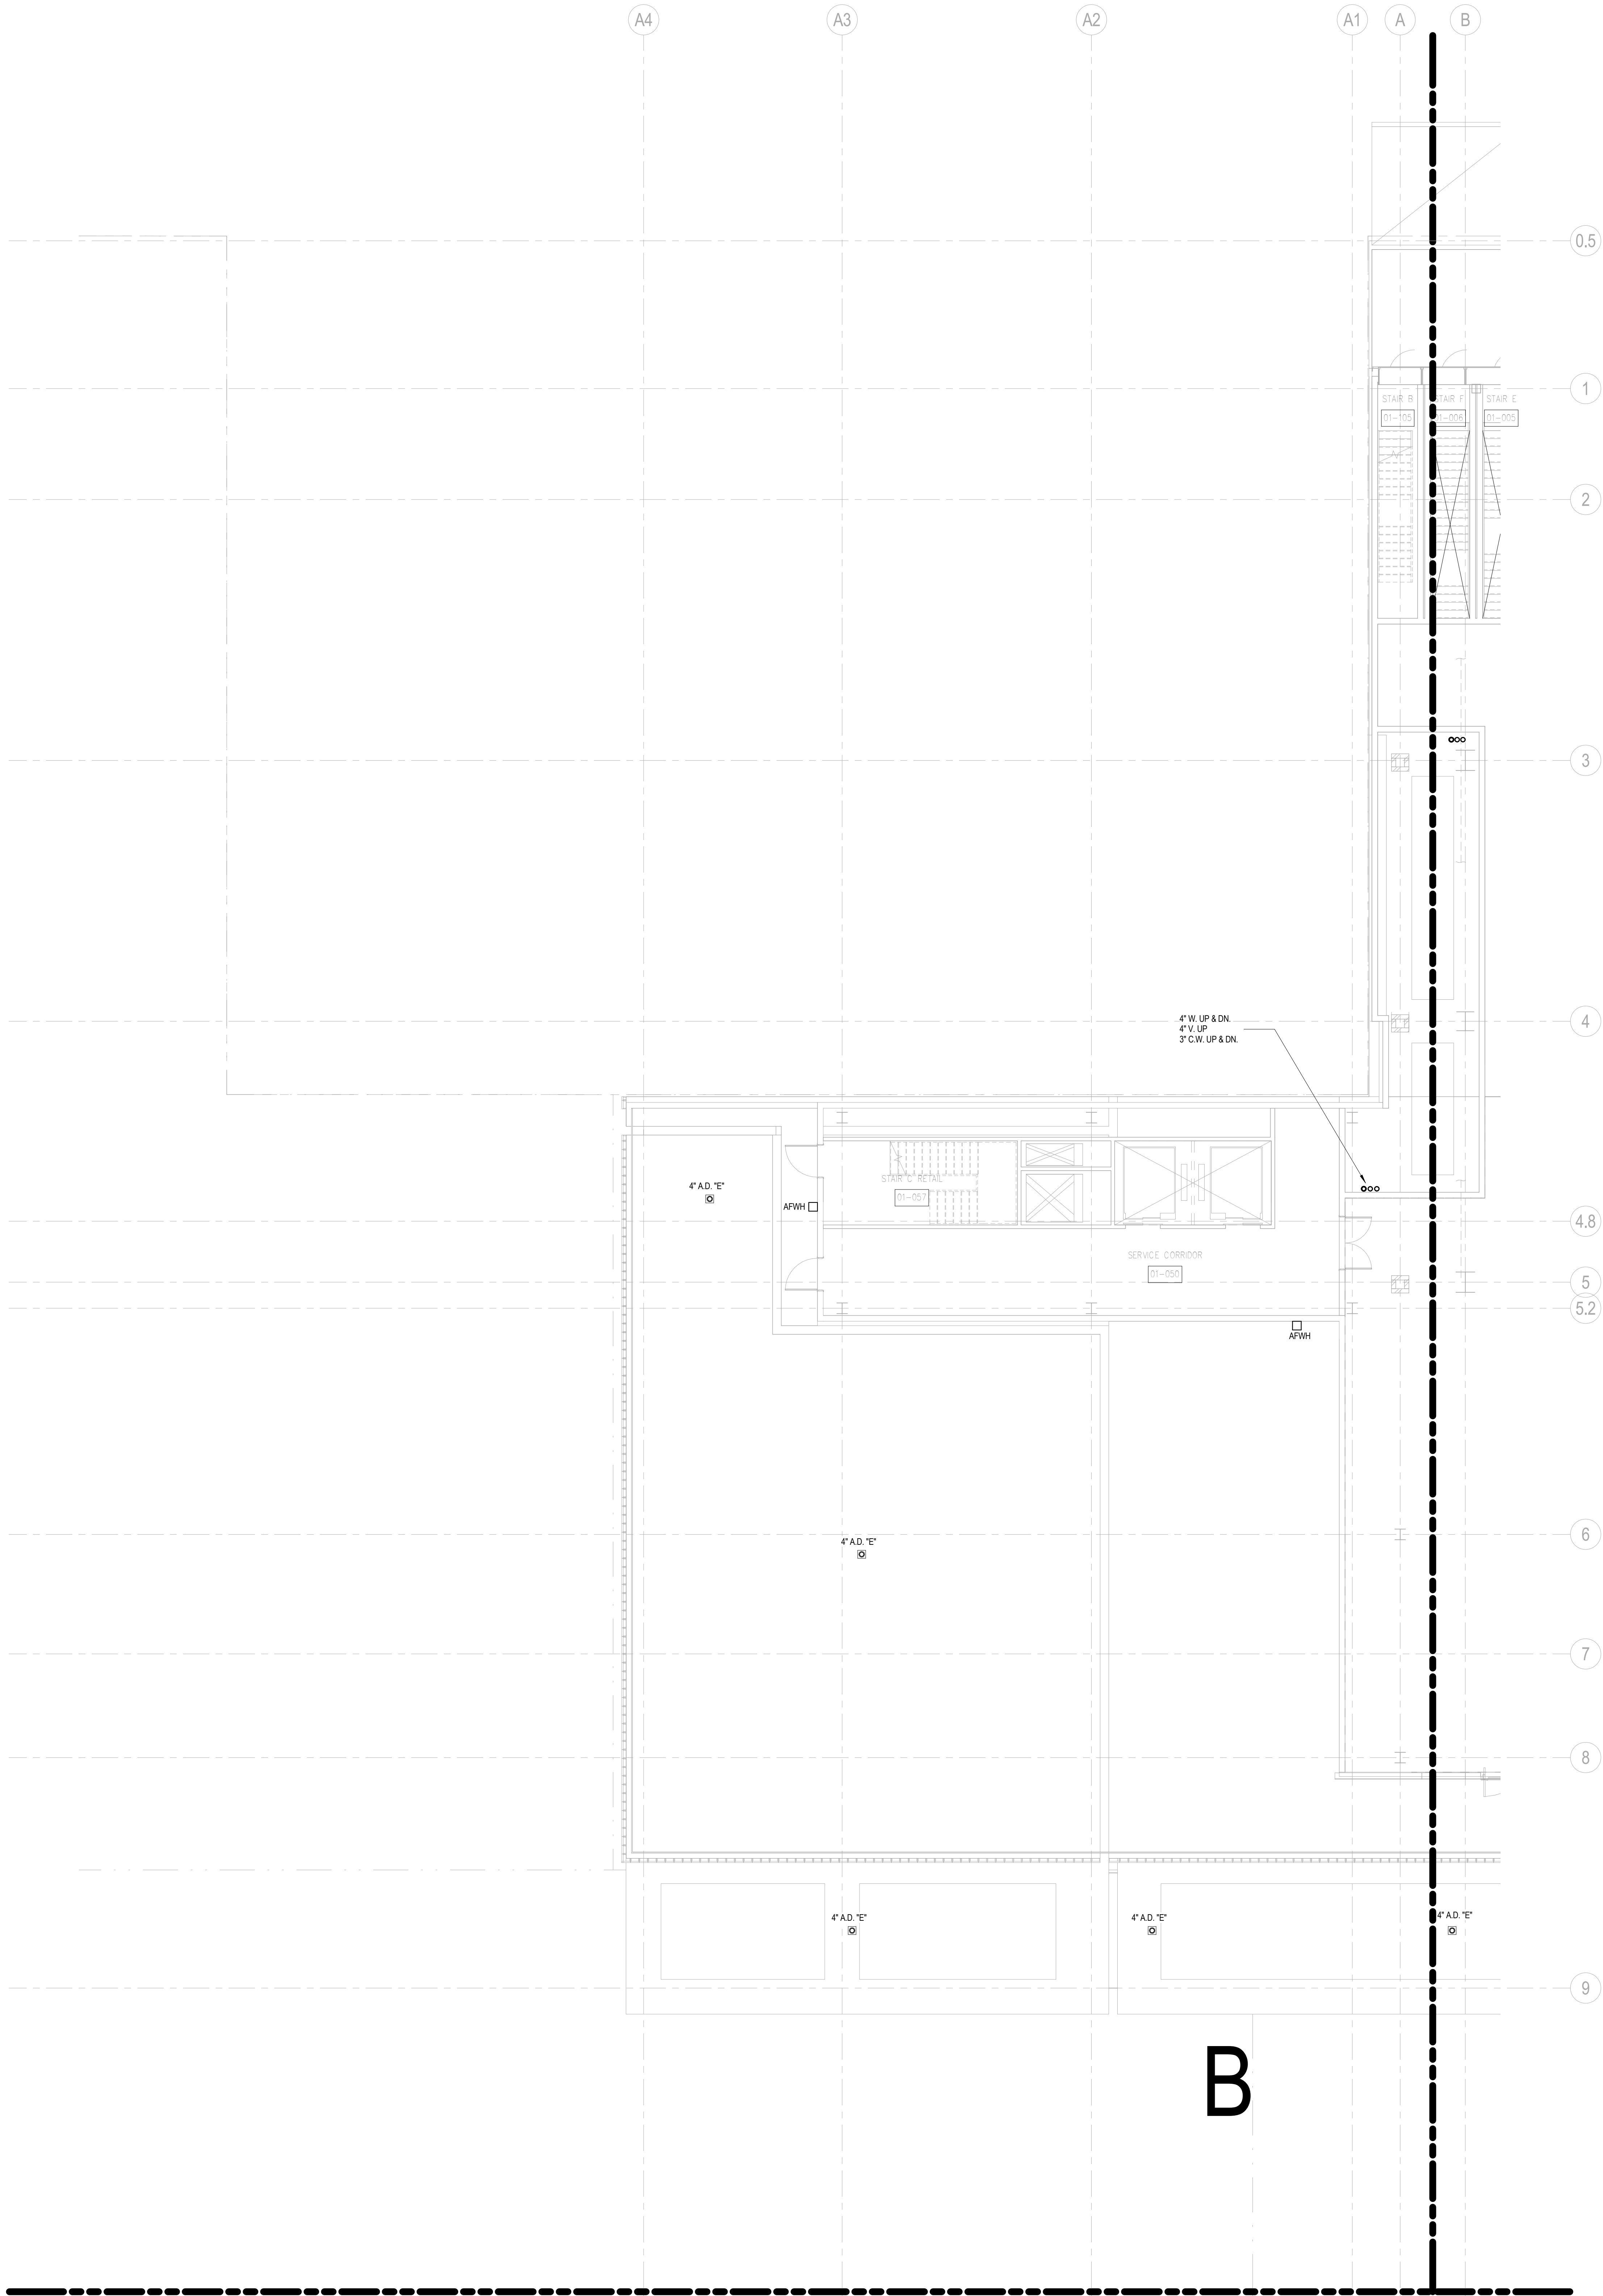
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Rowan Williams Davies & Irwin Inc.
650 Woodlawn Road West, Guelph
Ontario, Canada N1K 1S8

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No. Date Description
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**PLUMBING
GROUND FLOOR
PLAN - PART B**

Project No.:
14830-A-000

Date:
20 JUN 2014

Scale:
1/8" = 1'-0"

File No.:
P-101-B

B-SCAN Sheet No.:

P-101.00

Sheet No.:

P-101-B

Page No.:
13 OF 6

SHEET NOTES



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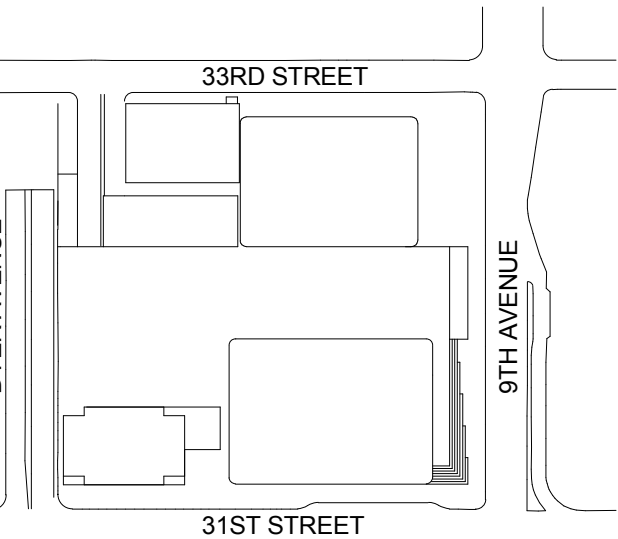
Facade Maintenance Consultant

Entek Engineering LLC
186 Ames Street, Hackensack, NJ 07601

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No. Date Description

Sheet Name:

**PLUMBING
LEVEL 2 FLOOR
PLAN - RETAIL**

Project No.:

14830-A-000

Date:

20 JUN 2014

Scale:

1/8" = 1'-0"

File No.:

P-102

B-SCAN Sheet No.:

P-102.00


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P-102

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Page No.. P-103	Page No.. 15 OF 6
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Brookfield Place
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Security Consultant
Ducibella, Ventor & Santore
250 State Street #F1, North Haven, CT 06473

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40 Wall Street, New York, NY 10005


Acoustical Consultant
Cerami & Associates
404 Fifth Avenue #8, New York, NY 10018

Vibration Consultant
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65 Broadway, Suite 401, New York, NY 10006
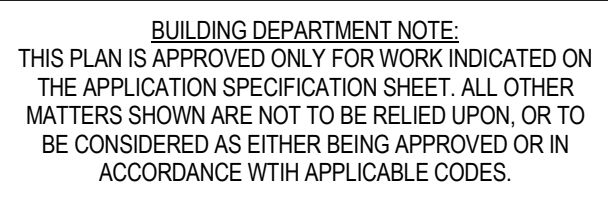
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186 Ames Street, Hackensack, NJ 07601

Wind Tunnel Consultant
Rowan Williams Davies & Irwin Inc.
650 Woodlawn Road West, Guelph
Ontario, Canada N1K 1B8

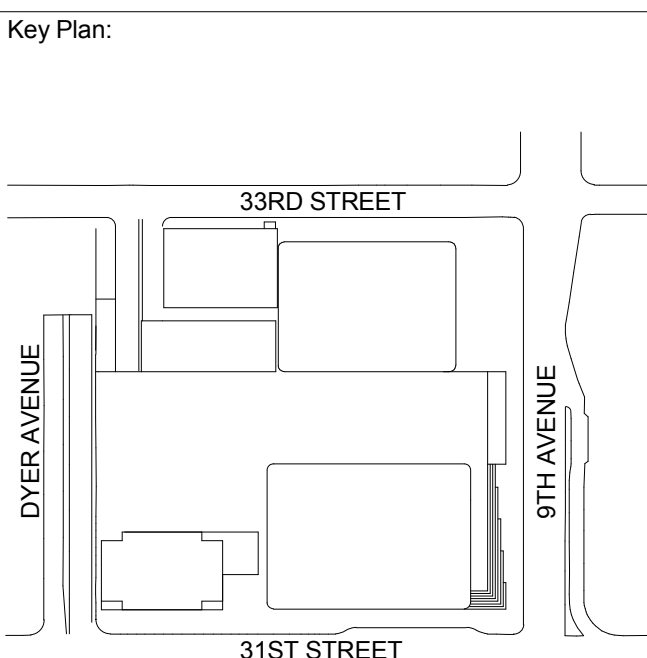


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**PLUMBING
LEVEL 4 FLOOR
PLAN -
MECHANICAL**

Project No.: 14830-A-000	B-SCAN Sheet No.: P-104.00
Date: 20 JUN 2014	Sheet No.: P-104
Scale: 1/8" = 1'-0"	Page No.: 16 OF 6
File No.: P-104	

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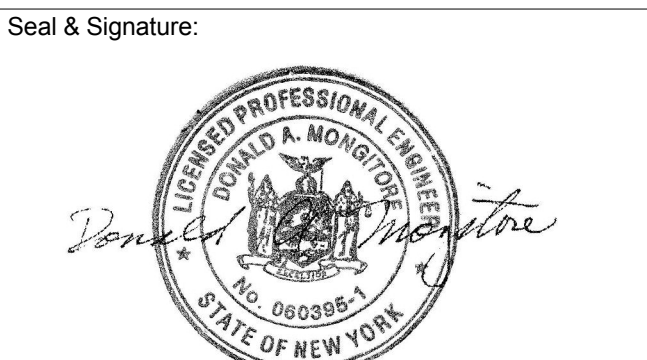
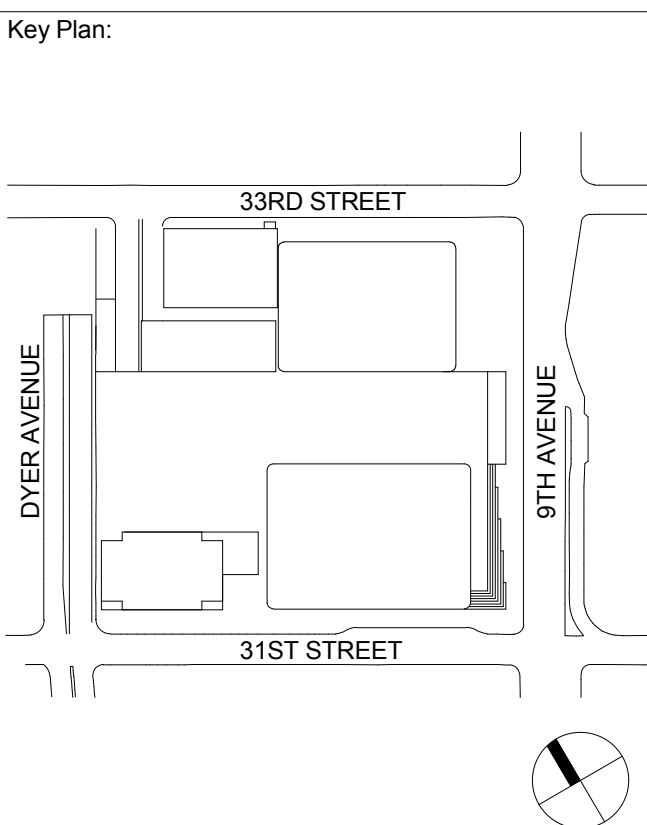
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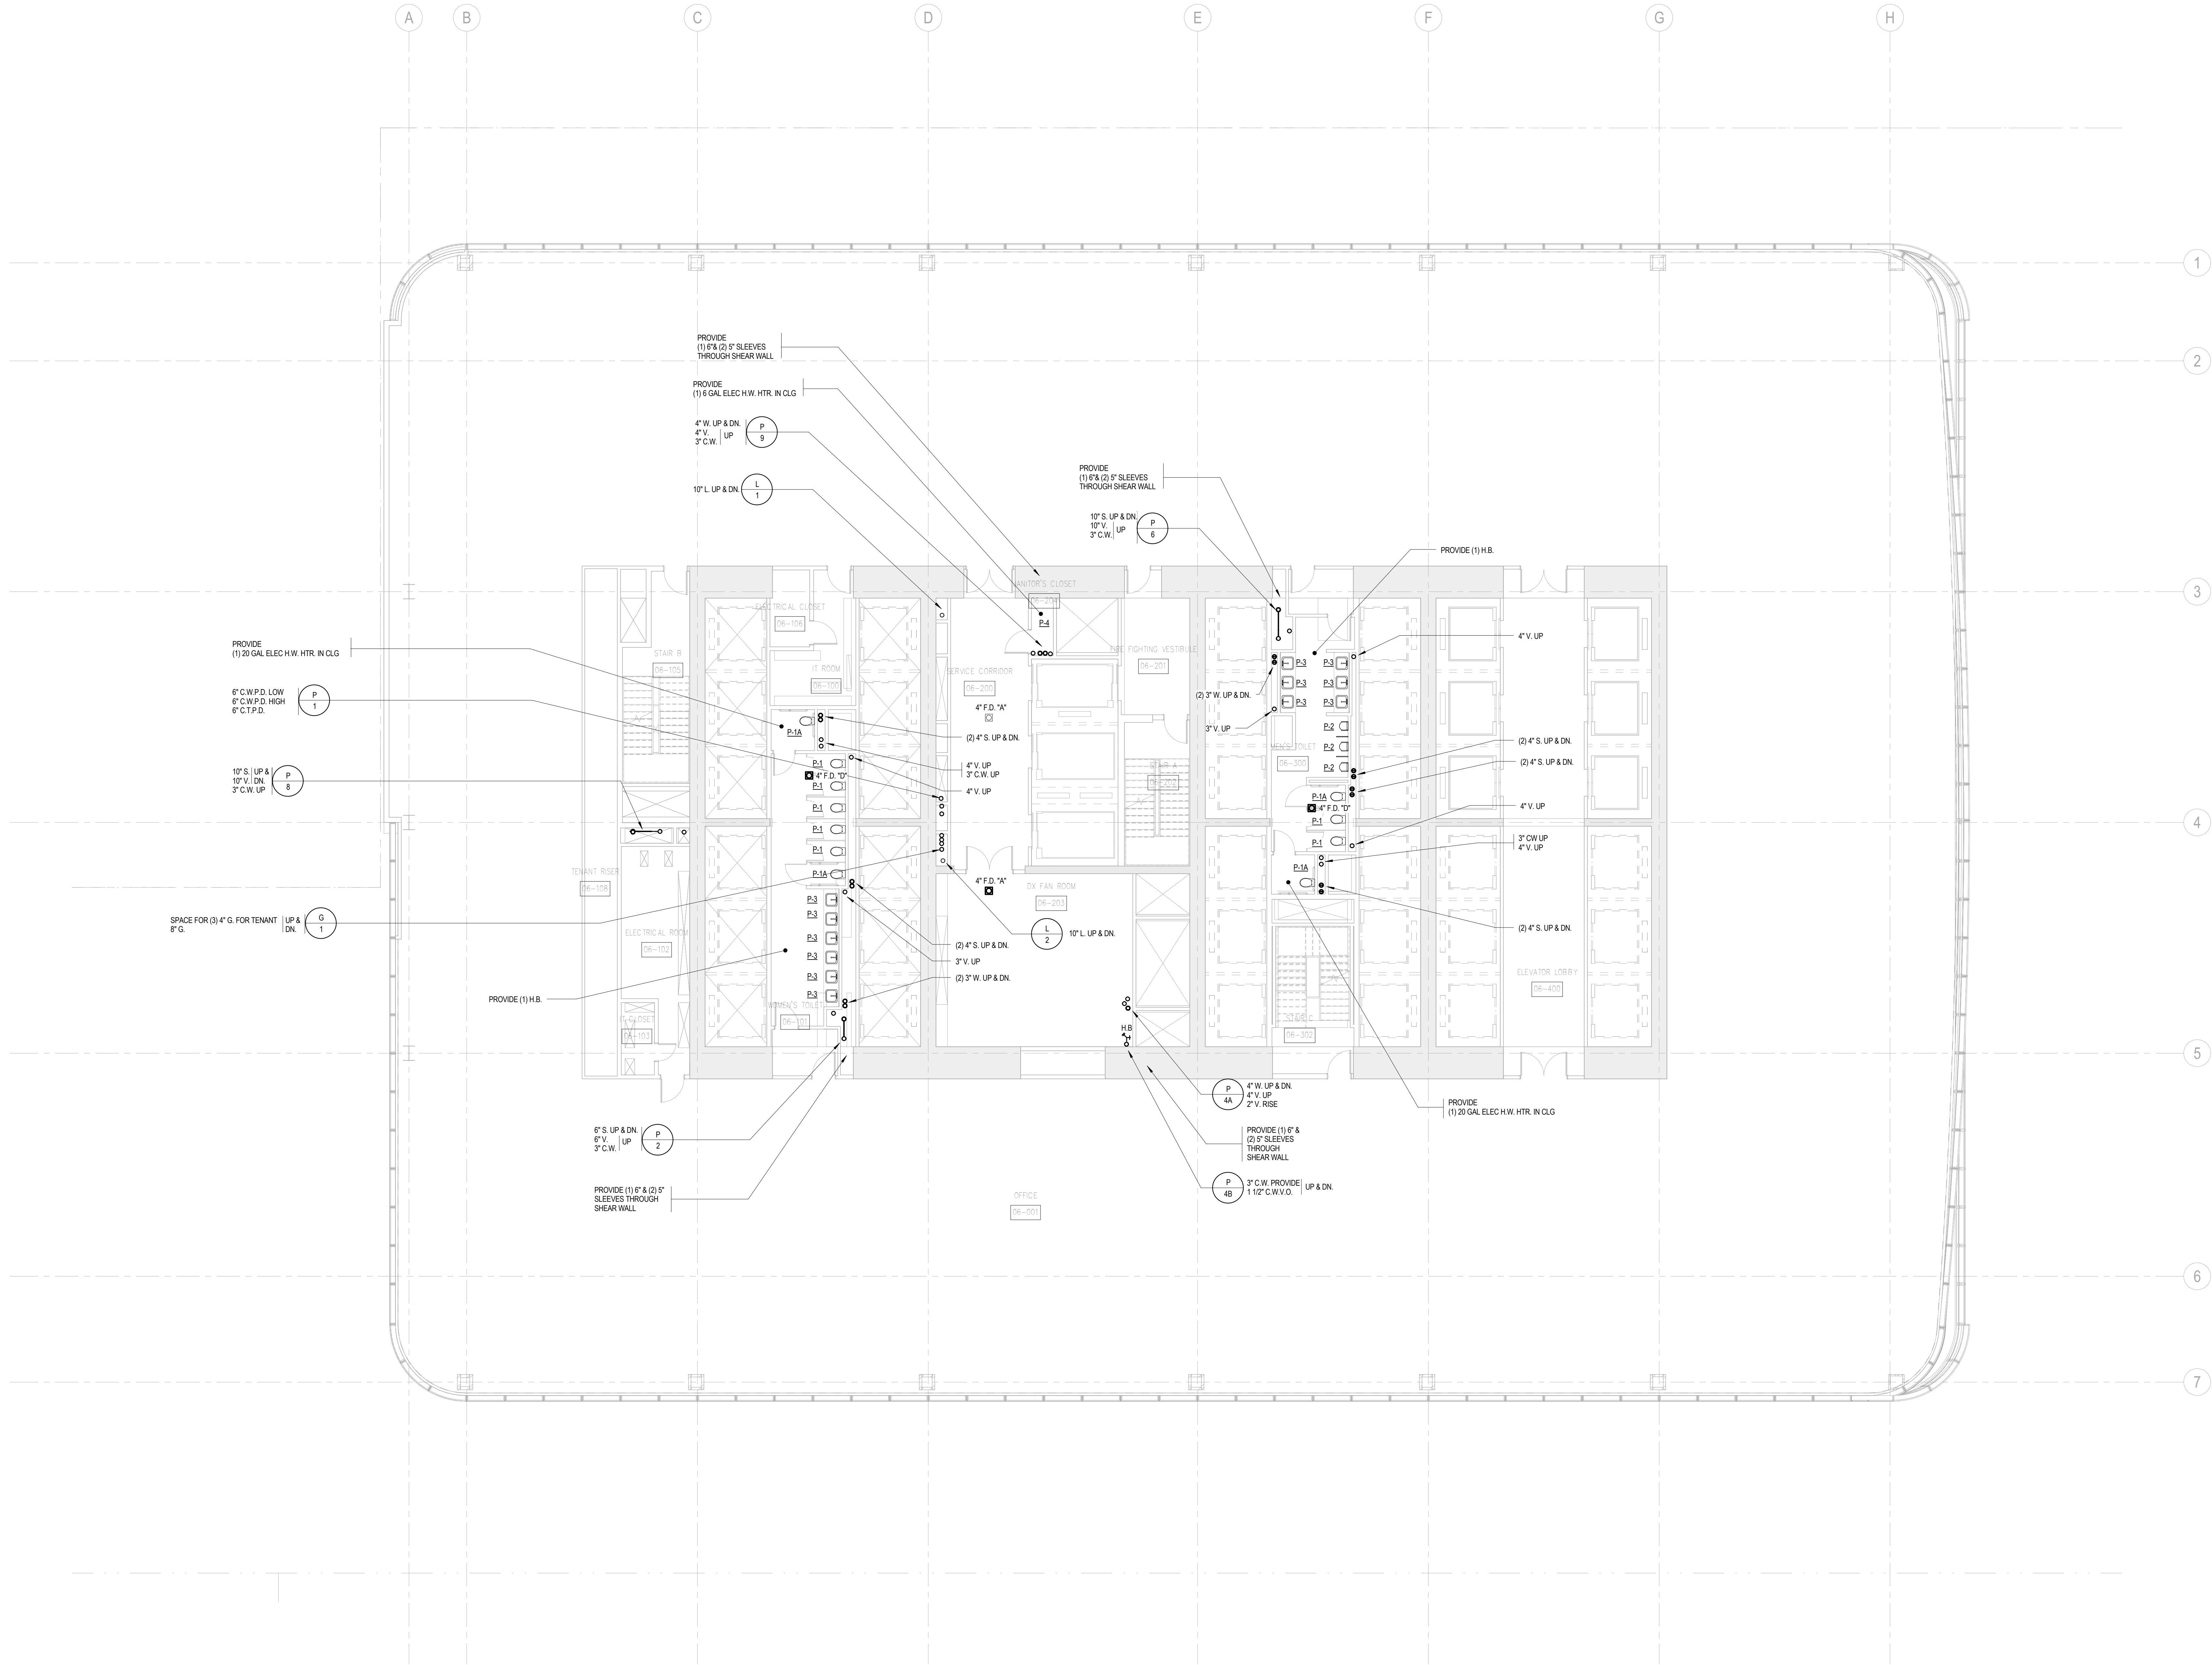
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**PLUMBING
LEVEL 6-15
FLOOR PLAN -
TYPICAL
LOW-RISE**

Project No.: 14830-A-000
Date: 20 JUN 2014
Scale: 1/8" = 1'-0"
File No.: P-106
B-SCAN Sheet No.:
P-106.00
Sheet No.: P-106
Page No.: 18 OF 6

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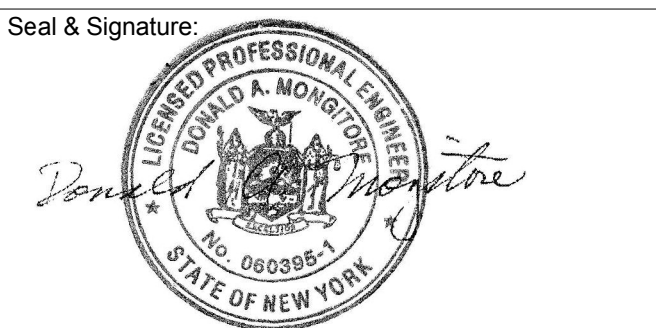
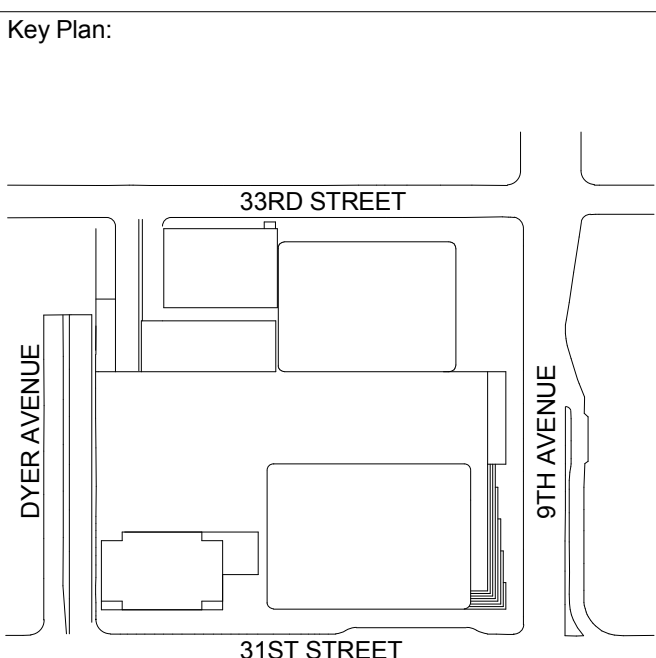
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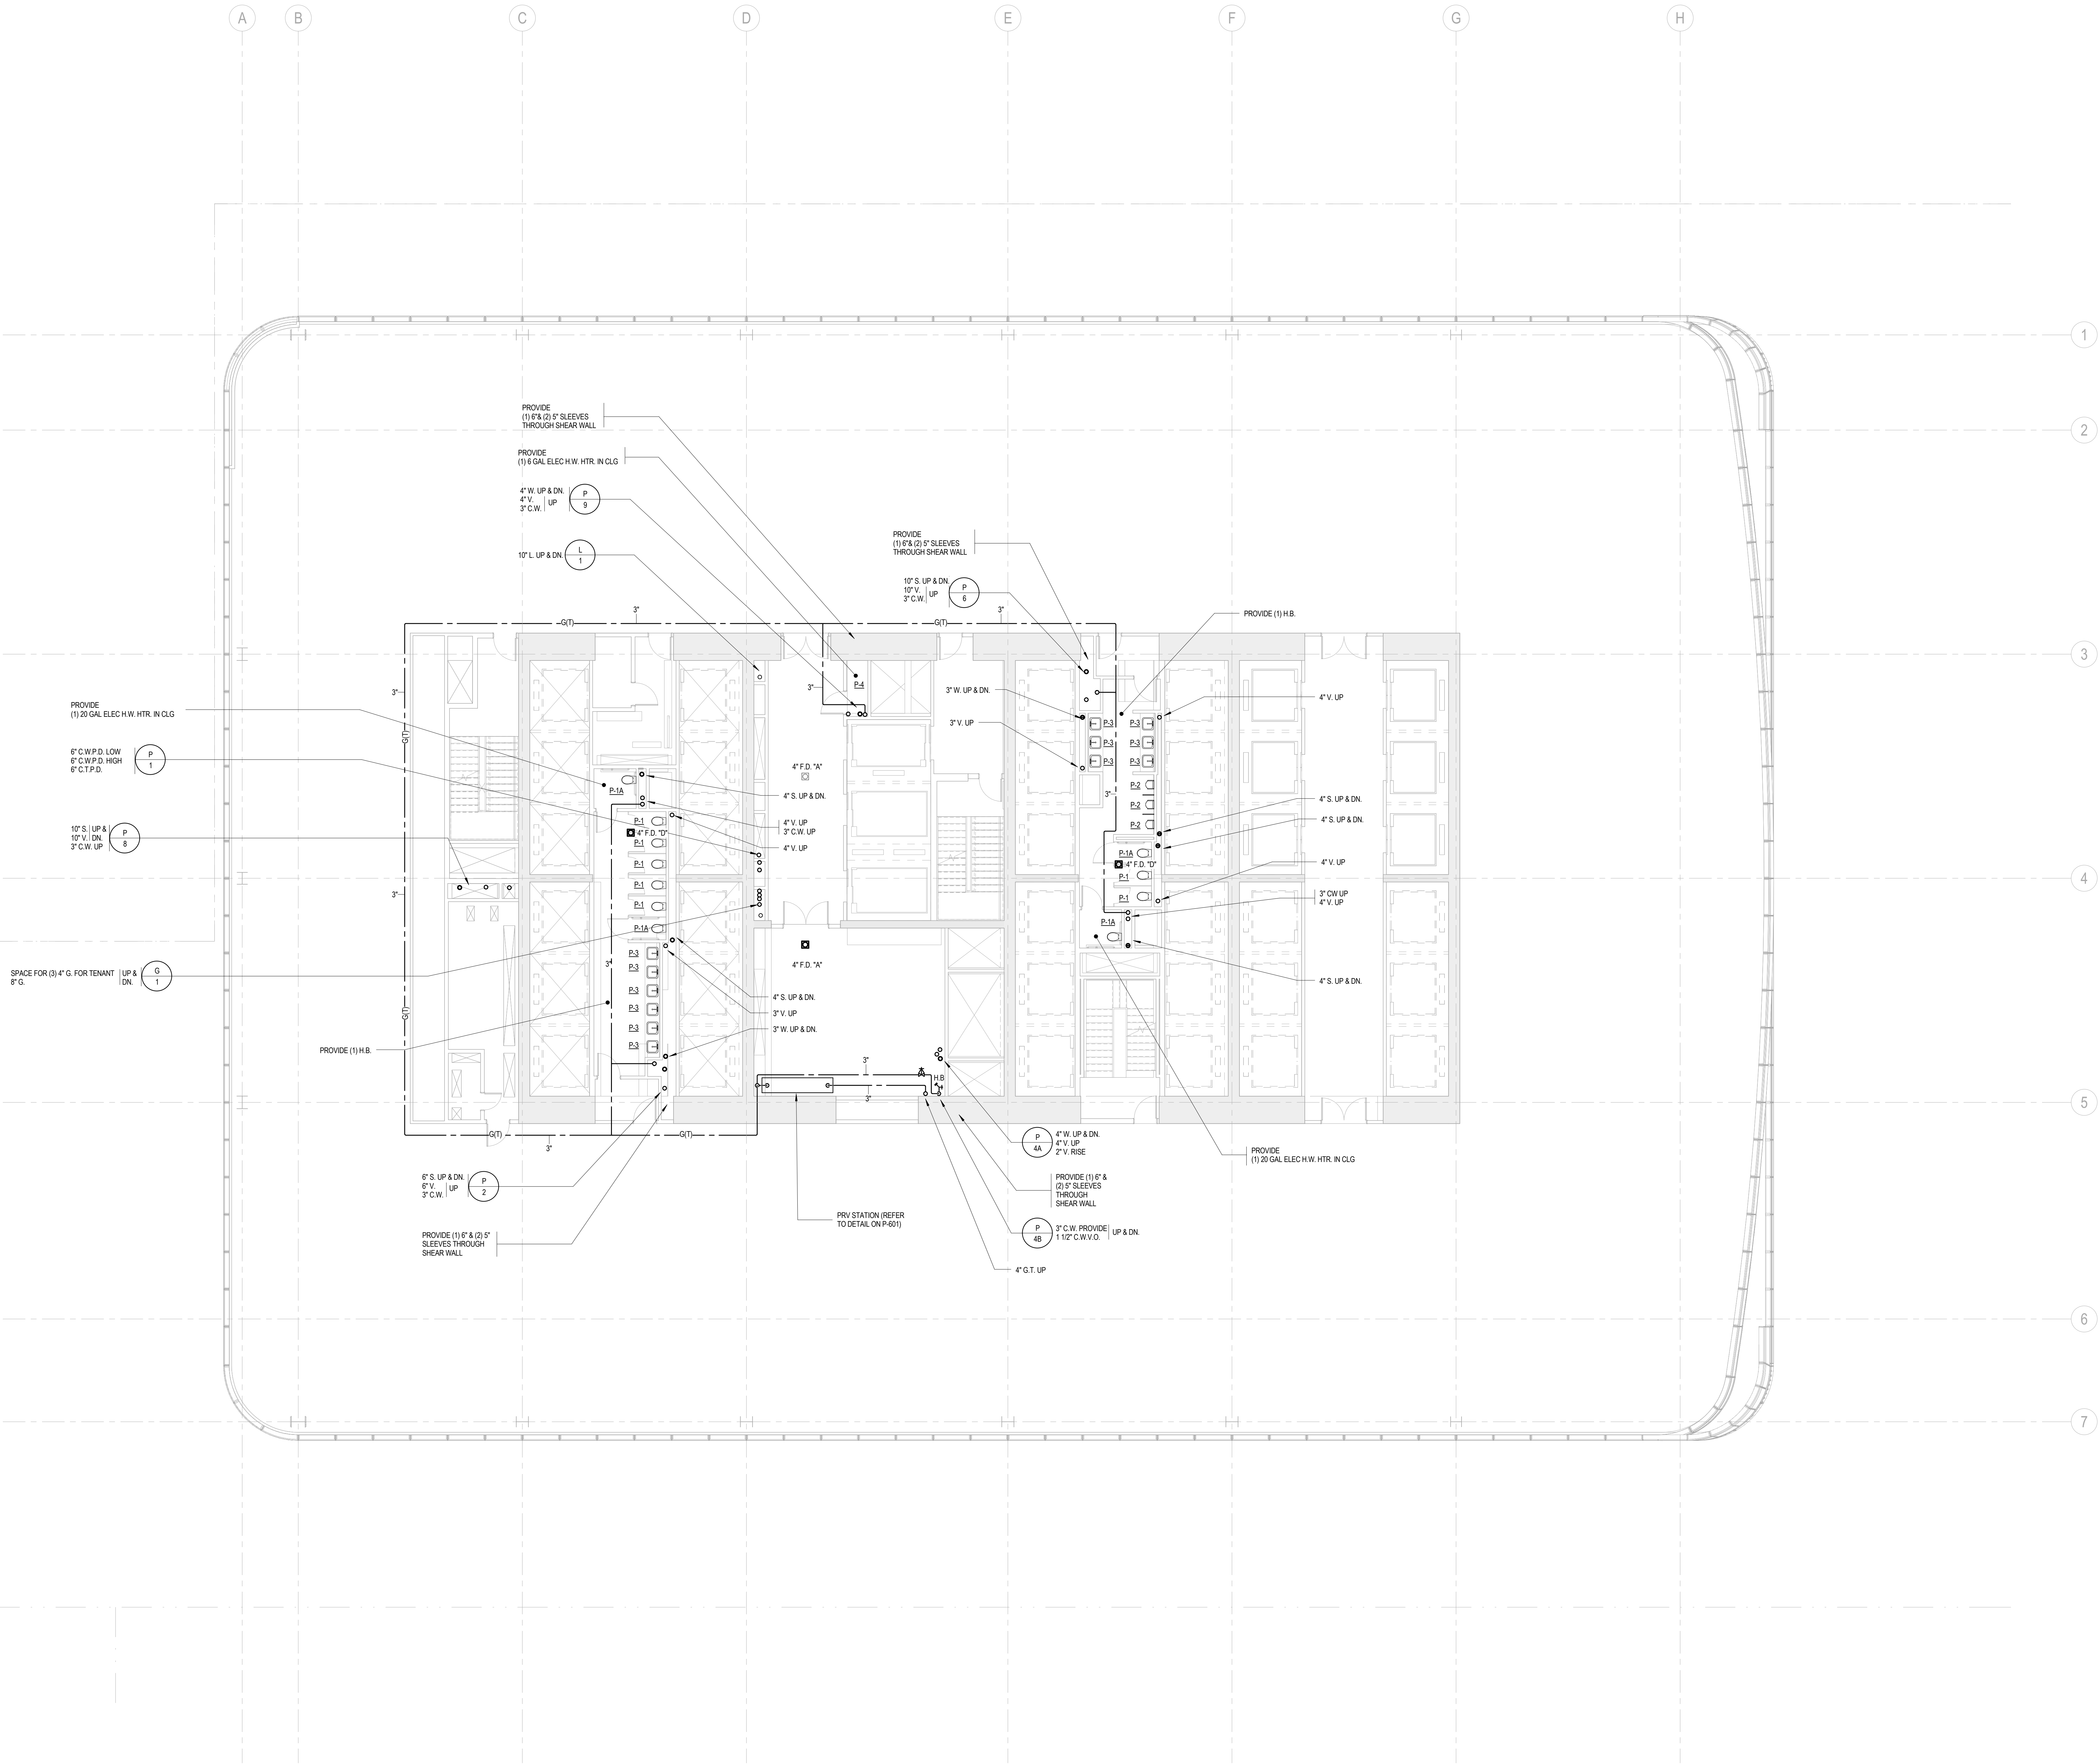
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**PLUMBING
LEVEL 16 FLOOR
PLAN - TYPICAL
LOW-RISE**

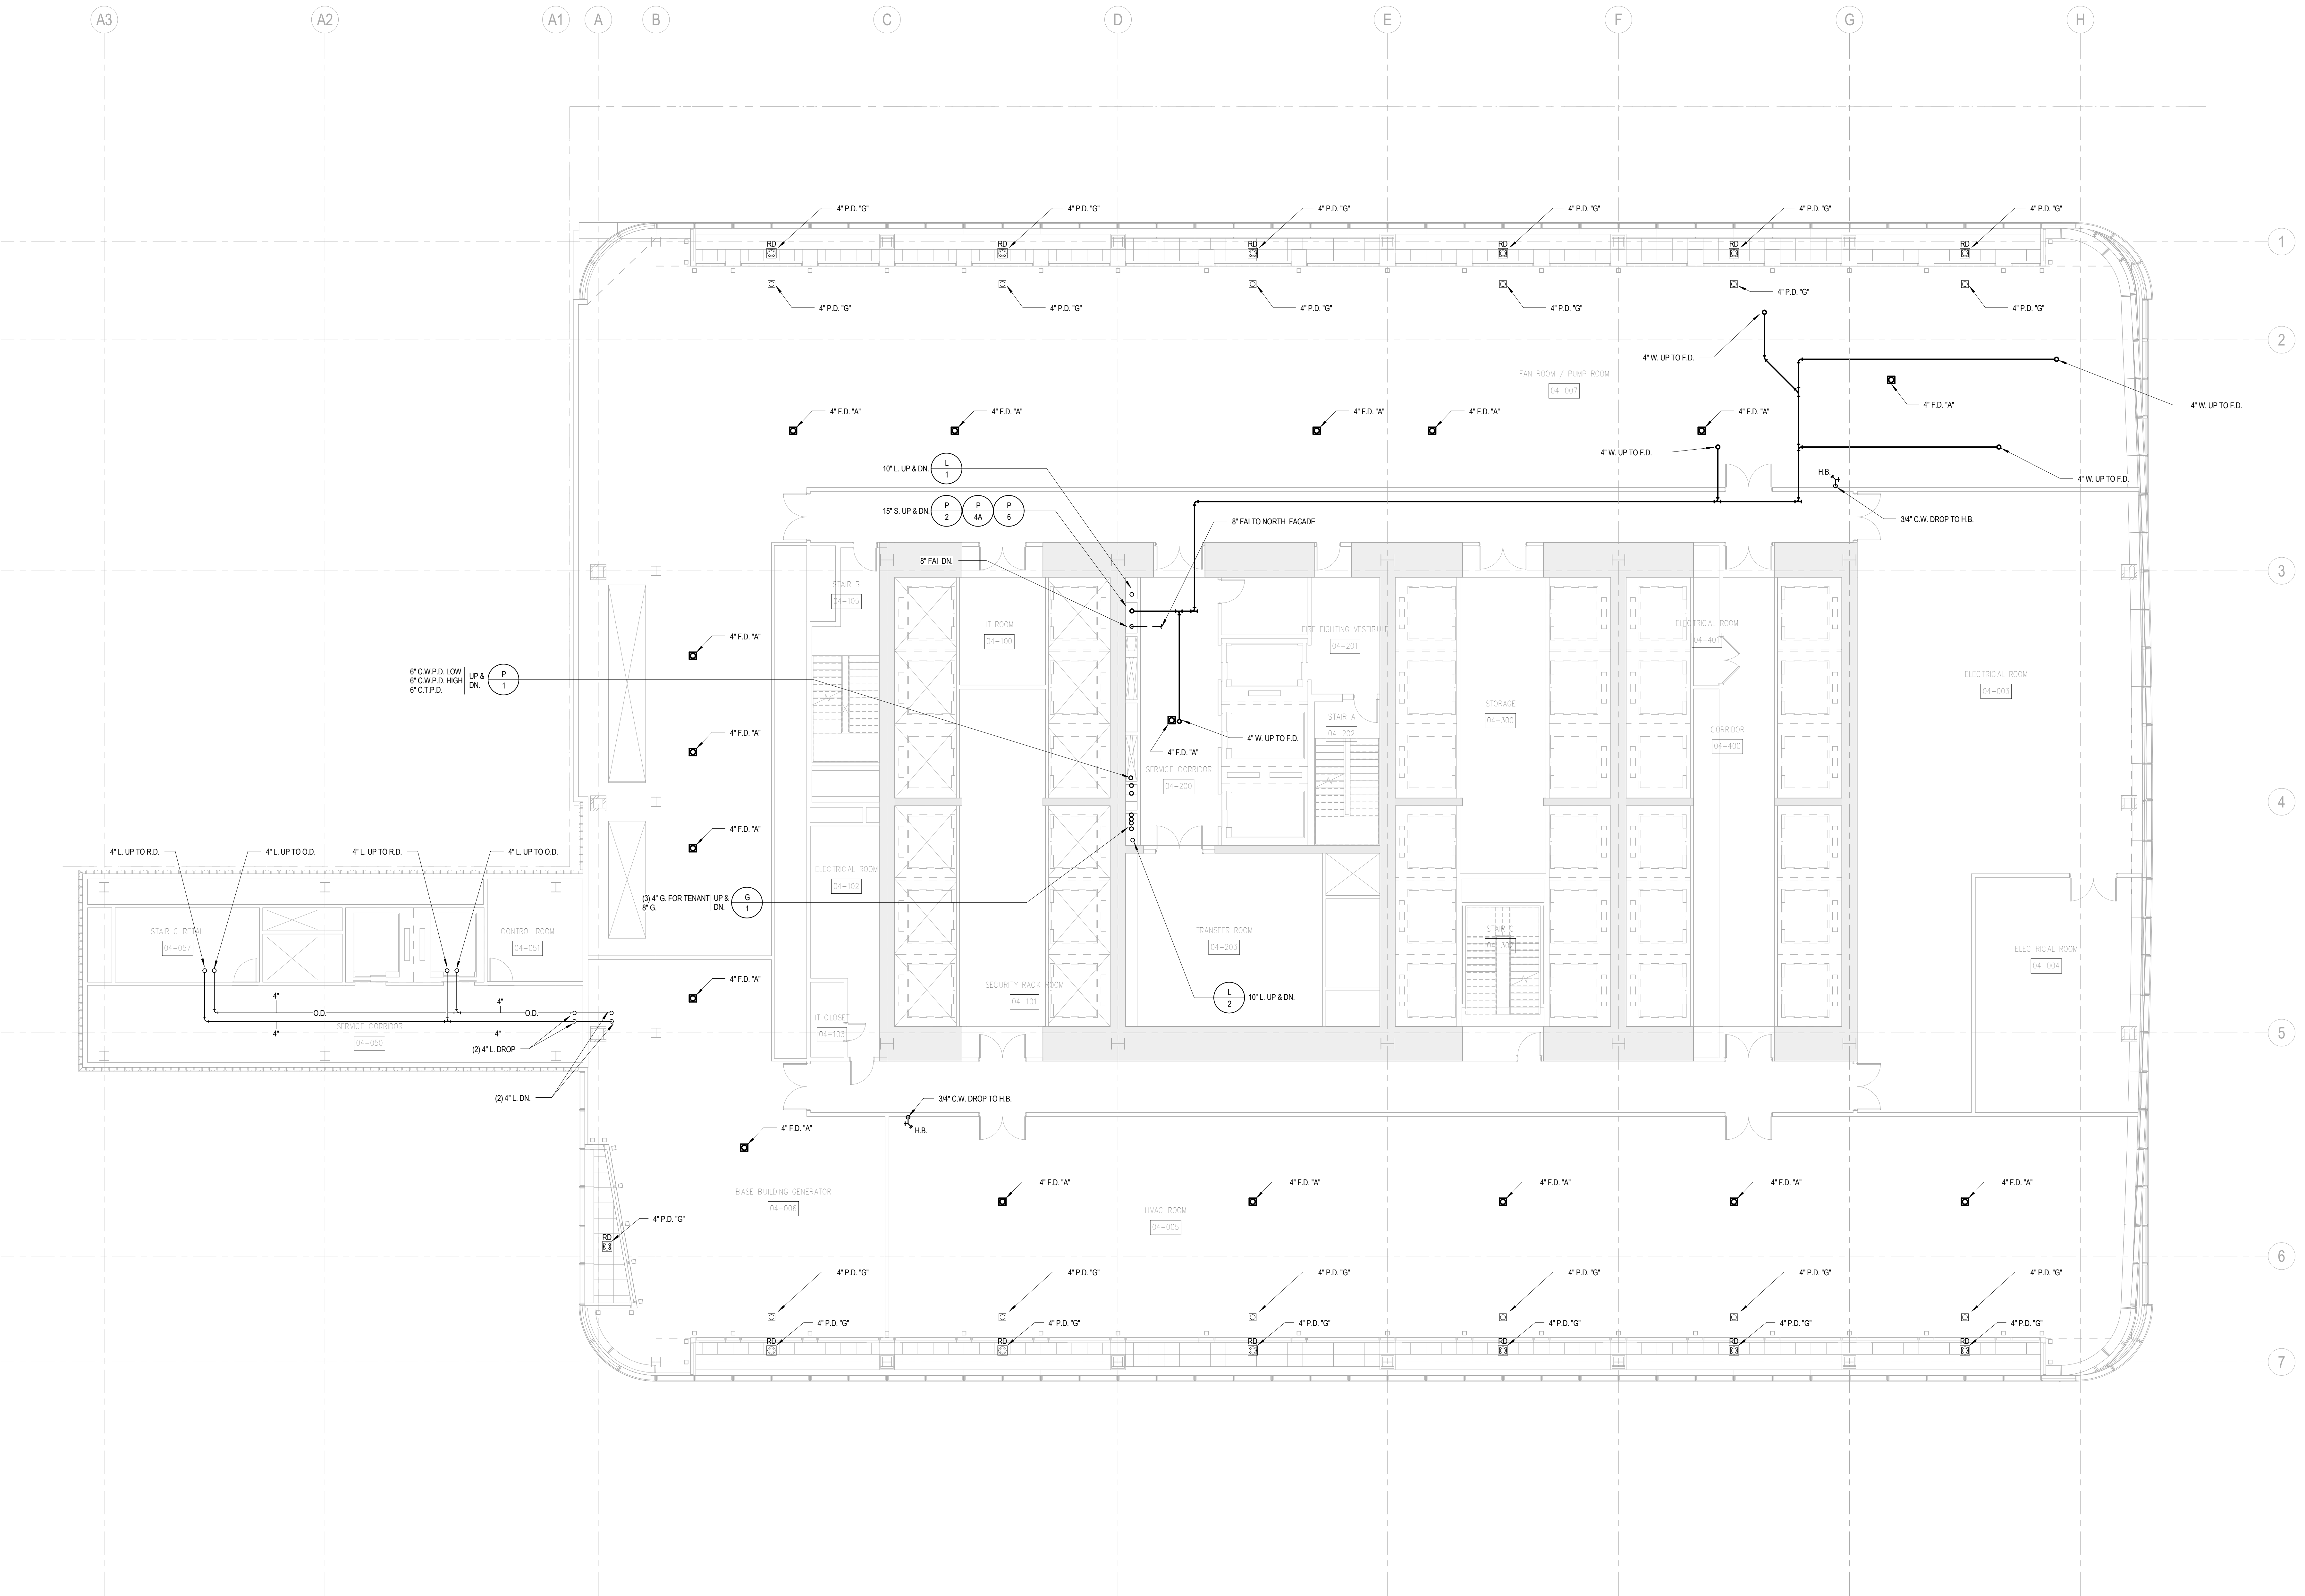Project No.: 14830-A-000	B-SCAN Sheet No.: P-116.00
Date: 20 JUN 2014	Sheet No.: P-116
Scale: 1/8" = 1'-0"	Page No.: 19 OF 6
File No.: P-116	

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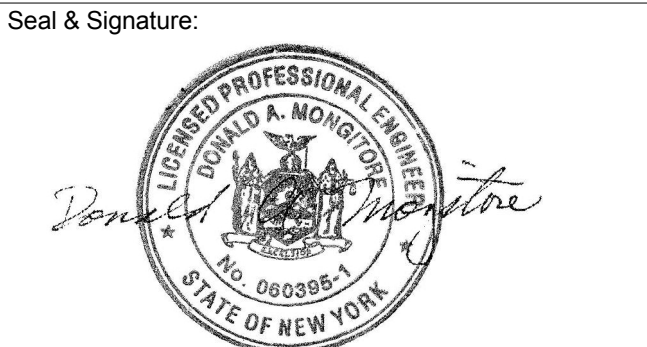
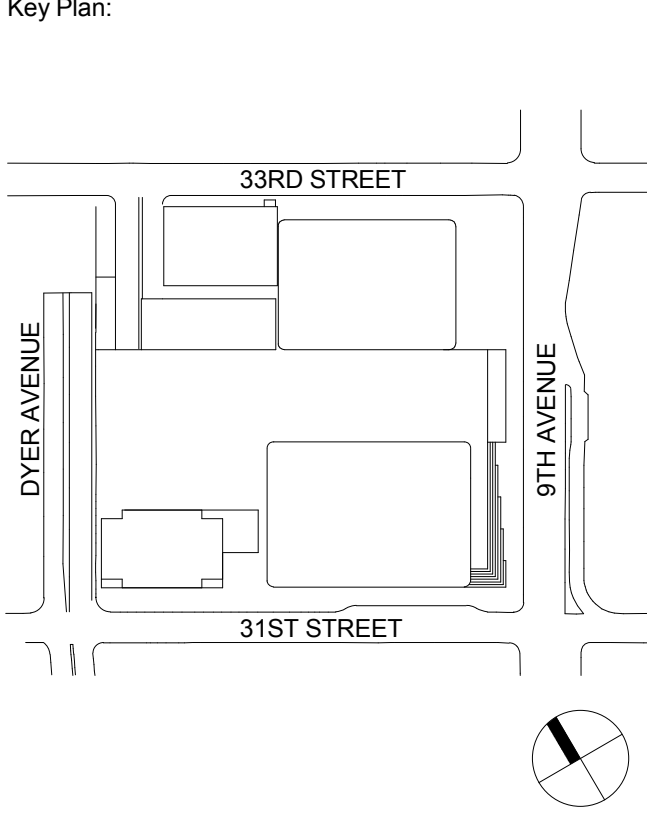
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Facade Maintenance Consultant
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186 Ames Street, Hackensack, NJ 07601

Wind Tunnel Consultant
Rowan Williams Davies & Irwin Inc.
650 Woodlawn Road West, Guelph
Ontario, Canada N1K 1B8





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No.	Date	Description
Sheet Name:		

**PLUMBING
LEVEL 17 FLOOR
PLAN - LOW-RISE**

Project No.: 14830-A-000	B-SCAN Sheet No.: P-117.00
Date: 20 JUN 2014	Sheet No.: P-117
Scale: 1/8" = 1'-0"	Page No.: 20 OF 6
File No.: P-117	

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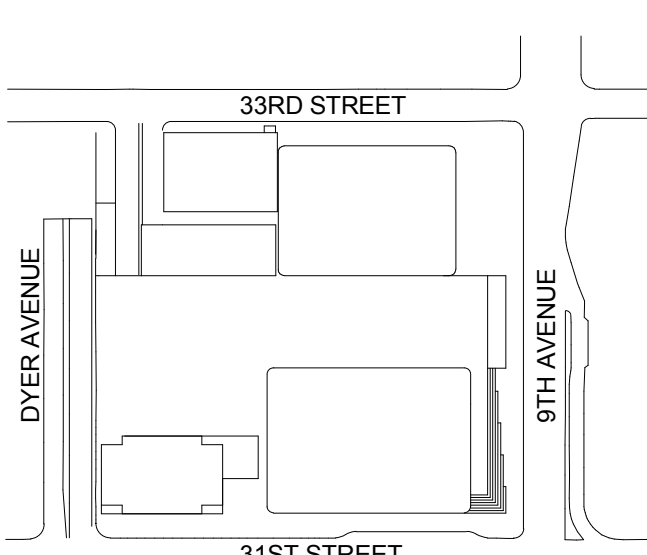
Facade Maintenance Consultant
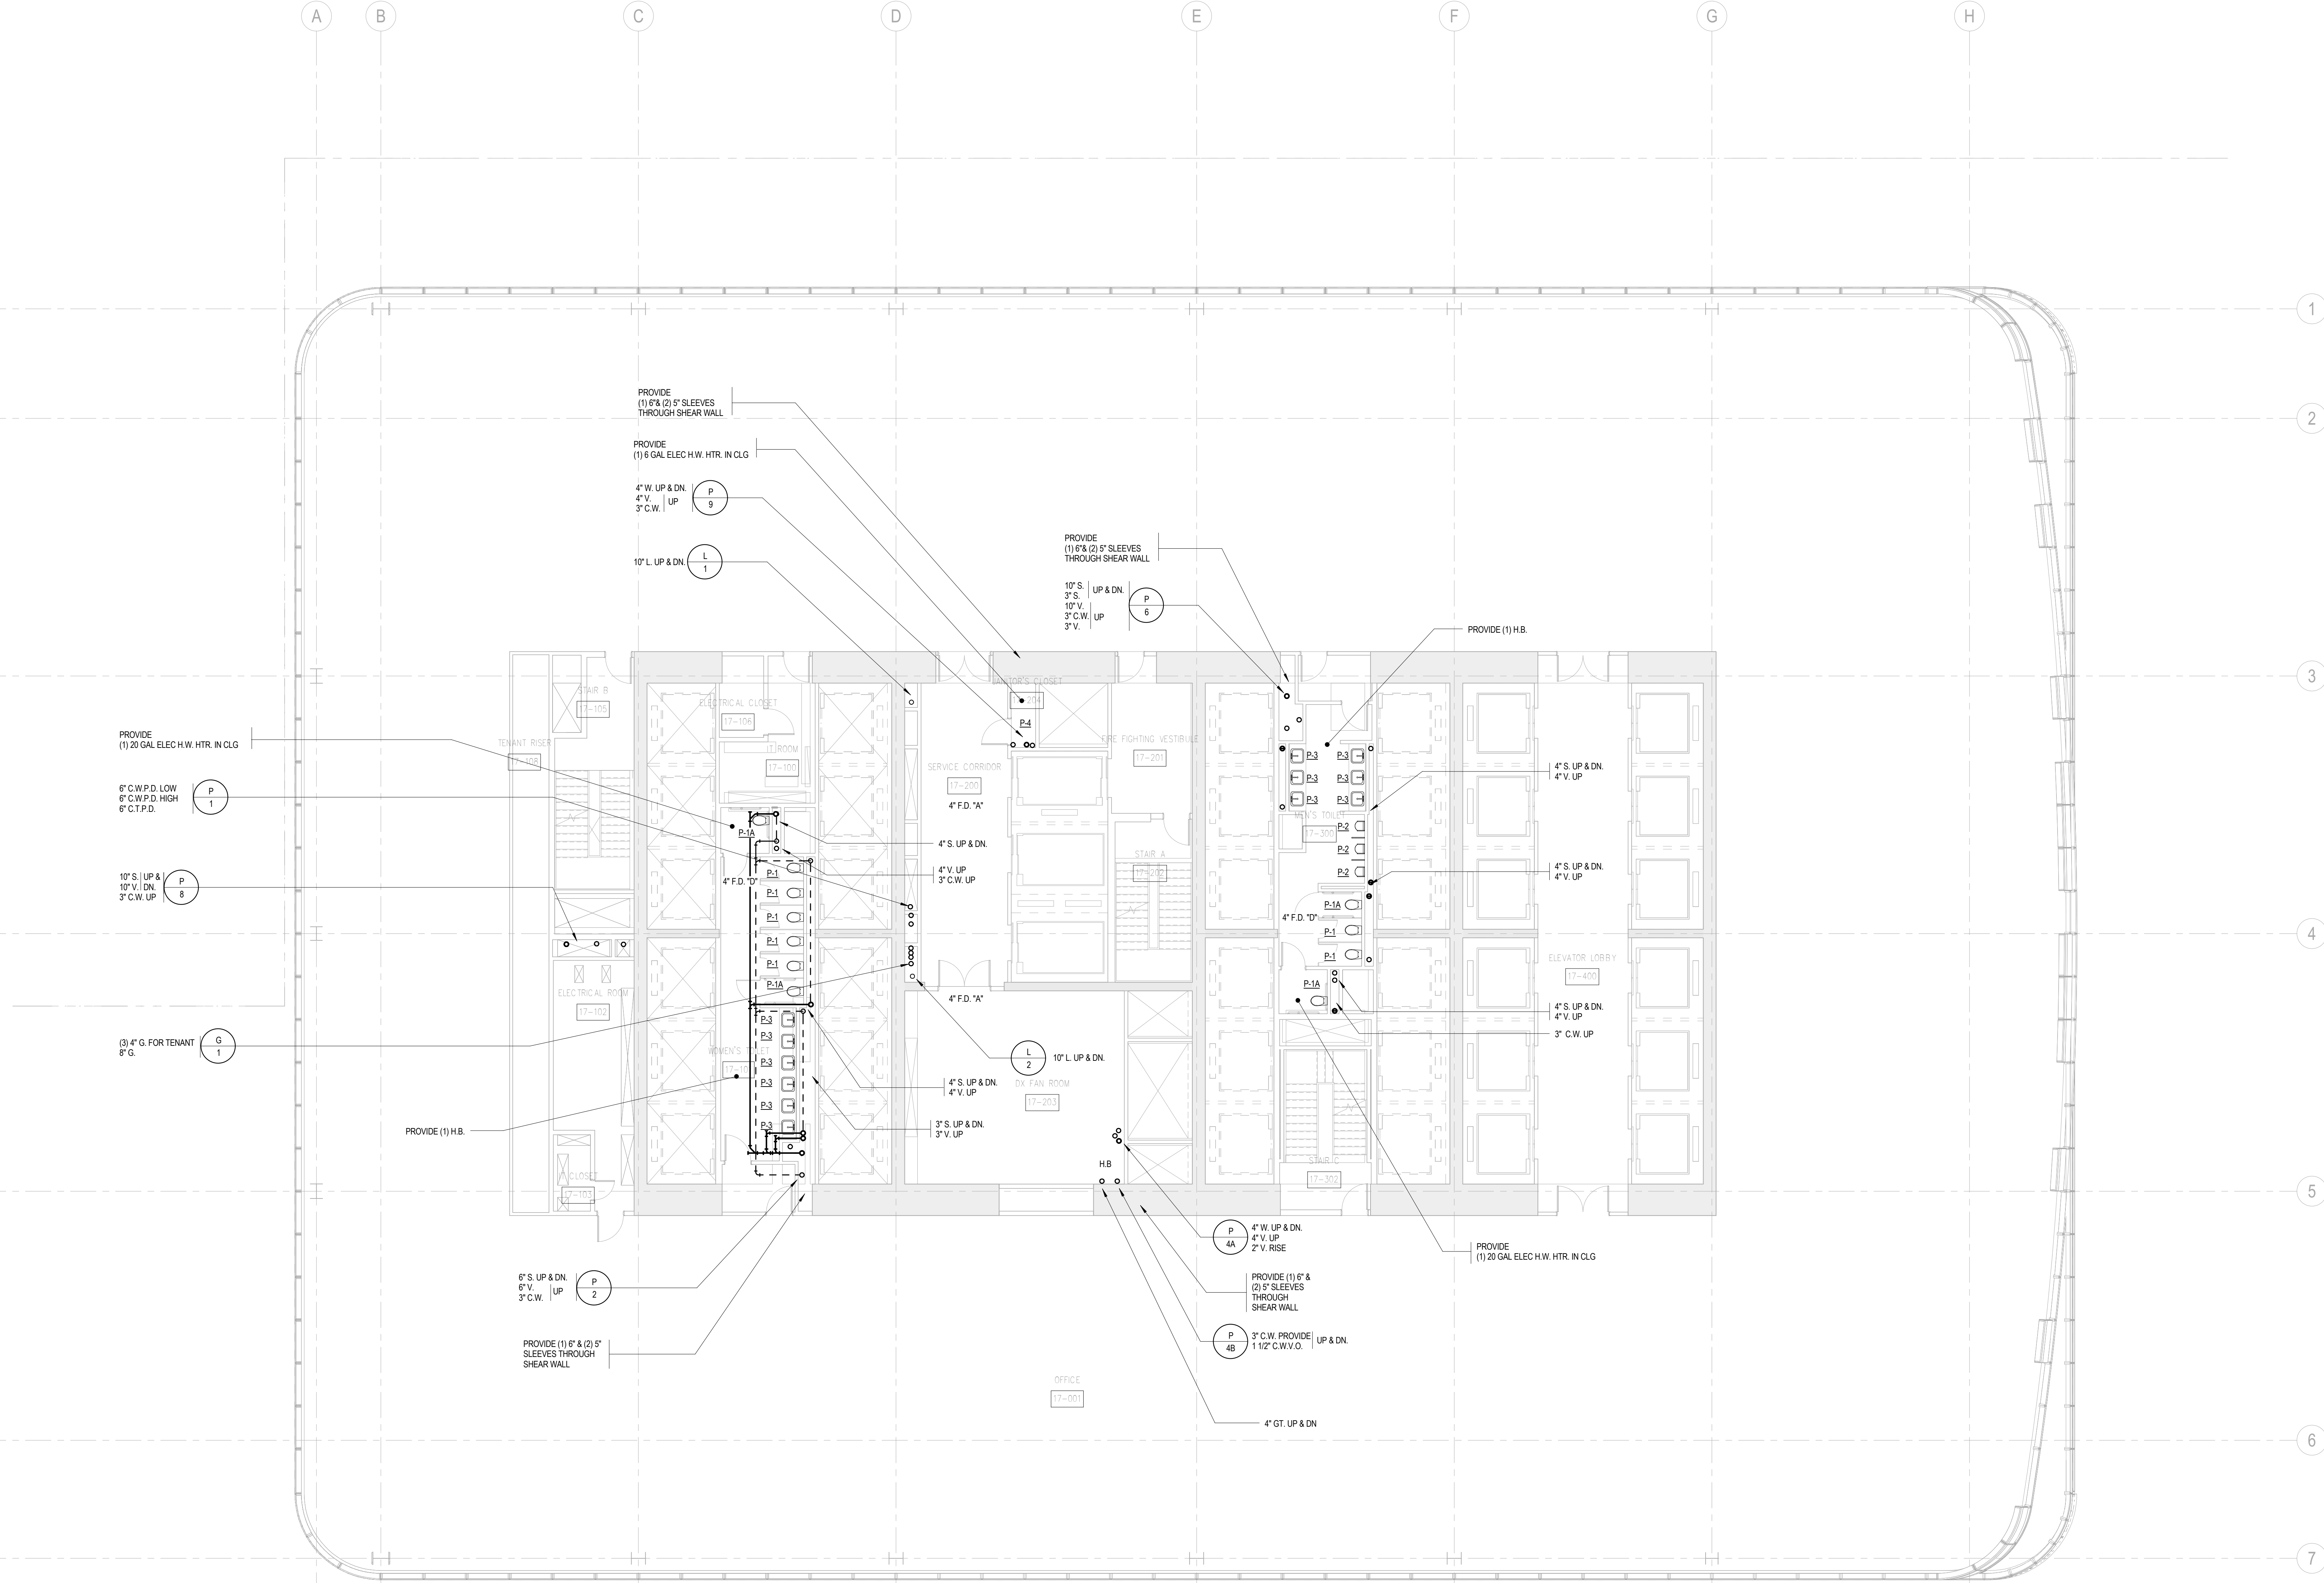
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188 Ames Street, Hackensack, NJ 07601
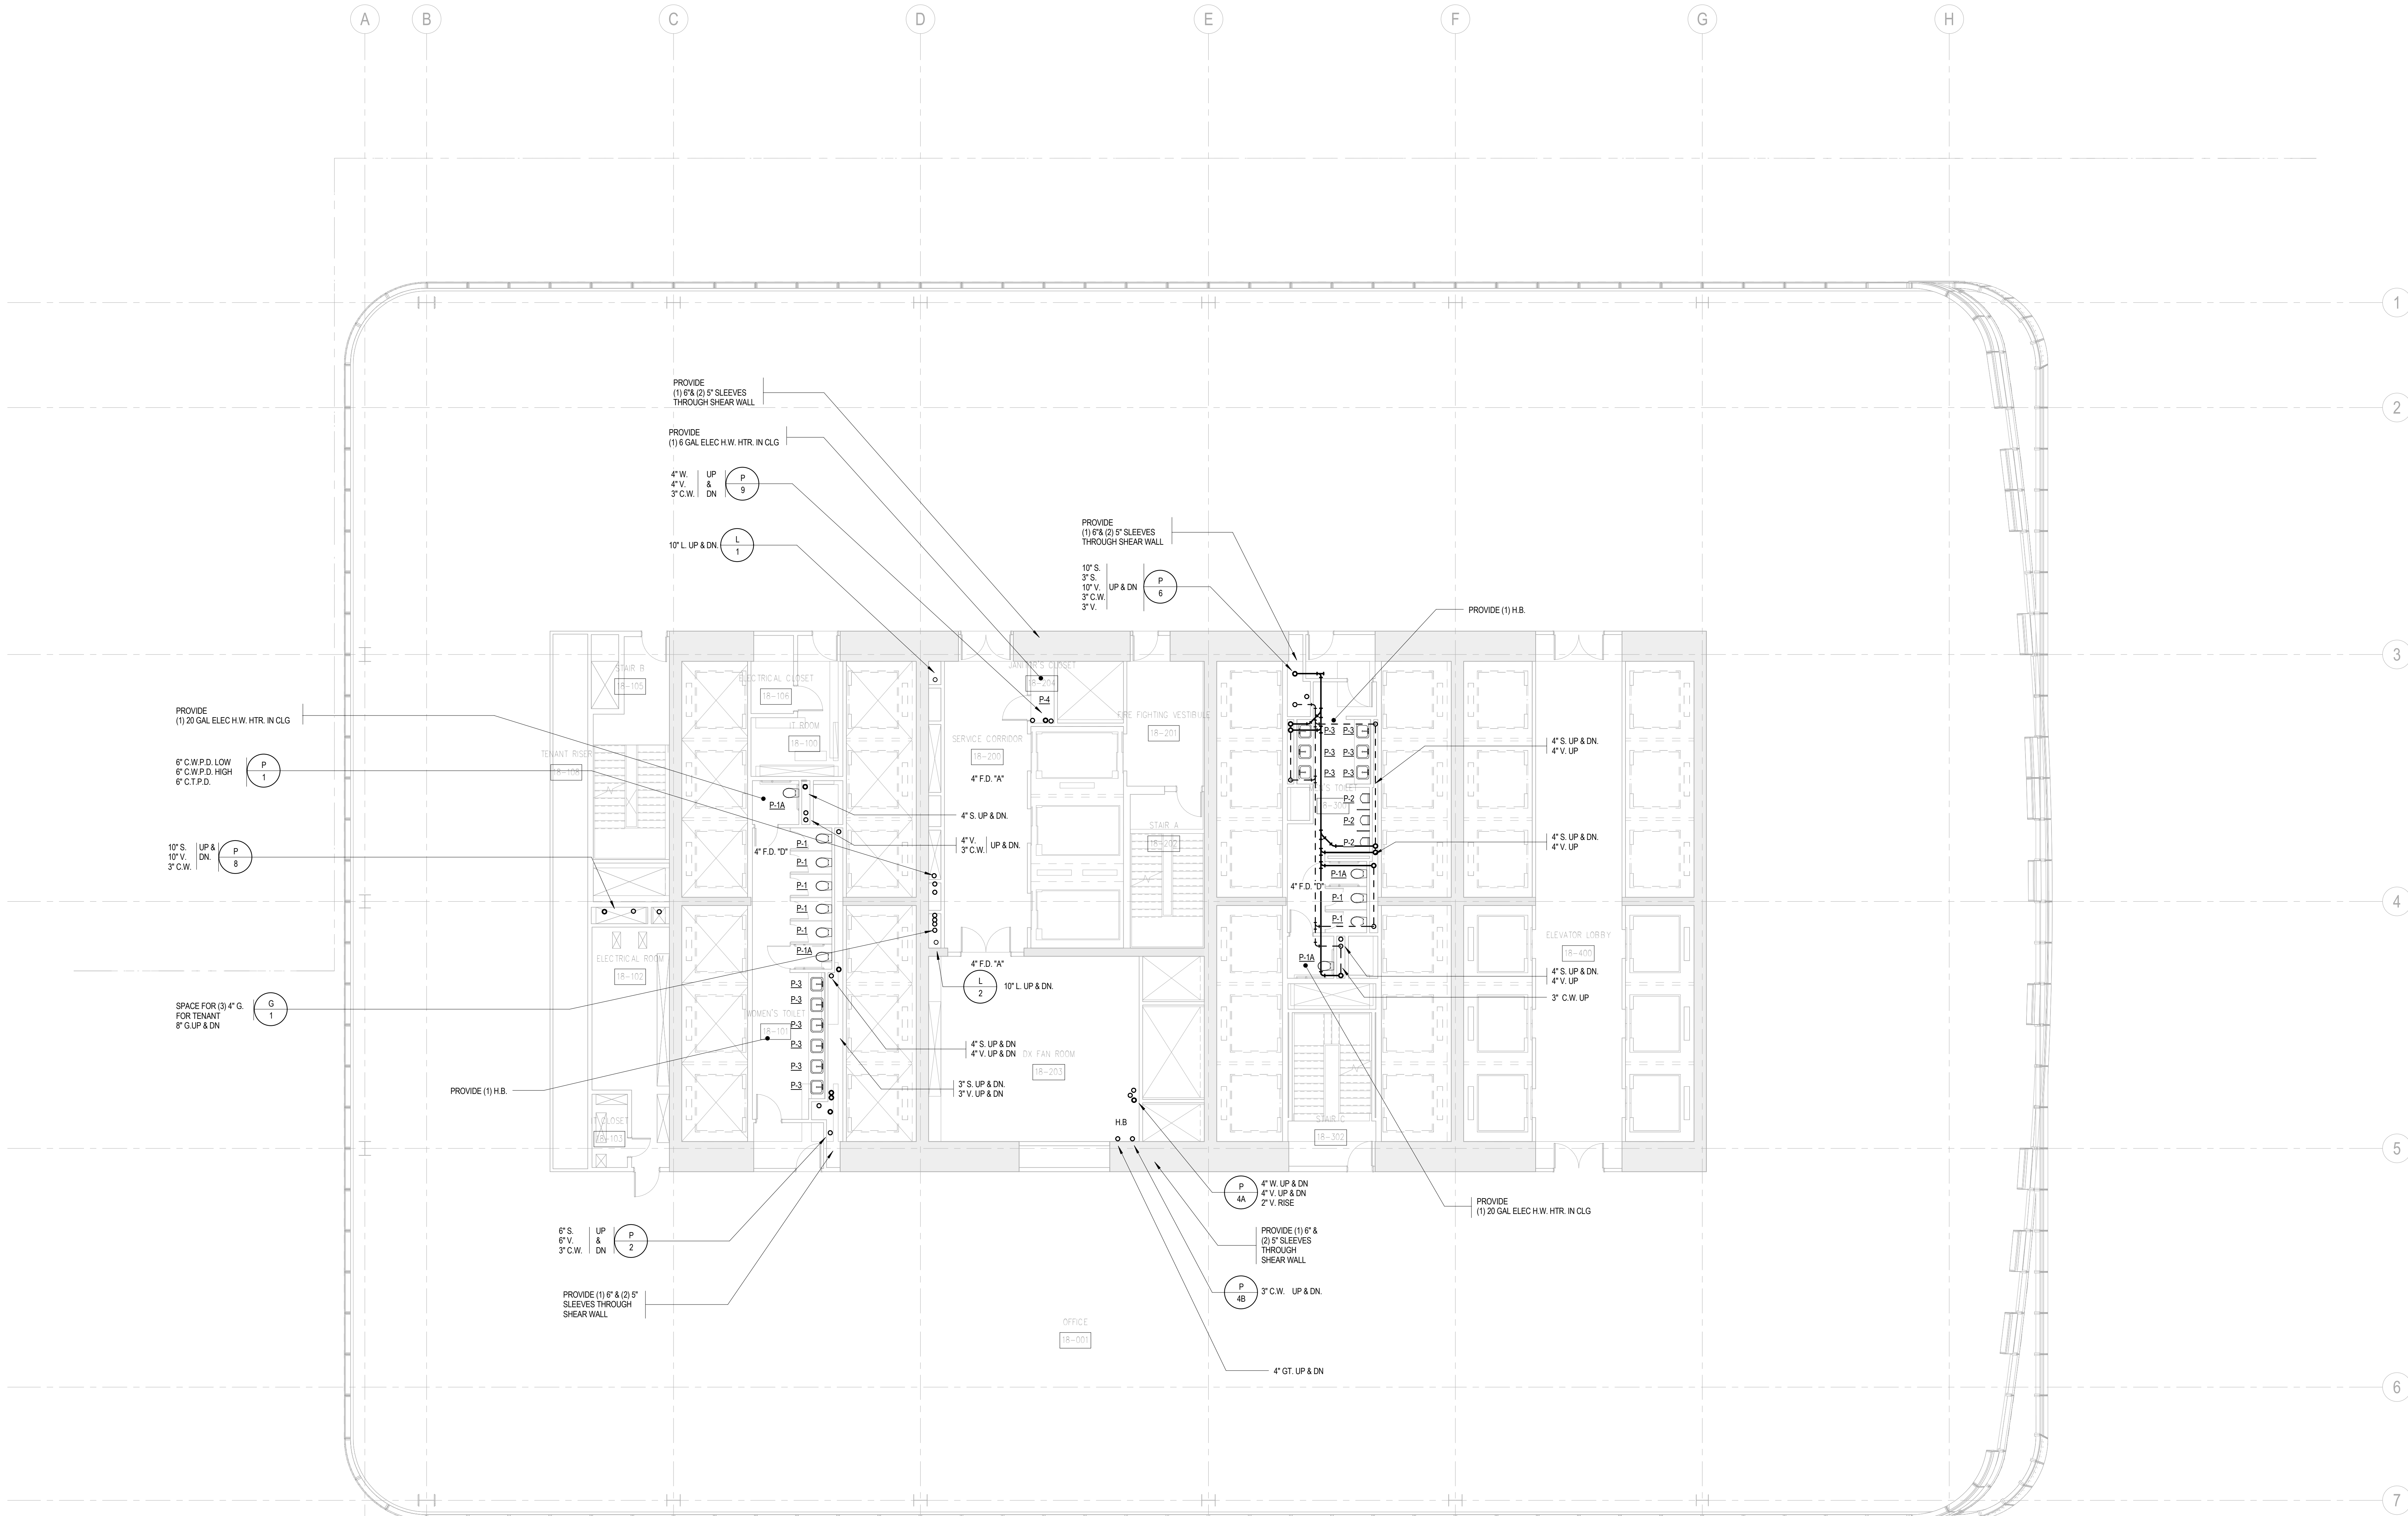
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650 Woodlawn Road West, Guelph
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Key Plan:



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2	12 JUL 2013	ISSUED FOR 50% DESIGN DEVELOPMENT
1	19 MAR 2013	ISSUED FOR RECONCILIATION

No. Date Description

Sheet Name:

PLUMBING
LEVEL 19-20
FLOOR PLAN -
LOW-RISE EMR

Project No.: 14830-A-000

Date: 20 JUN 2014

Scale: 1/8" = 1'-0"

File No: P-119

B-SCAN Sheet No.:

P-119.00

Sheet No.: P-119

Page No.: 22 OF 6

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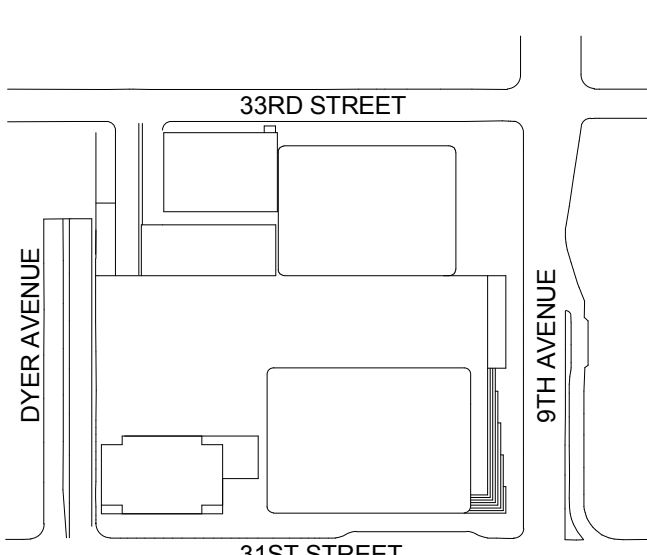
Facade Maintenance Consultant

Entek Engineering LLC
188 Ames Street, Hackensack, NJ 07601

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Ontario, Canada N1K 1B8

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2	12 JUL 2013	ISSUED FOR 60% DESIGN DEVELOPMENT
1	19 MAR 2013	ISSUED FOR RECONCILIATION

No. Date Description

Sheet Name:

**PLUMBING
LEVEL 28 FLOOR
PLAN - LOW-RISE
& MID-RISE**

Project No.: 14830-A-000

Date: 20 JUN 2014

Scale: 1/8" = 1'-0"


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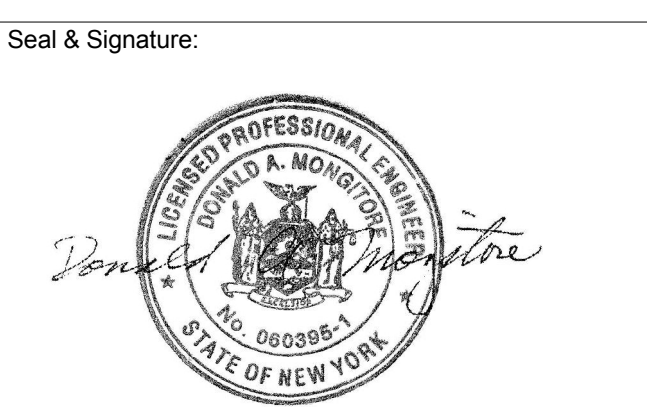
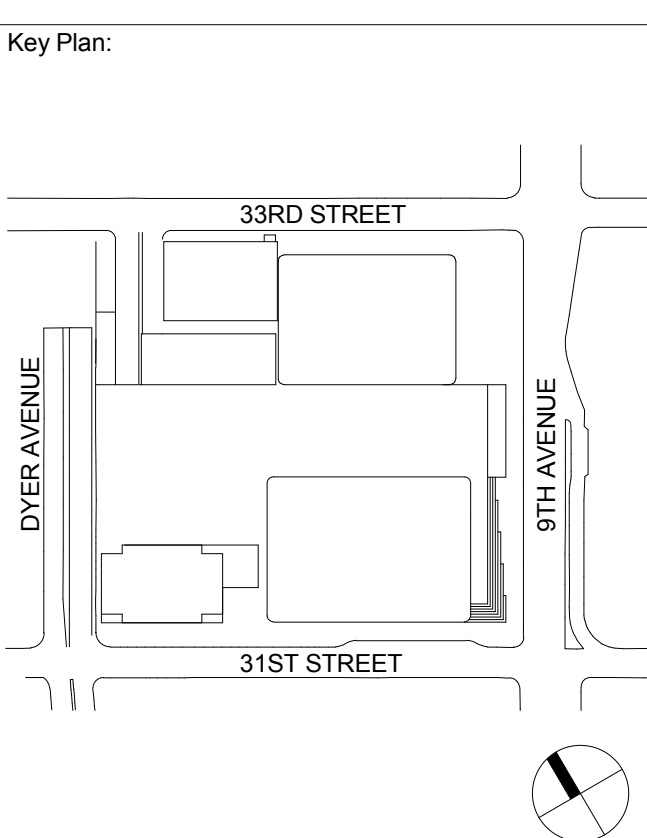
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Sheet No.: P-128

Page No.: 24 OF 6

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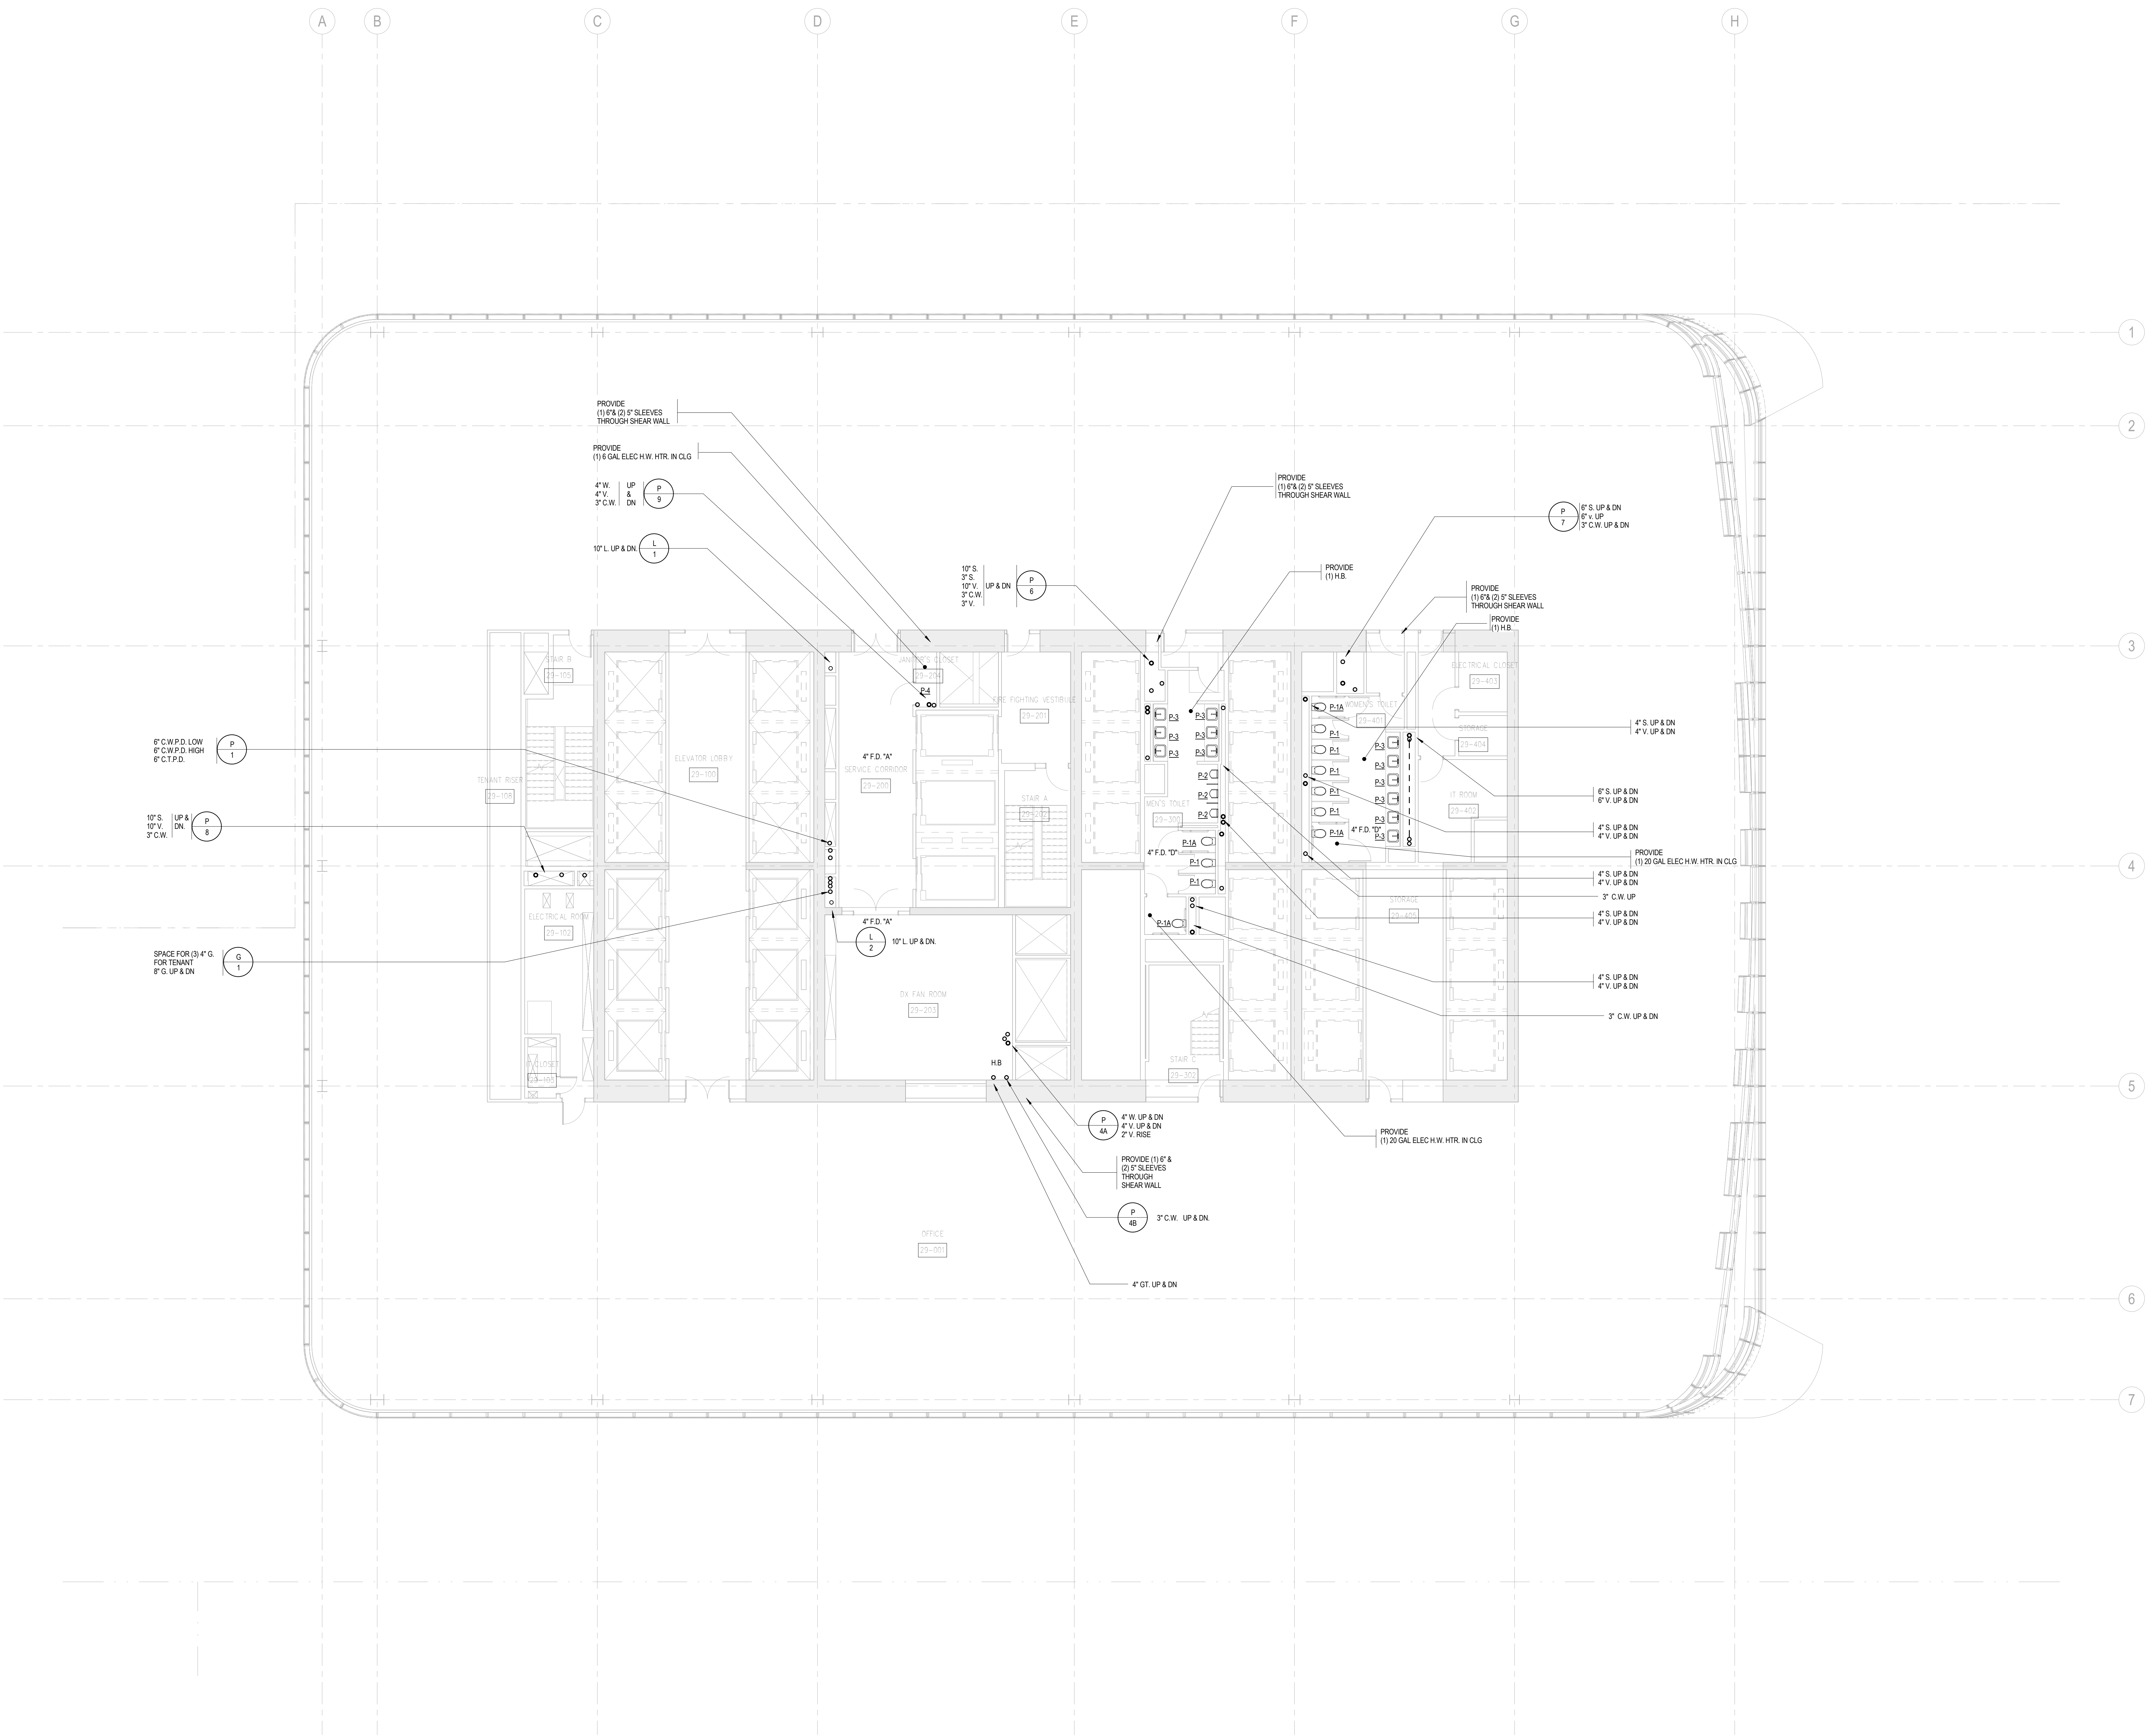




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3	15 NOV 2013	ISSUED FOR 50% DESIGN DEVELOPMENT
2	12 JUL 2013	ISSUED FOR 50% DESIGN DEVELOPMENT
1	19 MAR 2013	ISSUED FOR RECONCILIATION

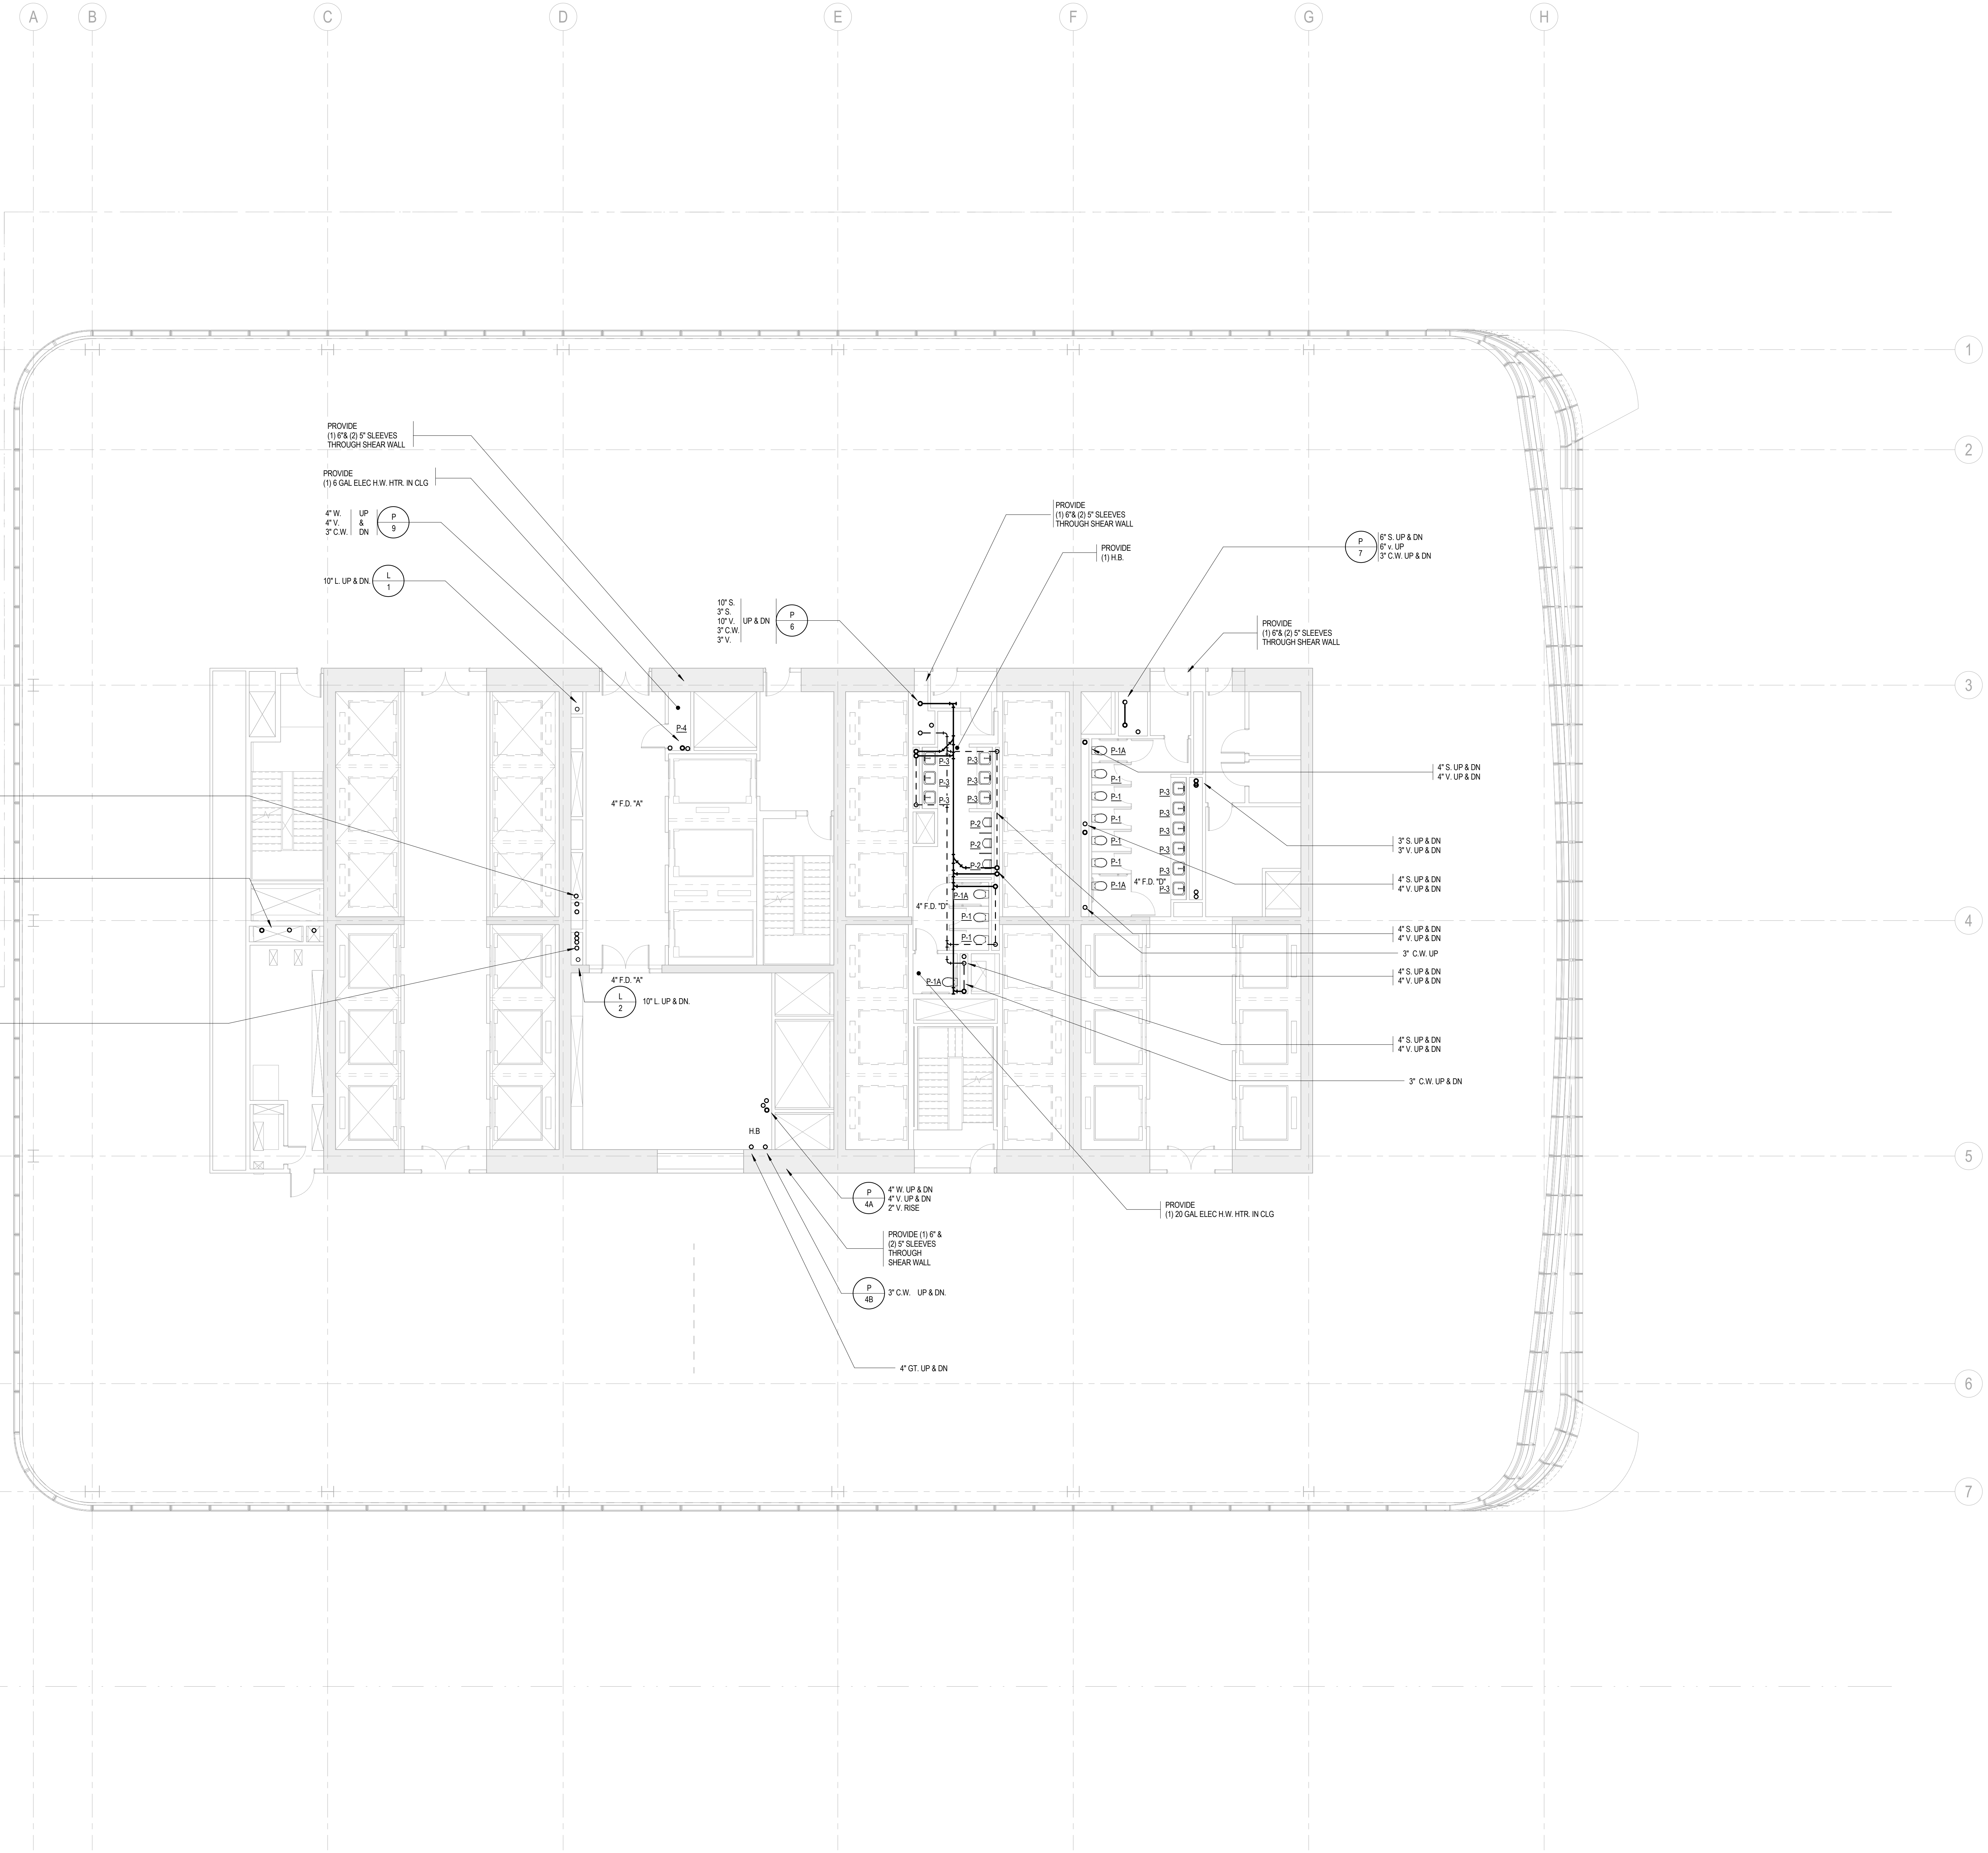PLUMBING
LEVEL 29 FLOOR
PLAN - MID-RISE
OVERRUN

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Acoustical Consultant
Cerami & Associates
404 Fifth Avenue #8, New York, NY 10018


Vibration Consultant
Wilson, Uhrig & Associates, Inc.
65 Broadway, Suite 401, New York, NY 10006

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Code Consultants Professional Engineers PC
215 West 40th Street, 15th Floor, New York, NY 10018


Facade Maintenance Consultant
Entek Engineering LLC
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Wind Tunnel Consultant
Rowan Williams Davies & Irwin Inc.
650 Woodlawn Road West, Guelph
Ontario, Canada N1K 1B8

Key Plan:

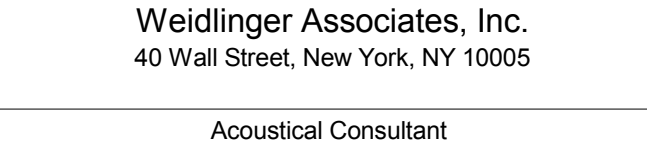

Seal & Signature:

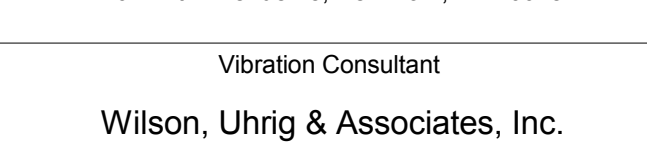

Project No.: 14830-A-000

Date: 20 JUN 2014

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File No: P-130

Sheet Name:

Project No.: 14830-A-000

Date: 20 JUN 2014

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File No: P-130

Sheet Name:

Project No.: 14830-A-000

Date: 20 JUN 2014

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Sheet Name:

Project No.: 14830-A-000

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File No: P-130



MANHATTAN WEST:
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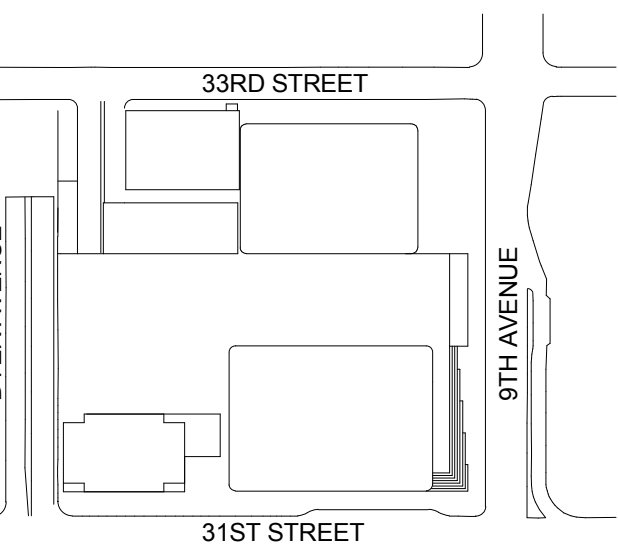
Facade Maintenance Consultant

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168 Ames Street, Hackensack, NJ 07601

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Rowan Williams Davies & Irwin Inc.
650 Woodlawn Road West, Guelph
Ontario, Canada N1K 1B8

Key Plan:



Seal & Signature:



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Sheet Name:

**PLUMBING
LEVEL 40-41
FLOOR PLAN -
MID-RISE
OVERRUN**

Project No.:

14830-A-000

Date:

20 JUN 2014

Scale:

1/8" = 1'-0"

File No.:

P-140

B-SCAN Sheet No.:

P-140.00

Sheet No.:

P-140

Page No.:

33 OF 6

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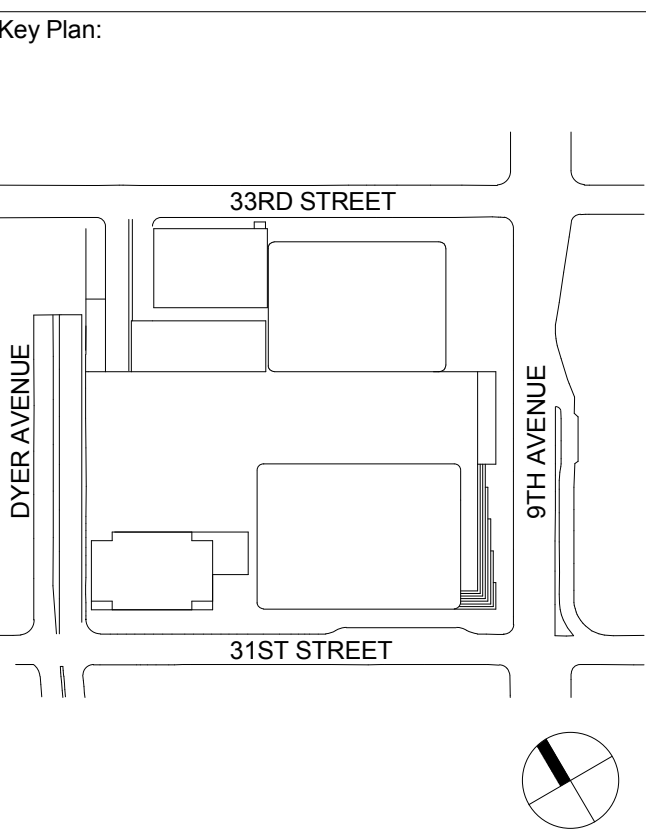
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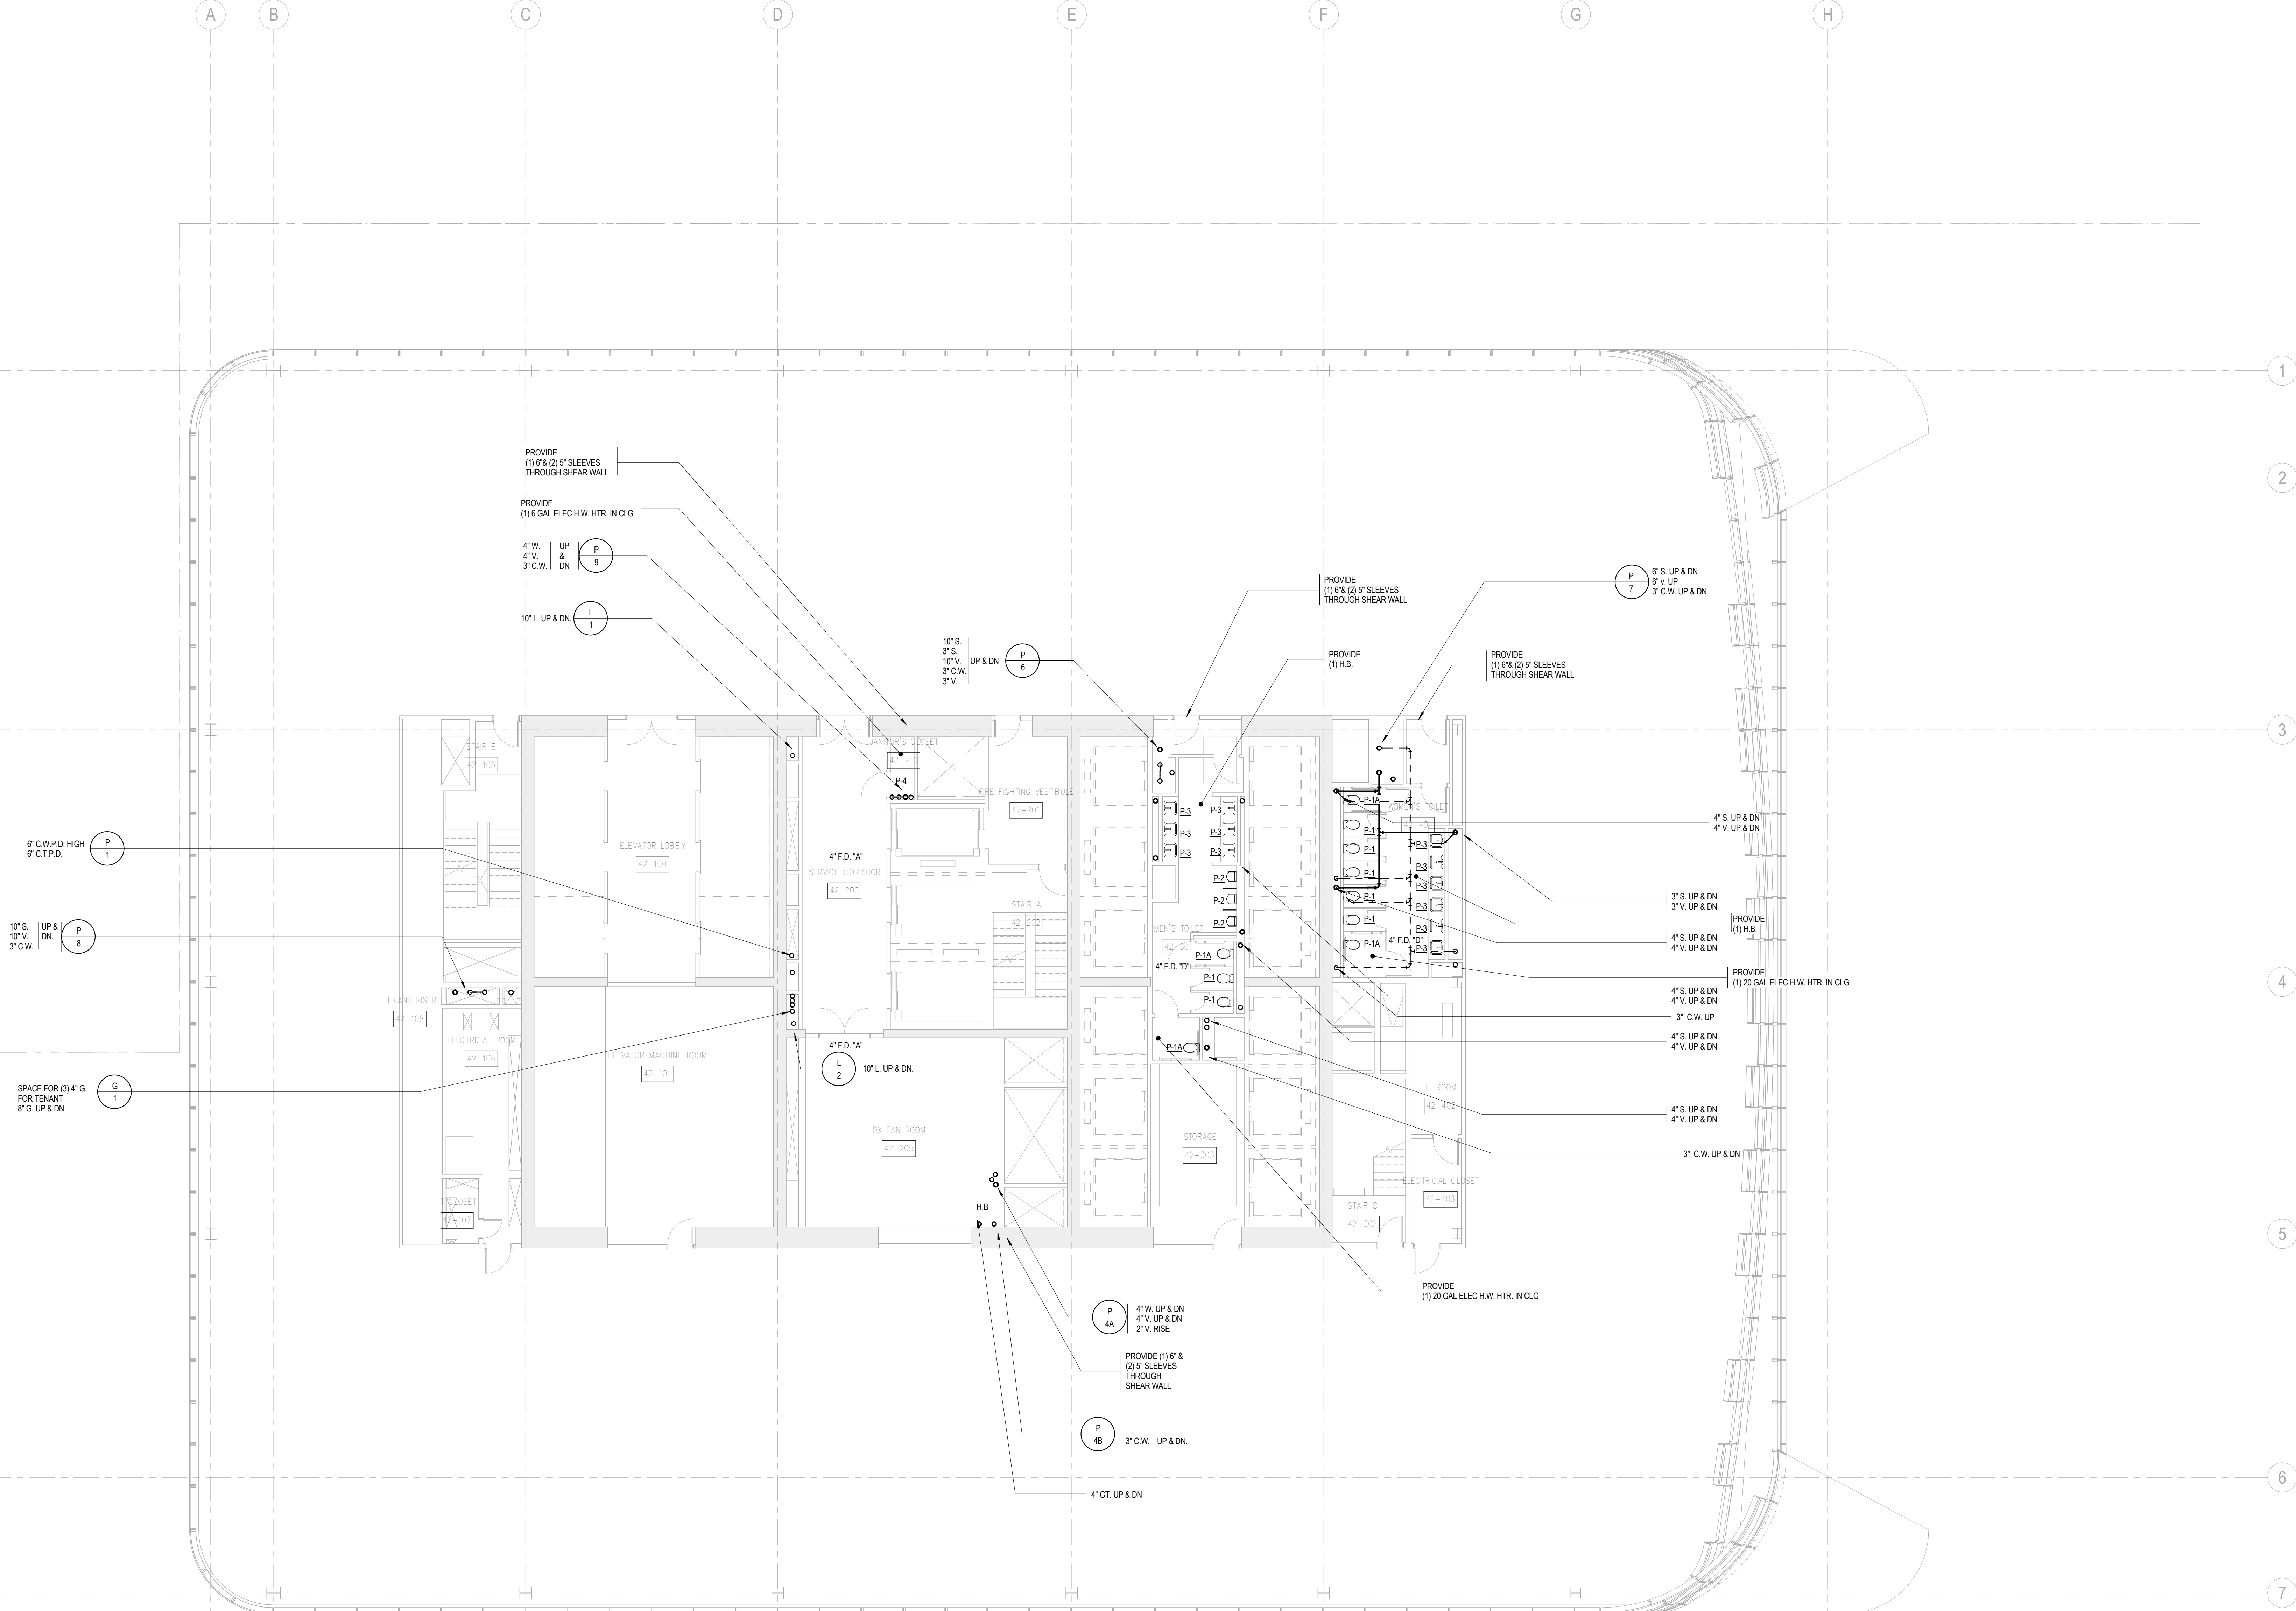
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2	12 JUL 2013	ISSUED FOR 50% DESIGN DEVELOPMENT
1	19 MAR 2012	ISSUED FOR RECONCILIATION

No. Date Description
Sheet Name:

**PLUMBING
LEVEL 42 FLOOR
PLAN - MID-RISE
EMR**

Project No.: 14830-A-000
Date: 20 JUN 2014
Scale: 1/8" = 1'-0"
File No: P-142
B-SCAN Sheet No.:
P-142.00
Sheet No.: P-142
Page No.: 34 OF 62

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SHEET NOTES



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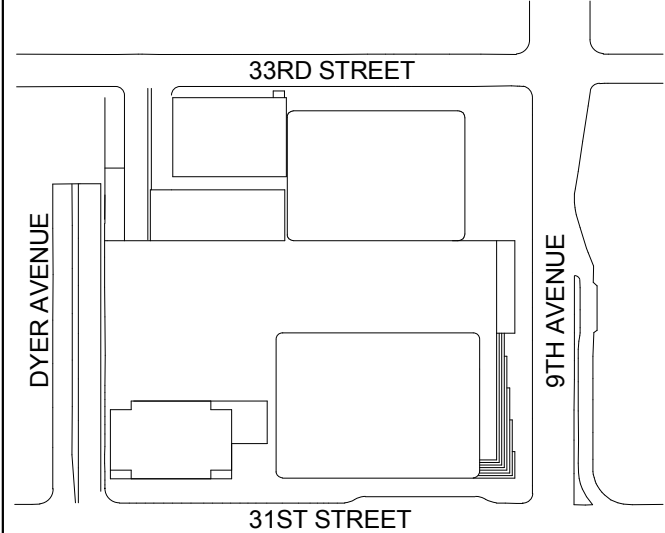
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Key Plan:



Seal & Signature:



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2	20 DEC 2013	ISSUED FOR FOUNDATION PERMIT
1	19 NOV 2013	ISSUED FOR 60 PERCENT PRICING

No. Date Description

Sheet Name:

PLUMBING
LEVEL 43-46
FLOOR PLAN -
TYPICAL
MID-RISE

Project No.:
14300-A-000

Date:
20 JUN 2014

Scale:
1/8" = 1'-0"


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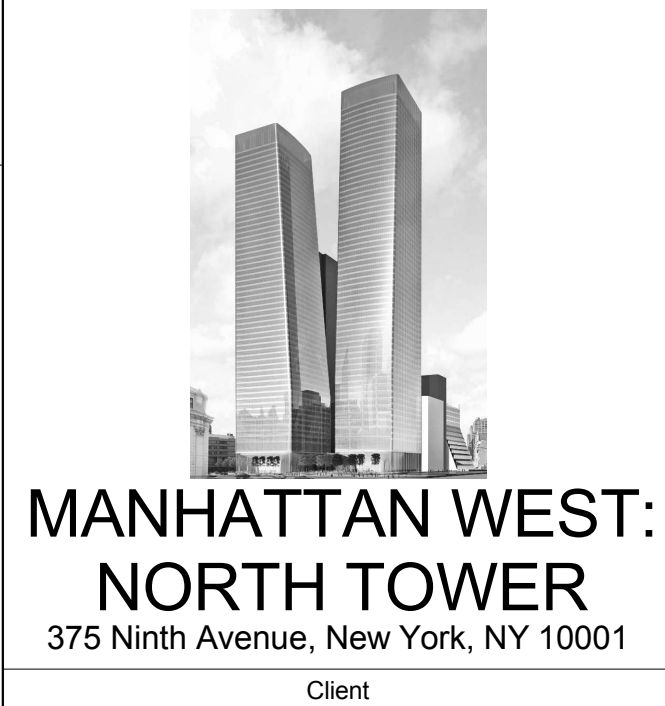
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Sheet No.:
P-143

Page No.:
35 OF 6

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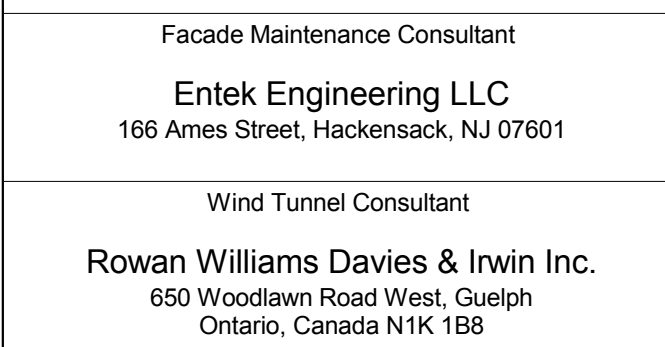
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650 Woodlawn Road West, Guelph
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Key Plan:



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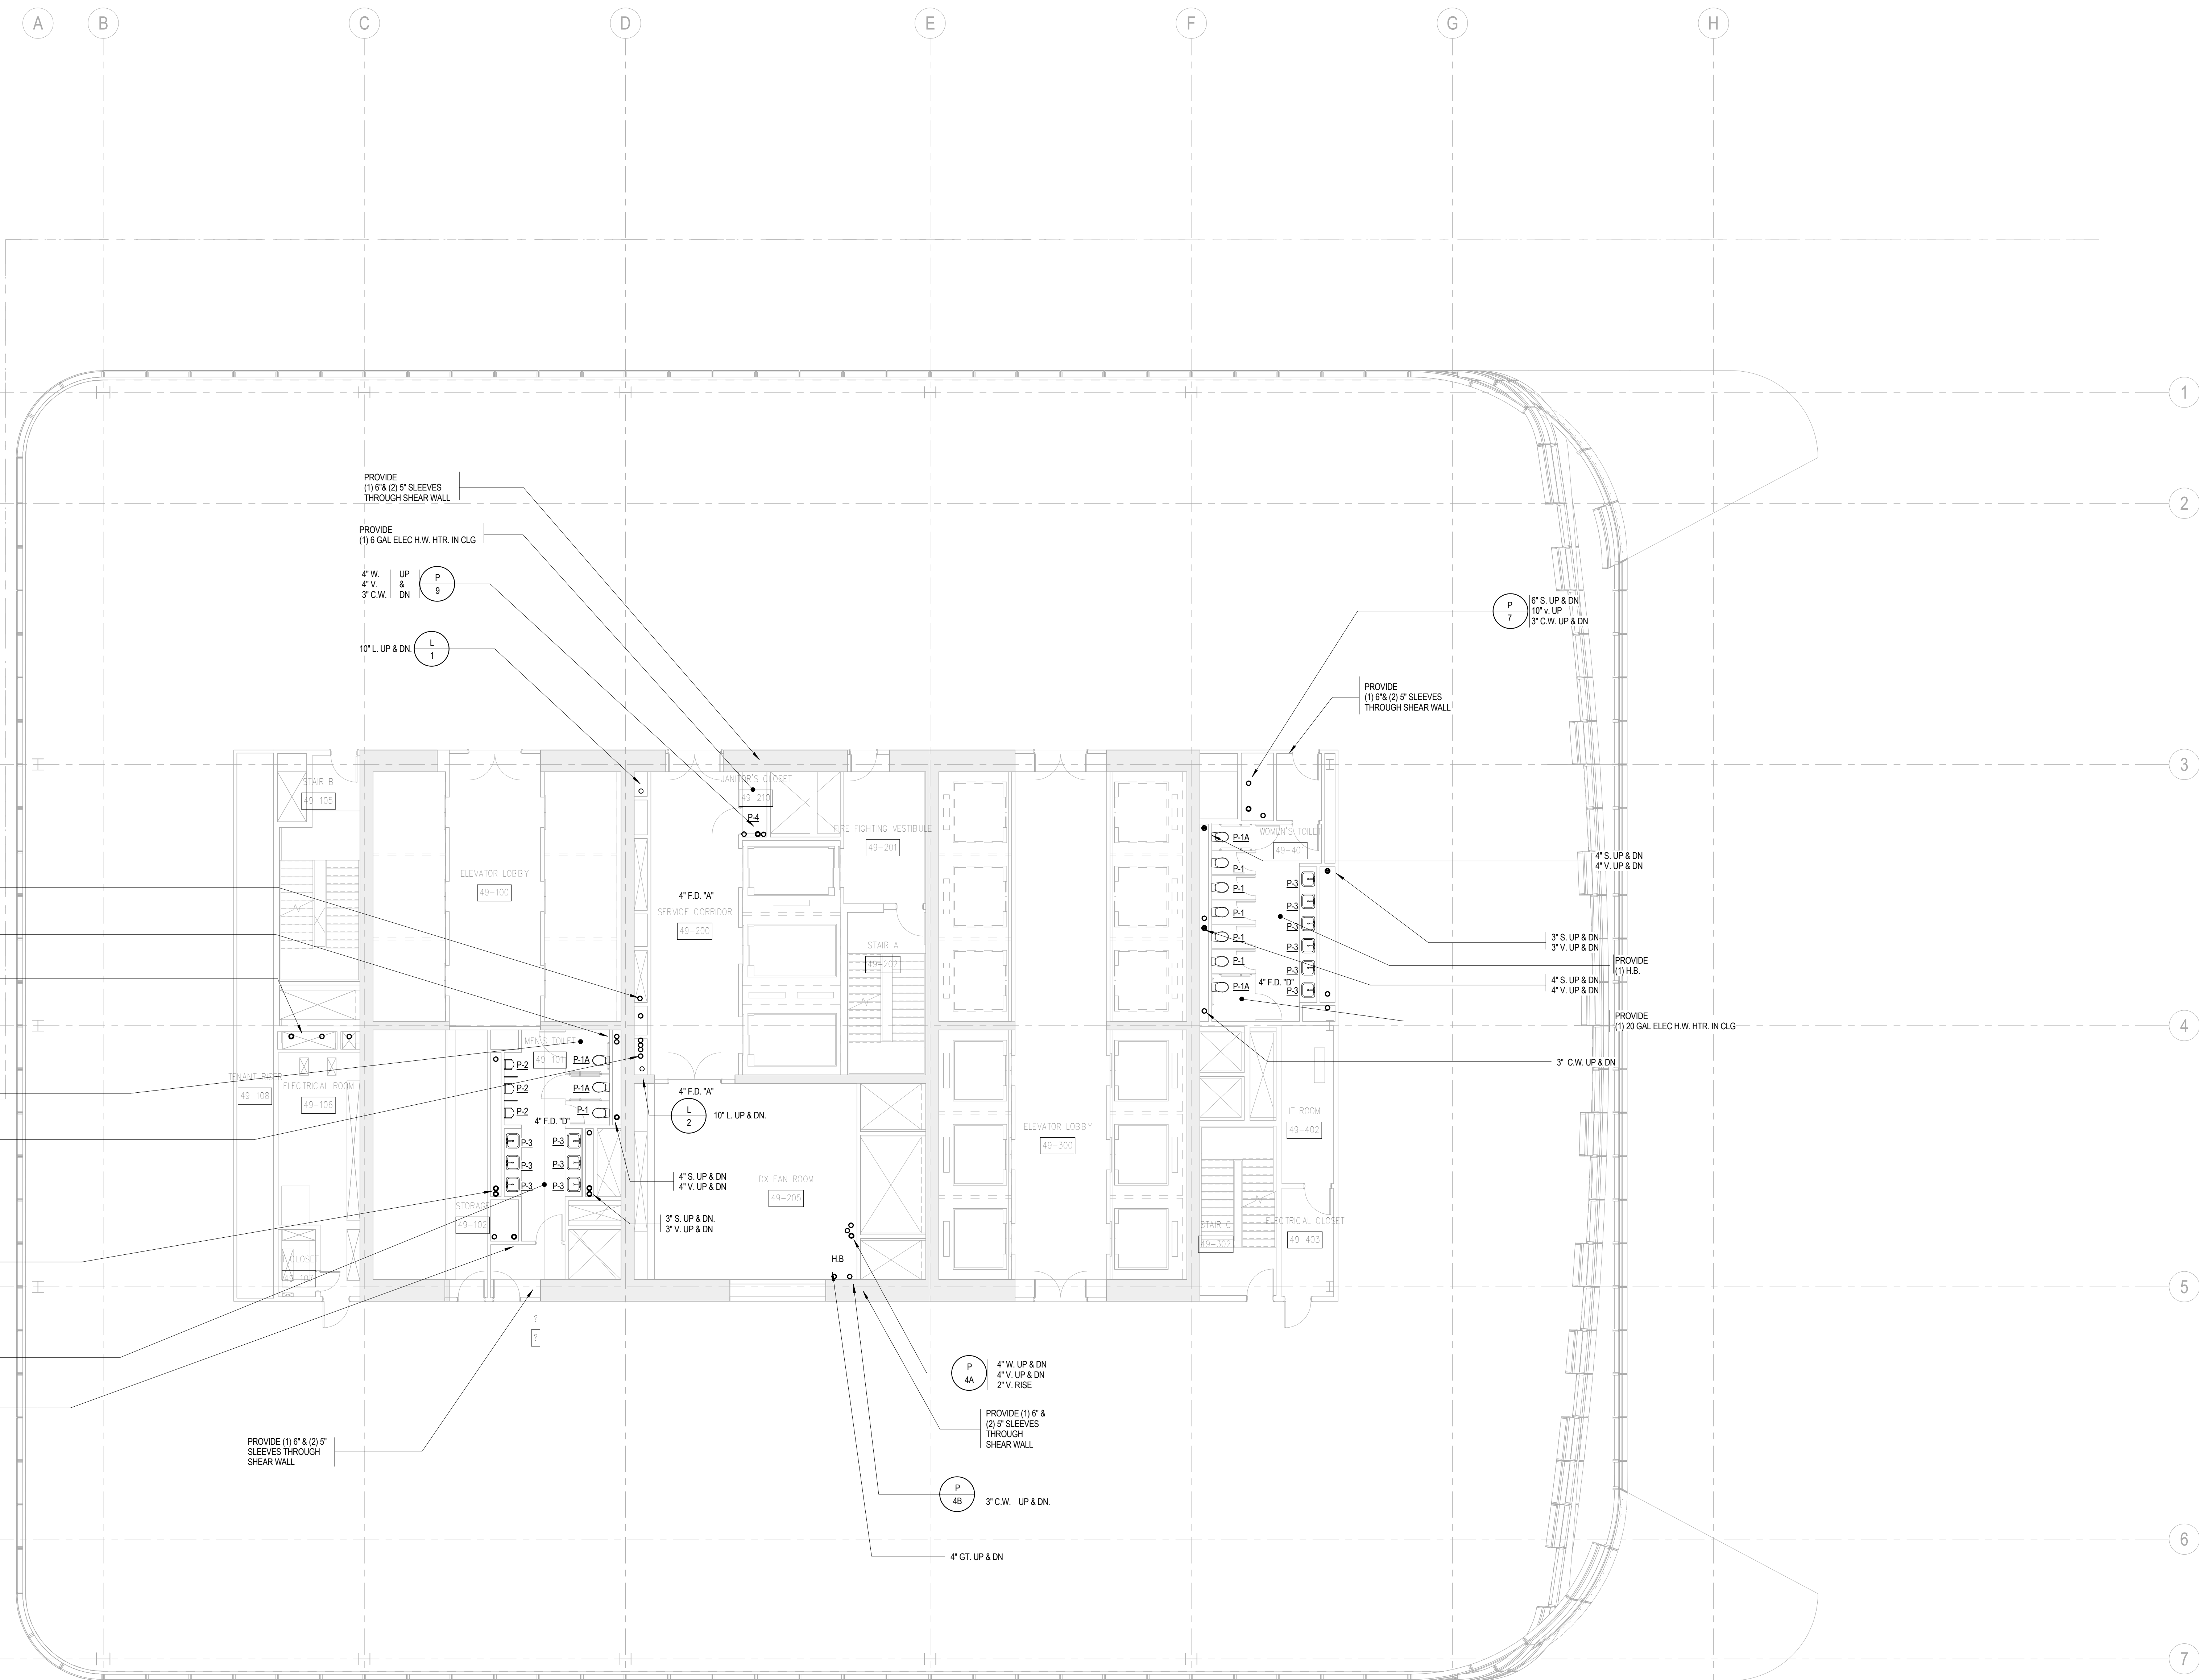


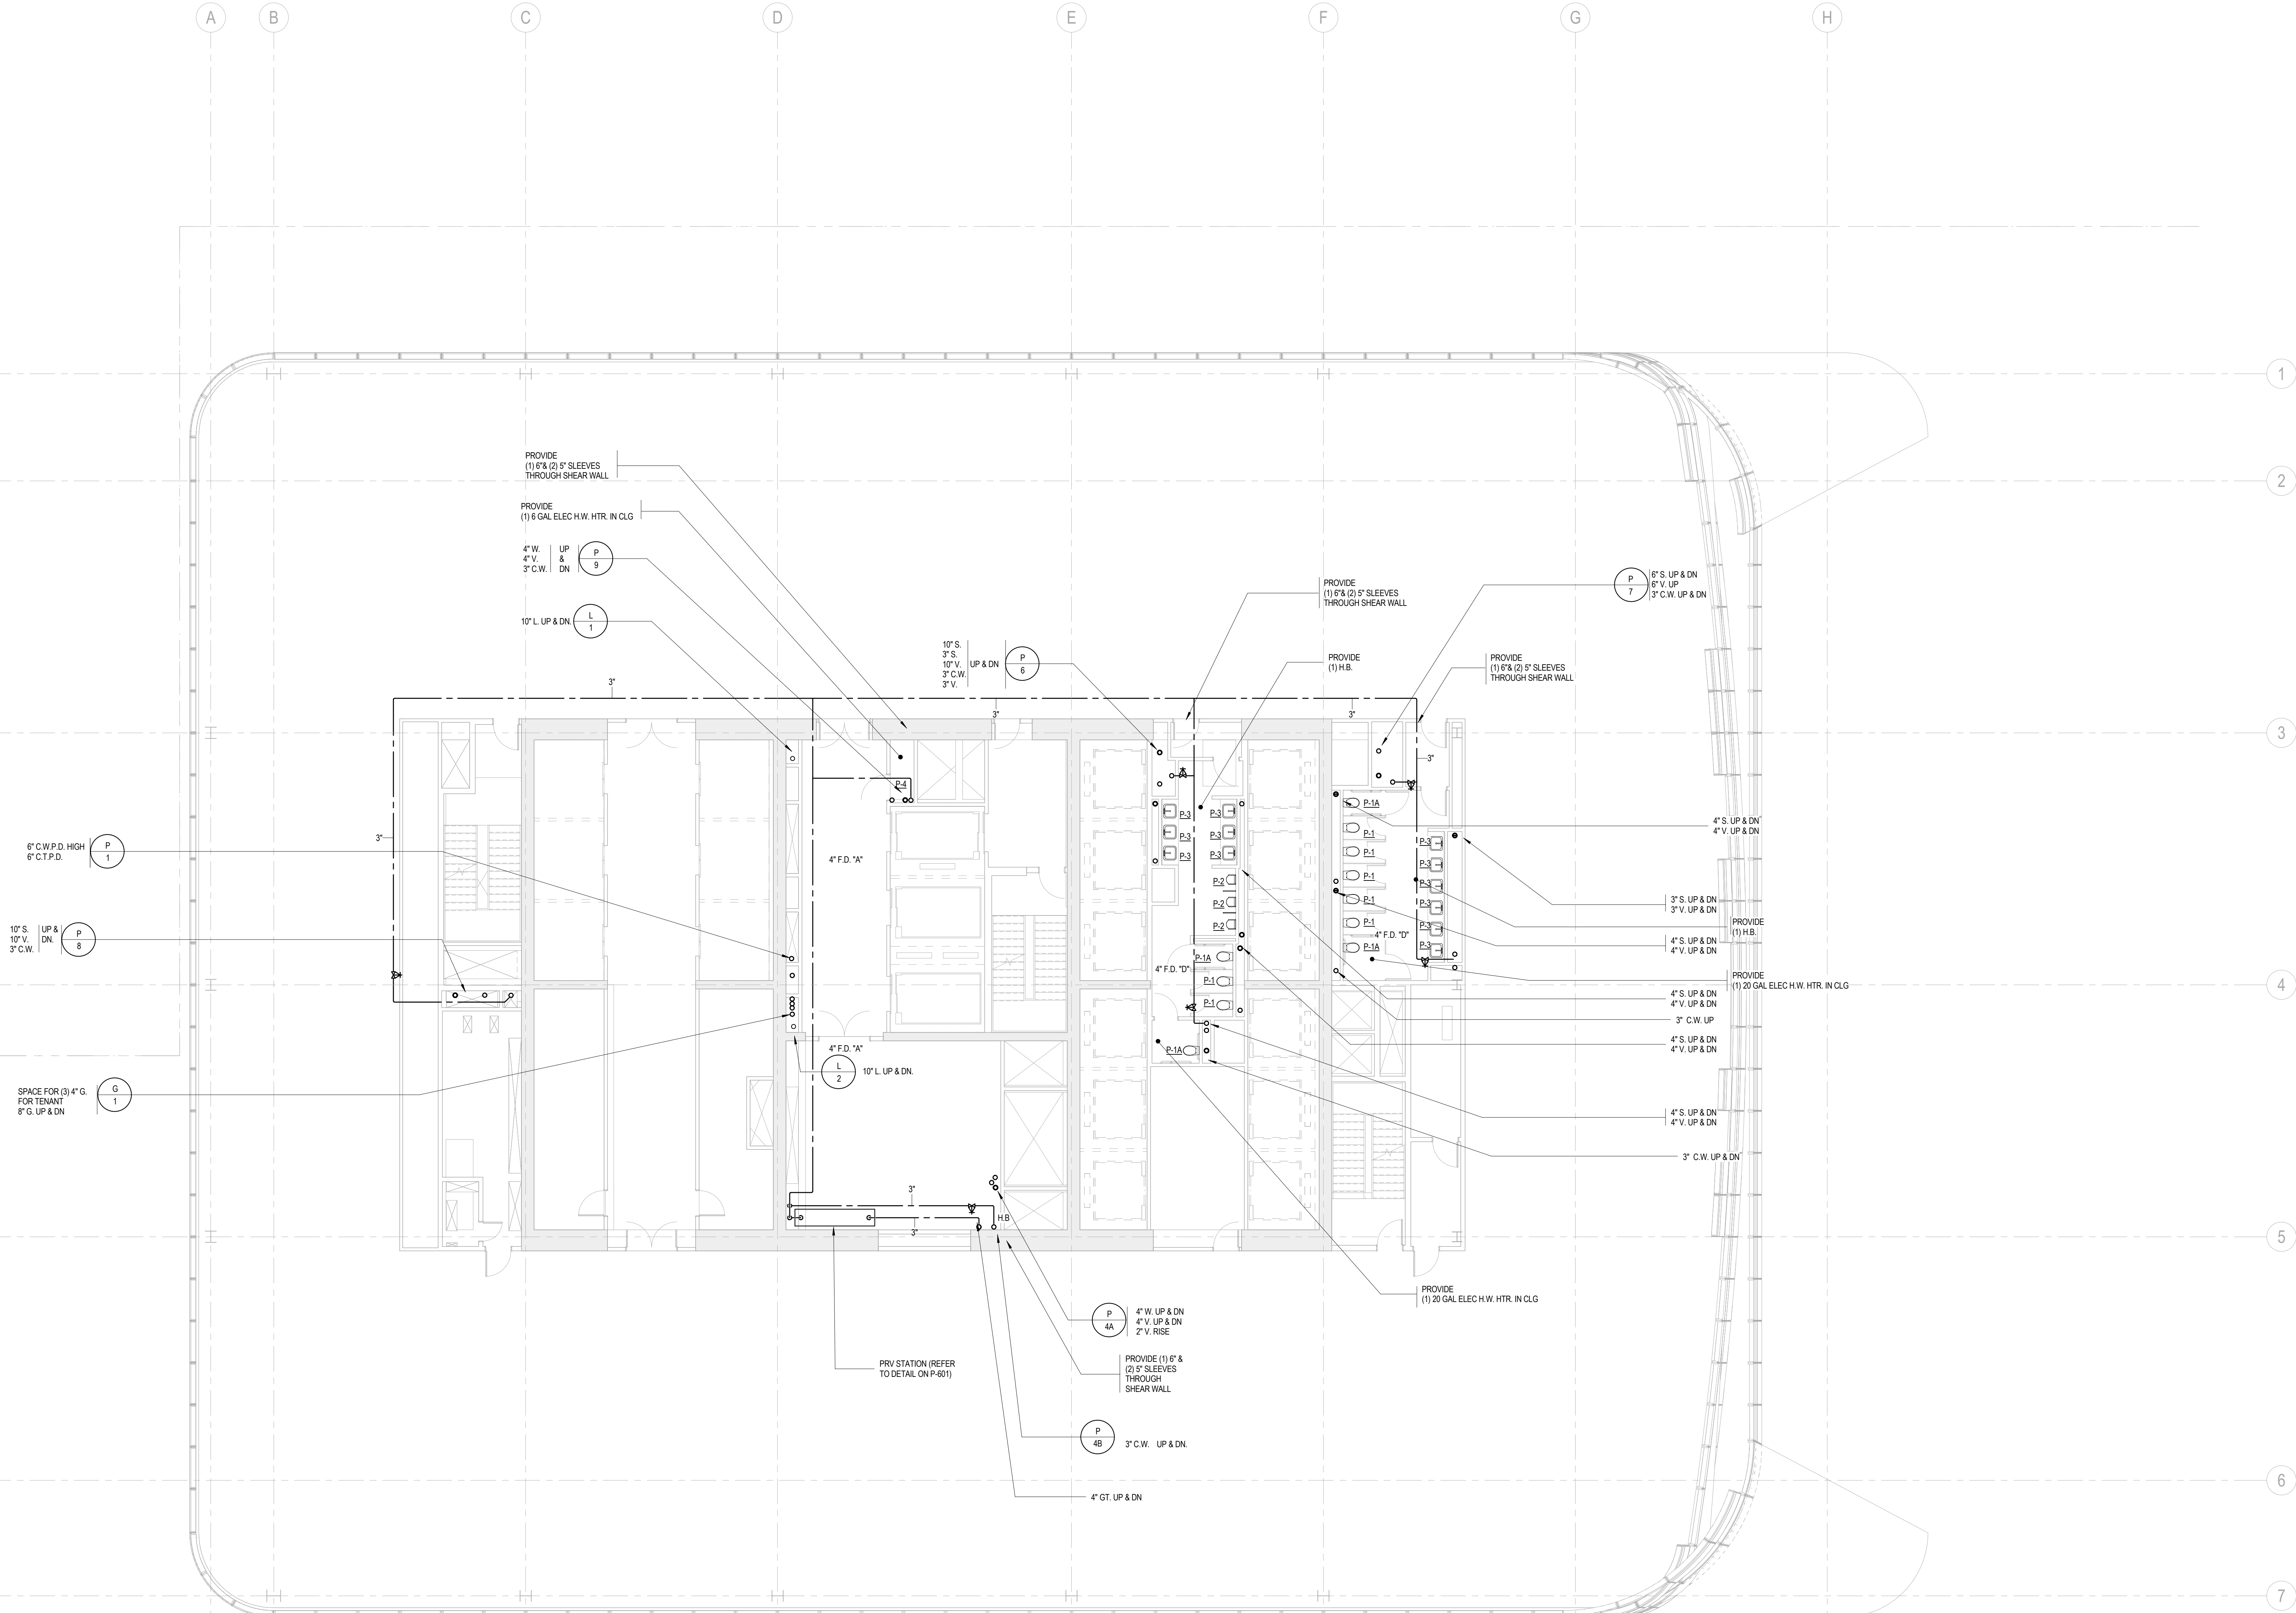
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Date: 20 JUN 2014
Scale: 1/8" = 1'-0"
File No: P-149

B-SCAN Sheet No.:
P-149.00
Sheet No.:
P-149
Page No.:
37 OF 6

PLUMBING
LEVEL 49 FLOOR
PLAN - MID-RISE
& HIGH-RISE

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Cerami & Associates
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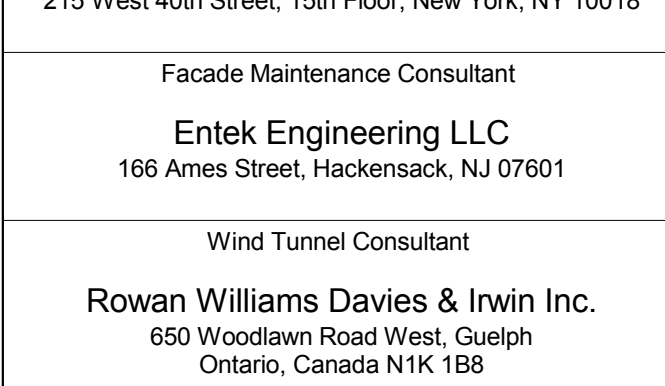
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650 Woodlawn Road West, Guelph
Ontario, Canada N1K 1B8

Key Plan:

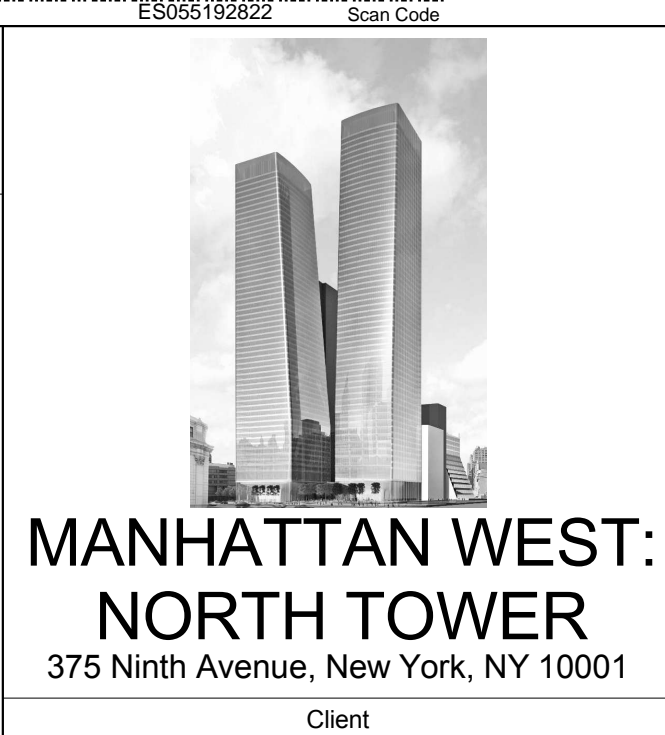

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Project No.: 14830-A-000
Date: 20 JUN 2014
Scale: 1/8" = 1'-0"
File No: P-150

B-SCAN Sheet No.:
Sheet No.: P-150.00
Page No.: 38 OF 6

PLUMBING
LEVEL 50-51
FLOOR PLAN -
HIGH-RISE
OVERRUN

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3 15 NOV 2013 ISSUED FOR 50% DESIGN DEVELOPMENT
2 12 JUL 2013 ISSUED FOR 50% DESIGN DEVELOPMENT
1 19 MAR 2013 ISSUED FOR RECONCILIATION

No. Date Description
Sheet Name:

Project No.: 14830-A-000
Date: 20 JUN 2014
Scale: 1/8" = 1'-0"
File No: P-150

B-SCAN Sheet No.:
Sheet No.: P-150.00
Page No.: 38 OF 6

PLUMBING
LEVEL 50-51
FLOOR PLAN -
HIGH-RISE
OVERRUN

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No. Date Description
Sheet Name:

Project No.: 14830-A-000
Date: 20 JUN 2014
Scale: 1/8" = 1'-0"
File No: P-150

B-SCAN Sheet No.:
Sheet No.: P-150.00
Page No.: 38 OF 6

PLUMBING
LEVEL 50-51
FLOOR PLAN -
HIGH-RISE
OVERRUN

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Sheet Name:

Project No.: 14830-A-000
Date: 20 JUN 2014
Scale: 1/8" = 1'-0"
File No: P-150

B-SCAN Sheet No.:
Sheet No.: P-150.00
Page No.: 38 OF 6

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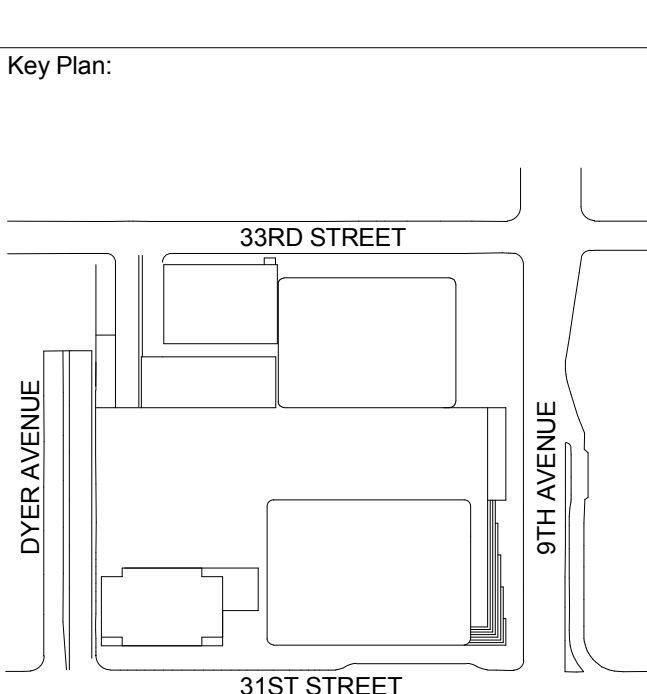
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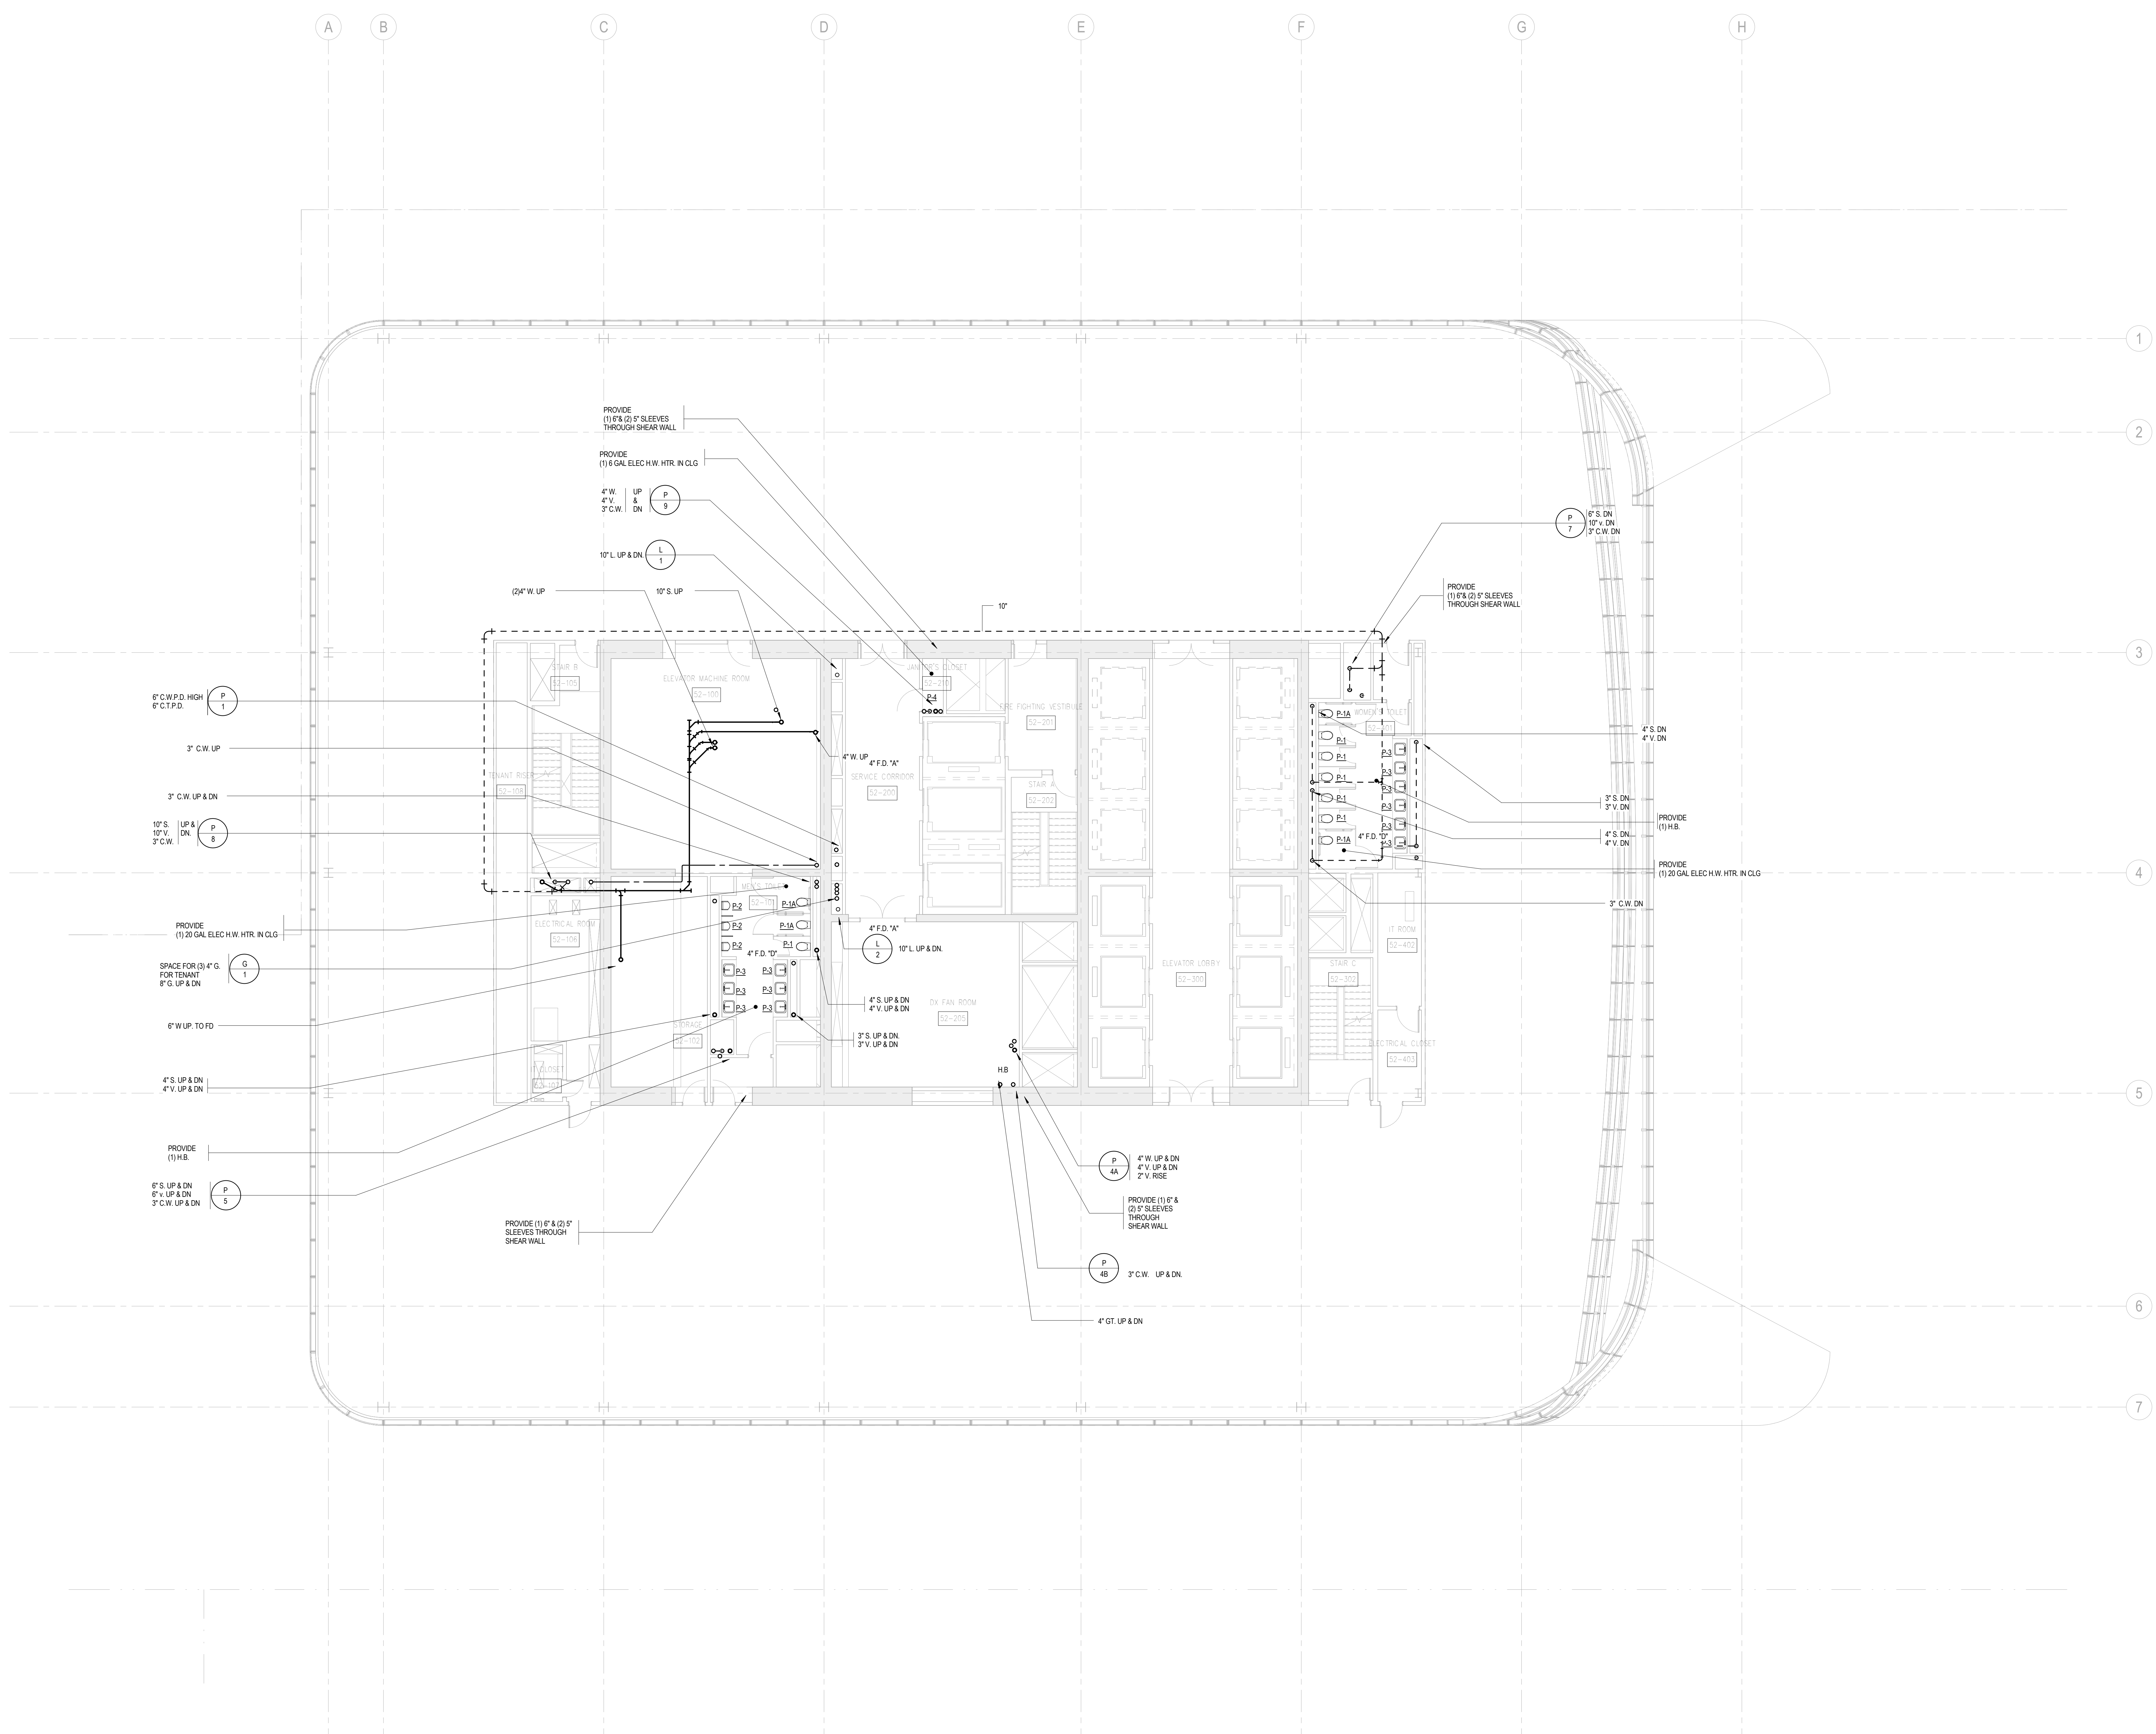
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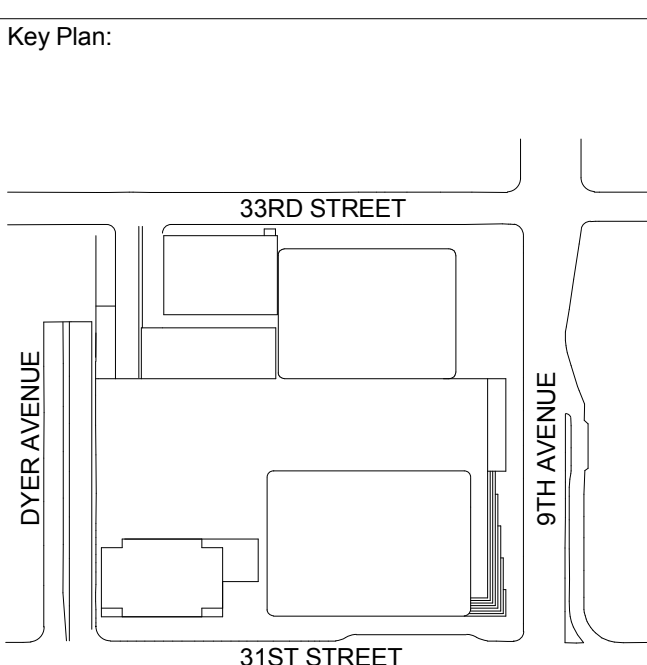
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Sheet Name:

PLUMBING
LEVEL 52 FLOOR
PLAN - HIGH-RISE
EMR

Project No.: 14830-A-000	B-SCAN Sheet No.: P-152.00
Date: 20 JUN 2014	Sheet No.: P-152
Scale: 1/8" = 1'-0"	Page No.: 39 OF 6
File No.: P-152	

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1	19 NOV 2013	ISSUED FOR CD PROGRESS PRICING


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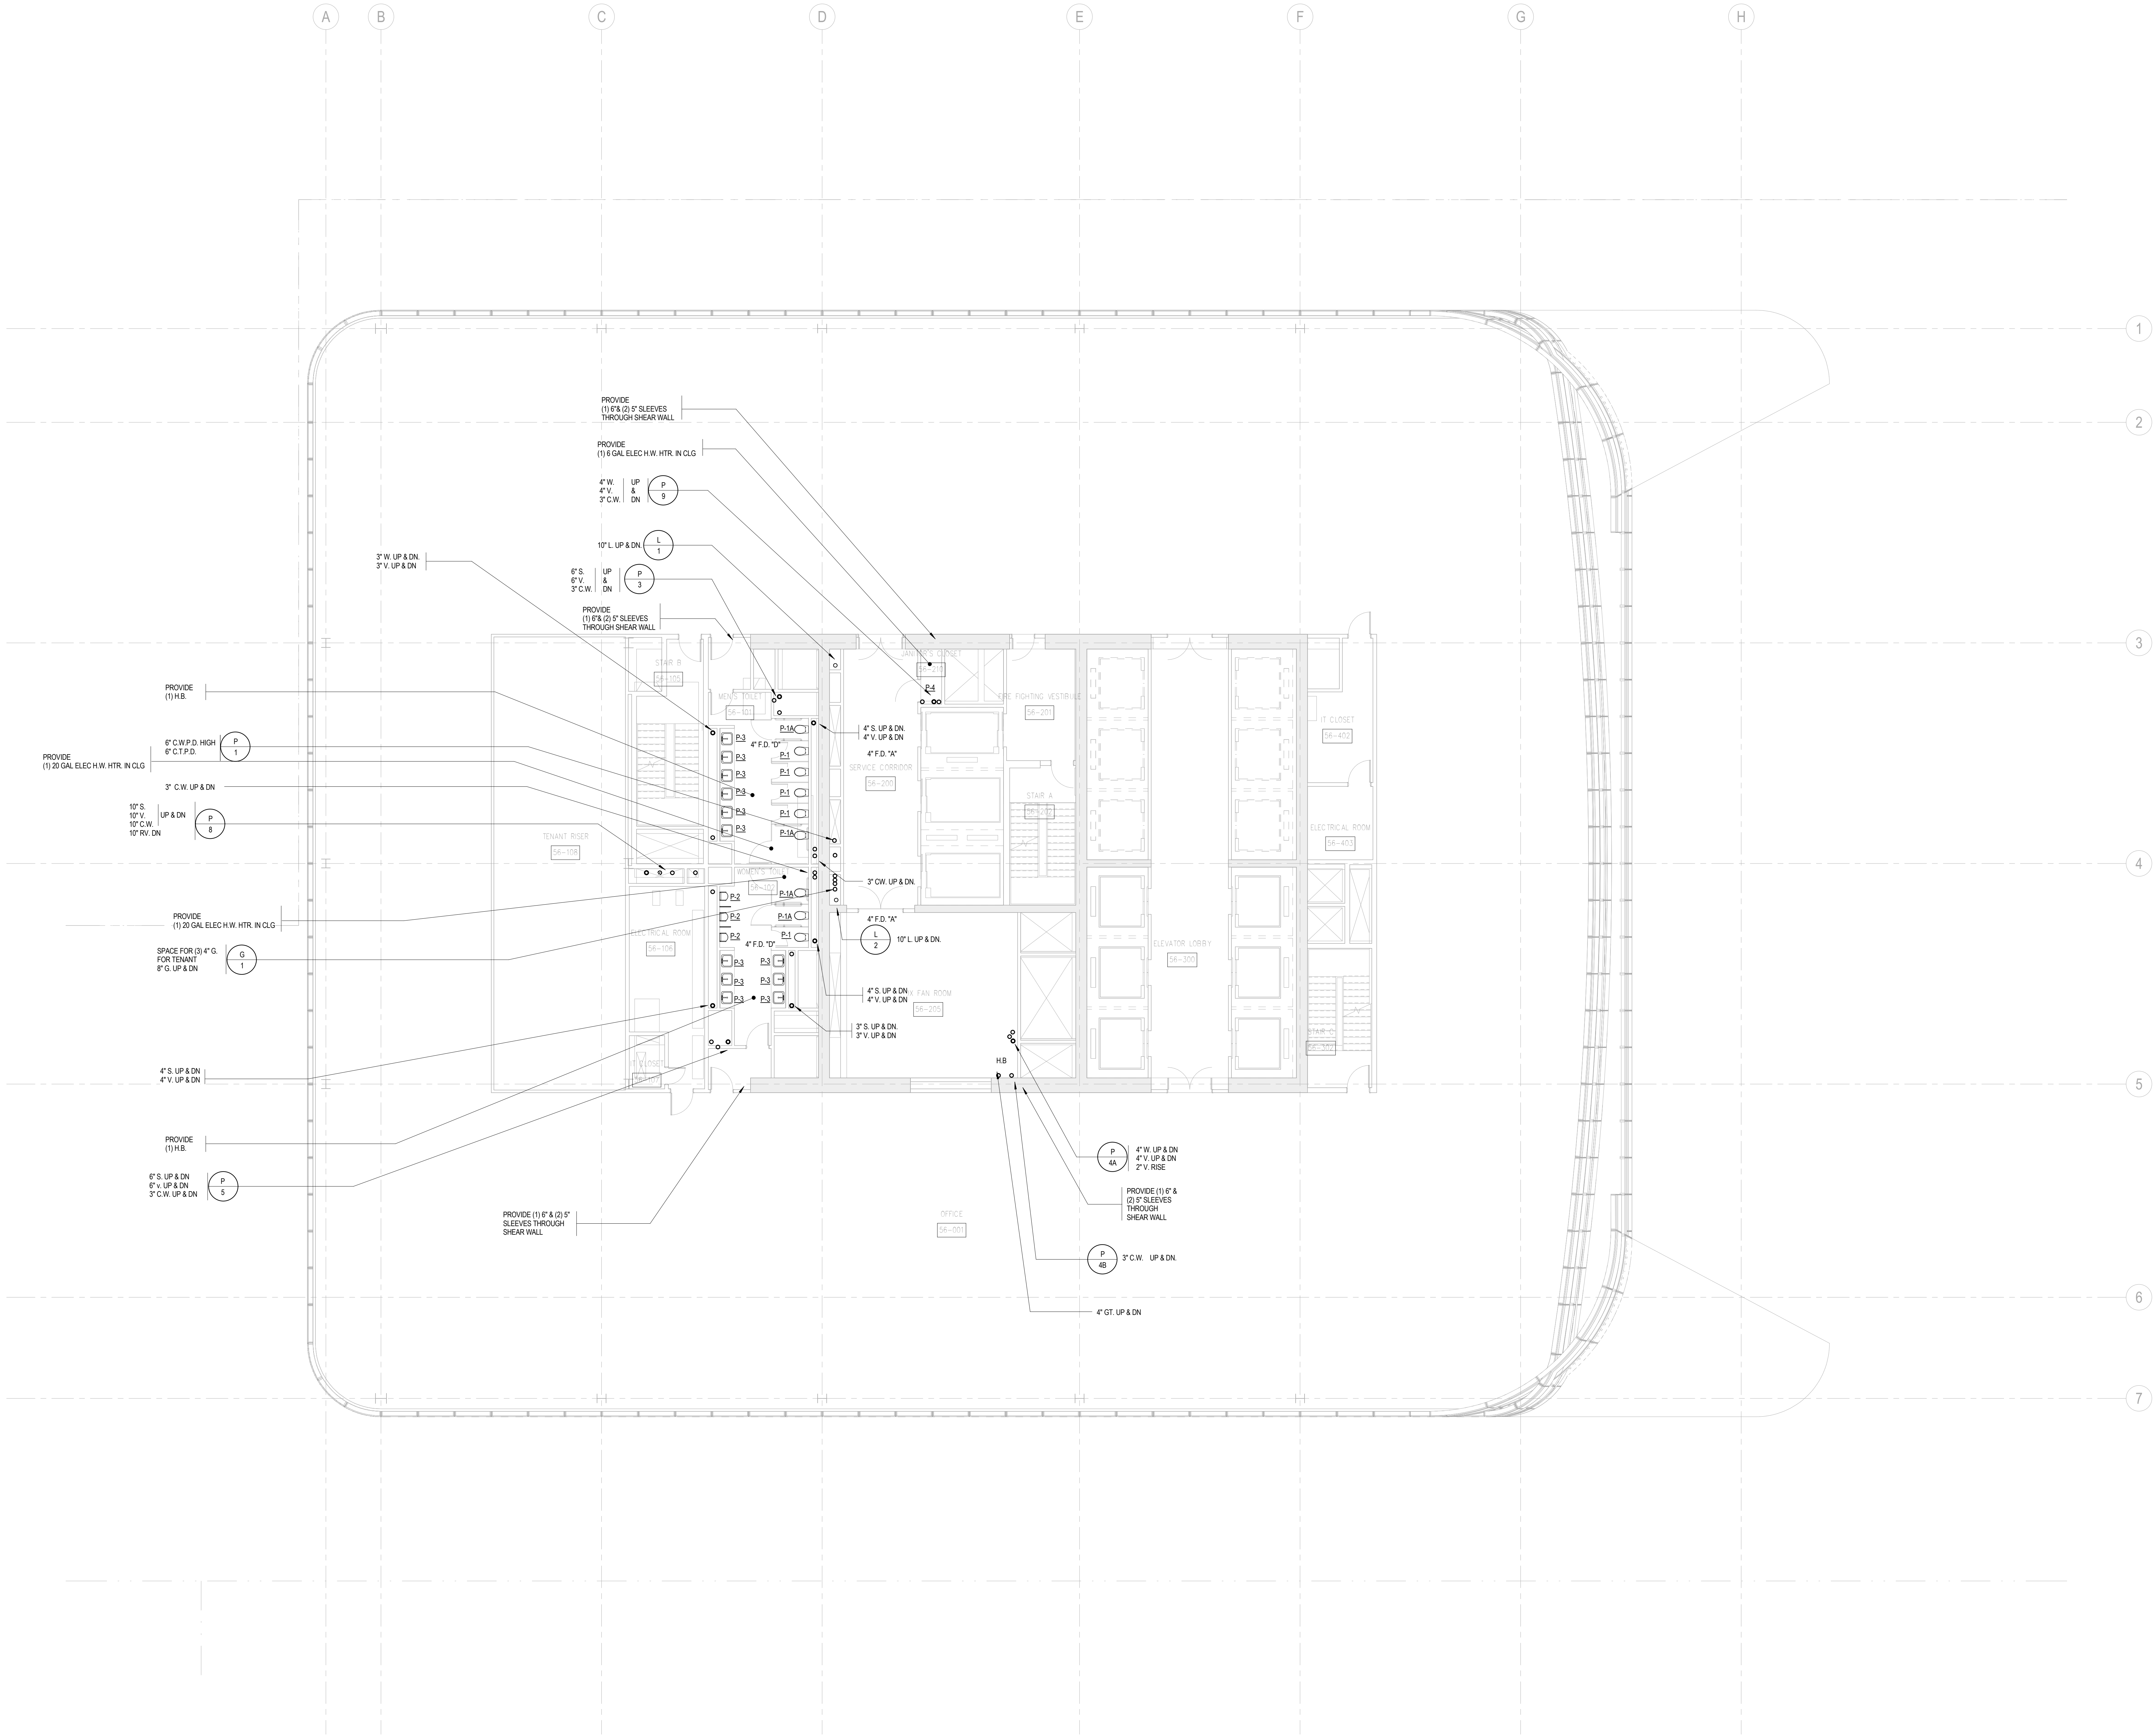
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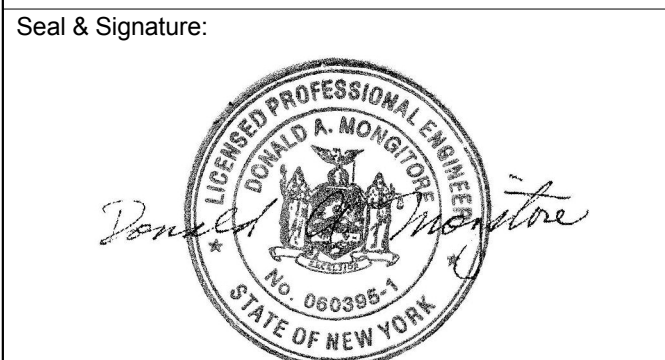
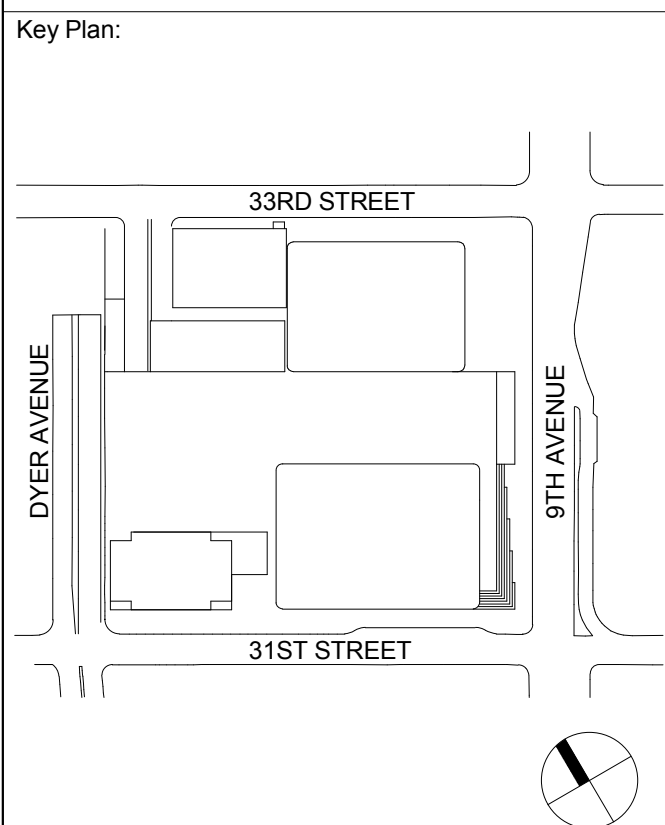
PLUMBING
LEVEL 54 FLOOR
PLAN - HIGH-RISE
WATER TANK

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NOTE: REFER TO RISER DIAGRAM FOR EXTENT
OF VALVING REQUIRED AT THIS LEVEL.






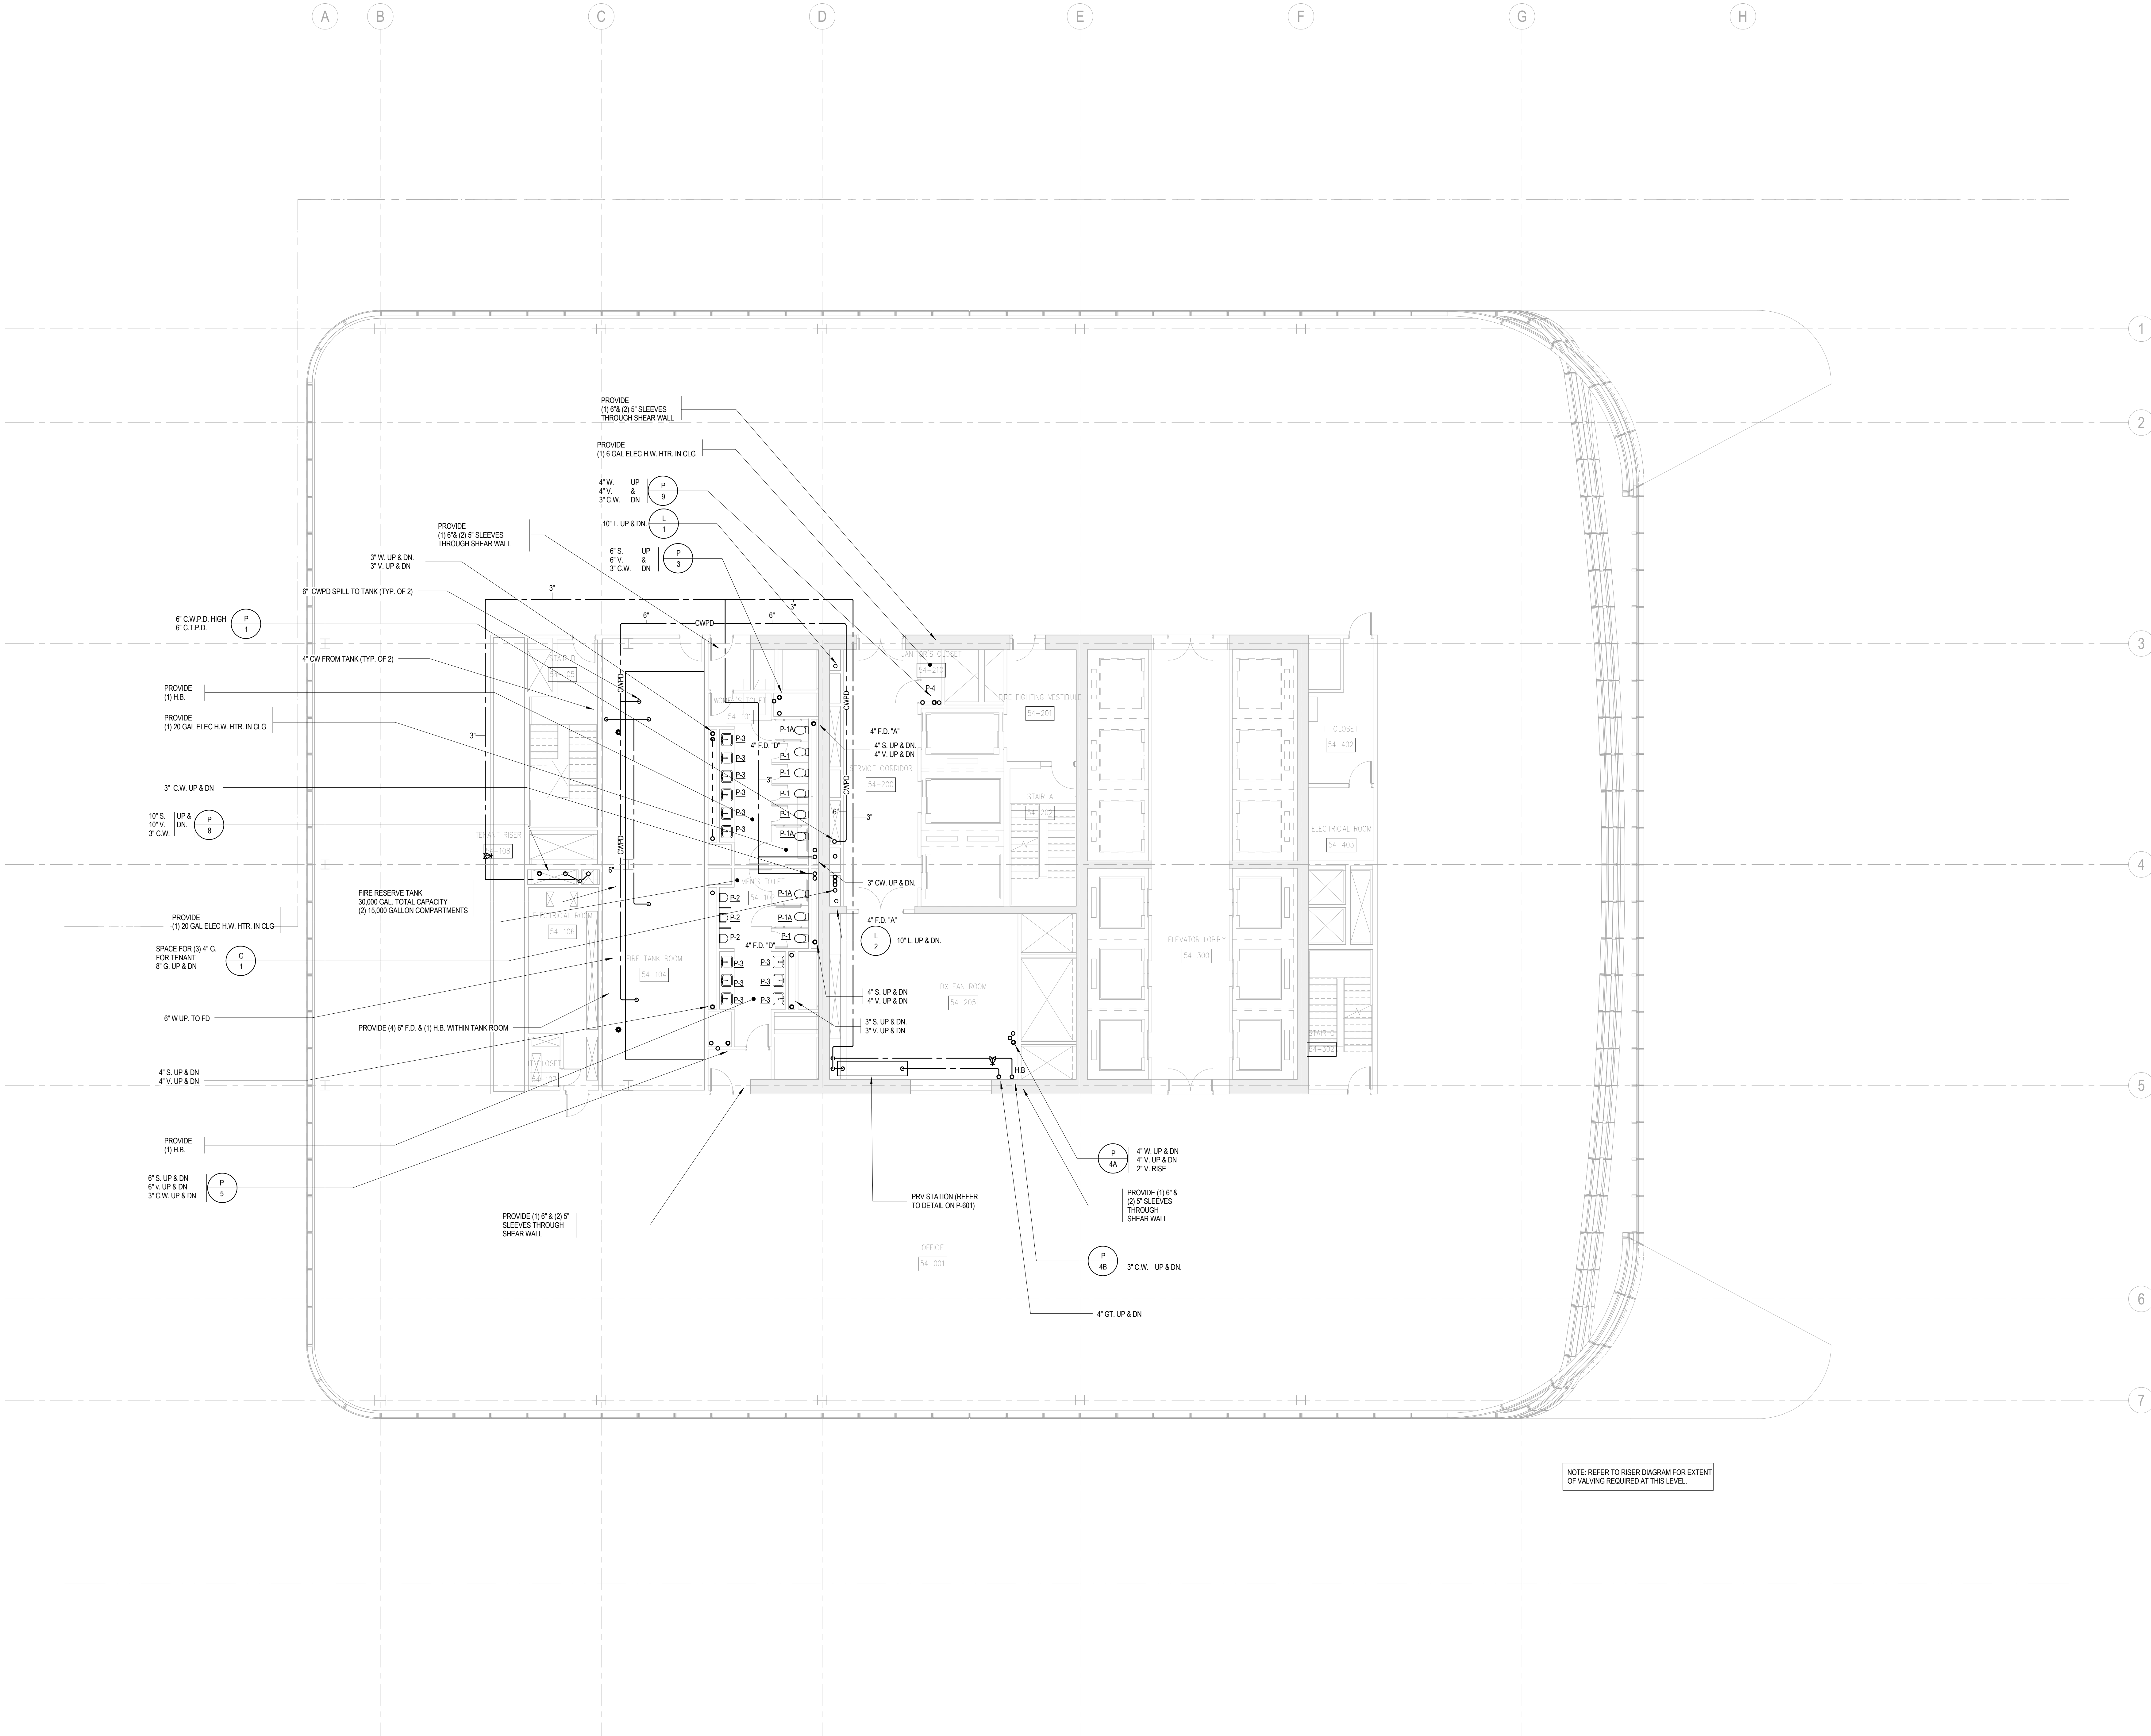

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1	19 NOV 2013	ISSUED FOR 60 PERCENT PRICING
No.	Date	Description
Sheet Name:		

PLUMBING
LEVEL 57-58
FLOOR PLAN -
TYPICAL
HIGH-RISE

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SHEET NOTES

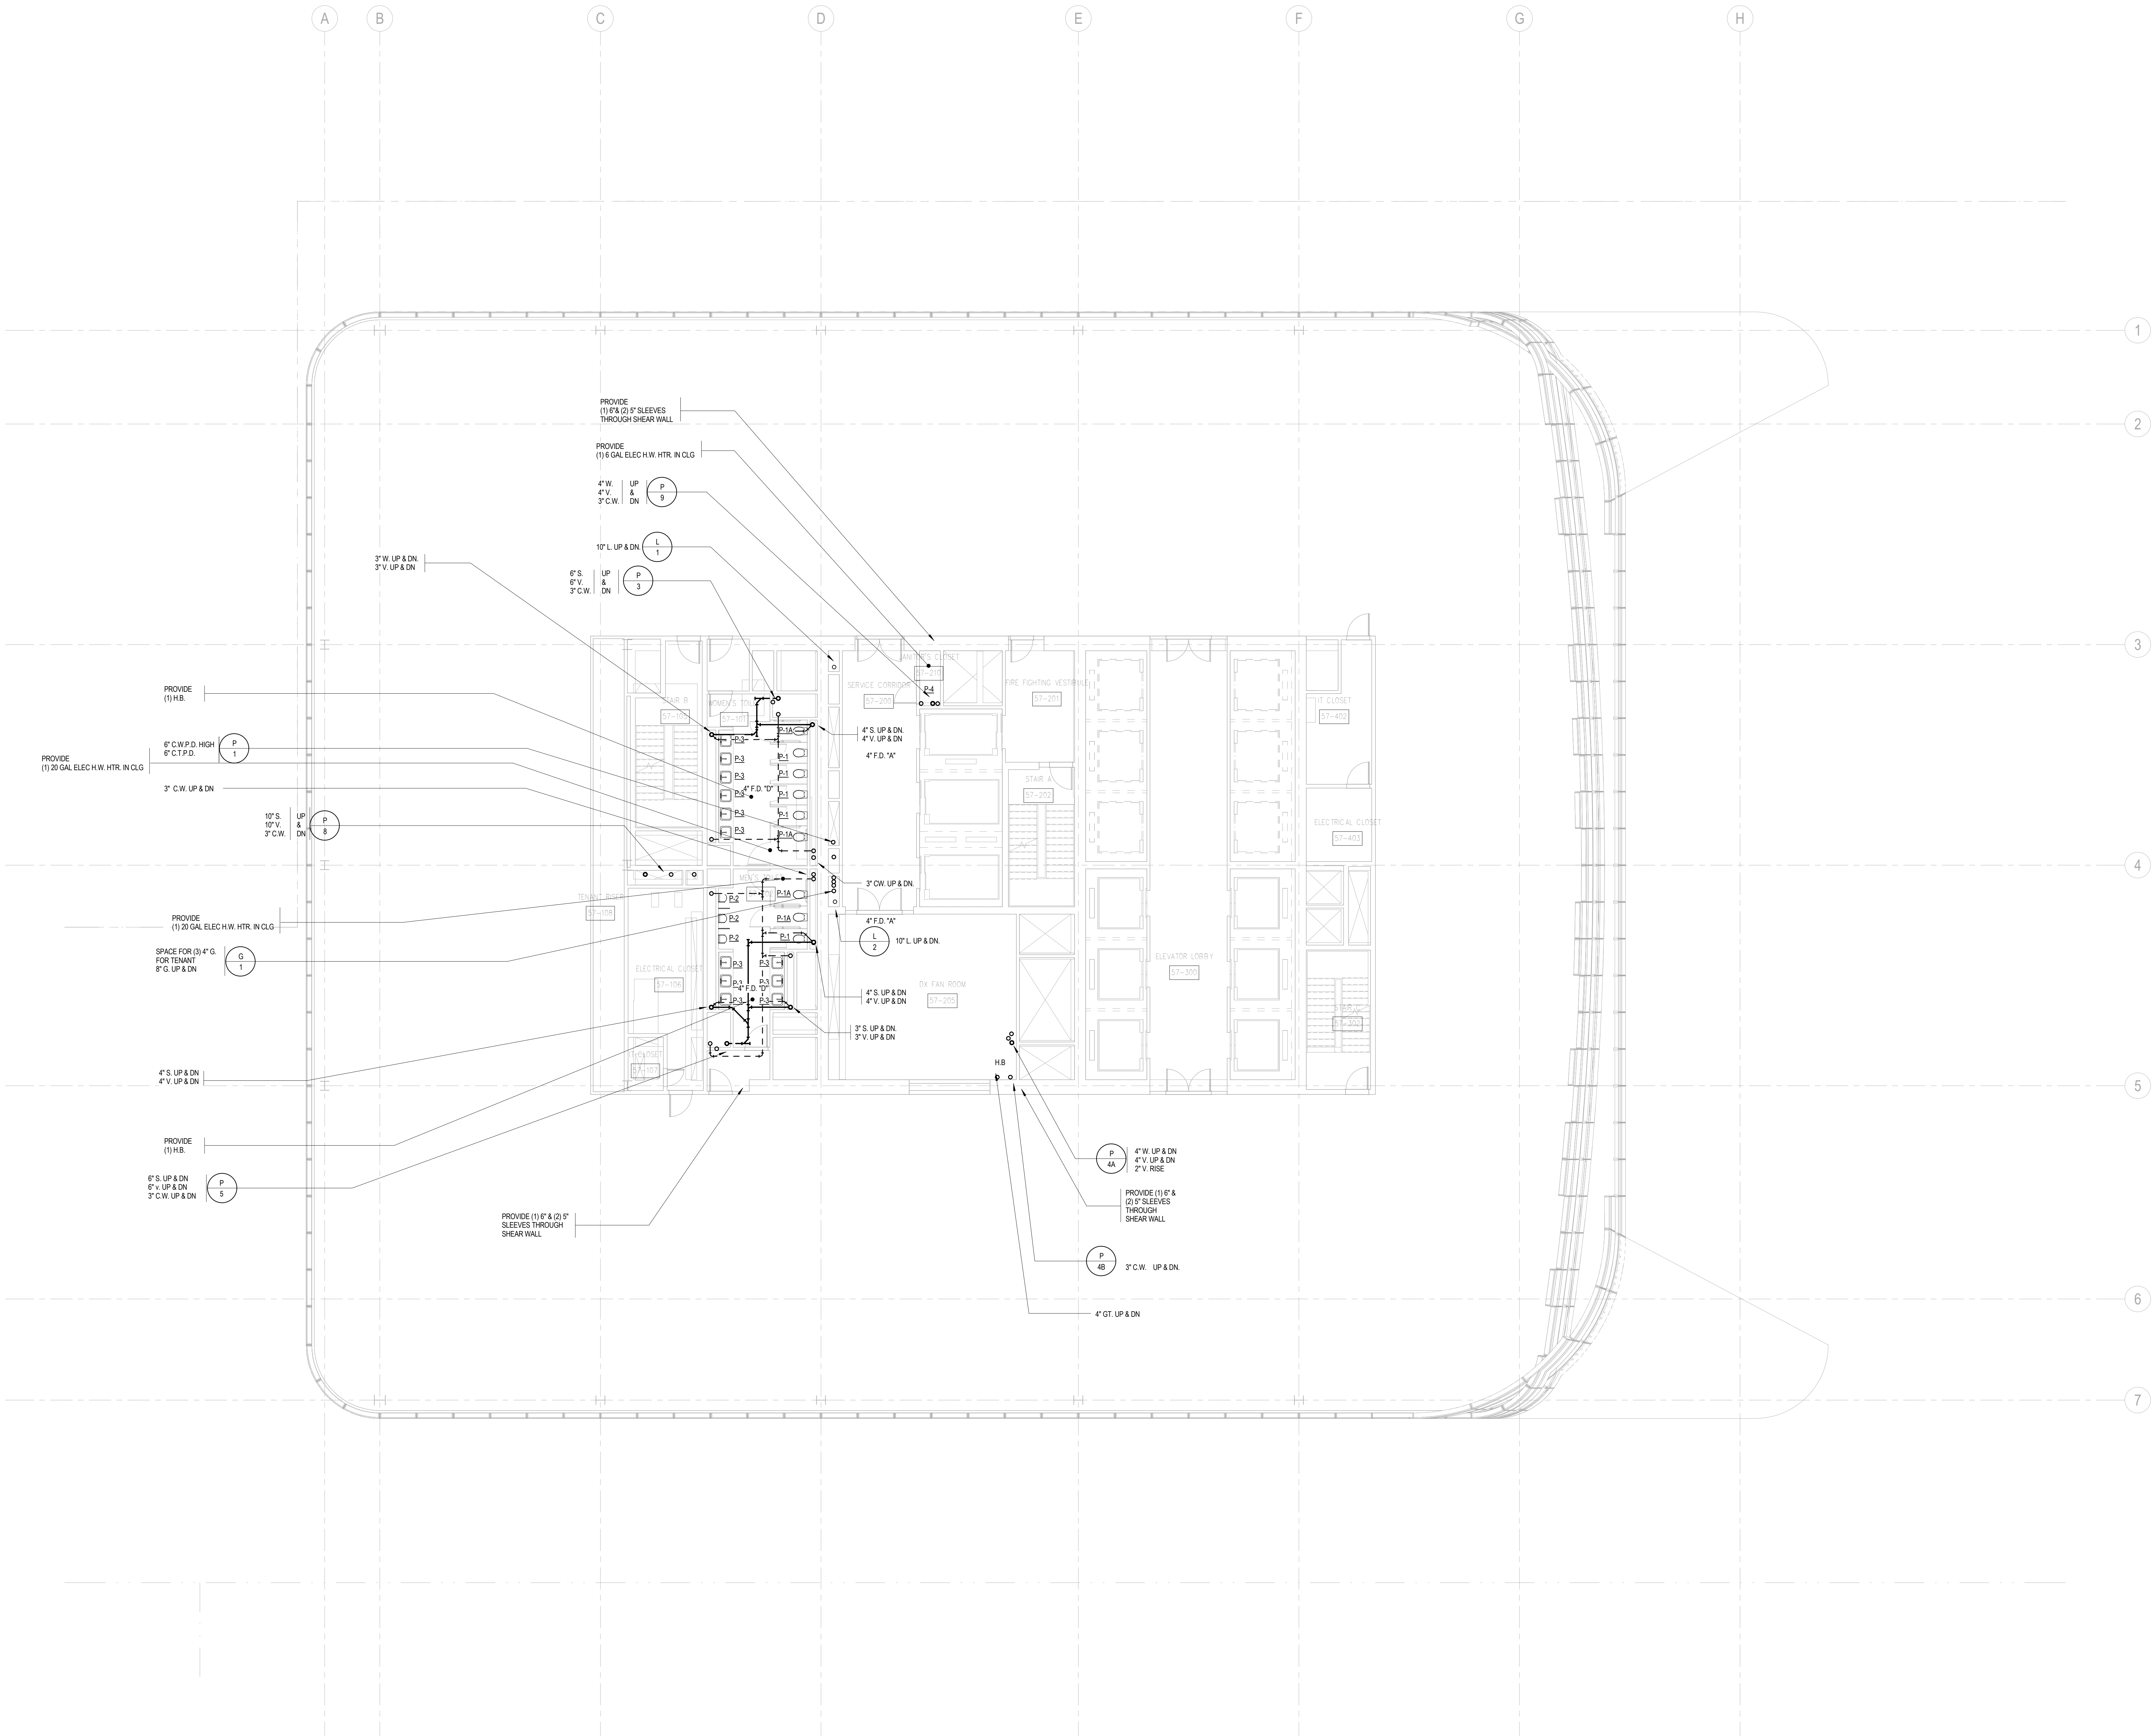

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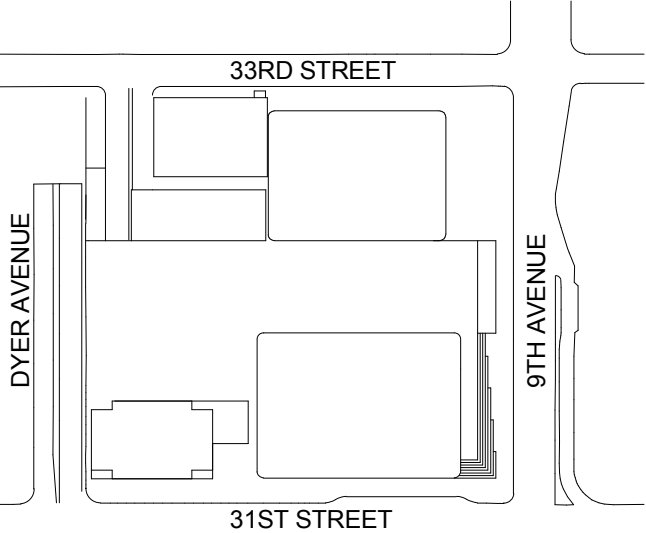
Facade Maintenance Consultant

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Key Plan:



Seal & Signature:



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No. Date Description

Sheet Name:

**PLUMBING
LEVEL 59 FLOOR
PLAN - HIGH-RISE**

Project No.:

14830-A-000

Date:

20 JUN 2014

Scale:

1/8" = 1'-0"

File No.:

P-159

B-SCAN Sheet No.:

P-159.00

Sheet No.:

P-159

Page No.:

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SHEET NOTES



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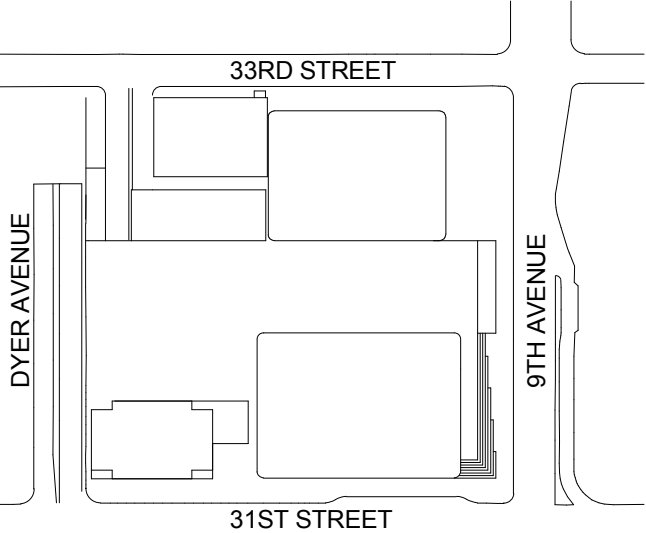
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No. Date Description

Sheet Name:

**PLUMBING
LEVEL 60-61
FLOOR PLAN -
HIGH-RISE
OVERRUN**

Project No.:

14830-A-000

Date:

20 JUN 2014

Scale:

1/8" = 1'-0"

File No.:

P-160

B-SCAN Sheet No.:

P-160.00

Sheet No.:

P-160

Page No.:

46 OF 6

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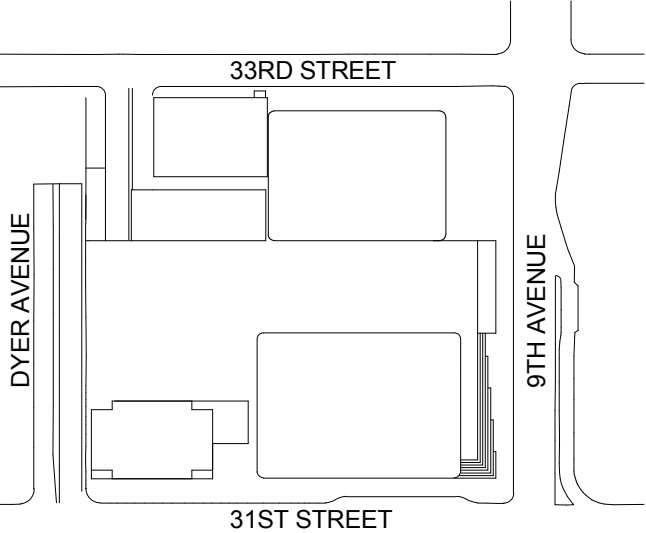
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Key Plan:



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No.	Date	Description

Sheet Name:

**PLUMBING
LEVEL 63 FLOOR
PLAN - HIGH-RISE**

Project No.:

14830-A-000

Date:

20 JUN 2014

Scale:

1/8" = 1'-0"

File No.:

P-163

B-SCAN Sheet No.:

P-163.00

Sheet No.:

P-163

Page No.:

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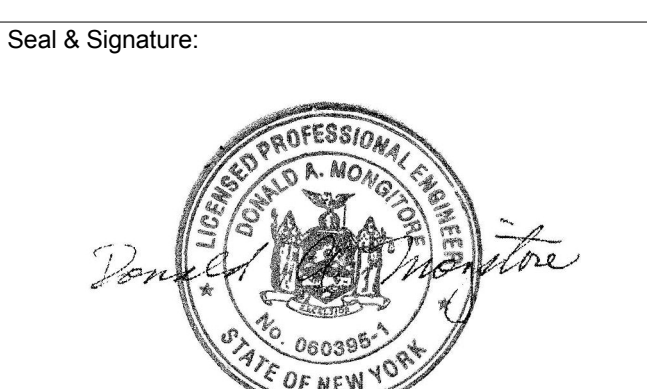
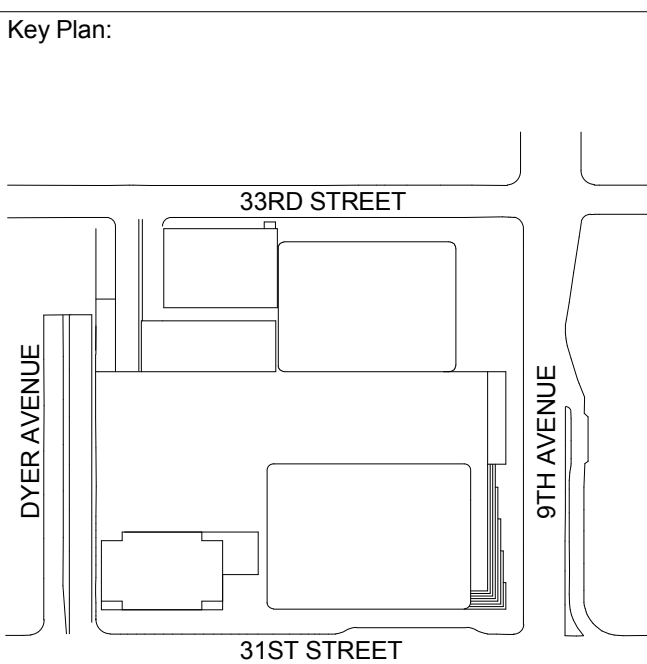
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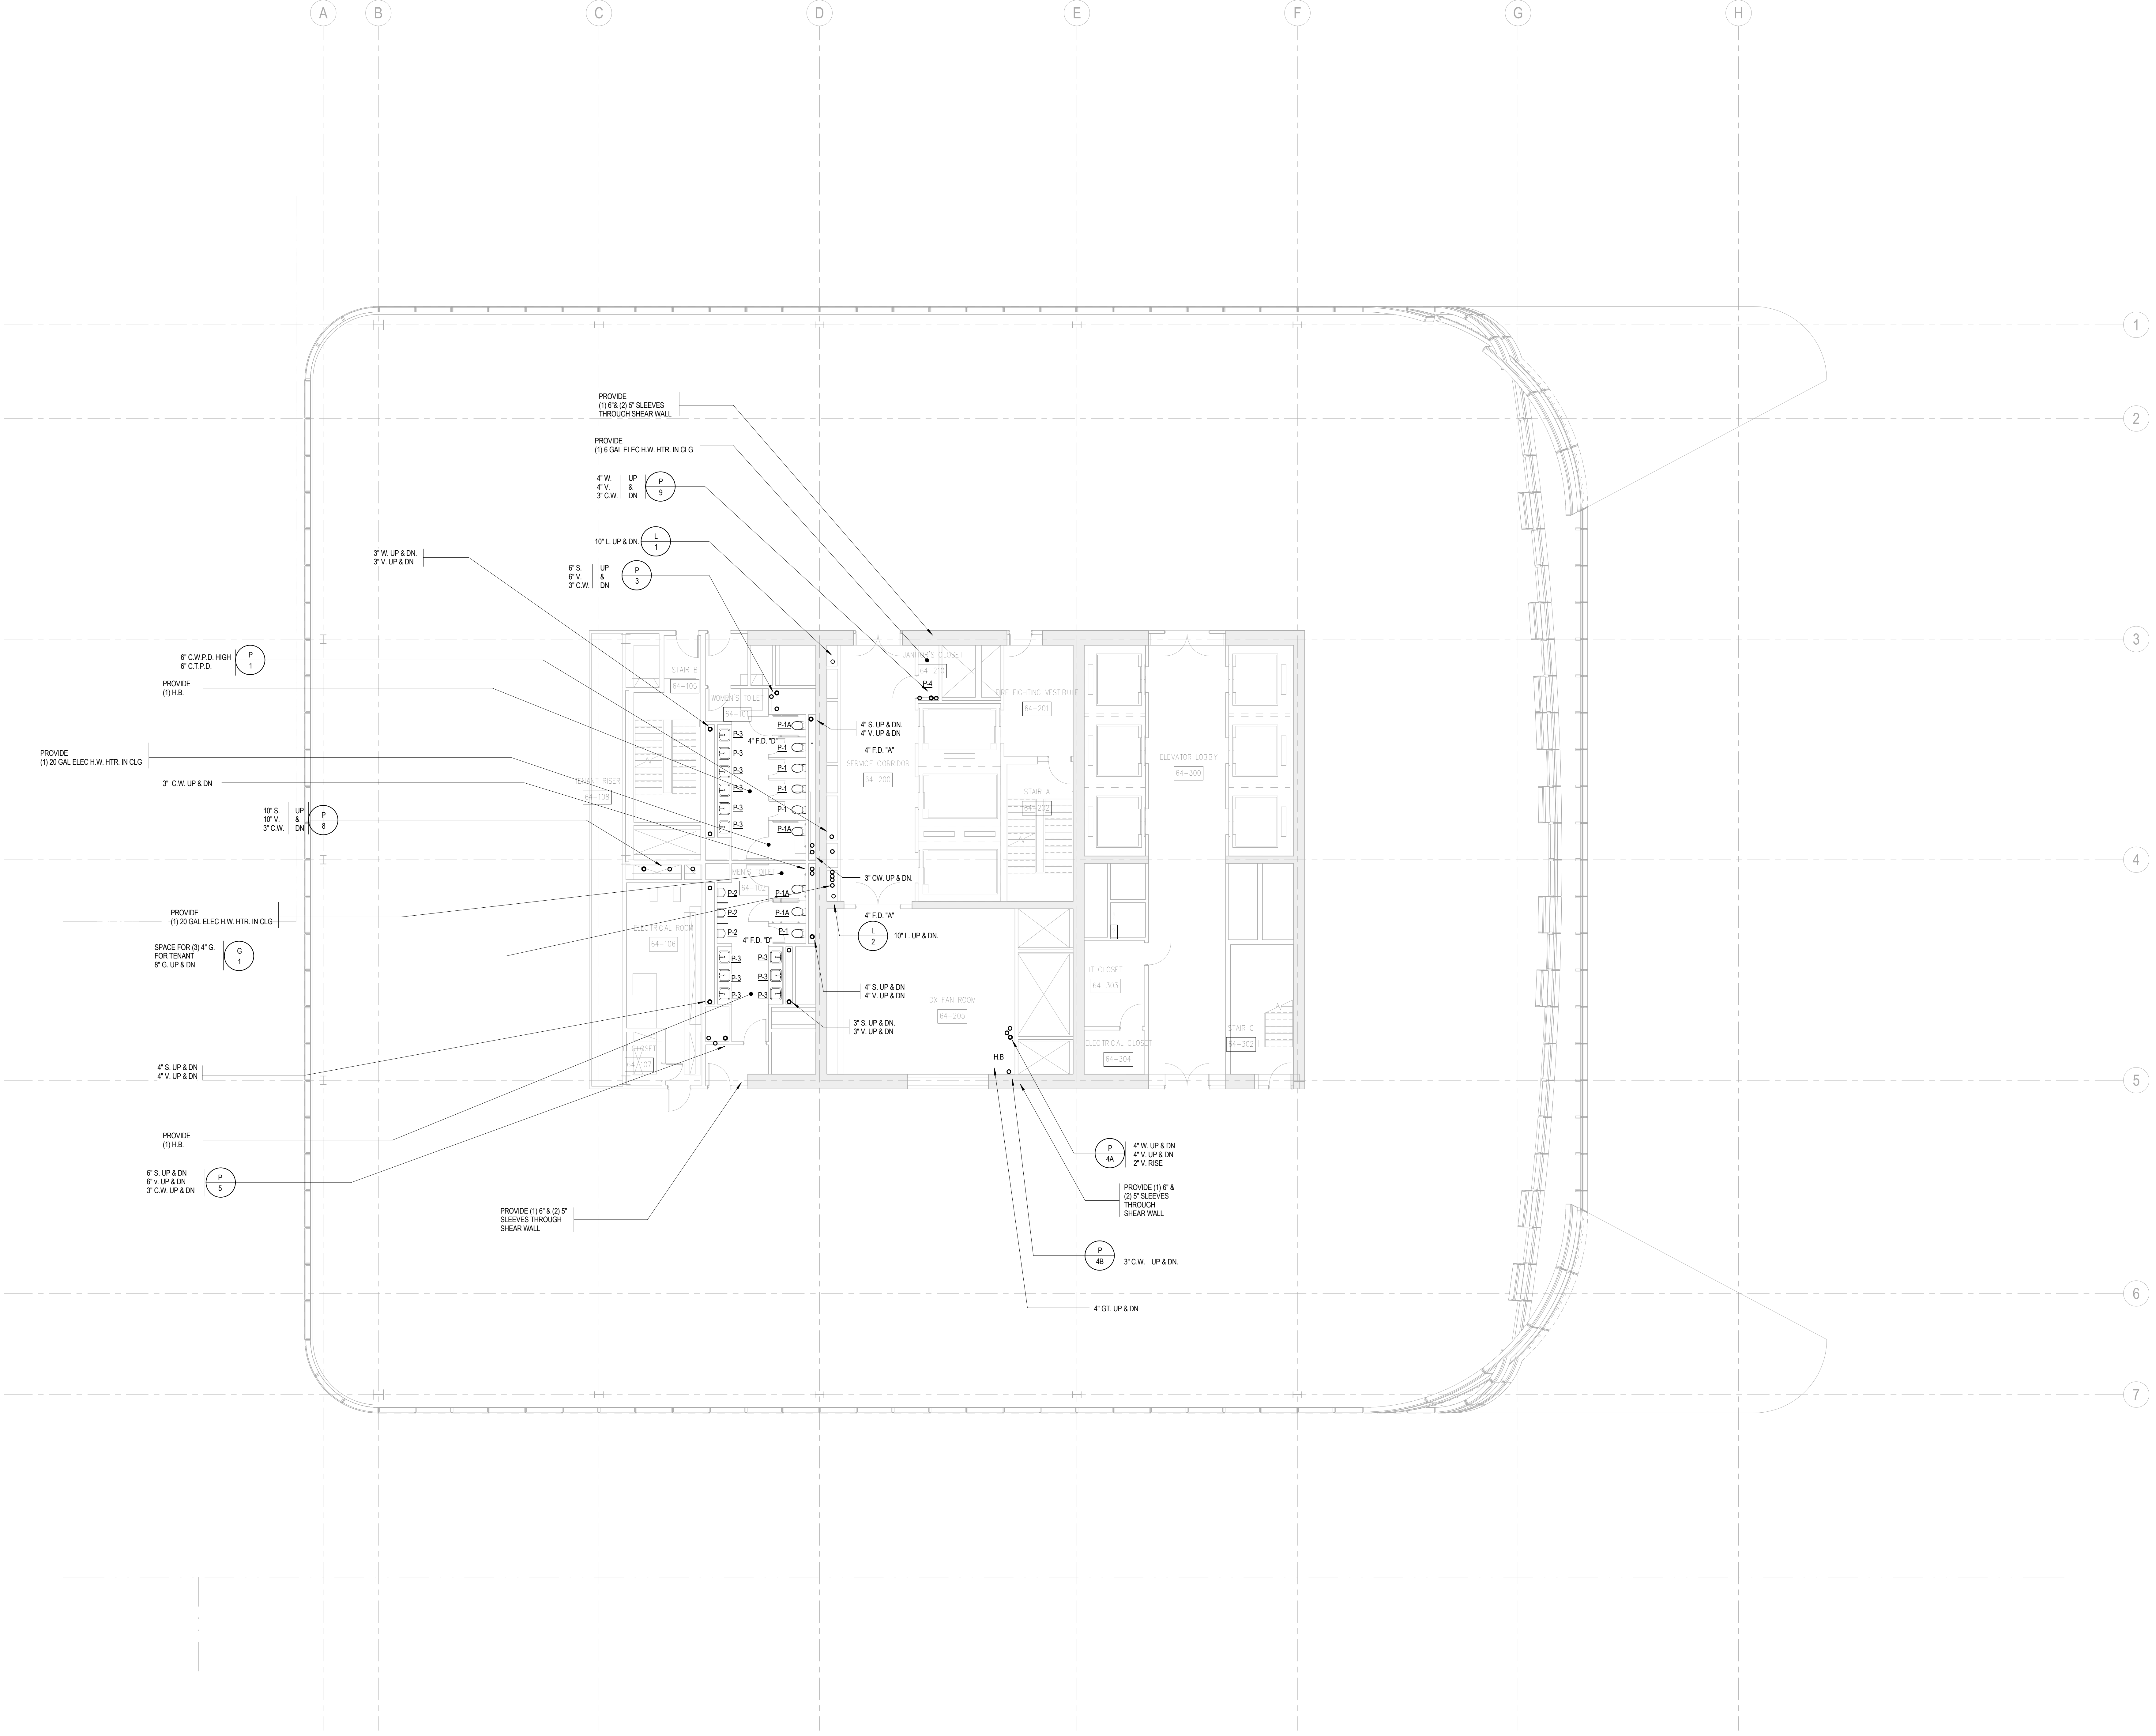
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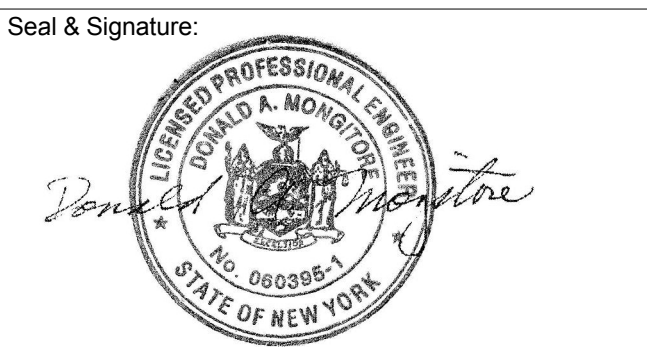
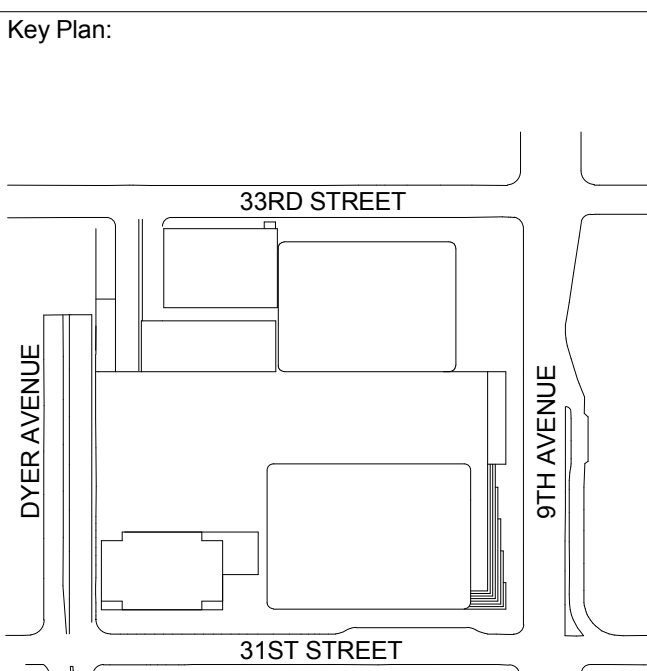
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**PLUMBING
LEVEL 64-66
FLOOR PLAN -
TYPICAL
HIGH-RISE**

Project No.: 14830-A-000
Date: 20 JUN 2014
Scale: 1/8" = 1'-0"
File No: P-164
B-SCAN Sheet No.:
P-164.00
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P-164
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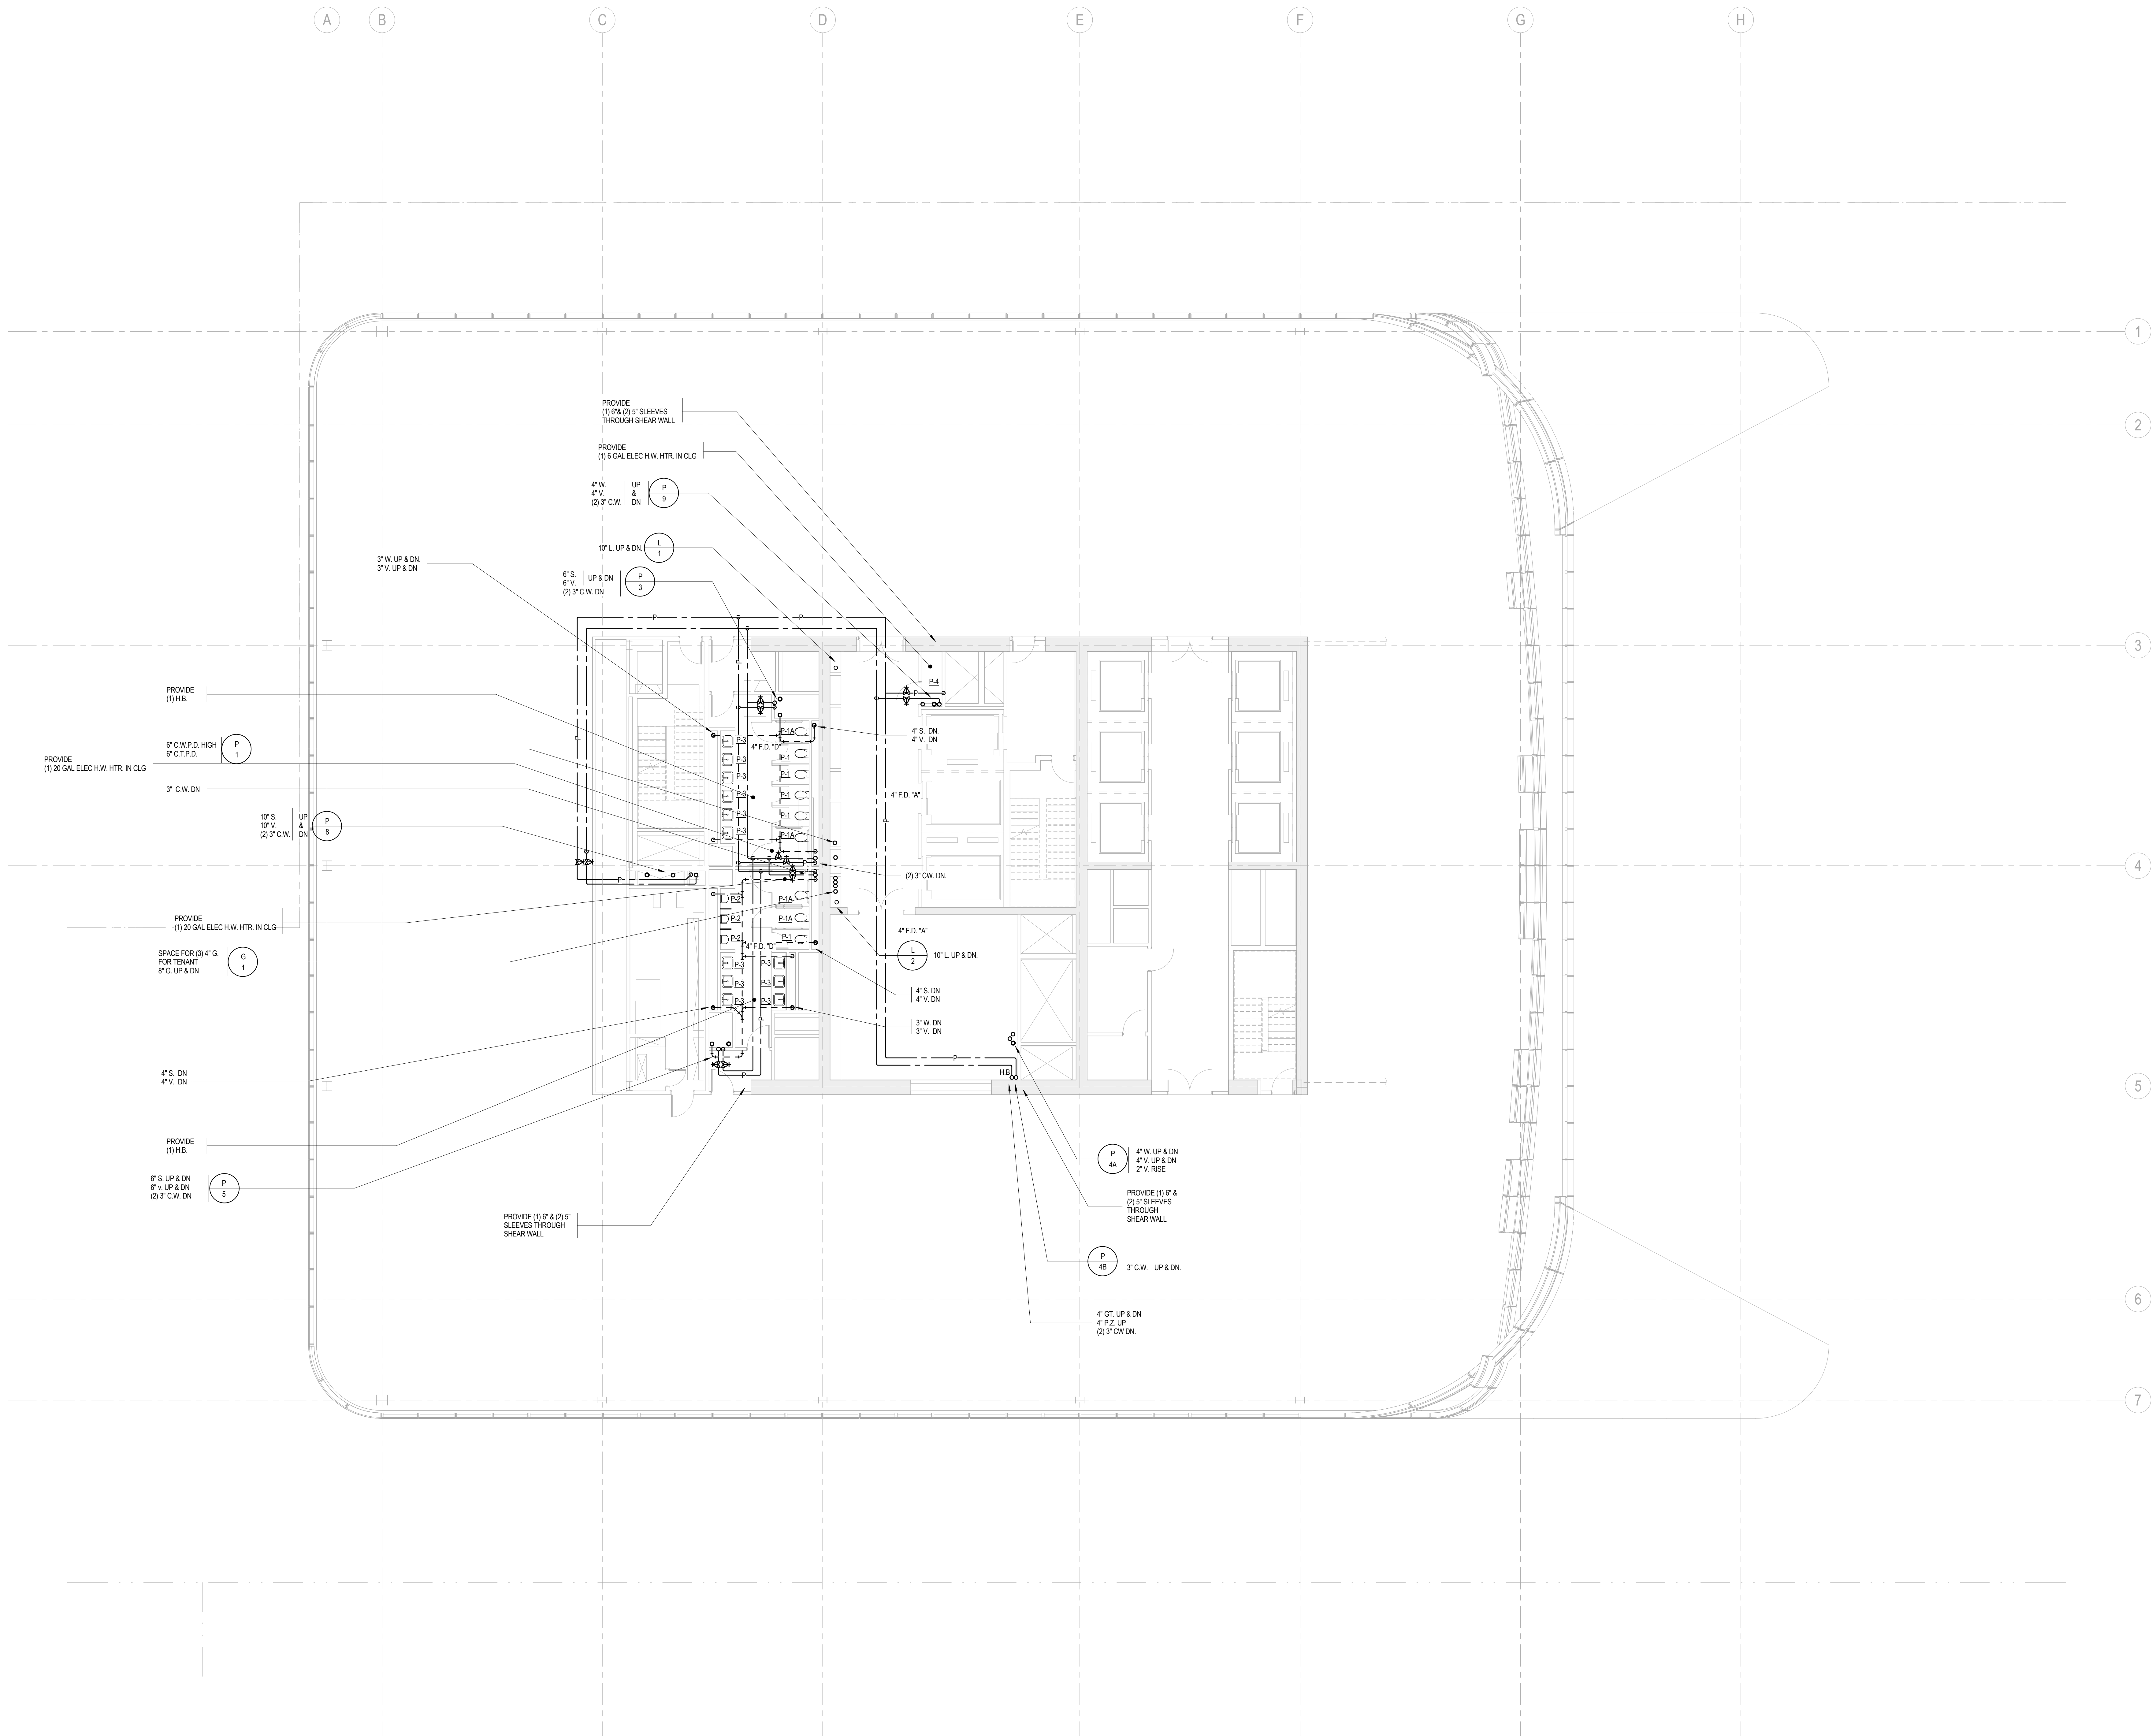
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3	15 NOV 2013	ISSUED FOR 50% DESIGN DEVELOPMENT
2	12 JUL 2013	ISSUED FOR 50% DESIGN DEVELOPMENT
1	19 MAR 2013	ISSUED FOR RECONCILIATION


No. Date Description

Sheet Name:

PLUMBING
LEVEL 67 FLOOR
PLAN - TYPICAL
HIGH-RISE

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Acoustical Consultant
Cerami & Associates
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Code Consultants Professional Engineers PC
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[illegible]

Key Plan:

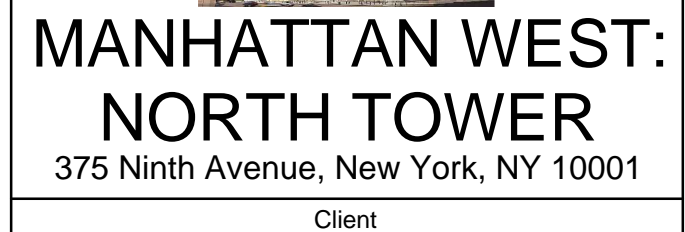REVENUE

REVENUE

Donald A. Montore


2	12 JUL 2013	ISSUED FOR 50% DESIGN DEVELOPMENT
1	15 MAR 2013	ISSUED FOR RECONCILIATION
No.	Date	Description

Sheet Name:

PLUMBING

MECHANICAL
MEZZANINE

Date: 20 DEC 2013	<div style="text-align: center;"> <h1>P-169.00</h1> </div>
Scale: 1/8" = 1'-0"	
File No.:	<div style="text-align: center;"> <p>Sheet No.:</p> <h2>P-169</h2> </div>
Page No.:	

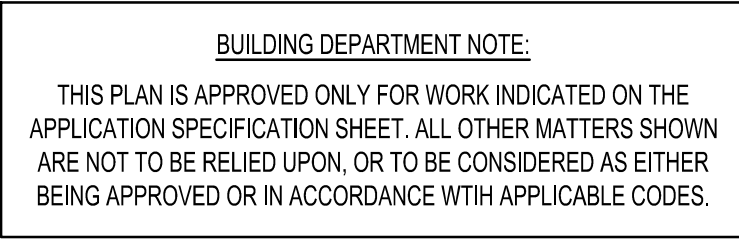

SHEET NOTES



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65 Broadway, Suite 401, New York, NY 10006

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215 West 40th Street, 16th Floor, New York, NY 10018


Facade Maintenance Consultant

Entek Engineering LLC
166 Ames Street, Hackensack, NJ 07601

Wind Tunnel Consultant

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650 Woodlawn Road West, Guelph
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Key Plan:

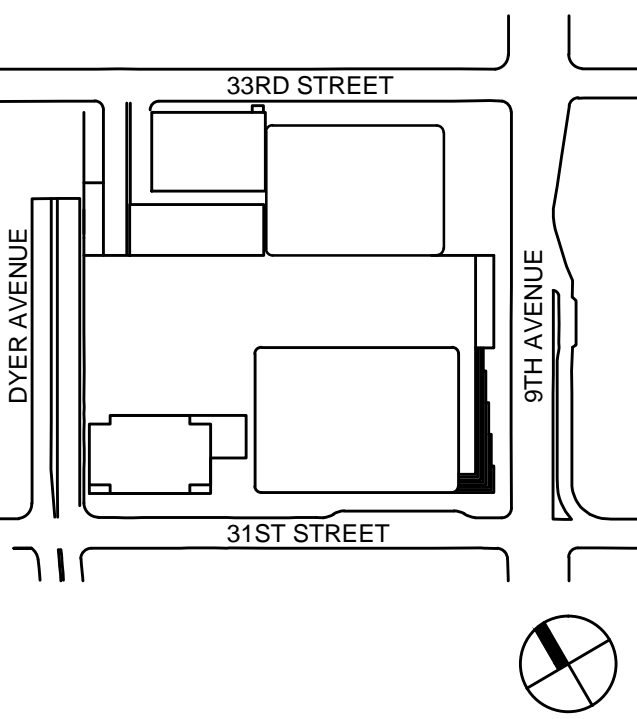

Seal & Signature:



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2	12 JUL 2013	ISSUED FOR 50% DESIGN DEVELOPMENT
1	13 MAR 2013	ISSUED FOR RECONCILIATION

No. Date Description

Sheet Name:

**PLUMBING
ROOF PLAN -
MECHANICAL
PENTHOUSE
ROOF**

Project No.:

14630_A

B-SCAN Sheet No.:

P-171

Date:

15 NOV 2013

Sheet No.:

P-171.00




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Key Plan:

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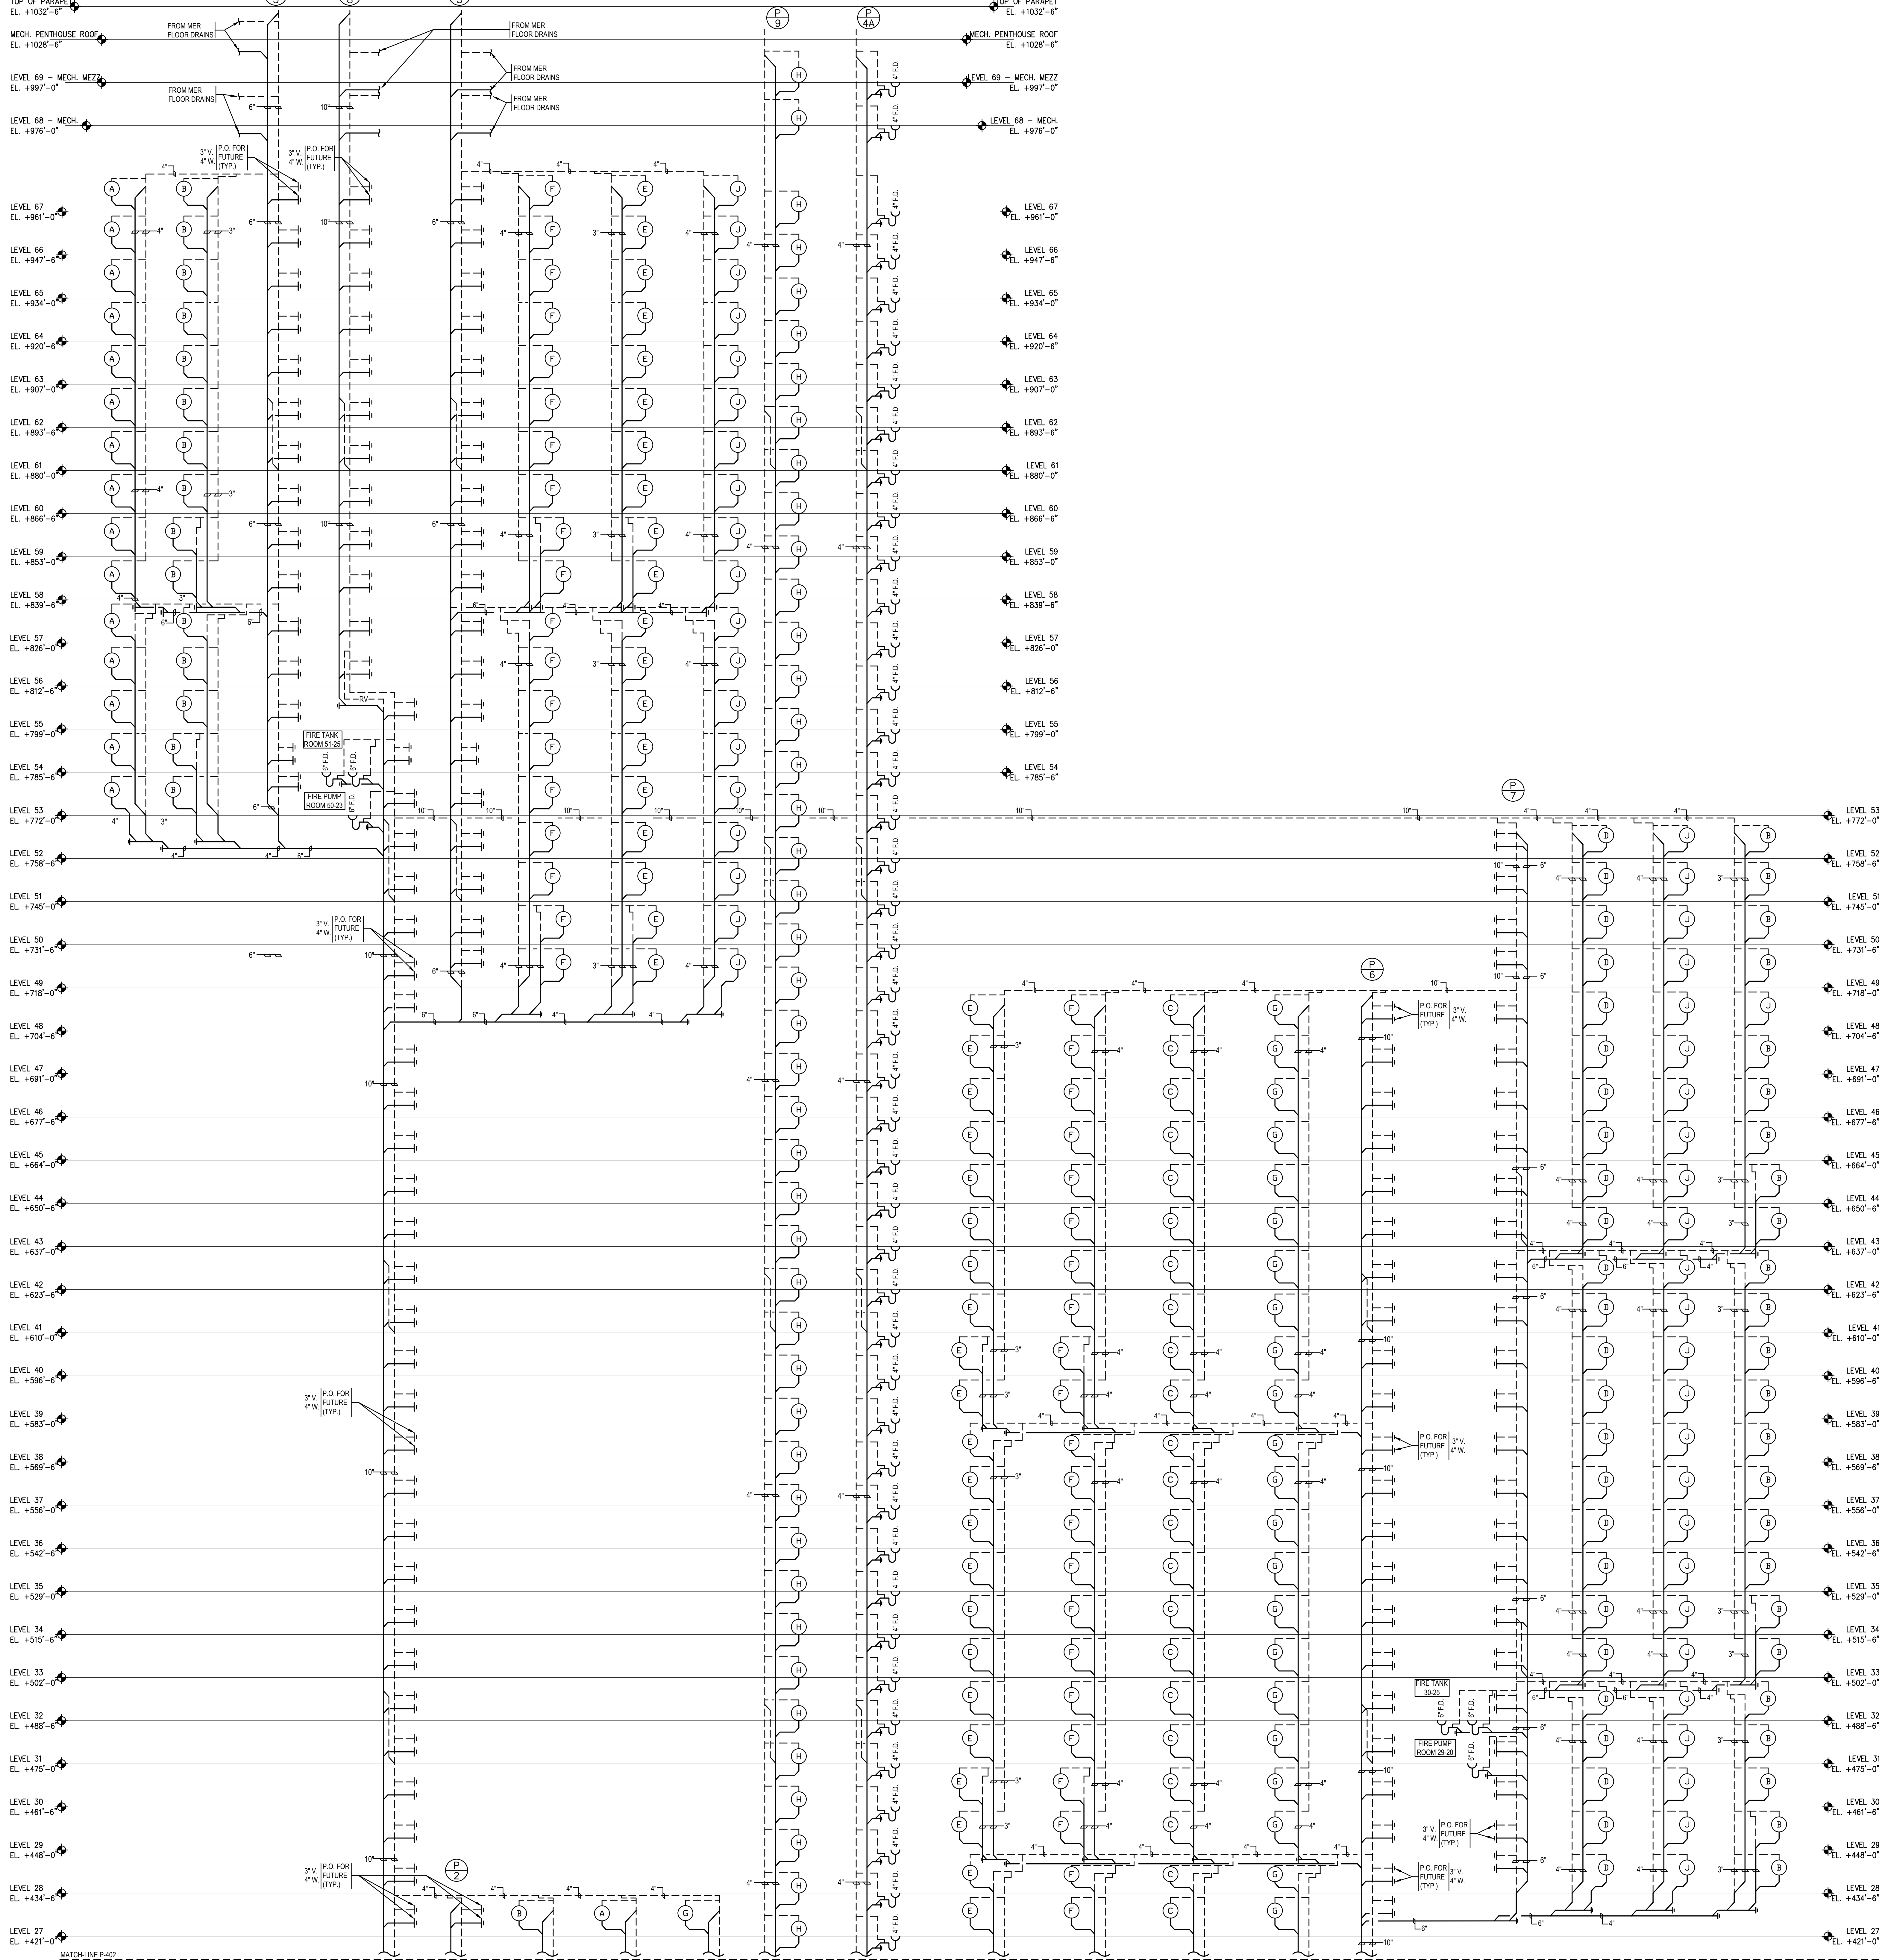
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4	13 JUL 2013	ISSUED FOR 50% DESIGN DEVELOPMENT
5	13 MAR 2013	ISSUED FOR RECONSTRUCTION

No. _____ Date _____ Description _____

Sheet Name:

**PLUMBING
DOMESTIC WATER
RISER
DIAGRAM**

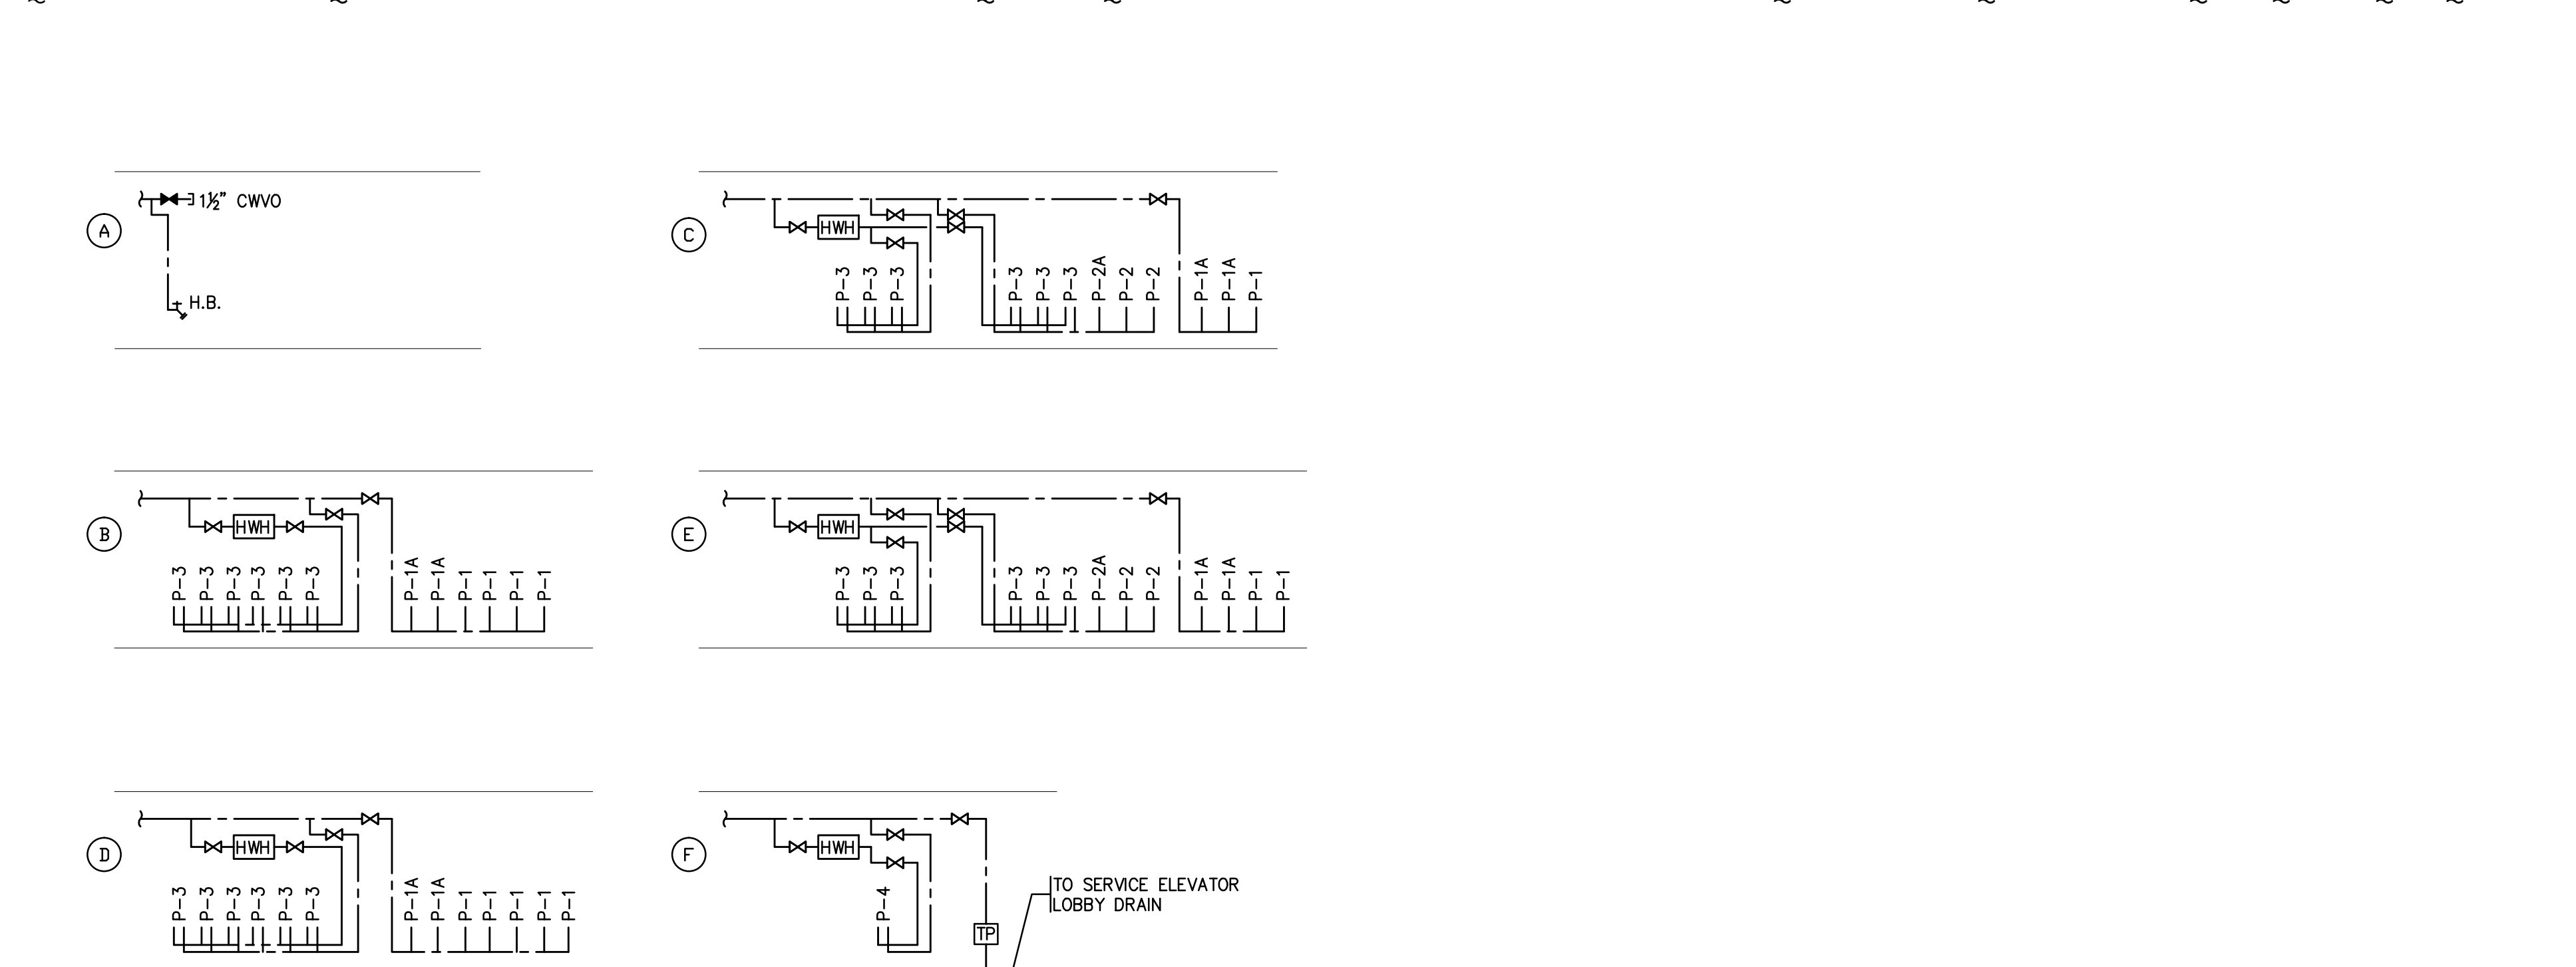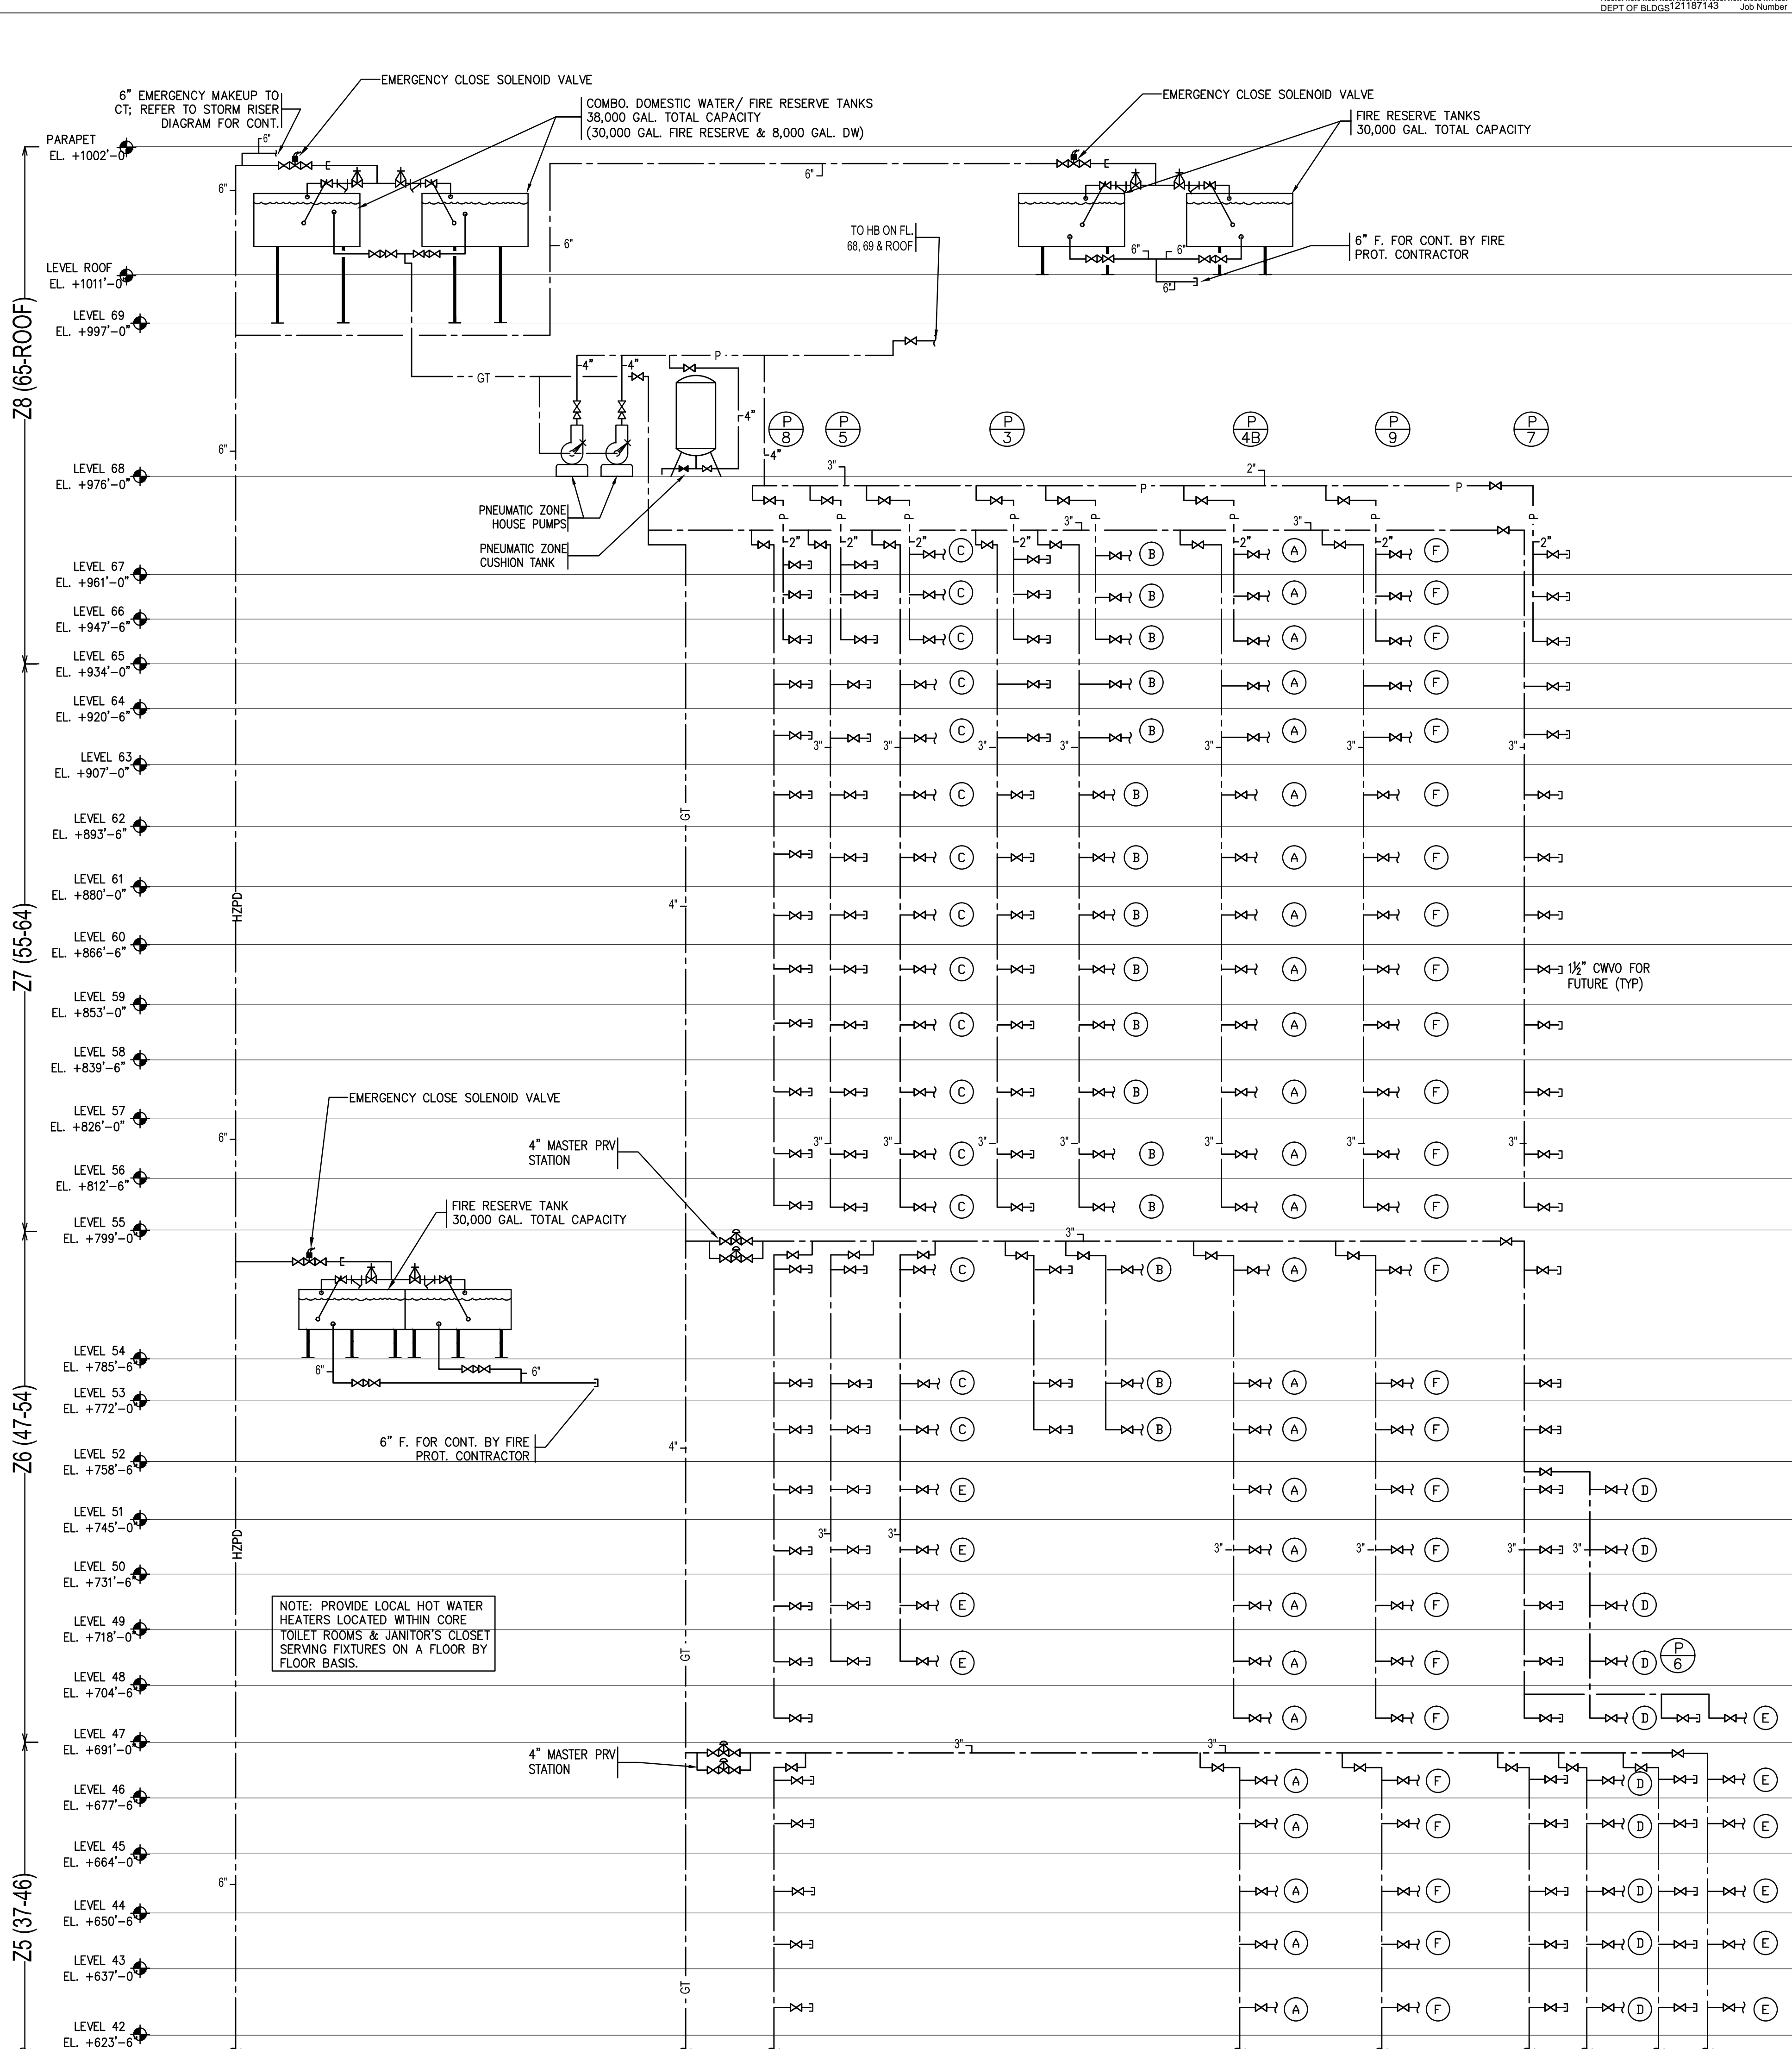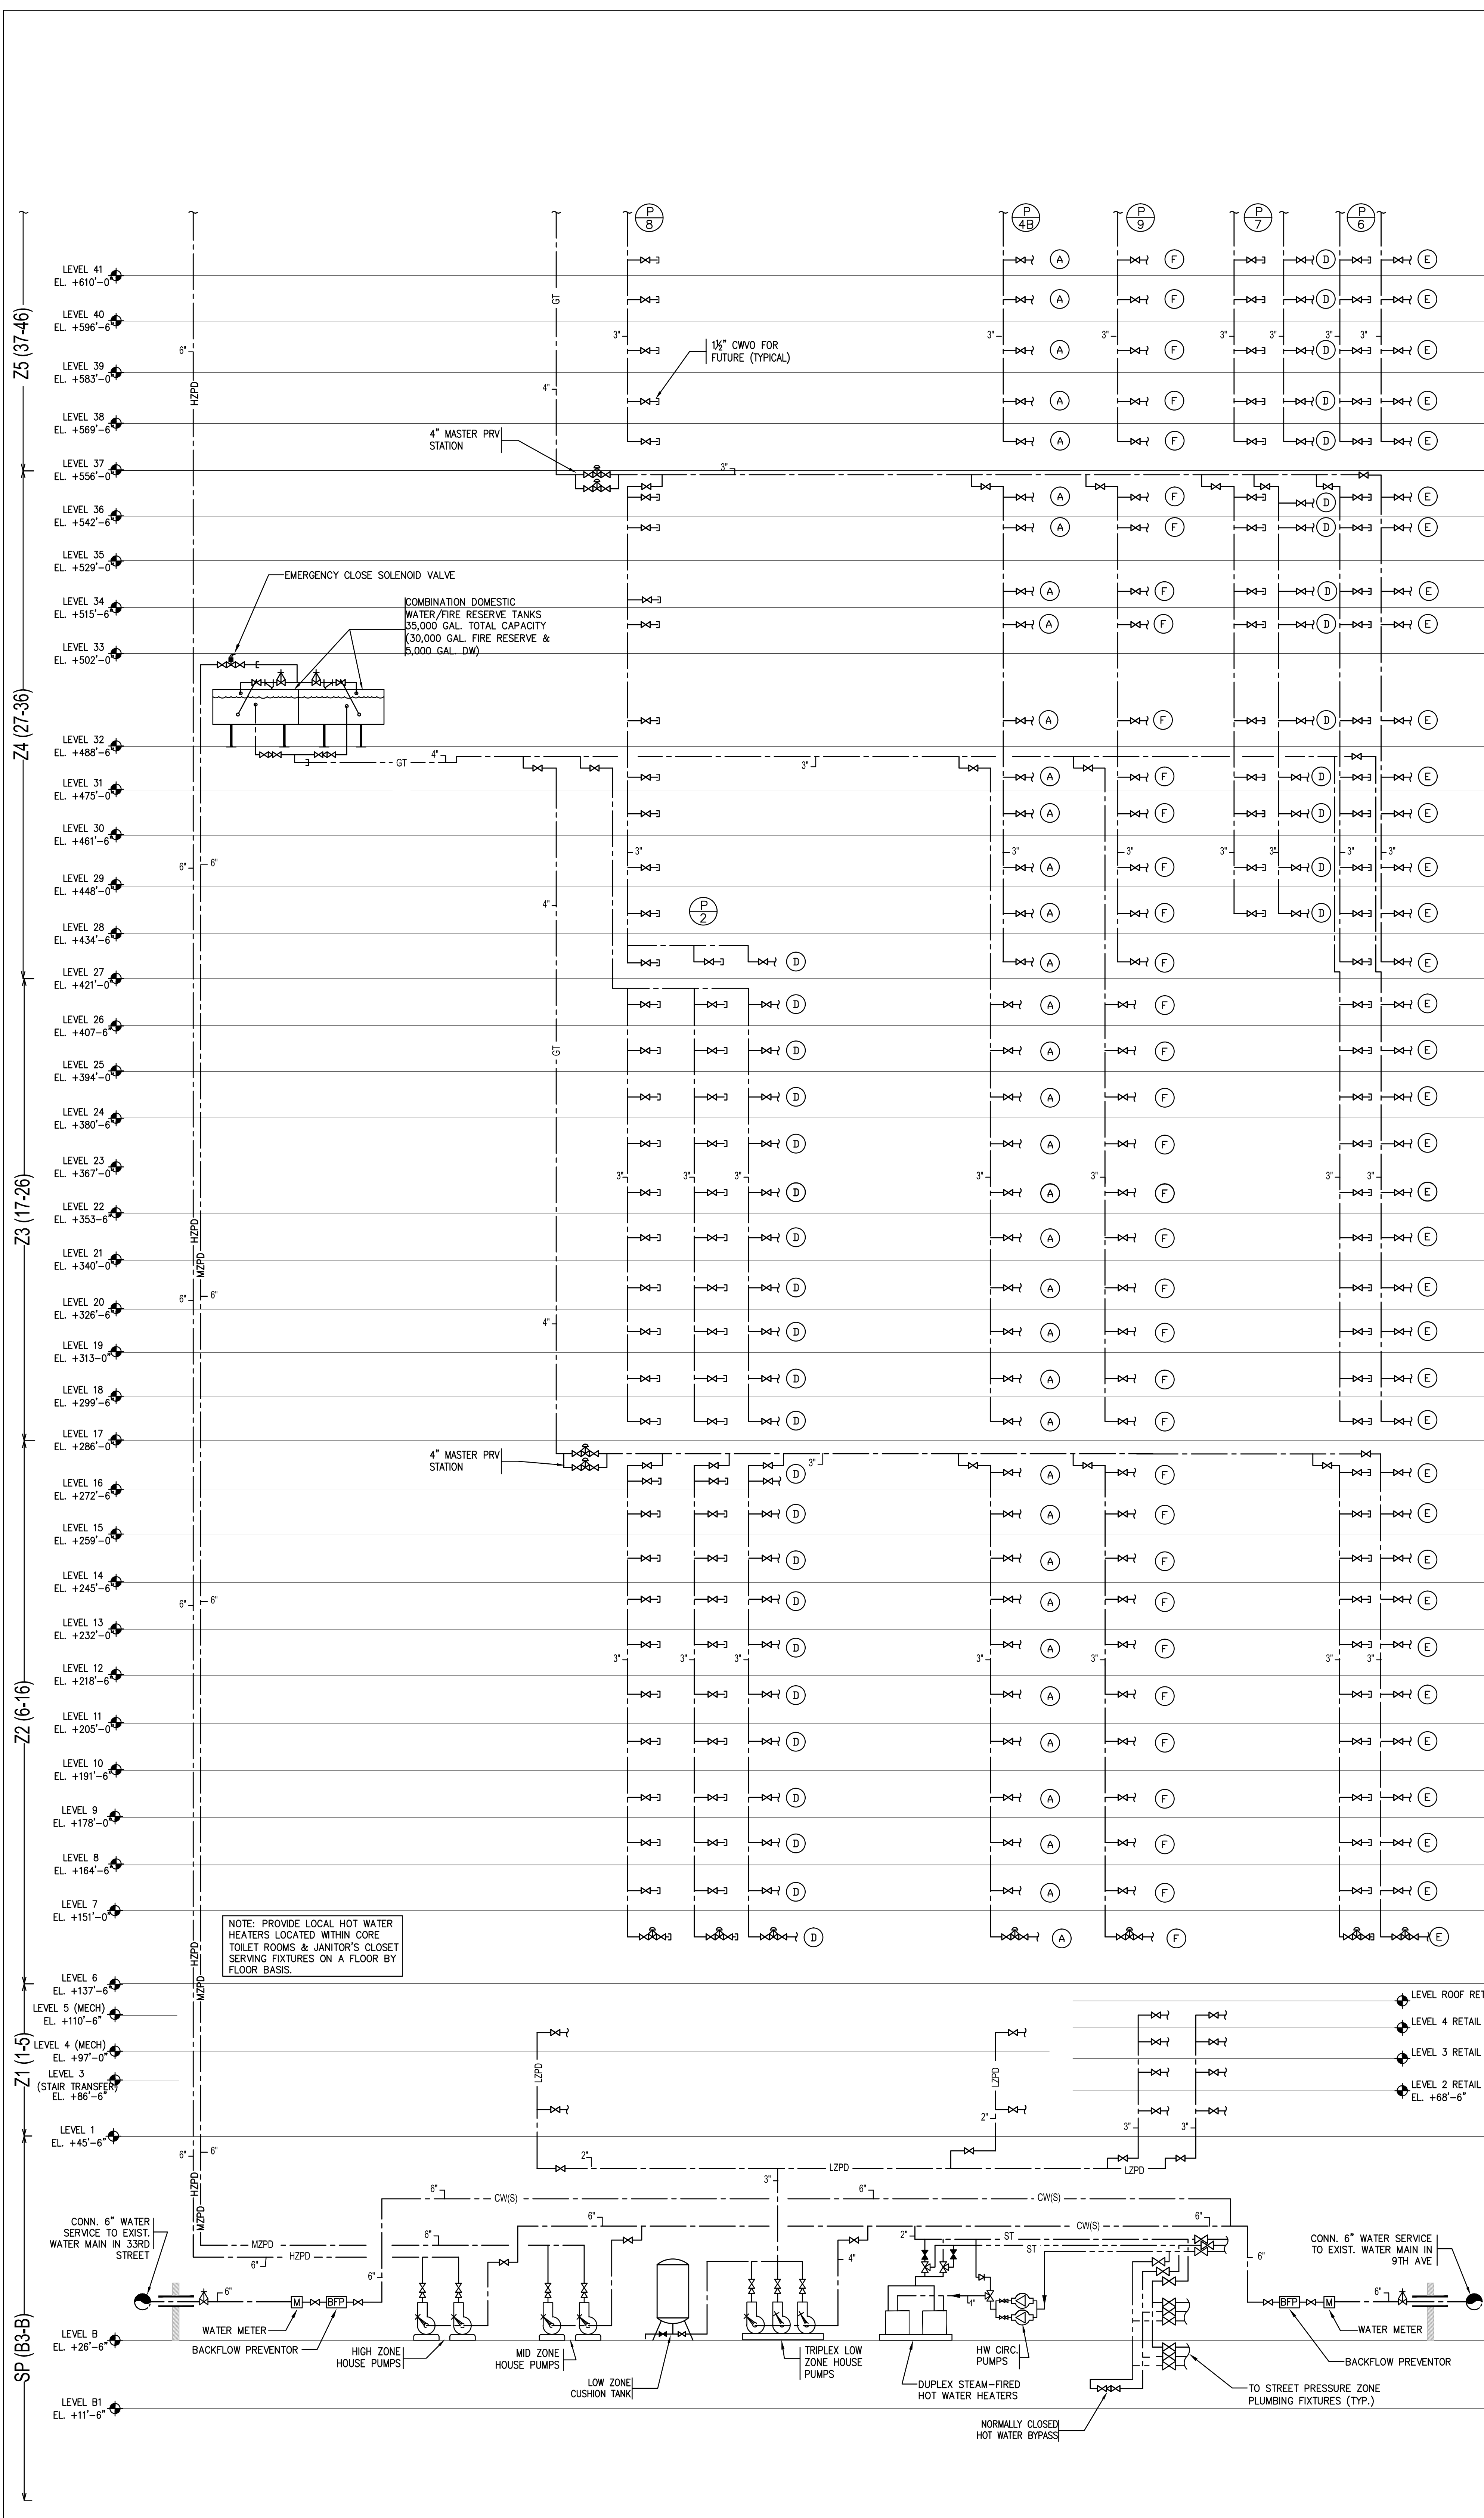
Project No.:	B-SCAN Sheet No.:
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Project No.: 14830.A	B-SCAN Sheet No.: <div style="font-size: 2em; text-align: center;">P-402.00</div>
Date: 20 DEC 2013	
Scale: NTS	
File No.:	Sheet No.: <div style="font-size: 1.5em; text-align: center;">P-402</div>
	Page No.: _____



**MANHATTAN WEST:
NORTH TOWER**
375 Ninth Avenue, New York, NY 10001



			DRAIN SCHEDULE																																			
			BODY													STRAINER													REMARKS									
DESIGNATION	ZURN NO. (UNLESS OTHERWISE NOTED)		CAST IRON DURA-COATED	GALVANIZED STAINLESS STEEL	NICKEL BRONZE	BOTTOM OUTLET	45° OUTLET	SIDE OUTLET	CLAMPING DEVICE	UNDERDECK CLAMP	BACK WATER VALVE	NO HUB	THREADED OUTLET	A/D RESISTANT PLATE	R/O RESISTANT COATED	CALKED	COLORED IRON LACQUER COATED	SEMI-CONDUCTOR BUCKET	SECONDARY STRAINER	NICKEL BRONZE	CHROME PLATED	STAINLESS STEEL	POISHED FINISH	6" HIGH SOLID WATER DAM	SATIN FINISH	TRACTOR GRAPE (DUCTILE IRON) PERFORATED ST. STL EXTENSION	FUNNEL TOP	FLAT TOP	USE PONGE	EXTENSION PIECE WEEP HOLES	GRAVEL GUARD	TOP SIZE	ANGLE TYPE	RASSED UP	VANDAL PROOF	ALUMINUM DOME	FLOW CONTROL ASSTY	GENERAL AREA OR LOCATION
A	Z-508-DG-Y		●	●		●											●	●								●						12"ø						MER, ELEVATOR PITs, BOH SPACES, PLENUM DRAINS
B	ZC-100-C-EA-R		●	●		●											●	●								●						12"ø						ROOF DRAINS
C	ZC-100-C-EA-R-W2		●	●		●											●	●								●						12"ø						OVERFLOW ROOF DRAINS
D	Z-415		●	●		●											●	●								●						9"						TOILET ROOM DRAINS
E	ZC-100-C-EA-R		●	●		●											●	●								●						12"ø						AREA DRAINS INSTALLED IN PLAZA TRENCHES
F	ZRB-125-C-EA-BS		●	●		●											●	●								●						8-3/8"ø						PLANTER DRAINS (INSTALLED IN PLAZA LANDSCAPING)
G	Z-533		●	●		●											●	●								●						12"ø			●			PARKING AREA DRAINS (INSTALLED IN GIRDERS)
H	Z-122		●	●		●									●		●	●								●						12"ø						COOLING TOWER DRAIN DOWN - ROOF - PROVIDE SOLID DAM 6" ABOVE FINISHED ROOF SURFACE
I	ZB2-U4-NS		●	●		●											●	●								●						12"ø						LOADING DOCK TRENCH DRAINS
K	Z520-P-Y W/ Z328		●	●		●											●	●								●						9"						SPK. DRY VALVE AREAS / SPK. PRE-ACTION VALVE AREAS
NOTE: THE PLUMBING CONTRACTOR IS RESPONSIBLE FOR VERIFYING ALL DRAIN TYPES & OPTIONS WITH CONSTRUCTION MANAGER AND CONFIRMING THE CONSTRUCTION MATERIALS.																																						
THICKNESS LENGTHS (FOR LINEAR/TRENCH DRAINS) & FINISHED FLOOR ELEVATIONS (I.E. EXTENSION HEIGHTS, GRAVEL STOP HEIGHTS, WATERPROOFING MATERIALS, ETC. PRIOR TO PURCHASING EQUIPMENT).																																						

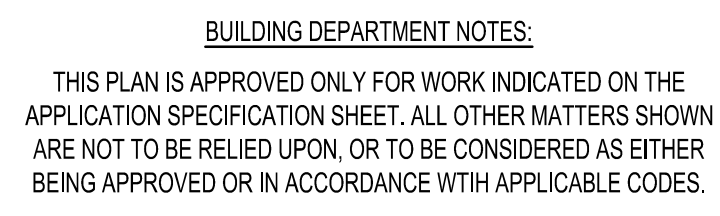PUMP SCHEDULE																								
PUMP DESIGNATIONS	SYSTEM	No. REQUIRED	G.P.M. / SQ.F. each	MAX. TDH/PSI	MECH. SEAL	MANUFACTURER	MODEL NUMBER	STAGES	WATER SHUT OFF HEAD (ft.)	WORKING HEAD (PSI) 11.7'	R.P.M.	VOLTS	PHASE	CYCLE	MANUAL CONT'L	STARTING SWT'L	AUTO CONT'L	PILOT LIGHT	PRESSURE GAUGE RANGE	POWER KWH	CONCRETE PIT	CONTROL	CENTER	LOCATION
DBP-NE-BB-1,2	PNEUMATIC ZONE BOOSTER PUMPS	2	30	140	●	P.P.C.	2TU12A-2	2	●	350	7.5	1750	460	3	60	●	●	●	●	0-100	●	●		
DBP-NE-BB-3,4	HIGH ZONE HOUSE PUMPS	2	253	981	●	P.P.C.	3TU9A-4	4	●	600	150	1750	460	3	60	●	●	●	●	0-500	●	●		
DBP-NE-B-1,2	MID ZONE HOUSE PUMPS	2	100	449	●	P.P.C.	3TU13A-3	3	●	350	50	1750	460	3	60	●	●	●	●	0-300	●	●		
DBP-NE-BB-5,6,7	LOW ZONE HOUSE PUMPS	3	35	123	●	P.P.C.	1.5TU7A-3	3	●	350	5	1750	460	3	60	●	●	●	●	0-100	●	●		
SP-NE-B-1,2	SUMP PUMP SET #1	2	100	45		FLYGT	CP3057 imp 266	1	1	150	2.5	3600	460	3	60	●	●	●	●	0-100	●	●		
SP-NE-B1-1,2	SUMP PUMP SET #2	2	250	80		FLYGT	NP3127 imp 488	1	1	150	10	1750	460	3	60	●	●	●	●	0-100	●	●		
SP-NE-B3-1,2	SUMP PUMP SET #3	2	250	85		FLYGT	NP3152 imp 464	1	1	150	15	1750	460	3	60	●	●	●	●	0-100	●	●		
SEJ-NE-B-1,2	EJECTOR PUMP SET #1	2	500	45		FLYGT	NP3127 imp 438A	1	1	150	10	1750	460	3	60	●	●	●	●	0-100	●	●		
SEJ-NE-B3-1,2	EJECTOR PUMP SET #2	2	125	85		FLYGT	FP3127 imp 244	1	1	150	10	3600	460	3	60	●	●	●	●	0-100	●	●		
ESP-NE-B3-1,2,3	ELEVATOR SUMP PUMP	3	50	84		STANCOR	SV750-DM	1	1	150	7.5	3600	460	1	60	●	●	●	●	0-100	●	●		
LFP-NE-B3-1	STORM WATER FILTER SKID	1	128	42		PEP	OPEL TC 2x4x4 BP2-PUR-V	4	350	2.5	3600	460	3	60	●	●	●	●	0-300	●	●			
MUP-NE-B3-1,2	COOLING TOWER MAKEUP PUMPS	2	253	1109	●	P.P.C.	3TU9A-4	2	●	600	200	3600	460	3	60	●	●	●	●	0-500	●	●		
IP-NE-B3-1,2	IRRIGATION PUMPS	2	70	243	●	P.P.C.	2TU12A-2	2	●	350	15	1750	460	3	60	●	●	●	●	0-100	●	●		
NGP-NE-6B-1,2	NATURAL GAS BOOSTER PUMP	2	20,000	15		ECLIPSE	AE0-5-5-20-15-35-SEQ-COM-14	1	150	35	3600	460	3	60	●	●	●	●	0-30	●	●			
HWC-NE-B-1,2	HOT WATER CIRCULATION PUMP	2	10	15		B&G	SERIES 60	1	175	1/2	1750	460	3	60	●	●	●	●	0-100	●	●			

P.P.C. = Peerless Pump Co. (Package Pump Plant); B&G = BELL & GOSSETT

[illegible]

NON-PRESSURE VESSELS & PITS						
DESIGNATION	NO REQUIRED	LOCATION	GAL/TANK	SIZE	MATERIAL	
COMBO HOUSE TANKS	2	ROOF	19,000	18'x12'H	WOOD	
SUMP PIT #1	1	B1 LEVEL	-----	5'x5'x9'D	CONCRETE	
SUMP PIT #2	1	B1 LEVEL	-----	5'x5'x9'D	CONCRETE	
SUMP PIT #3	1	B3 LEVEL	-----	5'x5'x9'D	CONCRETE	
EJECTOR PIT #1	1	B LEVEL	-----	5'x5'x9'D	CONCRETE	
EJECTOR PIT #2	1	B3 LEVEL	-----	5'x5'x9'D	CONCRETE	
ELEVATOR SUMP PITS	3	B3 LEVEL	-----	2'x2'x2'D	CONCRETE	
FIRE RESERVE TANKS	2	ROOF	15,000	20'x7'6"H	WOOD	
FIRE RESERVE TANKS	2	54TH FLOOR	15,000	10'8"x52'8"x13'6"H	CONCRETE	
COMBO HOUSE TANKS	2	32ND FLOOR	17,500	13'9"x59'6"x9'10"H	CONCRETE	
STORM DETENTION TANK	1	B3/82 LEVEL	-----	-----	CONCRETE	
SAND INTERCEPTOR	1	B LEVEL	-----	2'6"x5'x9'D	CONCRETE	
SAND INTERCEPTOR	1	B3 LEVEL	-----	2'6"x5'x9'D	CONCRETE	

FIXTURE CONNECTION SCHEDULE						
FIXTURES	S	W	V	HW	CW	RRM 1/2"
WALL HUNG FLUSH VALVE WATER CLOSET	4"	--	2"	--	1 1/2"	1" - 6"
SIPHON JET URINALS	--	2"	2"	--	1"	1" - 5"
LAVATORIES	--	2"	2"	3/4"	3/4"	2" - 10"
SLOP SINKS	--	3"	2"	3/4"	3/4"	--
DRINKING FOUNTAINS	--	2"	2"	--	1/2"	3" - 4"
SINKS	--	2"	2"	3/4"	3/4"	-- 4"

PRESSURE VESSELS AND HEATERS															
EQUIPMENT TAG	EQUIPMENT	NO. REQUIRED	MODEL	STORAGE WATER TEMP. (°F)	SIZE (OAL.S.)	SIZE	W.P.P.	TEST PRESSURE	SHELL THICKNESS	HEAD THICKNESS	BTU/HOUR/HEATER	AW	TEMP. RISE (°F)	PEAK FLOWRATE (GPM)	NOTES
DWH-NE-6 TO 67-1,2	ELECTRIC HOT WATER HEATER	140	HUBBEL 20 GAL.	140°	----	3"x5"	150	300			—	5	100°	—	(1) IN EACH CORE TOILET
DWH-NE-6 TO 67-3	ELECTRIC HOT WATER HEATER	70	HUBBEL 6 GAL.	140°	----	15"Dx18"H	150	300			—	1.5	100°	—	(1) IN EACH JANITOR'S CLOSET
DWH-NE-B-1,2	STEAM-FIRED HOT WATER HEATER	2	P.K. 06 S	—	----	—	150	300			750,000	—	100°	15	SERVING STREET PRESSURE ZONE
PT-NE-B-1	PNEUMATIC TANK	1	AMTROL WX-457C	60°	528	48x96H	125	225			—	—	—	—	B LEVEL
PT-NE-68-1	PNEUMATIC TANK	1	AMTROL WX-457C	60°	528	48x96H	125	225			—	—	—	—	68TH FLOOR (MER)
P.K.: PATTERSON KELLEY (PROVIDE A LEAK DETECTION SYSTEM FOR THE WATER HEATERS TO BE PLACED ON FLOOR BENEATH WATER HEATERS. CONNECT LEAK DETECTION SYSTEM TO BMS.)															
NOTE: PROVIDE HOLBY TEMPERING VALVE AT EACH SET OF H.W. HEATERS															

PLUMBING FIXTURES SCHEDULE							
ID#	FIXTURE TYPE	LOCATION	SIZE	MANUFACTURER	MODEL #	FAUCET / FLUSHOMETER / VALVE	NOTES
P-1	TOILET - PUBLIC	CORE TOILET ROOMS	1.28 GPF	AMERICAN STANDARD	AFWALL 3351.001	TOTO TETILN32	WALL HUNG; TOP SPUD; ECOPOWER
P-1A	TOILET - PUBLIC	CORE TOILET ROOMS	1.28 GPF	AMERICAN STANDARD	AFWALL 3351.001	TOTO TETILN32	WALL HUNG; TOP SPUD; ECOPOWER; MOUNTED AT ADA HEIGHT
P-2	URINAL - PUBLIC	CORE TOILET ROOMS	1/8 GPF	AMERICAN STANDARD	WASHROOM FLOWISE 6590.001	TOTO TETILUN12	TOP SPUD; EXPOSED AUTOMATIC FLUSH VALVE; ECOPOWER
P-2A	URINAL - PUBLIC	CORE TOILET ROOMS	1/8 GPF	AMERICAN STANDARD	WASHROOM FLOWISE 6590.001	TOTO TETILUN12	TOP SPUD; EXPOSED AUTOMATIC FLUSH VALVE; ECOPOWER; MOUNTED AT ADA HEIGHT
P-3	LAVATORY - PUBLIC	CORE TOILET ROOMS	0.17 GPC	AMERICAN STANDARD	OVALYN 9482.000	TOTO TEL5G5G10 W/ TH559EDV432	SELF-CLOSING; UNDERCOUNTER MOUNT SINK; THERMAL MIXING FAUCET; LAMINAR FLOW; 1 GPM W/ 10 SEC CYCLE
P-3A	LAVATORY - PUBLIC	CORE TOILET ROOMS	0.17 GPC	AMERICAN STANDARD	OVALYN 9482.000	TOTO TEL5G5G10 W/ TH559EDV432	SELF-CLOSING; UNDERCOUNTER MOUNT SINK; THERMAL MIXING FAUCET; MOUNTED AT ADA HEIGHT; LAMINAR FLOW; 1 GPM W/ 10 SEC CYCLE
P-4	MOP SINK	JANITOR CLOSET	—	JUST MANUFACTURING	C-2523	FIAT 830-AA	STAINLESS STEEL
P-7	SHOWER	LOCKER ROOMS	1.5 GPM	MOEN	52718EP15	MOEN 8370 MIXING VALVE	FIXED SHOWERHEAD
P-7A	SHOWER	LOCKER ROOMS ADA STALL BOH ADA LOCATIONS	1.5 GPM	MOEN	52236GBM15	MOEN 8370 MIXING VALVE	MOUNTED AT ADA HEIGHT
P-8	PANTRY SINK	BREAK ROOMS	1.5 GPM	ELKAY	LR2022	ELKAY LKE4121	DROP IN SINK; SINGLE LEVER MANUAL FAUCET

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Date: 15 NOV 2013	
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		21 00 - Fire Protection Sheet Matrix		Issue Dates	
Sheet Number	Sheet Name	DD	PROGRESS	Issued for Foundation Permit	
000 - Cover Sheet, General Notes, Legends					
FP-001	FIRE PROTECTION DRAWING INDEX		•		•
FP-002	FIRE PROTECTION ABBREVIATIONS AND SYMBOLS LIST		•		•
100 - Floor Plans					
FP-099B1-A	FIRE PROTECTION CELLAR B1 FLOOR PLAN - PART A		•		•
FP-100B-A	FIRE PROTECTION CELLAR B FLOOR PLAN - PART A		•		•
FP-100B-B	FIRE PROTECTION CELLAR B FLOOR PLAN - PART B		•		•
FP-101-A	FIRE PROTECTION GROUND FLOOR PLAN - PART A		•		•
FP-101-B	FIRE PROTECTION GROUND FLOOR PLAN - PART B		•		•
FP-102	FIRE PROTECTION LEVEL 2 FLOOR PLAN - RETAIL		•		•
FP-103	FIRE PROTECTION LEVEL 3 FLOOR PLAN - STAIR TRANSFER		•		•
FP-104	FIRE PROTECTION LEVEL 4 FLOOR PLAN - MECHANICAL		•		•
FP-105	FIRE PROTECTION LEVELS 5 FLOOR PLAN - MECHANICAL MEZZANINE		•		•
FP-106	FIRE PROTECTION LEVEL 6-16 FLOOR PLAN - TYPICAL LOW-RISE		•		•
FP-117	FIRE PROTECTION LEVEL 17 FLOOR PLAN - LOW-RISE		•		•
FP-118	FIRE PROTECTION LEVEL 18 FLOOR PLAN - LOW-RISE OVERRUN		•		•
FP-119	FIRE PROTECTION LEVEL 19-20 FLOOR PLAN - LOW-RISE EMR		•		•
FP-121	FIRE PROTECTION LEVEL 21-27 FLOOR PLAN - TYPICAL LOW-RISE		•		•
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FP-130	FIRE PROTECTION LEVEL 30 FLOOR PLAN - MID-RISE EMR		•		•
FP-131	FIRE PROTECTION LEVEL 31 FLOOR PLAN - MID-RISE PUMP ROOM		•		•
FP-132	FIRE PROTECTION LEVEL 32 FLOOR PLAN - MID-RISE WATER TANK		•		•
FP-133	FIRE PROTECTION LEVEL 33-38 FLOOR PLAN - TYPICAL MID-RISE		•		•
FP-139	FIRE PROTECTION LEVEL 39 FLOOR PLAN - MID-RISE		•		•
FP-140	FIRE PROTECTION LEVEL 40-41 FLOOR PLAN - MID-RISE OVERRUN		•		•
FP-142	FIRE PROTECTION LEVEL 42 FLOOR PLAN - MID-RISE EMR		•		•
FP-143	FIRE PROTECTION LEVEL 43-48 FLOOR PLAN - TYPICAL MID-RISE		•		•
FP-149	FIRE PROTECTION LEVEL 49 FLOOR PLAN - MID-RISE & HIGH-RISE		•		•
FP-150	FIRE PROTECTION LEVEL 50-51 FLOOR PLAN - HIGH-RISE OVERRUN		•		•
FP-152	FIRE PROTECTION LEVEL 52 FLOOR PLAN - HIGH-RISE EMR		•		•
FP-153	FIRE PROTECTION LEVEL 53 FLOOR PLAN - HIGH-RISE PUMP ROOM		•		•
FP-154	FIRE PROTECTION LEVEL 54 FLOOR PLAN - HIGH-RISE WATER TANK		•		•
FP-155	FIRE PROTECTION LEVEL 55 FLOOR PLAN - HIGH-RISE		•		•
FP-156	FIRE PROTECTION LEVEL 56 FLOOR PLAN - HIGH-RISE		•		•
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FP-159	FIRE PROTECTION LEVEL 59 FLOOR PLAN - HIGH-RISE		•		•
FP-160	FIRE PROTECTION LEVEL 60-61 FLOOR PLAN - HIGH-RISE OVERRUN		•		•
FP-162	FIRE PROTECTION LEVEL 62 FLOOR PLAN - HIGH-RISE EMR		•		•
FP-163	FIRE PROTECTION LEVEL 63 FLOOR PLAN - HIGH-RISE		•		•
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FP-168	FIRE PROTECTION LEVEL 68 FLOOR PLAN - MECHANICAL		•		•
FP-169	FIRE PROTECTION LEVEL 69 FLOOR PLAN - MECHANICAL MEZZANINE		•		•
FP-170	FIRE PROTECTION ROOF PLAN - MECHANICAL PENTHOUSE		•		•
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FP-199B1-A	FIRE PROTECTION CELLAR B1 FLOOR SPRINKLER PLAN - PART A		•		•
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FP-202	FIRE PROTECTION LEVEL 2 FLOOR SPRINKLER PLAN - RETAIL		•		•
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FP-206	FIRE PROTECTION LEVEL 6-27 FLOOR SPRINKLER PLAN - TYPICAL OFFICE FLOOR		•		•
FP-228	FIRE PROTECTION LEVEL 28-48 FLOOR SPRINKLER PLAN - TYPICAL OFFICE FLOOR		•		•
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FP-260	FIRE PROTECTION LEVEL 68 FLOOR SPRINKLER PLAN - MECHANICAL MEZZANINE		•		•
FP-269	FIRE PROTECTION ROOF SPRINKLER PLAN - MECHANICAL PENTHOUSE		•		•
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FP-400	FIRE PROTECTION RISER DIAGRAM SHEET 1		•		•
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500 - Schedules					

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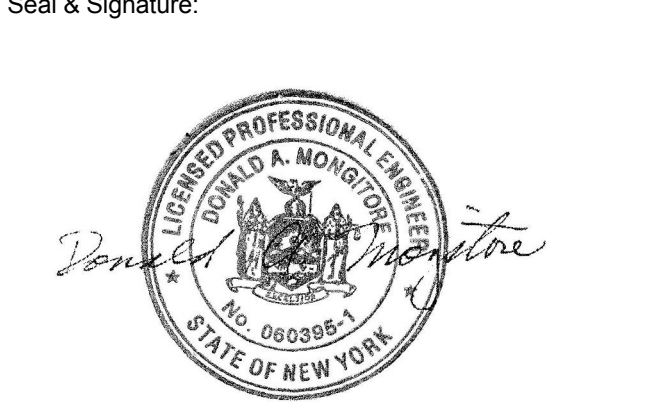
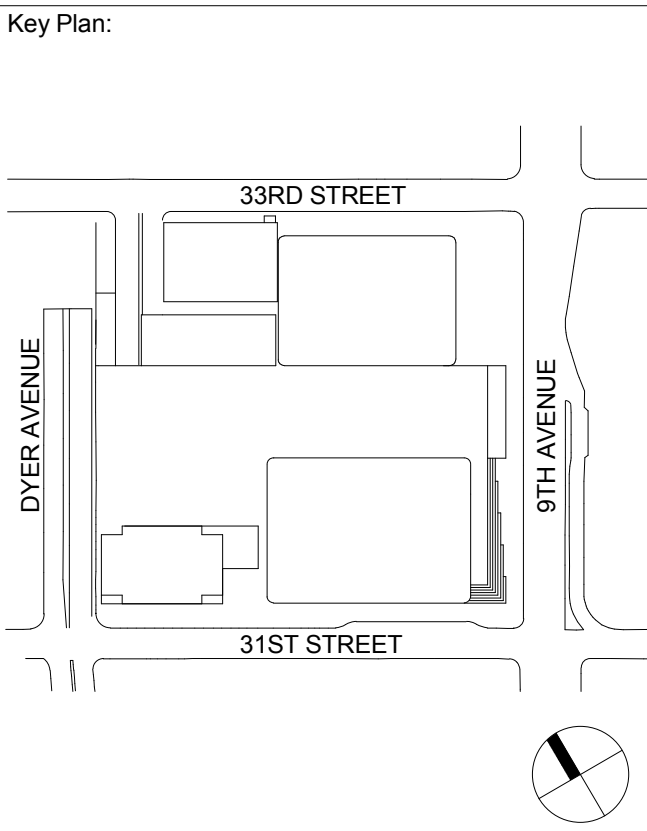
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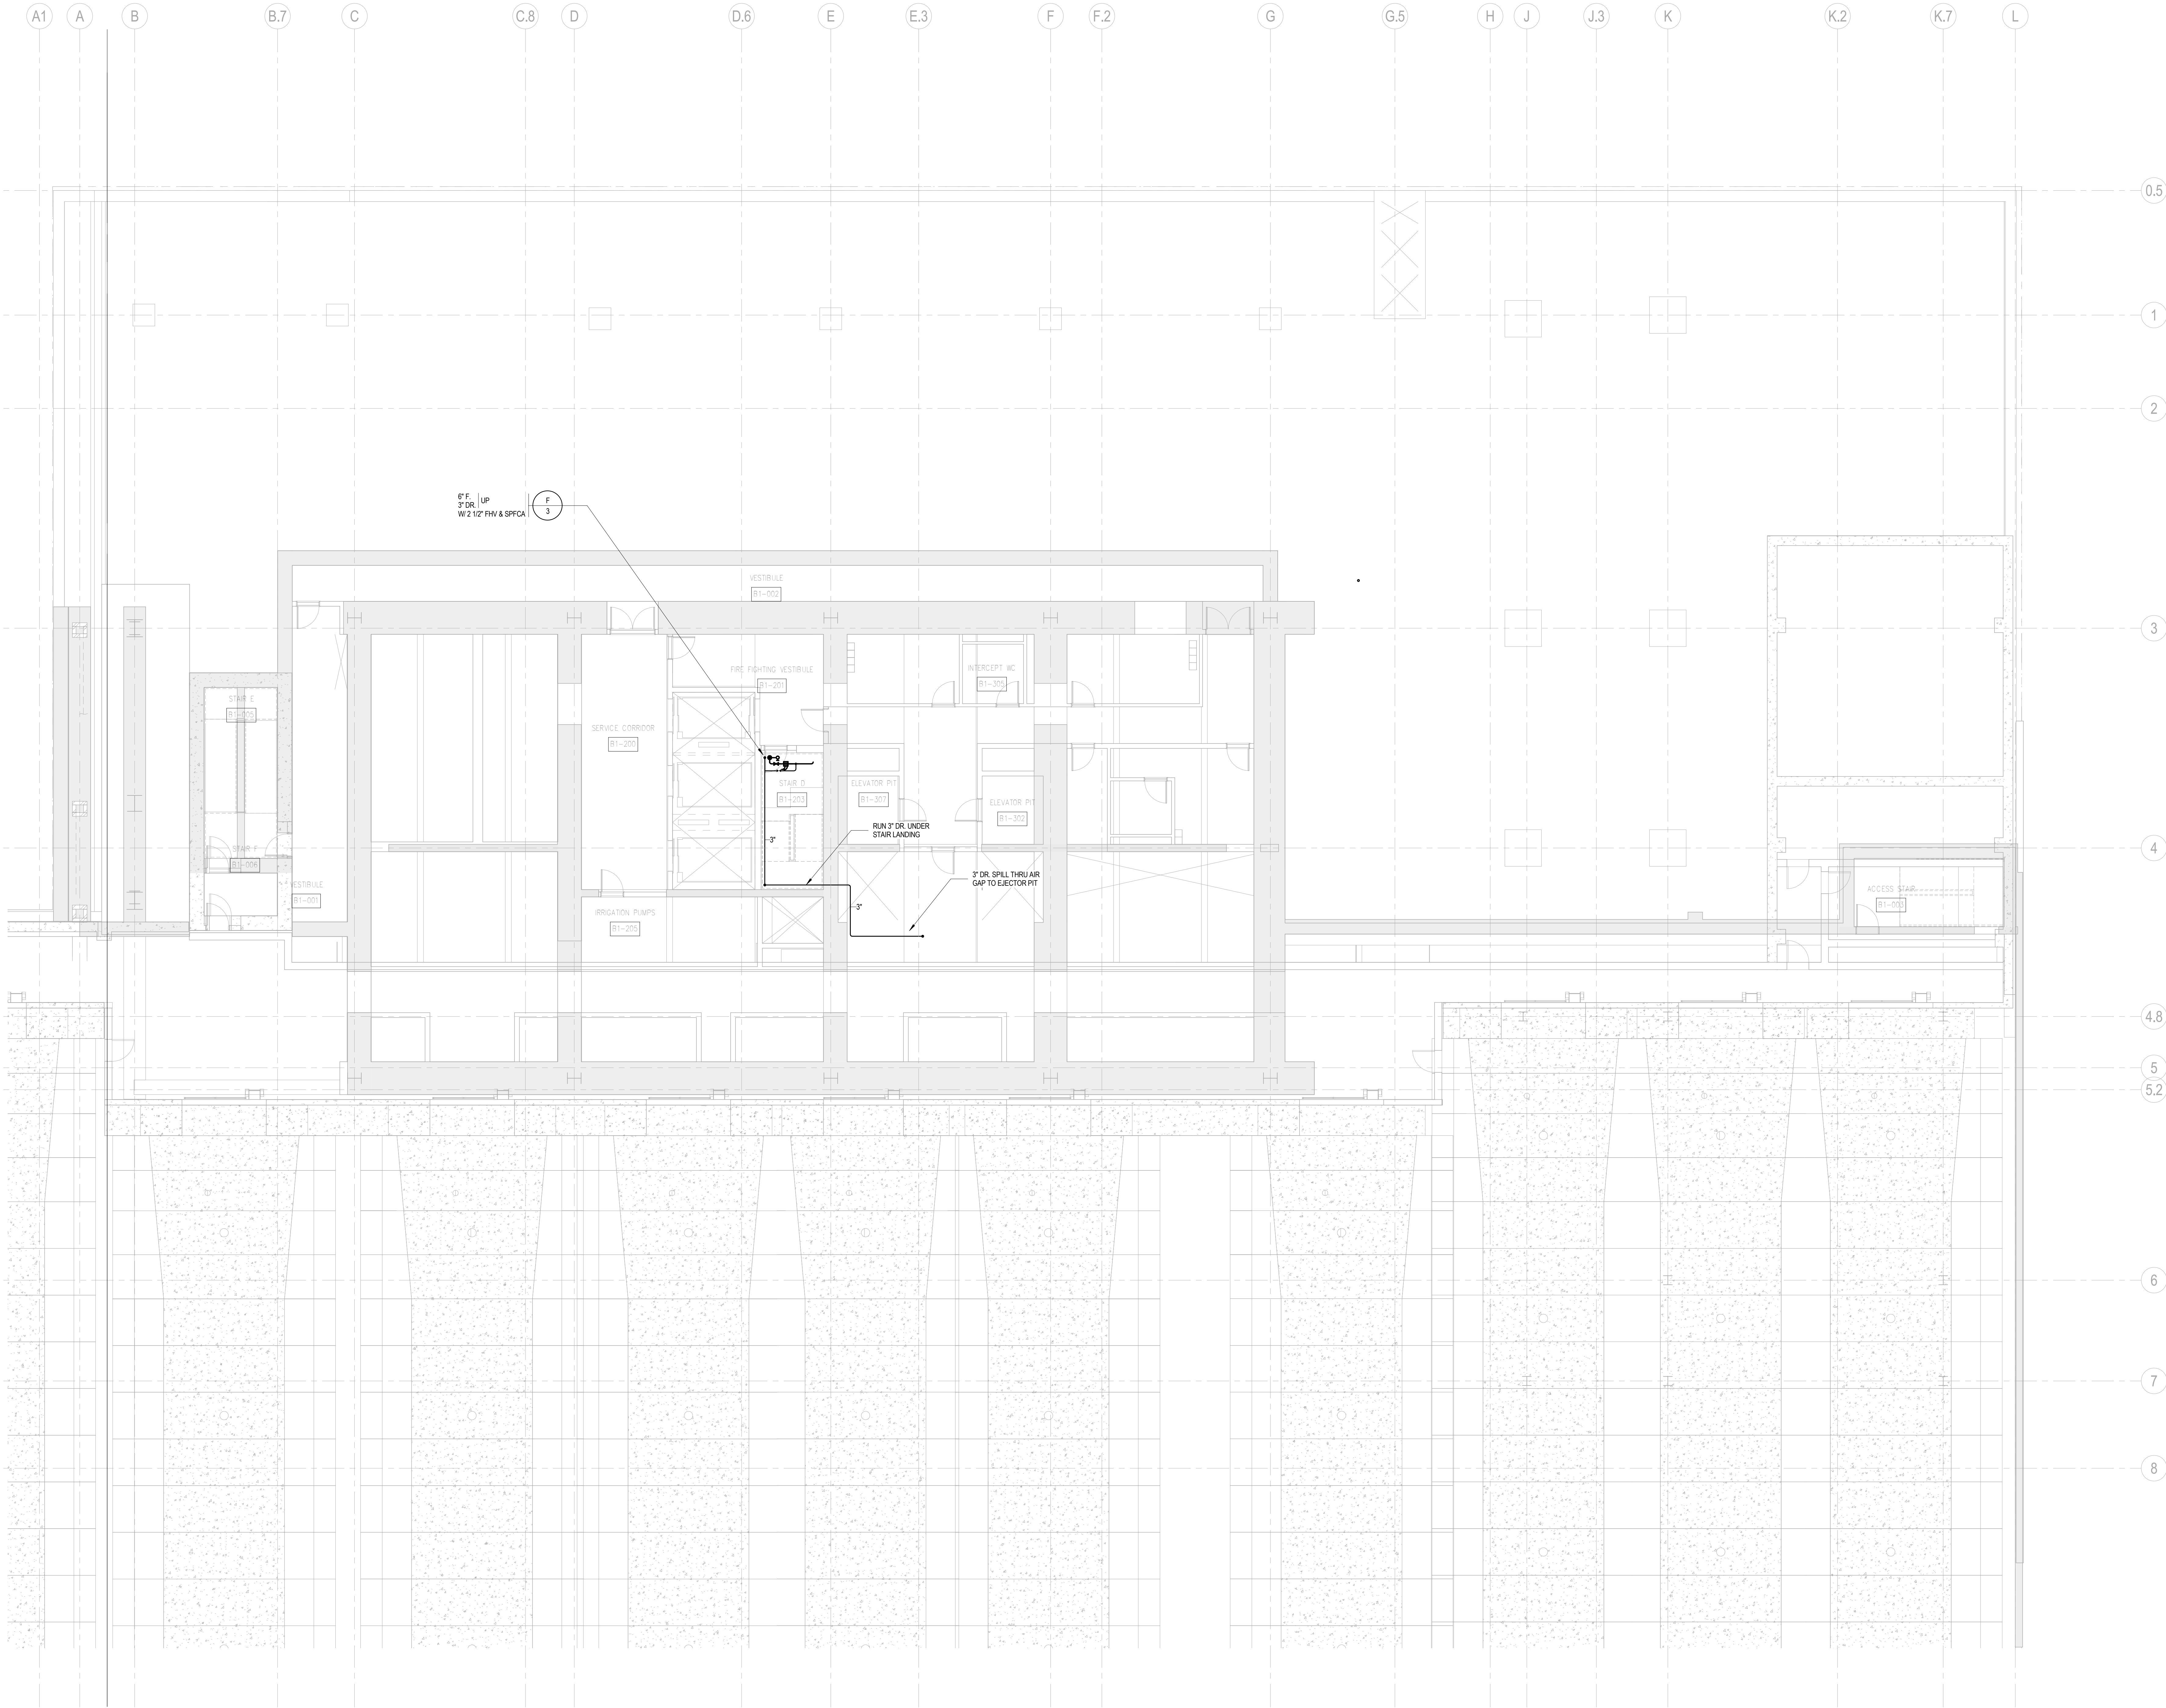
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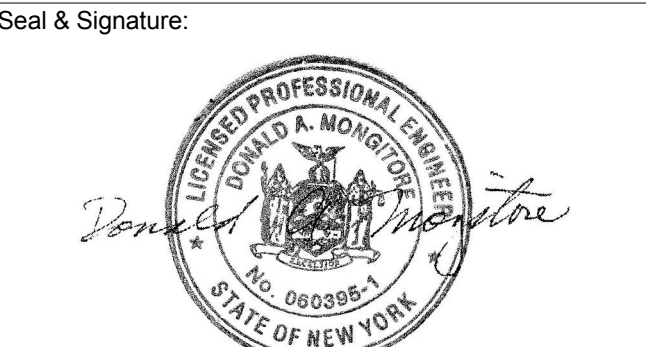
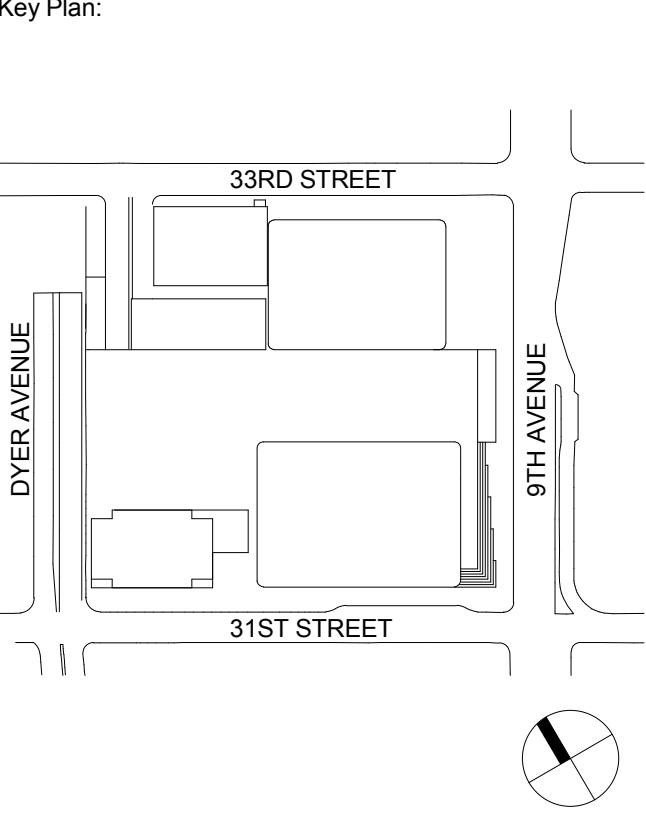


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3	15 NOV 2013	ISSUED FOR 0% PROGRESS PERMIT
2	12 JUL 2013	ISSUED FOR 50% DESIGN DEVELOPMENT
1	19 MAR 2012	ISSUED FOR RECONCILIATION

FIRE PROTECTION CELLAR B1 FLOOR PLAN - PART A

Project No.: 14330.A.000	Sheet No.: FP-099B1-A
Date: 20 JUN 2014	B-SCAN Sheet No.: FP-097.00
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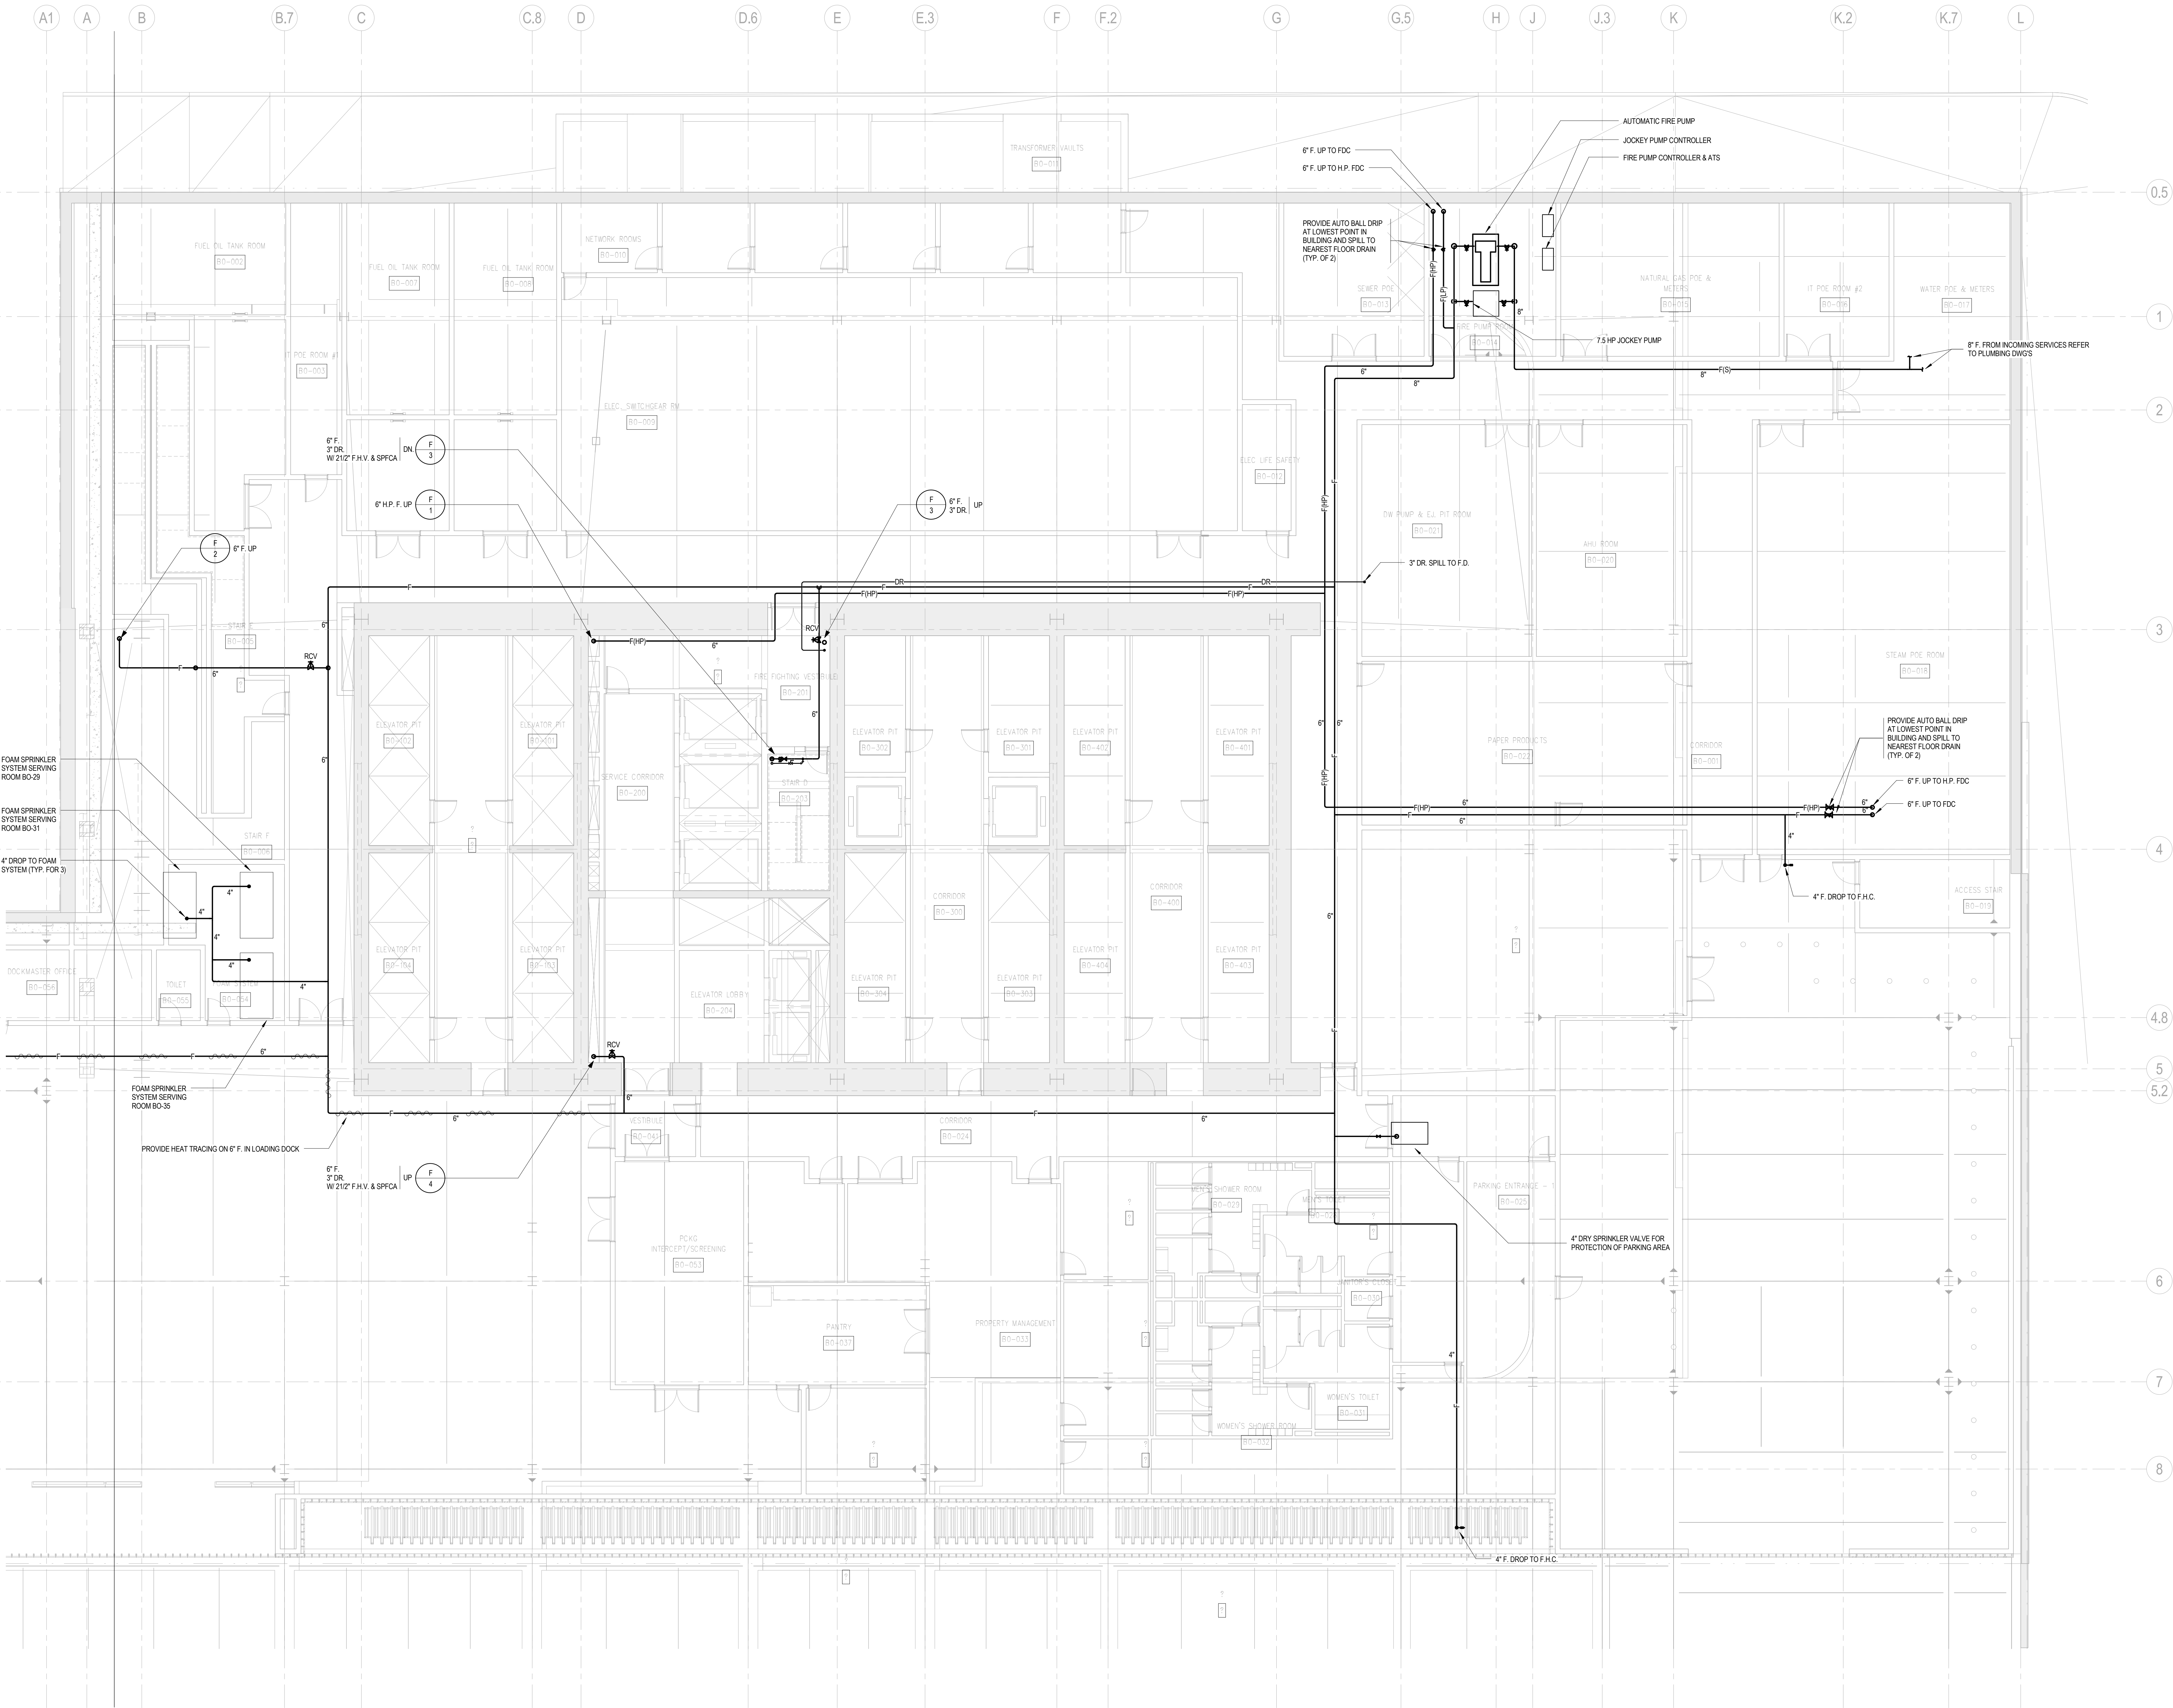



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FIRE
PROTECTION
CELLAR B FLOOR
PLAN - PART A

Project No.: 14830-A-000	Sheet No.: FP-100B-A
Date: 20 JUN 2014	B-SCAN Sheet No.: FP-098.00
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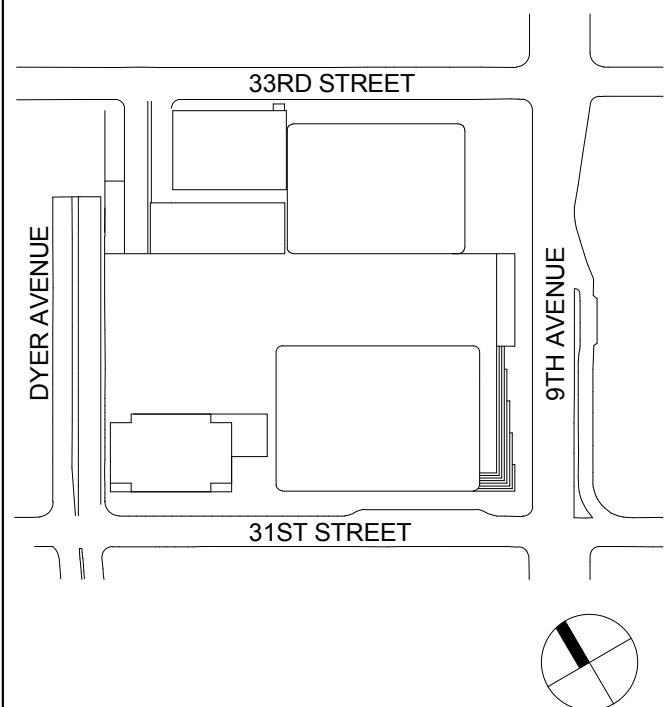
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FIRE
PROTECTION
CELLAR B FLOOR
PLAN - PART B

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Date: 20 JUN 2014
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File No.: FP-100B-B

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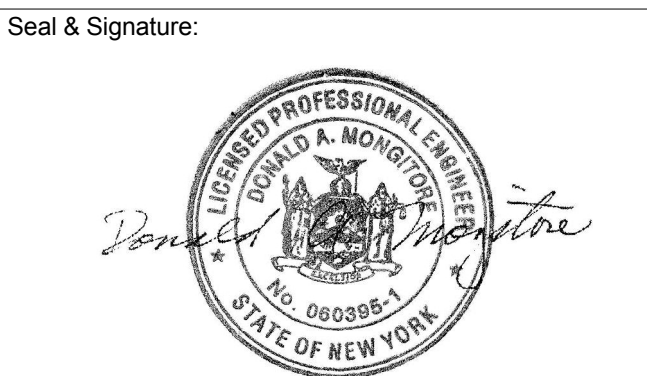
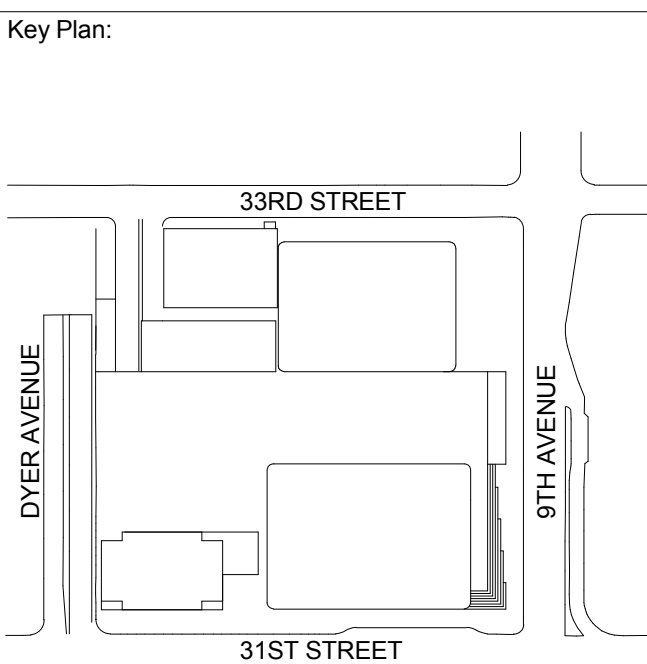
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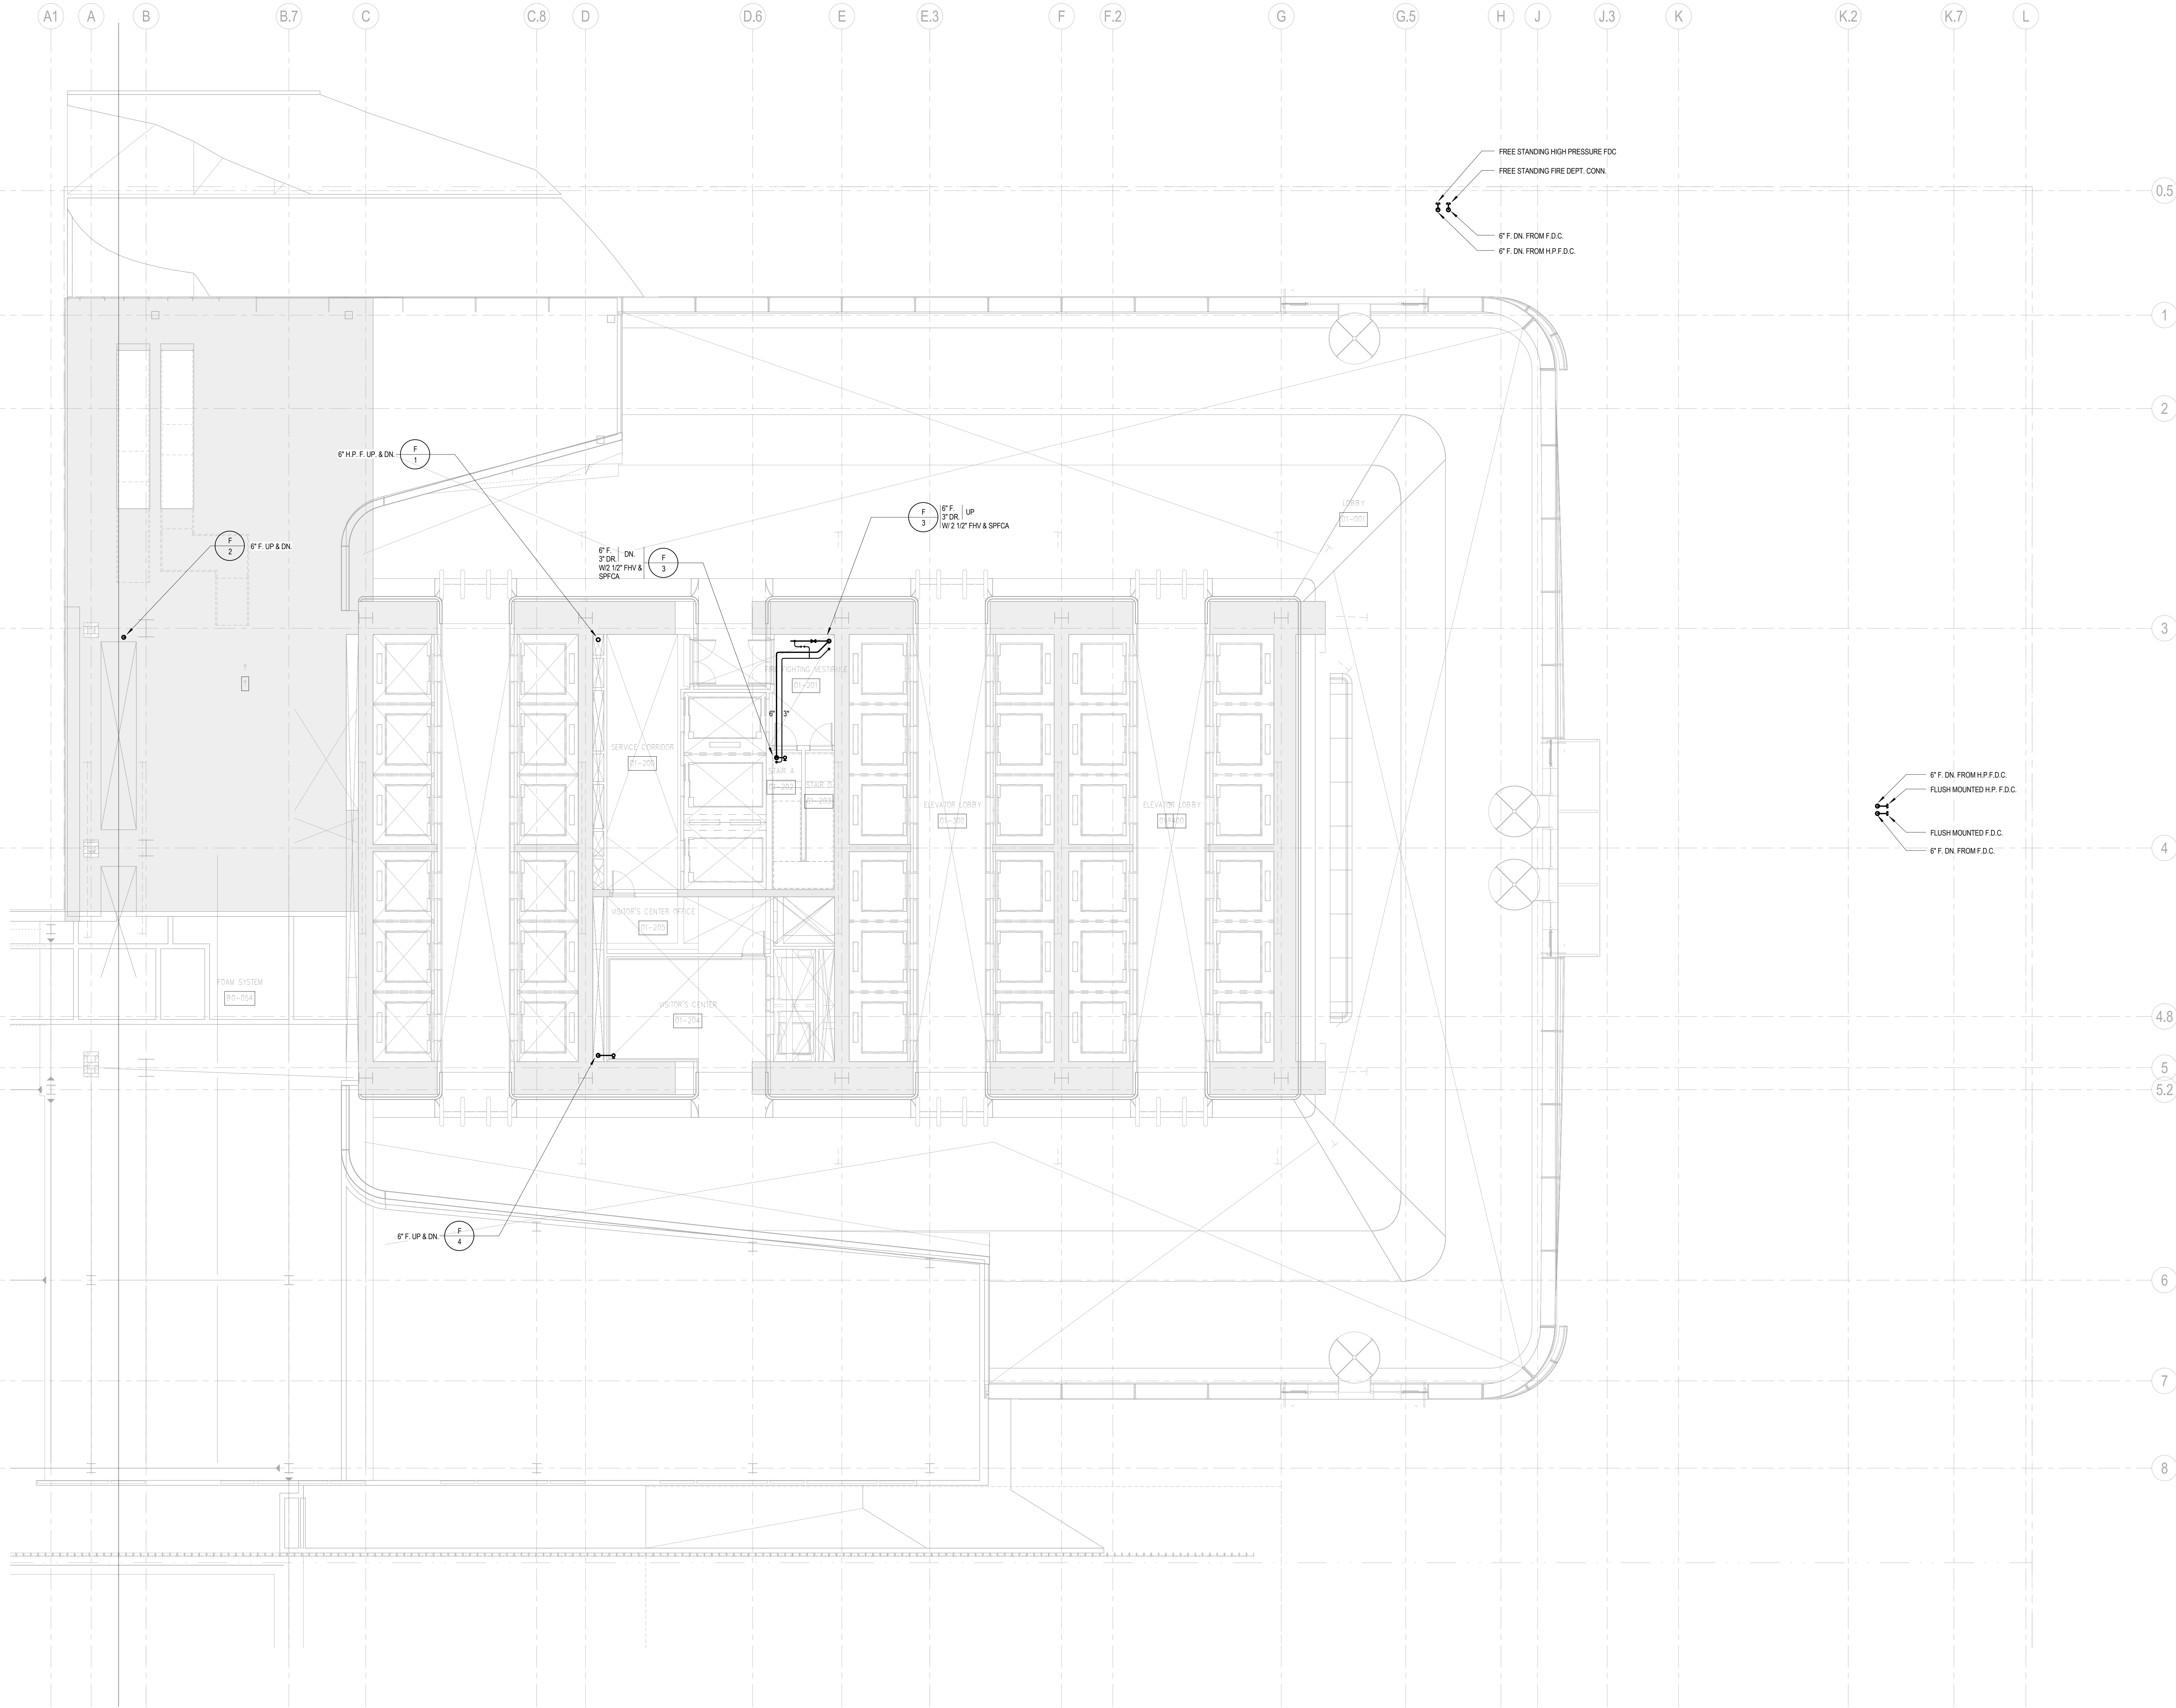



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**FIRE
PROTECTION
GROUND FLOOR
PLAN - PART A**
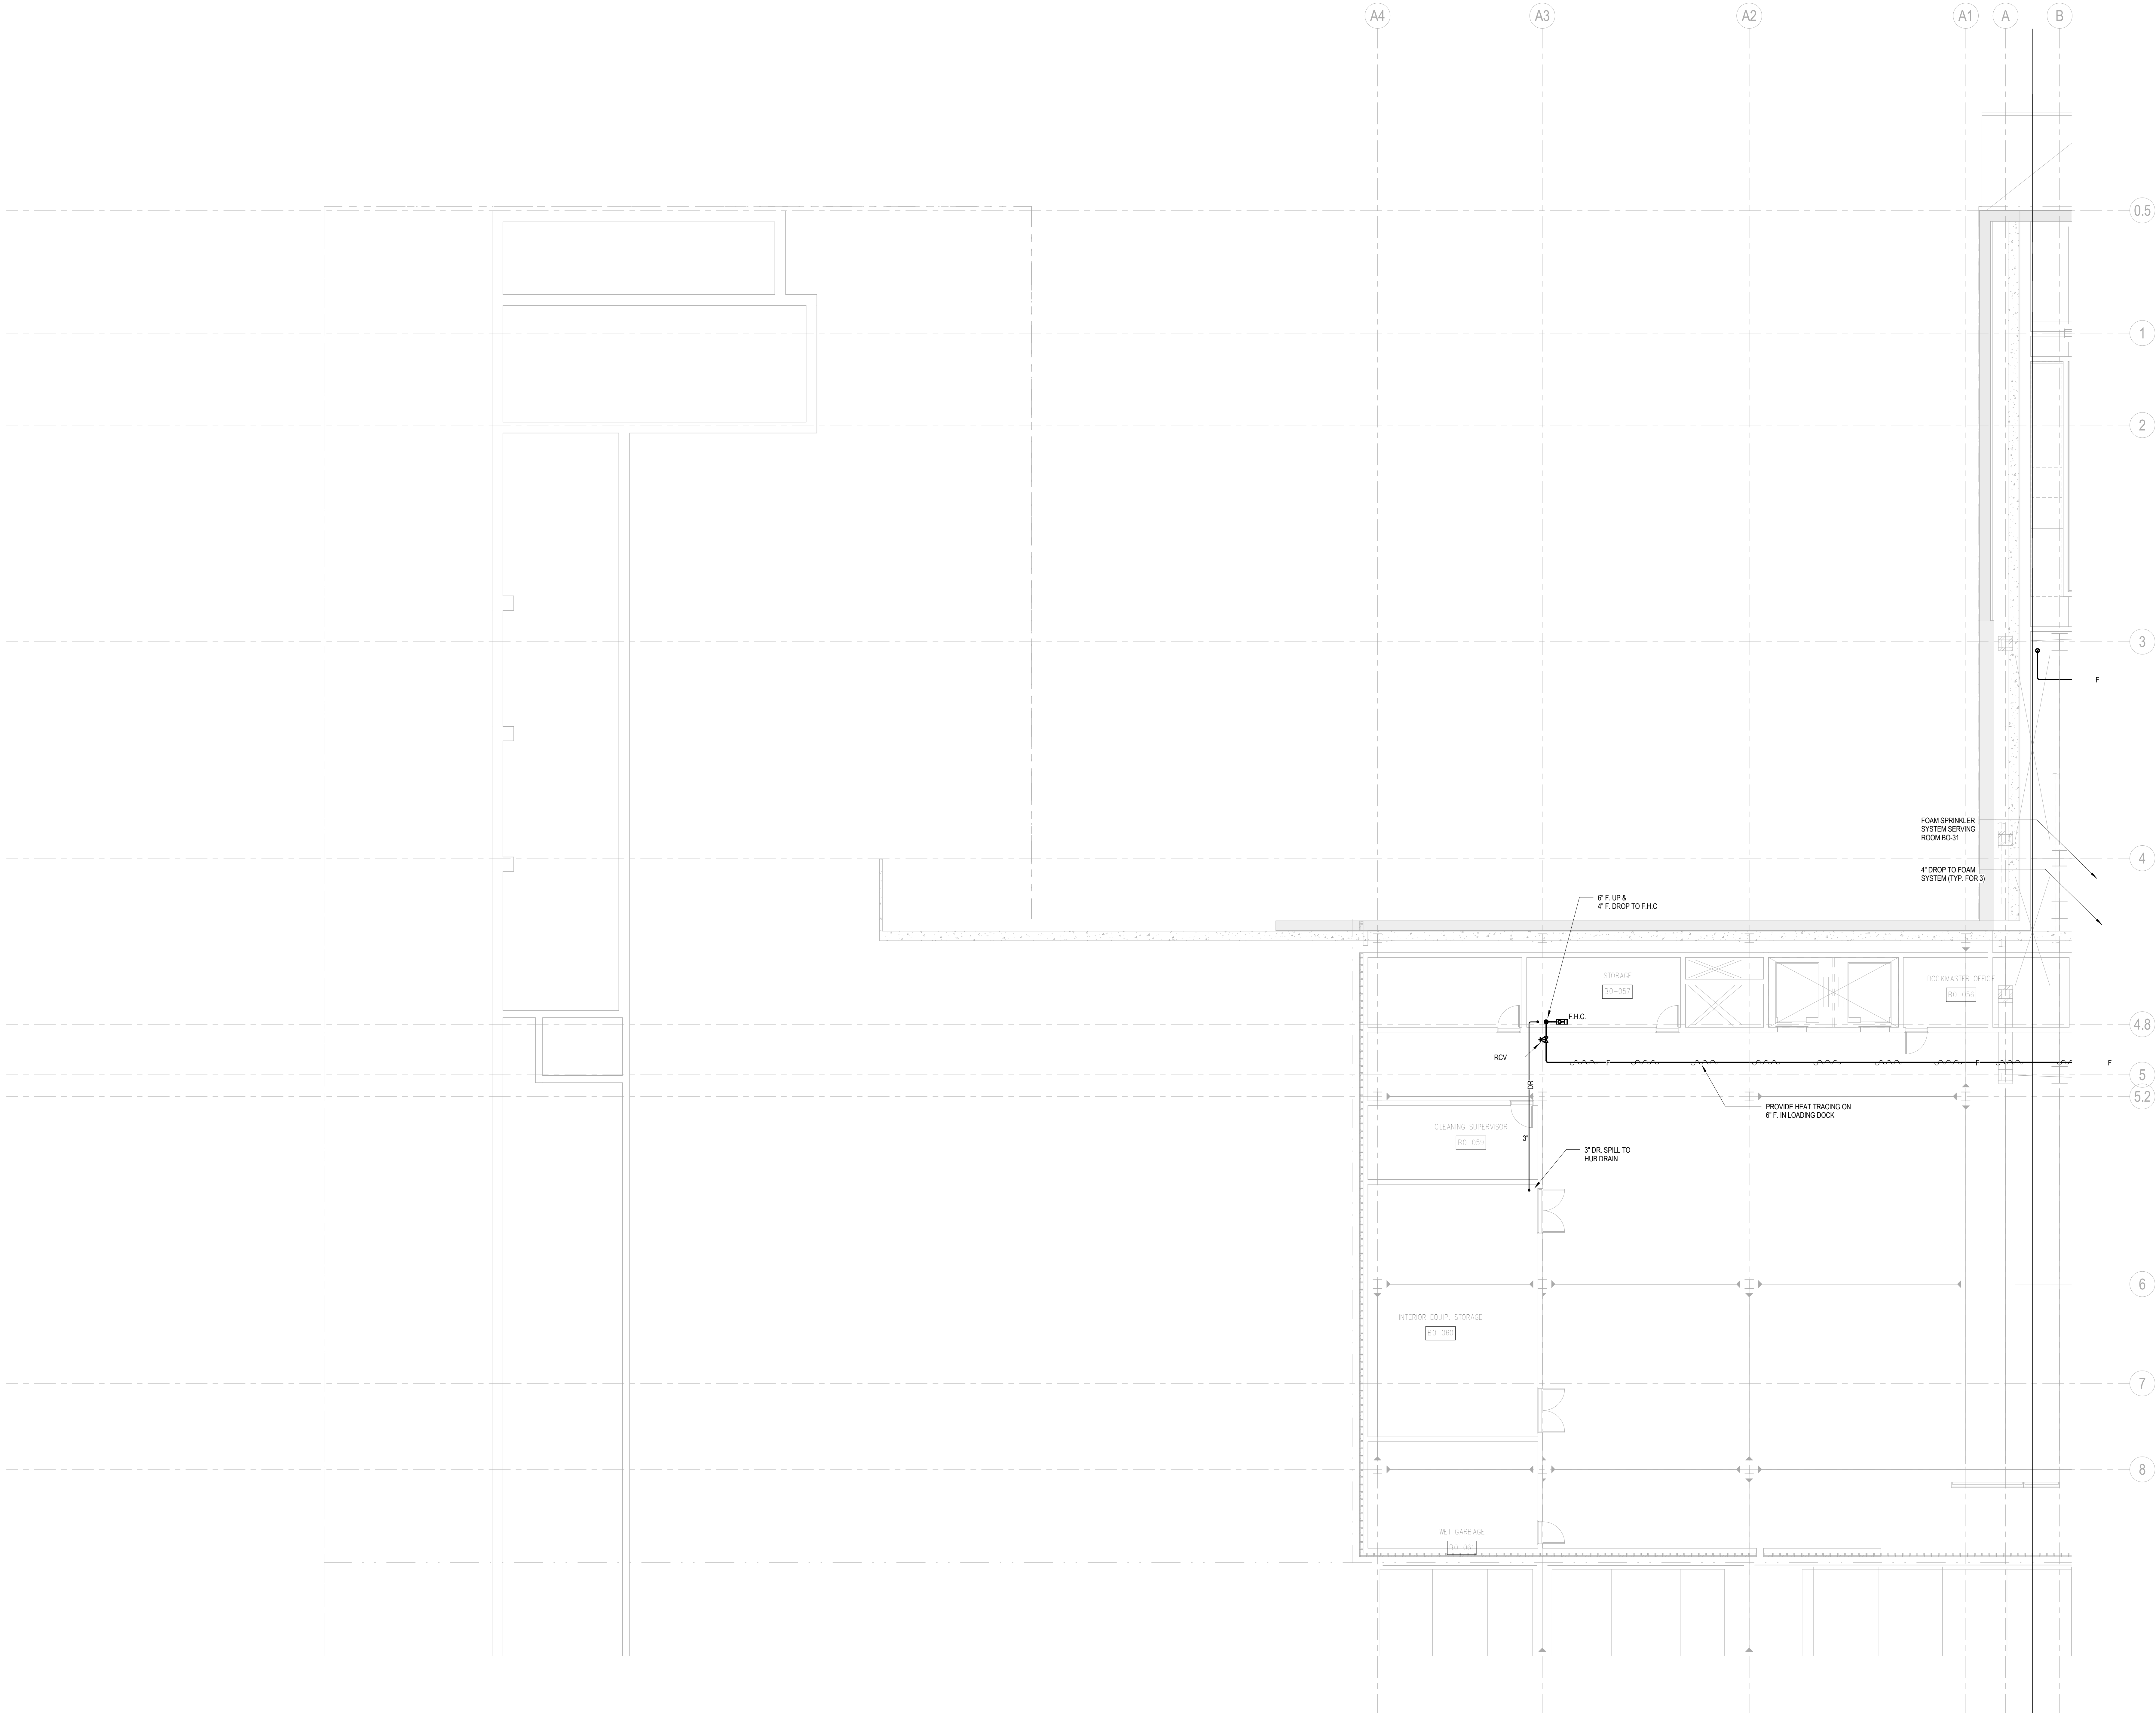
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Date: 20 JUN 2014	B-SCAN Sheet No.: FP-100.00
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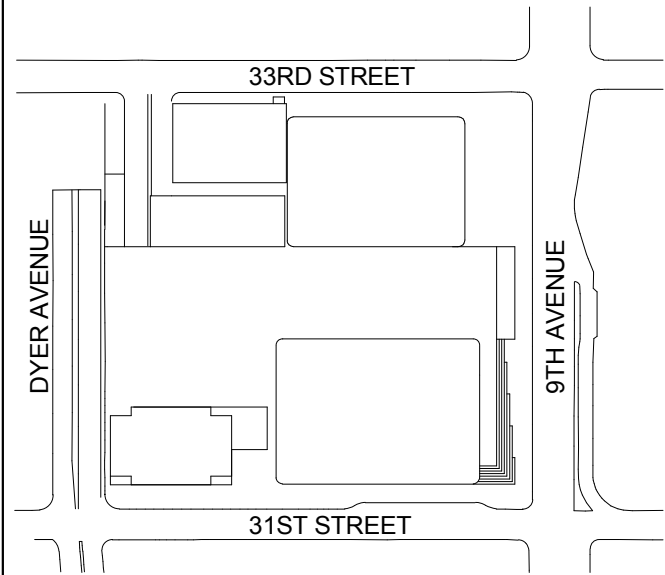
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**FIRE
PROTECTION
GROUND FLOOR
PLAN - PART B**

Project No.: 14830-A-000	Sheet No.: FP-101-B
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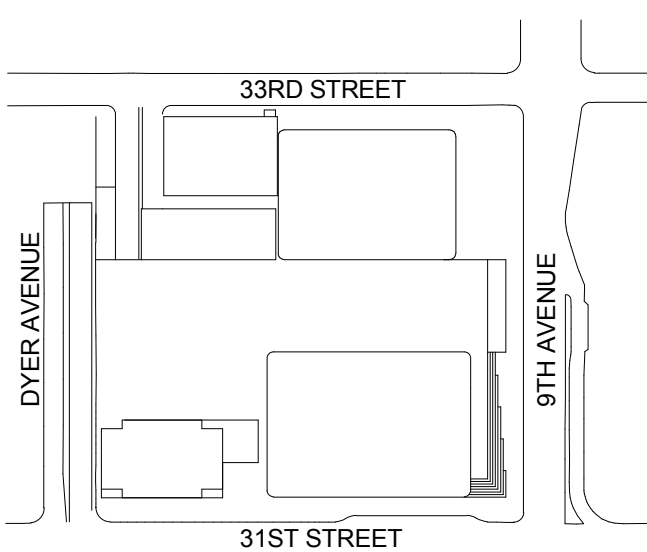
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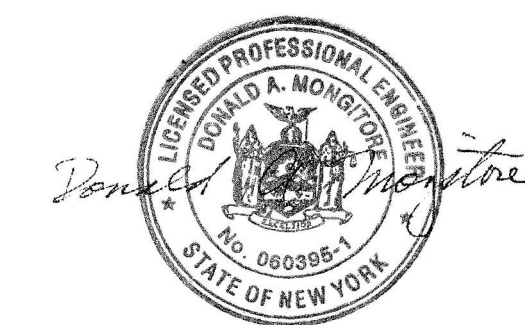
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**FIRE
PROTECTION
LEVEL 2 FLOOR
PLAN - RETAIL**

Project No.:
14830-A-000

Date:
20 JUN 2014
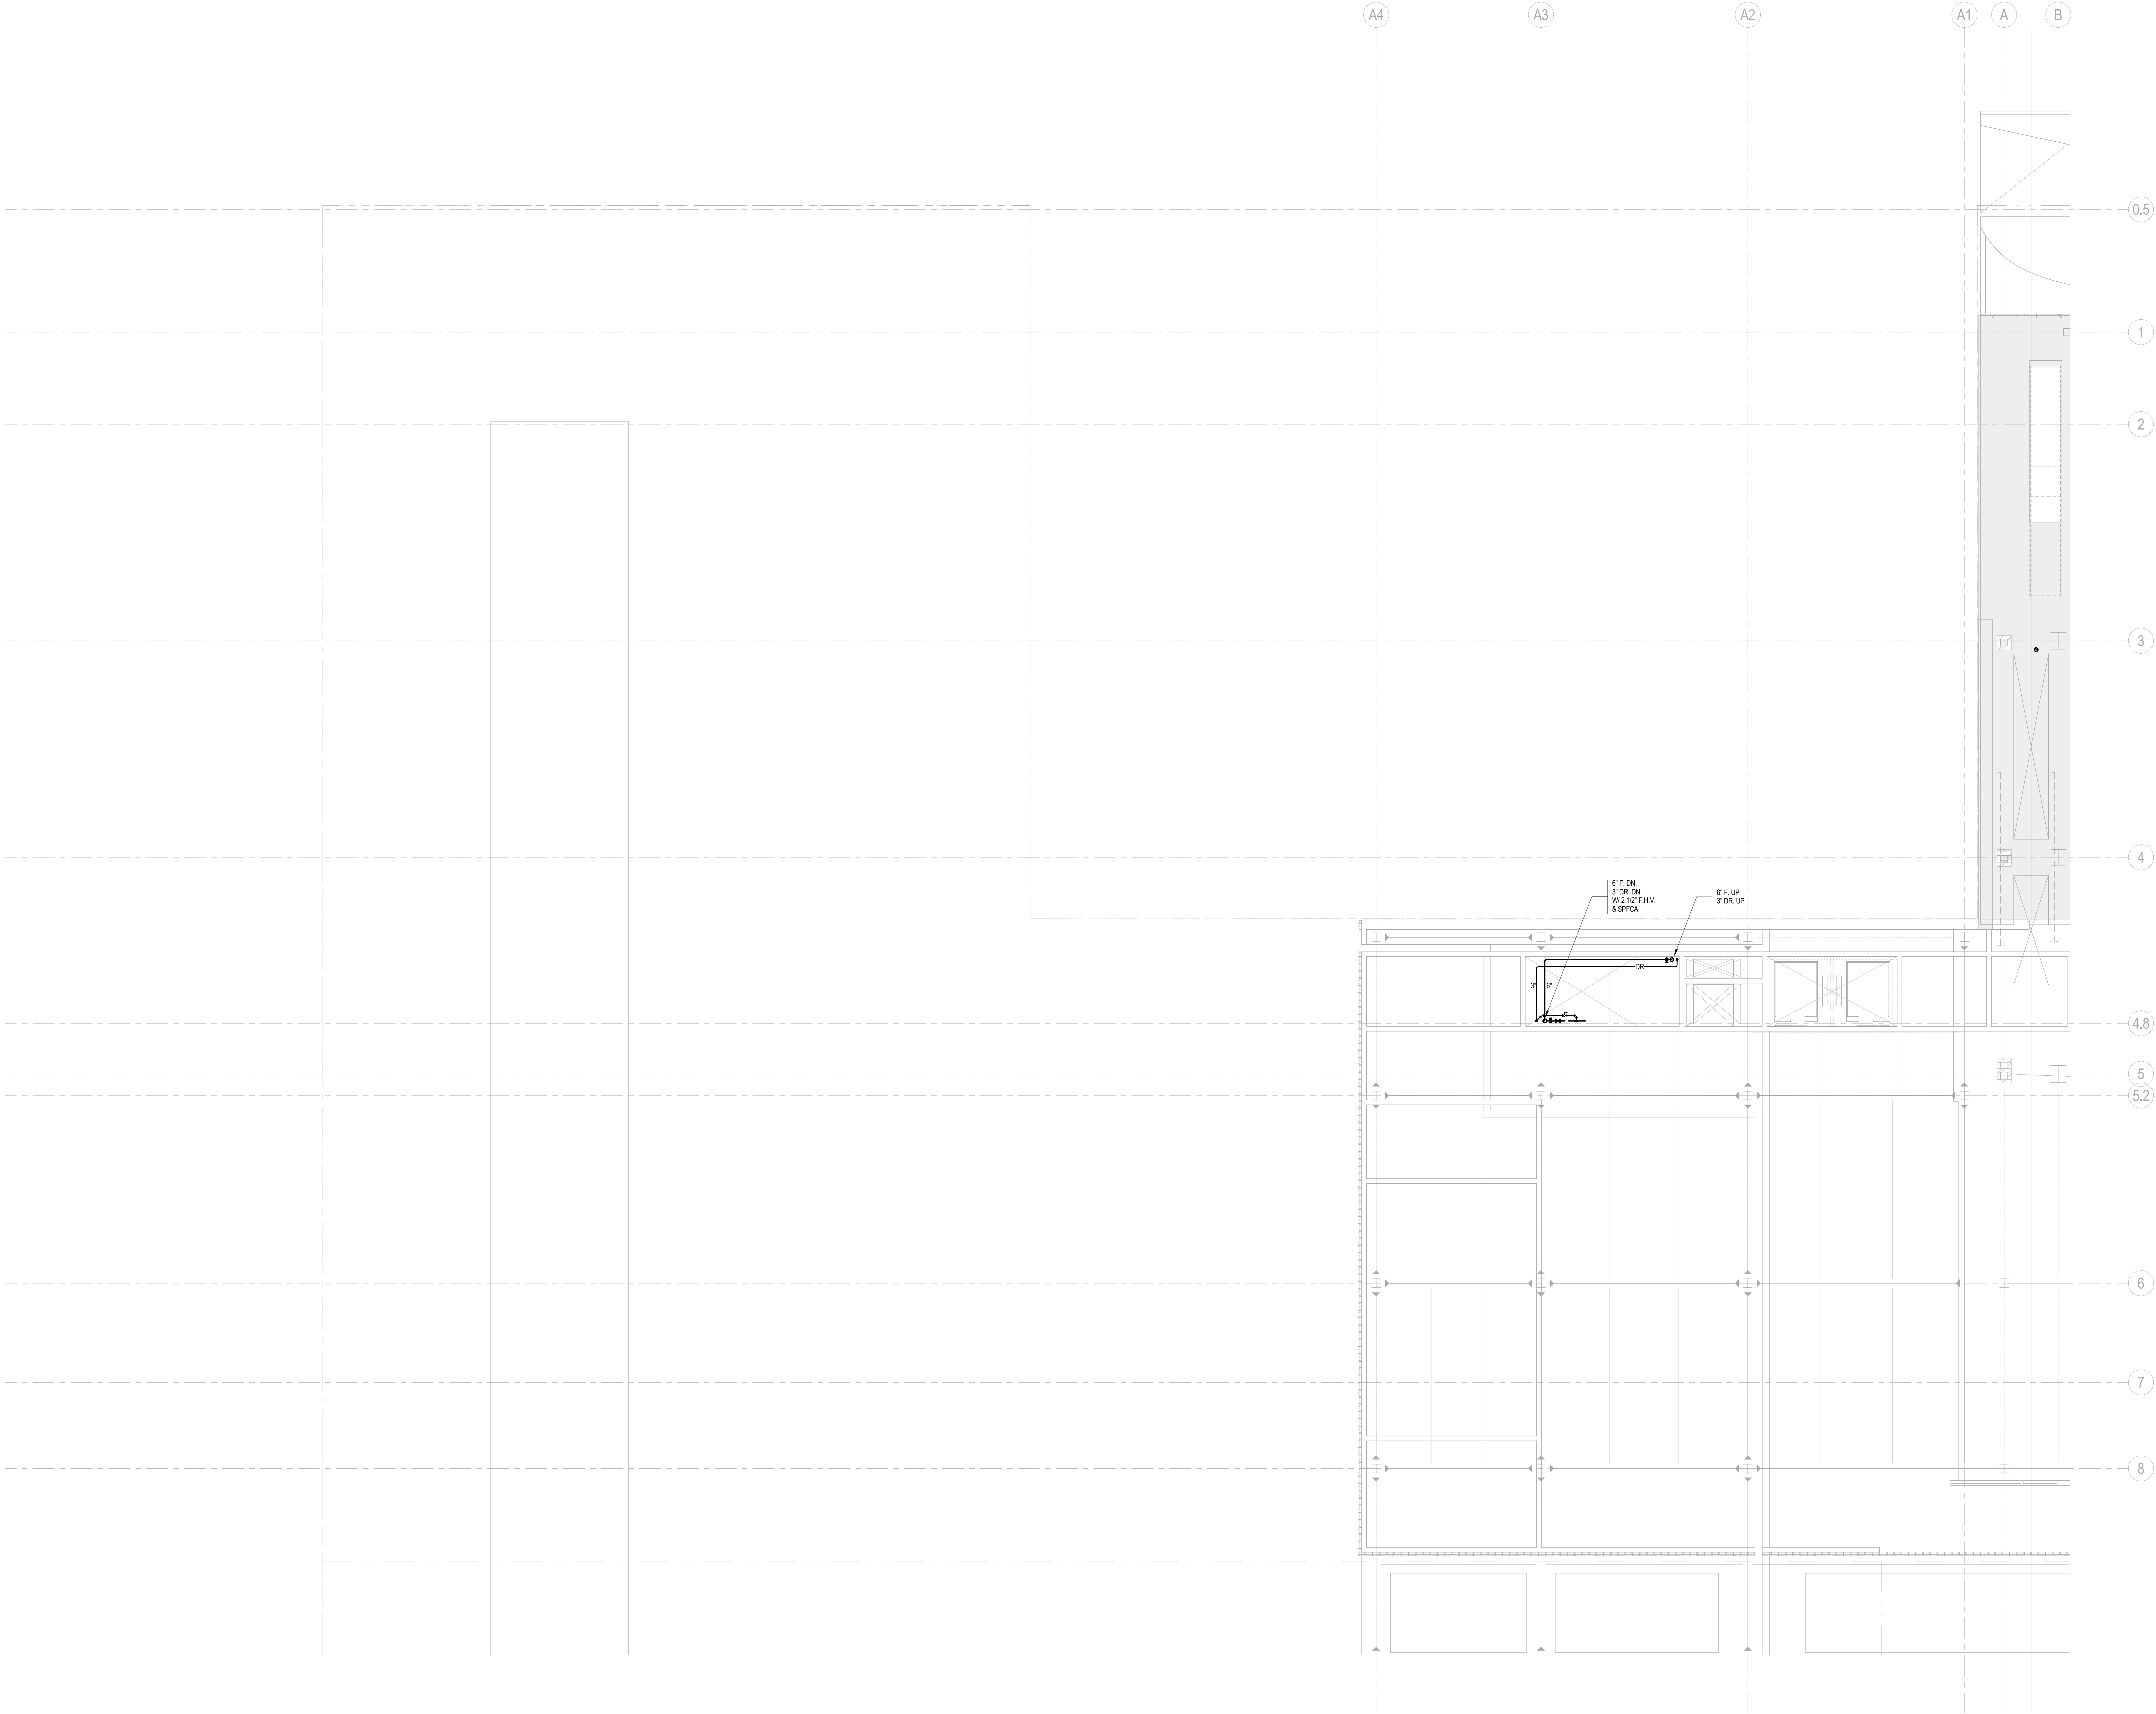
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File No.:
FP-102

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FP-102

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FP-102.00

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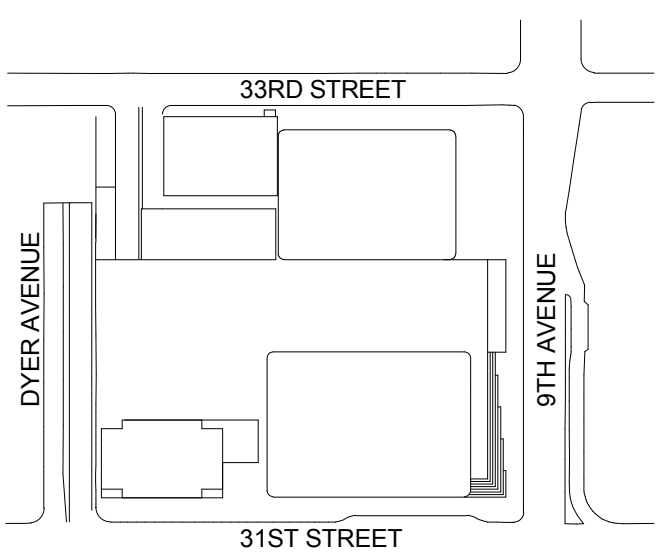
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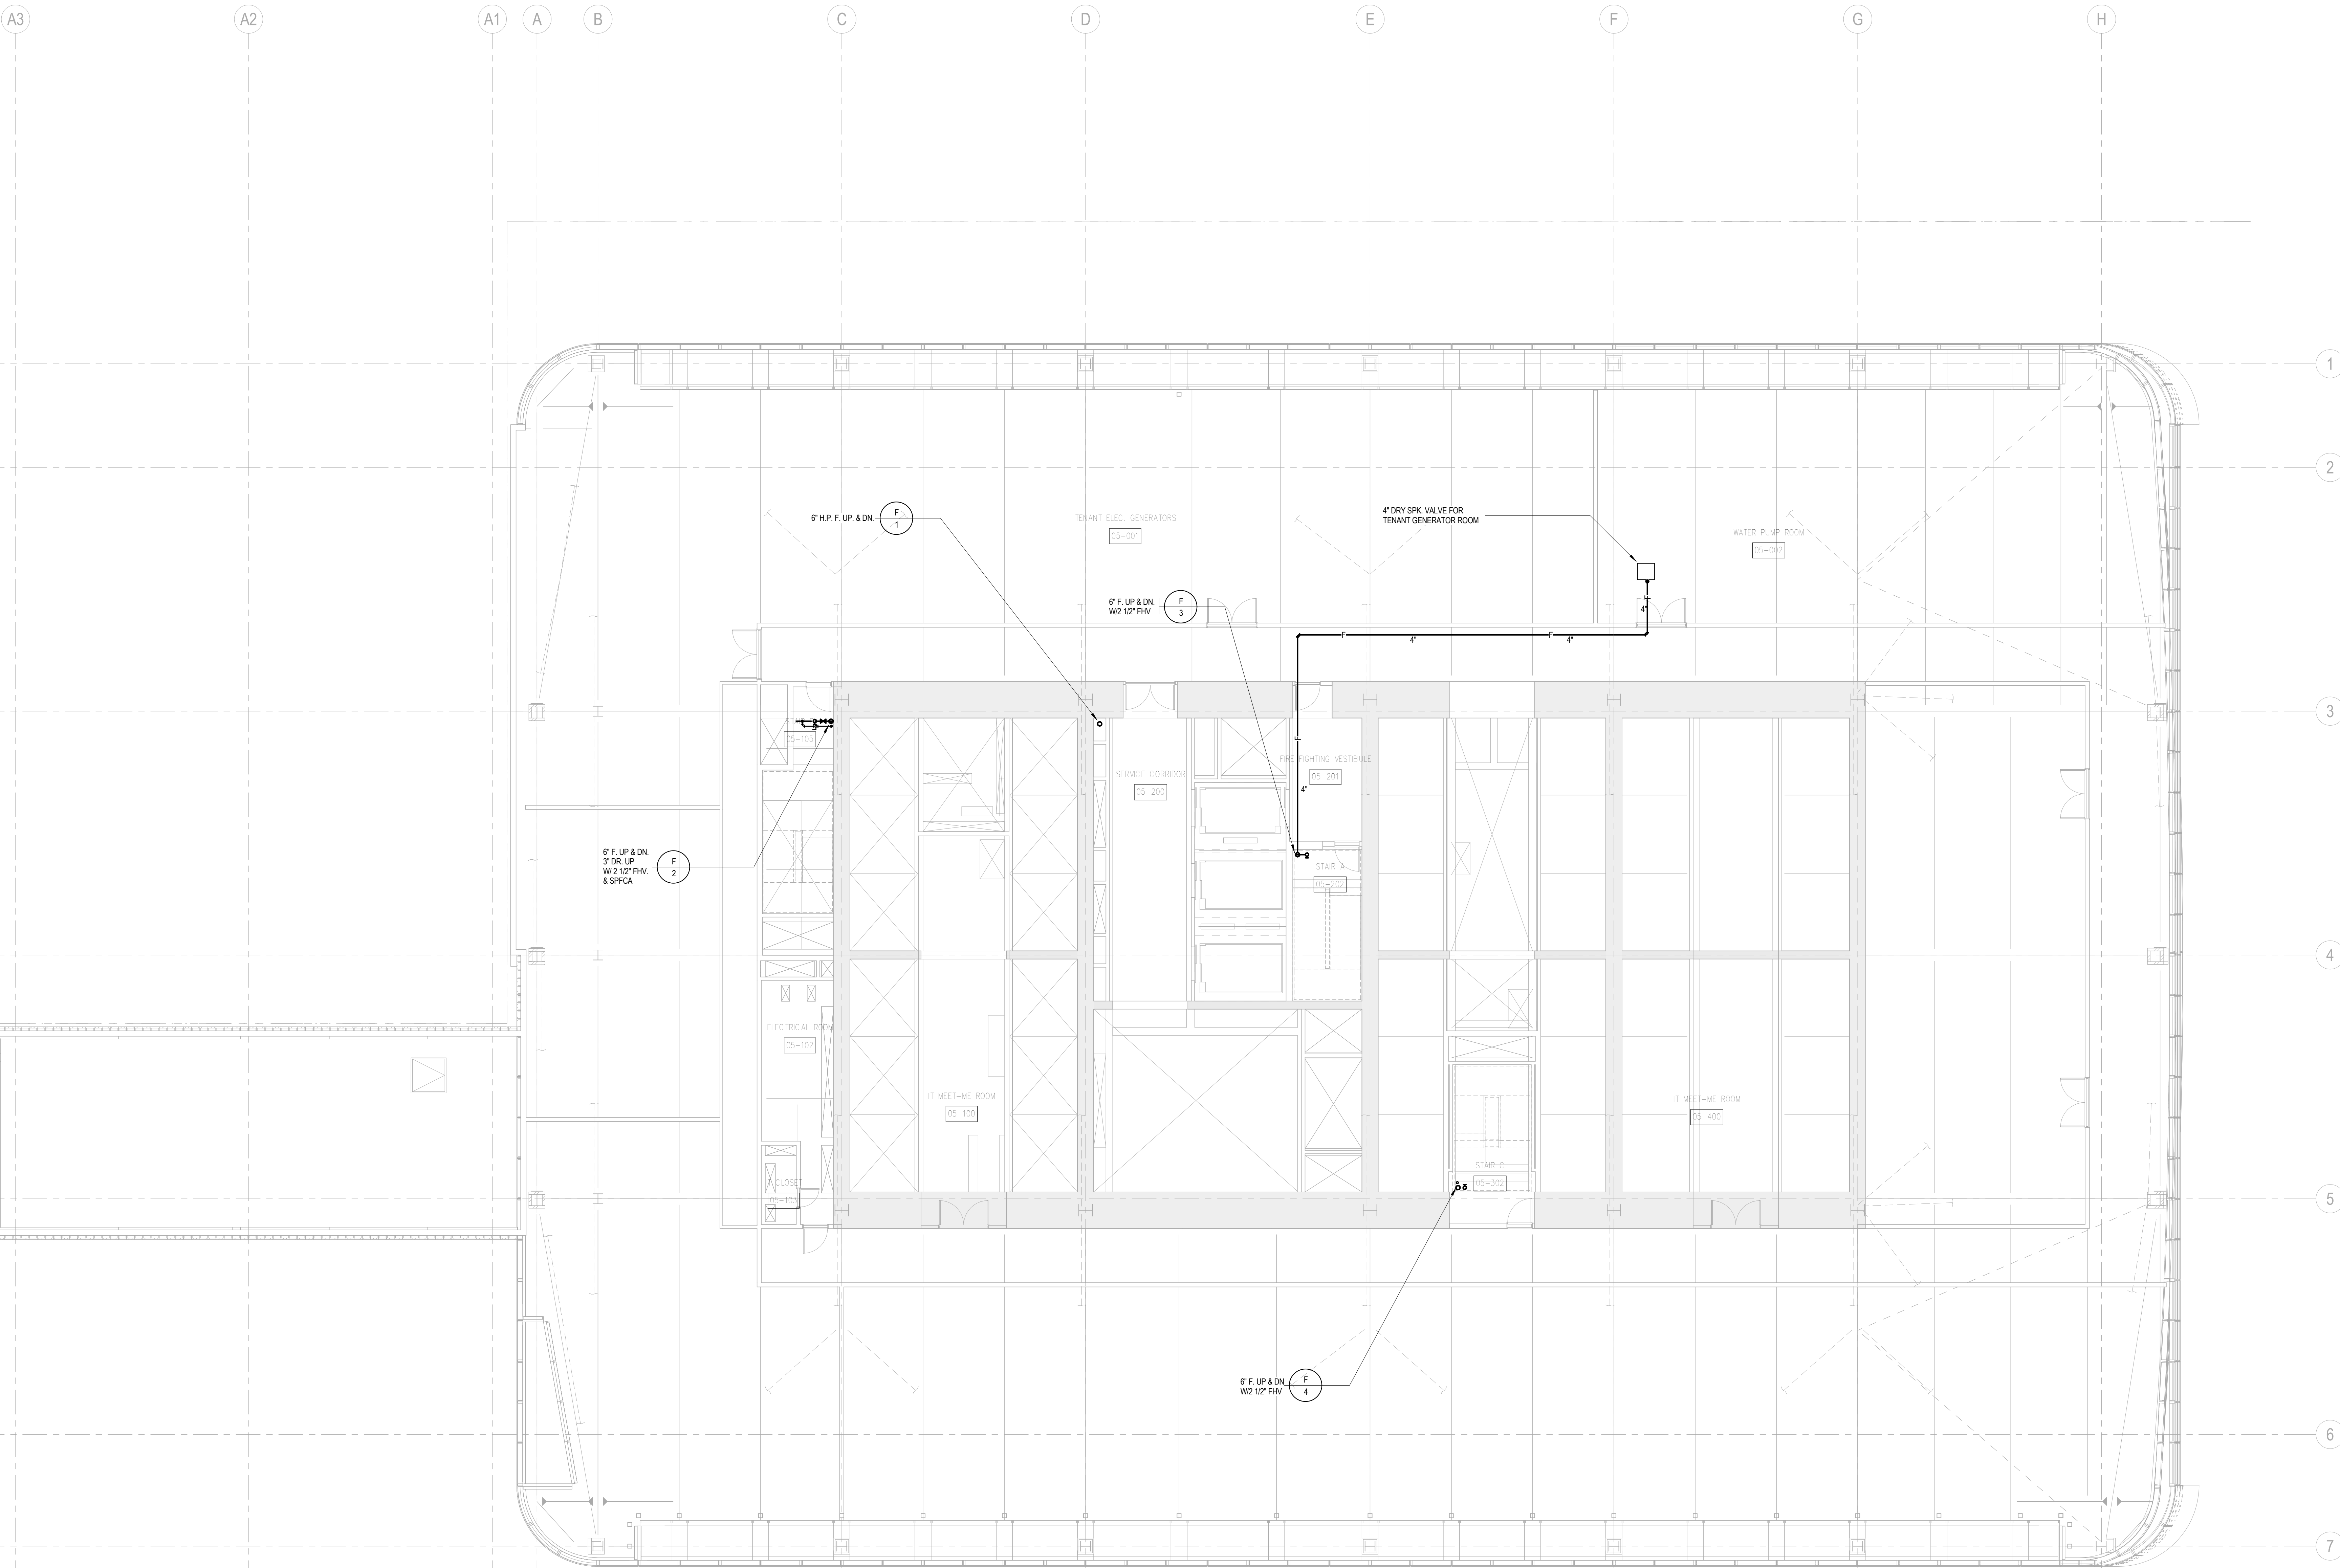
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FIRE
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LEVEL 5 FLOOR
PLAN -
MECHANICAL
MEZZANINE

Project No.:	14830-A-000	Sheet No.:	FP-105
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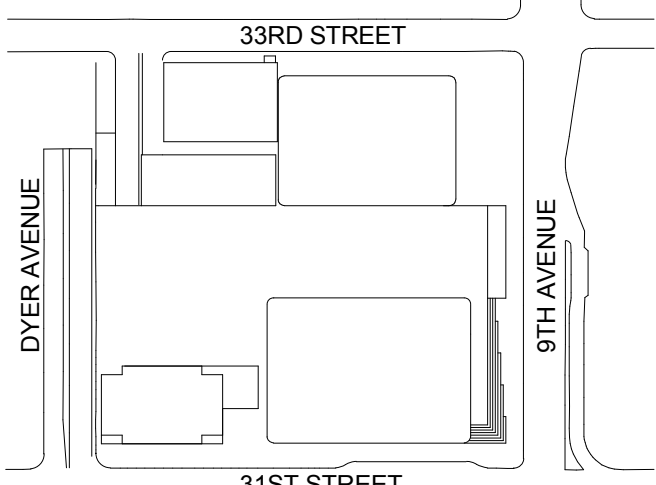
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FIRE
PROTECTION
LEVEL 6-16
FLOOR PLAN -
TYPICAL
LOW-RISE

Project No.: 14530.A.000	Sheet No.:
Date: 20 JUN 2014	<div>FP-106</div>
Scale: 1/8" = 1'-0"	
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No.	Date	Description

Sheet Name:

FIRE
PROTECTION
LEVEL 18 FLOOR
PLAN - LOW-RISE
OVERRUN

Project No.: 14830.A.000	Sheet No.:
Date: 20 JUN 2014	<div style="text-align: center;"> <h1>FP-118</h1> </div>
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File No.: FP-118	B-SCAN Sheet No.: <div style="text-align: center;"> <h2>FP-118.00</h2> </div>
	Page No.:

SHEET NOTES



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FIRE
PROTECTION
LEVEL 19-20
FLOOR PLAN -
LOW-RISE EMR

Project No.:

14830-A-000

Date:

20 JUN 2014

Scale:

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File No.:

FP-119

Sheet No.:

FP-119


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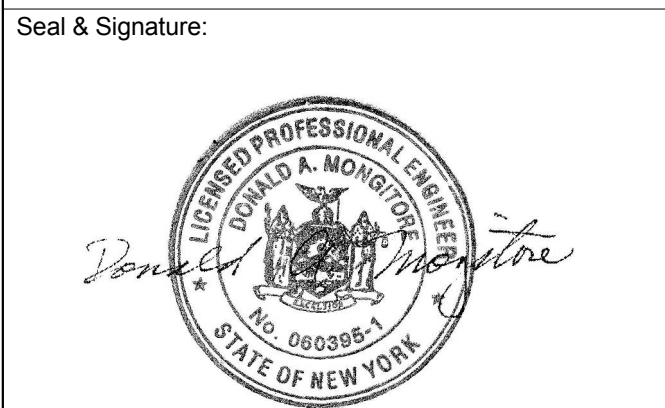
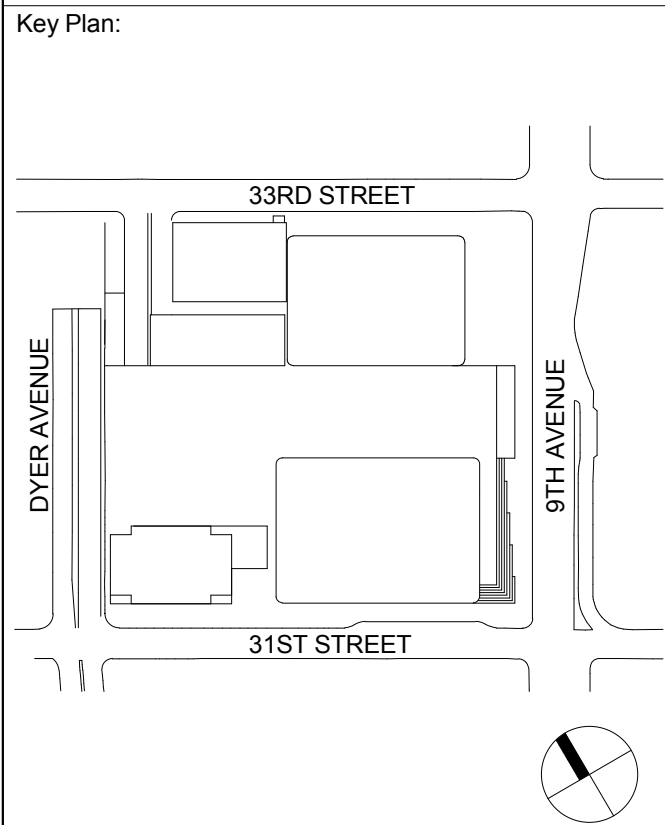
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FIRE
PROTECTION
LEVEL 21-27
FLOOR PLAN -
TYPICAL
LOW-RISE

Project No.: 14830-A-000	Sheet No.: FP-121
Date: 20 JUN 2014	B-SCAN Sheet No.: FP-121
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File No.: FP-121	



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1	19 MAR 2013	ISSUED FOR RECONCILIATION

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**FIRE
PROTECTION
LEVEL 30 FLOOR
PLAN - MID-RISE
EMR**

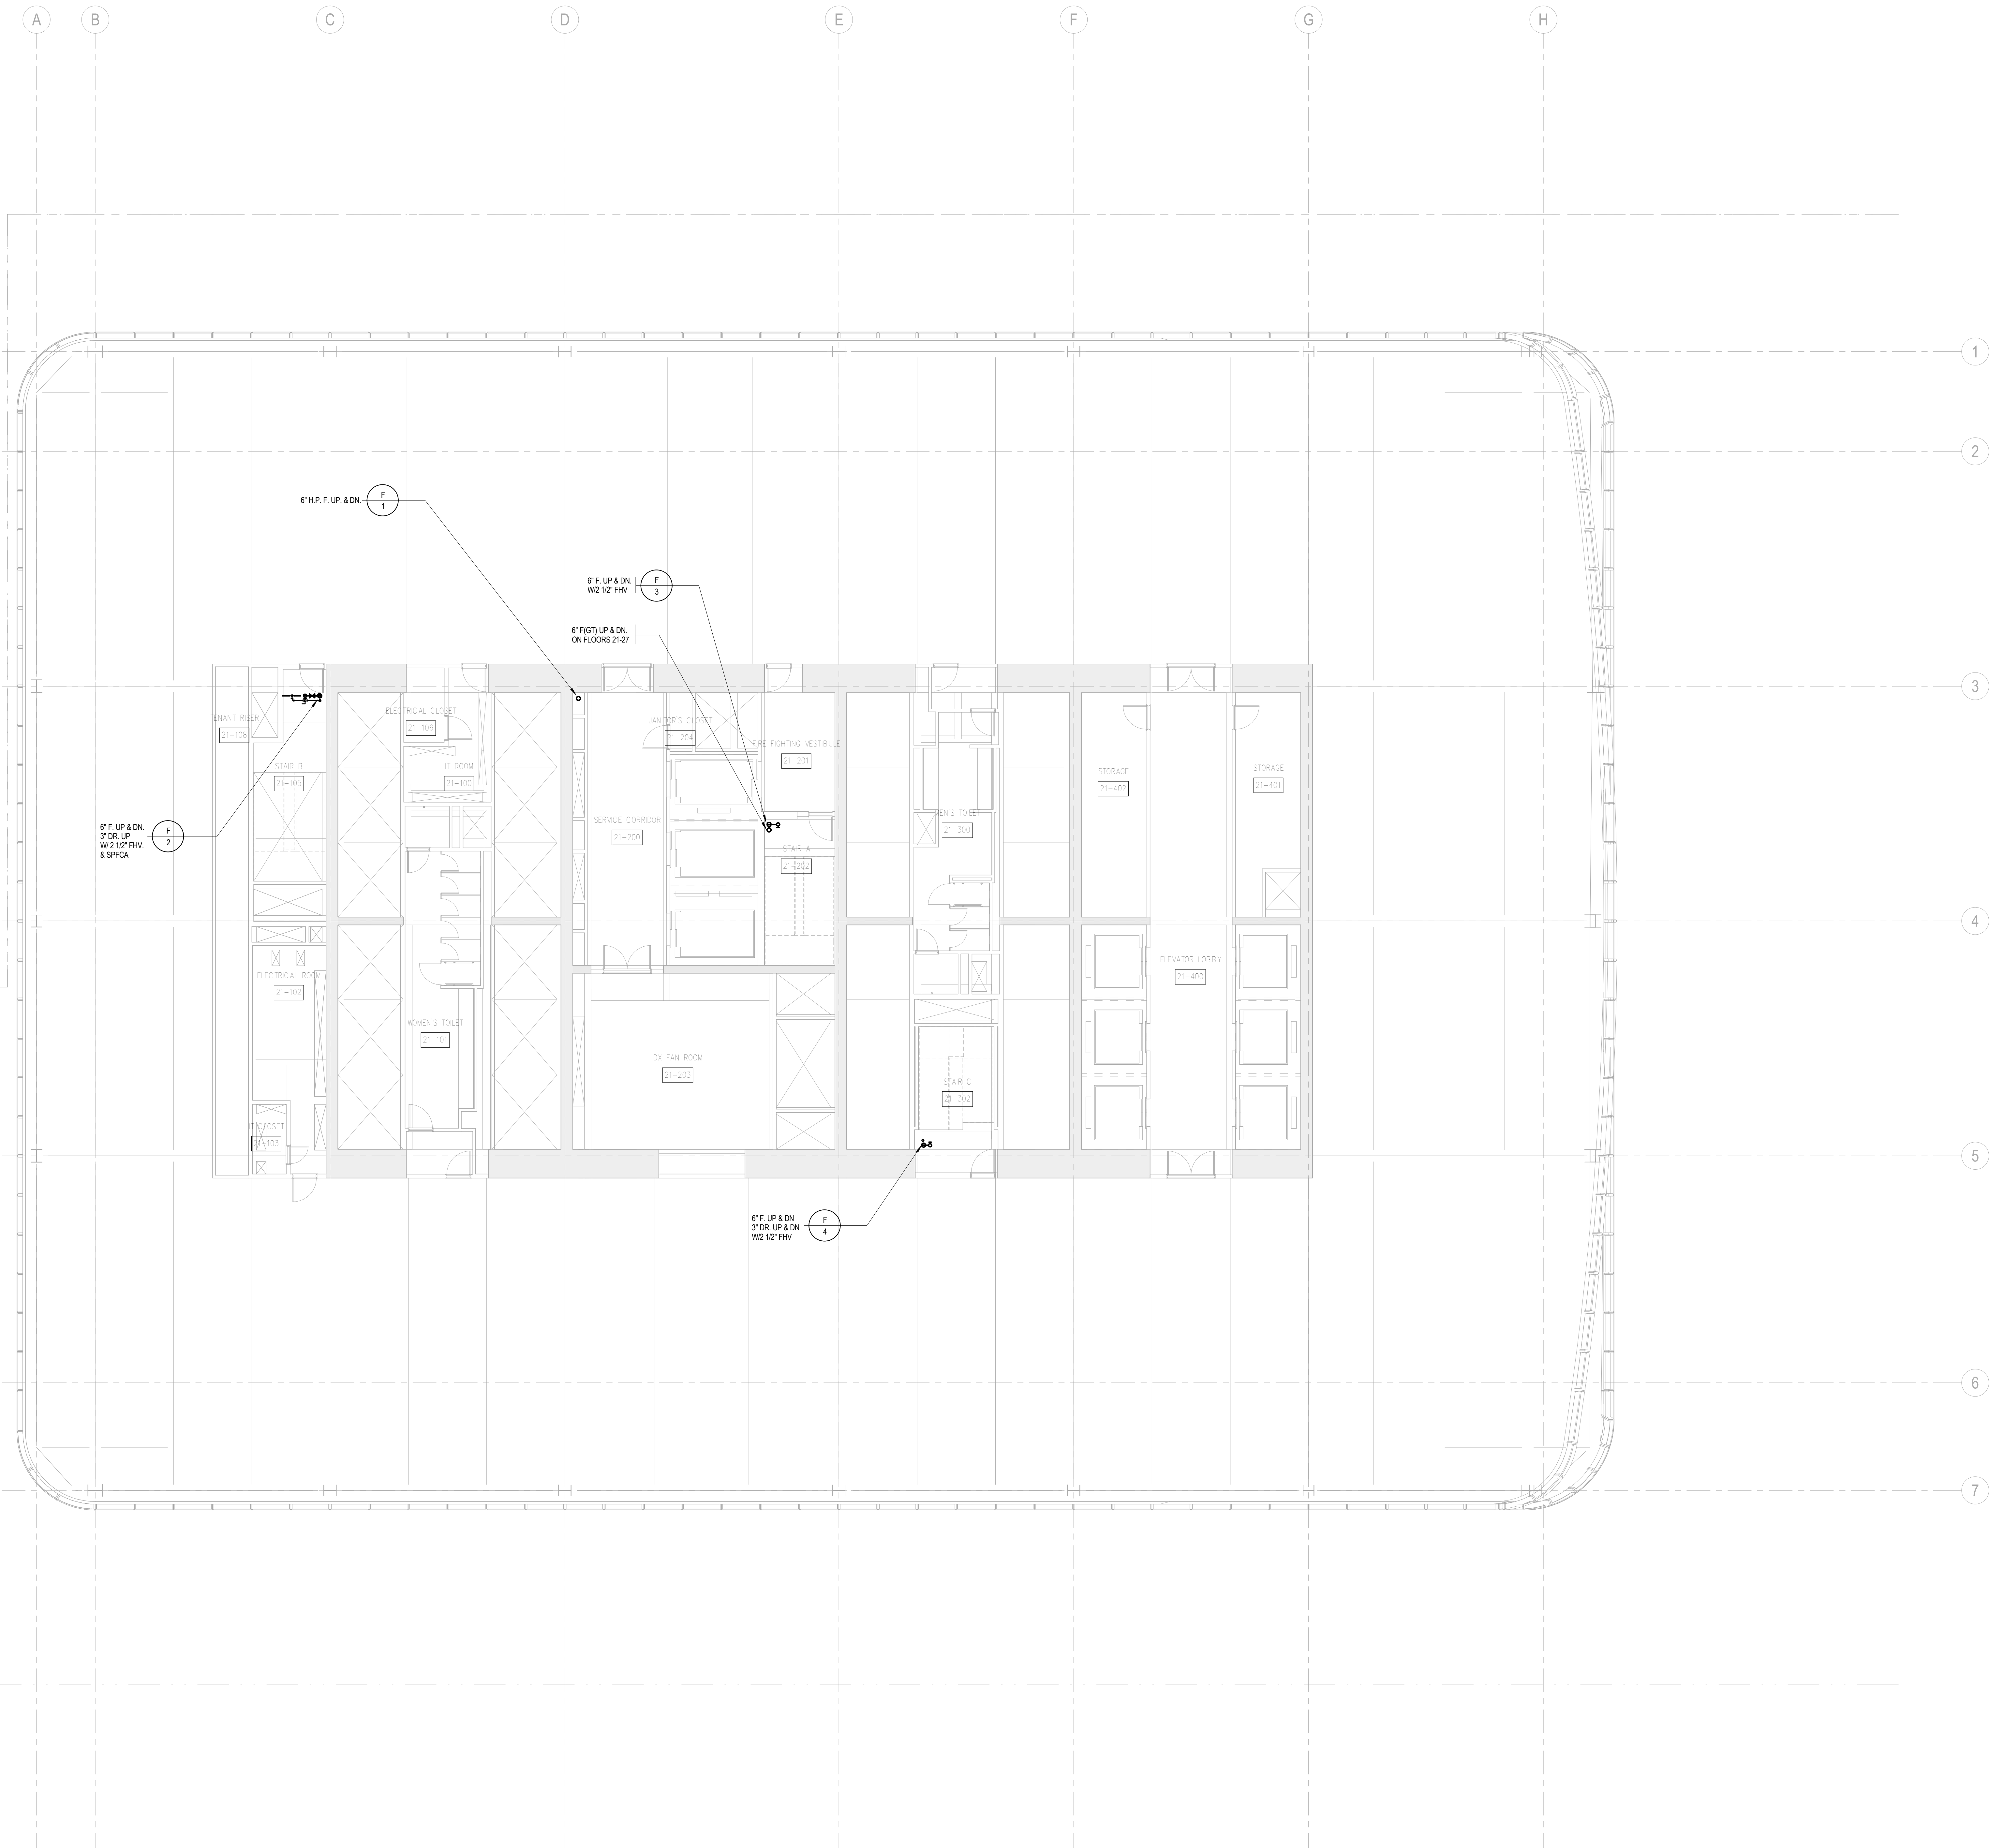Project No.:

14830-A-000

Date:

20 JUN 2014

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Sheet No.:

FP-130

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FP-130.00

Page No.:

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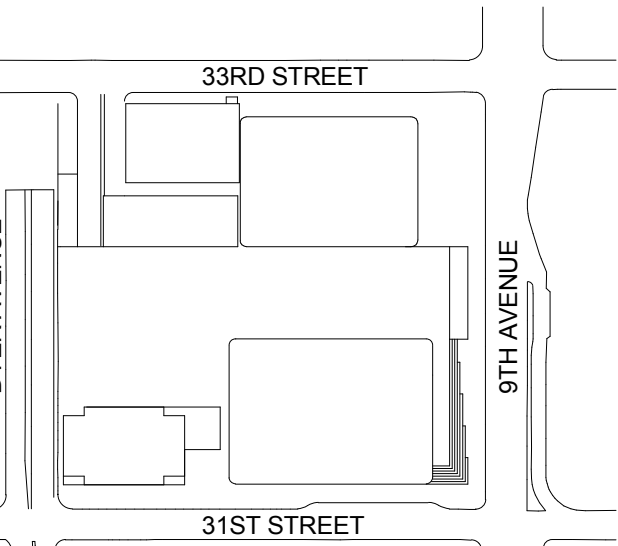
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FIRE
PROTECTION
LEVEL 31 FLOOR
PLAN - MID-RISE
PUMP ROOM

Project No.:

14830-A-000

Date:

20 JUN 2014

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File No.:

FP-131

Sheet No.:


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FP-131



NOTE: REFER TO RISER DIAGRAM FOR EXTENT
OF VALVING REQUIRED AT THIS LEVEL.



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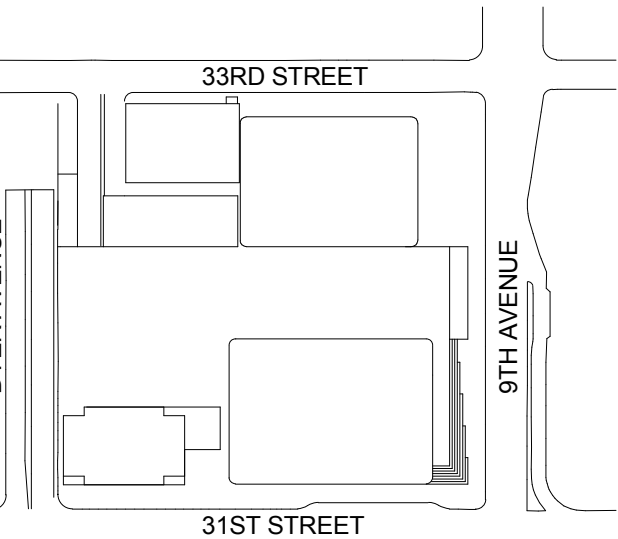
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**FIRE
PROTECTION
LEVEL 32 FLOOR
PLAN - MID-RISE
WATER TANK**

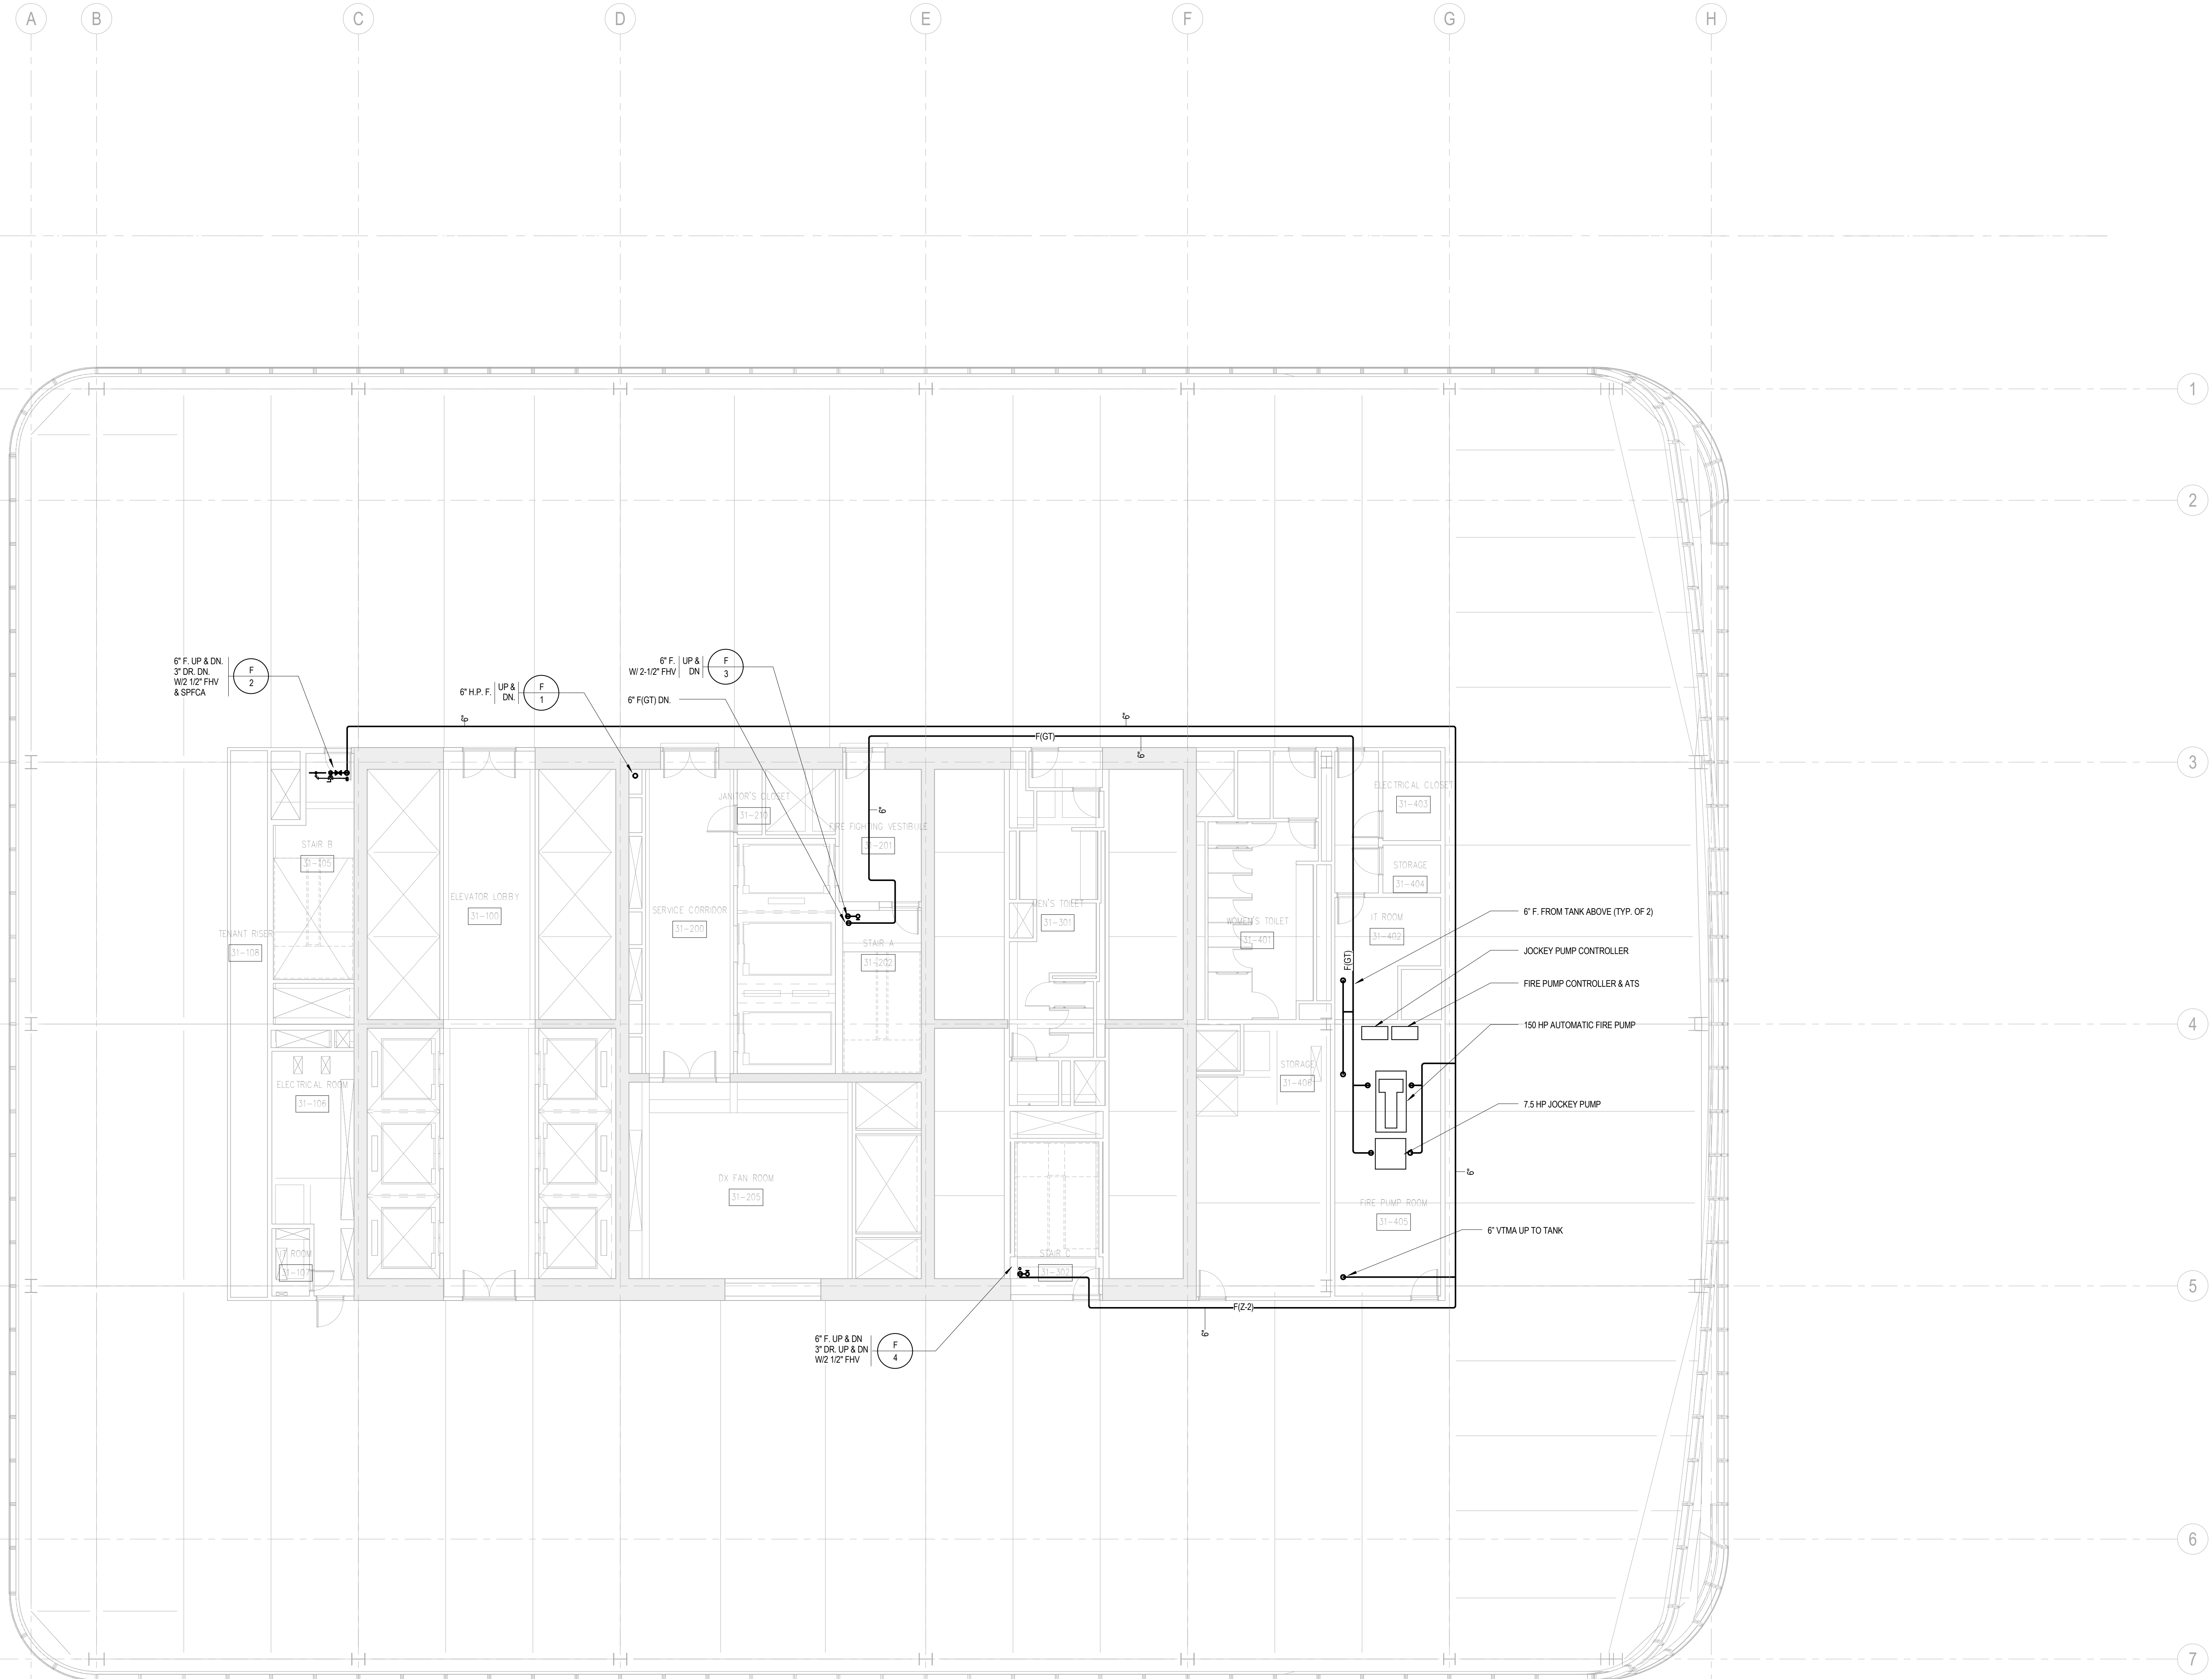Project No.:

14830-A-000

Date:

20 JUN 2014

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File No.:

FP-132

Sheet No.:

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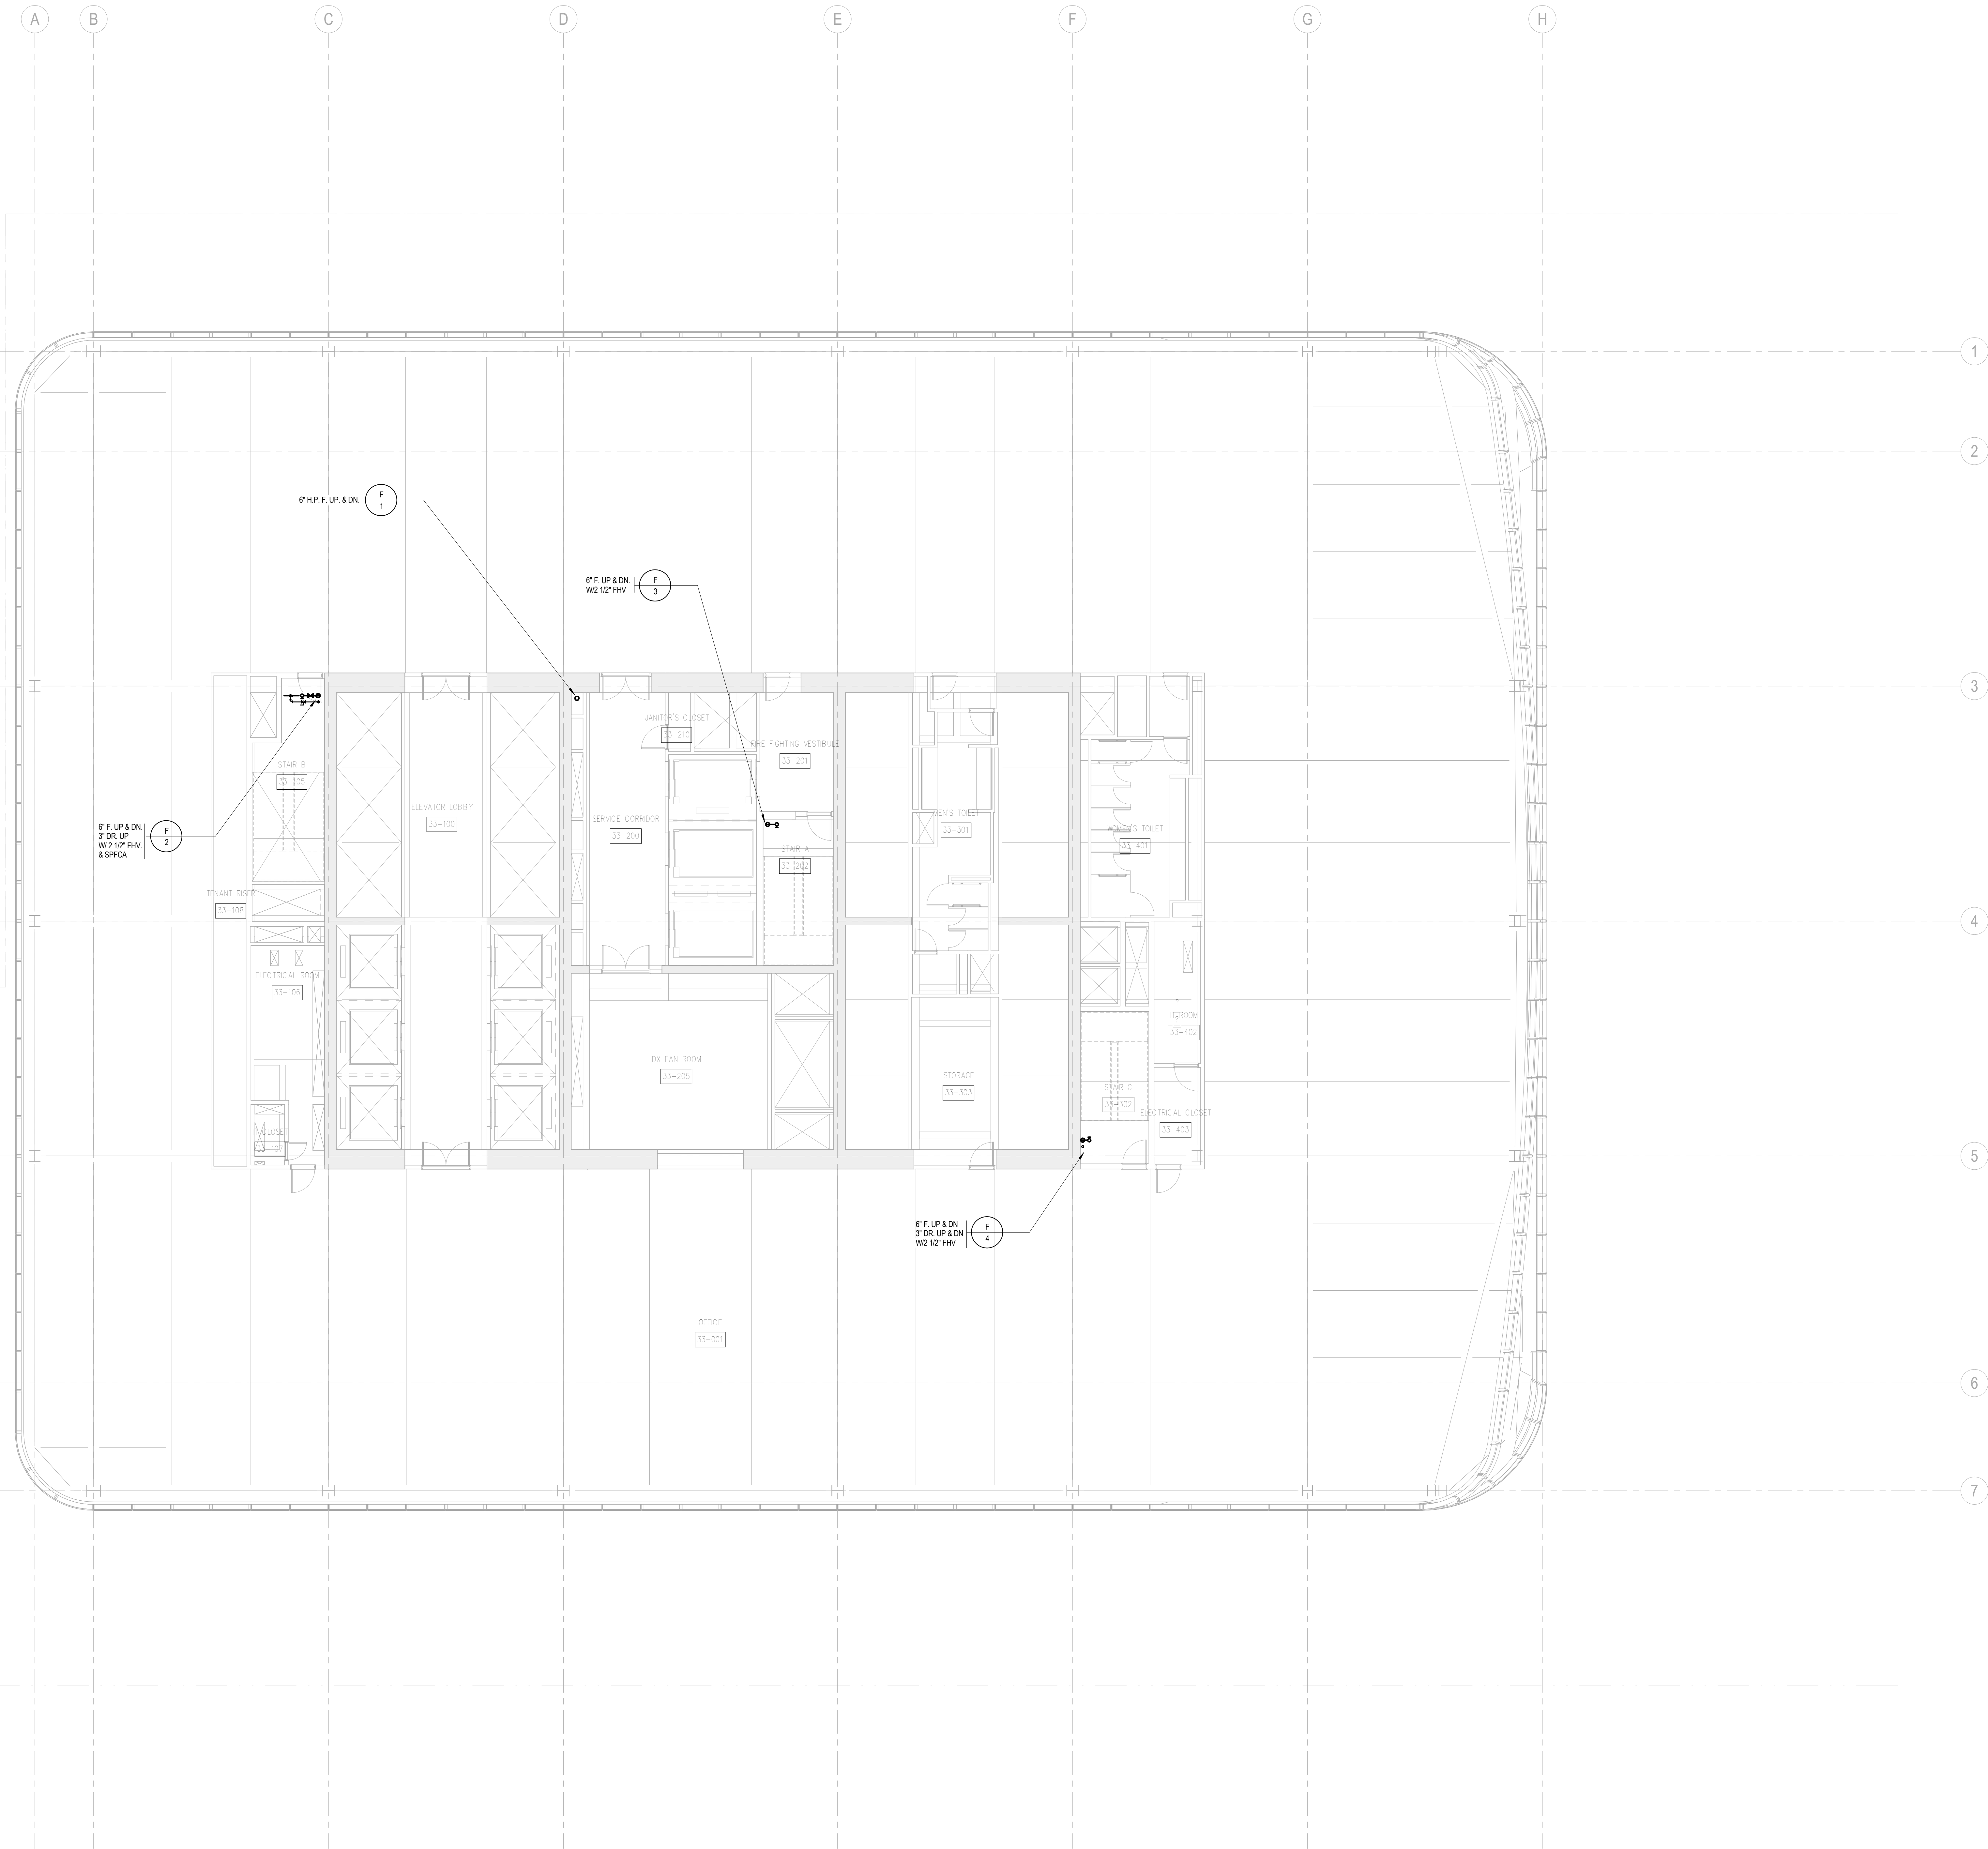
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FP-132.00

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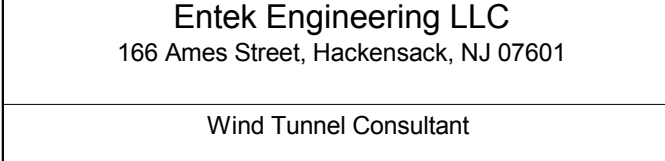
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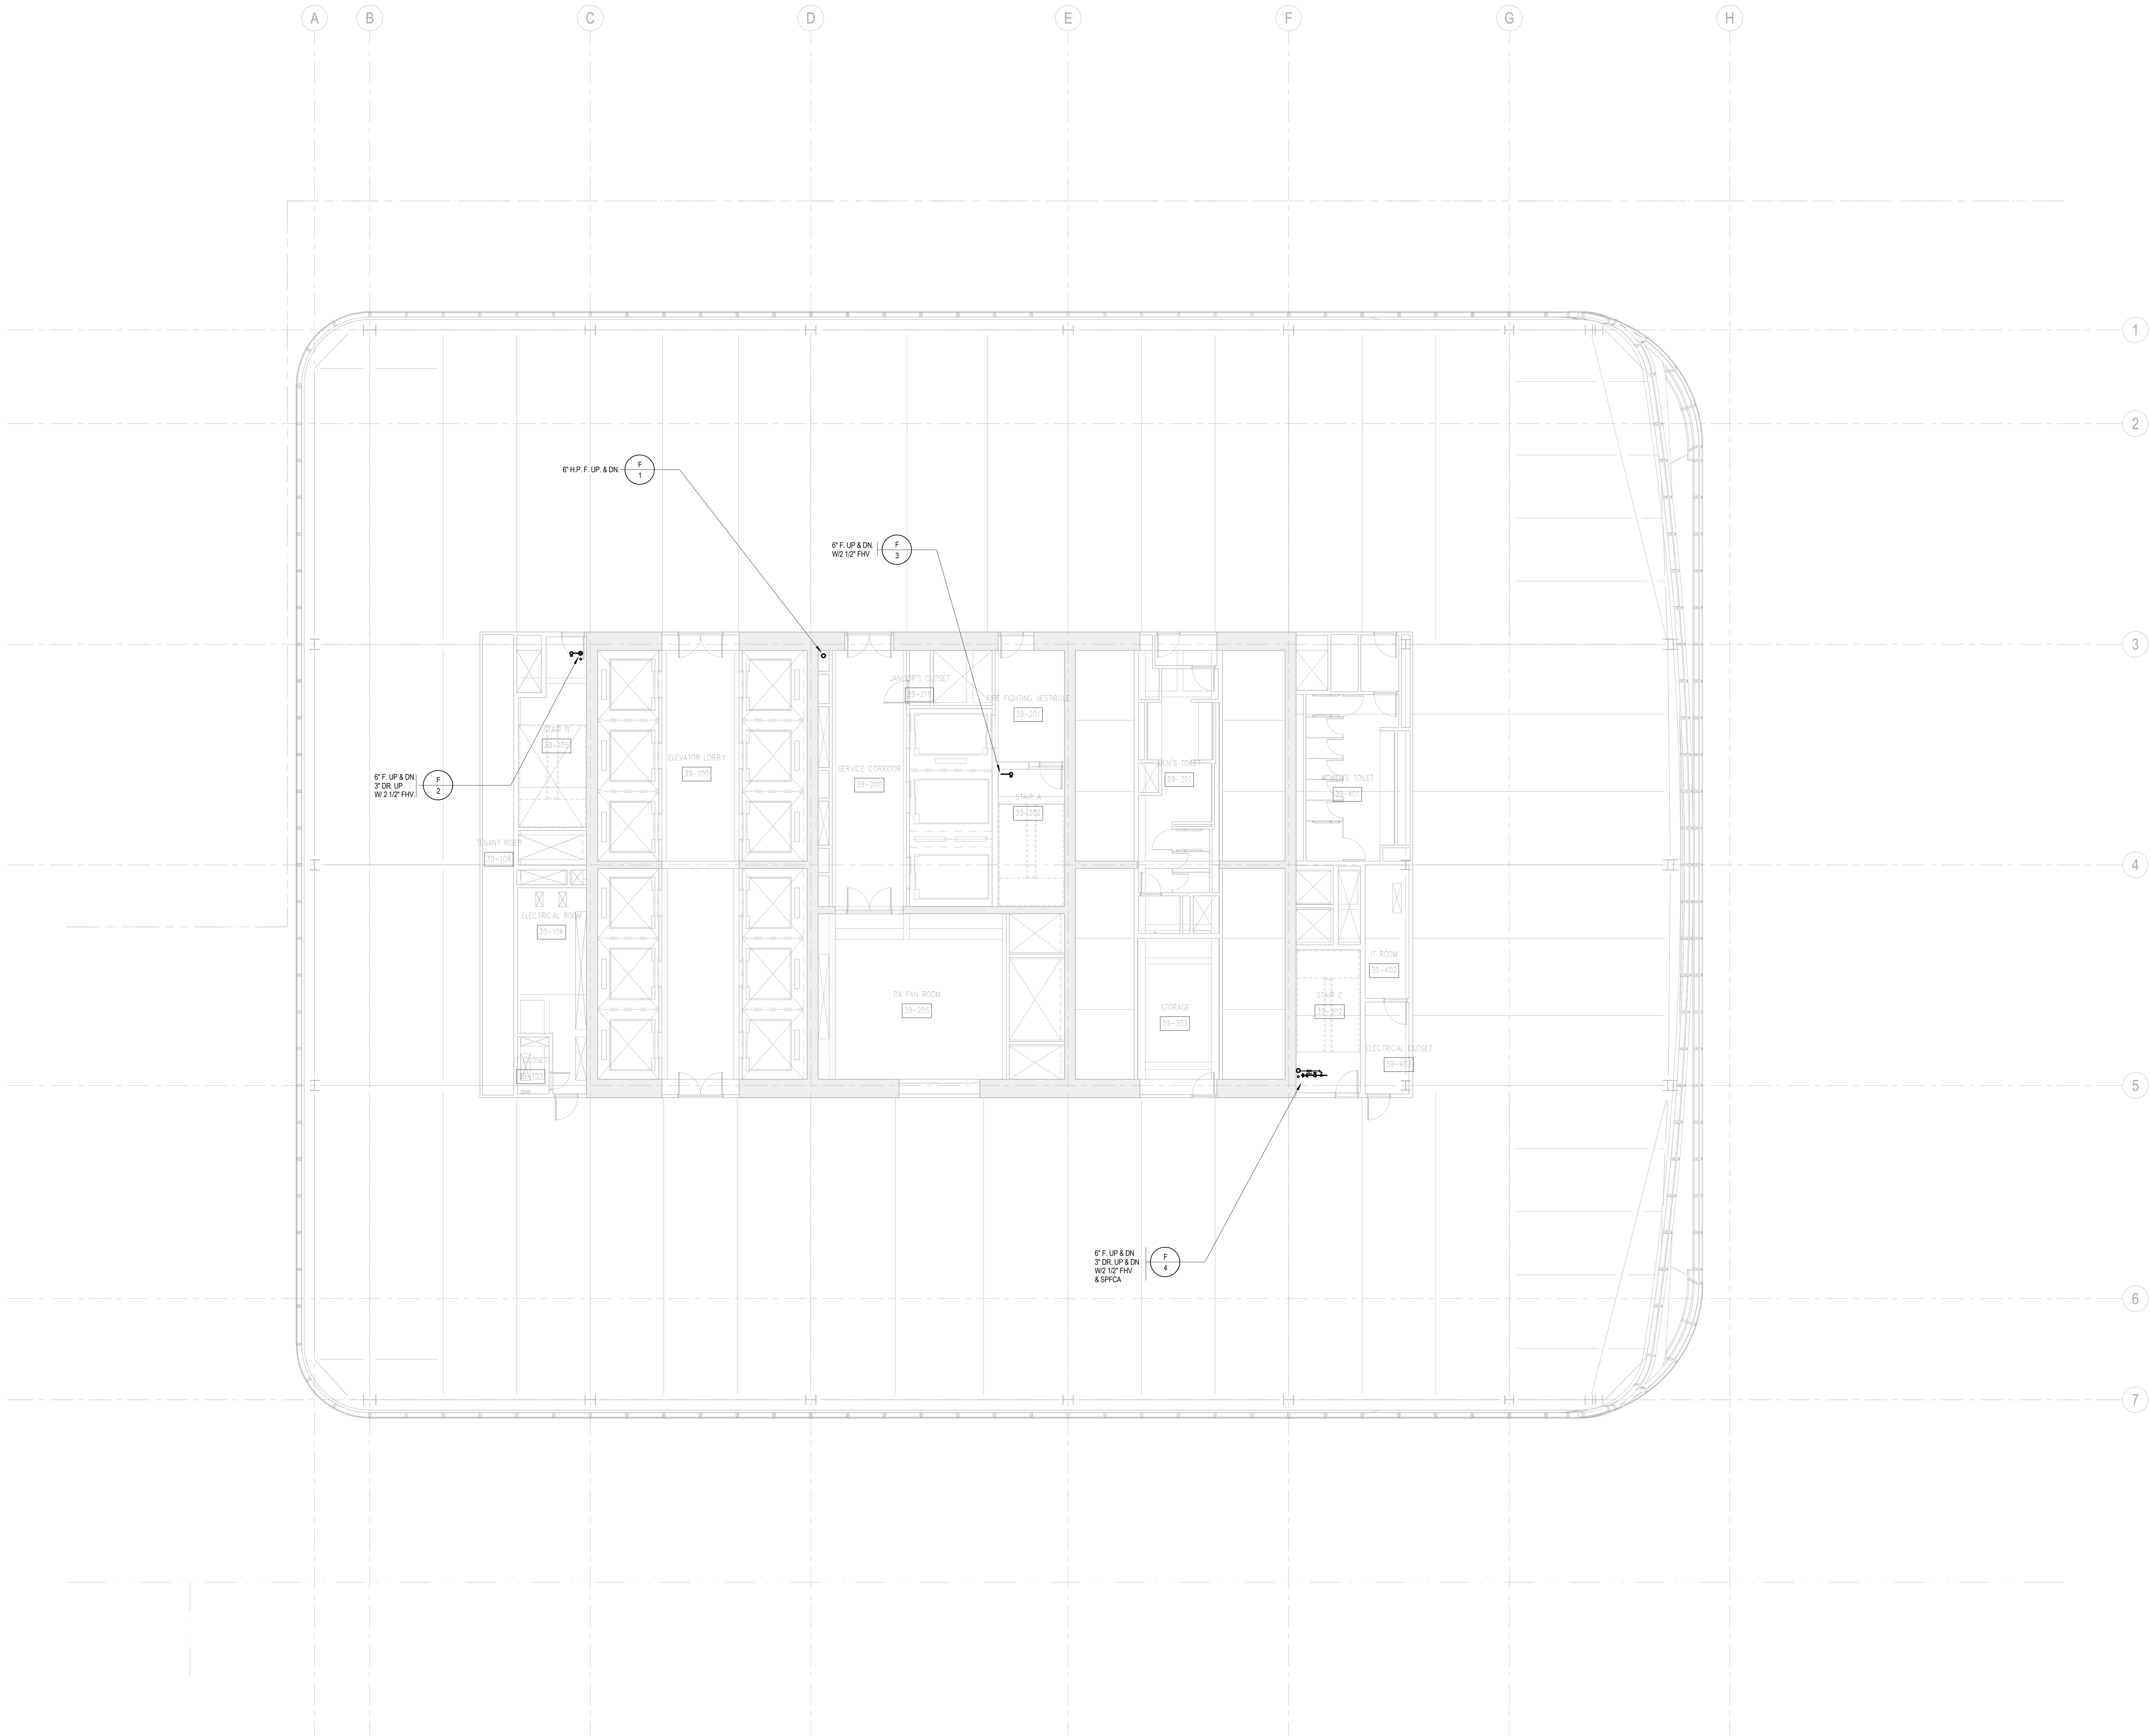
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**FIRE
PROTECTION
LEVEL 33-38
FLOOR PLAN -
TYPICAL
MID-RISE**

Project No.: 14830-A-000
Date: 20 JUN 2014
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File No: FP-133

Sheet No.: **FP-133**
B-SCAN Sheet No.: **FP-133.00**
Page No.:

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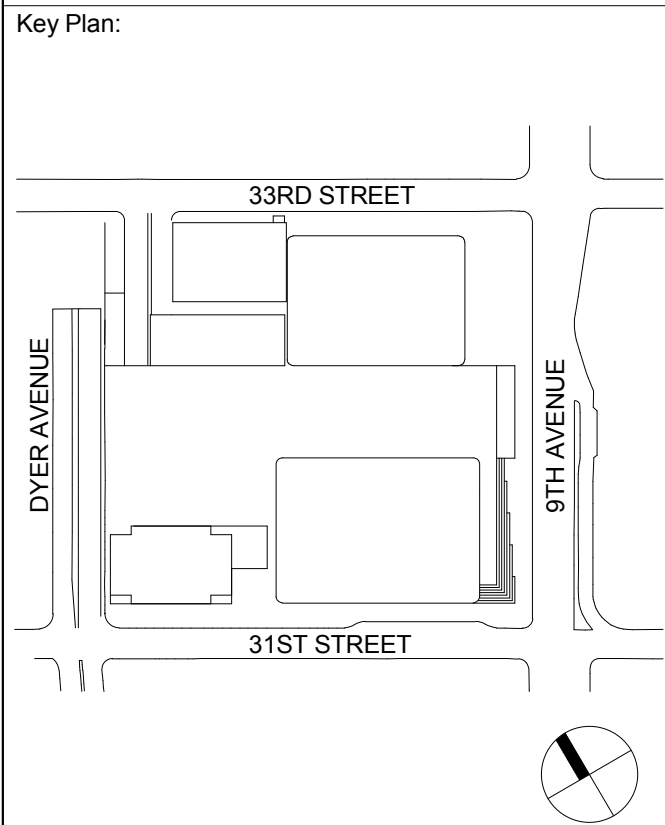
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No. Date Description
Sheet Name:

**FIRE
PROTECTION
LEVEL 39 FLOOR
PLAN - MID-RISE**

Project No.: 14830-A-000	Sheet No.: FP-139
Date: 20 JUN 2014	B-SCAN Sheet No.: FP-139.00
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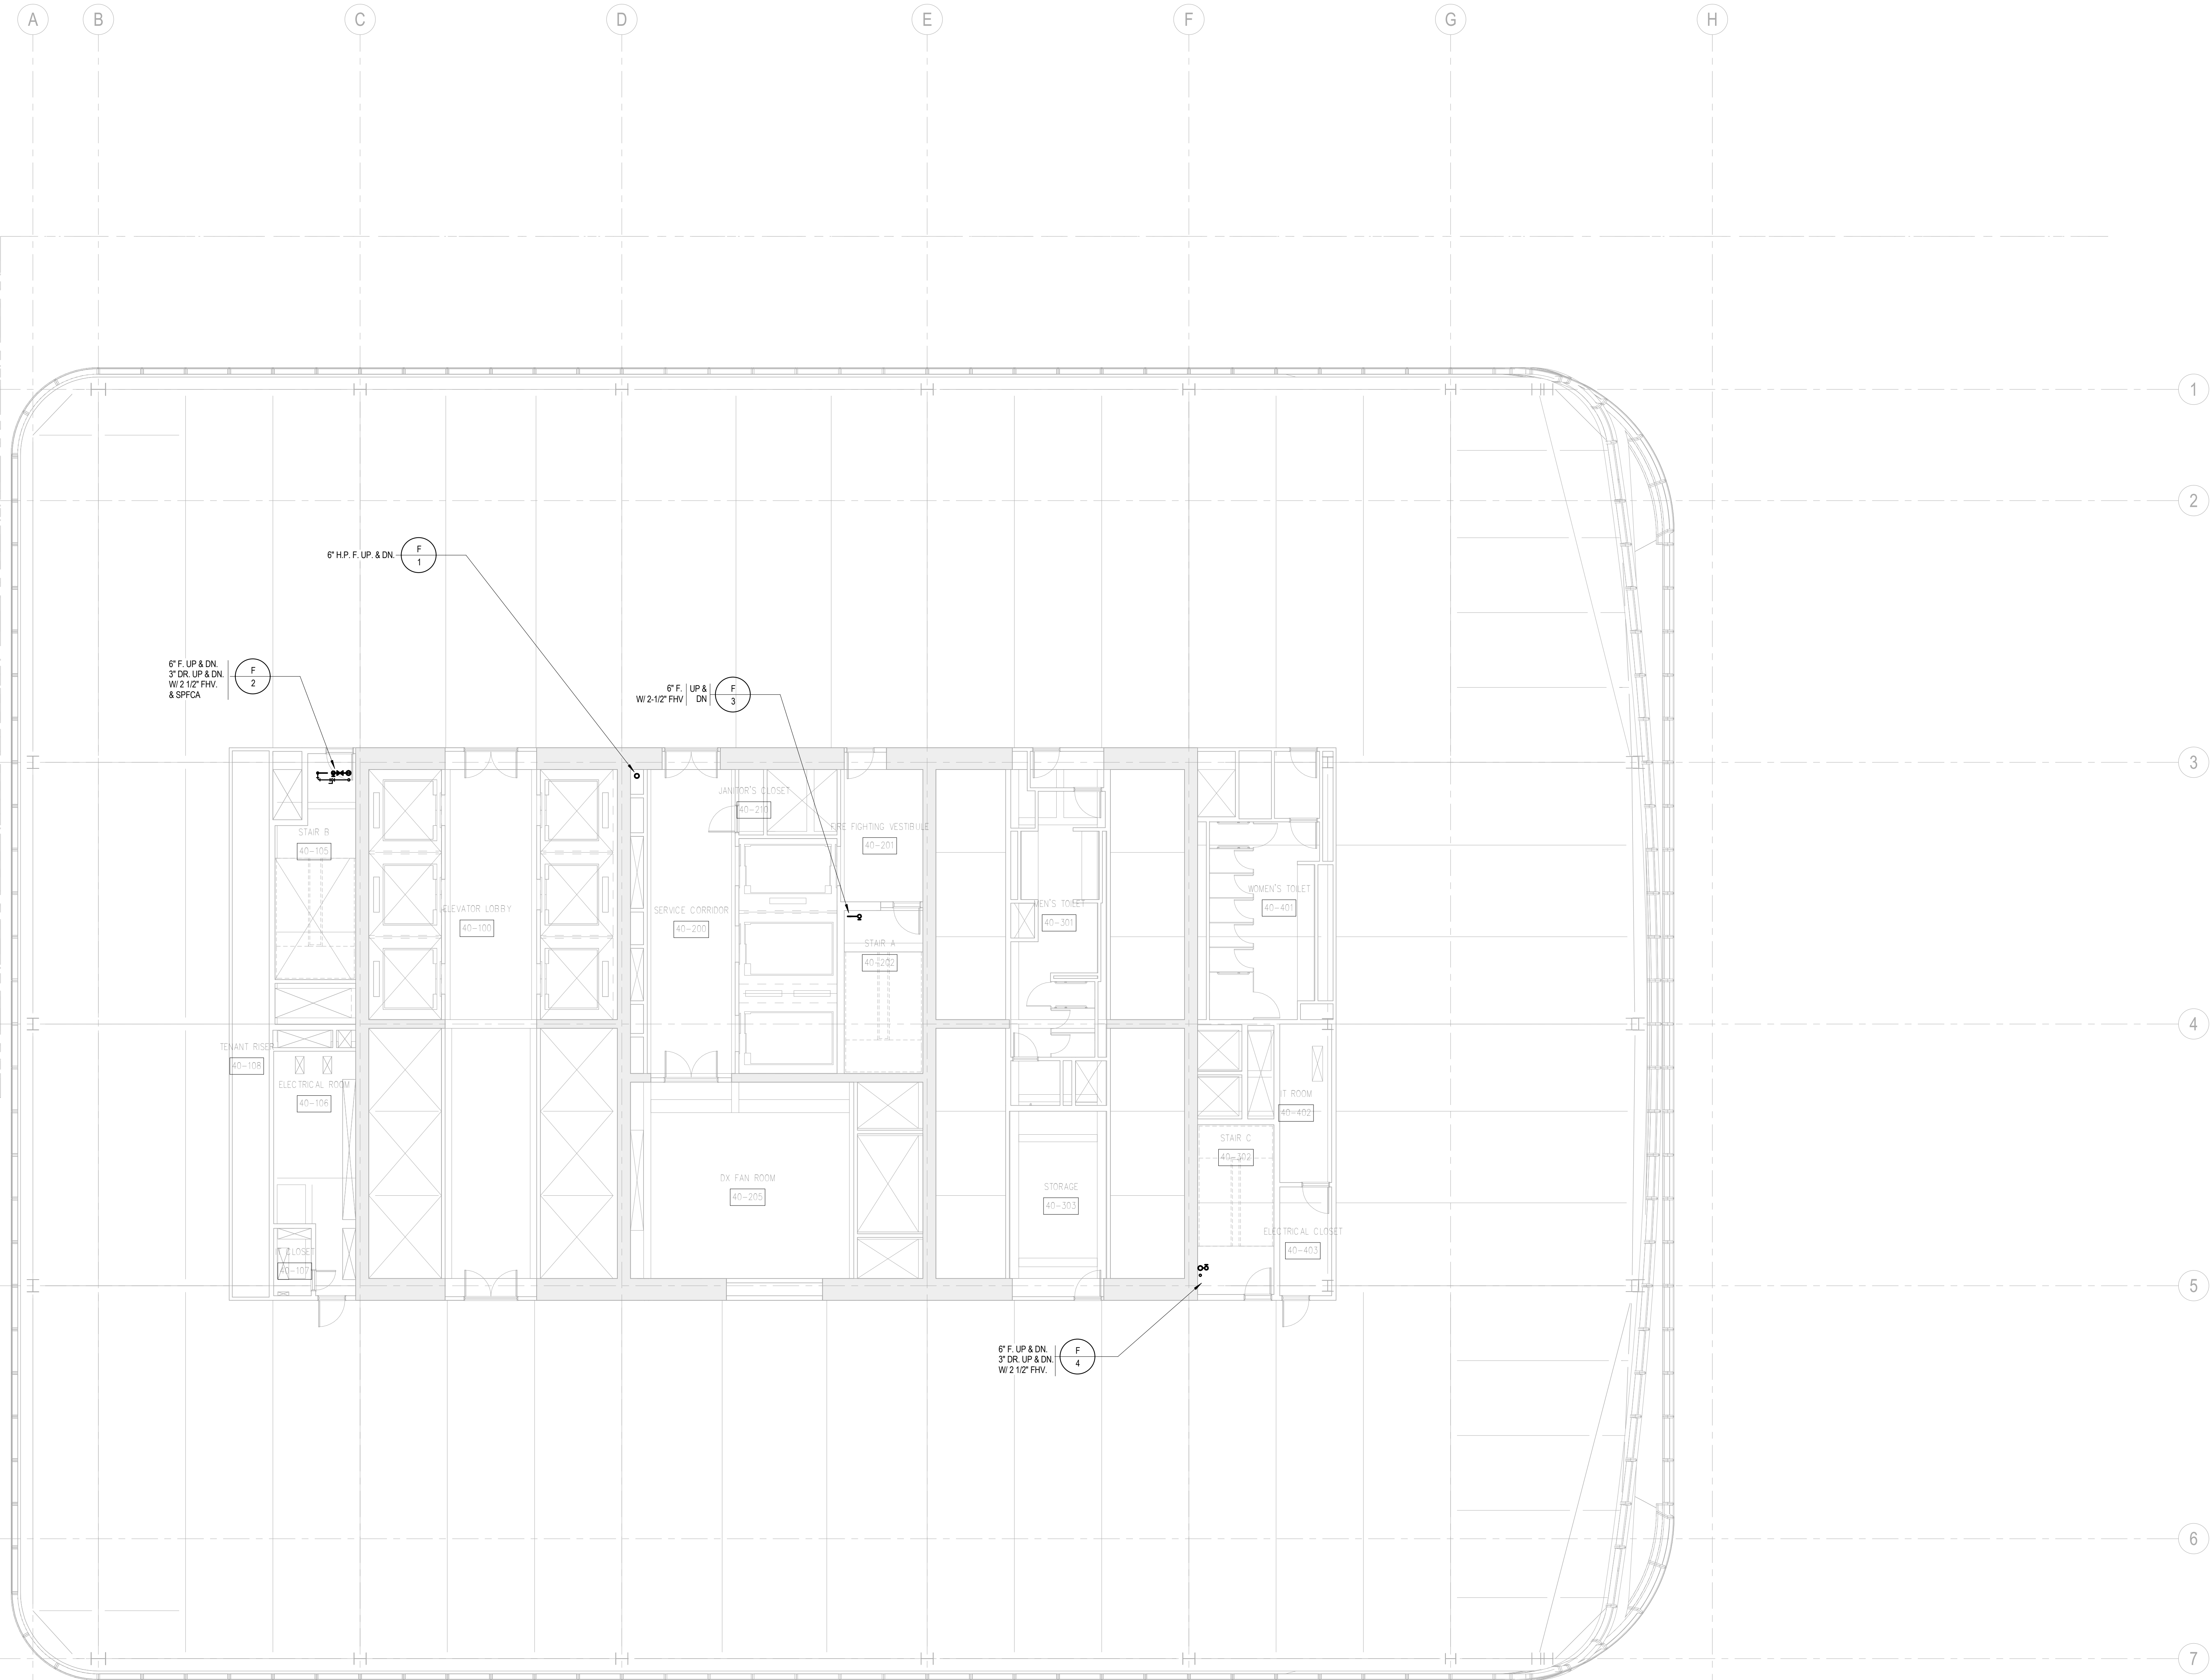
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FIRE
PROTECTION
LEVEL 40-41
FLOOR PLAN -
MID-RISE
OVERRUN

Project No.:

14830-A-000

Date:

20 JUN 2014

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FP-140

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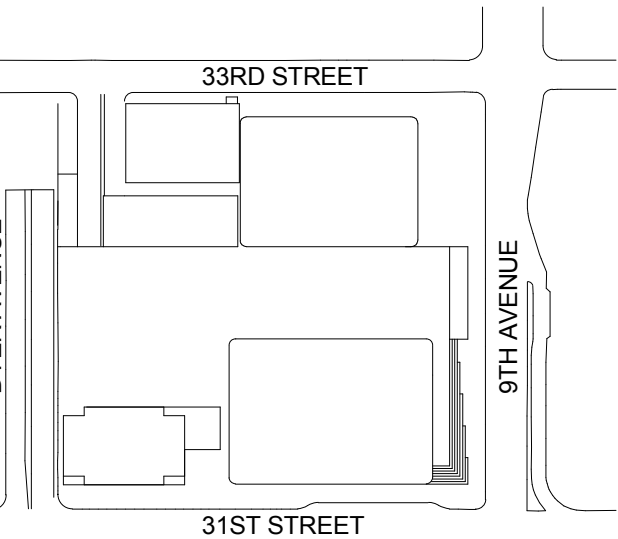
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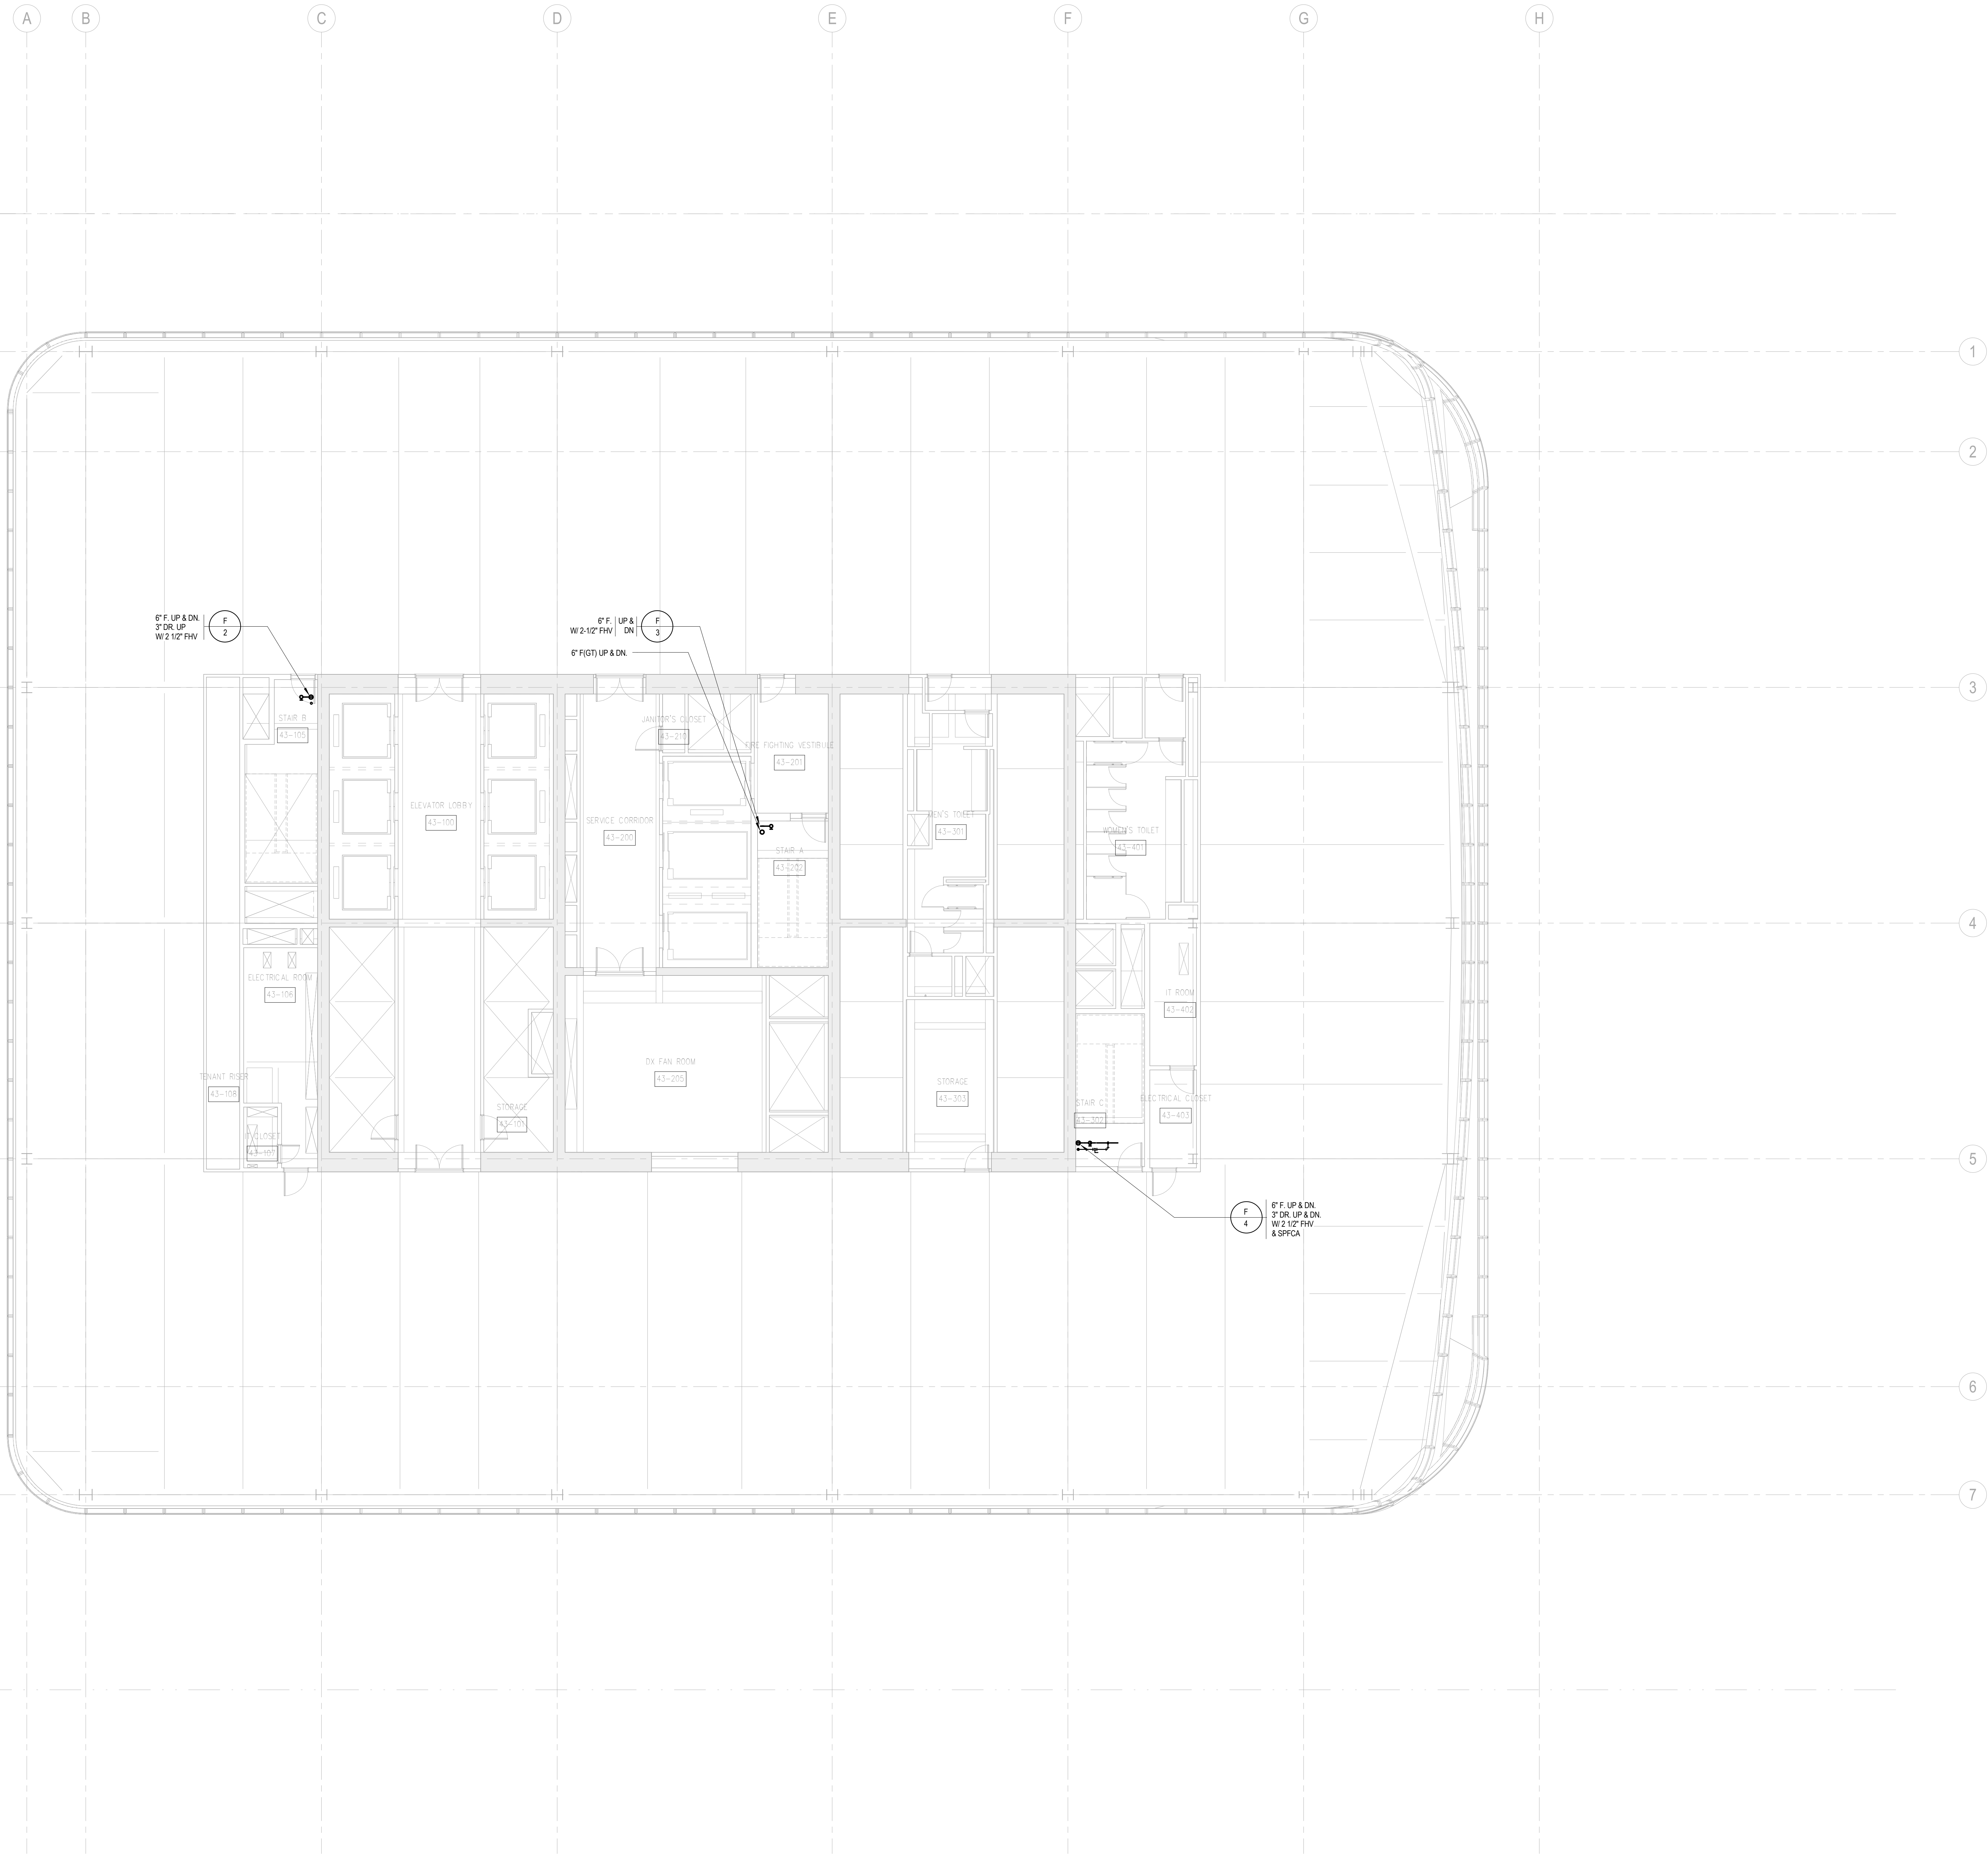
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**FIRE
PROTECTION
LEVEL 43-48
FLOOR PLAN -
TYPICAL
MID-RISE**

Project No.:	14830-A-000	Sheet No.:	FP-143
Date:	20 JUN 2014	B-SCAN Sheet No.:	FP-143
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Page No.:	FP-143		



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188 Ames Street, Hackensack, NJ 07601

Wind Tunnel Consultant

Rowan Williams Davies & Irwin Inc.
650 Woodlawn Road West, Guelph
Ontario, Canada N1K 1B8

Key Plan:



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2	20 JUN 2014	ISSUED FOR FOUNDATION PERMIT
1	19 NOV 2013	ISSUED FOR 60 PROGRESS PRICINGS
No.	Date	Description
Sheet Name:		

FIRE
PROTECTION
LEVEL 49 FLOOR
PLAN - MID-RISE
& HIGH-RISE

Project No.:

14830-A-000

Date:

20 JUN 2014

Scale:

1/8" = 1'-0"

File No.:

FP-149

Sheet No.:

FP-149

B-SCAN Sheet No.:

FP-149.00

Page No.:

FP-149

DEPT OF BLDGS 12187143 Job Number ES03030710 Sheet Code



MANHATTAN WEST:
NORTH TOWER
375 Ninth Avenue, New York, NY 10001

Client

Brookfield

Brookfield Place
250 Vesey Street, 15th Floor, New York, NY 10281

Architecture/Structural Engineering

SOM

Skidmore, Owings & Merrill LLP
14 Wall Street, New York, NY 10005

Civil Engineering

Philip Habib & Associates
102 Madison Avenue #11, New York, NY 10016

MEP Engineering

Jaros Baum & Bolles
80 Pine Street, New York, NY 10005

Vertical Transportation

Edgett Williams Consulting Group, Inc.
102 East Blithedale Ave. Suite 1, Mill Valley, California 94941

Sustainable Design

Viridian Energy & Environmental
50 Washington Street, Newark, CT 06854

Geo-Technical Engineering

Mueser Rutledge Consulting Engineers
14 Penn Plaza, 225 W. 34th Street #610,
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Landscape Consultant

Field Operations
475 10th Avenue, New York, NY 10018

Security Consultant

Ducibella, Ventor & Santore
250 State Street #F1, North Haven, CT 06473

Blast Consultant

Weidinger Associates, Inc.
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Acoustical Consultant

Cerami & Associates
404 Fifth Avenue #8, New York, NY 10018

Vibration Consultant

Wilson, Uhrig & Associates, Inc.
65 Broadway, Suite 401, New York, NY 10006

Code Consultant

Code Consultants Professional Engineers PC
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Wind Tunnel Consultant

Rowan Williams Davies & Irwin Inc.
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SHEET NOTES

Key Plan:



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4 20 JUN 2014 ISSUED FOR FOUNDATION PERMIT
3 15 NOV 2013 ISSUED FOR SD PROGRESS PERING
2 12 JUL 2013 ISSUED FOR 60% DESIGN DEVELOPMENT
1 19 MAR 2013 ISSUED FOR RECONCILIATION

No. Date Description
Sheet Name:

FIRE
PROTECTION
LEVEL 50-51
FLOOR PLAN -
HIGH-RISE
OVERRUN

Project No.:
14830-A-000

Date:
20 JUN 2014

Scale:
1/8" = 1'-0"

File No.:
FP-150

Sheet No.:

FP-150


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FP-150.00

Page No.:

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MANHATTAN WEST:
NORTH TOWER
375 Ninth Avenue, New York, NY 10001
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250 State Street #F1, North Haven, CT 06473

Blast Consultant
Weidinger Associates, Inc.
40 Wall Street, New York, NY 10005


Acoustical Consultant
Cerami & Associates
404 Fifth Avenue #8, New York, NY 10018
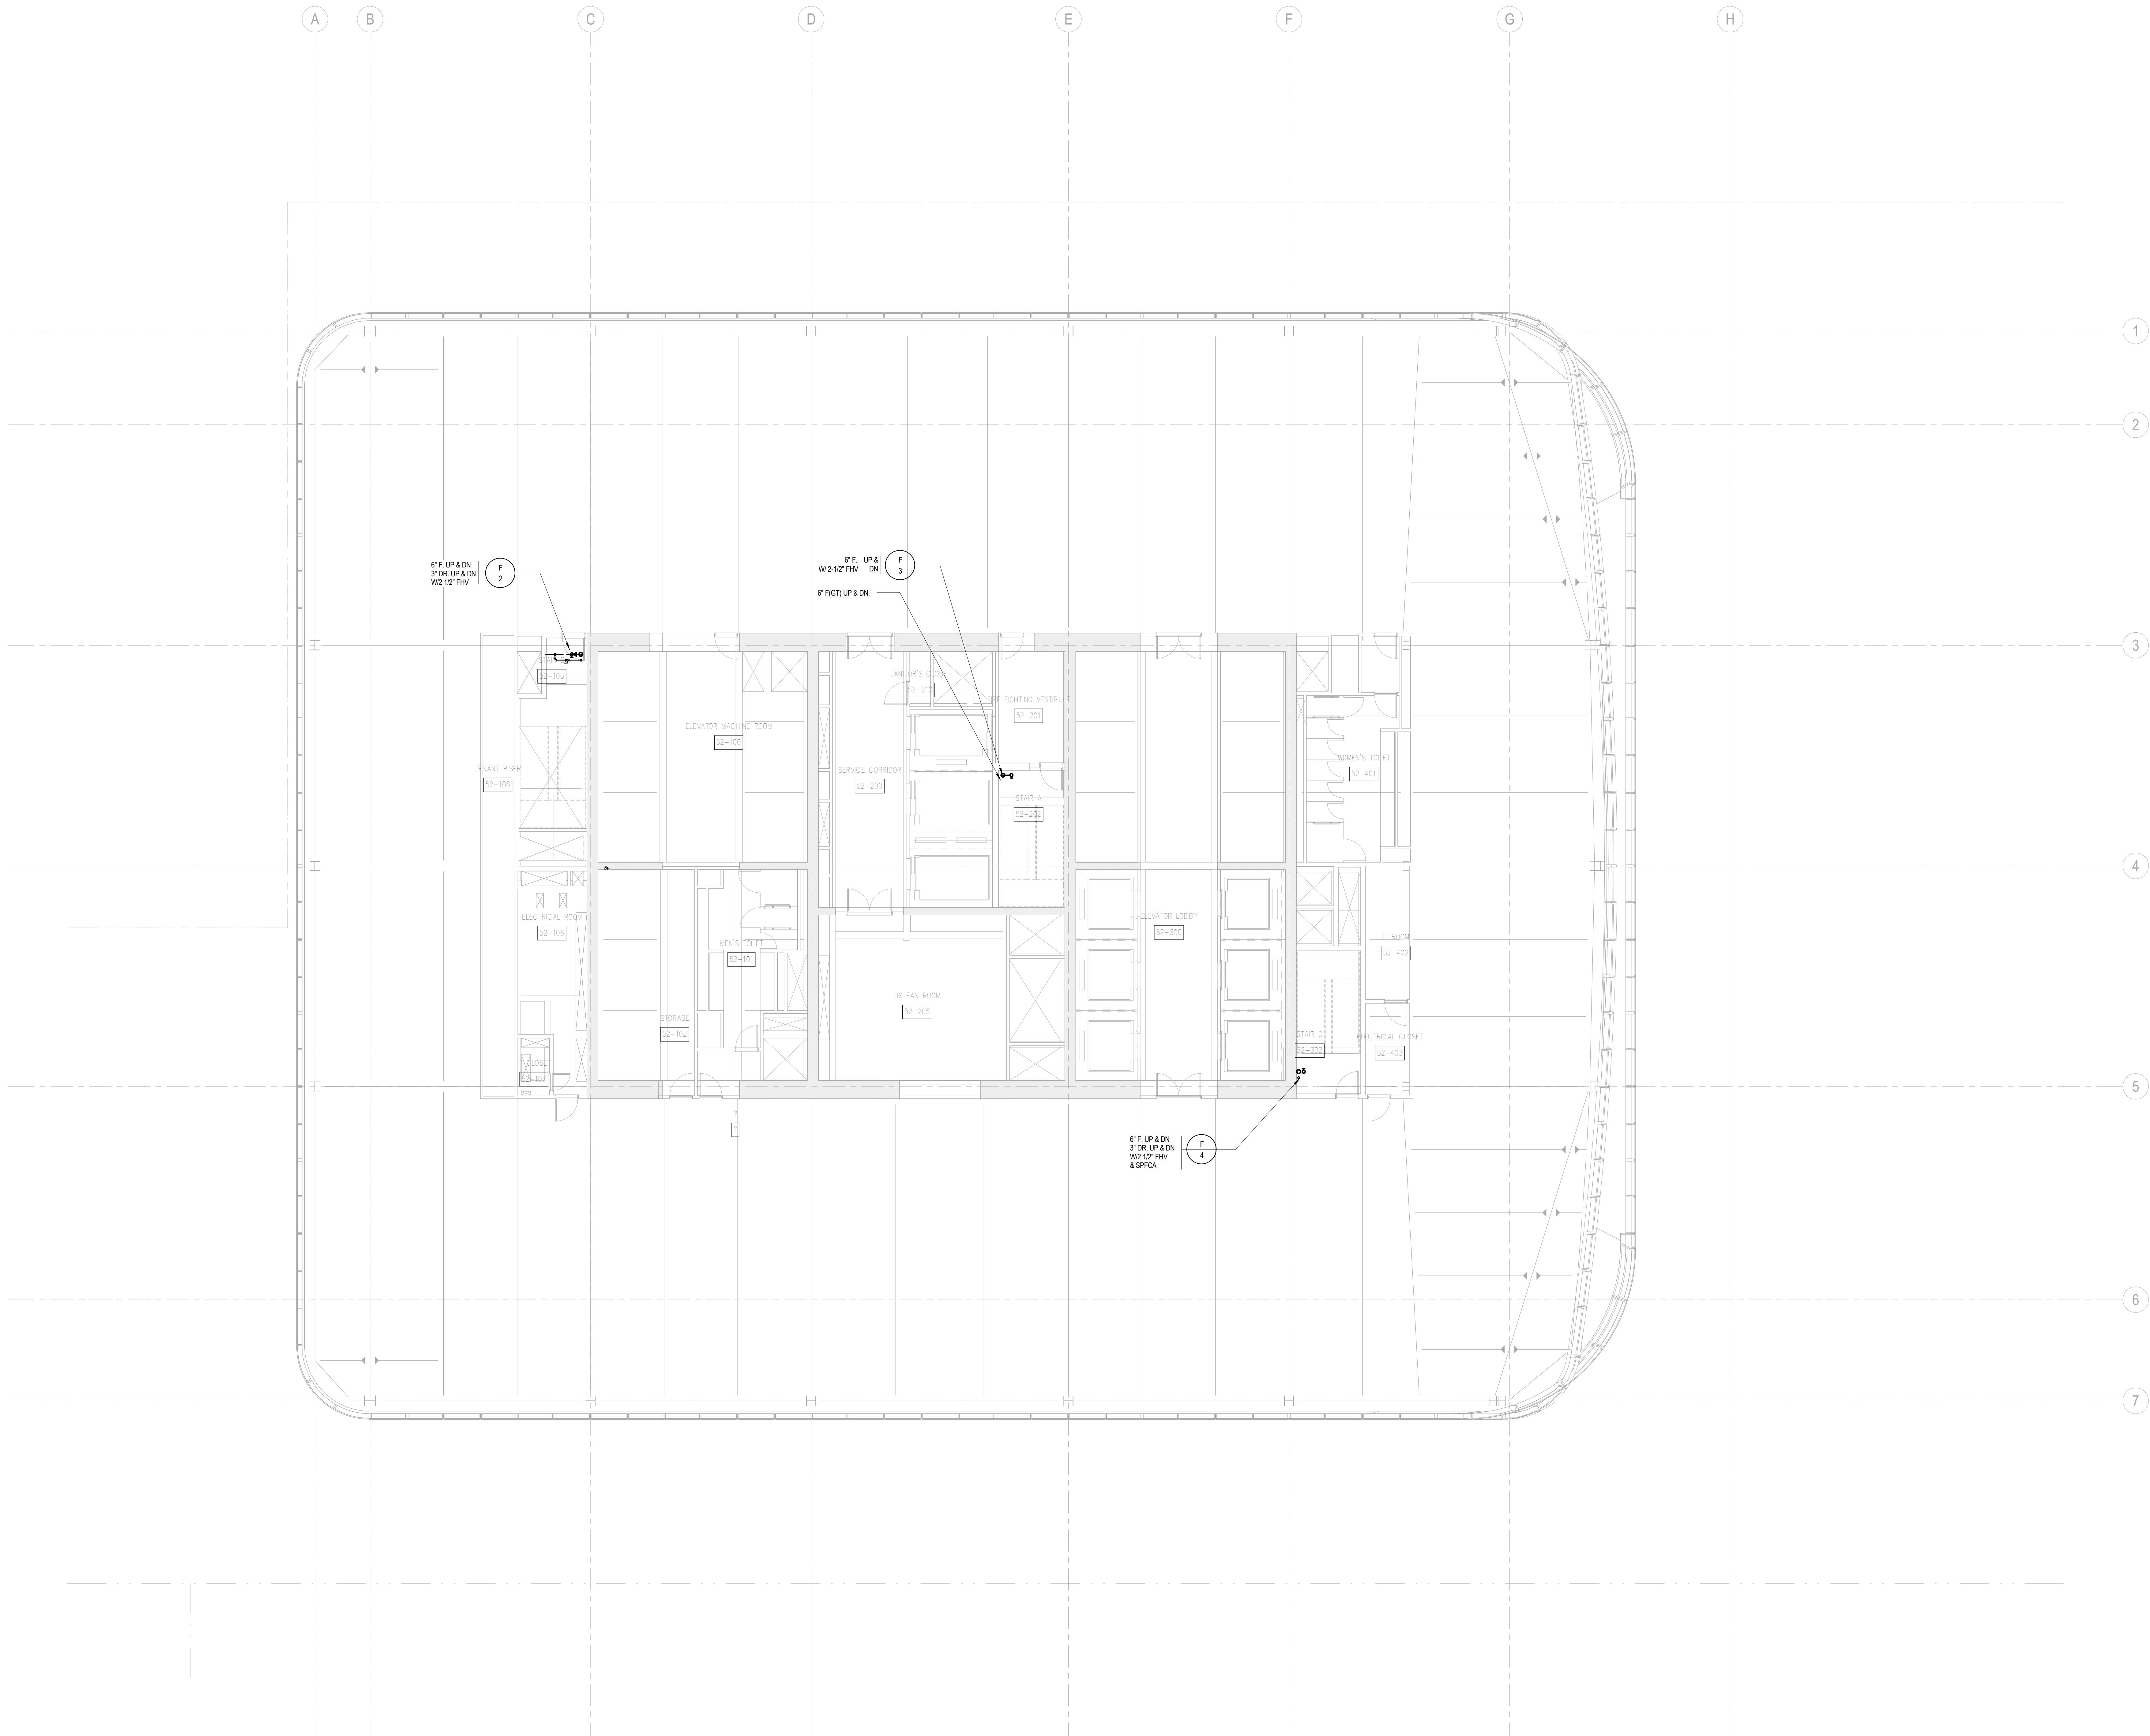
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Code Consultant
Code Consultants Professional Engineers PC
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Entek Engineering LLC
186 Ames Street, Hackensack, NJ 07601


Wind Tunnel Consultant
Rowan Williams Davies & Irwin Inc.
650 Woodlawn Road West, Guelph
Ontario, Canada N1K 1B8




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1	19 NOV 2013	ISSUED FOR 60 PROGRESS PRICINGS
No.	Date	Description
Sheet Name:		

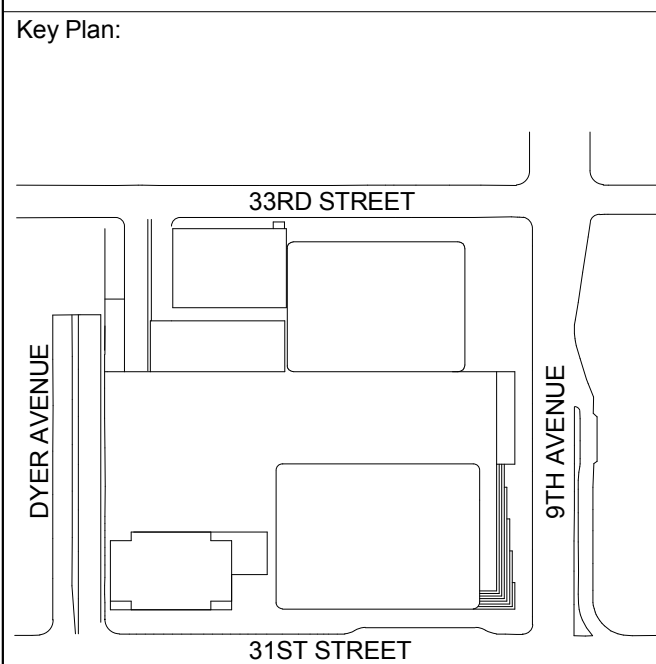**FIRE
PROTECTION
LEVEL 52 FLOOR
PLAN - HIGH-RISE
EMR**

Project No.: 14830-A-000	Sheet No.: FP-152
Date: 20 JUN 2014	B-SCAN Sheet No.: FP-152.00
Scale: 1/8" = 1'-0"	Page No.: FP-152
File No.: FP-152	

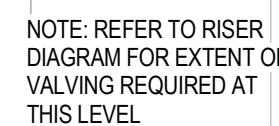

Project No.: 14890.A.000	Sheet No.: FP-153
Date: 20 JUN 2014	B-SCAN Sheet No.: FP-153.00
Scale: 1/8" = 1'-0"	
File No.: FP-153	Page No.:

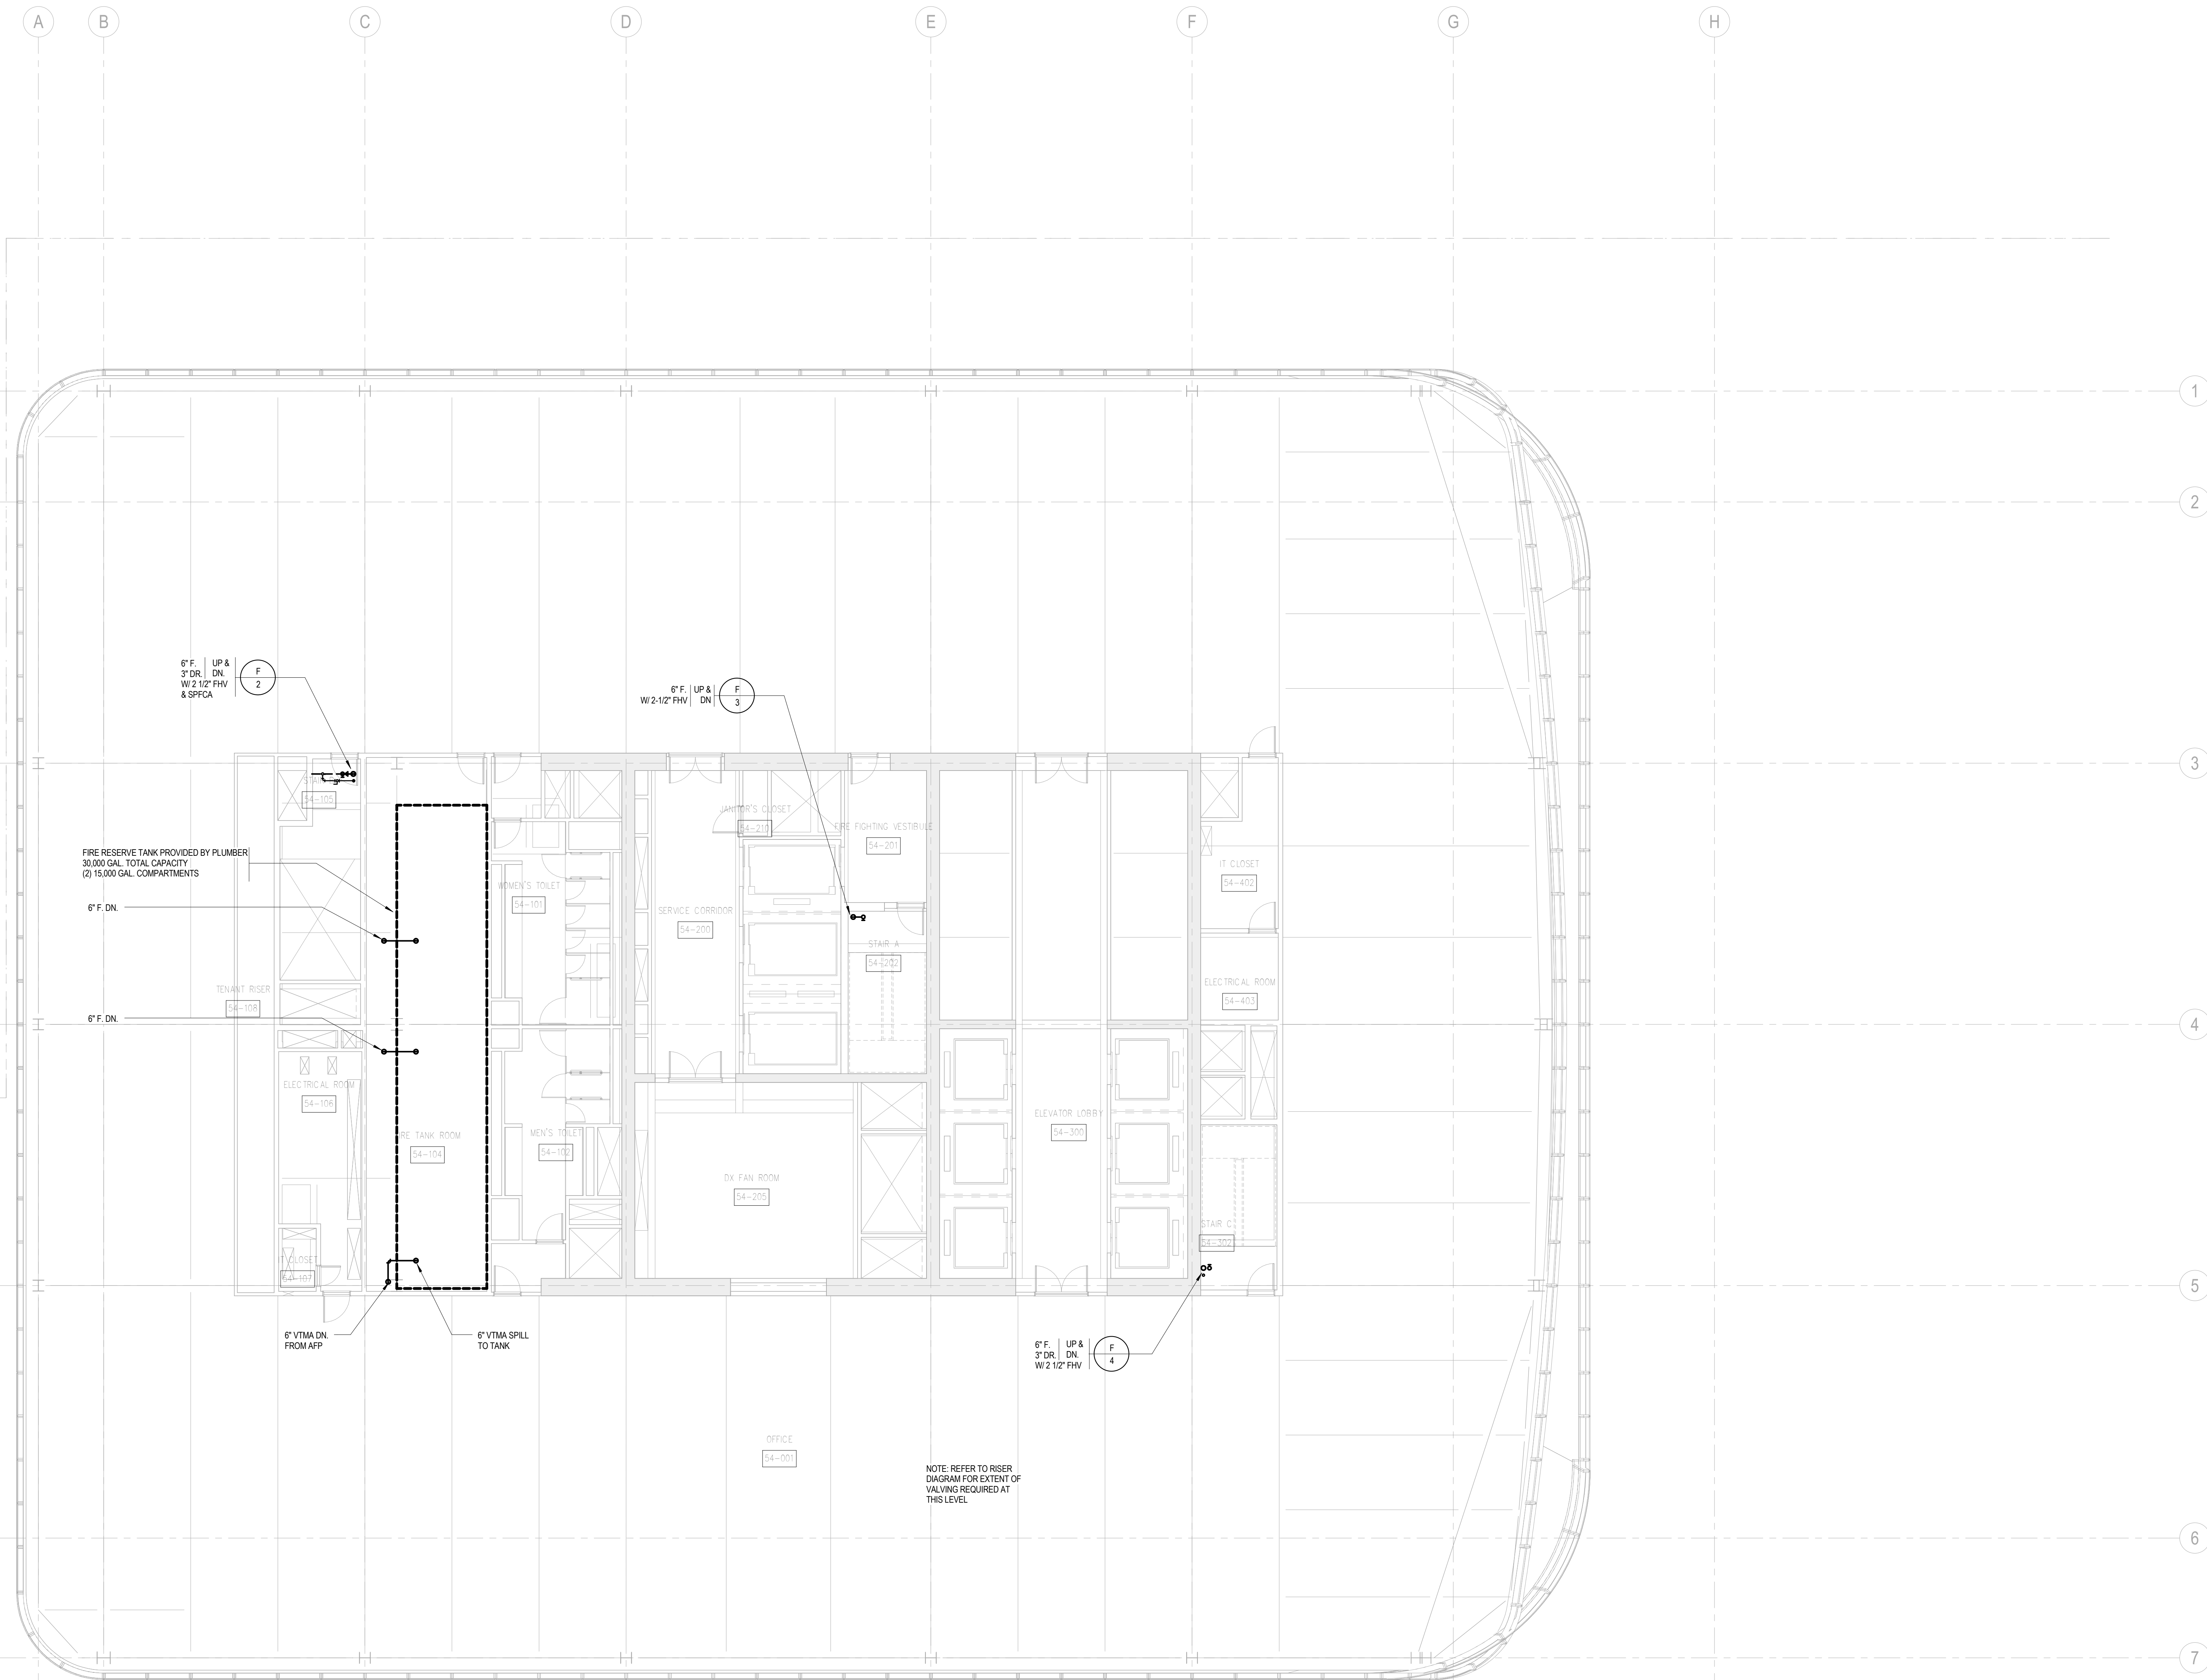

SHEET NOTES



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Weidinger Associates, Inc.
40 Wall Street, New York, NY 10005



Acoustical Consultant
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404 Fifth Avenue #8, New York, NY 10018

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No.	Date	Description
Sheet Name:		

FIRE
PROTECTION
LEVEL 54 FLOOR
PLAN - HIGH-RISE
WATER TANK

Project No.: 14830-A-000	Sheet No.: FP-154
Date: 20 JUN 2014	B-SCAN Sheet No.: FP-154.00
Scale: 1/8" = 1'-0"	Page No.: FP-154
File No.: FP-154	

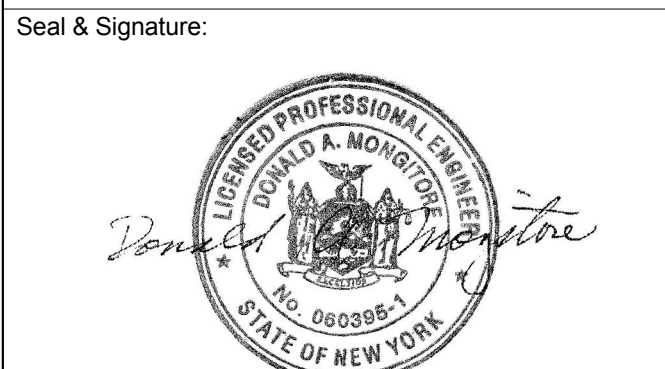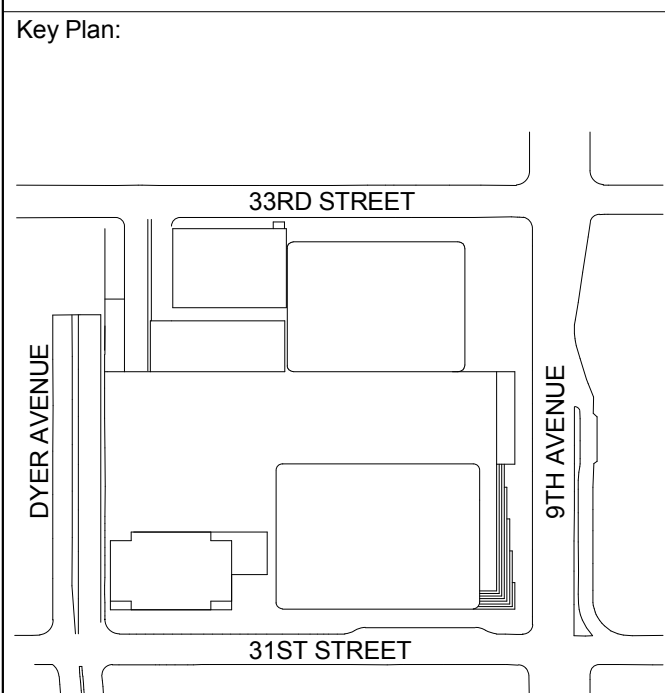

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215 West 40th Street, 15th Floor, New York, NY 10018


Facade Maintenance Consultant

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Wind Tunnel Consultant

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Ontario, Canada N1K 1B8

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1	19 NOV 2013	ISSUED FOR DD PROGRESS PRICING
No.	Date	Description
Sheet Name:		

FIRE
PROTECTION
LEVEL 55 FLOOR
PLAN - HIGH-RISE

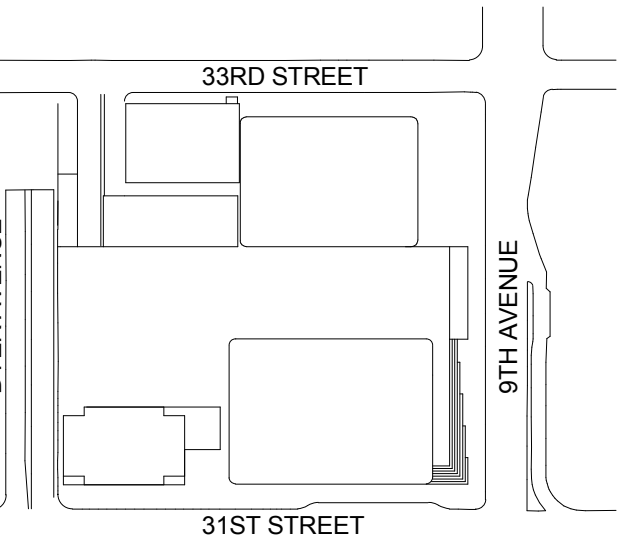Project No.:

14830-A-000

Date:

20 JUN 2014

Scale:

1/8" = 1'-0"

File No.:

FP-155

Sheet No.:

FP-155

B-SCAN Sheet No.:

Page No.:



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650 Woodlawn Road West, Guelph
Ontario, Canada N1K 1B8

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2	20 JUN 2014	ISSUED FOR FOUNDATION PERMIT
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No.	Date	Description
Sheet Name:		

**FIRE
PROTECTION
LEVEL 57-58
FLOOR PLAN -
TYPICAL
HIGH-RISE**

Project No.:

14830-A-000

Date:

20 JUN 2014

Scale:

1/8" = 1'-0"

File No.:

FP-157

Sheet No.:

FP-157

B-SCAN Sheet No.:

Page No.:



MANHATTAN WEST:
NORTH TOWER

375 Ninth Avenue, New York, NY 10001

Client

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250 Vesey Street, 15th Floor, New York, NY 10281

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Vibration Consultant

Wilson, Uhrig & Associates, Inc.
65 Broadway, Suite 401, New York, NY 10006

Code Consultant

Code Consultants Professional Engineers PC
215 West 40th Street, 15th Floor, New York, NY 10018


Facade Maintenance Consultant

Entek Engineering LLC
188 Ames Street, Hackensack, NJ 07601

Wind Tunnel Consultant

Rowan Williams Davies & Irwin Inc.
650 Woodlawn Road West, Guelph
Ontario, Canada N1K 1B8

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Sheet Name:		

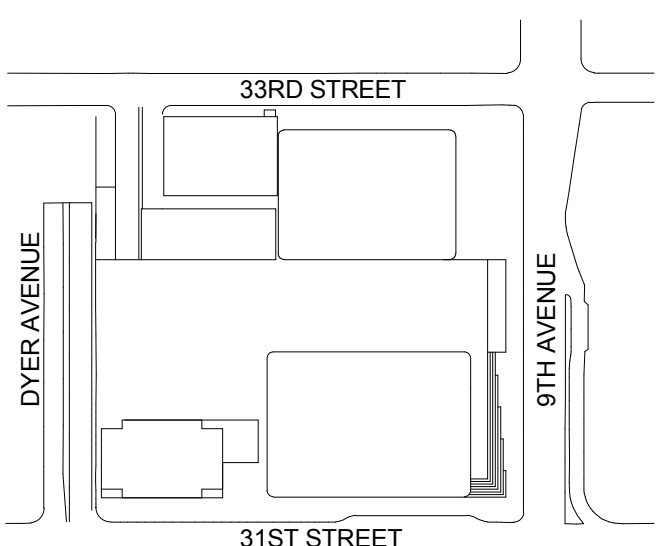FIRE
PROTECTION
LEVEL 59 FLOOR
PLAN - HIGH-RISE

Project No.:
14830-A.000

Date:
20 JUN 2014

Scale:
1/8" = 1'-0"

File No.:
FP-159

Sheet No.:

FP-159

B-SCAN Sheet No.:

FP-159.00

Page No.:



MANHATTAN WEST:
NORTH TOWER
375 Ninth Avenue, New York, NY 10001
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Brookfield
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Vibration Consultant

Wilson, Uhrig & Associates, Inc.
65 Broadway, Suite 401, New York, NY 10006

Code Consultant

Code Consultants Professional Engineers PC
215 West 40th Street, 15th Floor, New York, NY 10018


Facade Maintenance Consultant

Entek Engineering LLC
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2	20 JUN 2014	ISSUED FOR FOUNDATION PERMIT
1	19 NOV 2013	ISSUED FOR 60 PROGRESS PRICINGS
No.	Date	Description

Sheet Name:

FIRE
PROTECTION
LEVEL 60-61
FLOOR PLAN -
HIGH-RISE
OVERRUN

Project No.:

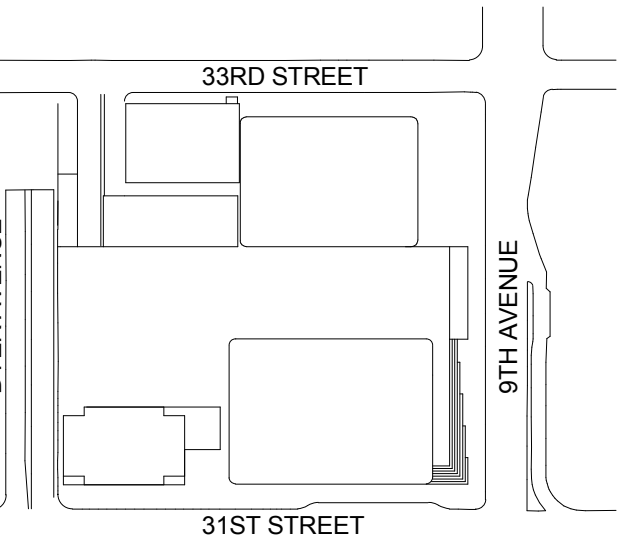Sheet No.:

Date:

FP-160

Scale:

B-SCAN Sheet No.:

File No.:

Page No.:



MANHATTAN WEST:
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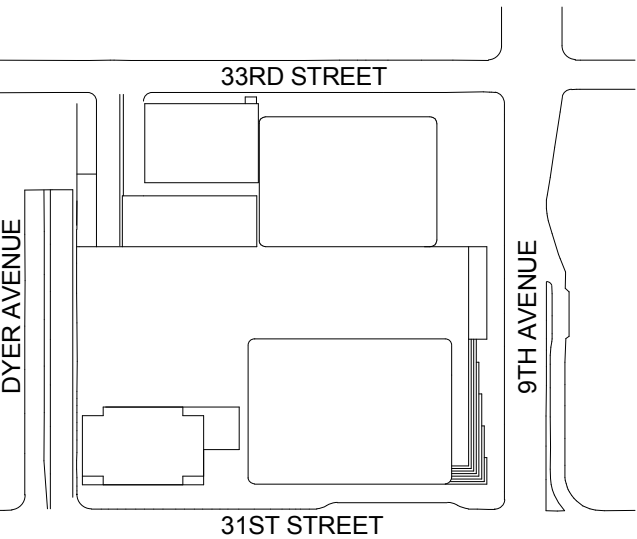
Facade Maintenance Consultant

Entek Engineering LLC
186 Ames Street, Hackensack, NJ 07601

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650 Woodlawn Road West, Guelph
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1	19 NOV 2013	ISSUED FOR DD PROGRESS PRICING
No.	Date	Description
Sheet Name:		

**FIRE
PROTECTION
LEVEL 63 FLOOR
PLAN - HIGH-RISE**

Project No.:

14830-A-000

Date:

20 JUN 2014

Scale:

1/8" = 1'-0"

File No.:

FP-163

Sheet No.:

FP-163

B-SCAN Sheet No.:

FP-163.00

Page No.:

1

DEPT OF BLDGS 12187143 Job Number ES2014-0680 08/01/2014



MANHATTAN WEST:
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Key Plan:



Seal & Signature:



4 20 JUN 2014 ISSUED FOR FOUNDATION PERMIT
3 15 NOV 2013 ISSUED FOR 50% PROGRESS PERING
2 12 JUL 2013 ISSUED FOR 60% DESIGN DEVELOPMENT
1 19 MAR 2013 ISSUED FOR RECONCILIATION

No. Date Description
Sheet Name:


**FIRE
PROTECTION
LEVEL 64-67
FLOOR PLAN -
TYPICAL
HIGH-RISE**

Project No.: 14830-A-000 Sheet No.: **FP-164**

Date: 20 JUN 2014 B-SCAN Sheet No.: **FP-164.00**

Scale: 1/8" = 1'-0" File No.: **FP-164**

Page No.: **FP-164**

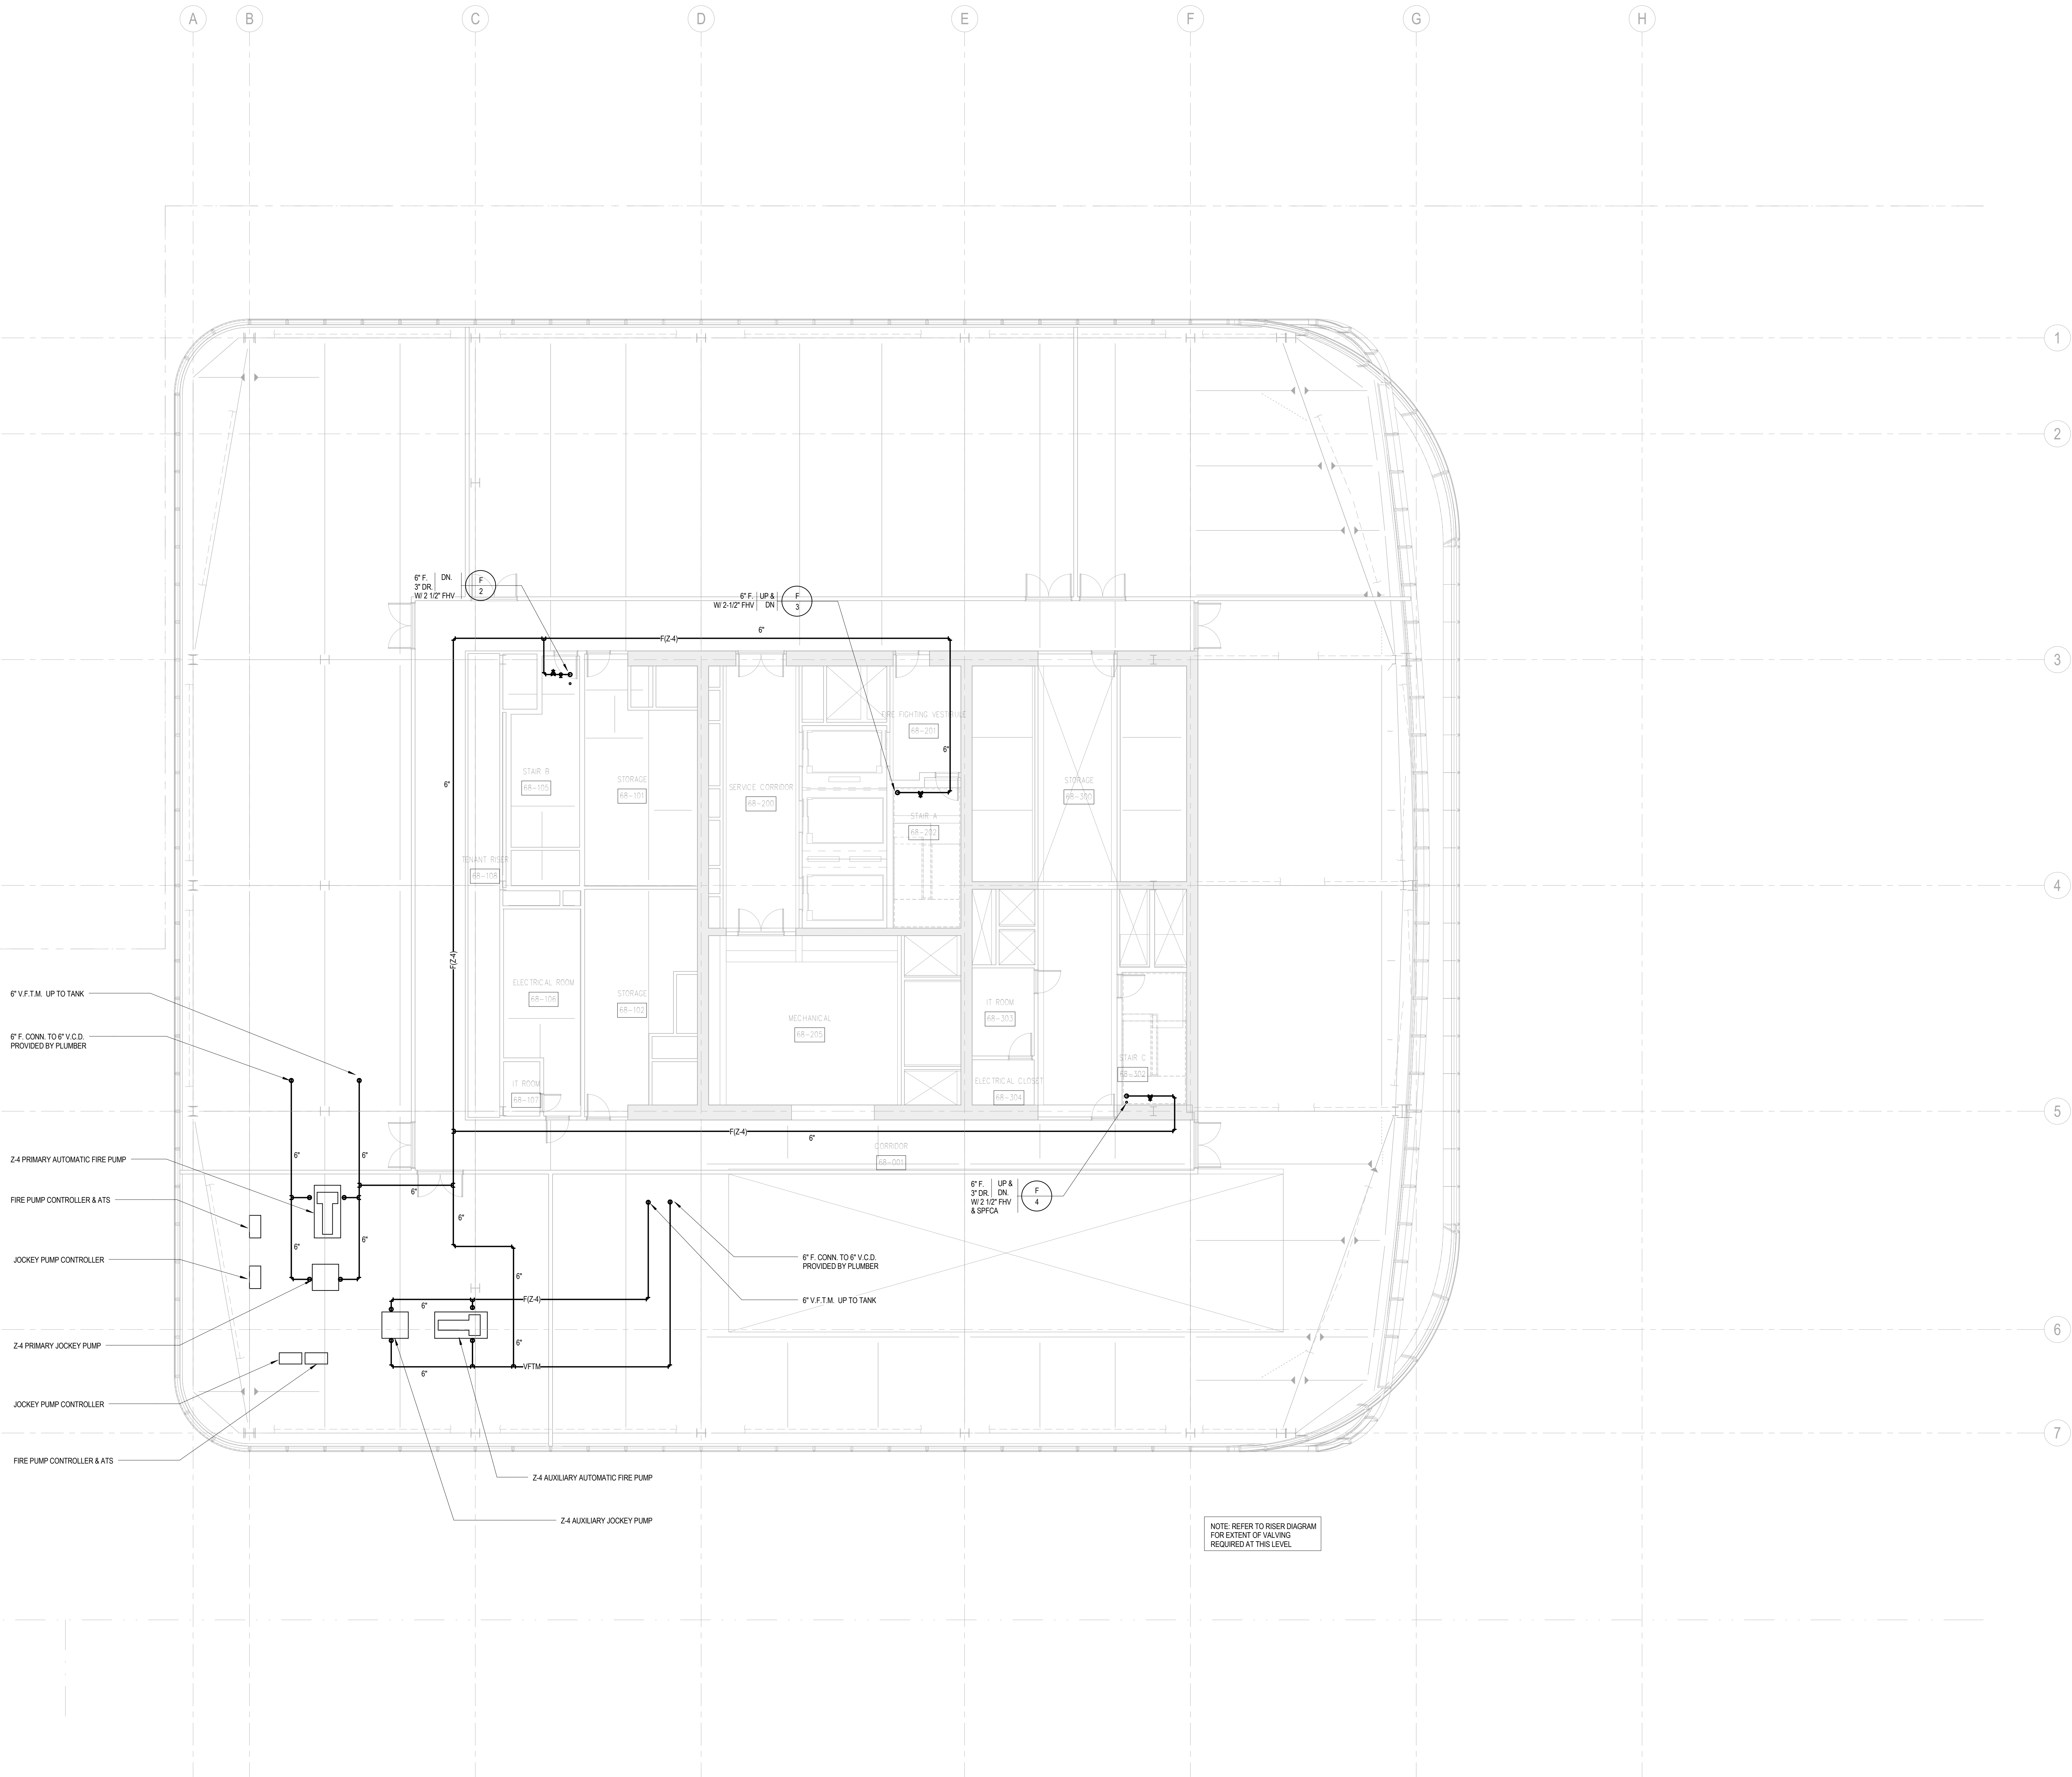



MANHATTAN WEST:
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Key Plan:



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No.	Date	Description
Sheet Name:		

**FIRE
PROTECTION
LEVEL 69 FLOOR
PLAN -
MECHANICAL
MEZZANINE**

Project No.:

14830-A-000

Date:

20 JUN 2014

Scale:

1/8" = 1'-0"

File No.:

FP-169

Sheet No.:


FP-169

B-SCAN Sheet No.:

FP-169.00

Page No.:

FP-169

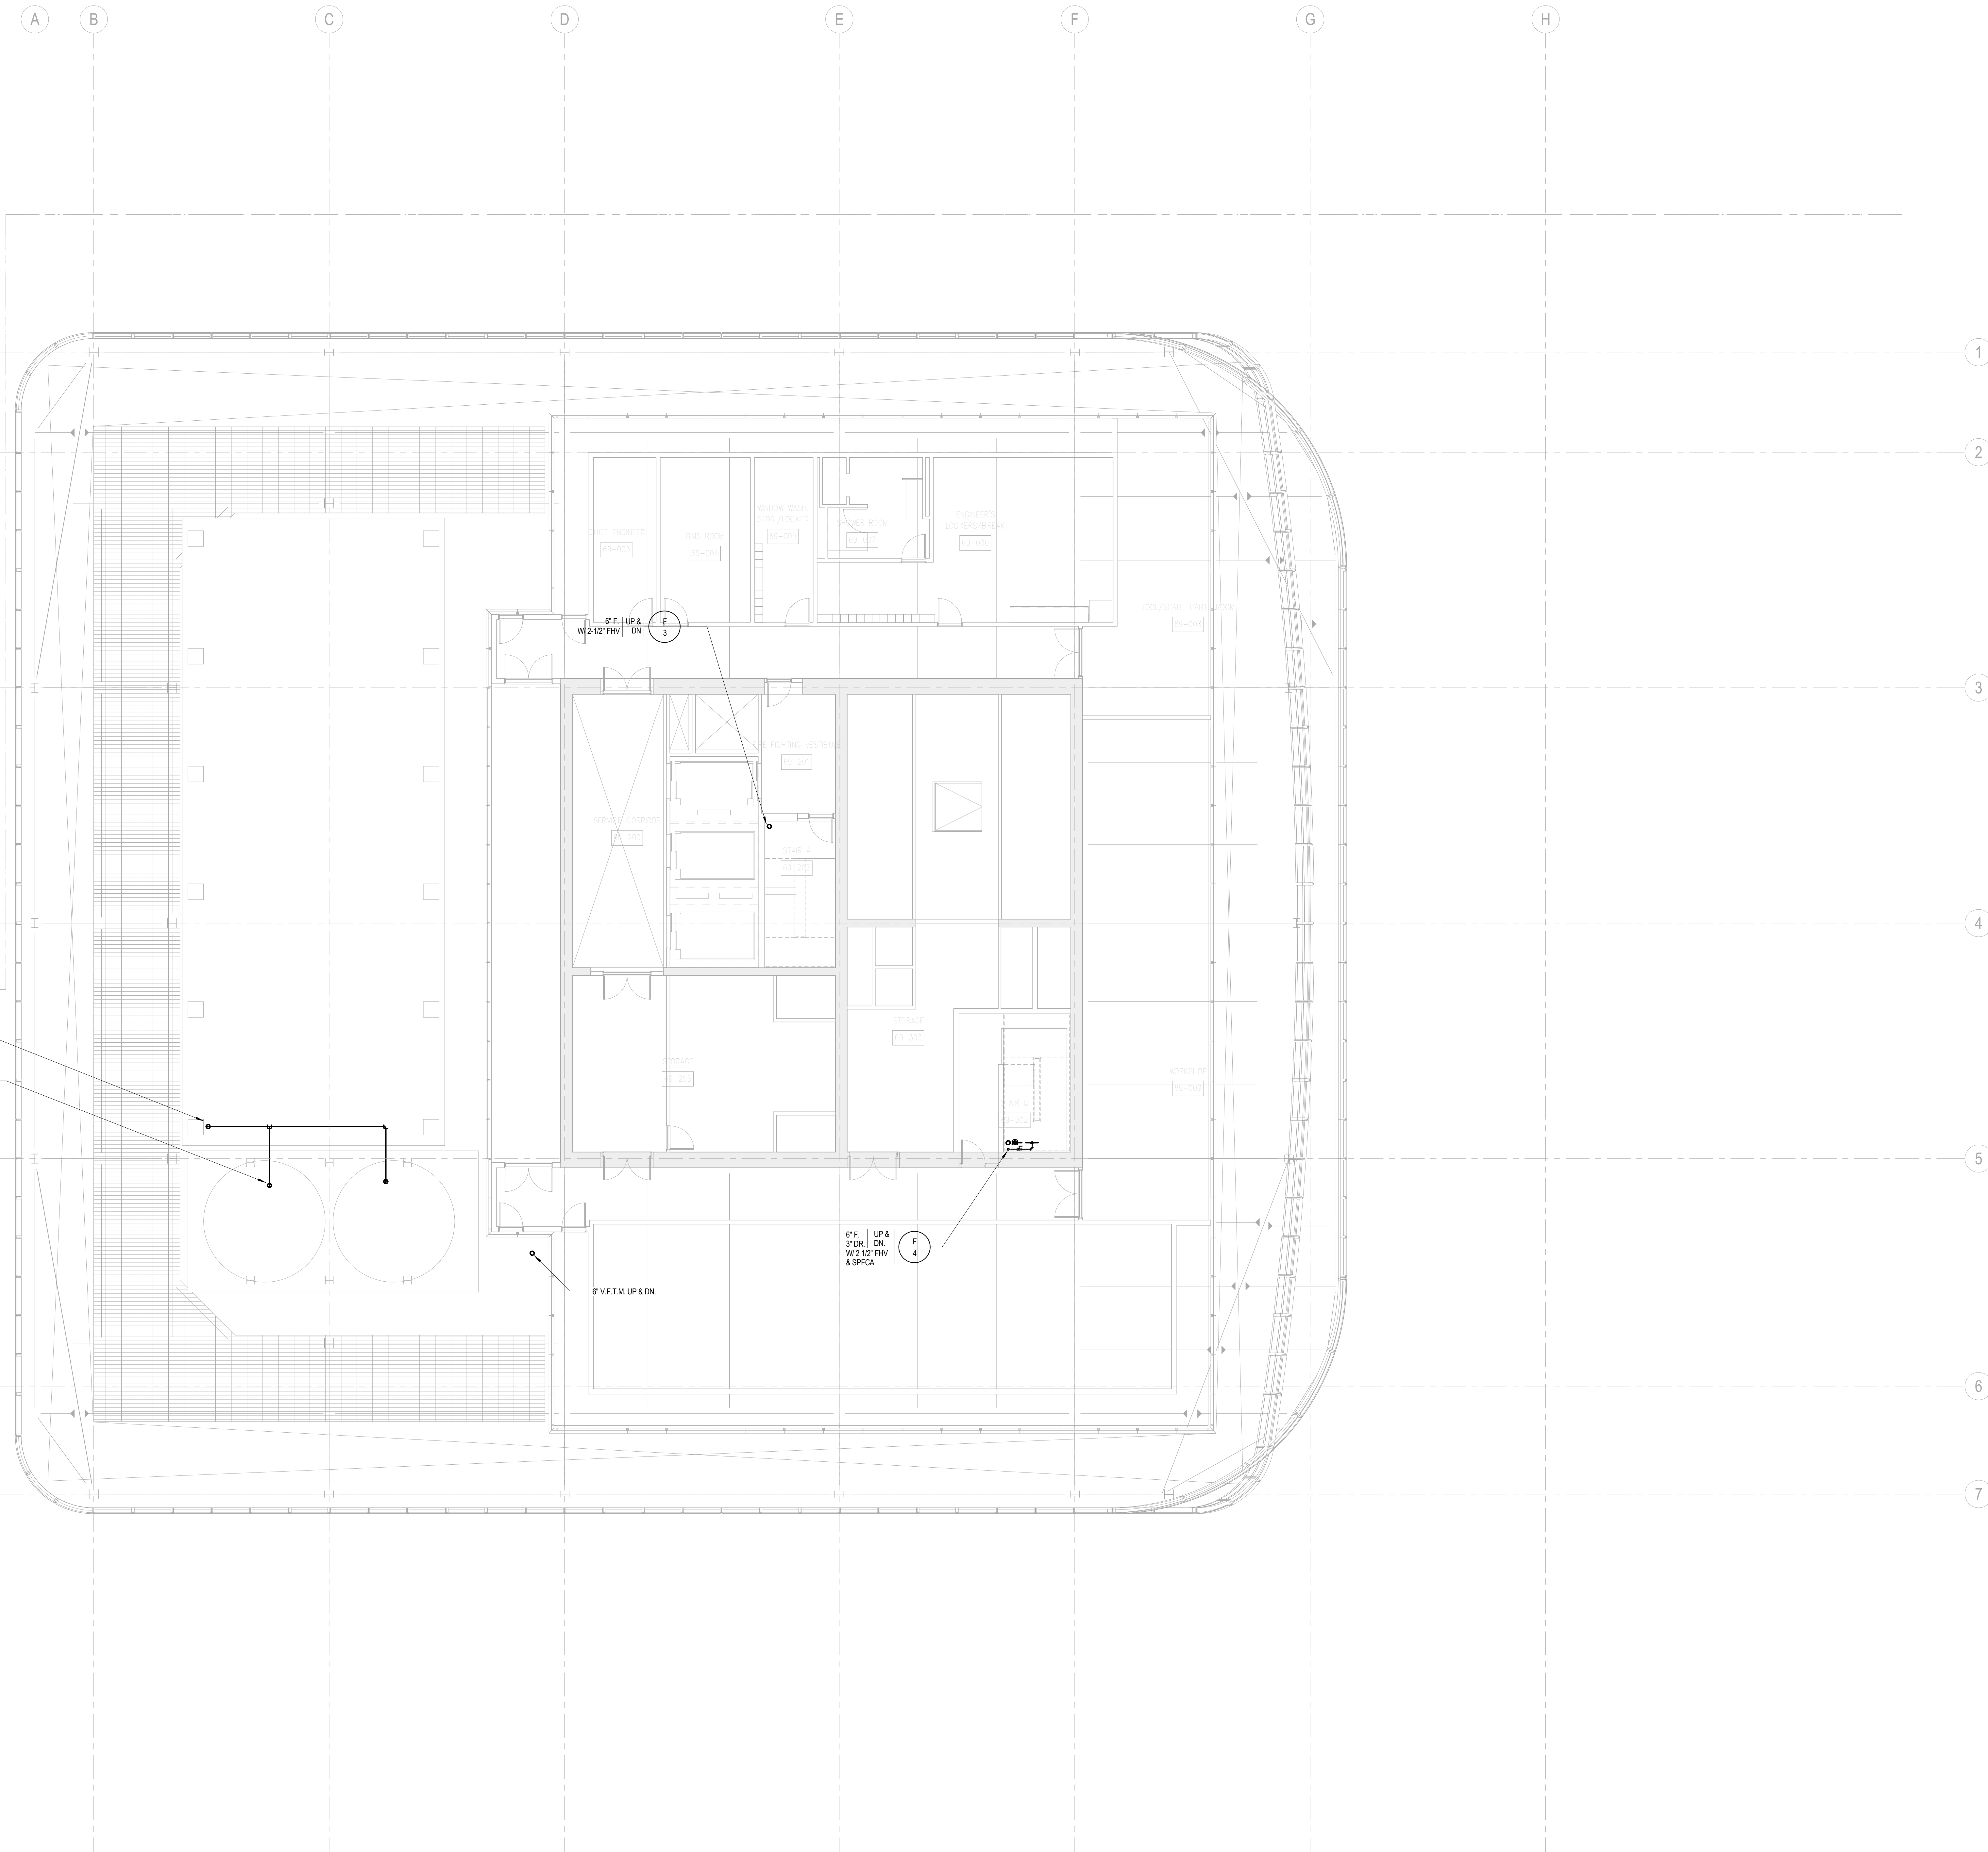

6" V.F.T.M. DN FROM Z-4
PRIMARY APP DISCHARGE

6" V.F.T.M. SPILL TO TANK
(TRIP FORCE)

6" V.F.T.M. UP & DN

6" F. UP &
3" DR. DN
W/2-1/2" RHV
& SPICA

F
4

SHEET NOTES



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102 Madison Avenue #11, New York, NY 10016

MEP Engineering

Jaros Baum & Bolles
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Vertical Transportation

Edgett Williams Consulting Group, Inc.
102 East Blithedale Ave., Suite 1, Mill Valley, California 94041

Sustainable Design

Viridian Energy & Environmental
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14 Penn Plaza, 225 W. 34th Street #610,
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Landscape Consultant

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Security Consultant

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Cerami & Associates
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Vibration Consultant

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Entek Engineering LLC
186 Ames Street, Hackensack, NJ 07601

Wind Tunnel Consultant

Rowan Williams Davies & Irwin Inc.
650 Woodlawn Road West, Guelph
Ontario, Canada N1K 1B8

Key Plan:



Seal & Signature:



4 20 JUN 2014 ISSUED FOR FOUNDATION PERMIT
3 15 NOV 2013 ISSUED FOR 50% PROGRESS PERING
2 12 JUL 2013 ISSUED FOR 60% DESIGN DEVELOPMENT
1 19 MAR 2013 ISSUED FOR RECONCILIATION

No. Date Description
Sheet Name:

**FIRE
PROTECTION
ROOF PLAN -
MECHANICAL
PENTHOUSE**

Project No.:
14839A.000

Date:
20 JUN 2014

Scale:
1/8" = 1'-0"

File No.:
FP-170

Sheet No.:

FP-170

B-SCAN Sheet No.:

FP-170.00

Page No.:

A1 A B B.7 C C.8 D D.6 E E.3 F F.2 G G.5 H J J.3 K K.2 K.7 L

SHEET NOTES



MANHATTAN WEST:
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375 Ninth Avenue, New York, NY 10001

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Key Plan:



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Project No.: 14830 A-000
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B-SCAN Sheet No.:
FP-199B1-A

Sheet No.:
FP-197.00

Page No.:
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Date: 16 NOV 2013
Scale: 1/8" = 1'-0"

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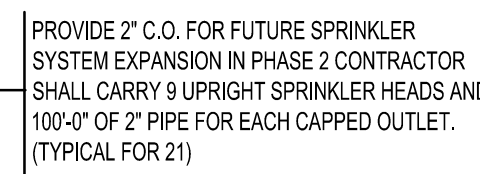
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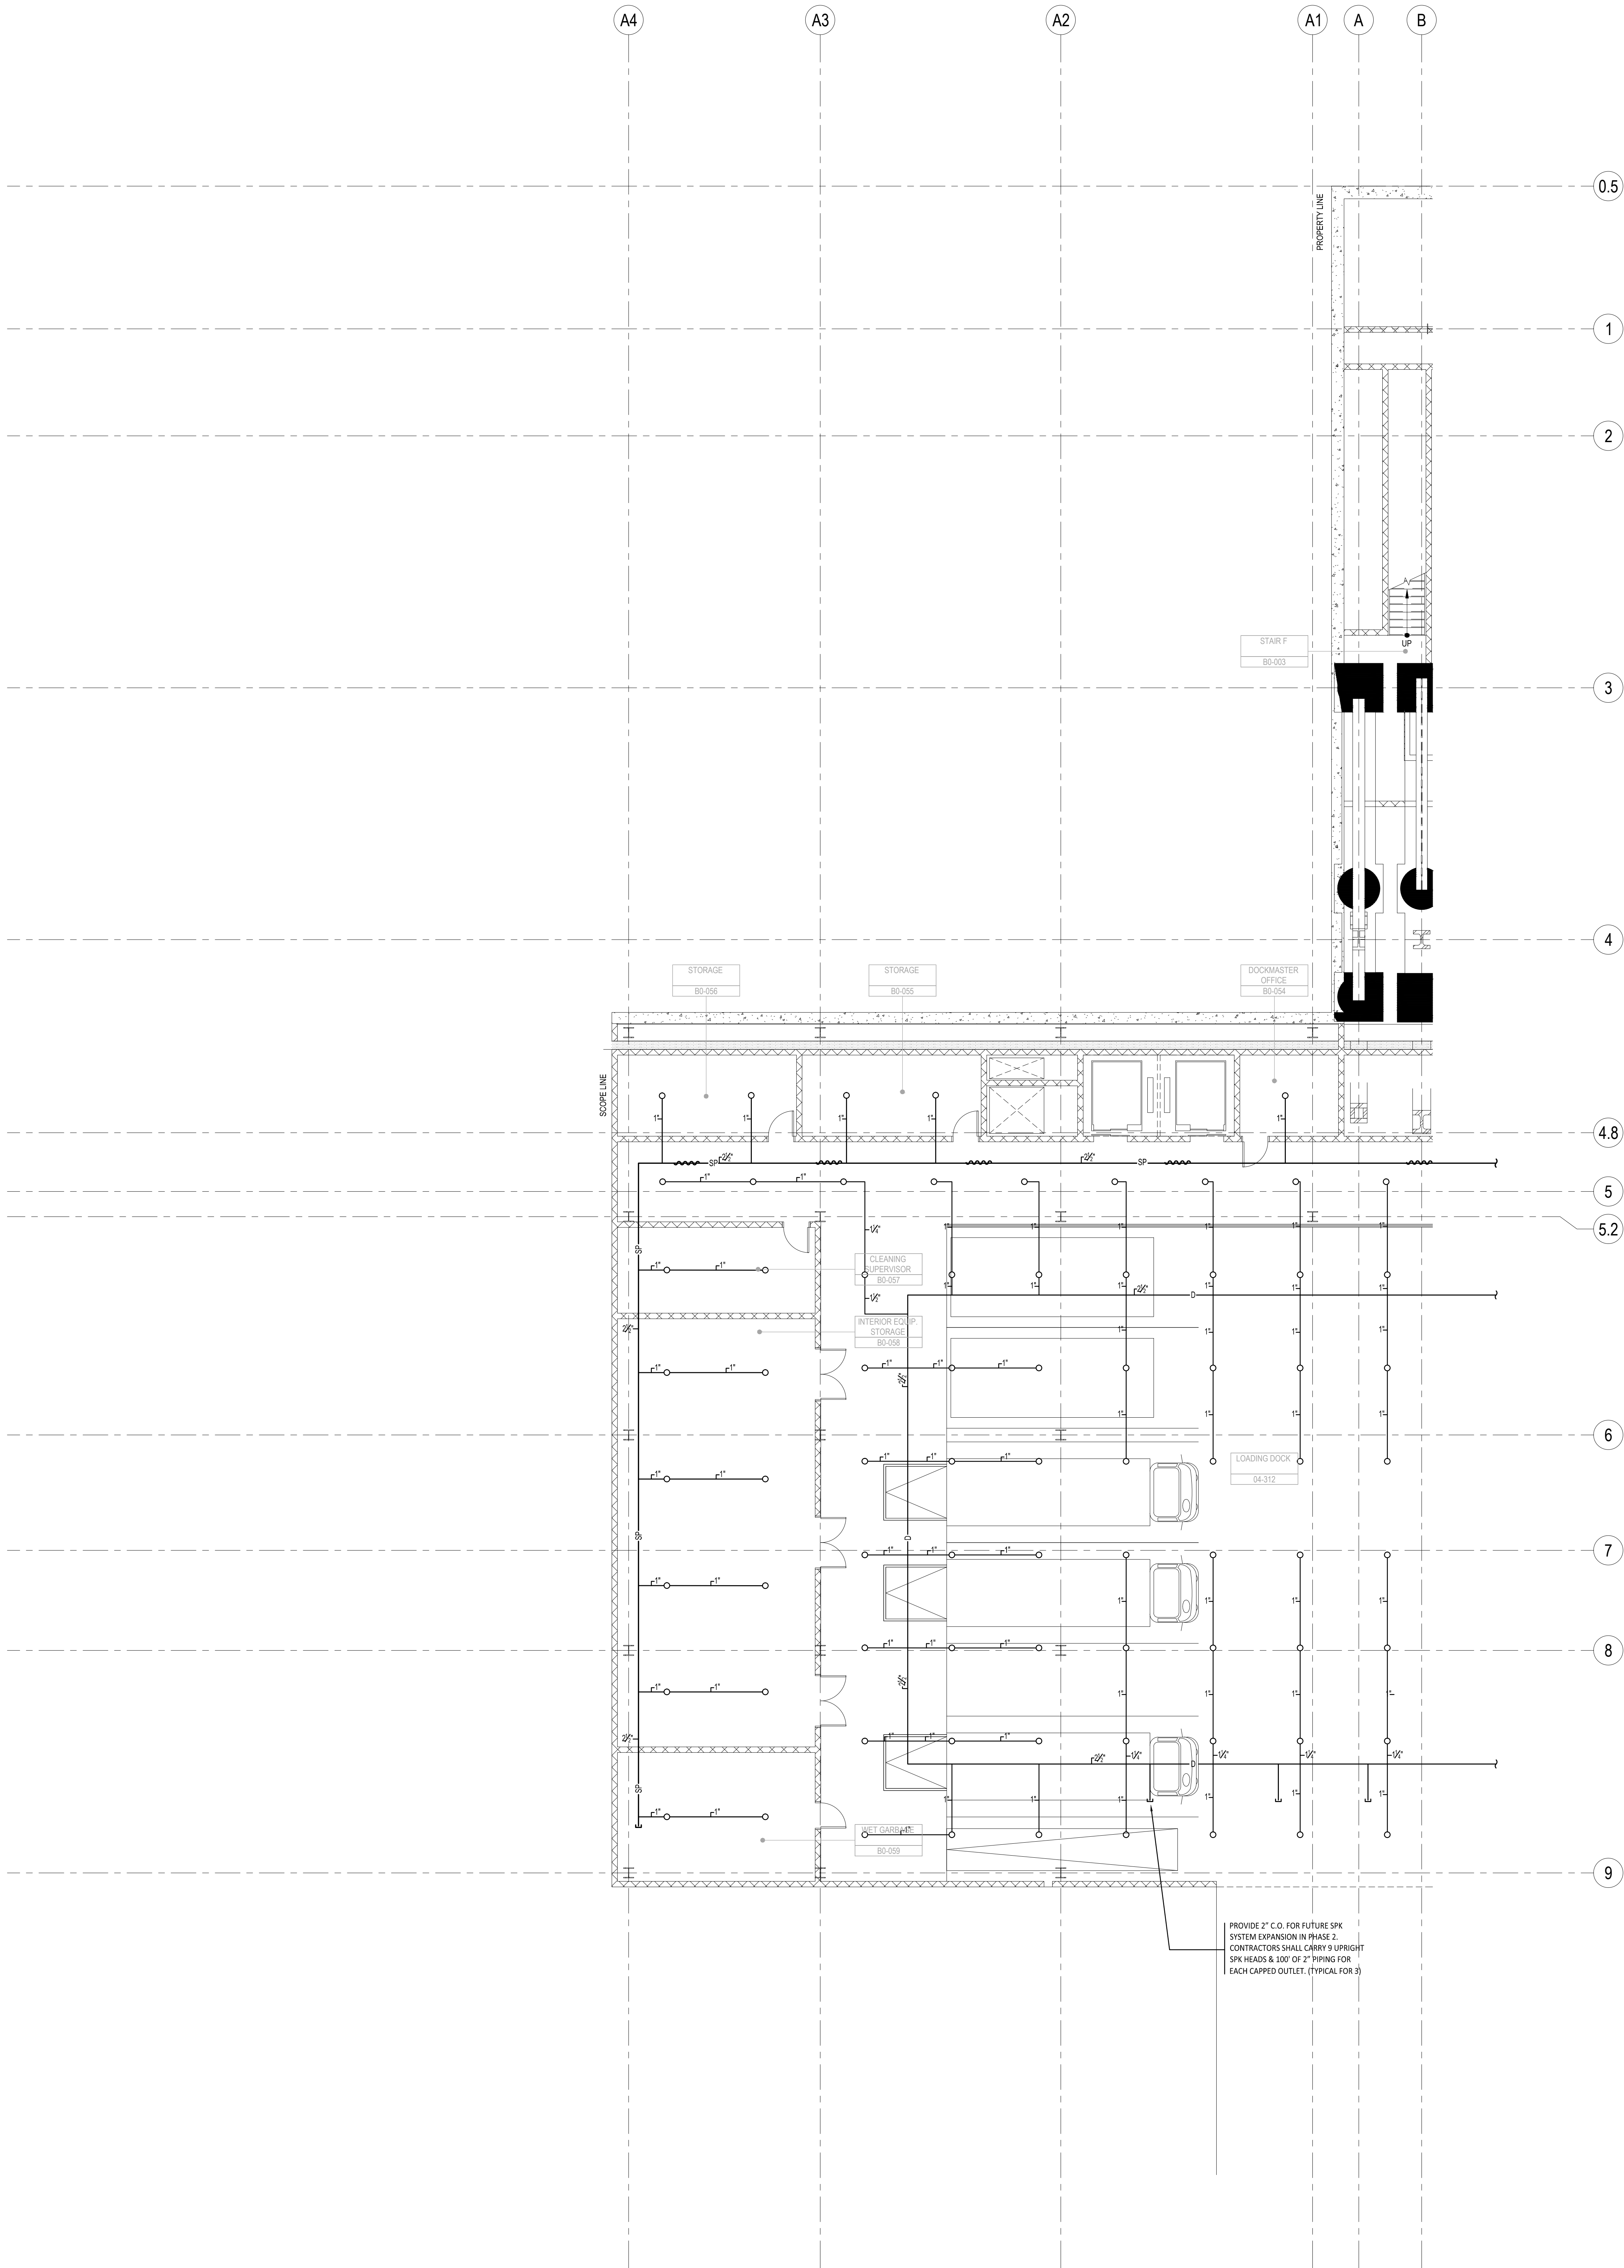
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
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SHEET NOTES



**MANHATTAN WEST:
NORTH TOWER**
375 Ninth Avenue, New York, NY 10001

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Brookfield
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Blast Consultant
Weidinger Associates, Inc.
40 Wall Street, New York, NY 10005

Acoustical Consultant
Cerami & Associates
404 Fifth Avenue #8, New York, NY 10018


Vibration Consultant
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65 Broadway, Suite 401, New York, NY 10006

Code Consultant
Code Consultants Professional Engineers PC
215 West 40th Street, 15th Floor, New York, NY 10018


Facade Maintenance Consultant
Entek Engineering LLC
166 Ames Street, Hackensack, NJ 07601

Wind Tunnel Consultant
Rowan Williams Davies & Irwin Inc.
650 Woodlawn Road West, Guelph
Ontario, Canada N1K 1B9

Key Plan:

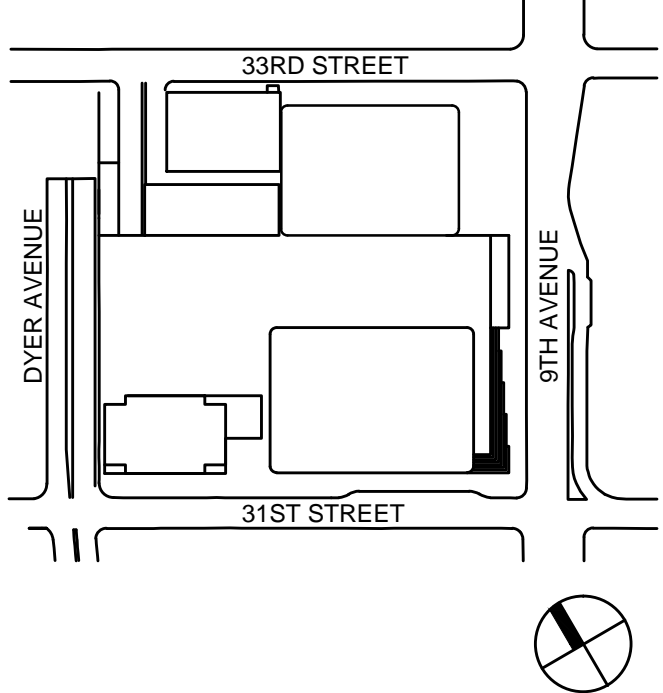

Seal & Signature:




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4	20 DEC 2013	ISSUED FOR FOUNDATION PERMIT
3	15 NOV 2013	ISSUED FOR DESIGN PROGRESS PRICING
2	12 JUL 2013	ISSUED FOR RPA DESIGN DEVELOPMENT
1	15 MAR 2013	ISSUED FOR RECONSTRUCTION

Sheet Name:

**FIRE PROTECTION
CELLAR B FLOOR
SPRINKLER PLAN -
PART B**

Project No.:	B-SCAN Sheet No.:
14830 A-000	FP-200B-B
Date: 15 NOV 2013	Sheet No.: FP-199.00
Scale: 1/8" = 1'-0"	Page No.:
File No.: FP-200B-B	

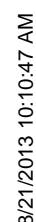

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Client:

Discussion

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Ontario, Canada N1K 1B8

Key Plan:

33RD STREET

REVUE

REVUE

DYER 9TH AV

A street map showing the intersection of 31st Street and a road labeled "31ST STREET". The map includes a compass rose indicating North (N) and a scale bar.

Seal & Signature:



5	20 JUN 2014	ISSUED FOR FOUNDATION PERMIT
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3	15 NOV 2013	ISSUED FOR DD PROGRESS PRICING

No.	Date	Description
Sheet Name:		
FIRE PROTECTION		

GROUND FLOOR
SPRINKLER PLAN -

PART A

Project No.: 14830.A.000	B-SCAN Sheet No.: B-301-A
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15 NOV 2013	Sheet No.: FP-200.00
Scale: 1/8" = 1'-0"	
File No.:	Page No.:

SHEET NOTES



MANHATTAN WEST:
NORTH TOWER

375 Ninth Avenue, New York, NY 10001

6

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Vibration Consulta

Wilson, Uhrig & Associates, Inc.
65 Broadway, Suite 401, New York, NY 10006

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Code Consultants Professional Engineers PC
215 West 40th Street 15th Floor New York, NY 10018


Escade Maintenance Consultant

Entek Engineering LLC
168 Ames Street, Hackensack, NJ 07601

Wind Tunnel Consult

Rowan Williams Davies & Irwin Inc.
650 Woodlawn Road West, Guelph
Ontario, Canada N1H 2T5

Key Plan

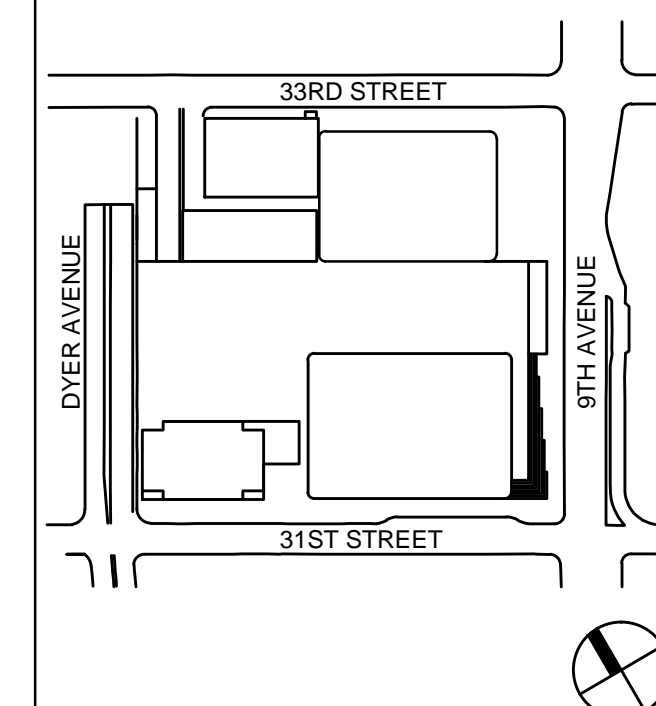

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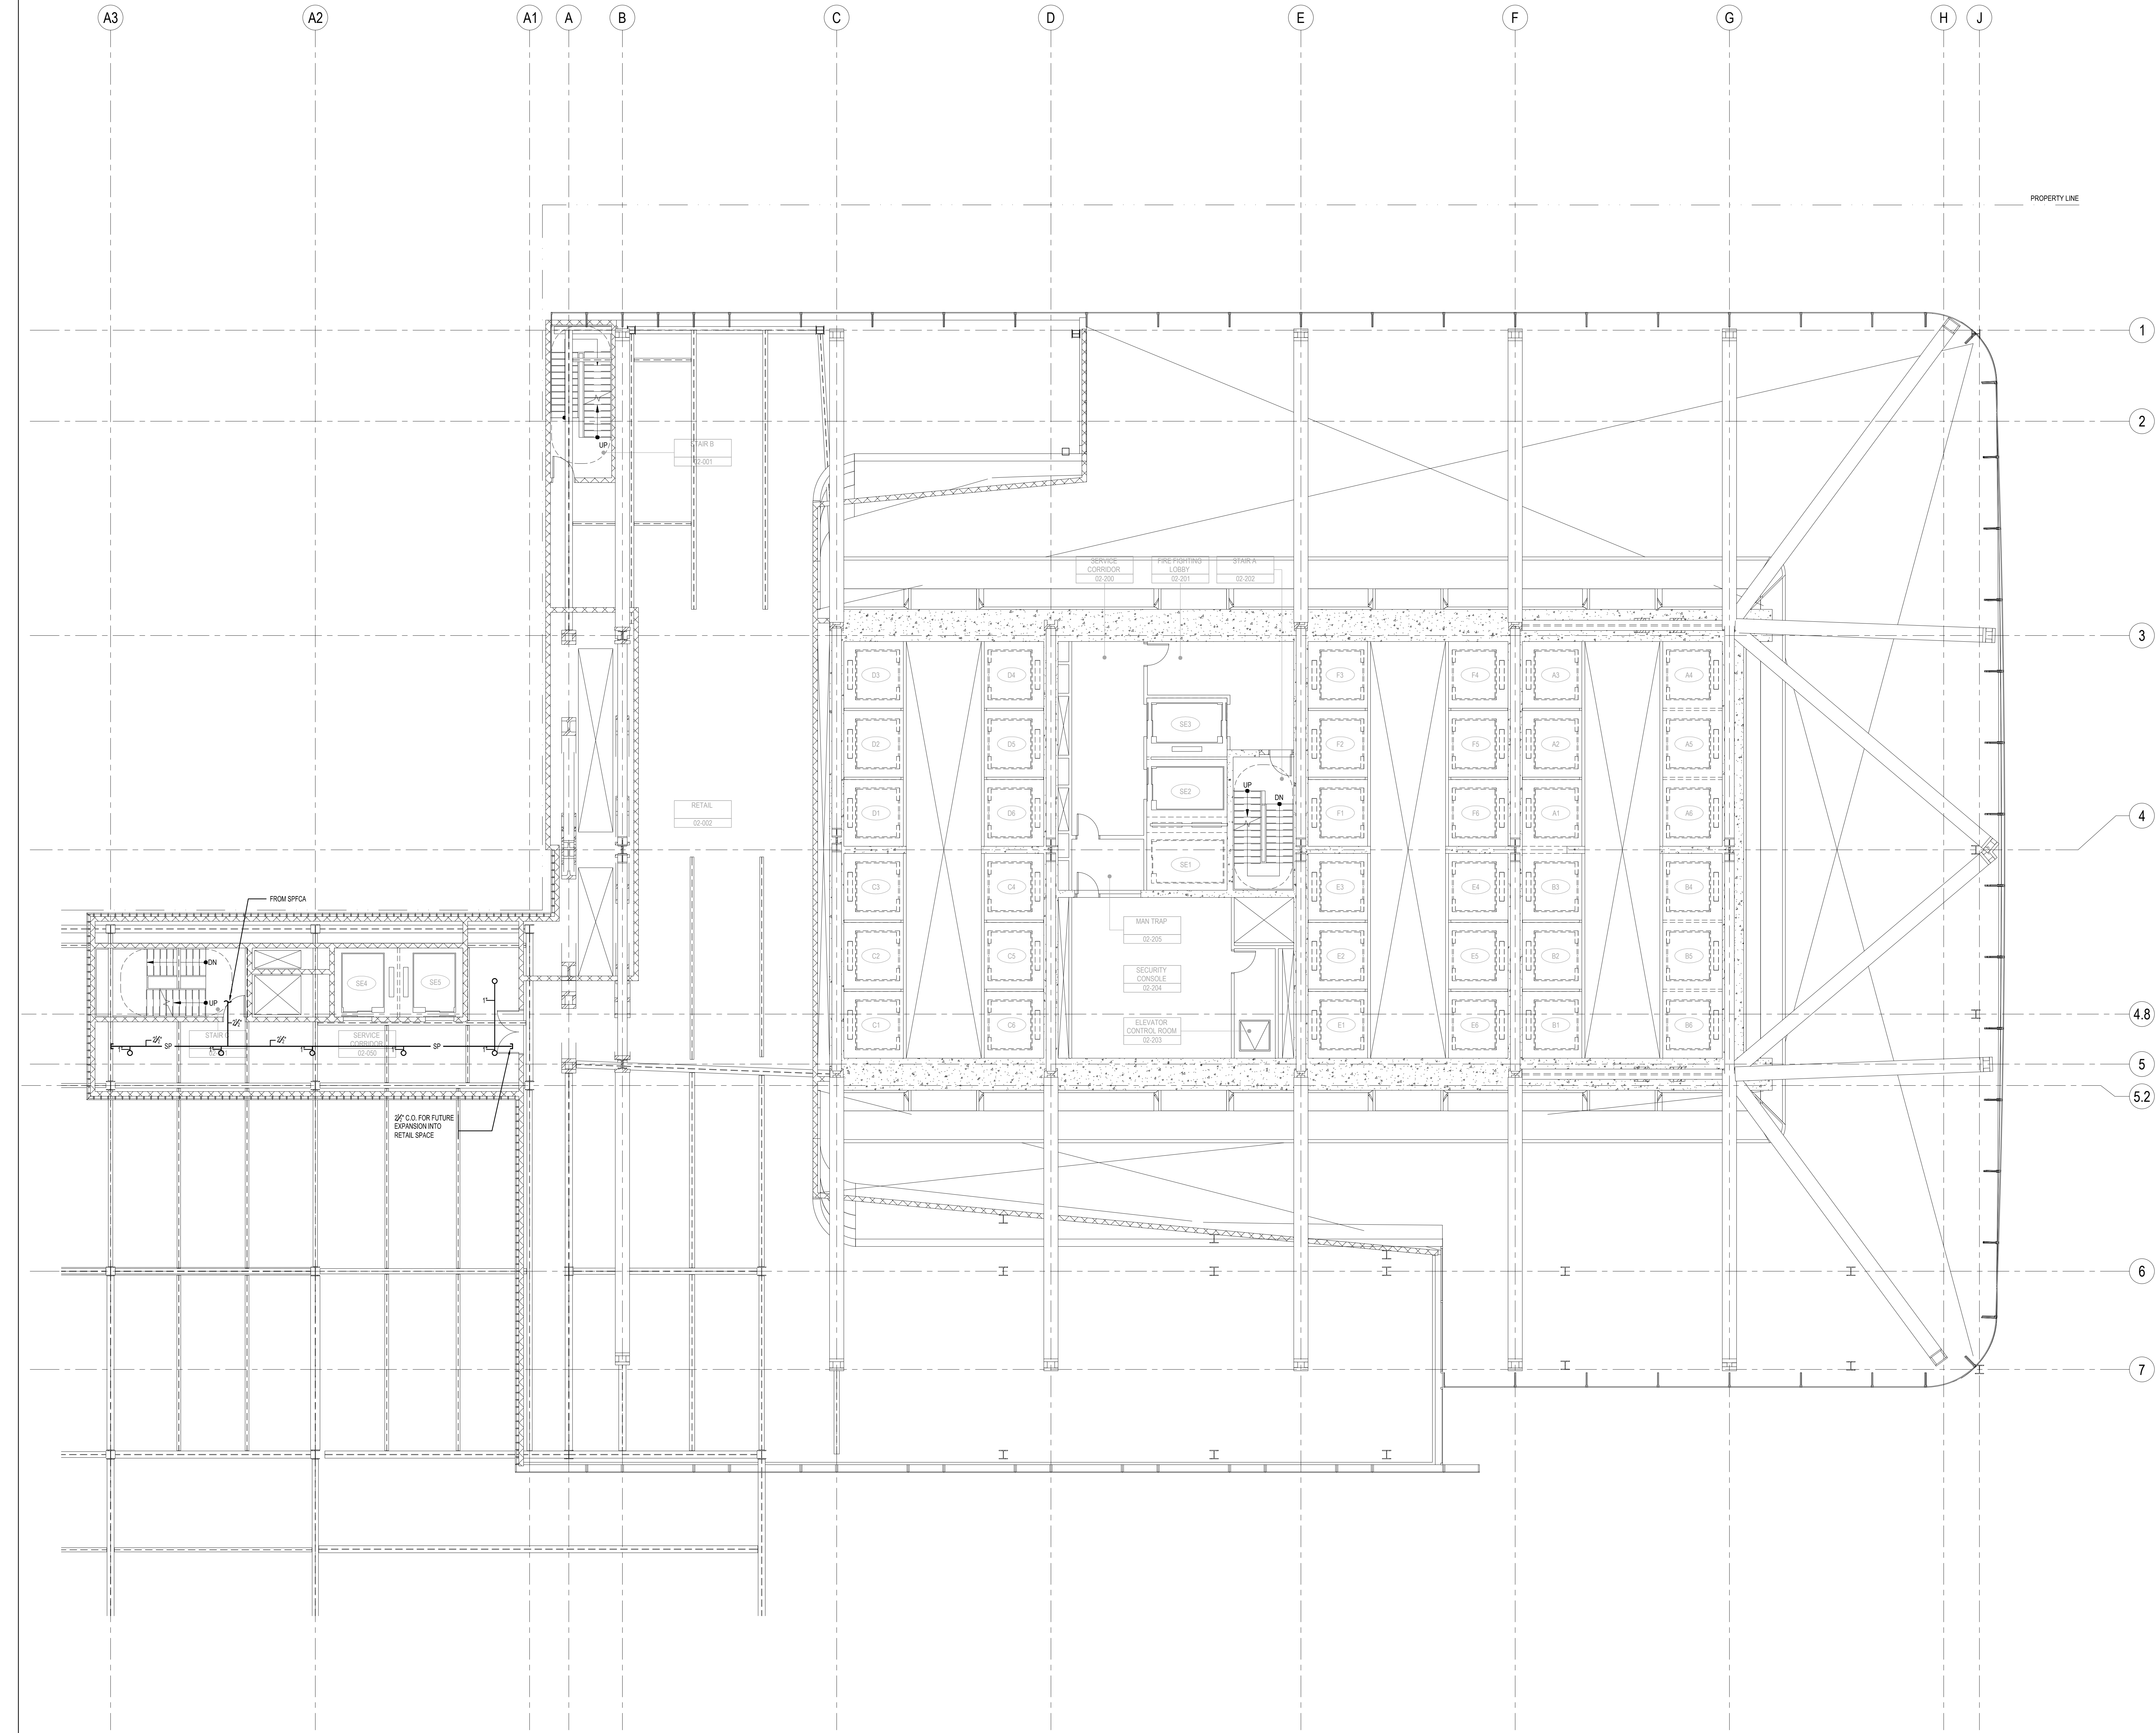
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1	15 MAR 2013	ISSUED FOR RECONCILIATION
No.	Date	Description

Sheet Name:

FIRE PROTECTION
GROUND FLOOR
SPRINKLER PLAN -
PART B

Project No.: 14830-A-000	B-SCAN Sheet No.: FP-201-B
Date: 15 NOV 2013	Sheet No.: FP-201.00
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File No.: FP-201-B	Page No.:

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SHEET NOTES



**MANHATTAN WEST:
NORTH TOWER**
375 Ninth Avenue, New York, NY 10001

Client

Brookfield

Brookfield Plaza
250 Vesey Street, 15th Floor, New York, NY 10281

Architecture/Structural Engineering

SOM

Skidmore, Owings & Merrill LLP
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Civil Engineering
Philip Habib & Associates
102 Madison Avenue #11, New York, NY 10016

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Jaros Baum & Bolles
80 Pine Street, New York, NY 10005

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Edgett Williams Consulting Group, Inc.
102 East Bimacale Ave. Suite 1, Mill Valley, California 94041

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Viridian Energy & Environmental
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Mueser Rutledge Consulting Engineers
14 Penn Plaza, 225 W. 34th Street #610,
New York, NY 10122

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475 10th Avenue, New York, NY 10018

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Ducibella, Vantor & Santoro
250 State Street #F1, North Haven, CT 06473

Blast Consultant
Weidinger Associates, Inc.
40 Wall Street, New York, NY 10005

Acoustical Consultant
Cerami & Associates
404 Fifth Avenue #8, New York, NY 10018


Vibration Consultant
Wilson, Uhrig & Associates, Inc.
65 Broadway, Suite 401, New York, NY 10006

Code Consultant
Code Consultants Professional Engineers PC
215 West 40th Street, 15th Floor, New York, NY 10018

Facade Maintenance Consultant
Entek Engineering LLC
166 Ames Street, Hackensack, NJ 07601

Wind Tunnel Consultant
Rowan Williams Davies & Irwin Inc.
650 Woodlawn Road West, Guelph
Ontario, Canada N1K 1B5

Key Plan:

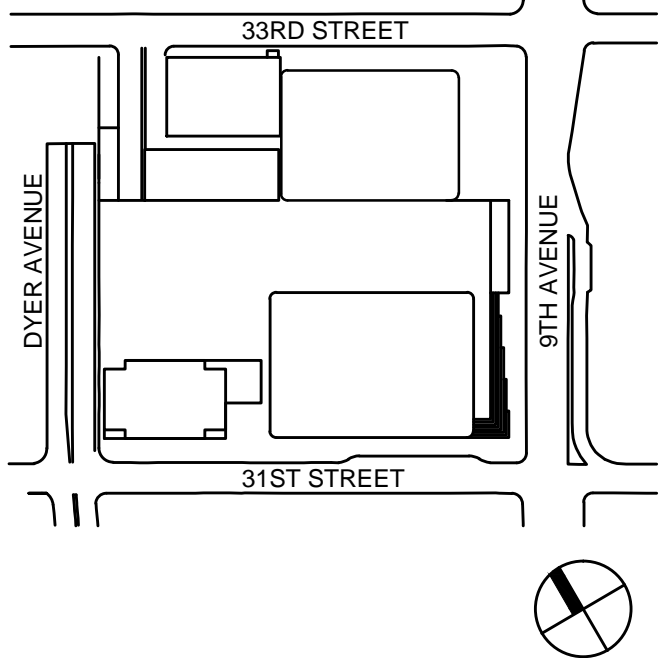

Seal & Signature:




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2	12 JUL 2013	ISSUED FOR RPA DESIGN DEVELOPMENT
1	15 MAR 2013	ISSUED FOR RECONSTRUCTION

Sheet Name:

**FIRE PROTECTION
LEVEL 2 FLOOR
SPRINKLER PLAN -
RETAIL**

Project No.:	B-SCAN Sheet No.:
14830 A-000	FP-202
Date:	15 NOV 2013
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File No.:	FP-202

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SHEET NOTES

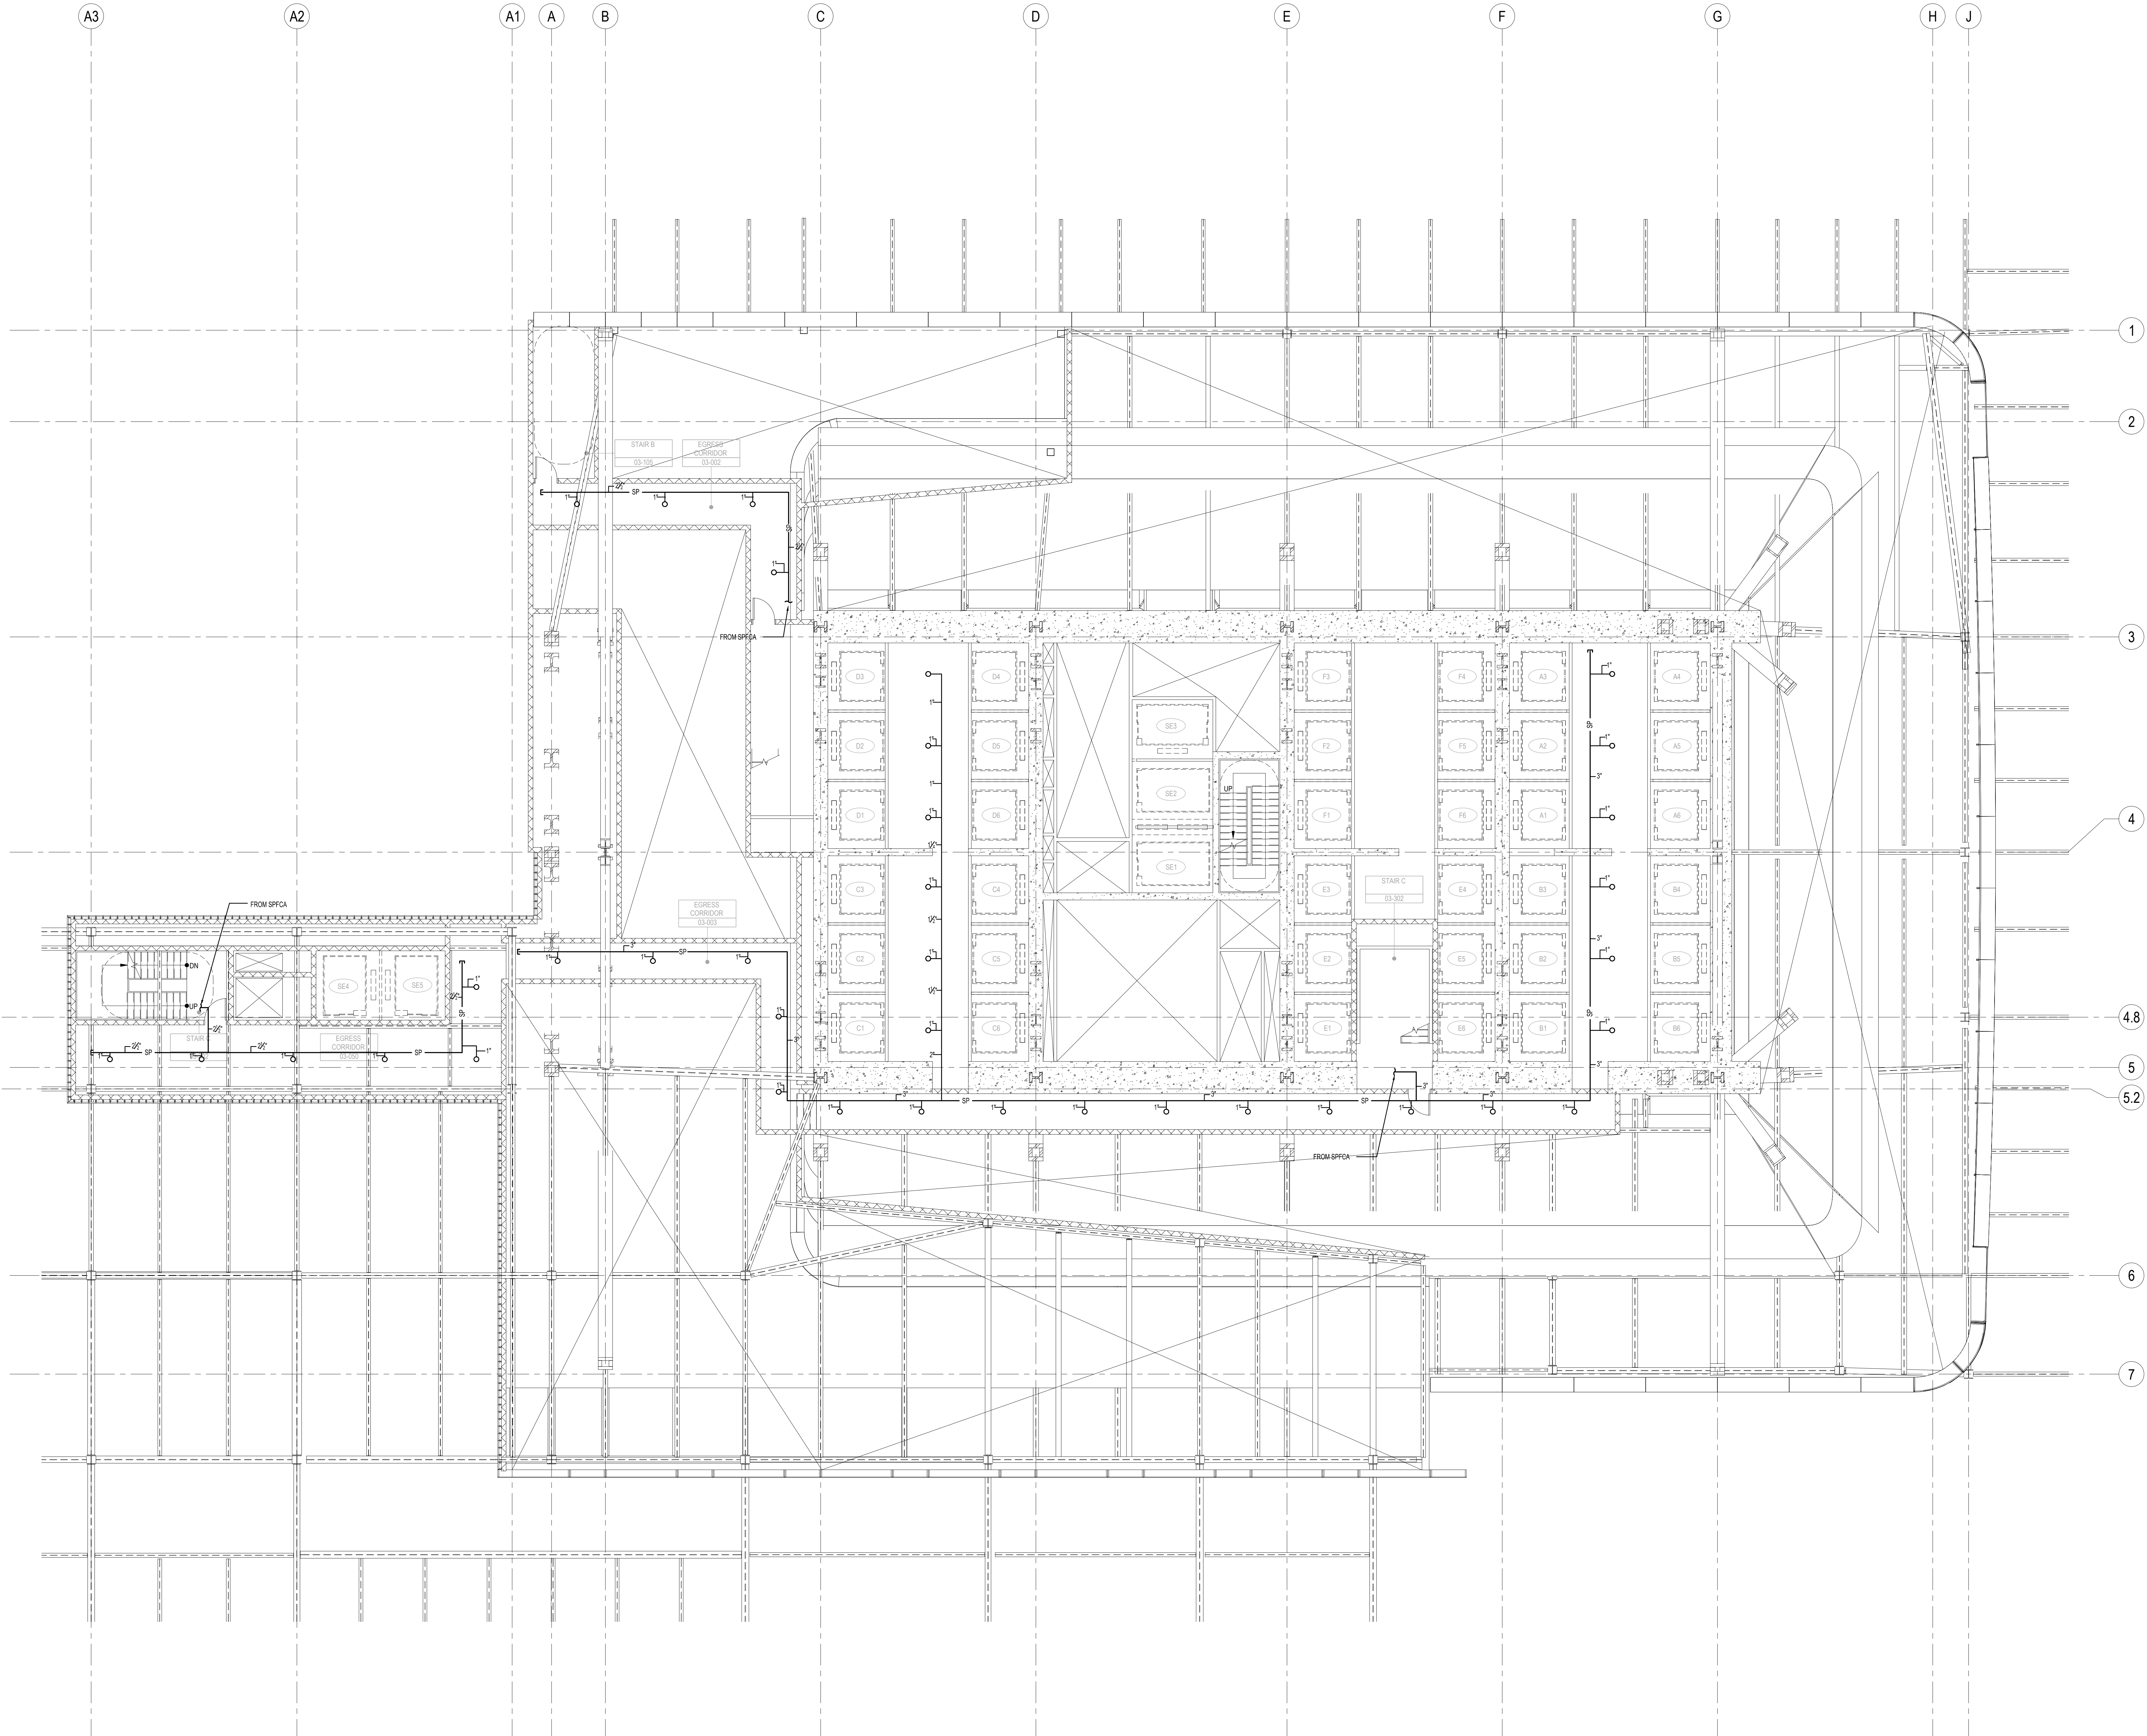

**MANHATTAN WEST:
NORTH TOWER**
375 Ninth Avenue, New York, NY 10001

Client
Brookfield
Brookfield Plaza
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Key Plan:



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No.	Date	Description
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3	15 NOV 2013	ISSUED FOR DESIGN PROGRESS PRICING
2	12 JUL 2013	ISSUED FOR RPA DESIGN DEVELOPMENT
1	15 MAR 2013	ISSUED FOR RECONSTRUCTION

Sheet Name:

**FIRE PROTECTION
LEVEL 3 FLOOR
SPRINKLER PLAN -
STAIR TRANSFER**

Project No.:	B-SCAN Sheet No.:
14830 A-000	FP-203

Date:	Sheet No.:
16 NOV 2013	FP-203.00

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SHEET NOTES

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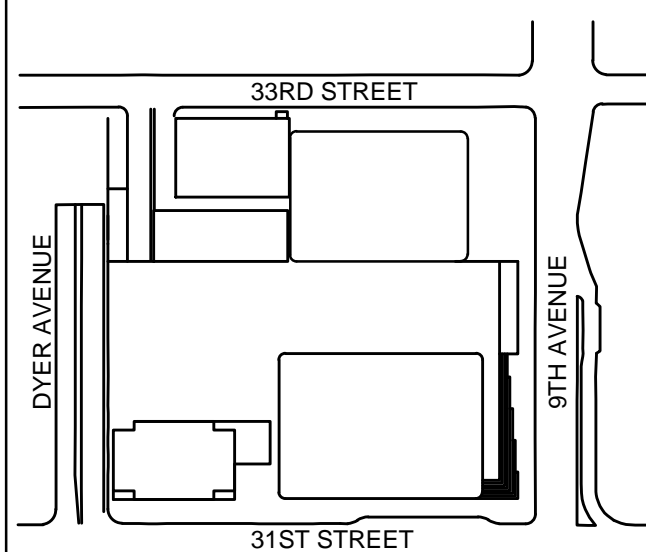
Facade Maintenance Consultant

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Key Plan:



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Sheet Name:

**FIRE PROTECTION
LEVEL 5 FLOOR
SPRINKLER PLAN -
MECHANICAL
MEZZANINE**

Project No.:

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FP-205

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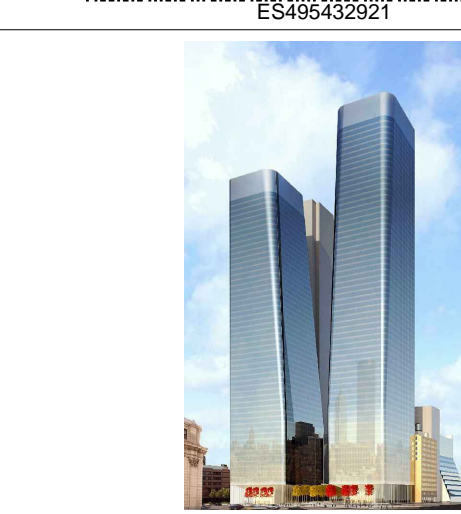
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MANHATTAN WEST:
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375 Ninth Avenue, New York, NY 10001

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Gordon & Associates

Cerami & Associates
404 Fifth Avenue #8, New York, NY 10018

Vibration Consultant

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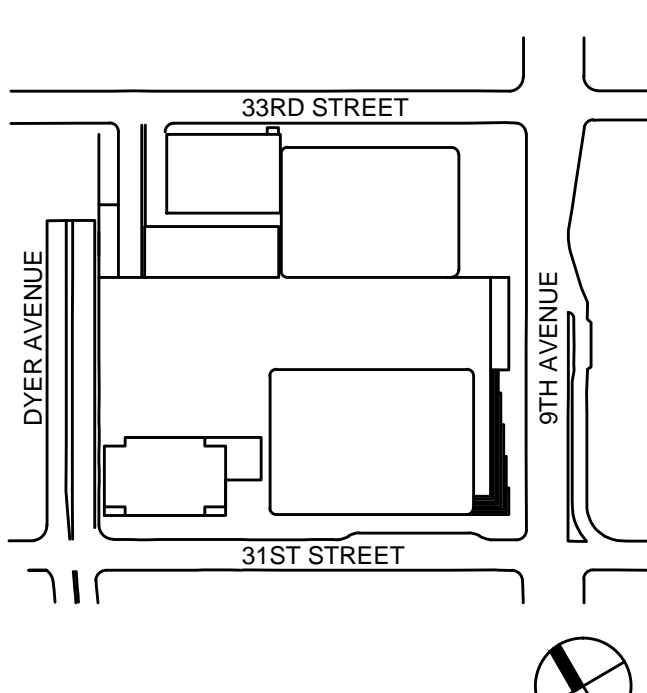
Code Consultants Professional Engineers P
215 West 40th Street, 15th Floor, New York, NY 10018

Entek Engineering LLC
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No.	Date	Description

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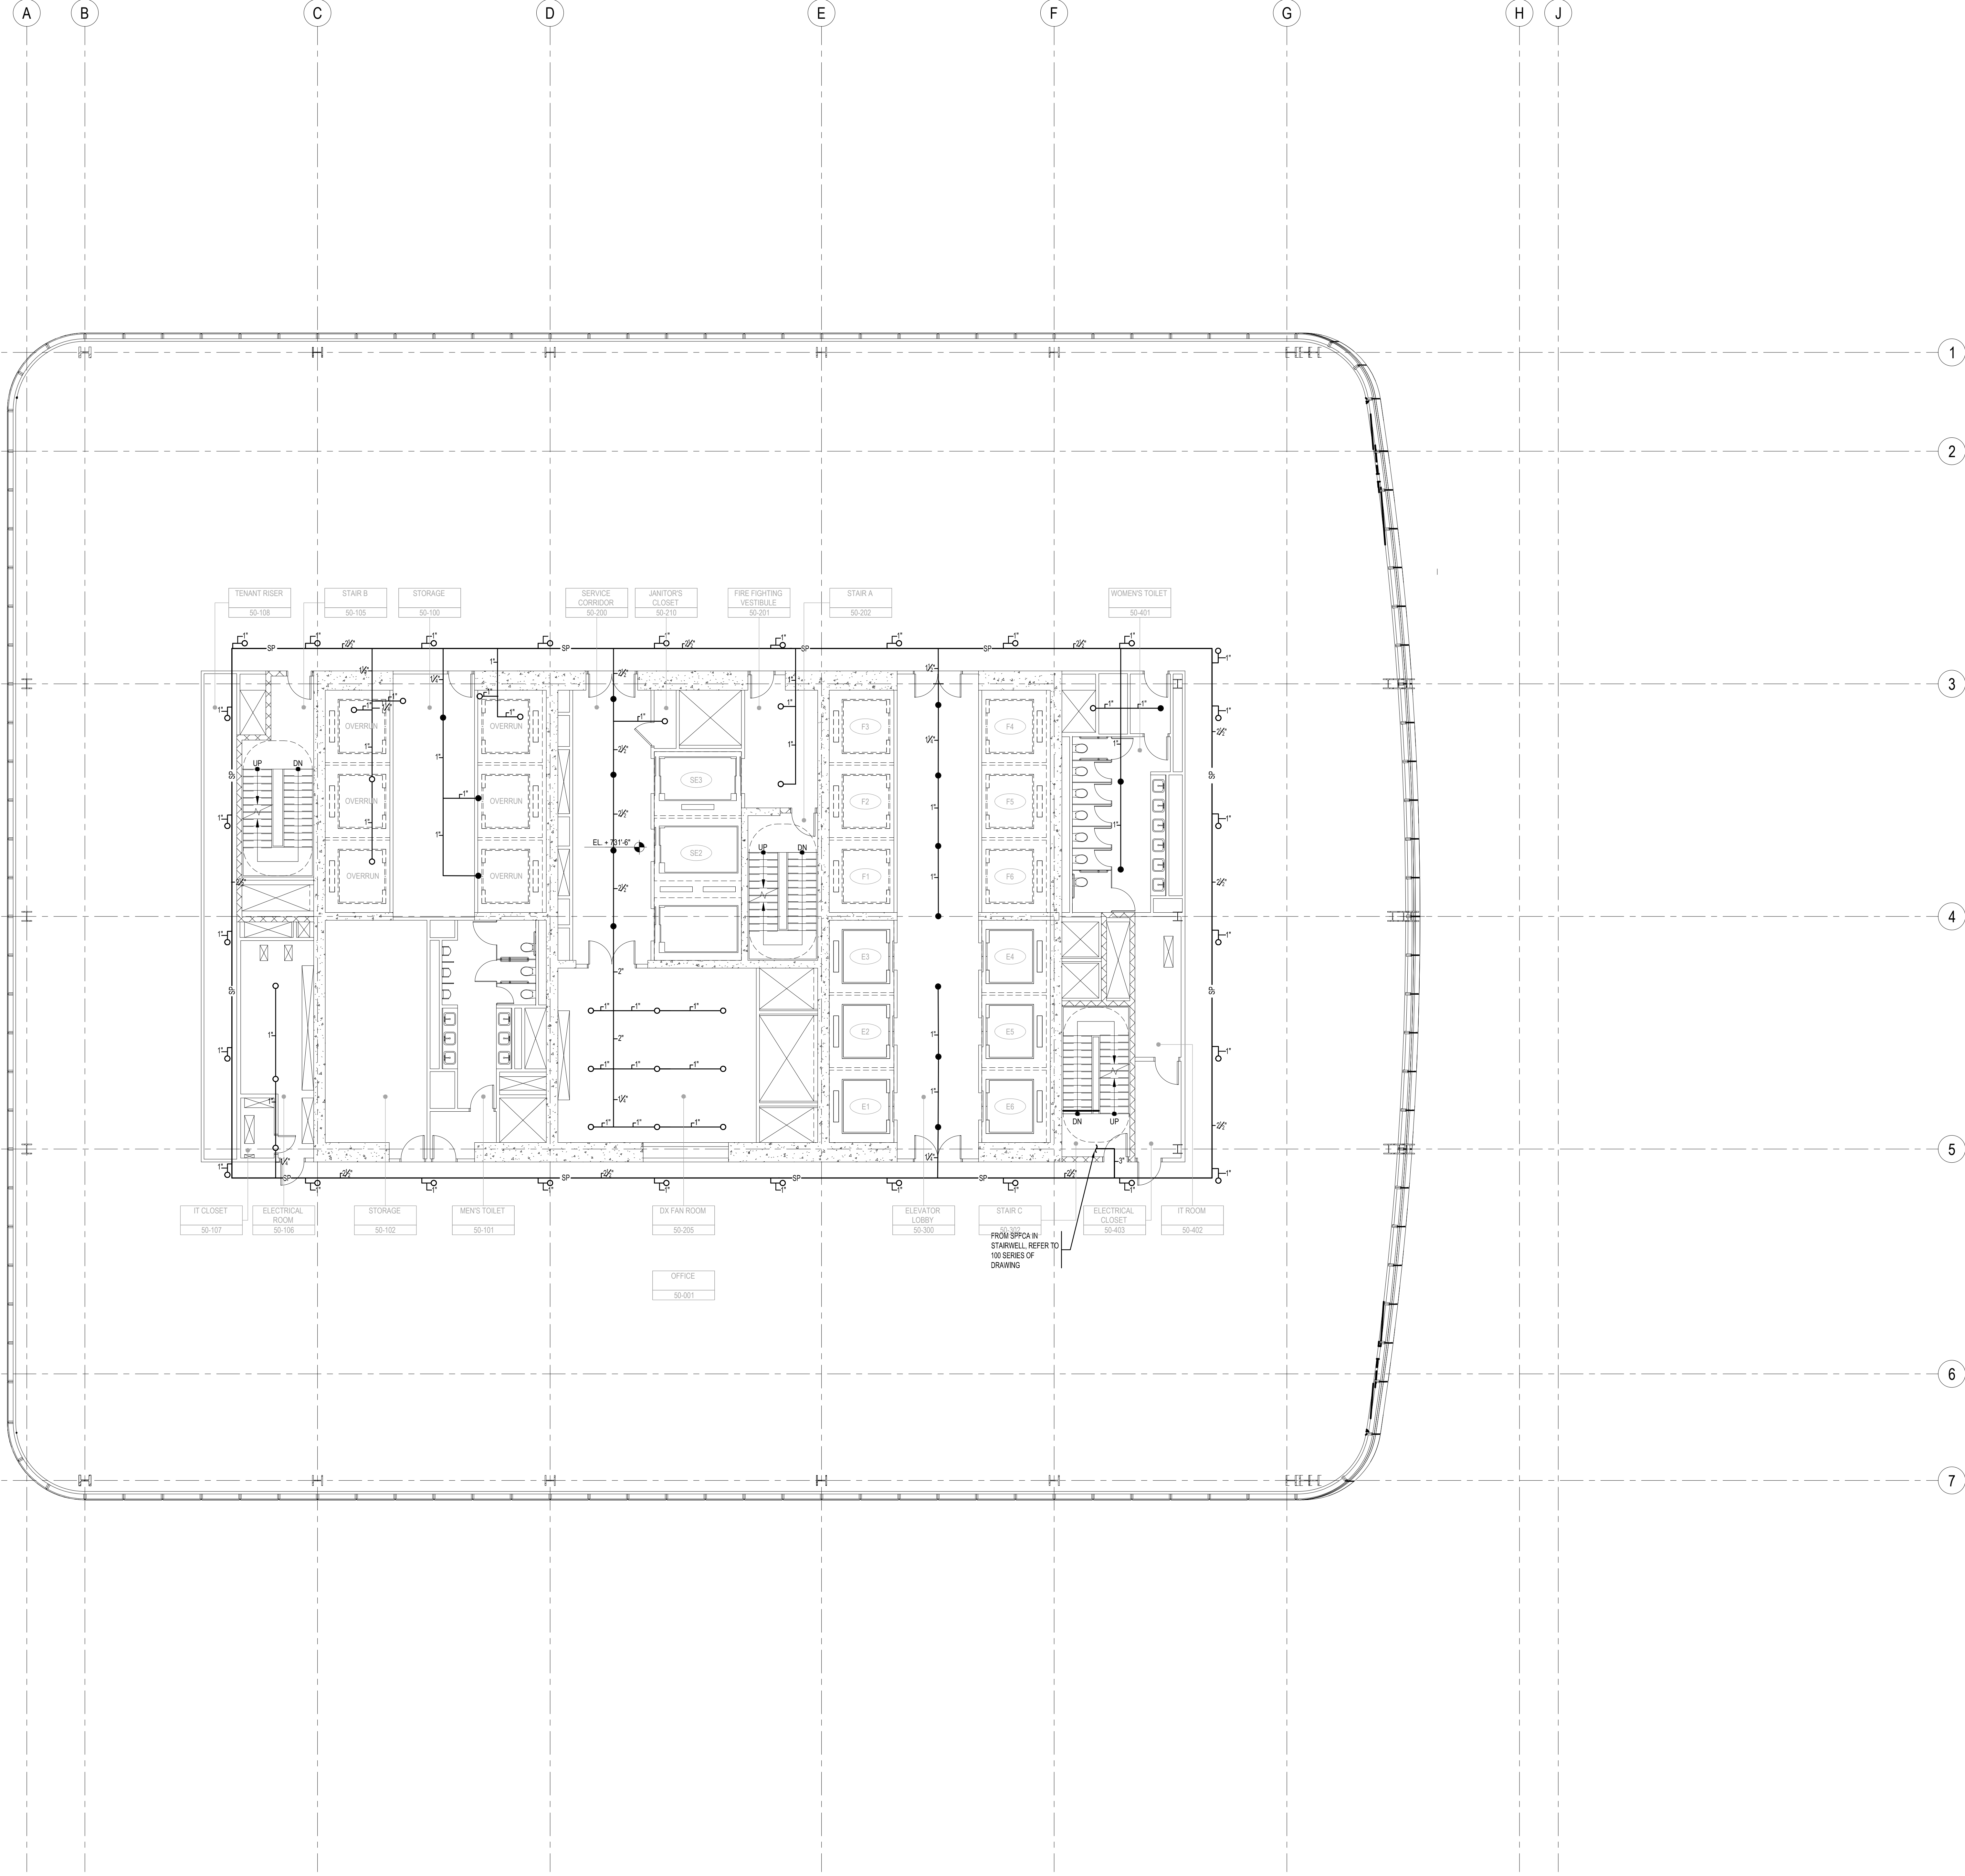
FIRE PROTECTION
LEVEL 49-67 FLOOR
SPRINKLER PLAN -
TYPICAL OFFICE
FLOOR

Project No.: 14830.A.000	B-SCAN Sheet No.: B-312
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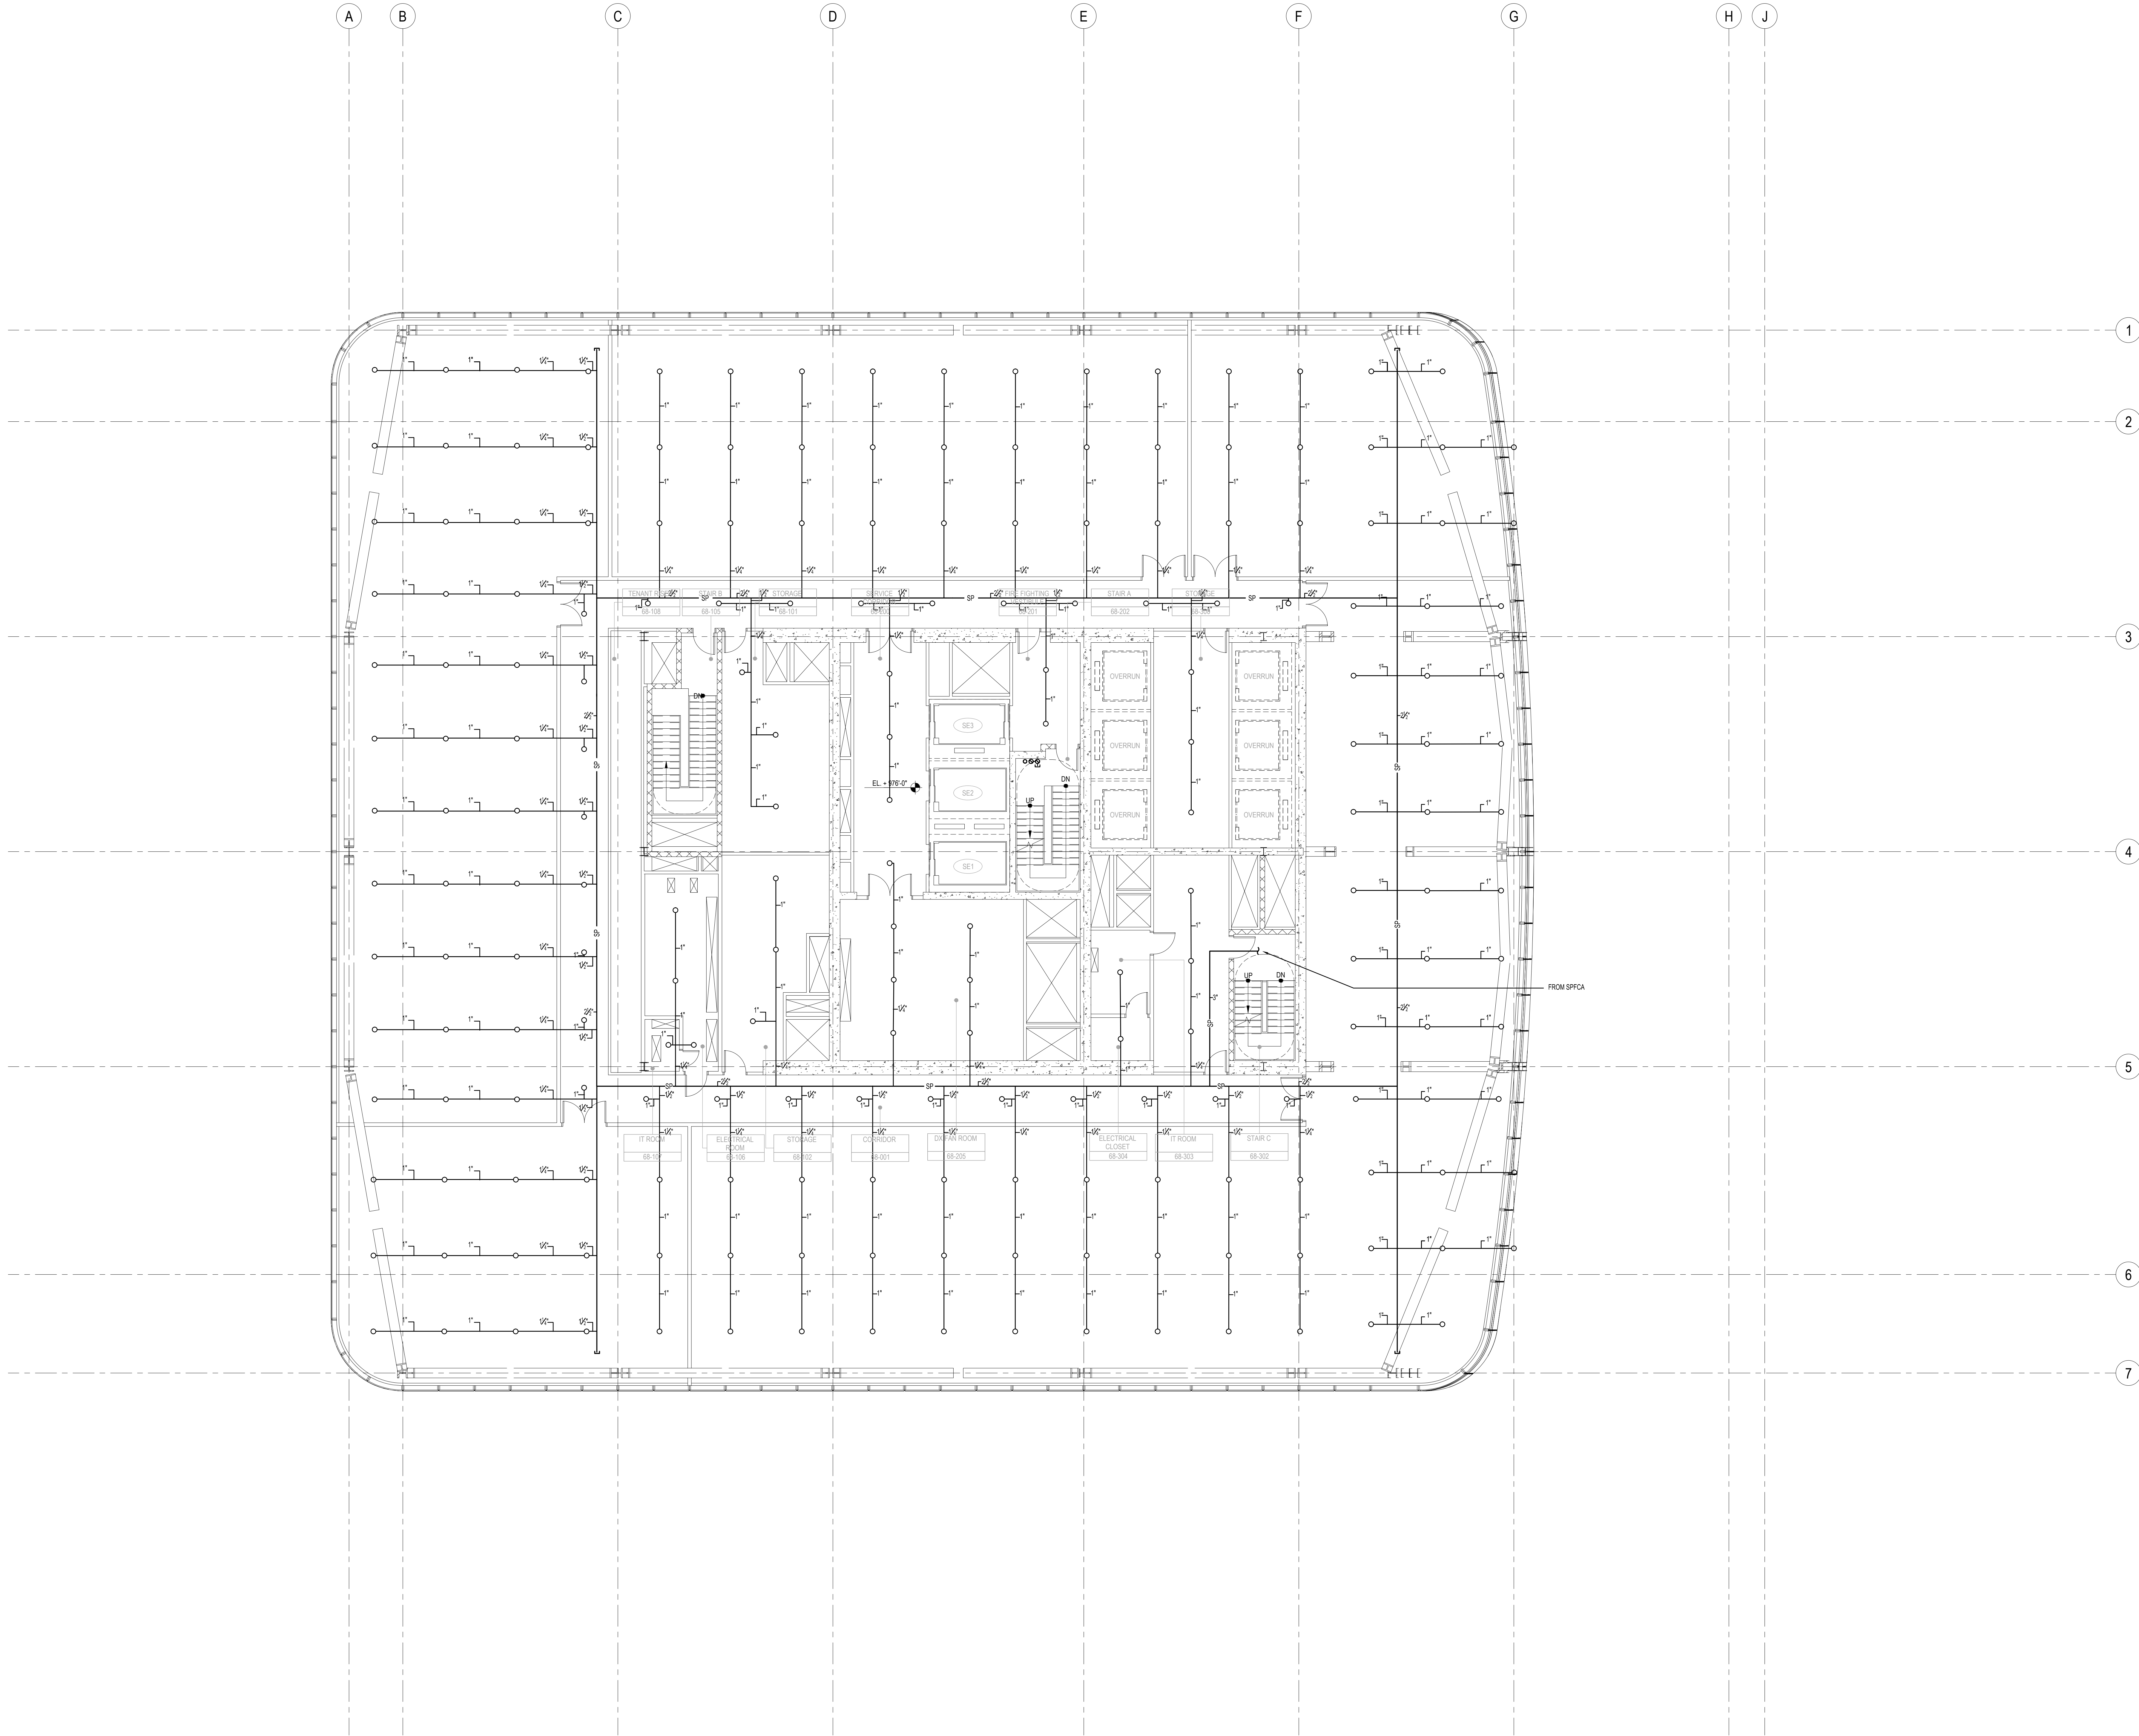
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SHEET NOTES



**MANHATTAN WEST:
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Key Plan:



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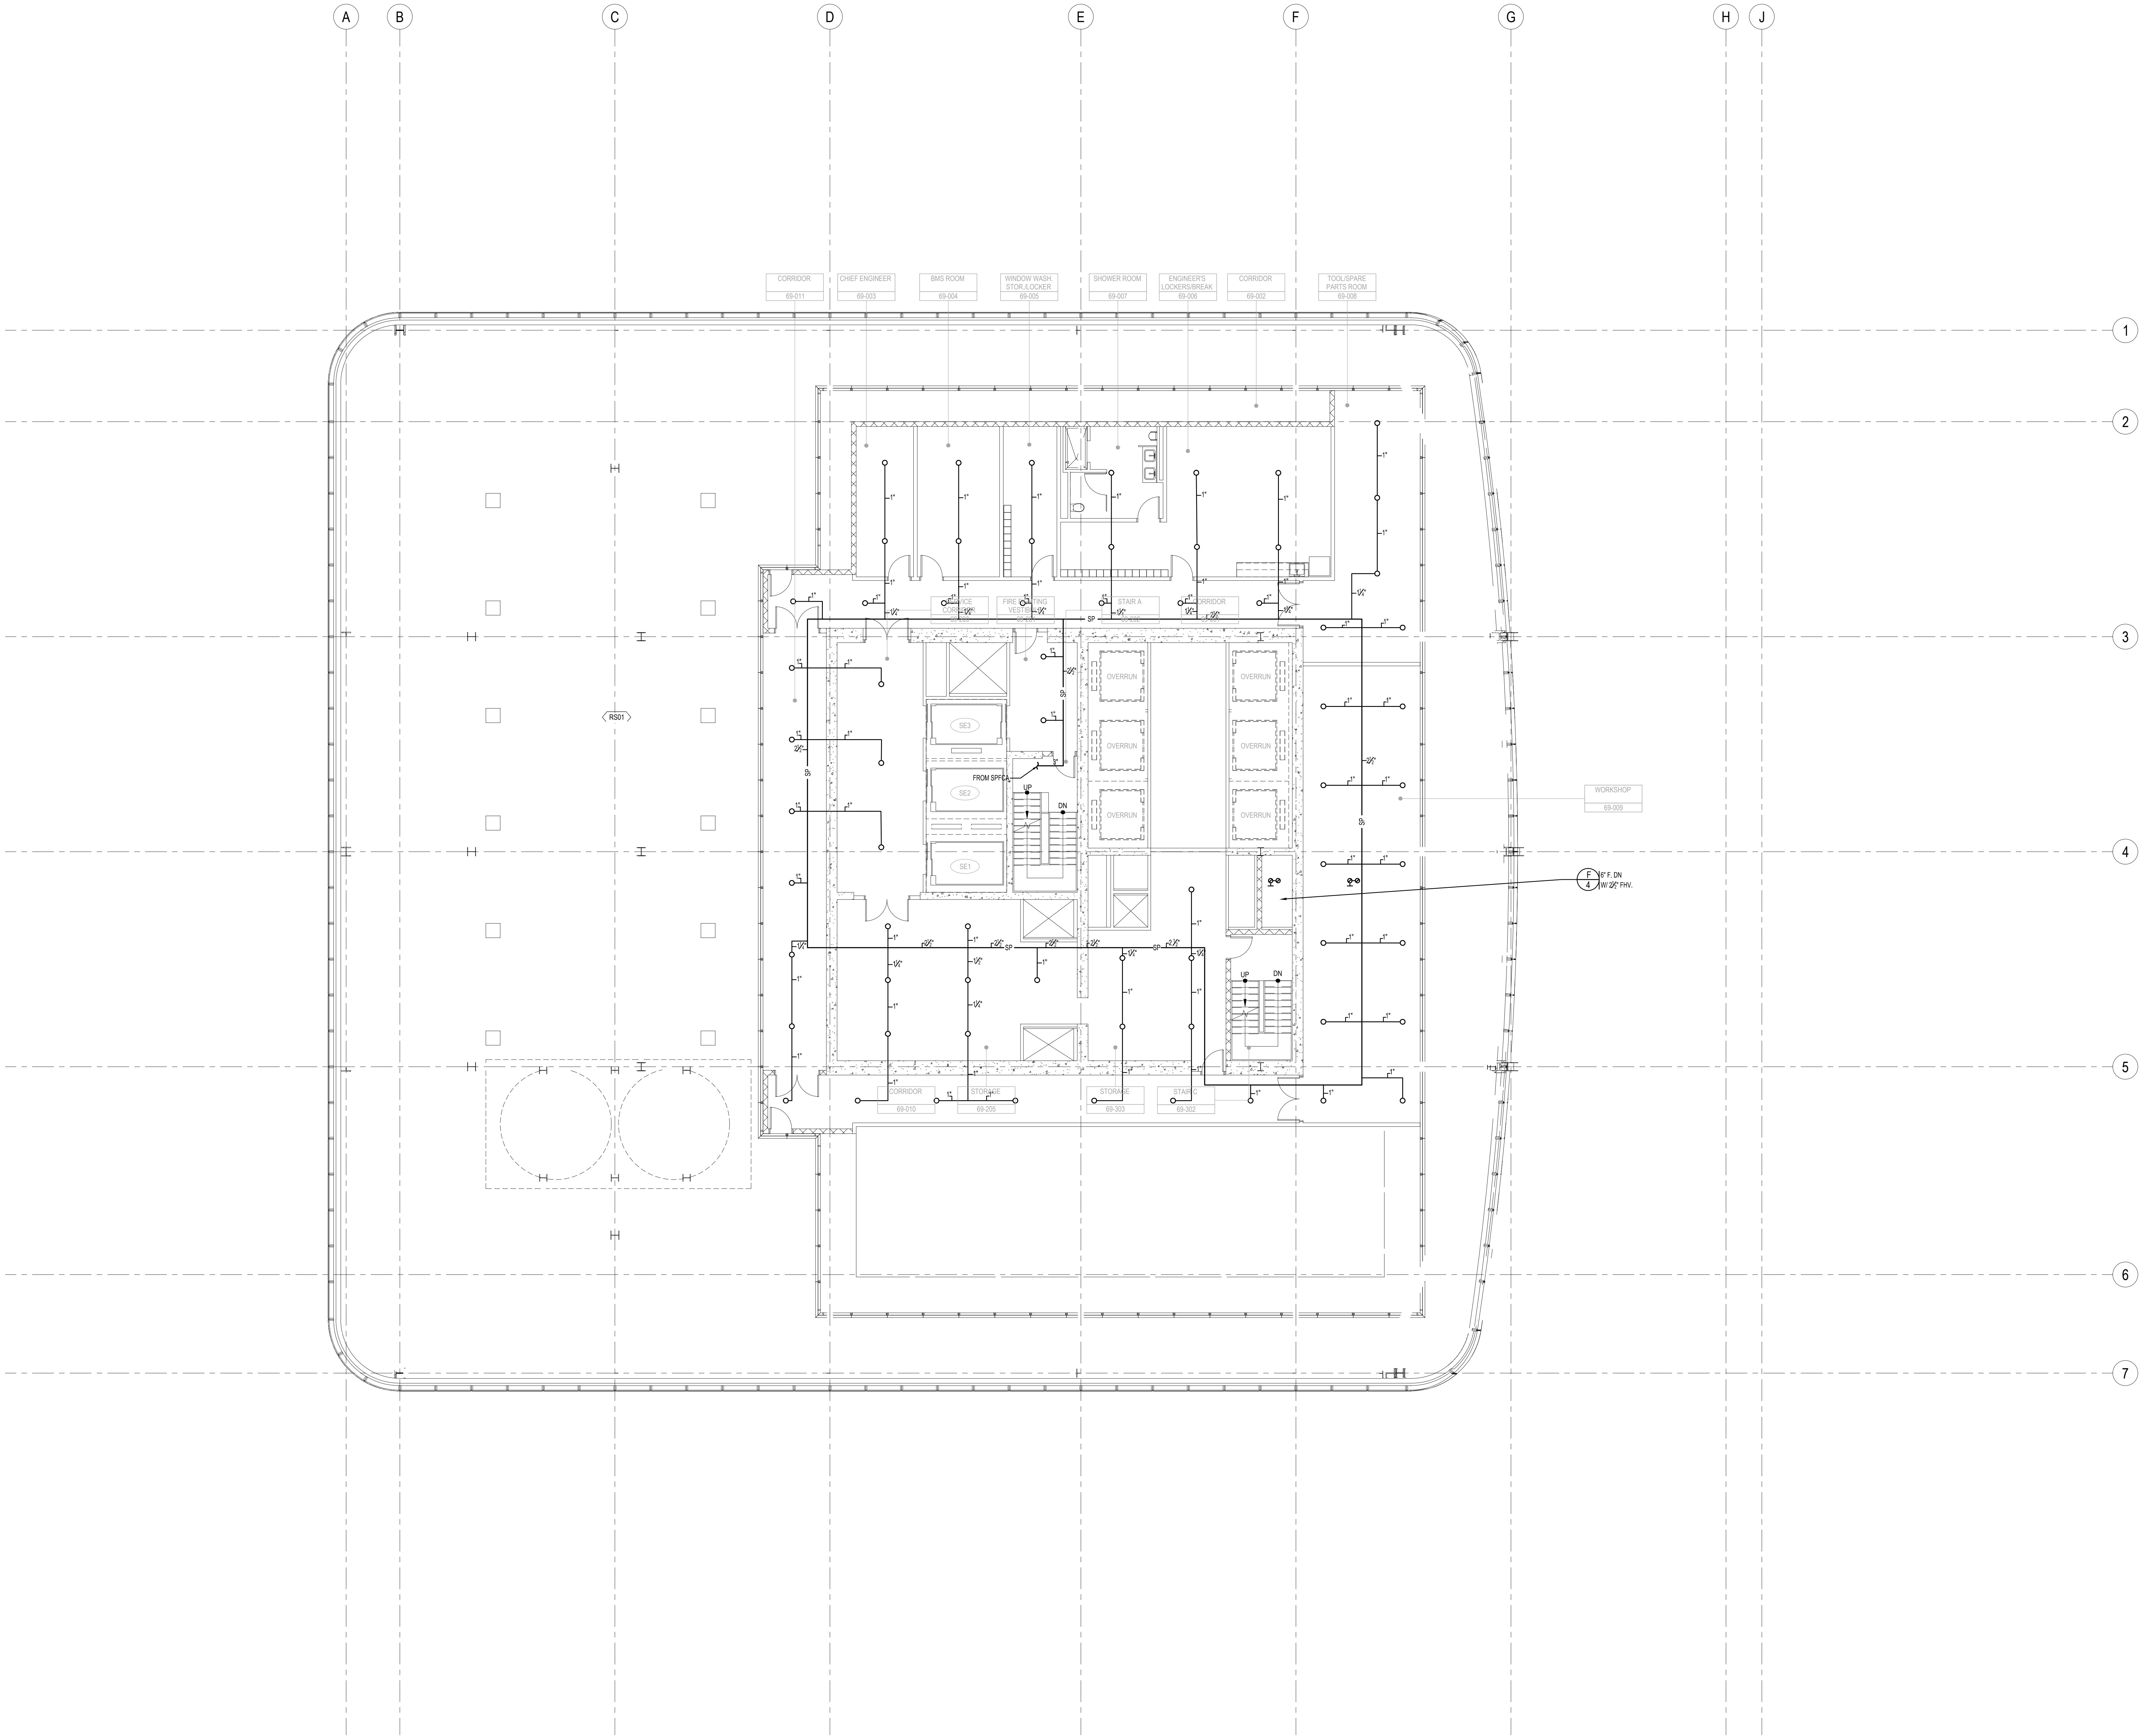


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4	20 DEC 2013	ISSUED FOR FOUNDATION PERMIT
3	15 NOV 2013	ISSUED FOR DESIGN PROGRESS PRICING
2	12 JUL 2013	ISSUED FOR RPA DESIGN DEVELOPMENT
1	15 MAR 2013	ISSUED FOR RECONSTRUCTION

Sheet Name:

**FIRE PROTECTION
LEVEL 68 FLOOR
SPRINKLER PLAN -
MECHANICAL
MEZZANINE**

Project No.:	B-SCAN Sheet No.:
14830 A-000	FP-268
Date: 15 NOV 2013	Sheet No.:
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File No.:	Page No.:
FP-268	



SHEET NOTES



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Key Plan:
33RD STREET
31ST STREET
DIXIE AVENUE
9TH AVENUE

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Project No.: 14830 A.000
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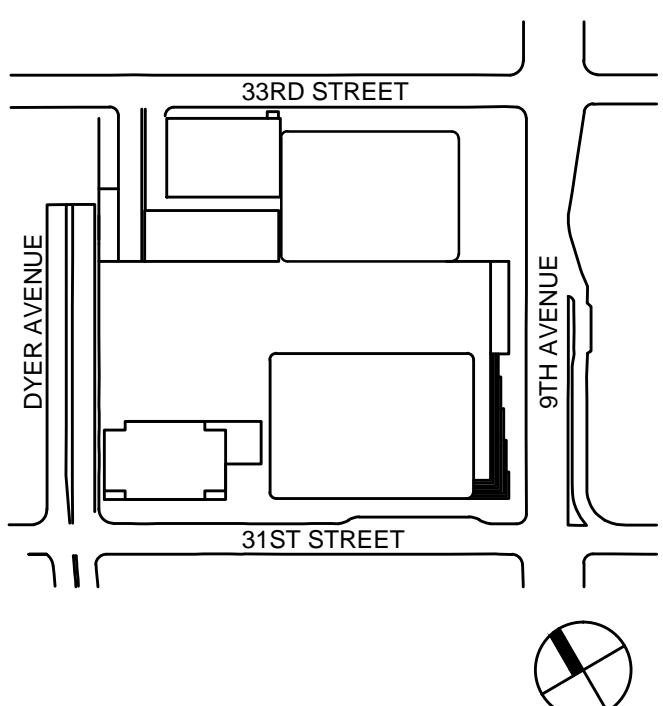
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Key Plan:



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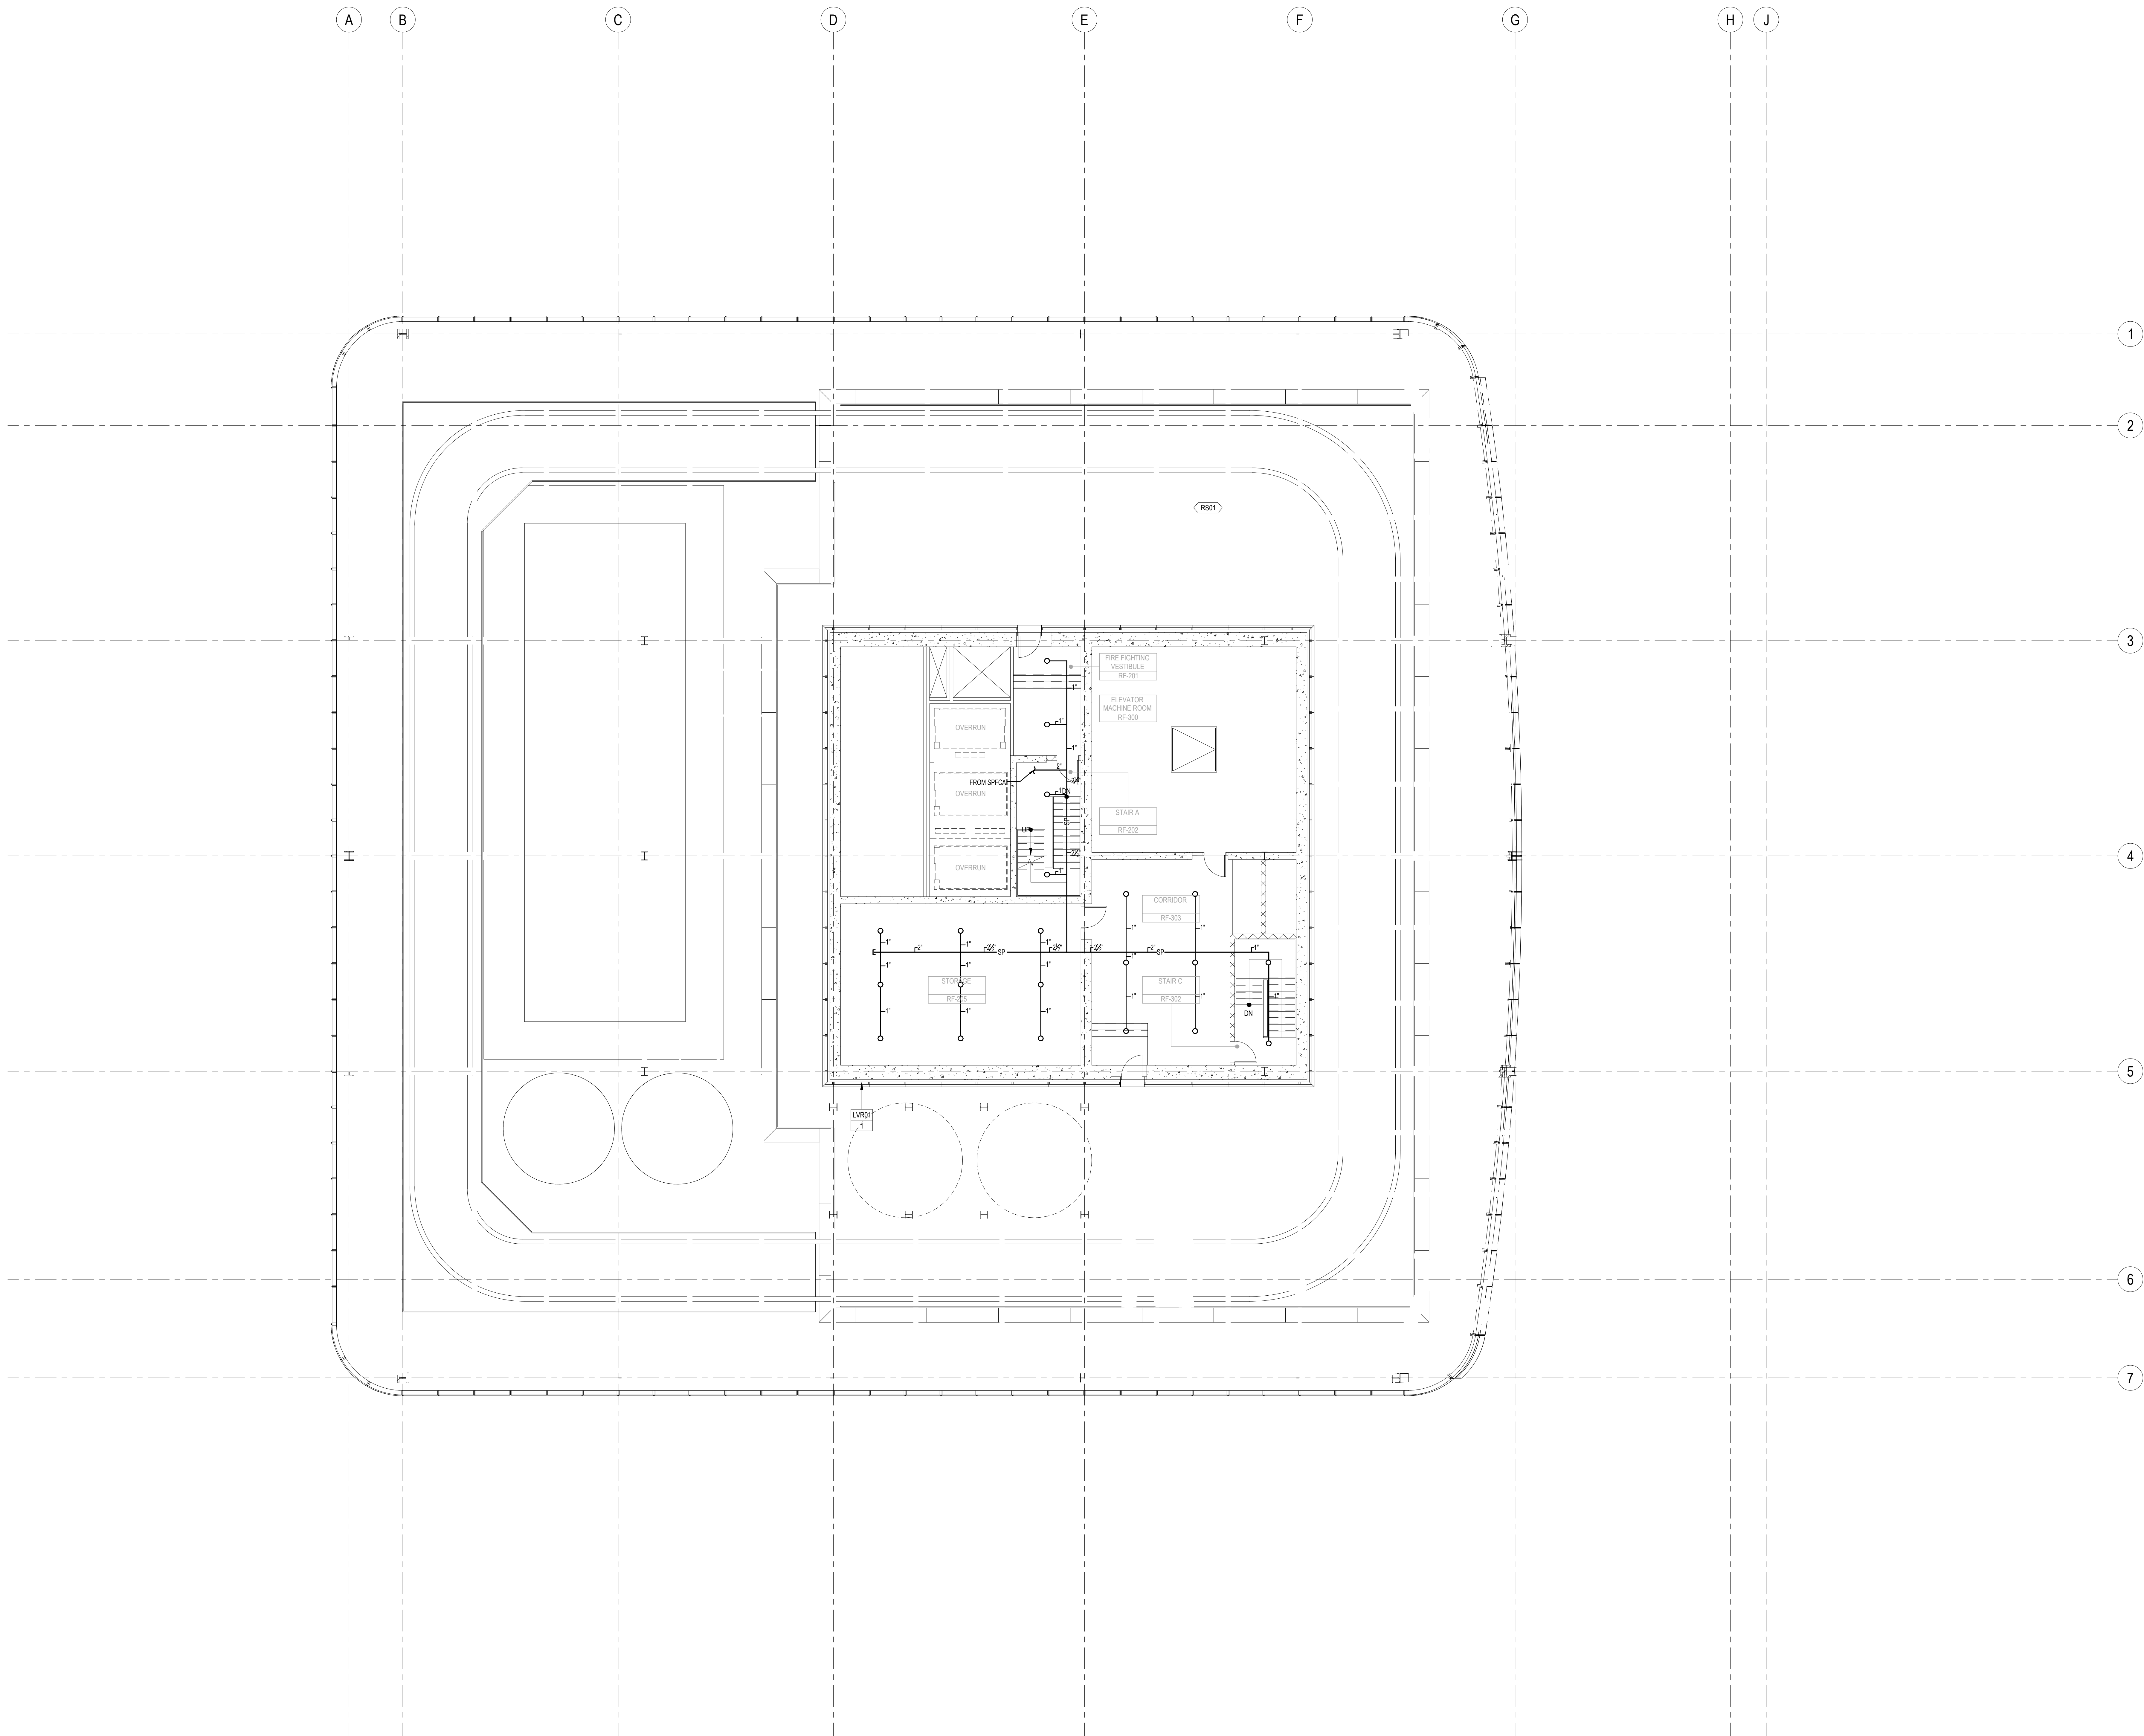


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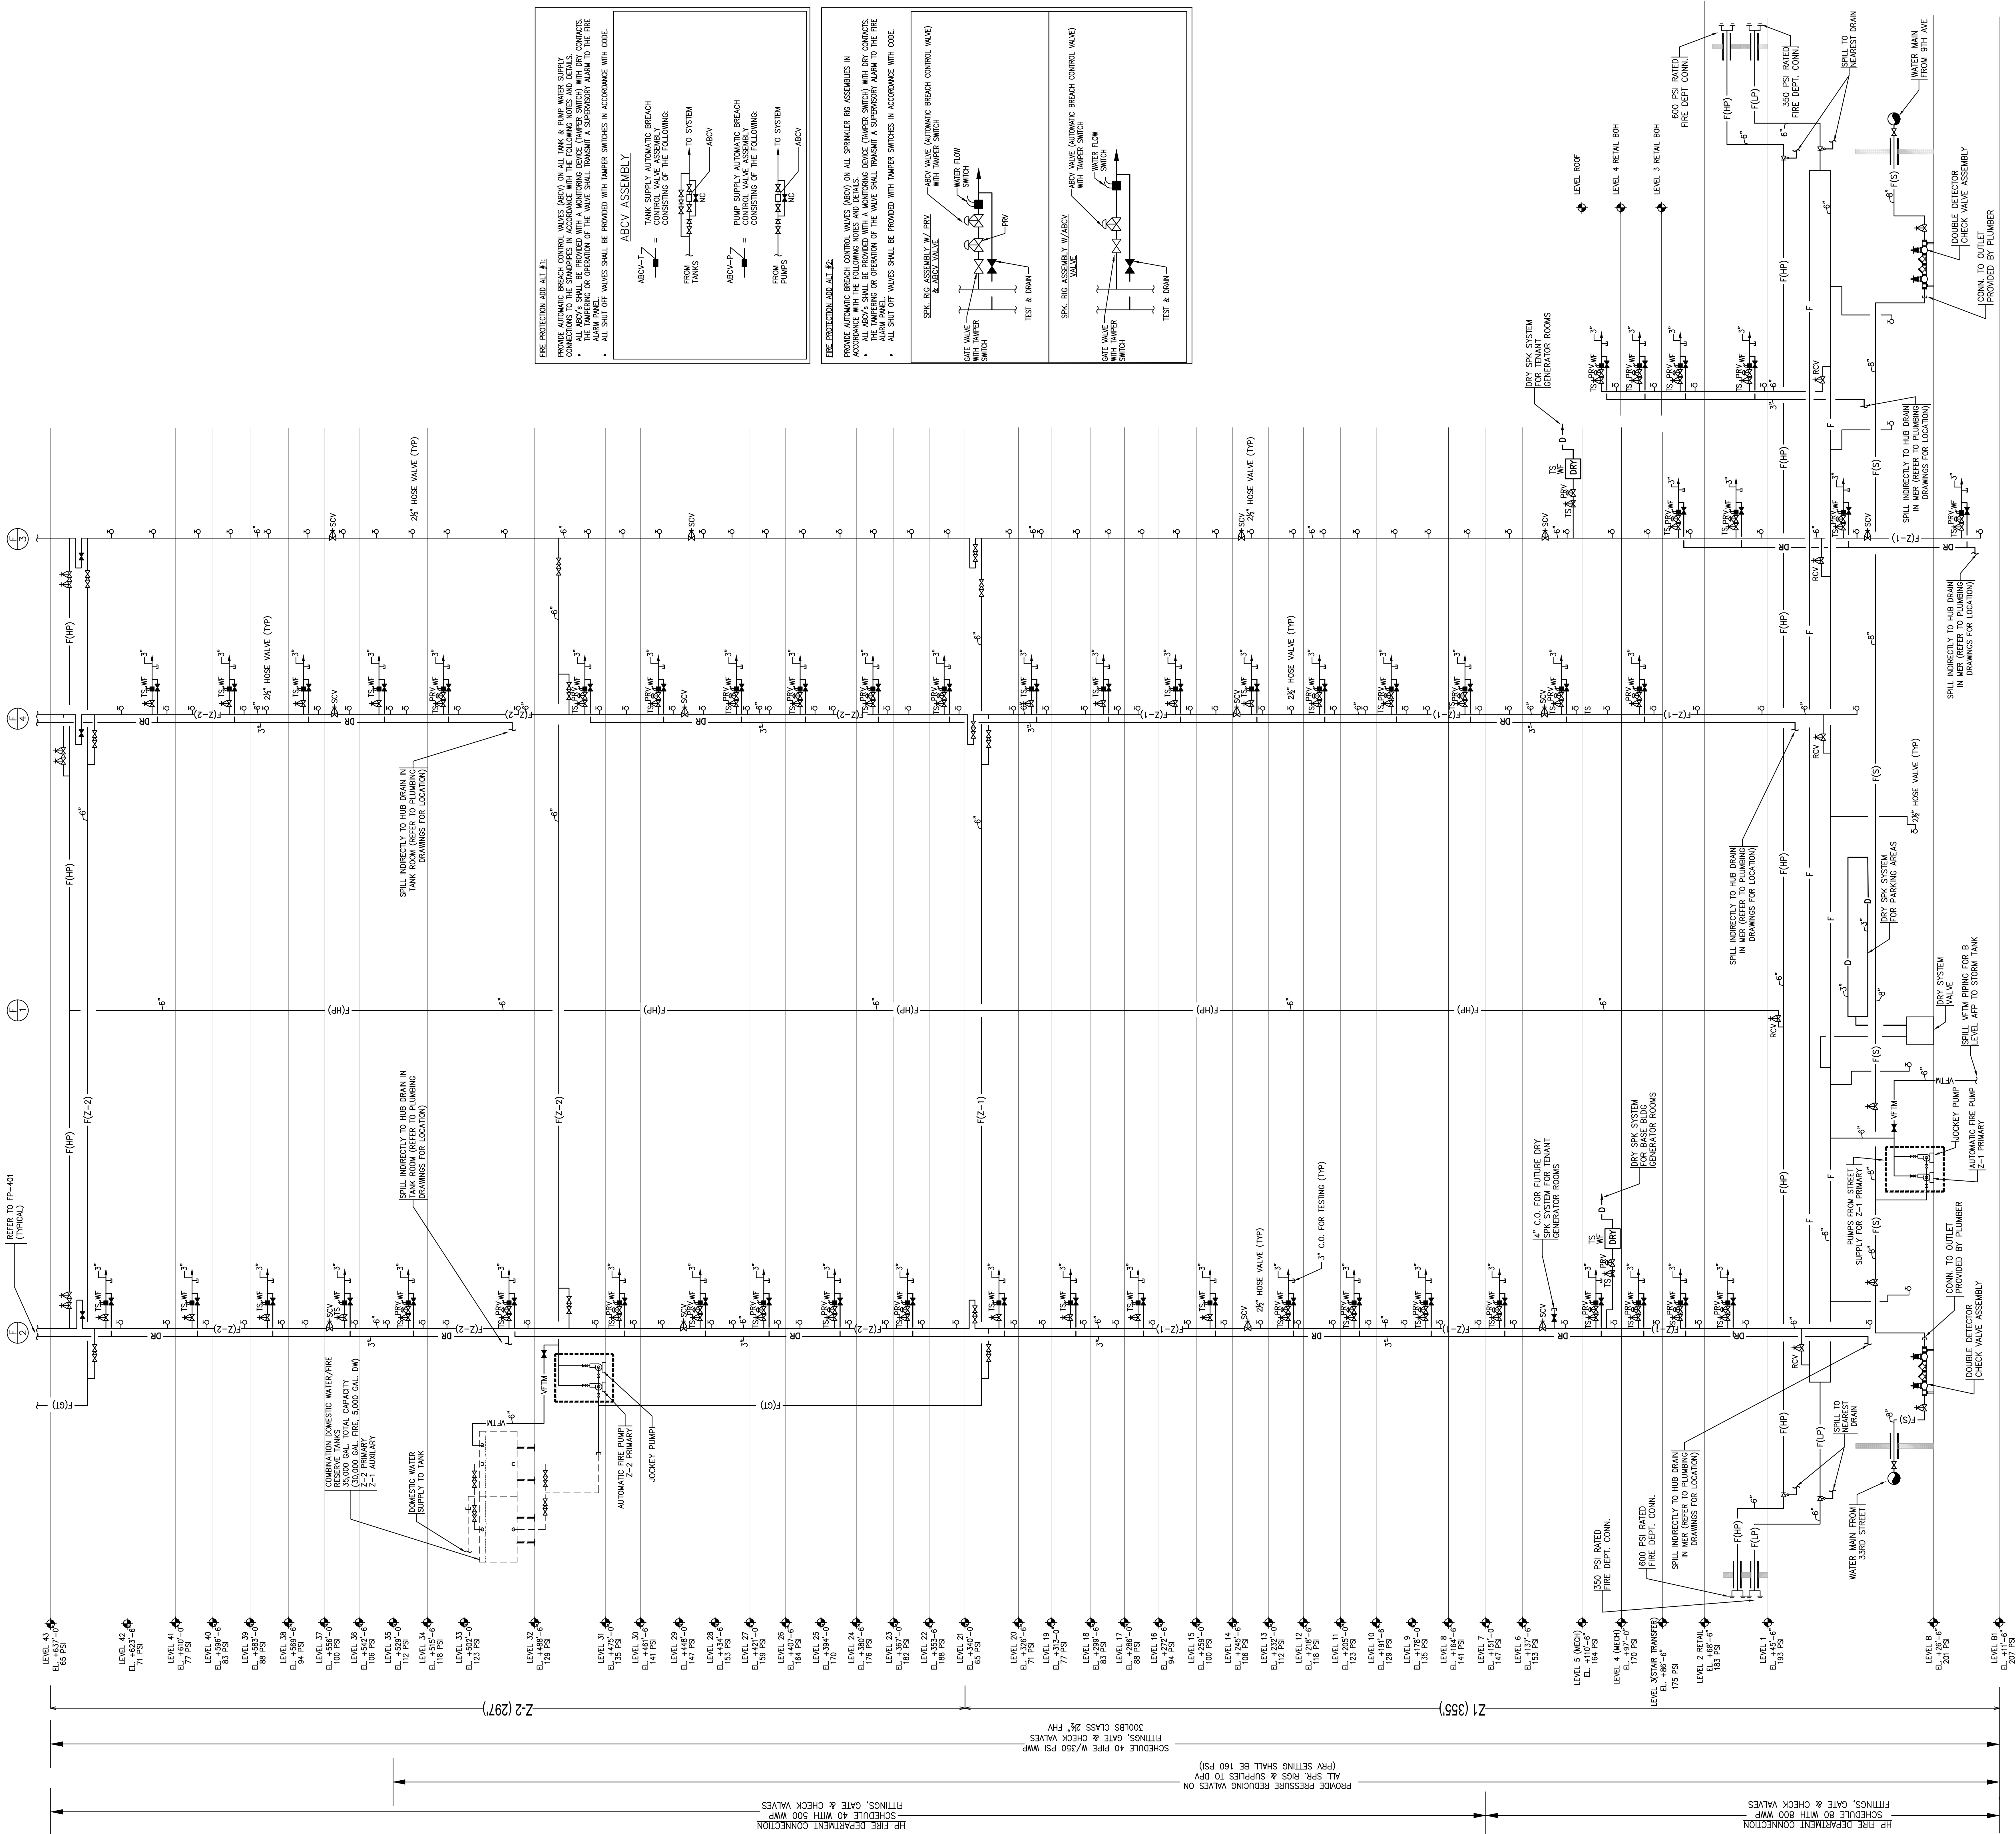
FIRE PROTECTION
ROOF SPRINKLER
PLAN -
MECHANICAL
PENTHOUSE
ROOF

Project No.: 14830.A.000	B-SCAN Sheet No.: FP-270
Date: 15 NOV 2013	Sheet No.: FP-270.00
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SHEET NOTES



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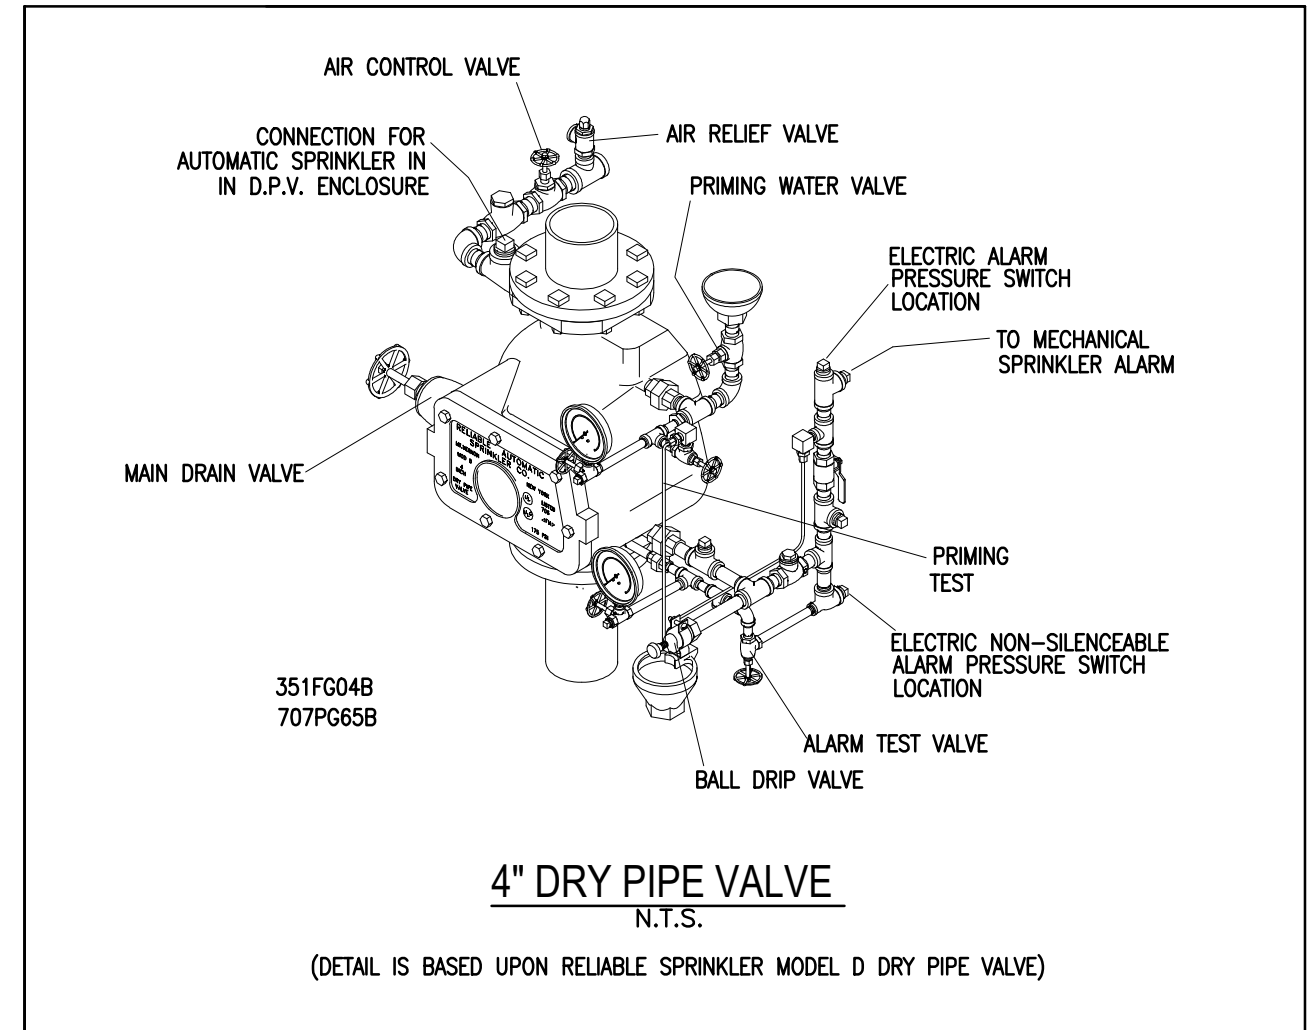
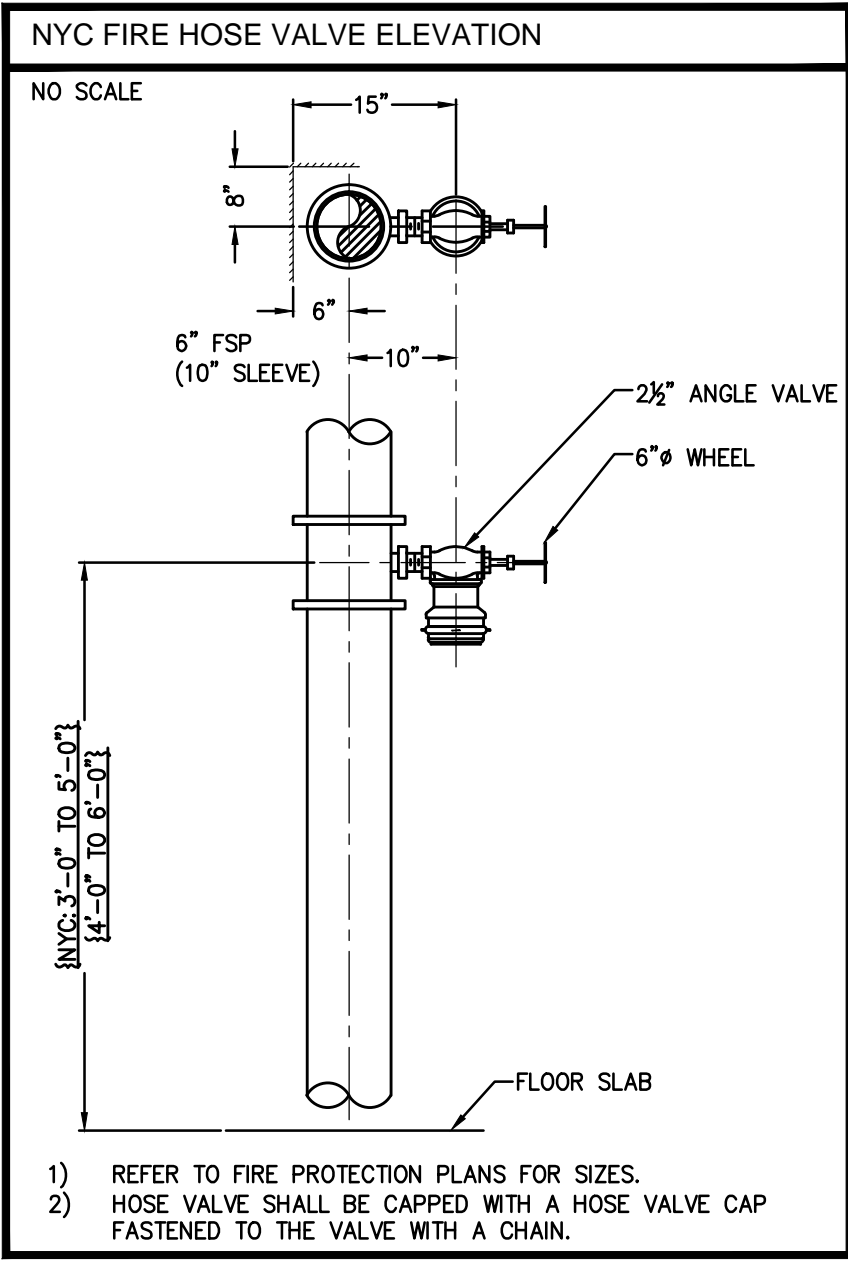
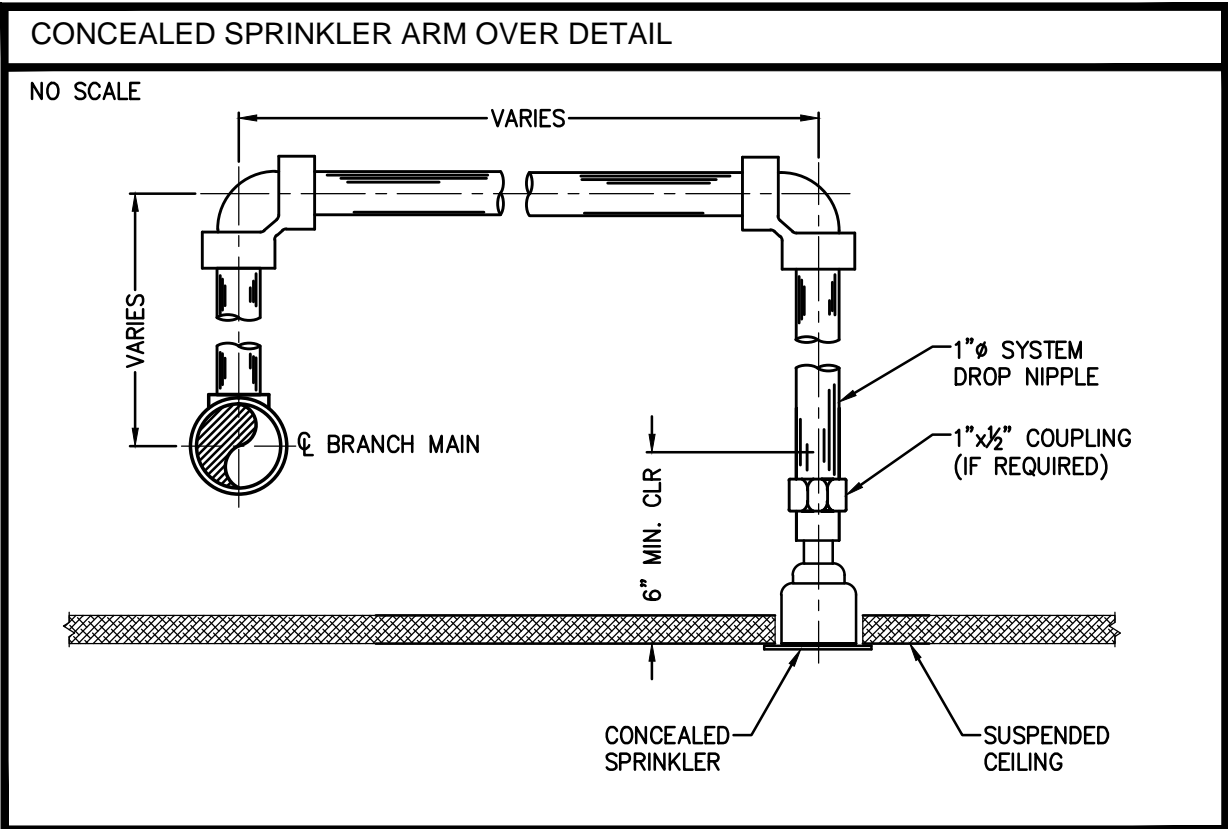
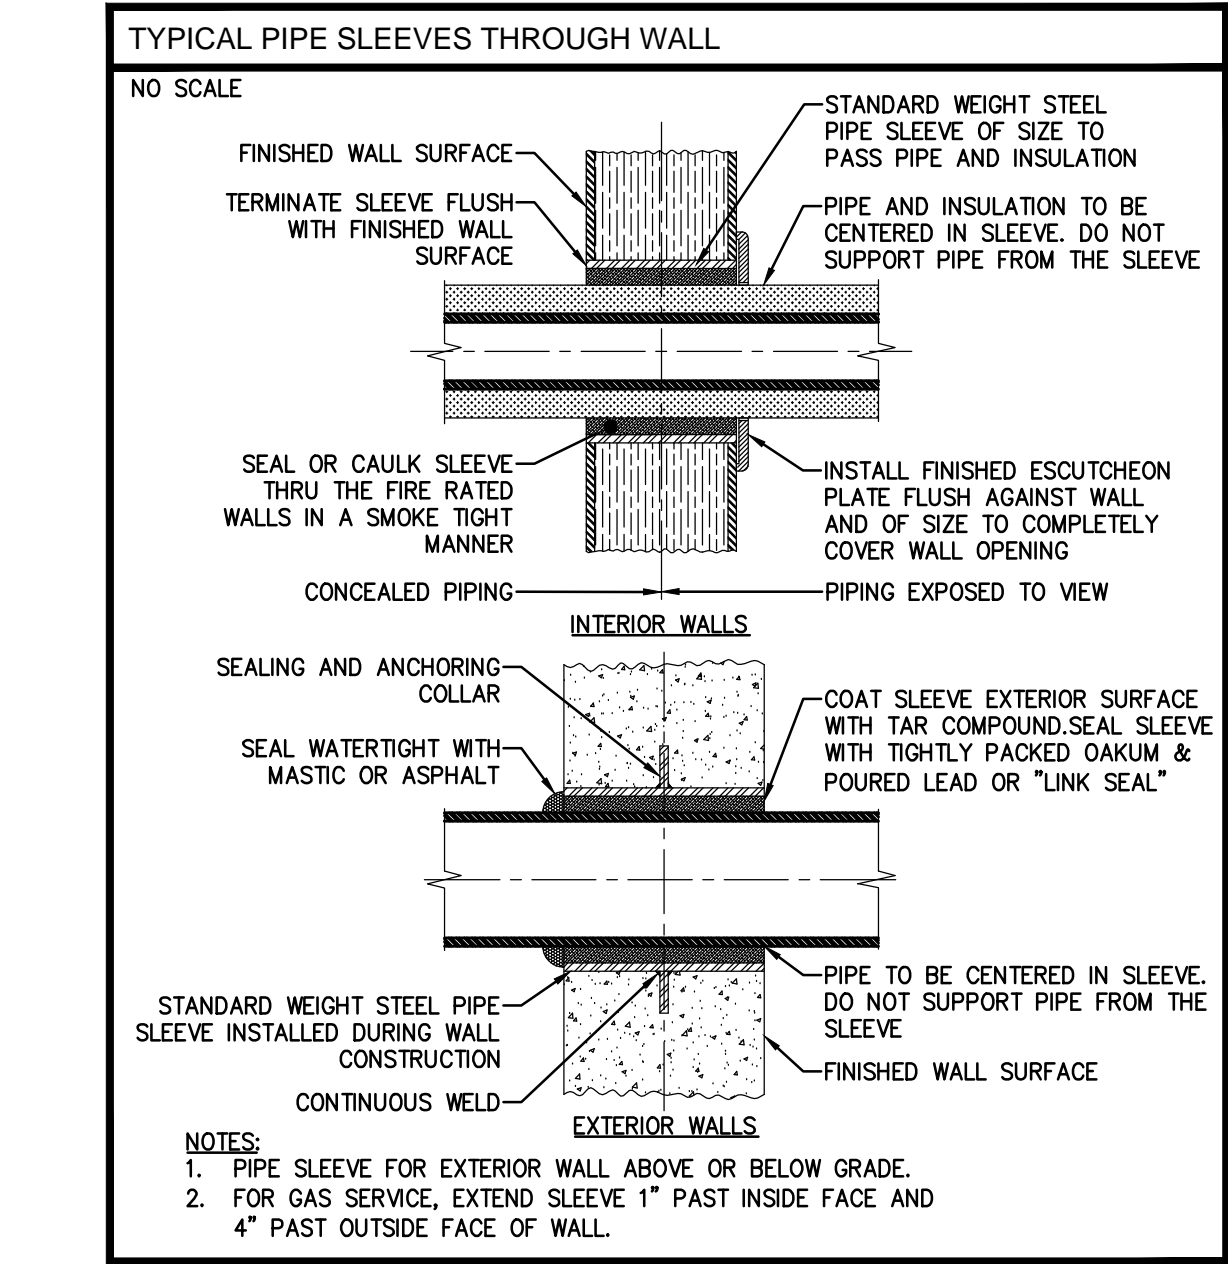
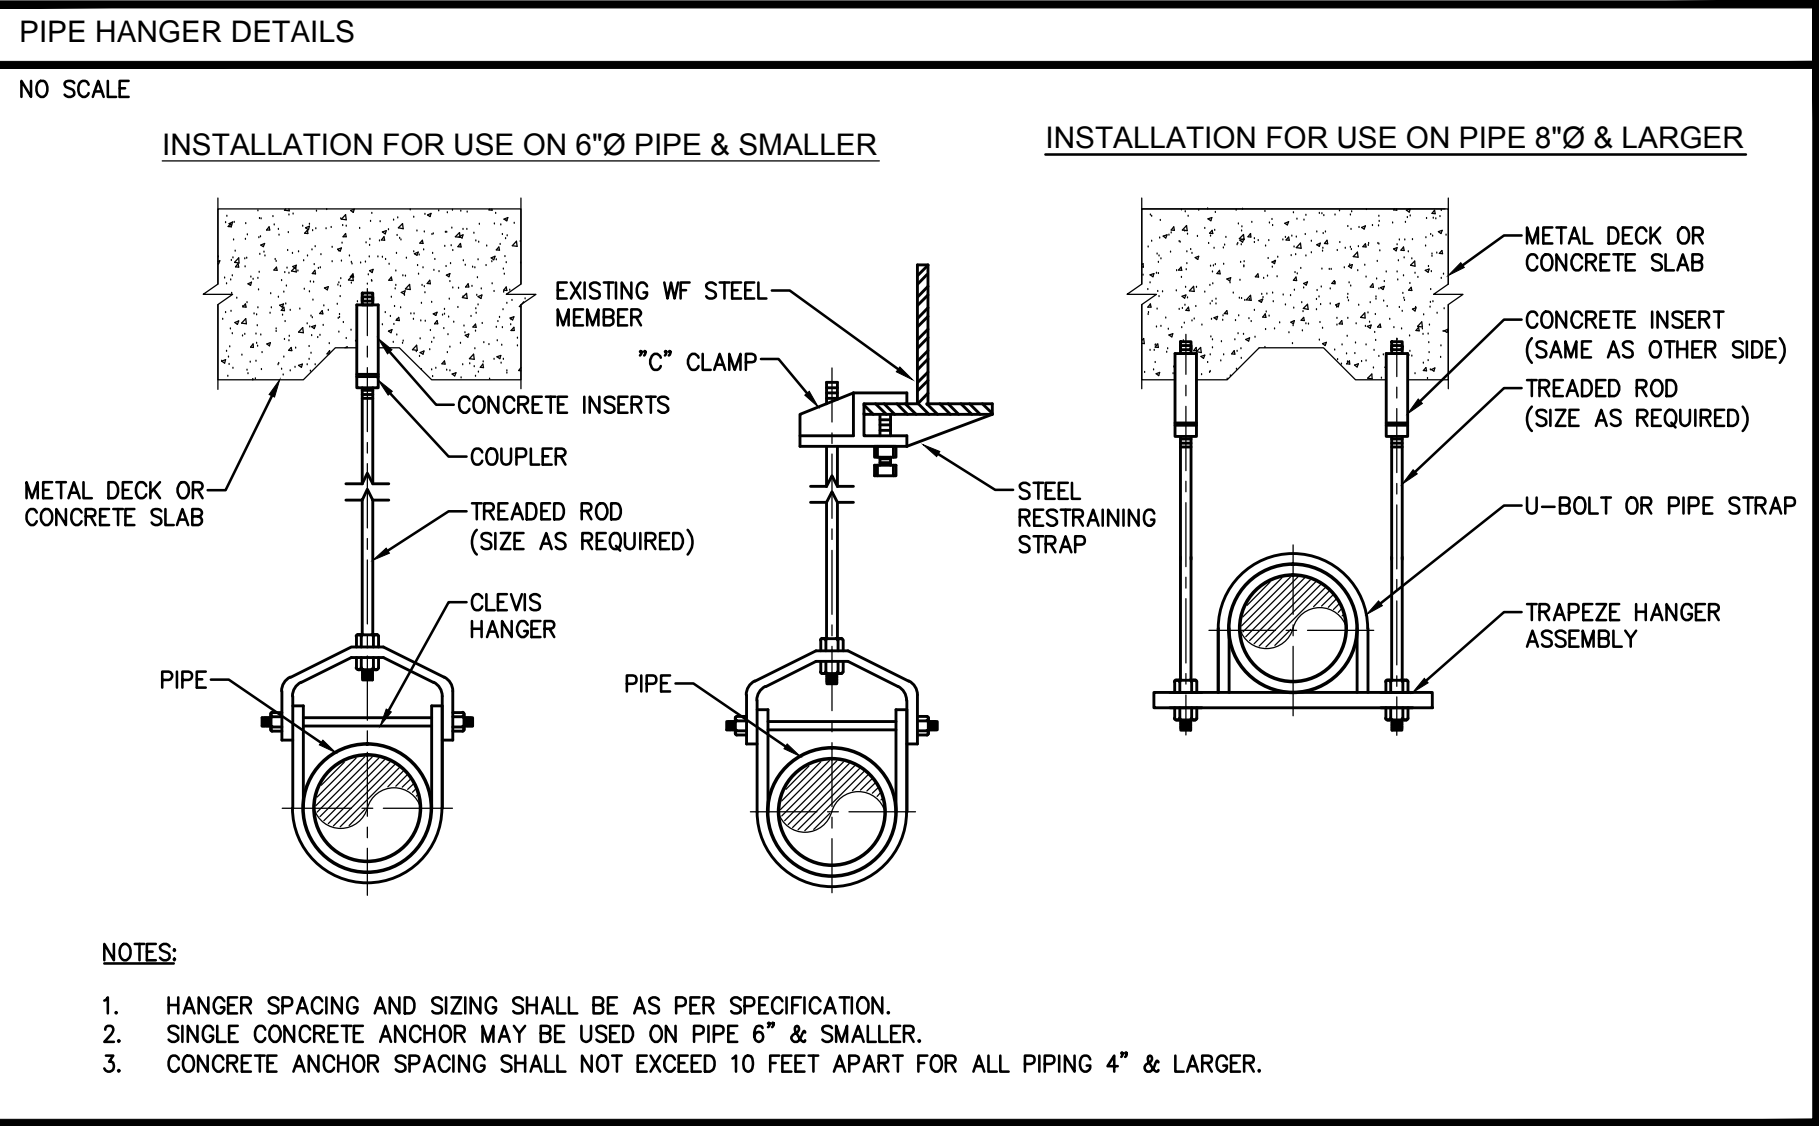
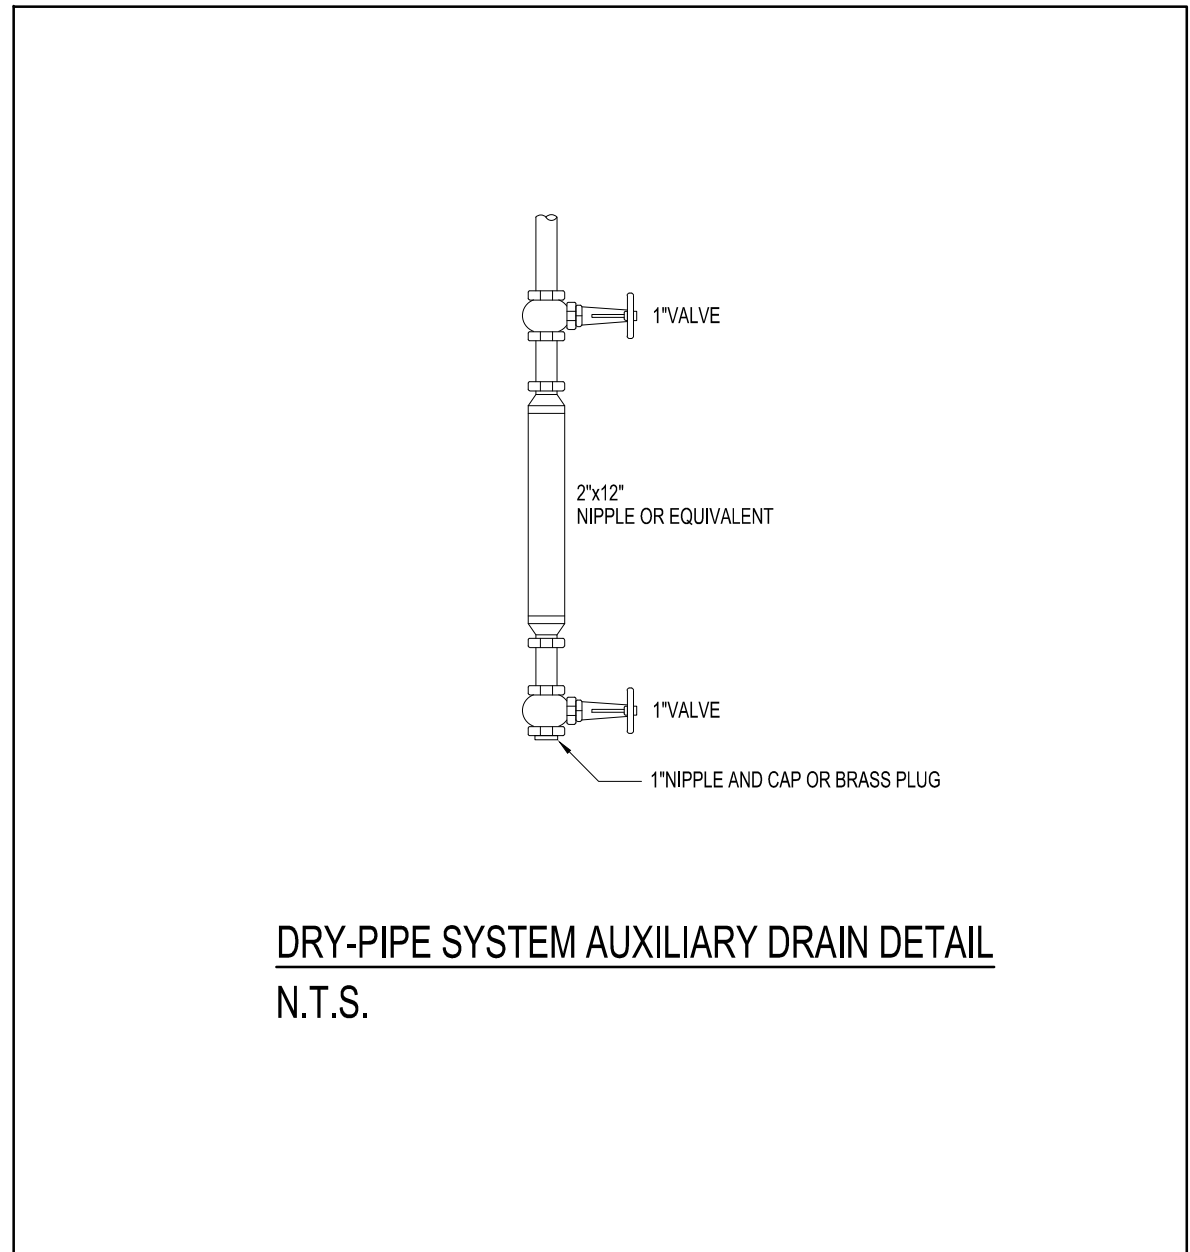
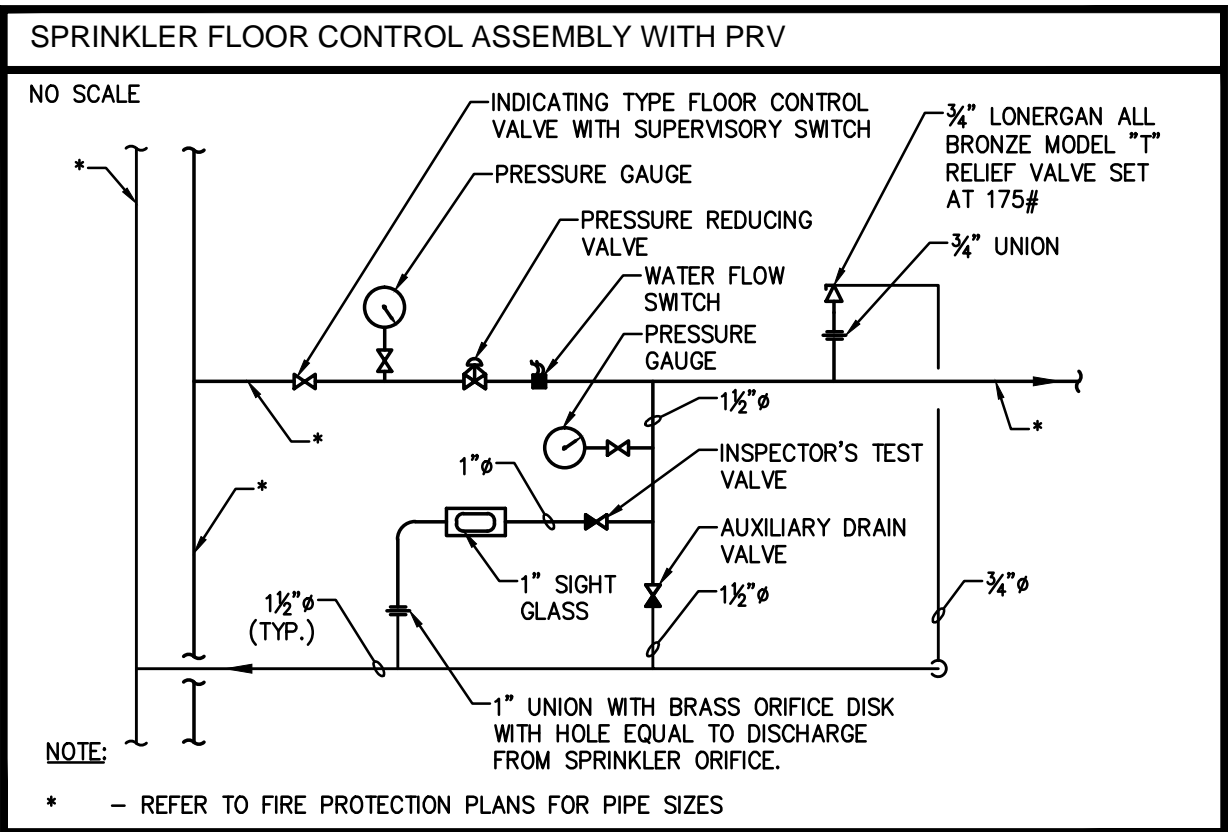
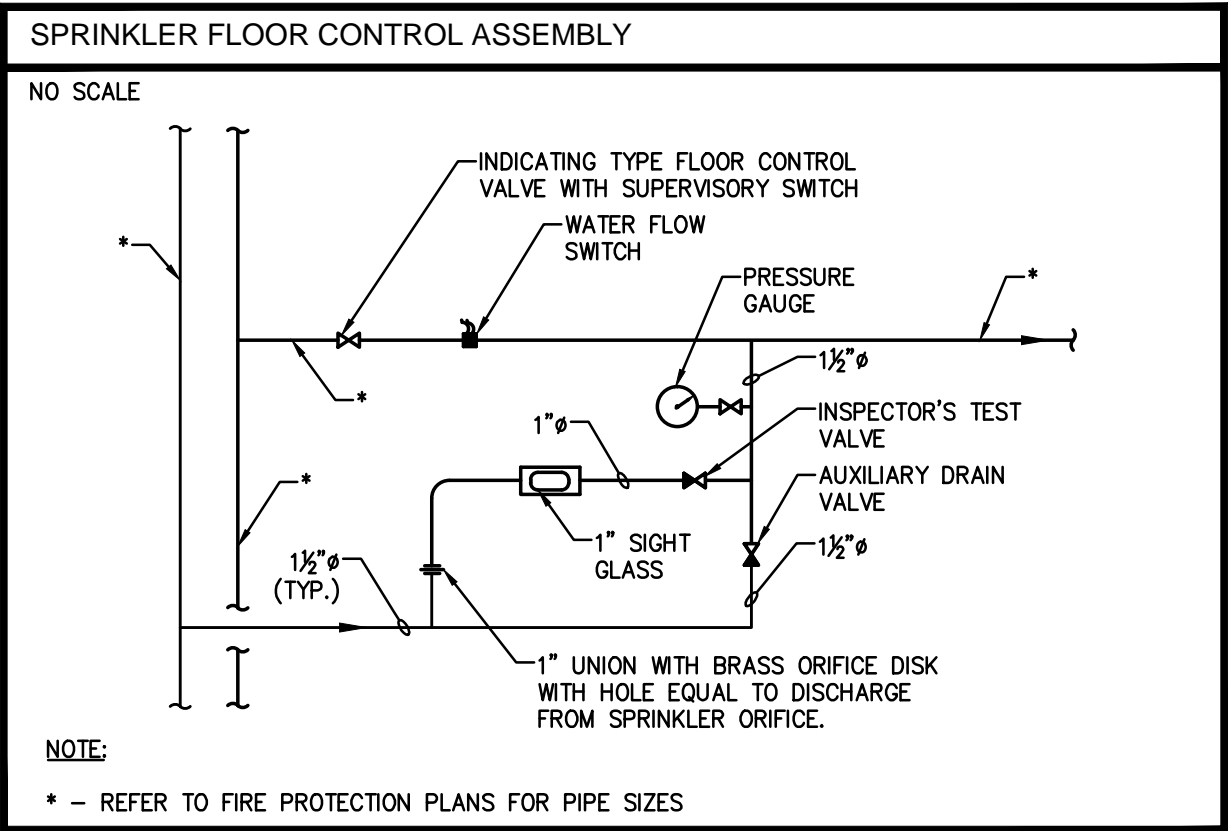
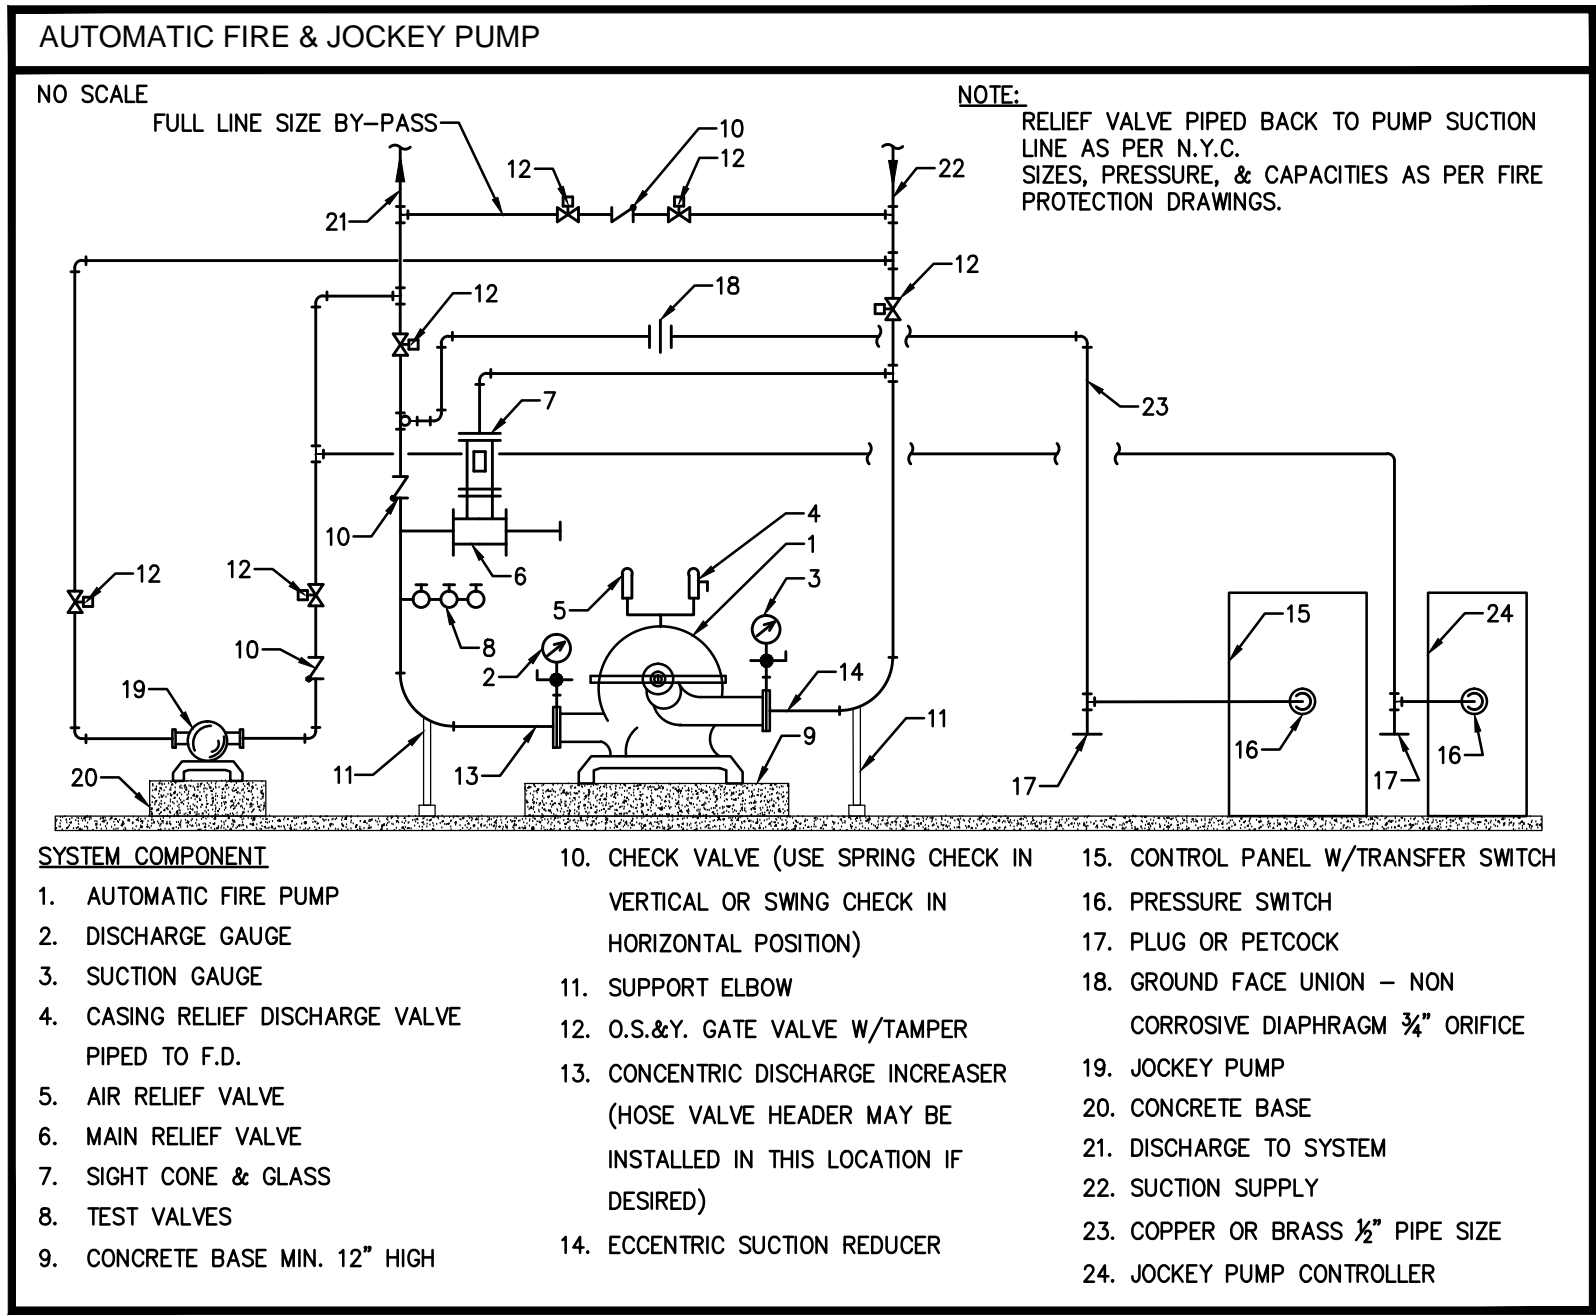
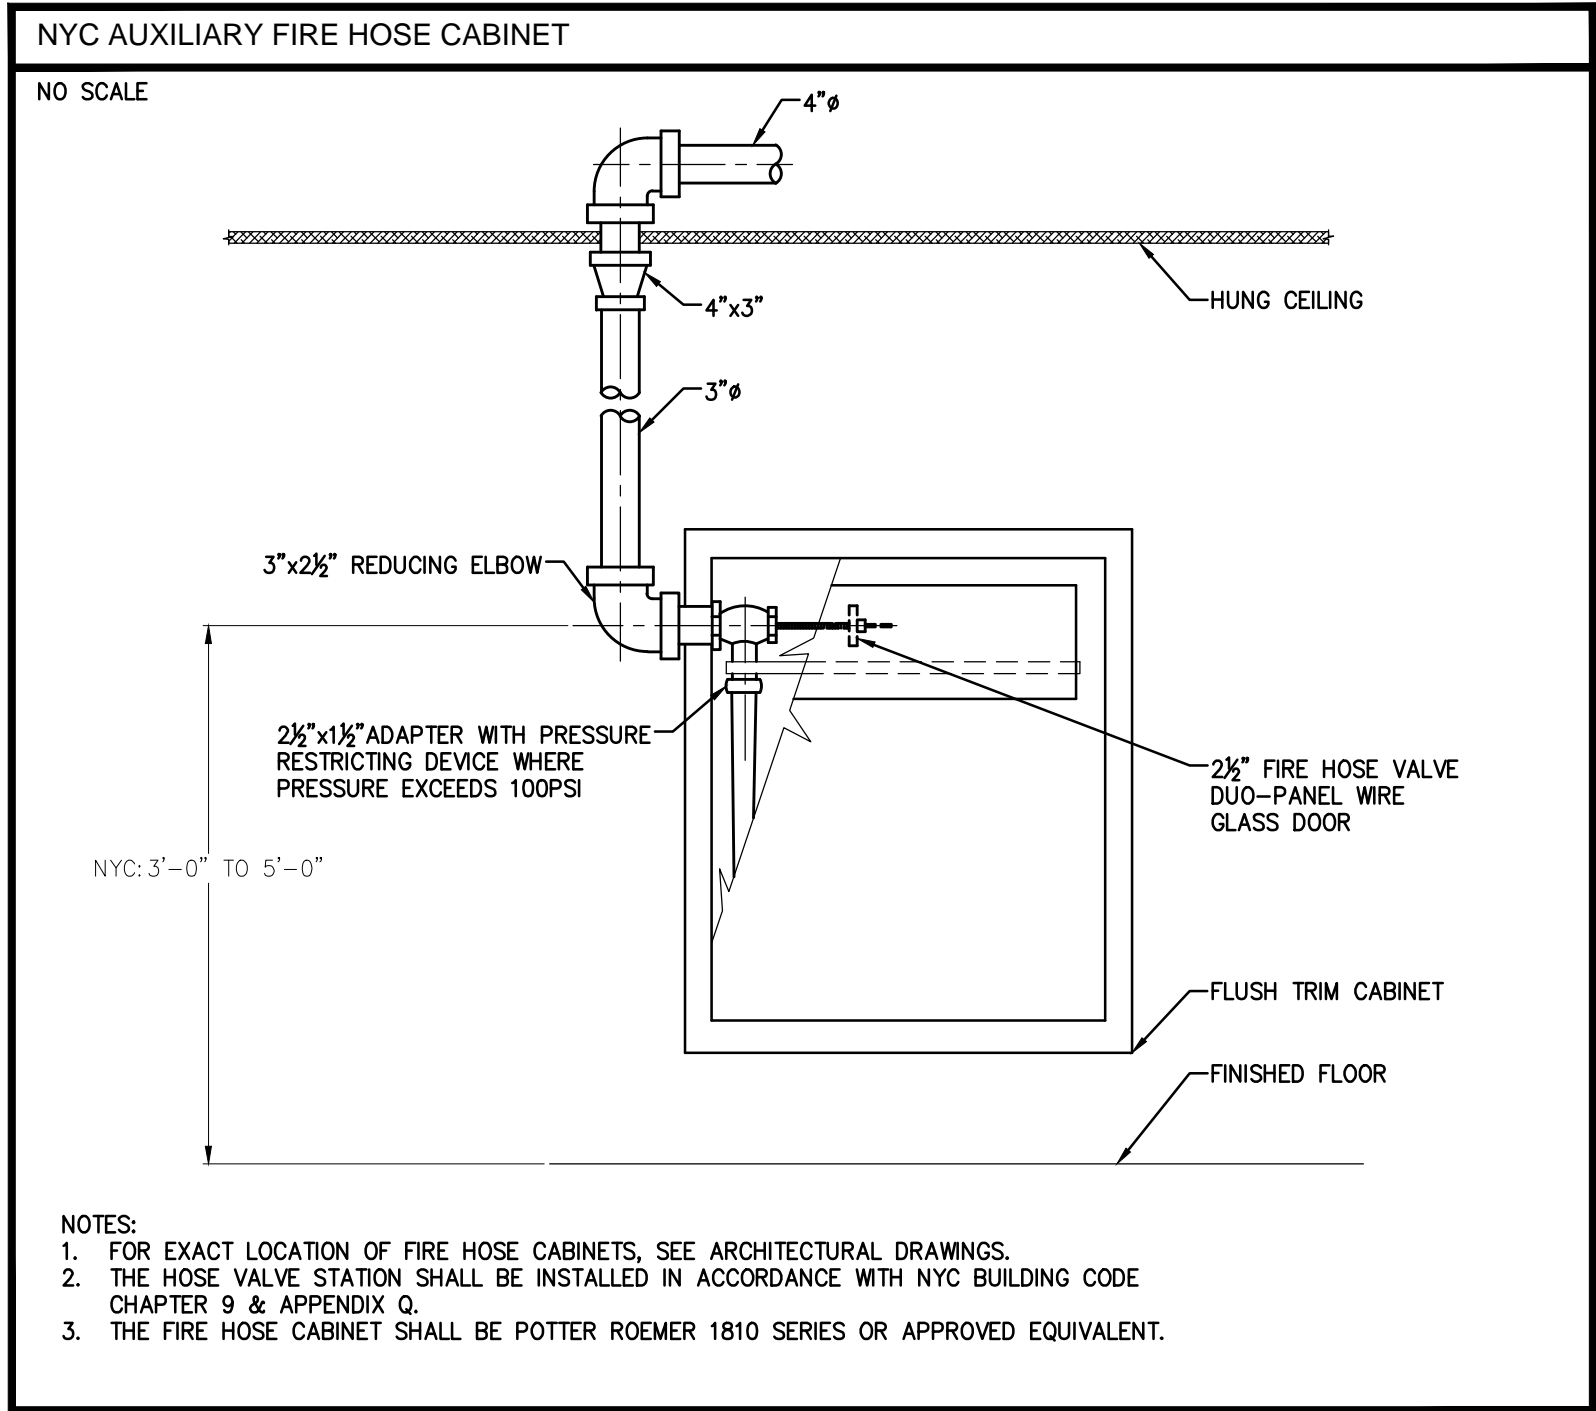
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FIRE PROTECTION RISER DIAGRAM SHEET 1

Project No.: 1400A.000	B-SCAN Sheet No.: FP-400
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SHEET NOTES

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Key Plan:

Seal & Signature:

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Sheet Name: FIRE PROTECTION DETAIL SHEET

SHEET NOTES



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EXCAVATION NOTES:

3. THE CONTRACTOR SHALL COORDINATE ALL WORK NEAR THE RAILROAD TRACKS WITH URR AND AMTRAK.
2. SOIL EXCAVATION SHALL NOT PROCEED DEEPER THAN 2 FEET BELOW THE LAST INSTALLED LAGGING. ALL LAGGING SHALL BE PLACED HORIZONTAL AND BACKPACKED PRIOR TO ADVANCING THE EXCAVATION. THE EXCAVATION SHALL BE SEQUENCED SO THAT STABILITY OF ADJACENT STRUCTURES IS MAINTAINED AT ALL TIMES.
3. ROCK EXCAVATION:
 - A. SLOT (CHANNEL) OR LINE DRILL AS REQUIRED.
 - B. PLUG ALL SEEMS AND LENSES IN ROCK WITH GROUT AS REQUIRED.
 - C. INSTALL ROCK BOLTS AND TENSIONED ROCK ANCHORS AS REQUIRED AND AS DIRECTED BY THE ENGINEER.
4. CONTRACTOR SHALL LOCATE ALL UTILITIES AND EXISTING UNDERGROUND STRUCTURES PRIOR TO INSTALLING SOLDIER PILES, TIEBACKS OR ROCK BOLTS. THE CONTRACTOR IS RESPONSIBLE FOR REMOVING, RELOCATING AND REINSTALLING EXISTING UTILITIES THAT INTERFERE WITH PROPOSED EXCAVATION AND SUPPORT OF EXCAVATION MEMBERS.
5. THE CONTRACTOR SHALL PROVIDE ALL MEASURES AND PRECAUTIONS NECESSARY TO PREVENT DAMAGE AND MINIMIZE SETTLEMENT OF EXISTING OR NEW CONSTRUCTION INSIDE OR OUTSIDE PROJECT LIMITS.
6. CONTRACTOR IS RESPONSIBLE FOR ESTABLISHING A GRID OF MONITORING POINTS WITHIN AND OUTSIDE THE SITE. THE CONTRACTOR SHALL FREQUENTLY READ AND RECORD ALL MOVEMENTS OR SETTLEMENTS DURING EXCAVATION AND REPORT MOVEMENTS TO CONSTRUCTION MANAGER.
7. REMOVE SURFACE WATER AND SEEPAGE FROM ROCK BY SUMPS AS NECESSARY. PROTECT EXISTING DRAINAGE SYSTEM BELOW THE EXISTING PLATFORM CAP BEAM.
8. PROPOSED WORK ON DRAWINGS ARE SUBJECT TO SPECIAL INSPECTION IN ACCORDANCE WITH THE NEW YORK CITY BUILDING CODE.
9. CONTRACTOR MAY SUBMIT ALTERNATIVE DESIGN DRAWINGS AND CALCULATIONS FOR THE SUPPORT OF EXCAVATION. DRAWINGS AND CALCULATIONS SHALL BE SIGNED AND SEALED BY A PROFESSIONAL ENGINEER LICENSED IN THE STATE OF NEW YORK. DESIGN SHALL INCLUDE ALL MEASURES REQUIRED TO SUPPORT ADJACENT FOUNDATIONS, BUILDINGS, STREETS, SIDEWALKS, AND UTILITIES.
10. ELEVATIONS ON PLANS ARE GIVEN RELATIVE TO NAVD 88.
11. THE SUPPORT OF EXCAVATION SYSTEM HAS BEEN DESIGNED FOR 600 PSF VERTICAL SURCHARGE AT EXISTING GRADE ALONG THE EXTERIOR OF THE SITE.
12. MATERIALS:
 - A. ALL STEEL (U.O.N.): ASTM A572, GRADE 50
 - B. SOLDIER PILE PILES: API N80 (FY=80KSI)
 - C. TIMBER LAGGING: SOUTHERN PINE OR EQUAL
FB = 1250 PSI (MIN)
FV = 175 PSI (MIN)
 - D. THREADED STEEL BAR FOR TENSIONED PERMANENT ANCHORS AND TIE-BACKS: ASTM A722, GRADE 150
 - E. ROCK BOLTS: ASTM A615 GRADE 75
 - F. SOLDIER PILE GROUT: MIN. 4000 PSI COMPRESSIVE STRENGTH AT 28 DAYS
 - G. WELDING: AWS D1.1, E70XX ELECTRODES
13. SOLDIER (DRILLED-IN) PILE PILES:
 - A. ALL SOLDIER PILES SHALL BE INSTALLED PLUMB IN DRILLED HOLES. ANY DEVIATIONS OF THE PILE ALIGNMENT BEYOND THOSE SPECIFIED SHALL BE BROUGHT TO THE ATTENTION OF THE CONSTRUCTION MANAGER PRIOR TO EXCAVATION.
 - B. ALL PILES SHALL BE FILLED WITH GROUT.

TIEBACK NOTES:

1. THE TIEBACK INSTALLATION TOLERANCE FOR VERTICAL AND HORIZONTAL ANGLES SHALL BE A MAXIMUM OF 3 DEGREES.
2. THE TIEBACK GROUT USED TO FILL THE DRILLED HOLE SHALL CONSIST OF A MIXTURE OF PORTLAND CEMENT, WATER AND FLUIDIFIER (IF REQUIRED) PROPORTIONED TO PROVIDE A GROUT CAPABLE OF BEING PLACED WITHOUT DIFFICULTY AND WHICH WILL LATERALLY PENETRATE AND FILL THE SOIL AROUND THE ANCHOR. MATERIALS SHALL BE PROPORTIONED TO PROVIDE A MINIMUM COMPRESSIVE STRENGTH OF 3500 PSI AT 7 DAYS AND 5000 PSI AT 28 DAYS.
3. THE MAXIMUM EXCAVATION LEVEL BELOW THE CENTERLINE OF THE TIEBACKS SHALL BE 10 TO 2 FEET PRIOR TO INSTALLATION AND STRESSING.
4. HOLES FOR TIEBACKS SHALL BE DRILLED BY ROTARY METHODS USING INTERNAL FLUSH OF DRILL CUTTINGS AND UTILIZING A TEMPORARY METHODS OF INSTALLATION SHALL BE USED WHICH SHALL PREVENT THE LOSS OF GROUND DUE TO EROSION. INSTALLATION METHODS USED MUST BE SUCH THAT THE FLOW OF WATER OR MOVEMENT OF SOIL THROUGH ANNULAR SPACES OUTSIDE THE CASING IS PREVENTED.
5. CONDUCT PERFORMANCE TESTS ON THE FIRST 2 ANCHOR TESTED. CONDUCT PERFORMANCE TESTS BY INCREMENTALLY LOADING AND UNLOADING THE ANCHOR IN ACCORDANCE WITH THE FOLLOWING SCHEDULE:

P = DESIGN LOAD
L = LOCK OFF LOAD (L=0.8P)
AL = ALIGNMENT LOAD

AL, 0.25P
AL, 0.25P, 0.50P
AL, 0.25P, 0.50P, 0.75P
AL, 0.25P, 0.50P, 0.75P, 1.00P
AL, 0.25P, 0.50P, 0.75P, 1.00P, 1.20P
AL, 0.25P, 0.50P, 0.75P, 1.00P, 1.20P, 1.33P
UNLOAD AND LOCK OFF AT L
6. PROOF TEST EACH ANCHOR WHICH IS NOT PERFORMANCE TESTED BY INCREMENTALLY LOADING AND UNLOADING THE ANCHOR IN ACCORDANCE WITH THE FOLLOWING SCHEDULE:

P = DESIGN LOAD
L = LOCK OFF LOAD (L=0.8P)
AL = ALIGNMENT LOAD


AL, 0.25P, 0.50P, 0.75P, 1.00P, 1.20P, 1.33P
UNLOAD AND LOCK OFF AT L
(SEE TIEBACK SCHEDULE FOR "P" AND "L")
7. IN ALL TESTS, THE FINAL LOAD INCREMENT SHALL BE HELD FOR 10 MINUTES. IF THE CREEP CRITERIA FOR THE 10 MINUTE HOLD PERIOD IS NOT MET (SEE NOTE 8 BELOW), THE HOLD PERIOD SHALL BE EXTENDED TO 60 MINUTES. ALL OTHER INCREMENTS SHALL BE HELD LONG ENOUGH FOR THE ENGINEER TO OBTAIN THE MOVEMENT READING, BUT NOT LONGER THAN 1 MINUTE.
8. TIEBACK ACCEPTANCE CRITERIA:

A. CREEP RATE SHALL NOT EXCEED 0.040 INCHES BETWEEN 1 AND 10 MINUTES OR 0.080 INCHES BETWEEN 6 AND 60 MINUTES.

B. MEASURED ELASTIC EXTENSION CORRESPONDS TO THE CALCULATED ELASTIC EXTENSION. MEASURED ELASTIC EXTENSION SHALL NOT EXCEED THE EXTENSION COMPUTED BASED ON THE FREE ANCHOR LENGTH PLUS 50-PERCENT OF THE BOND ZONE LENGTH, OR BE LESS THAN THE ELASTIC EXTENSION COMPUTED BASED ON 90-PERCENT OF FREE ANCHOR LENGTH.
9. ANCHOR TESTING SHALL BE PERFORMED IN THE PRESENCE OF THE ENGINEER WHO WILL MONITOR THE ANCHOR HEAD MOVEMENTS DURING THE TESTS.
10. FOR ALL ANCHORS, AFTER TRANSFERRING THE LOCK-OFF LOAD, AND PRIOR TO REMOVING THE JACK, PERFORM AN INITIAL LIFT-OFF TEST ON EACH ANCHOR. IF THE INITIAL LIFT-OFF LOAD DIFFERS BY MORE THAN 5% OF THE LOCK-OFF LOAD, PROOF TEST THE ANCHOR AGAIN.
11. FOR EACH ANCHOR, WHICH REQUIRED AN ADDITIONAL PROOF TEST DUE TO THE INITIAL LIFT-OFF TEST VARYING BY MORE THAN 5% FROM THE LOCK OFF LOAD, PERFORM A DEFERRED LIFT OFF TEST A MINIMUM OF TWO (2) HOURS AFTER THE LOAD HAS BEEN LOCKED OFF. IF THE DEFERRED LIFT-OFF LOAD IS LESS THAN THE LOCK-OFF LOAD BY MORE THAN 5%, THE ANCHOR IS UNACCEPTABLE AND SHALL BE REPLACED AS DIRECTED BY THE ENGINEER.
12. UPON COMPLETION OF WORK, ALL AND FOLLOWING BACKFILLING TO 2 FEET BELOW EACH TIEBACK, TIEBACKS SHALL BE DETENSIONED.

PRELIMINARY
NOT FOR CONSTRUCTION

Key Plan:

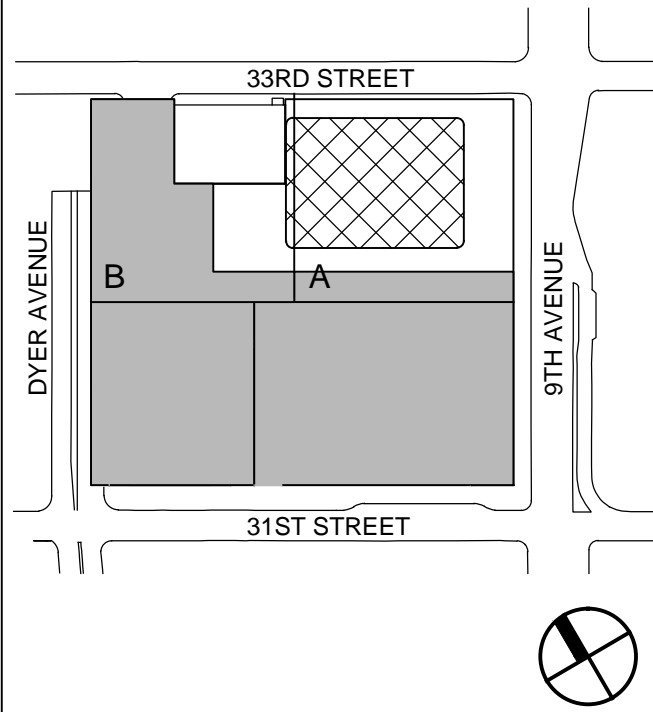


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SUPPORT OF EXCAVATION NOTES

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


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SCALE: 1/8"=1'-0"

NOTES:

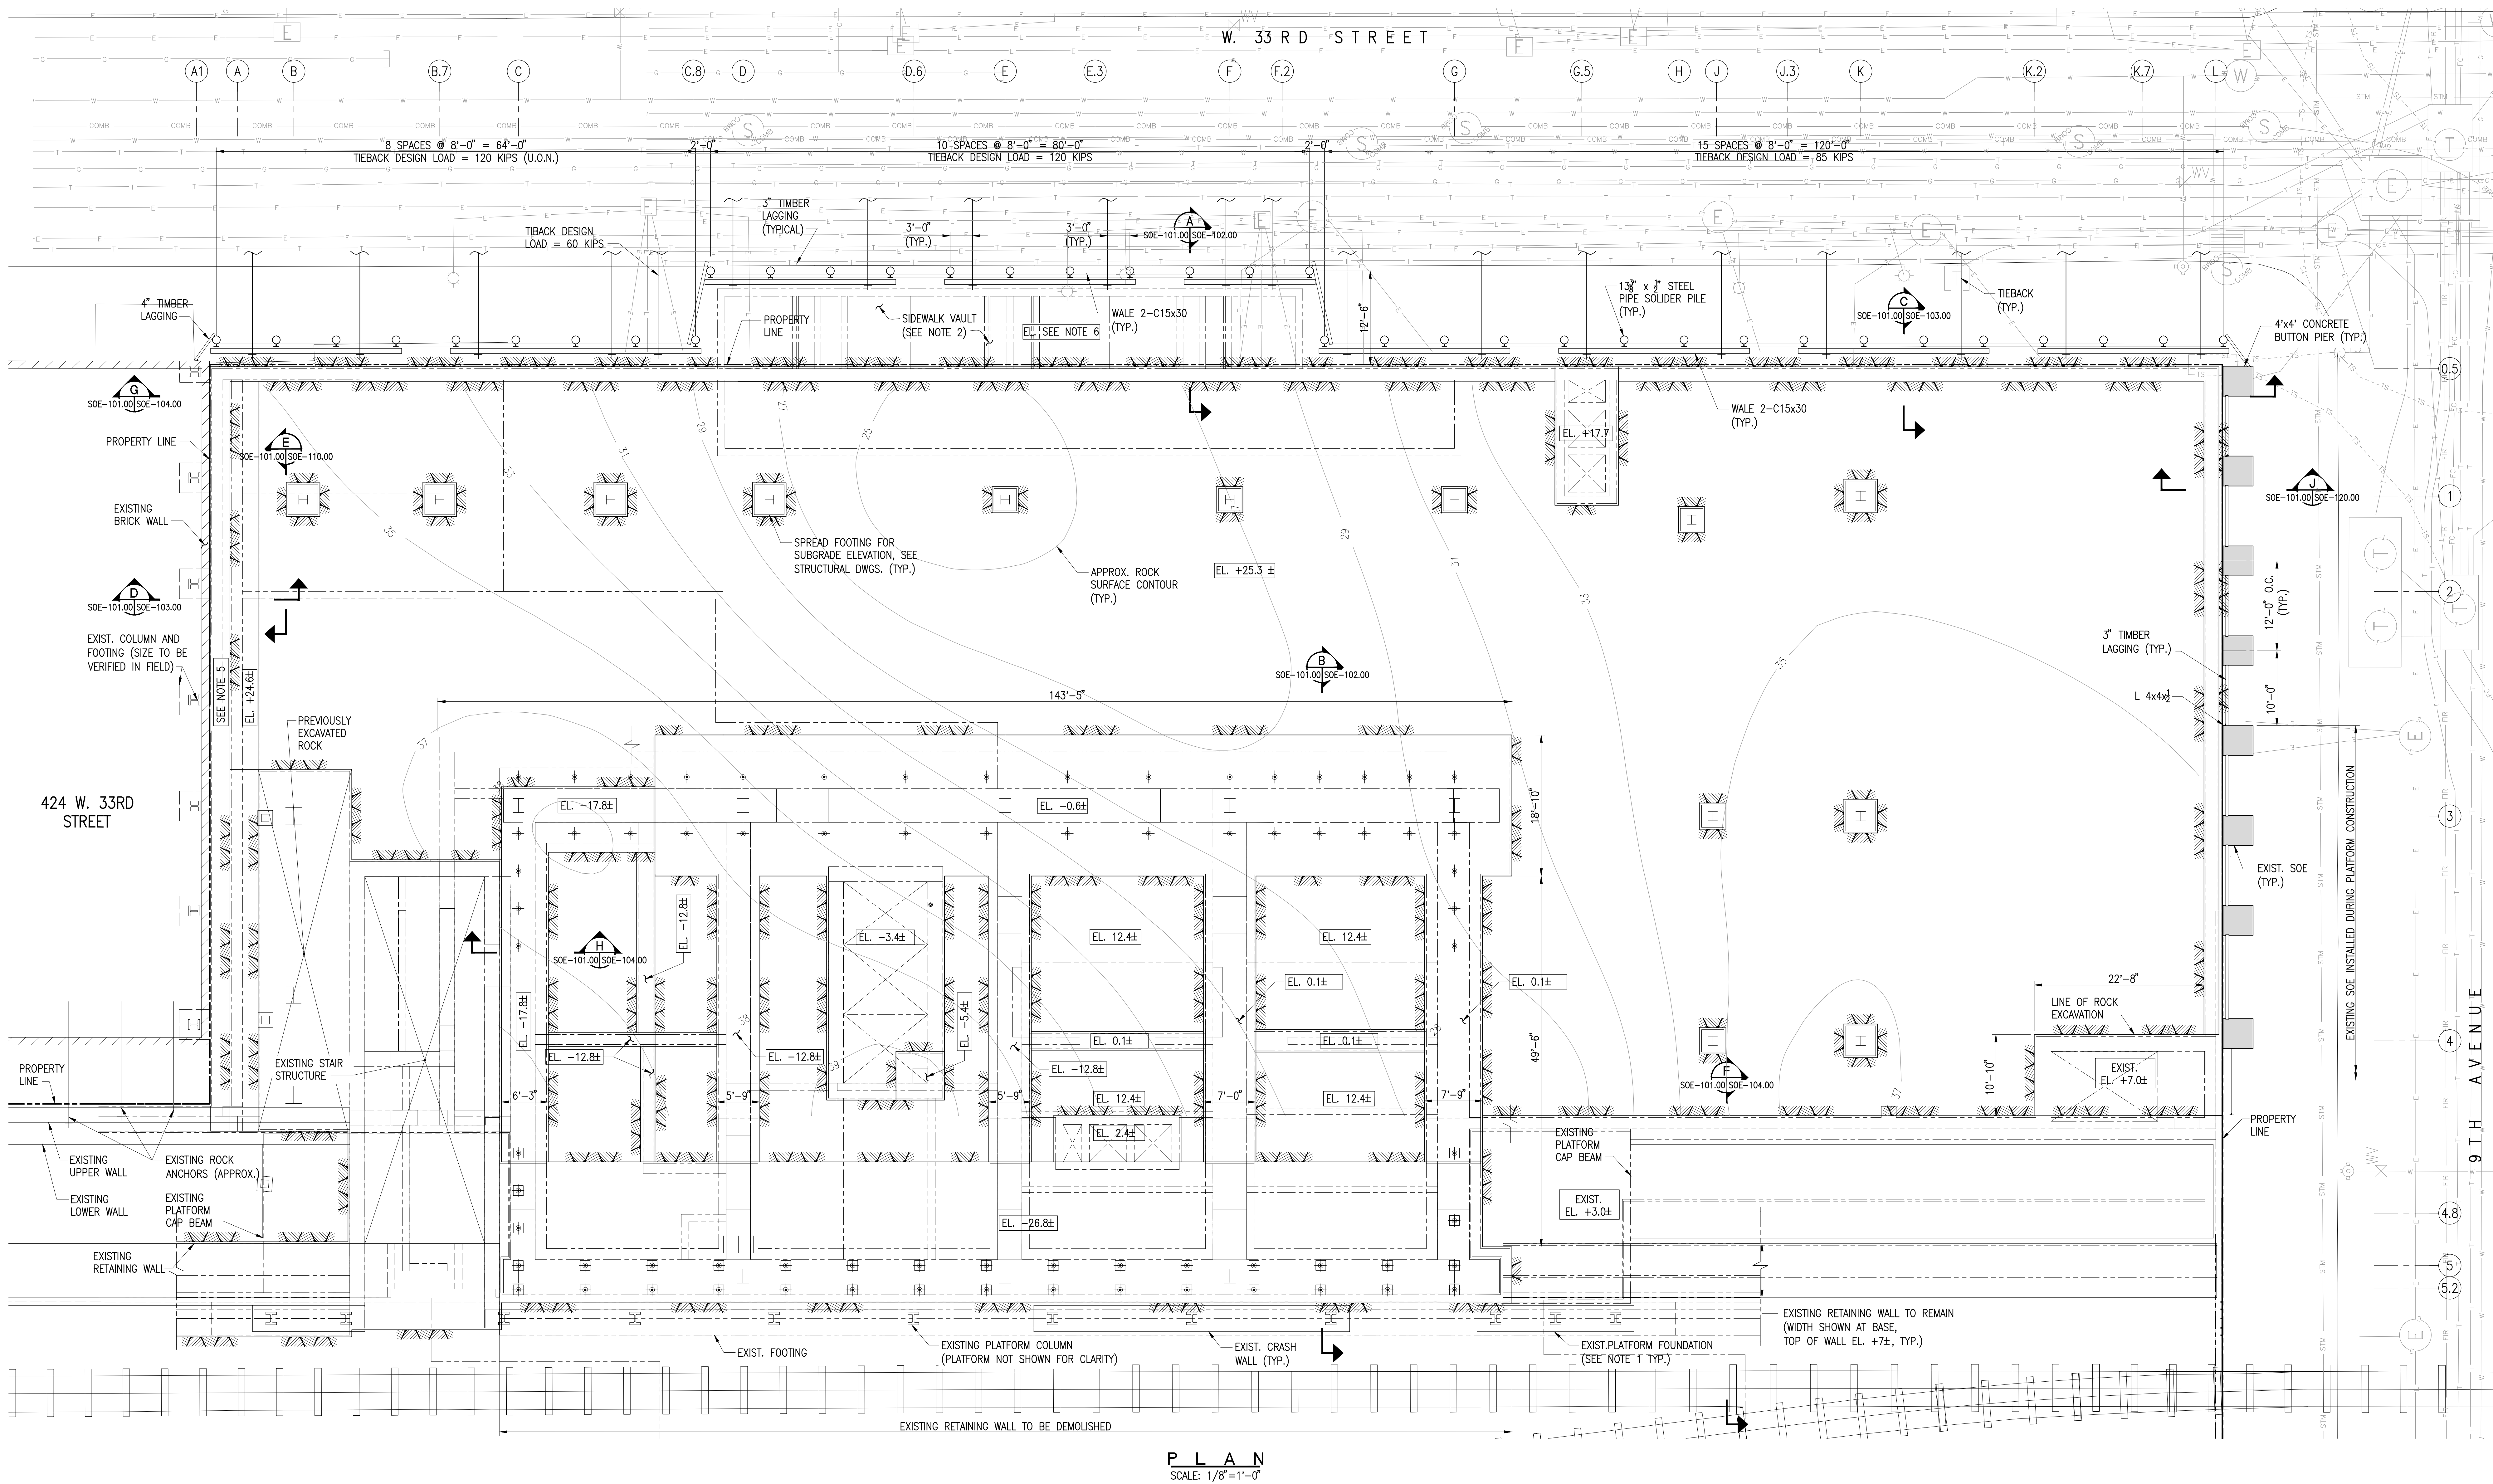1. BEARING PRESSURE AT PLATFORM FOOTINGS AT TIME OF TOWER CONSTRUCTION VARIES BETWEEN 25 TSF AND 40 TSF.
2. AT SIDEWALK VAULT, EXCAVATE TO TOP OF ROCK AND BACK FILL WITH FLOWABLE FILL TO ELEVATION SHOWN ON PLAN.
3. TENSIONED PERMANENT ANCHORS TO BE INSTALLED UNDER 424 W. 33RD STREET ARE NOT SHOWN FOR CLARITY. SEE DRAWING SOE-110.00 FOR SPACING.
4. TENSION TIE DOWNS AFTER CONSTRUCTING CAISSON CAP BETWEEN EXISTING BUILDING AND EXISTING STAIR STRUCTURE. DESIGN LOAD = 60 KIPS.
5. ROCK SUBGRADE AT BASE OF LOFT BUILDING FOUNDATION (V.I.F.)
6. ALL ELEVATION ARE REFERENCED TO BOROUGH OF MANHATTAN DATUM.

SHEET NOTES




**MANHATTAN WEST:
NORTH TOWER**
375 Ninth Avenue, New York, NY 10001
Client

Brookfield
Brookfield Place
220 Vesey Street, 15th Floor, New York, NY 10281

Geotechnical Engineering
Mueser Rutledge Consulting Engineers
14 Penn Plaza, 225 W. 34th Street, New York, NY 10122

PRELIMINARY
NOT FOR CONSTRUCTION

Key Plan:

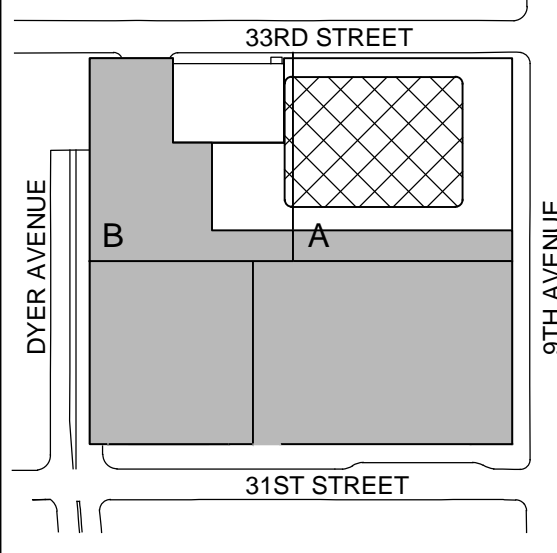

Seal & Signature:





3	30 MAY 2014	ISSUED FOR ROCK ENG. ADD. TO LOFT BLD.
2	20 DEC 2013	ISSUED FOR FOUNDATION PERMIT
1	28 MAR 2014	ISSUED FOR PERMITS DEVELOPMENT
No.	Date	Description
Sheet Name:		

SUPPORT OF EXCAVATION PLAN


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Date: 20 JUN 2014	Sheet No.: SOE-101.00
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File No.: SOE-101.00	

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- NOTE: ROCK ADJACENT TO EXISTING NT-1 FOOTING SHALL BE REMOVED AS FOLLOWS:
1. EXCAVATE ROCK TO EL. -23.3 FOR MAXIMUM 20 FOOT WIDTH ALONG FOOTING.
 2. INSTALL TEMPORARY ROCK BOLTS AT 5'-0" O.C. MIN.
 3. REPEAT STEPS 1 AND 2.

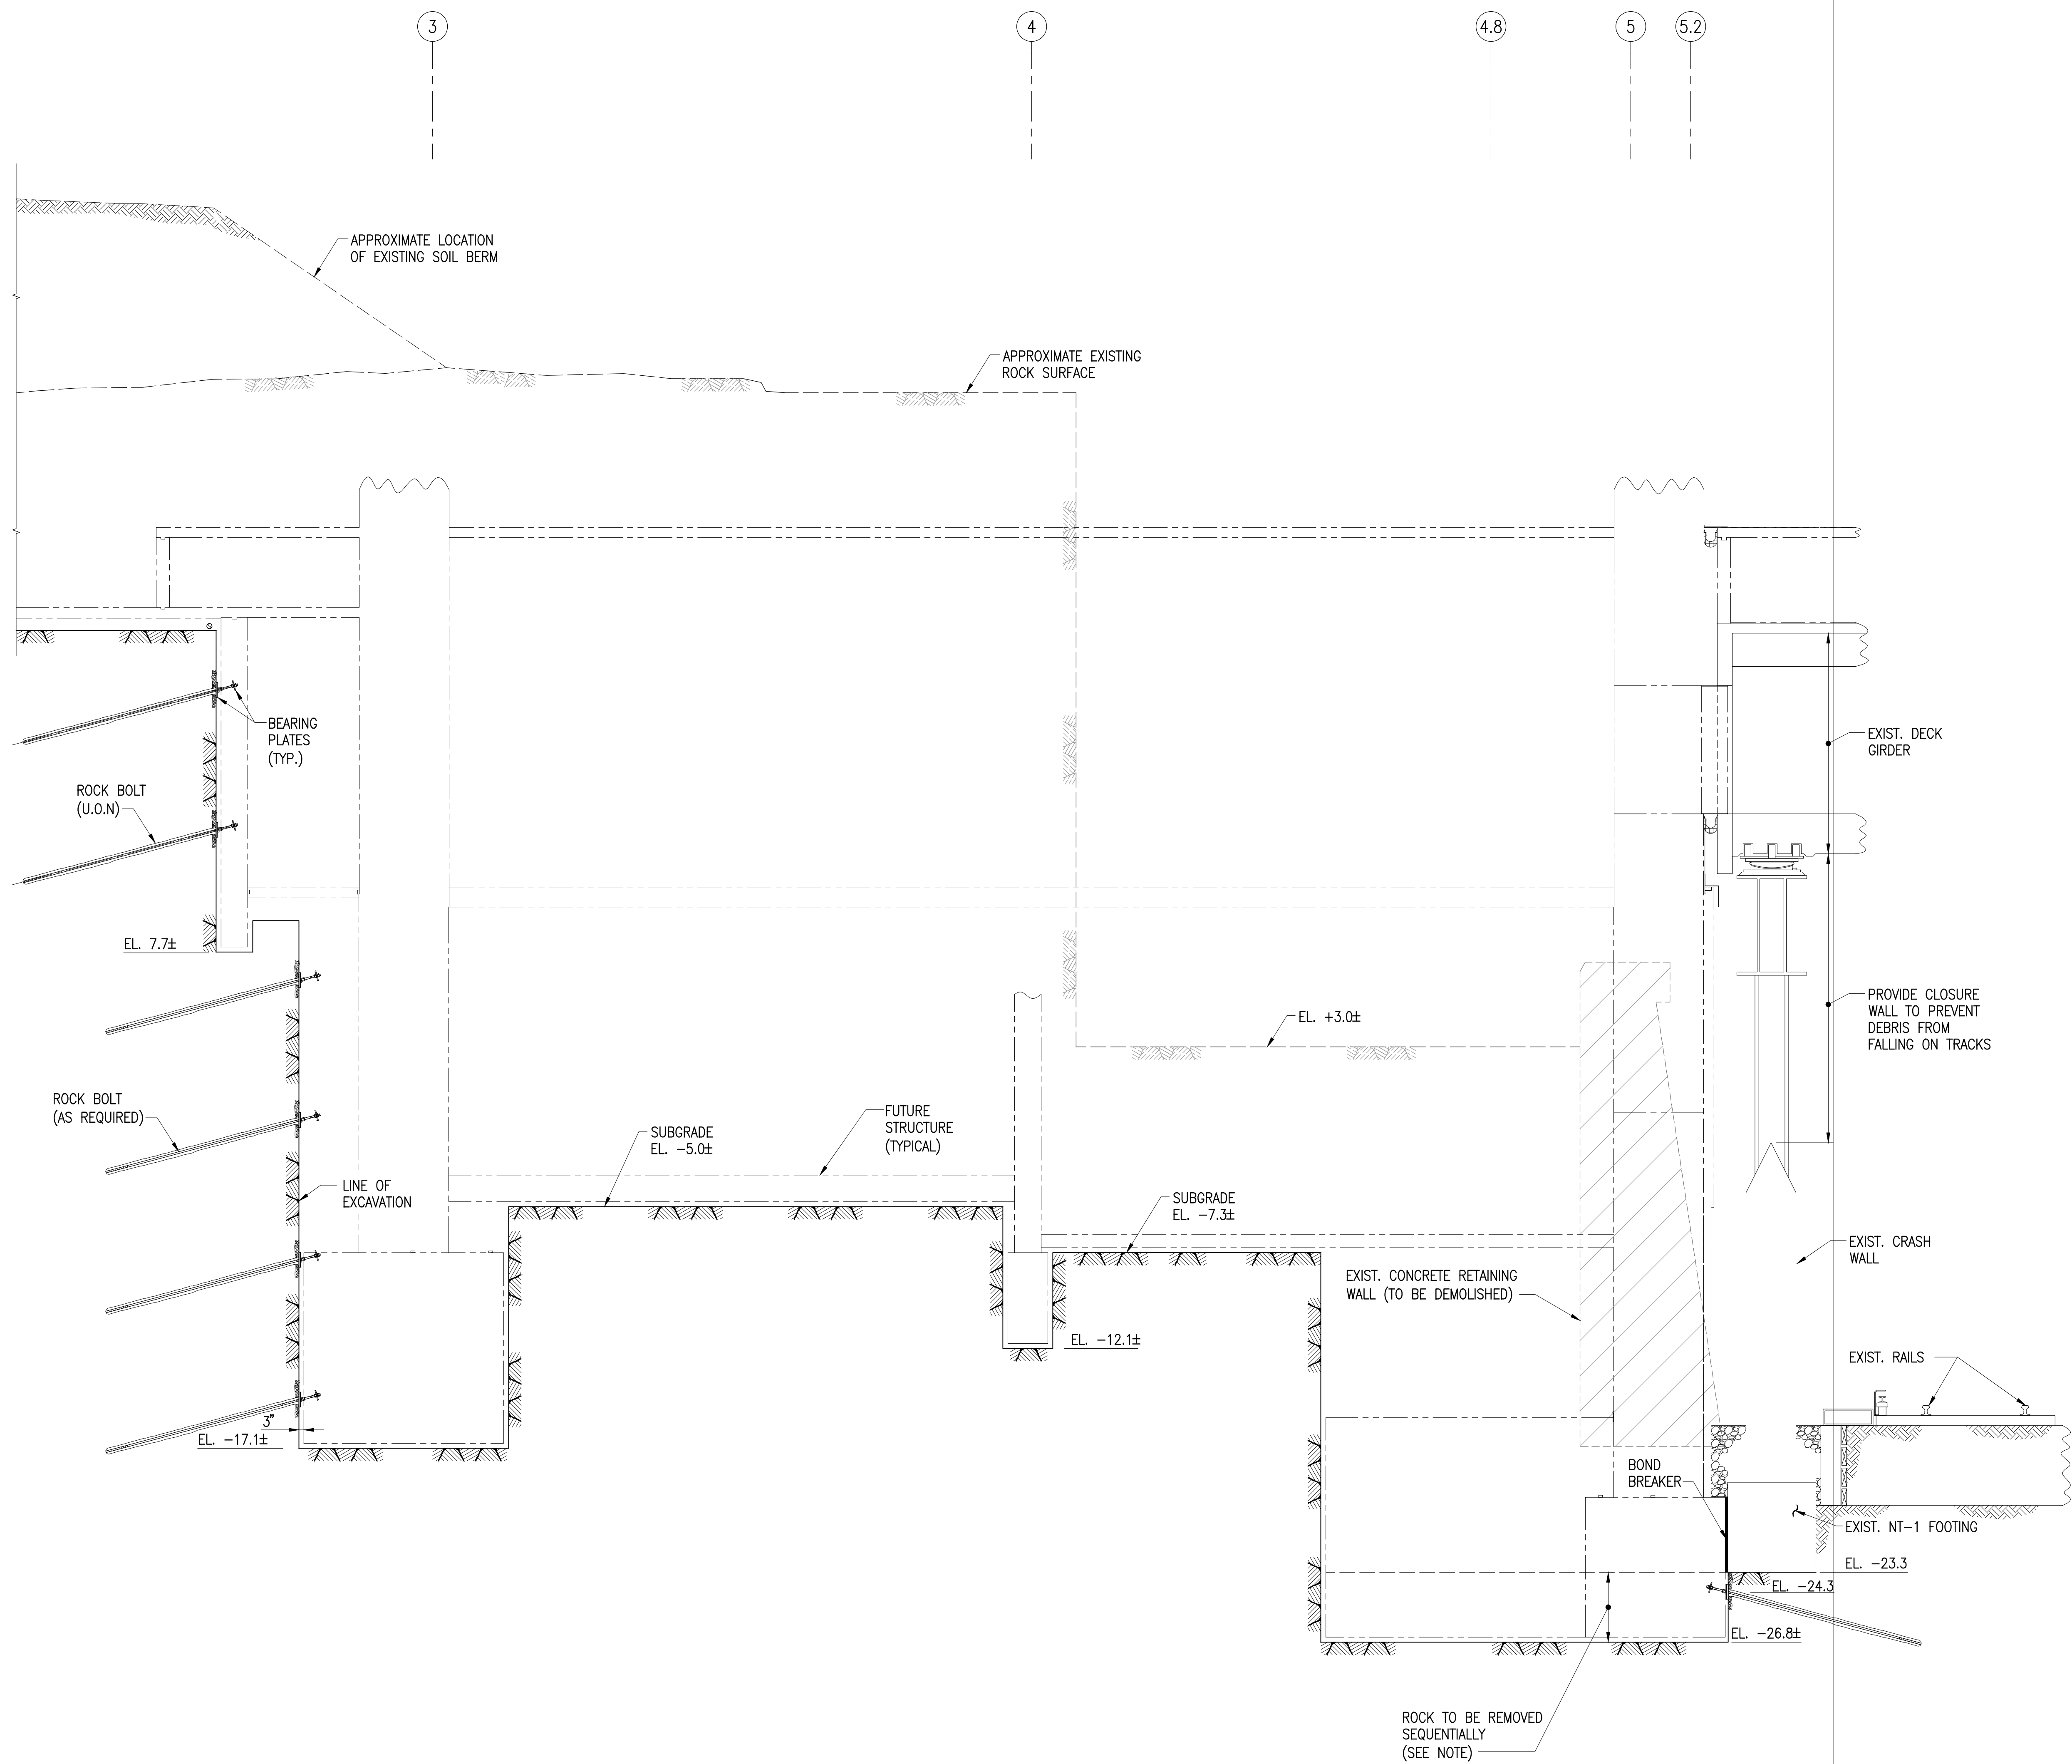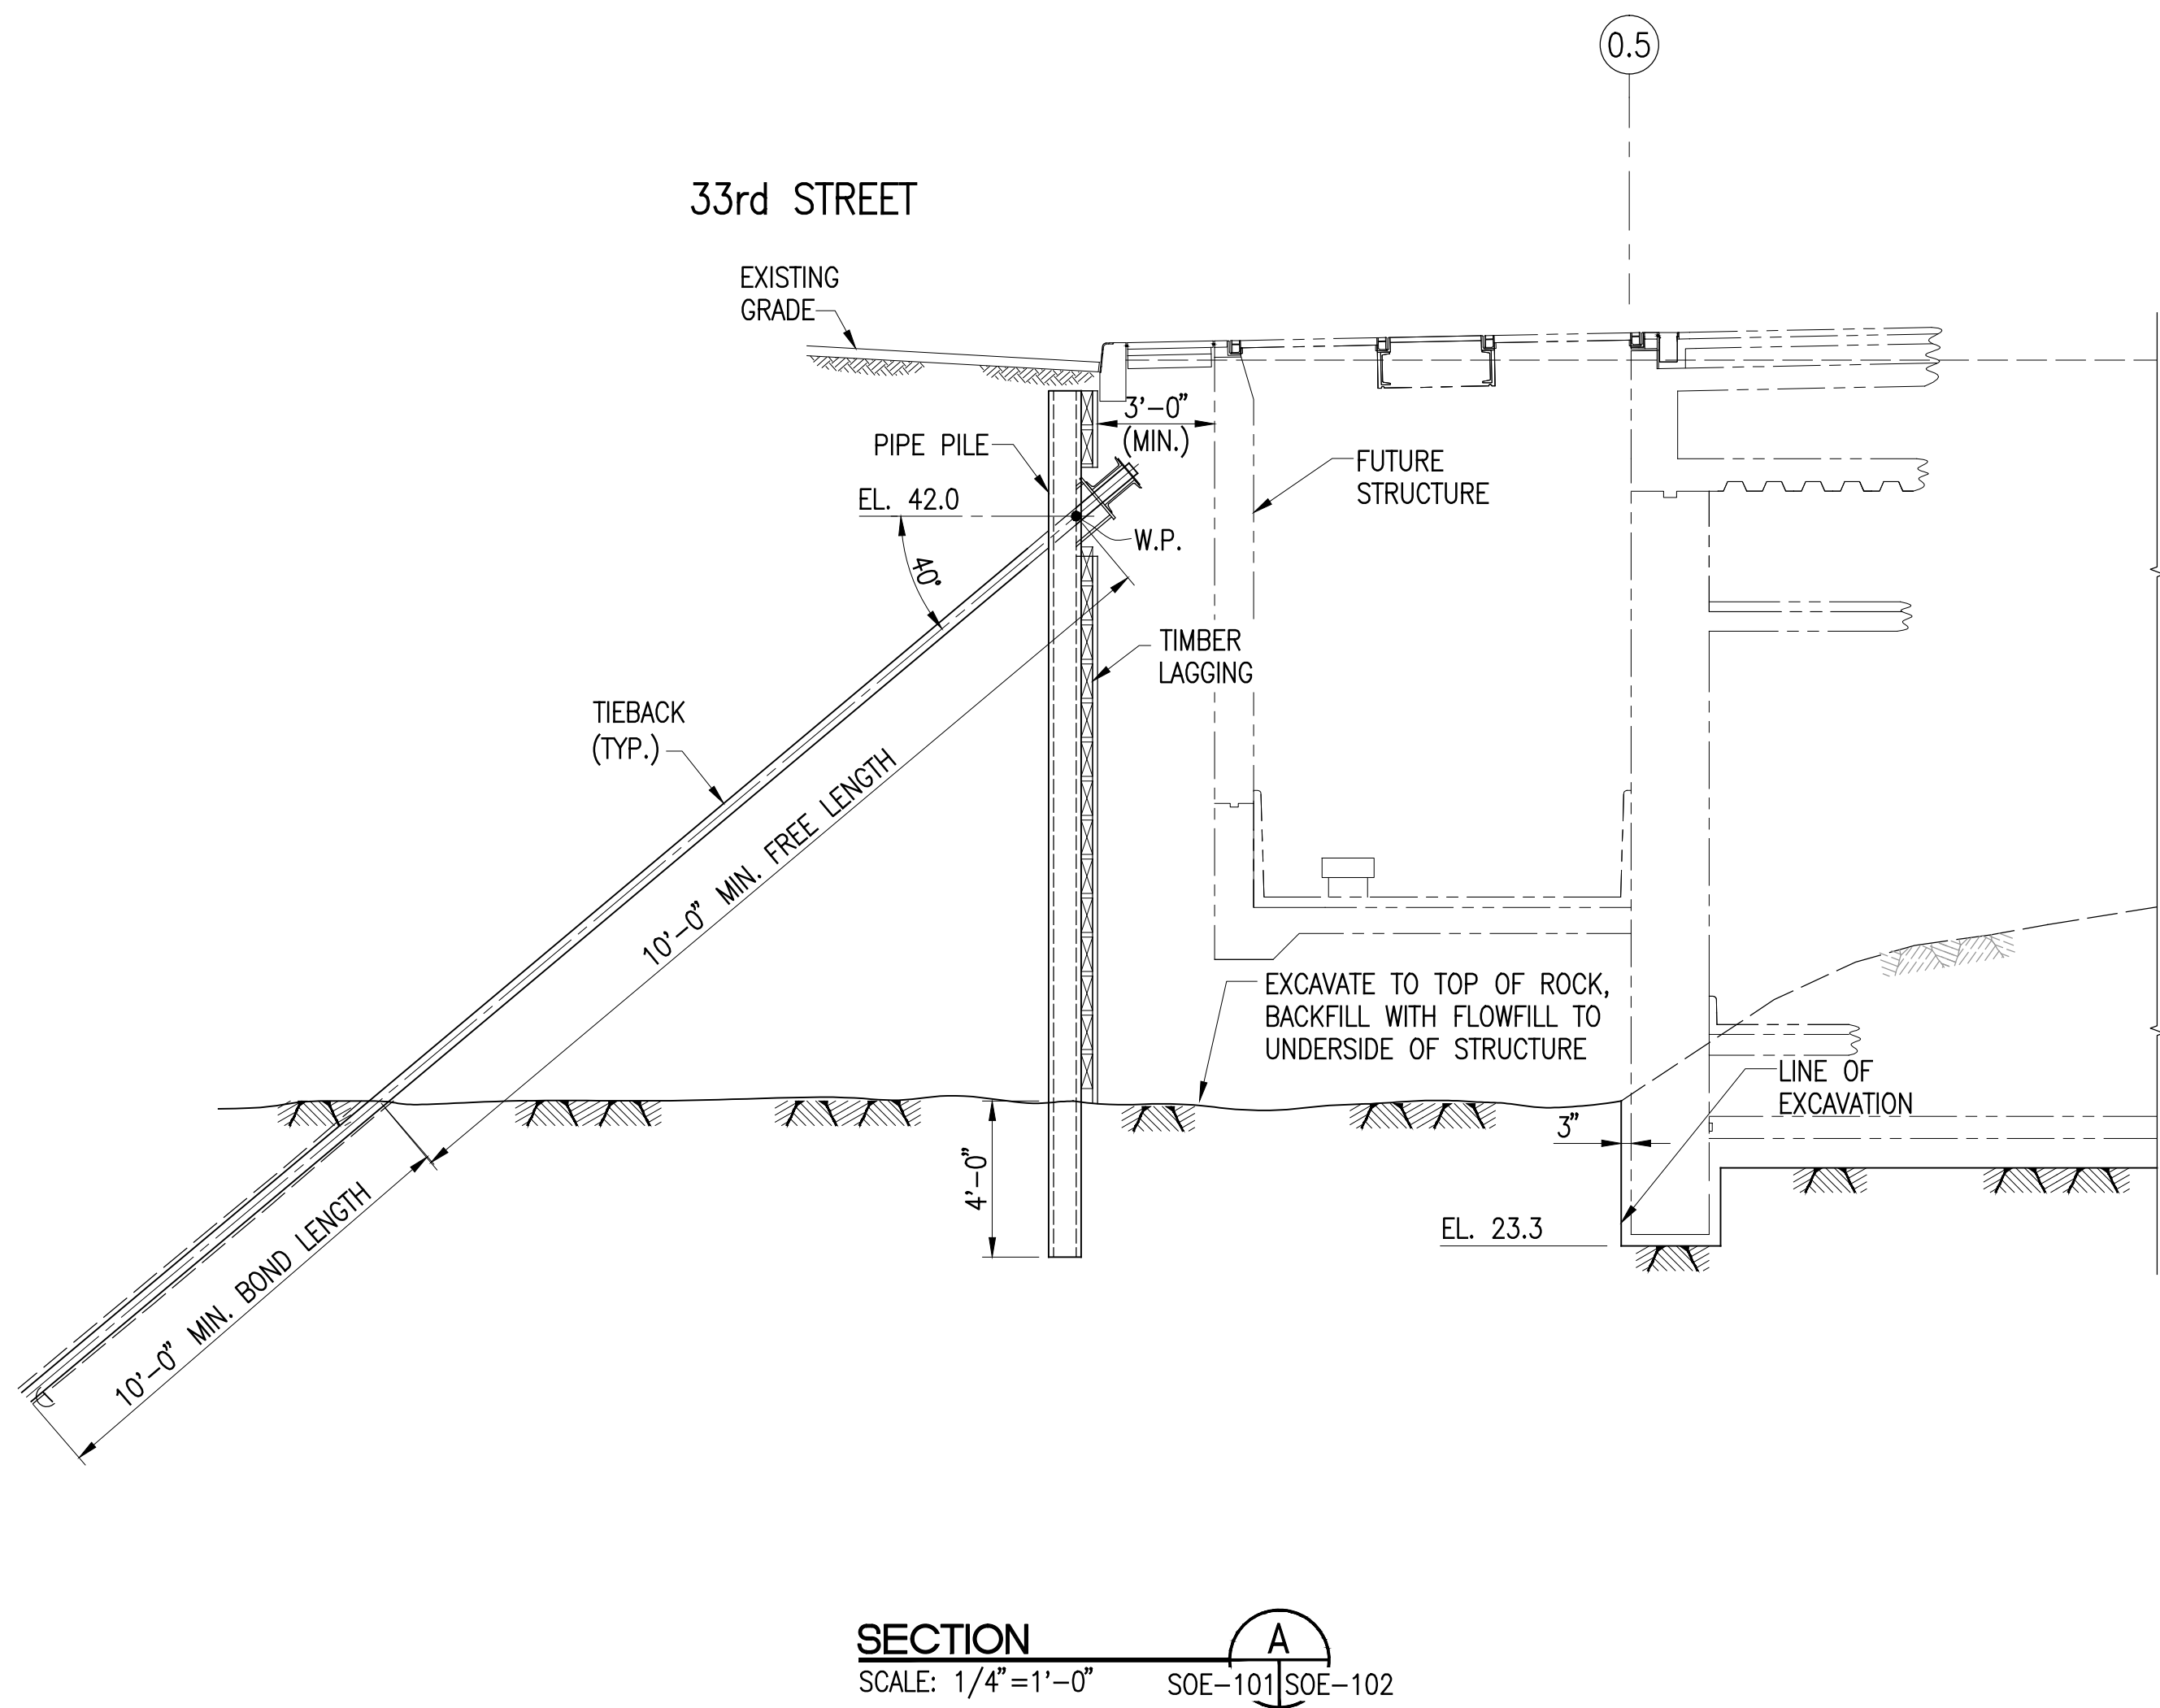SHEET NOTES




MANHATTAN WEST:
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Seal & Signature:

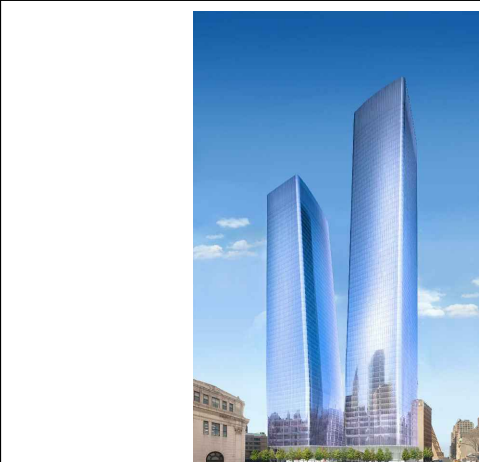


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Sheet Name:

**SUPPORT OF
EXCAVATION
SECTIONS**

Project No.: B-SCAN Sheet No.:
Date: 20 JUNE 2014
Scale: 1/4" = 1'-0"
File No.: SOE-102
Page No.: 3 OF 7

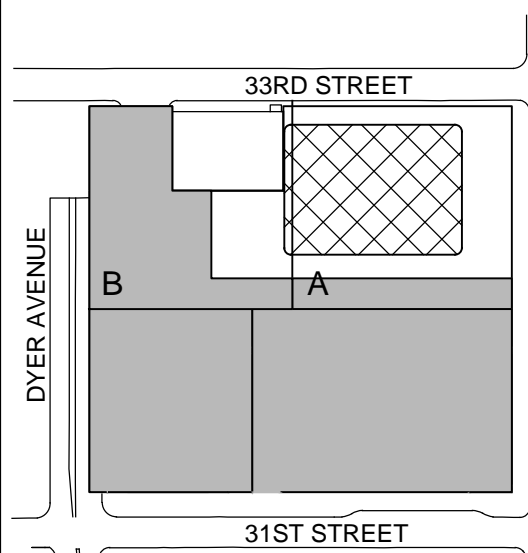SOE-102.00


Sheet No.:
SOE-102

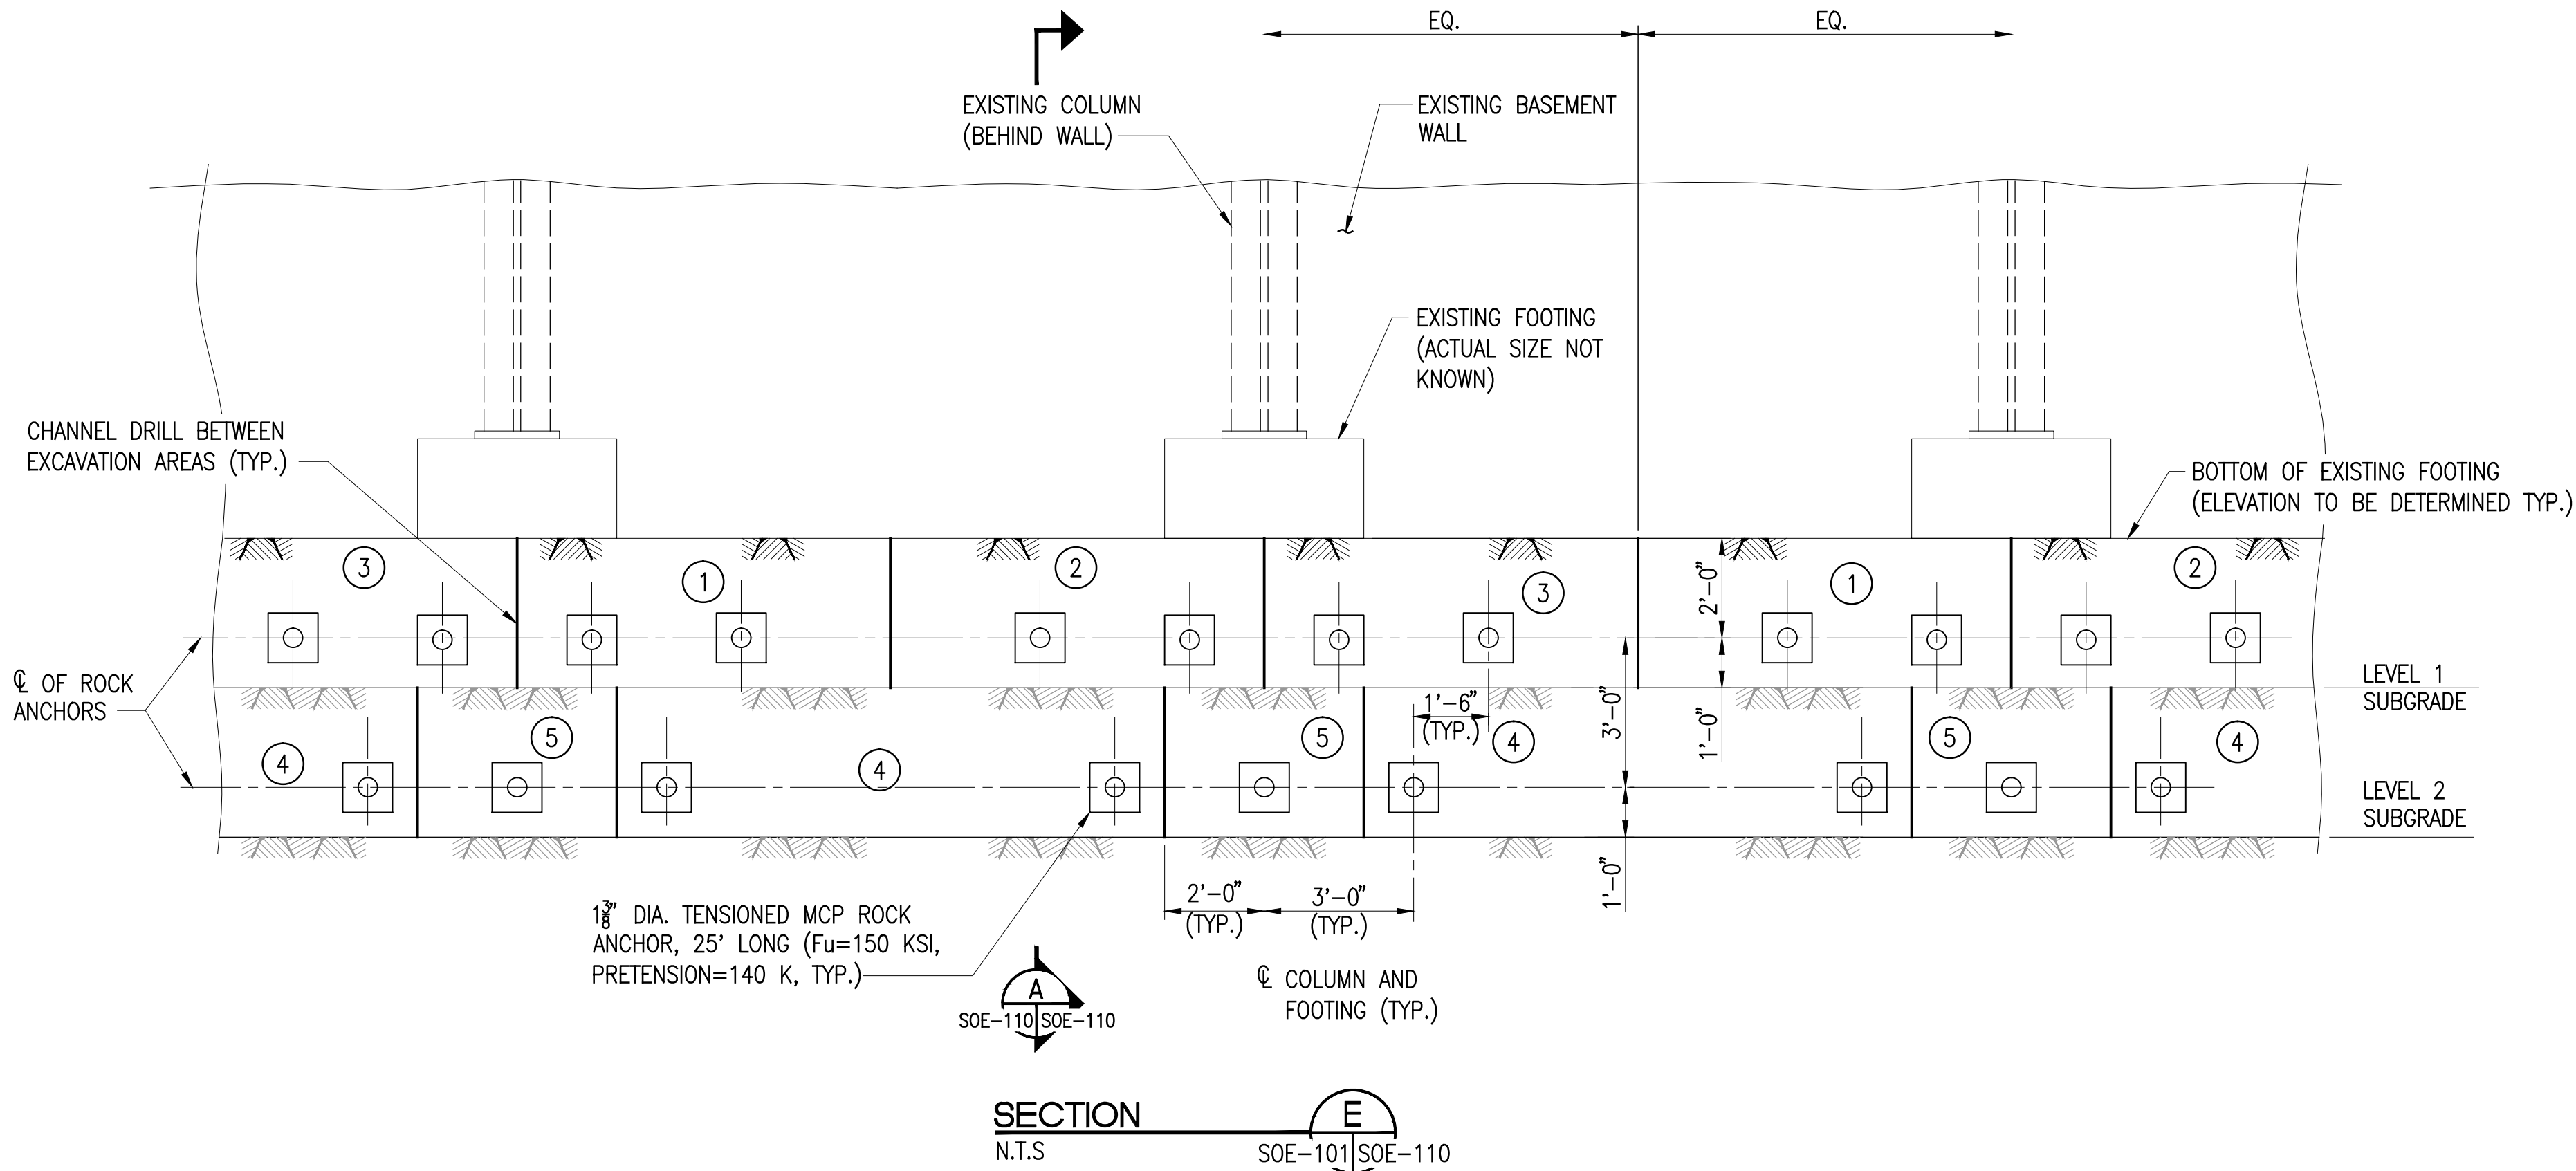

TYPICAL SEQUENCE OF ROCK EXCAVATION AT BUILDING COLUMNS


EXCAVATION SEQUENCE AT BUILDING COLUMN:

- EXCAVATE TO BEARING LEVEL OF EXISTING COLUMN FOUNDATIONS.
- LEVEL 1 PERMANENT ANCHOR INSTALLATION BELOW FOOTINGS
 - BEYOND 6'-8" FROM THE WESTERN PROPERTY LINE, EXCAVATE TO A MAXIMUM OF FOUR (4) FEET BELOW LEVEL 1 SUBGRADE (SEE SECTION A AT STEP 2.2 ON THE LEFT SIDE OF THIS DRAWING).
 - WITHIN 6'-8" OF THE WESTERN PROPERTY LINE, EXCAVATE ROCK TO LEVEL 1 SUBGRADE IN AREAS MARKED 1, (SEE SECTION A AT STEP 2.2 ON THE LEFT SIDE OF THIS DRAWING).
 - INSTALL PERMANENT ROCK ANCHORS AND TENSION AS REQUIRED.
 - WITHIN 6'-8" OF THE WESTERN PROPERTY LINE, EXCAVATE ROCK TO LEVEL 1 SUBGRADE IN AREA MARKED (2).
 - INSTALL PERMANENT ROCK ANCHORS AND TENSION AS REQUIRED.
 - WITHIN 6'-8" OF THE WESTERN PROPERTY LINE, EXCAVATE ROCK TO LEVEL 1 SUBGRADE IN AREA MARKED (3).
 - INSTALL PERMANENT ROCK ANCHORS AND TENSION AS REQUIRED.
- LEVEL 2 PERMANENT ANCHOR INSTALLATION
 - INSTALL ANCHORS AT LEVEL 2 USING THE LEVEL 1 CRITERIA STARTING WITH THE LOWEST NUMBERED AREAS (SEE SECTION A EXCAVATION AT STEP 3.1, ON THE RIGHT SIDE OF THIS DRAWING).
- INSTALLATION AT REMAINING PERMANENT ANCHOR LEVELS (INSTALL ANCHORS ON NORTH FACE AS ANCHOR LOCATIONS ARE EXPOSED)
 - EXCAVATE TO A MAXIMUM OF FOUR (4) FEET BELOW THE ANCHOR ELEVATION.
 - INSTALL PERMANENT ROCK ANCHORS AND TENSION AS REQUIRED.
 - REPEAT STEPS 2.1 AND 4.2 UNTIL ALL PERMANENT ROCK ANCHORS HAVE BEEN INSTALLED AND TENSIONED.

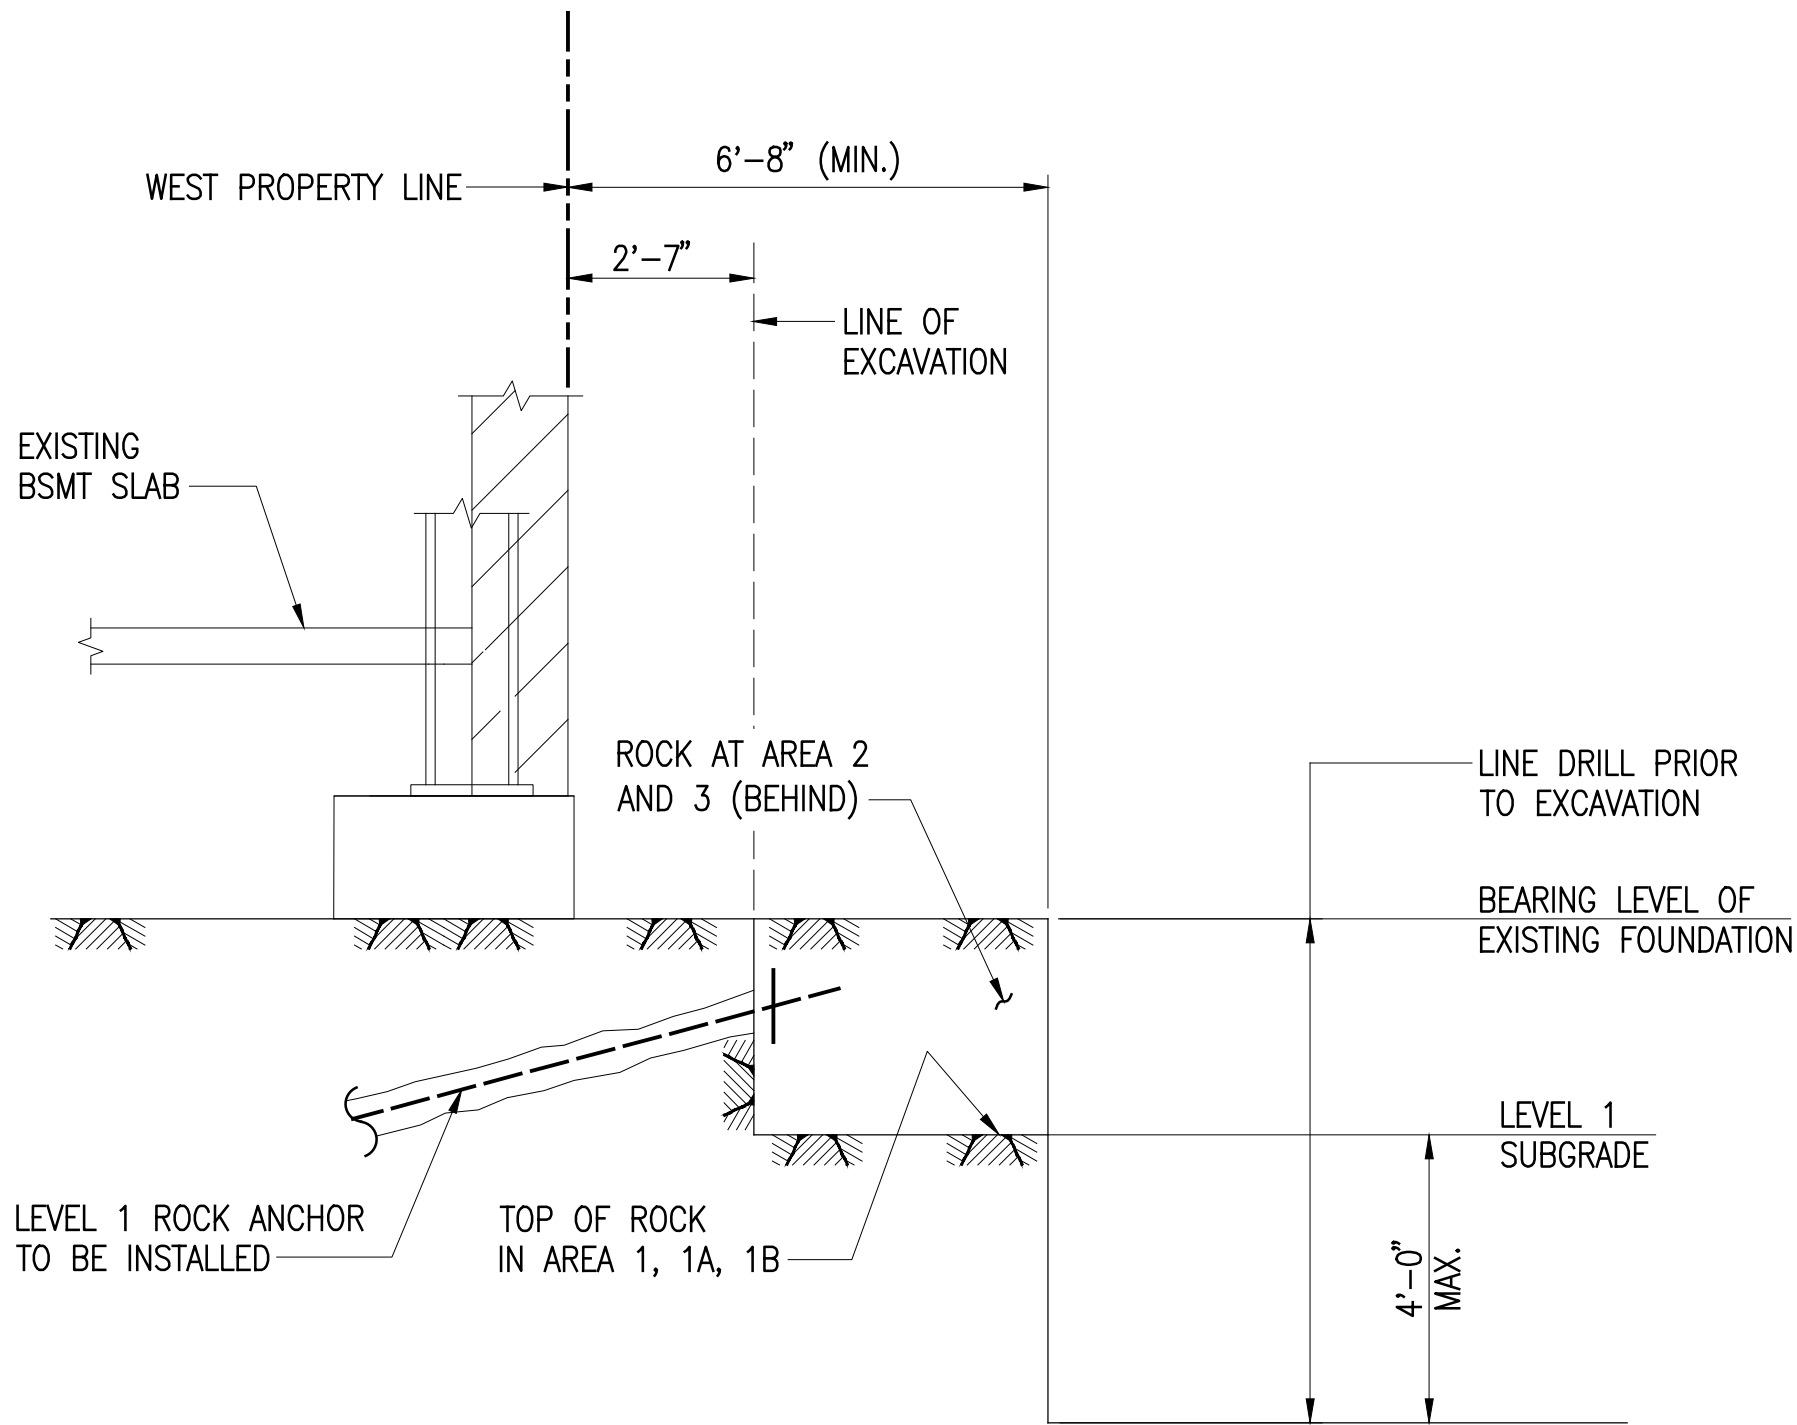

EXCAVATION AT STEP 2.2

SECTION A
N.T.S. SOE-110 SOE-110

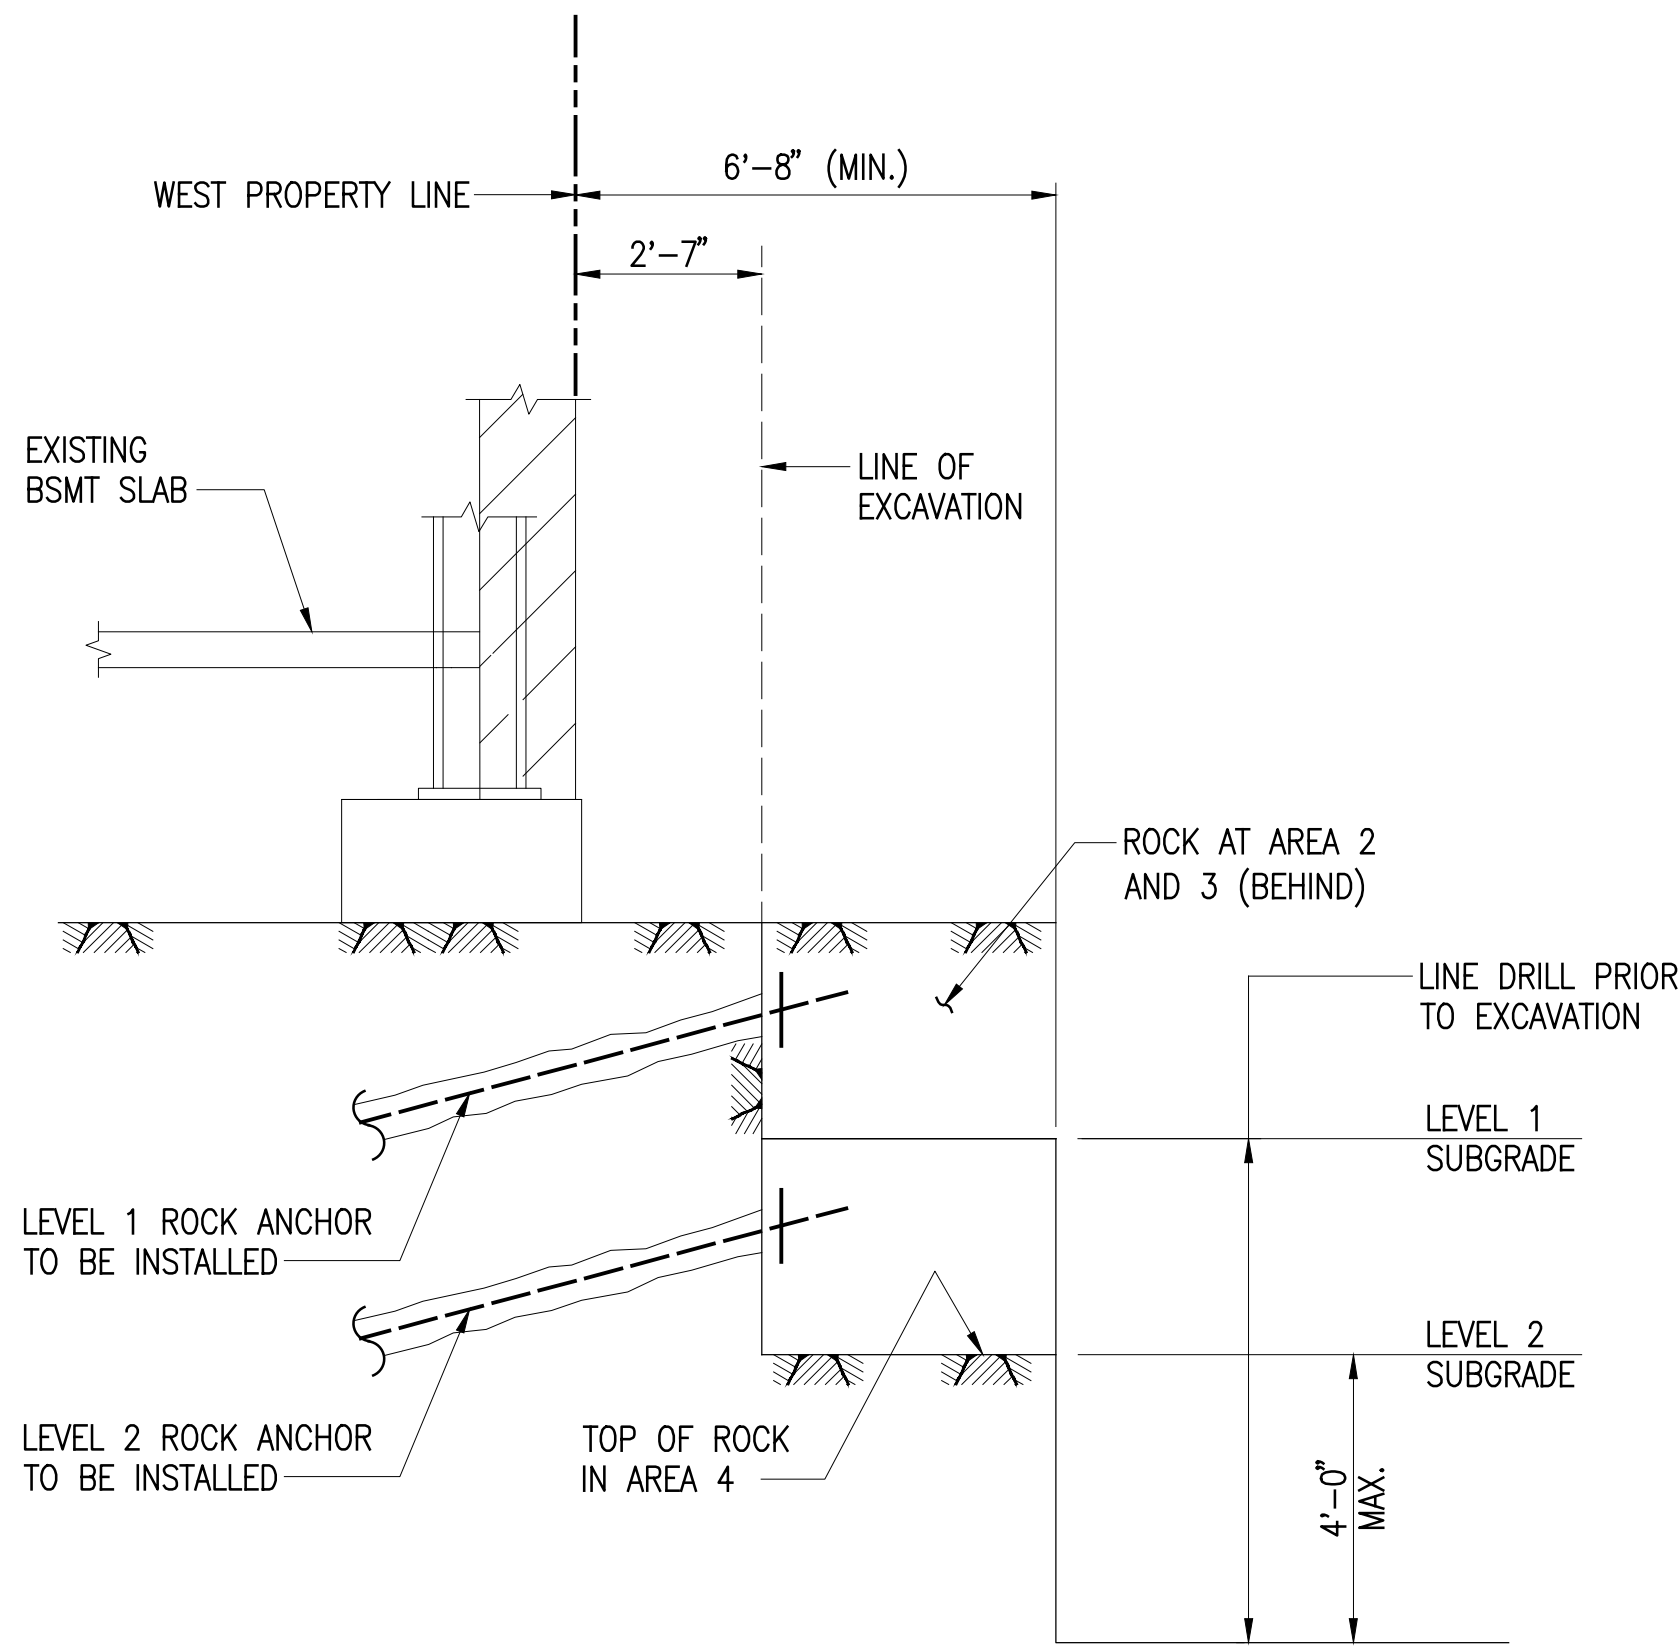

EXCAVATION AT STEP 3.1

SECTION A
N.T.S. SOE-110 SOE-110

SHEET NOTES

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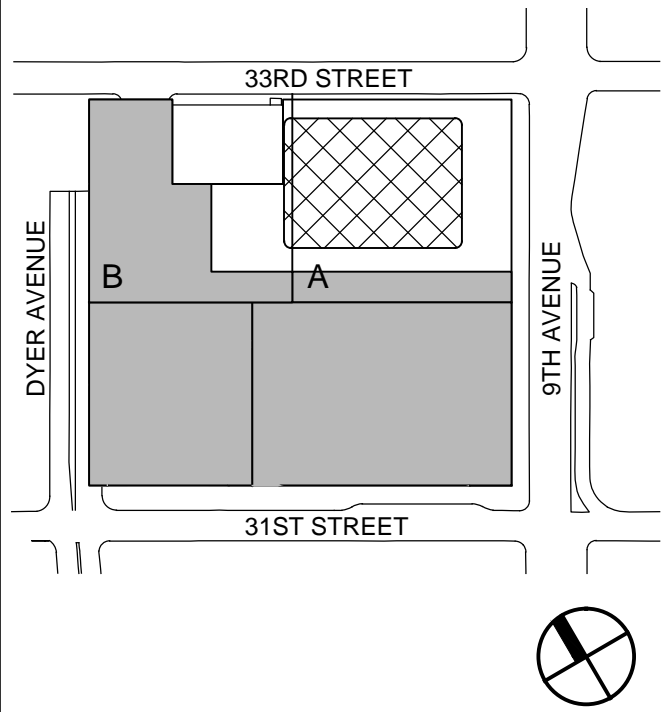
**MANHATTAN WEST:
NORTH TOWER**
375 Ninth Avenue, New York, NY 10001
Client

Brookfield
Brookfield Place
250 Vesey Street, 15th Floor, New York, NY 10281

Geotechnical Engineering
Mueser Rutledge Consulting Engineers
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**SUPPORT OF
EXCAVATION
SEQUENCE
ADJACENT TO
EXISTING
STRUCTURES**

Project No.:	B-SCAN Sheet No.:
Date: 20 JUNE 2014	SOE-110.00
Scale: N.T.S.	Sheet No.: SOE-110
File No.: SOE-110	Page No.: 6 OF 7

MANHATTAN WEST:
NORTH TOWER

375 Ninth Avenue, New York, NY 10001

Client

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250 Vesey Street, 15th Floor, New York, NY 10281

Geotechnical Engineering

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14 Penn Plaza, 225 W. 34th Street, New York, NY 10122

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Key Plan:

Seal & Signature:

1 20 JUNE 2014 ISSUED FOR PERMIT
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Sheet Name:

UNDERSLAB
DRAINAGE
PLAN & DETAILS

Project No.:	B-SCAN Sheet No.:
Date:	U-001.00
Scale:	AS SHOWN
File No.:	Page No.:
SDE-101	1 OF 1

W. 33 R D S T R E E T

P L A N
SCALE: 1/8"=1'-0"

SLAB DETAIL "GRAVEL UNDER S.O.G." - ROCK SURFACE NOT FULLY CLEANED
SCALE: 1-1/2"=1'-0"

SLAB DETAIL "GRAVEL UNDER S.O.G." - ROCK SURFACE FULLY CLEANED
SCALE: 1-1/2"=1'-0"

NOTE: ORIENT CLEANOUTS SO THAT ALL PERIMETER
DRAINAGE PIPES ARE ACCESSIBLE.

TYPICAL CLEANOUT DETAIL
SCALE: 1-1/2"=1'-0"

NOTES:

- FOR SLAB, WALLS AND WATERPROOFING DESIGN, SEE
STRUCTURAL DRAWINGS.
- FOUNDATION BASE PLAN FROM STRUCTURAL DRAWINGS.

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September 15, 2014

ENERGY MODELING OF THE MANHATTAN WEST NORTH TOWER NEW YORK CITY

Submitted by:
Vidaris, Inc.
50 Washington Street
Norwalk, CT 06854

Adrian Tuluca, RA
Senior Principal
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TABLE OF CONTENTS

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REPORT OVERVIEW

The Manhattan West North Tower is a core and shell office building located in New York City, with approximately 1.85 million ft² and 69-stories, plus a mechanical bulkhead and basement floors.

The following two energy models were created using the DOE2.1E simulation program:

- The Design Energy Model based on the NYC ECC Set dated September 12, 2014
- The Code Baseline using the New York City Energy Conservation Code 2011 (based on the 2010 NYS Energy Construction Conservation Code, Section 506 with LL 48/10 & LL 1/11).

It is important to note that in the NYS Energy Code, the fan power, expressed in W/cfm, is a mandatory provision. The W/cfm limit may not be exceeded for any fan. Exterior lighting also falls under the category of mandatory provisions.

This report refers solely to compliance in reference to the energy cost of the design vs. the energy cost of the Energy Code baseline. Mandatory provisions have to be met by the design team.

The table below summarizes the annual energy use and cost for the Design and Code Baseline:

	Annual Energy Cost [\$]	Annual Regulated Energy Cost [\$]	Regulated Savings Vs. Code Case [\$]	Regulated Savings Vs. Code Case [%]	Energy Code Compliance With Regard to Energy Cost [Yes/No]
2011 NYC Energy Code Baseline	\$7,527,189	\$5,460,862			
Proposed Design	\$6,516,101	\$4,700,412	\$760,450	13.93%	Yes

Regulated energy cost excluded plug loads, elevators, escalators, kitchen uses, appliances, computers, printers, copiers and other office equipment, as well as process loads.

Note on Actual Energy Use

This report is developed for the purpose of determining code compliance. Actual energy use and cost will be greater, since the modeling rules do not account for many real-life issues, such as three-dimensional heat loss at the envelope, piping heat loss, quality of construction, equipment functionality, building operation and other factors.

COMPARISON OF DESIGN BUILDING AND NYCECC 2011 CODE BASELINE

The following table shows the comparison of the Proposed Design Case and the 2011 NYC Energy Code (based on the 2010 NYS Energy Conservation Code and NYC LL 48/10 & LL 1/11):

Proposed Design	CODE Baseline: NYCECC 2011 (based on ECCCNY 2010 + LL 48/10 and LL 1/11)	Reference Drawing / Document
Wall, Above Grade Glass spandrel curtain wall: <ul style="list-style-type: none"> 1-1/4" Insulated glazing unit 3-11/16" Air space 4" Semi-rigid insulation with R-4.2/inch and vertical mullions 5'-0" O.C., horizontal mullions 18'-4.5" O.C. U-factor = U-0.179 (based on THERM analysis) Storefront curtain wall: <ul style="list-style-type: none"> 1-5/16" Semi-rigid insulation with R-4.2/inch and vertical mullions 10'-0" O.C., horizontal mullions 1'-4" O.C. 1/2" Steel plate Air space 1/2" Steel plate U-factor = U-1.123 (based on THERM analysis) Basement wall next to unconditioned space: <ul style="list-style-type: none"> 8" Concrete masonry unit, fully grouted 1 3/8" Semi-rigid insulation with R-4.2/inch 5/8" Gypsum board U-factor = U-0.128 	Wall, Above Grade <ul style="list-style-type: none"> U-factor = U-0.064 (Steel framed) U-factor = U-0.104 (Mass wall, non-residential) 	EN-200, Issued for Foundation Permit, September 12, 2014

<p>Vertical Glazing</p> <p>Glazing area = 67% of exterior façade area</p> <p>Typical tower glazing</p> <ul style="list-style-type: none"> • U-0.42 (unit); curtain wall with thermally broken aluminum frame • U-0.27 (center of glass) • SHGC = 0.29 • Visible transmittance = 41% <p>Lobby glazing</p> <ul style="list-style-type: none"> • U-1.06 (unit); curtain wall with thermally broken aluminum frame • U-1.0 (center of glass) • SHGC = 0.88 • Visible transmittance = 80% 	<p>Vertical Glazing</p> <p>Glazing area = 40%</p> <ul style="list-style-type: none"> • U-factor = U-0.50 (Metal framing; curtain wall/storefront) • SHGC = 0.40 	<p>EN-200, A-200, A-201, Issued for Foundation Permit, September 12, 2014</p>
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Roof Tower roof <ul style="list-style-type: none"> Concrete pavers Air space 5" Extruded polystyrene insulation Roofing membrane 9" Concrete slab Metal deck U-factor = U-0.036 Roof albedo - reflectivity of 0.3 Plaza roof <ul style="list-style-type: none"> 2" Stone paving 3" Mortar setting bed 7" Extruded polystyrene insulation 6" Concrete slab 1/2" Extruded polystyrene insulation 10" Concrete slab Metal deck U-factor = U-0.025 Roof albedo - reflectivity of 0.3 	Roof <ul style="list-style-type: none"> U-factor = U-0.048 (Insulation entirely above deck) Roof albedo - reflectivity of 0.3 	EN-200, Issued for Foundation Permit, September 12, 2014
Wall, Below Grade <ul style="list-style-type: none"> C-factor = C-1.140 	Wall, Below Grade <ul style="list-style-type: none"> C-factor = C-1.140 	EN-200, Issued for Foundation Permit, September 12, 2014
Slab-On-Grade Floors <ul style="list-style-type: none"> F-factor = F-0.730 	Slab-On-Grade Floors <ul style="list-style-type: none"> F-factor = F-0.730 	EN-200, Issued for Foundation Permit, September 12, 2014
Opaque Door <ul style="list-style-type: none"> U-factor = U-0.7 (Swinging) 	Opaque Door <ul style="list-style-type: none"> U-factor = U-0.7 (Swinging) 	

Lighting Power Density		Lighting Power Density		EN-100 to EN-138, Issued for Foundation Permit, September 12, 2014
<u>Space</u>	<u>LPD (W/ft²)</u>	<u>LPD (W/ft²)</u>	<u>Space Classification</u>	
Lobby	0.47	1.0	Office	
Mechanical	0.28	0.3	Parking Garage	
Electrical	0.22			
EMR	0.29			
Corridor	0.39			
Storage Active	0.35			
Stair	0.30			
Elevator Lobby	0.55			
Restrooms	0.52			
Lockers	0.47			
Parking	0.30			
IT rooms	0.47			
BOH Office	0.75			
<u>Tenant Fit-out per ASHRAE 90.1-2010 (New Energy Code that will apply to all tenants)</u>		<u>Tenant Fit-out</u>		
Office - Enclosed	1.11	1.11	Office - Enclosed	
Office - Open Plan	0.98	0.98	Office - Open Plan	
Retail	1.68	1.68	Retail - Sales Area	

Lighting Control <u>Core & Shell:</u> Occupancy sensors in restrooms, storage, IT rooms and stairwells, BOH offices. Daylight dimming in lobby. <ul style="list-style-type: none">Lighting setpoint: 50 foot-candles maintained throughout occupied hours.Minimum fixture power input percentage: 18%Minimum fixture lighting output percentage: 10%	Lighting Control No occupancy sensors, except for conference rooms without multi-scene controls, BOH offices < 250 ft² No daylight dimming.	EN-100 to EN-138, Issued for Foundation Permit, September 12, 2014																						
Plug-in office equipment Computers, monitors, printers, copiers will have standard efficiency <table><tr><td><u>Space</u></td><td><u>EPD (W/ft²)</u></td></tr><tr><td>Open Office</td><td>1.5</td></tr><tr><td>Enclosed Office</td><td>1.5</td></tr><tr><td>Lobby</td><td>0.5</td></tr><tr><td>Mechanical</td><td>0.25</td></tr><tr><td>Electrical</td><td>5</td></tr><tr><td>Elevator Machine Room</td><td>10</td></tr><tr><td>IT Rooms</td><td>10</td></tr><tr><td>Data Center</td><td>30</td></tr><tr><td>Meet Me Rooms</td><td>5</td></tr><tr><td>Retail</td><td>0.5</td></tr></table>	<u>Space</u>	<u>EPD (W/ft²)</u>	Open Office	1.5	Enclosed Office	1.5	Lobby	0.5	Mechanical	0.25	Electrical	5	Elevator Machine Room	10	IT Rooms	10	Data Center	30	Meet Me Rooms	5	Retail	0.5	Plug-in office equipment Same as Design.	
<u>Space</u>	<u>EPD (W/ft²)</u>																							
Open Office	1.5																							
Enclosed Office	1.5																							
Lobby	0.5																							
Mechanical	0.25																							
Electrical	5																							
Elevator Machine Room	10																							
IT Rooms	10																							
Data Center	30																							
Meet Me Rooms	5																							
Retail	0.5																							
High efficiency elevators with regenerative braking (savings of 25%)	Same as Design																							

Outside Air Offices 20 cfm per person Corridors 0.06 cfm per square foot. Lobby 11 cfm per person Retail 16 cfm per person	Outside Air Same as Proposed Case	
Outside Air The outside air is heated by purchased steam. It is provided separately to air handling units on each floor.	Outside Air The outside air is provided separately as Design	Issued for Foundation Bid Issued June 20, 2014 Sheet # M-502.00
Office Floors Water-cooled, packaged DX units with variable air volume system. Minimum supply air temperature is 49F with warmest control. System fan power w/cfm is as per New York State Code Table 503.2.10.1 VAV boxes have minimum turn down ratio of 35%. Perimeter fan powered boxes with ECM motors. DX compressors with 0.85 kW/ton. DX units equipped with water-side economizers.	Office Floors <u>System 2 - VAV with reheat</u> <ul style="list-style-type: none"> • Fan Control: VAV • Minimum supply air temperature is 55F with warmest control. • System fan power w/cfm same as Design • Cooling Type: Chilled water • Heating Type: Purchased steam • VAV minimum flow setpoint of 0.4 cfm/ft² of the floor area 	Issued for Foundation Bid Issued June 20, 2014 Sheet # M-505.00

<p>Lobby Water-cooled, packaged DX units with variable air volume system. Minimum supply air temperature is 49F with warmest control.</p> <p>System fan power w/cfm is as per New York State Code Table 503.2.10.1</p> <p>VAV boxes have minimum turn down ratio of 50%.</p> <p>Lobby has fan powered boxes with ECM motors.</p> <p>DX compressors with 0.85 kW/ton.</p> <p>DX units equipped with water-side economizers.</p>	<p>Lobby <u>System 7 - VAV with reheat</u></p> <ul style="list-style-type: none"> • Fan Control: VAV • Minimum supply air temperature is 55F with warmest control. • System fan power w/cfm same as Design. • Cooling Type: Chilled water • Heating Type: Purchased steam • VAV minimum turn down ratio (M-C-R) of 50% 	<p>Issued for Foundation Bid Issued June 20, 2014 Sheet # M-505.00</p>
<p>EMR Rooms 'B' System type: Fancoil units</p> <ul style="list-style-type: none"> • Fan Control: Constant volume • System fan power w/cfm as per New York State Code Table 503.2.10.1. • Cooling Type: Chilled water • Heating Type: Purchased steam 	<p>EMR Rooms 'B' <u>System 7 - Four Pipe Fan Coil</u></p> <ul style="list-style-type: none"> • Fan Control: Constant volume • System fan power w/cfm same as Design. • Cooling Type: Chilled Water • Heating Type: Purchased Steam 	<p>Issued for Foundation Bid Issued June 20, 2014 Sheet # M-505.00</p>
<p>Data, Meetme, IT Rooms, EMR 'A'</p> <ul style="list-style-type: none"> • Fan Control: Constant volume • System fan power w/cfm is as per New York State Code Table 503.2.10.1. • Cooling Type: Water Cooled DX units; Cooling efficiency (EER) = 12.1 • Heating Type: Purchased steam 	<p>Data, Meetme, IT Rooms, EMR 'A' <u>System 7 - Four Pipe Fan Coil</u></p> <ul style="list-style-type: none"> • Fan Control: Constant volume • System fan power w/cfm same as Design. • Cooling Type: Chilled Water • Heating Type: Purchase steam 	<p>Issued for Foundation Bid Issued June 20, 2014 Sheet # M-505.00</p>

Parking Garage CO sensors in parking garage. The fans operate for ten hours per day. The parking garage is not heated.	Parking Garage Same as Design.	Issued for Foundation Bid Issued June 20, 2014 Sheet # M-501.00
Mechanical Areas Constant volume system. Heating is provided by purchased steam Cooling by air cooled packaged DX units (Cooling SEER= 13.0). Cooling setpoint is high, so there is no cooling load.	Mechanical Areas Constant volume system. Heating is provided by purchased steam Cooling same as Design	Issued for Foundation Bid Issued June 20, 2014 Sheet # M-504.00
Steam heat with condensate recovery (4% heat recovered)	Steam heat without condensate heat recovery.	
Hot water pumps : <ul style="list-style-type: none"> Hot water supply temperature = 180 °F Hot water return temperature = 130 °F Hot water supply temperature reset <ul style="list-style-type: none"> 180 °F at 20 °F and below 150 °F at 50 °F and above Ramped linearly between 180 °F and 150 °F at temperature between 20 °F and 50 °F 33 W/gpm (based on 150 feet head and 85% pump efficiency) VFD (w/ 30% minimum turndown ratio) Premium efficiency motors 	Hot water pumps : <ul style="list-style-type: none"> Hot water supply temperature = 180 °F Hot water return temperature = 130 °F Hot water supply temperature reset <ul style="list-style-type: none"> 180 °F at 20 °F and below 150 °F at 50 °F and above Ramped linearly between 180 °F and 150 °F at temperature between 20 °F and 50 °F Same as Design VFD (w/ 30% minimum turndown ratio) NEMA Standard efficiency motors 	Issued for Foundation Bid Issued June 20, 2014 Sheet # M-500.00
Cooling tower <ul style="list-style-type: none"> Five Cells (One Standby) Entering temperature = 95 °F Leaving temperature = 85 °F Wet bulb outdoor air = 75 °F The cooling tower fan has variable frequency drive with minimum turn down ratio of 50% 	Cooling tower <ul style="list-style-type: none"> Five cells (one Standby) Entering temperature = 95 °F Leaving temperature = 85 °F Wet bulb outdoor air = 75 °F The cooling tower fan has two speed drive 	Issued for Foundation Bid Issued June 20, 2014 Sheet # M-500.00

Condenser water pumps <ul style="list-style-type: none"> Primary pumps: 44 W/gpm Secondary Pumps: 22 W/gpm Tertiary Pumps: 22 W/gpm Premium efficiency motors 	Condenser water pumps <ul style="list-style-type: none"> Same as Design NEMA Standard efficiency motors 	Issued for Foundation Bid Issued June 20, 2014 Sheet # M-500.00
Chillers Chillers serve the EMR <ul style="list-style-type: none"> Five 60-ton modular multi-stack chillers with efficiency of 0.822 kw/ton 250 ton single-effect absorption chiller using heat recovered from co-generation plant Pumps with VFD (w/ 30% minimum turndown ratio) 	Chillers Chillers serve the entire building <ul style="list-style-type: none"> Seven 750-ton electric centrifugal chillers with efficiency of 0.576 kw/ton at ARI conditions Pumps same as Design 	Issued for Foundation Bid Issued June 20, 2014 Sheet # M-500.00
Service Water Heating <ul style="list-style-type: none"> Electric DHW heaters 	Service Water Heating <ul style="list-style-type: none"> Electric DHW heaters 	
Electric Cogeneration Plant (Microturbines) <ul style="list-style-type: none"> Electric Generation Capacity = 1200 KW Electric Generation Efficiency =29.90% Thermal Efficiency = 32.0% Heat recovered from cogeneration plant is used by a 250 ton single-effect absorption chiller. Electric generation mode is track electric Heat recovered from cogeneration plant is also used for service hot water heating and space heating. 	Electric Cogeneration Plant No cogeneration plant.	Issued for Foundation Bid Issued June 20, 2014 Sheet # M-600.00
Premium efficiency motors for fans	NEMA Standard Efficiency motors for fans	


SCHEDULES FOR OCCUPANCY, LIGHTING AND EQUIPMENT

Occupancy Patterns

Space Type	Occupancy Density	Schedule
Open Office	140 ft ² /person	Office occupancy
Enclosed Office	140 ft ² /person	Office occupancy
Lobby	50 ft ² /person	Corridor occupancy
Mechanical	5000 ft ² /person	Mechanical occupancy
Electrical	5000 ft ² /person	Mechanical occupancy
Corridor	140 ft ² /person	Corridor occupancy
Elevator Lobby	140 ft ² /person	Corridor occupancy
Restrooms	140 ft ² /person	Corridor occupancy
Stairwells	140 ft ² /person	Corridor occupancy
Lockers	140 ft ² /person	Corridor occupancy
Parking	5000 ft ² /person	Corridor occupancy
IT Rooms	5000 ft ² /person	Mechanical occupancy
Retail	50 ft ² /person	Retail occupancy


Corridor occupancy

Schedule thru December 31

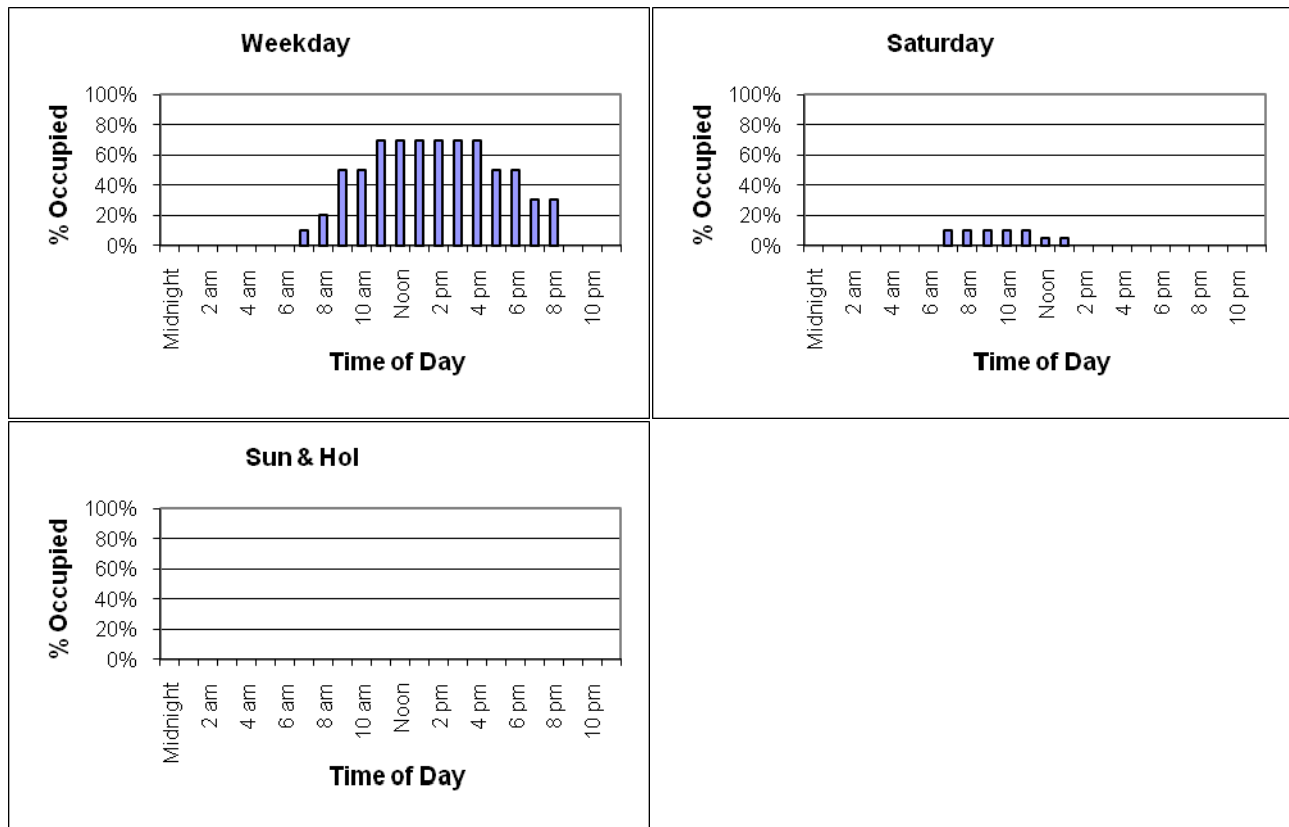


Mechanical occupancy


Schedule thru December 31

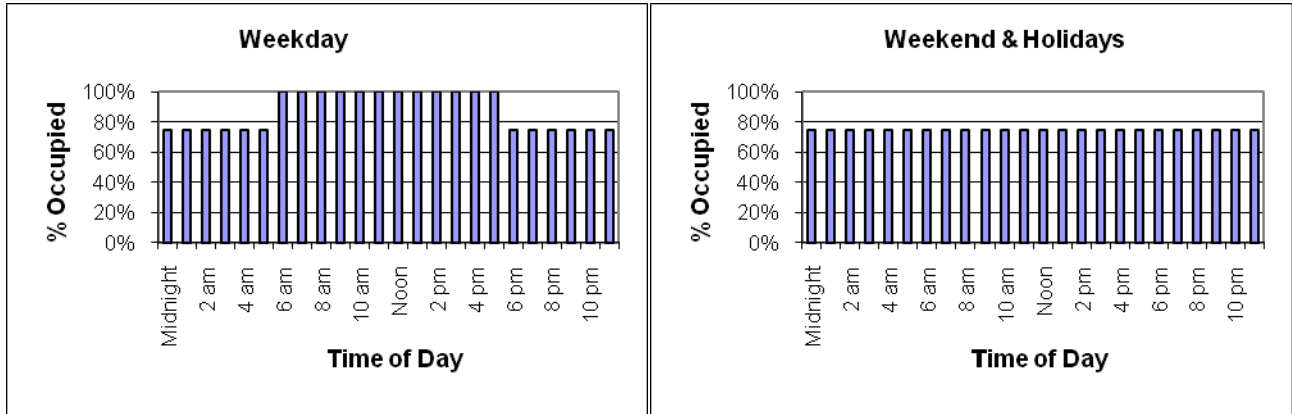

Office occupancy
Schedule thru December 31

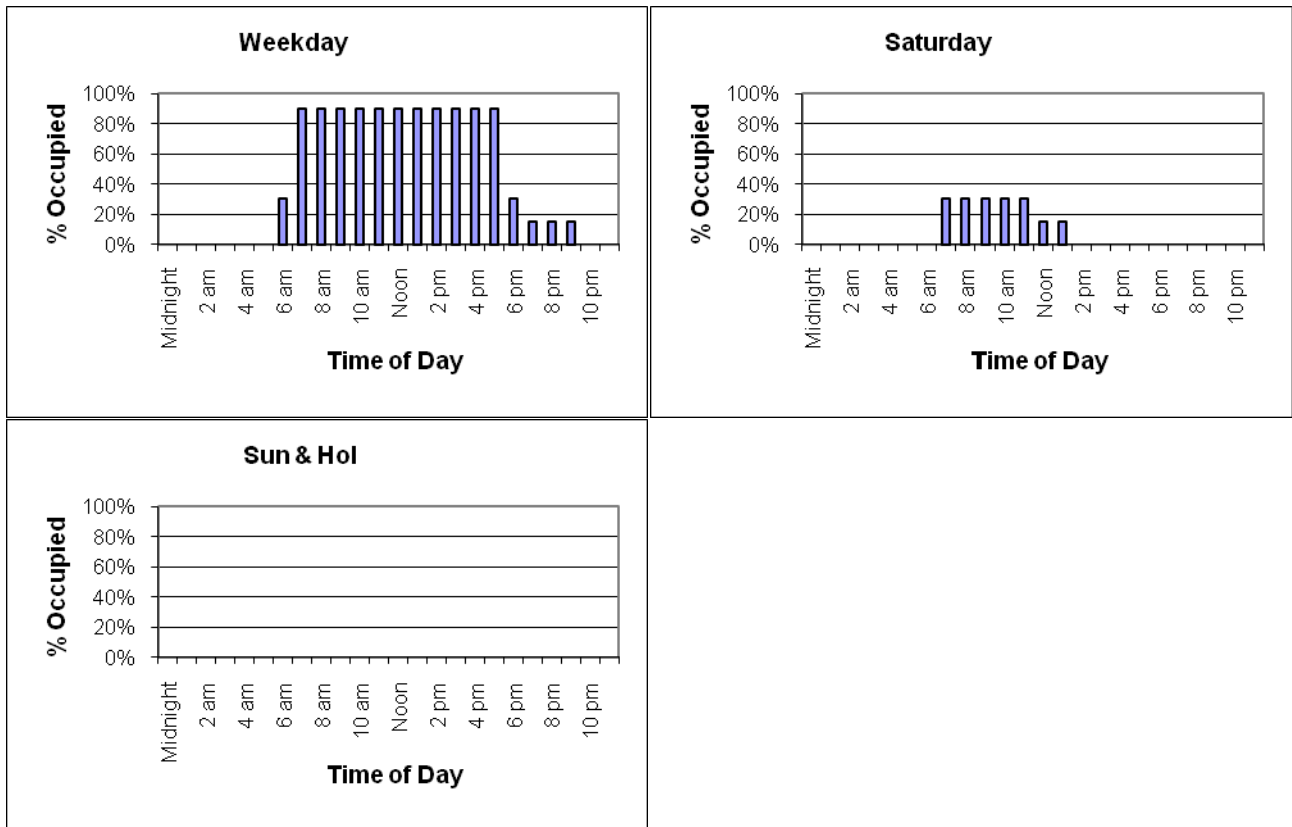

Retail occupancy
Schedule thru December 31

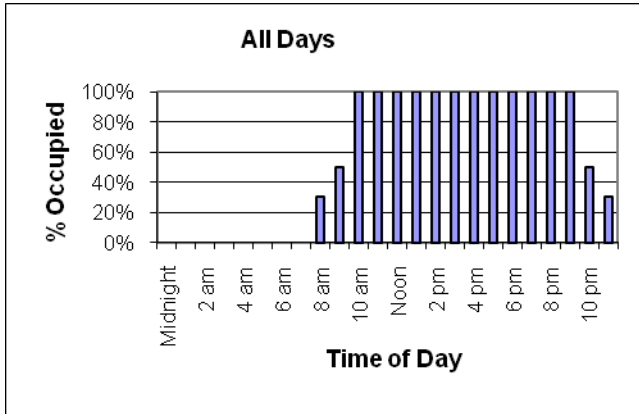


Lighting Use Patterns

Space Type	Lighting Power Density	Schedule
Open Office (tenant)	0.98 W/ft ²	Office lighting
Enclosed Office (tenant)	1.11 W/ft ²	Office lighting
Lobby	0.47 W/ft ²	Lobby lighting
Mechanical	0.28 W/ft ²	Mechanical lighting
Electrical	0.22 W/ft ²	Mechanical lighting
EMR	0.29 W/ft ²	Mechanical lighting
Corridor	0.39 W/ft ²	Corridor lighting
Elevator Lobby	0.55 W/ft ²	Corridor lighting
Restrooms	0.52 W/ft ²	Core lighting
Stairwells	0.30 W/ft ²	Stair lighting
Storage	0.35 W/ft ²	Core lighting
Lockers	0.47 W/ft ²	Corridor lighting
Parking	0.30 W/ft ²	Corridor lighting
IT rooms	0.47 W/ft ²	Mechanical lighting
Retail	1.68 W/ft ²	Retail lighting


Core lighting

Schedule thru December 31

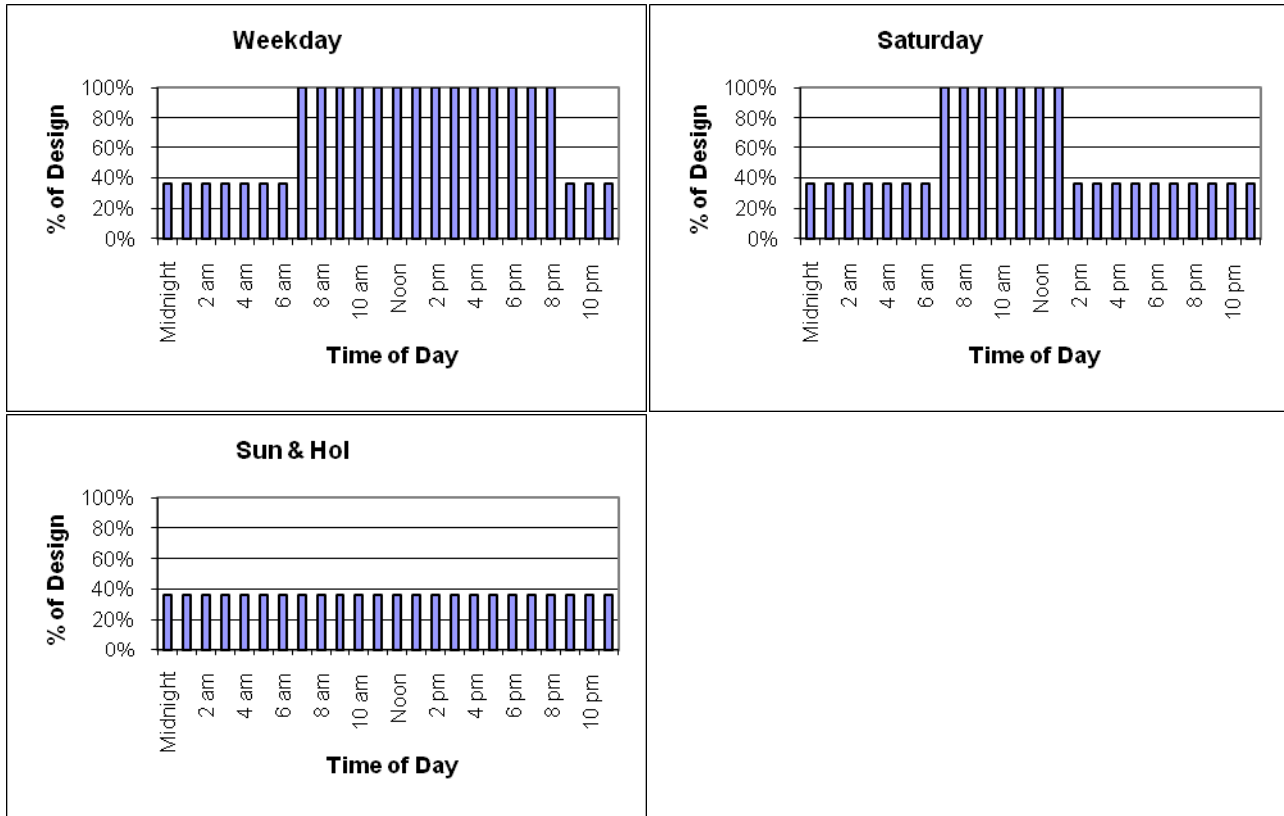


Corridor lighting

Schedule thru December 31

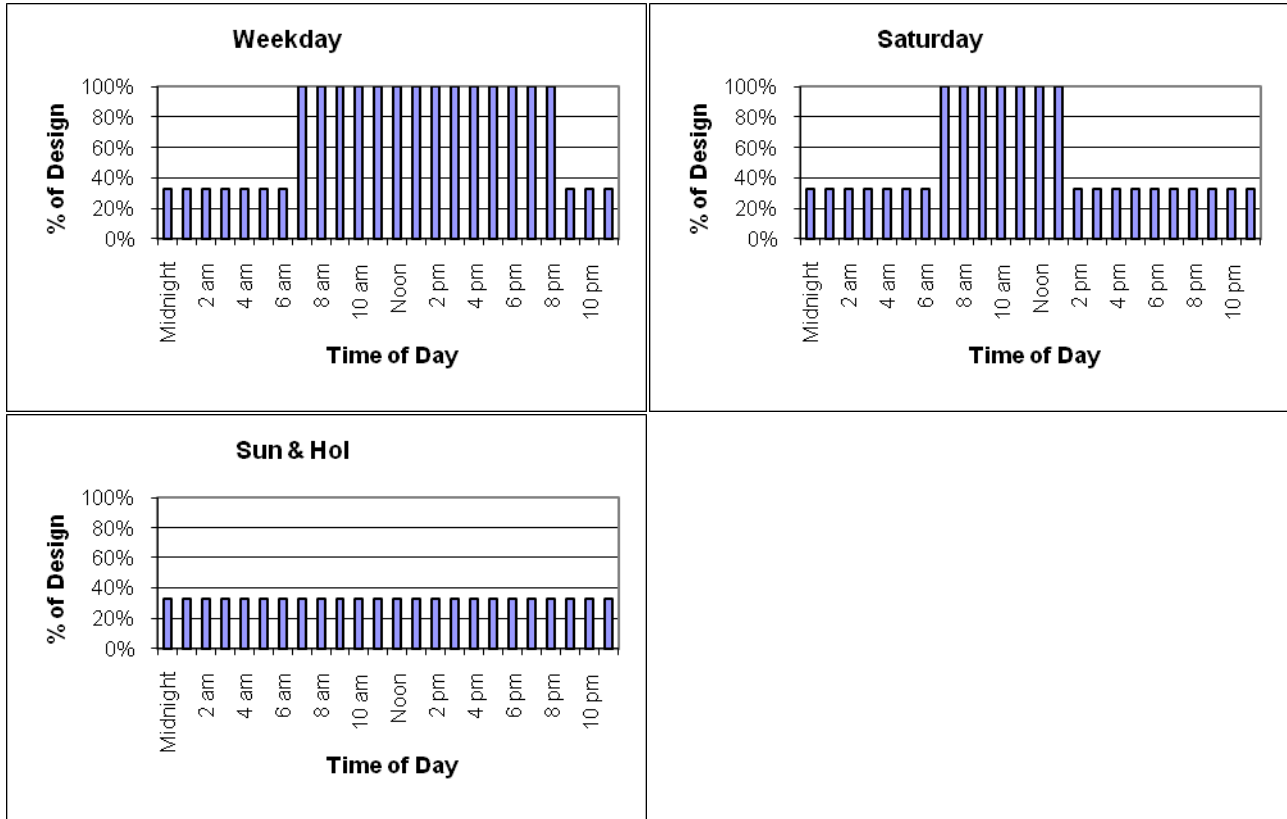


Lobby lighting
Schedule thru December 31

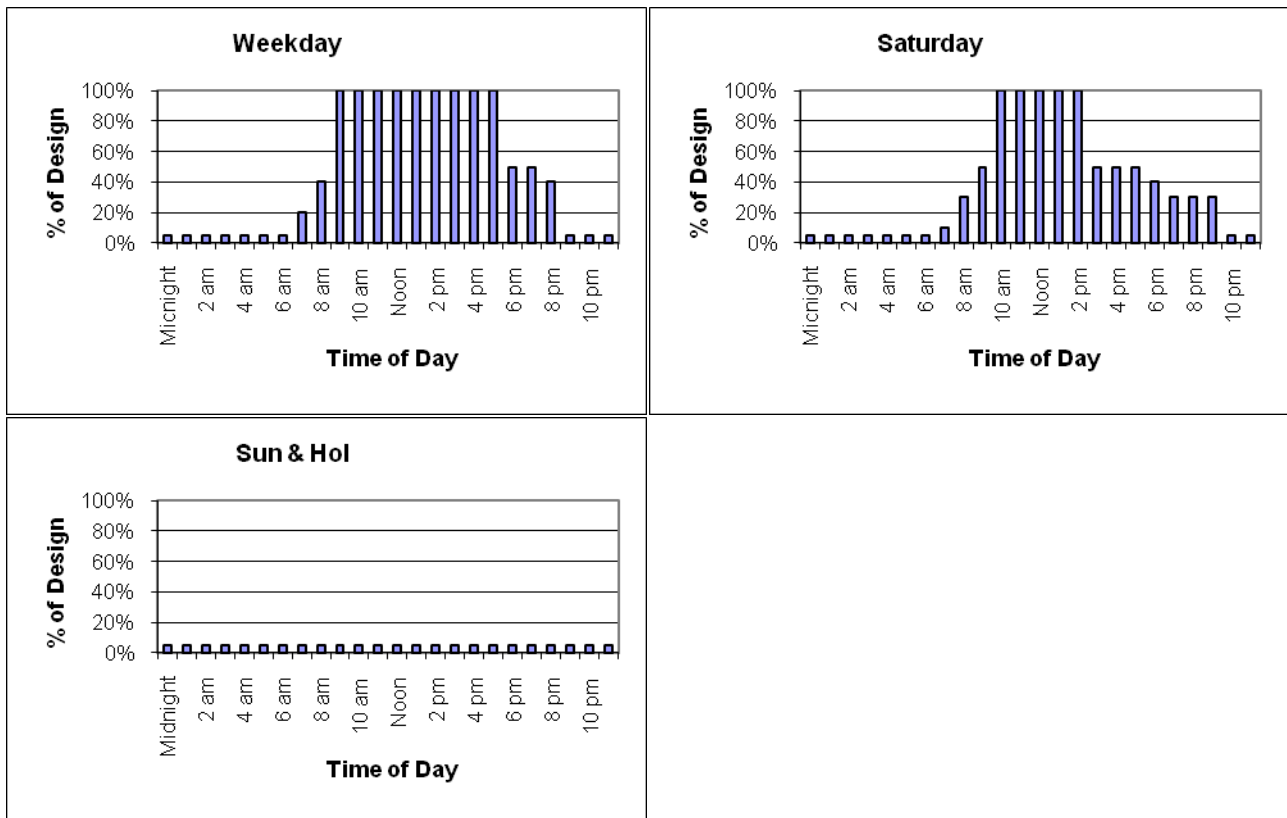


Mechanical lighting

Schedule thru December 31

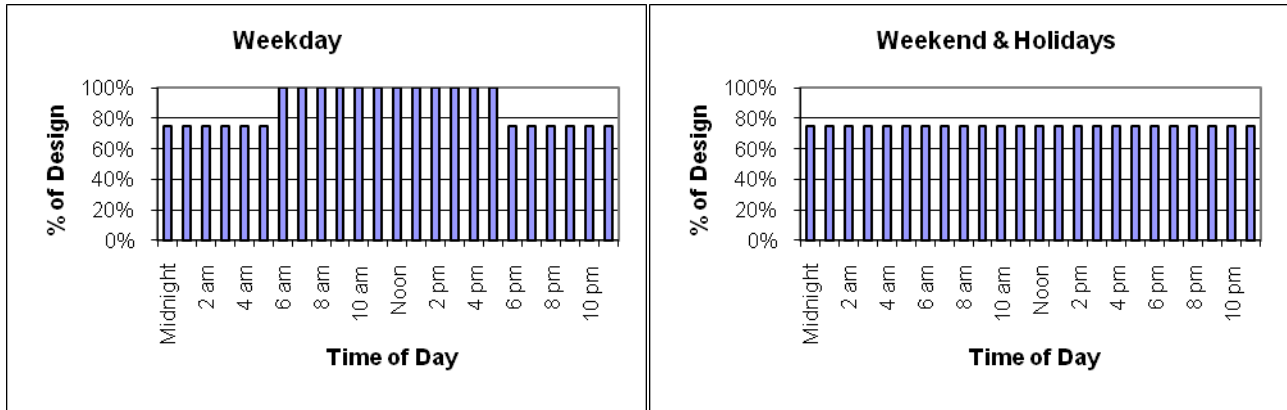


Office lighting

Schedule thru December 31

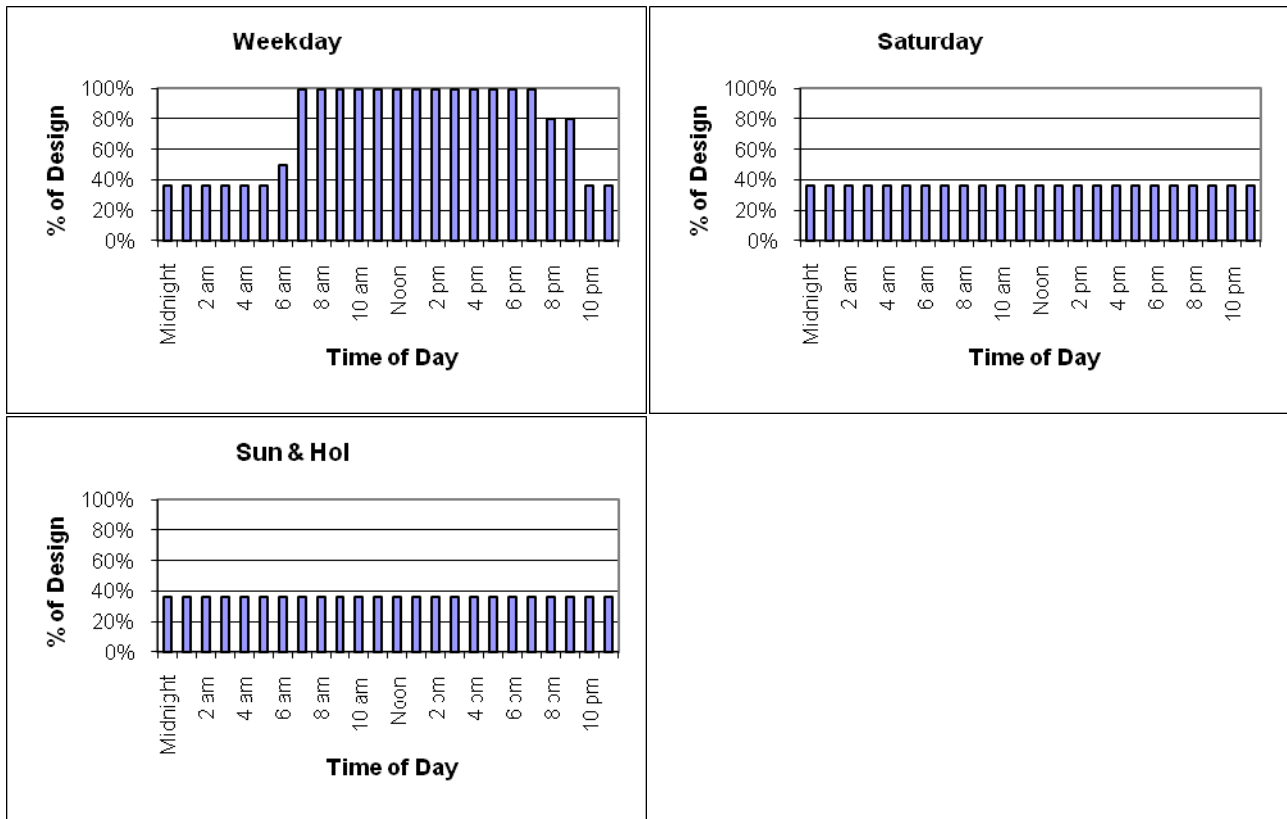


Retail lighting

Schedule thru December 31

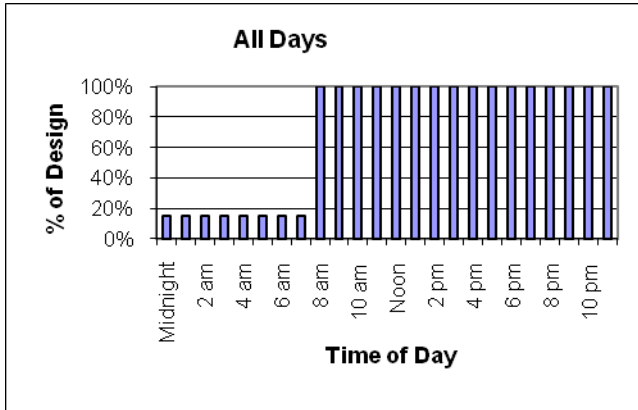

Stair lighting
Schedule thru December 31

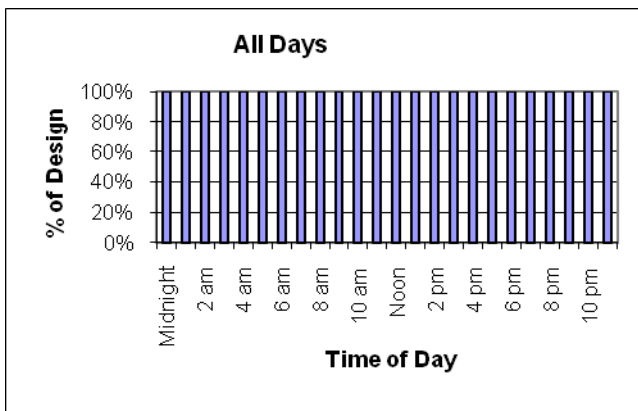


Equipment Use Patterns

Space Type	Equipment Power Density	Schedule
Open Office	1.5 W/ft ²	Office equipment
Enclosed Office	1.5 W/ft ²	Office equipment
Lobby	0.5 W/ft ²	Lobby equipment
Mechanical	0.25 W/ft ²	Mechanical equipment
Electrical	5 W/ft ²	Mechanical equipment
Elevator Machine Room	10 W/ft ²	Mechanical equipment
IT Rooms	10 W/ft ²	Mechanical equipment
Data Center	30 W/ft ²	Mechanical equipment
Meet Me Rooms	5 W/ft ²	Mechanical equipment
Retail	0.5 W/ft ²	Retail equipment


Office equipment

Schedule thru December 31

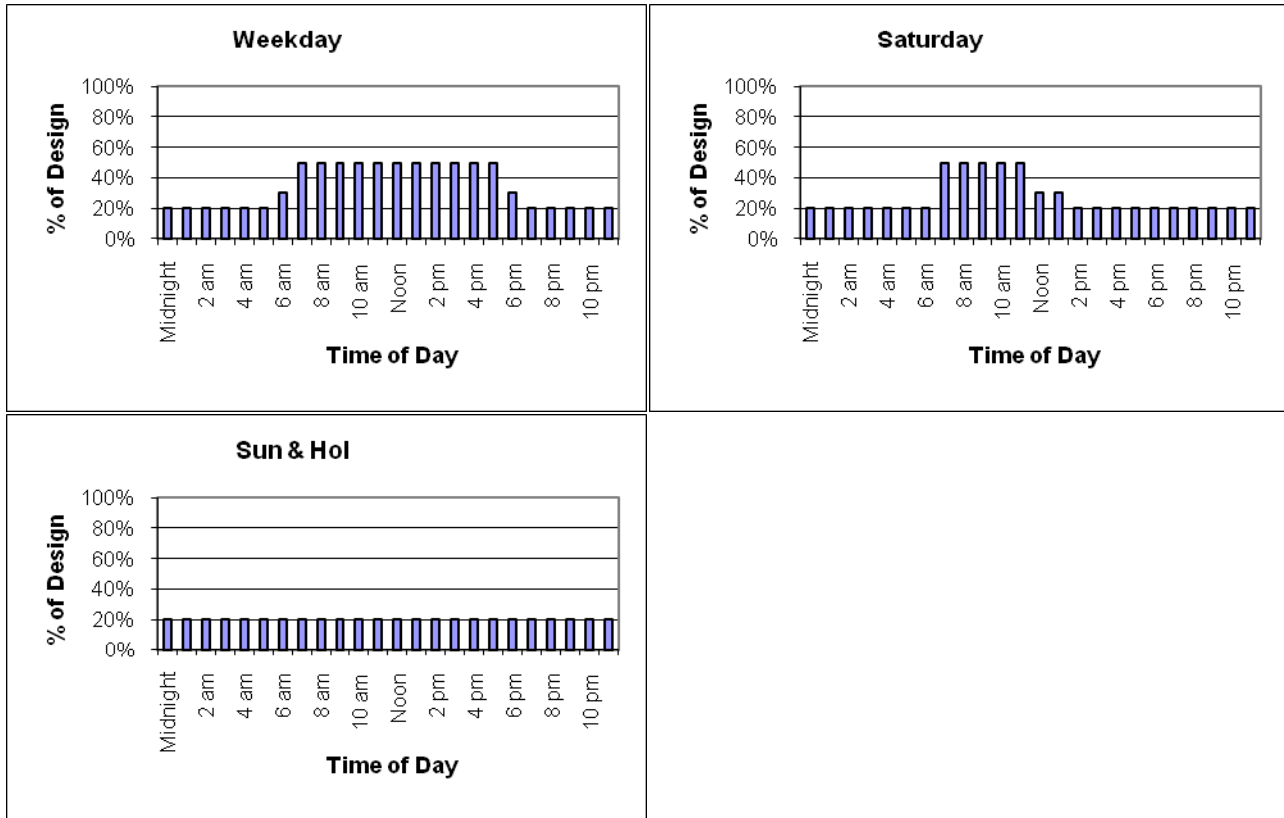


Lobby equipment


Schedule thru December 31

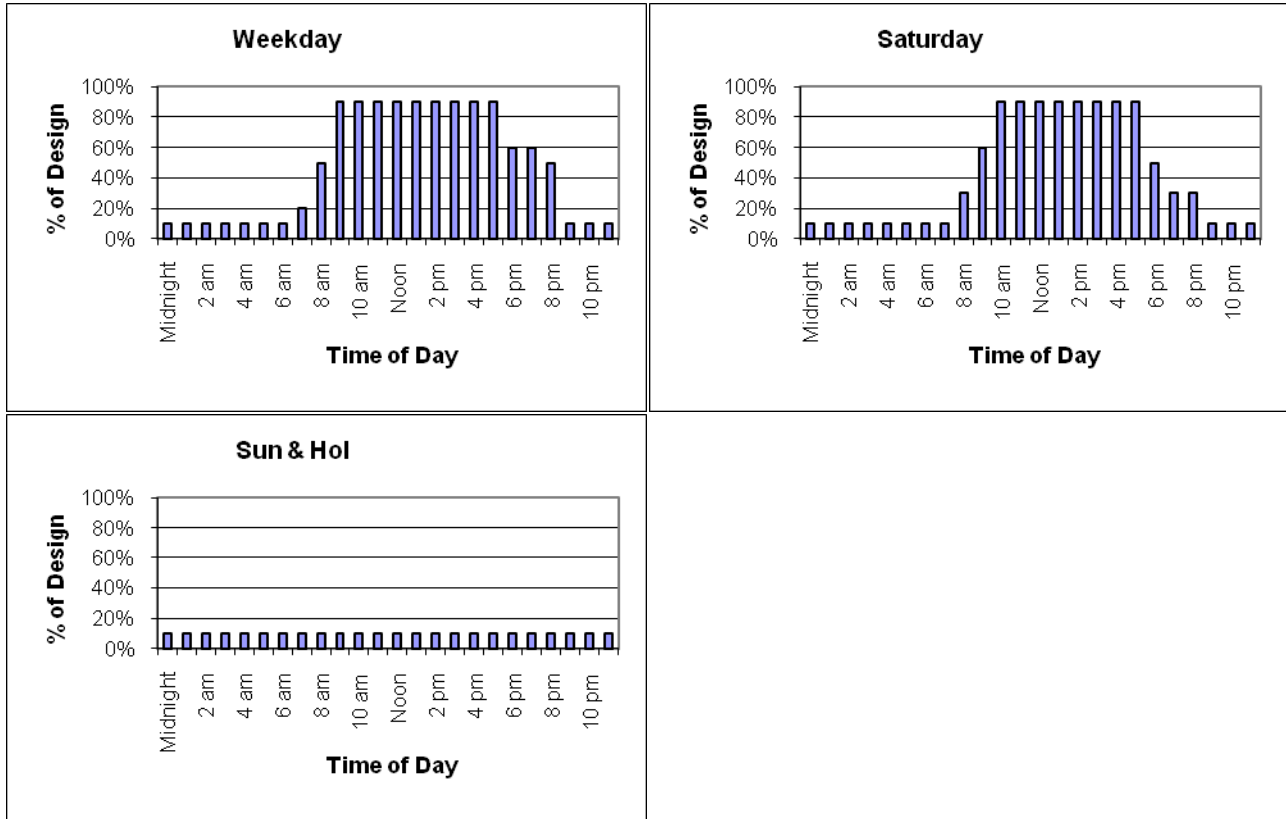

Mechanical equipment
Schedule thru December 31

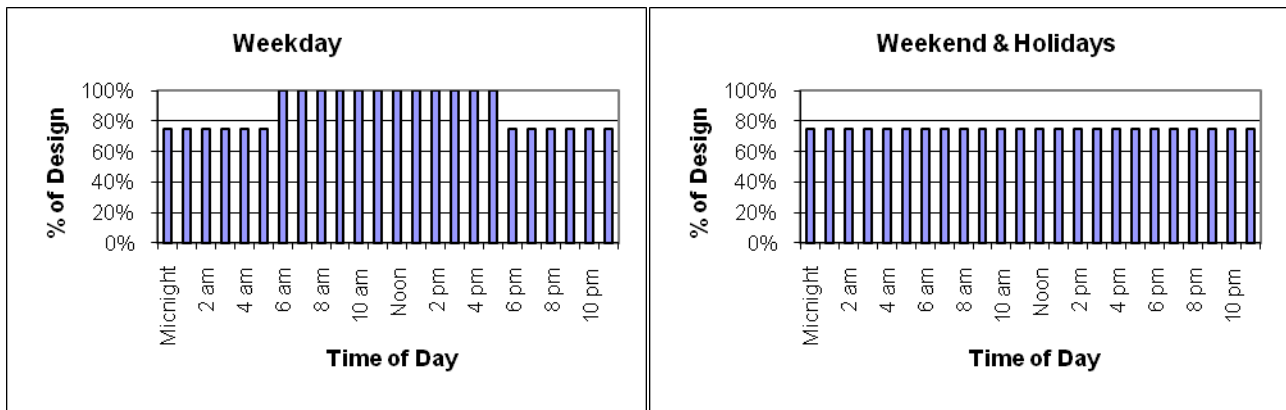

Retail equipment:
Schedule thru December 31

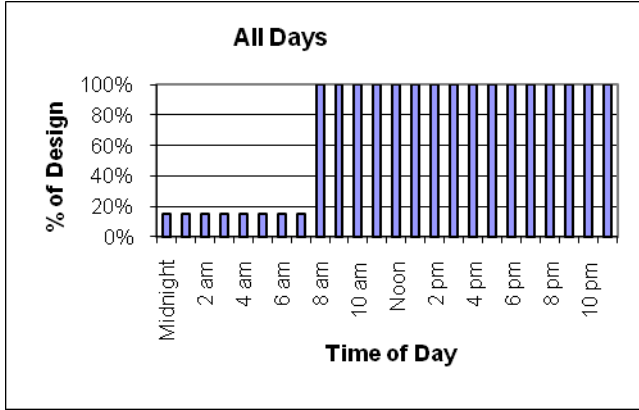

APPENDIX A - UTILITY RATES

The energy model uses the following utility rates to calculate the building's energy cost.

1.1. Electricity

ConEdison PSC-10, SC-9, Rate II (General Large > 1,500 kW monthly demand), low tension

NY Sales Tax: 8.875

Time Period	Demand Charge			Energy Charge	
	M-F, 8am-6 pm per kW	M-F, 8am-10pm per kW	All hours per kW	M-F 8am-10pm per kWh	Other hours per kWh
January	\$24.87	\$19.41	\$7.71	\$0.0958	\$0.0783
February	\$22.89	\$17.43	\$5.73	\$0.0983	\$0.0905
March	\$22.89	\$17.43	\$5.73	\$0.1103	\$0.0985
April	\$22.89	\$17.43	\$5.73	\$0.1054	\$0.0924
May	\$32.84	\$27.38	\$15.68	\$0.0999	\$0.0844
June	\$57.06	\$40.03	\$24.16	\$0.1300	\$0.0970
July	\$57.06	\$40.03	\$24.16	\$0.0975	\$0.0653
August	\$57.06	\$40.03	\$24.16	\$0.0776	\$0.0550
September	\$57.06	\$40.03	\$24.16	\$0.1049	\$0.0883
October	\$32.84	\$27.38	\$15.68	\$0.0734	\$0.0596
November	\$24.87	\$19.41	\$7.71	\$0.1086	\$0.0946
December	\$24.87	\$19.41	\$7.71	\$0.0741	\$0.0650

1.2. Steam

DES Steam Rate

NY Sales Tax: 8.375%

Month	Per MMBTU
January	\$17.708
February	\$22.922
March	\$21.704
April	\$22.422
May	\$18.843
June	\$18.377
July	\$11.265
August	\$12.594
September	\$8.965
October	\$12.780
November	\$16.483
December	\$23.915

1.3. Gas

ConEdison PSC-9 Gas, Rider H Rate I (Distributed Generation Rule for less than 5,000 kW)

NY Sales Tax: 8.875 %

Time Period	Energy Charge	
	Monthly Charge	Energy Charge <i>per therm</i>
January	\$420.588	\$0.9065
February	\$420.573	\$0.9065
March	\$420.420	\$0.8125
April	\$421.305	\$0.8250
May	\$421.470	\$0.6100
June	\$421.320	\$0.6515
July	\$421.371	\$0.6515
August	\$421.236	\$0.6675
September	\$421.359	\$0.6675
October	\$421.230	\$0.6900
November	\$420.753	\$0.8805
December	\$420.564	\$0.8805

APPENDIX B – DOE2.1E SUMMARY OUTPUT REPORTS

1 DOE 2.1E MANHATTAN WEST DOE-2.1E-121 Mon Sep 15 10:47:26 2014PDL RUN 1
Alnp3: 1600 kW:290 TR SIM: VIRIDIAN ENERGY & ENVIRONMENTAL LL
REPORT- PS-D PLANT LOADS SATISFIED WEATHER FILE- NEW YORK CENTRAL NY

HEATING LOADS	MBTU SUPPLIED	PCT OF TOTAL LOAD
-----	-----	-----
HW-BOILER	36521.5	63.4
ELEC-DHW-HEATER	0.0	0.0
GTURB-GEN	21043.6	36.6
	=====	=====
LOAD SATISFIED	57565.1	100.0
TOTAL LOAD ON PLANT	57564.5	

COOLING LOADS	MBTU SUPPLIED	PCT OF TOTAL LOAD
-----	-----	-----
OPEN-REC-CHLR	0.0	0.0
ABSOR1-CHLR	2178.2	64.9
COOLING-TWR	1177.0	35.1
	=====	=====
LOAD SATISFIED	3355.2	100.0
TOTAL LOAD ON PLANT	3355.2	

ELECTRICAL LOADS	KWH SUPPLIED	PCT OF TOTAL LOAD
-----	-----	-----
GTURB-GEN	11641912.0	38.4
ELECTRICITY	18655876.0	61.6
	=====	=====
LOAD SATISFIED	30297788.0	100.0
TOTAL LOAD ON PLANT	30297732.0	

TOWER ABOVE DESIGN TEMPERATURE OF 88.F 0 HOURS
1 DOE 2.1E MANHATTAN WEST DOE-2.1E-121 Mon Sep 15 10:47:26 2014PDL RUN 1
Alnp3: 1600 kW:290 TR SIM: VIRIDIAN ENERGY & ENVIRONMENTAL LL
REPORT- PS-D PLANT LOADS SATISFIED WEATHER FILE- NEW YORK CENTRAL NY
----- (CONTINUED) -----

SUMMARY OF LOADS MET

TYPE OF LOAD	TOTAL LOAD (MBTU)	LOAD SATISFIED (MBTU)	TOTAL OVERLOAD (MBTU)	PEAK OVERLOAD (MBTU)	HOURS OVERLOADED
HEATING LOADS	57564.5	57565.1	0.000	0.000	0
COOLING LOADS	3355.2	3355.2	0.000	0.000	0
ELECTRICAL LOADS	103405.2	103405.4	0.000	0.000	0

1 DOE 2.1E MANHATTAN WEST DOE-2.1E-121 Mon Sep 15 10:47:26 2014PDL RUN 1
 Alnp3: 1600 kW:290 TR SIM: VIRIDIAN ENERGY & ENVIRONMENTAL LL
 REPORT- PS-E MONTHLY ENERGY END-USE SUMMARY WEATHER FILE- NEW YORK CENTRAL NY

OELECTRICAL END-USES IN KWH

	JAN	FEB	MAR	APR	MAY	JUN	JUL	AUG	SEP	OCT	NOV	DEC	TOTAL
0 AREA LIGHTS	714750.	658119.	755434.	727493.	714489.	727437.	728302.	741487.	713691.	714608.	700073.	727963.	8623846.
MAX KW	1551.8	1551.8	1548.5	1547.0	1547.0	1547.0	1547.0	1547.0	1547.0	1547.0	1551.8	1551.8	1551.8
DAY/HR	4/18	2/18	1/18	1/10	3/10	1/10	1/10	2/10	1/10	29/18	1/18	1/18	
0 MISC EQUIPMT	780987.	712654.	806567.	778502.	780987.	778501.	790703.	796851.	768785.	780987.	759069.	787135.	9321729.
MAX KW	1596.4	1596.4	1596.4	1596.4	1596.4	1596.4	1596.4	1596.4	1596.4	1596.4	1596.4	1596.4	1596.4
DAY/HR	4/10	1/10	1/10	1/10	3/10	1/10	1/10	2/10	1/10	1/10	1/10	1/10	
0 SPACE COOL	98521.	132886.	241911.	227671.	338628.	549136.	708531.	632038.	442266.	229131.	228002.	122418.	3951139.
MAX KW	1134.8	1339.0	1702.8	2377.4	1854.9	1880.7	2370.2	2931.9	1911.8	1305.0	1475.4	1153.7	2931.9
DAY/HR	19/14	23/14	16/13	28/ 4	28/17	2/16	13/16	17/16	3/16	1/15	18/13	16/14	
0 HEAT REJECT	14.	342.	3017.	6153.	21364.	32851.	47743.	42607.	30133.	10142.	2425.	41.	196830.
MAX KW	1.6	44.5	45.9	91.9	91.9	91.9	91.9	91.9	91.9	48.9	44.5	6.5	91.9
DAY/HR	26/14	2/10	16/12	28/11	12/14	2/13	3/14	2/10	2/13	18/14	6/16	21/13	
0 PUMPS & MISC	260973.	280628.	370183.	143336.	128379.	99153.	119032.	112026.	92910.	151641.	313850.	309079.	2381188.
MAX KW	1100.4	1093.0	1126.6	1075.9	1036.0	308.1	401.7	515.3	590.7	675.0	1086.8	1098.1	1126.6
DAY/HR	18/13	6/13	16/14	8/ 9	6/ 8	22/15	13/16	17/16	20/ 5	30/12	18/ 9	11/13	
0 VENT FANS	411444.	377276.	431458.	410734.	383215.	424340.	440846.	437613.	397569.	386559.	384074.	414556.	4899682.
MAX KW	1026.0	1026.6	1045.5	1085.4	1188.7	1221.6	1245.3	1312.4	1177.0	1067.4	1044.7	1025.9	1312.4
DAY/HR	27/10	2/10	16/13	28/17	10/15	22/16	21/18	17/16	7/16	1/17	2/13	15/10	
0 DOMHOT WATER	2182.	1971.	2182.	2112.	2182.	2112.	2182.	2182.	2112.	2182.	2112.	2182.	25695.
MAX KW	2.9	2.9	2.9	2.9	2.9	2.9	2.9	2.9	2.9	2.9	2.9	2.9	2.9
DAY/HR	1/ 1	1/ 1	15/23	1/ 1	1/ 2	1/ 2	1/ 2	1/ 2	20/ 9	9/15	1/ 1	13/ 3	
0 EXT LIGHTS	3302.	2762.	2996.	2899.	2802.	2472.	2690.	2939.	2899.	2996.	3084.	3439.	35280.
MAX KW	8.1	8.1	8.1	8.1	8.1	8.1	8.1	8.1	8.1	8.1	8.1	8.1	8.1
DAY/HR	1/ 1	1/ 1	1/ 1	1/ 1	1/ 2	1/ 2	1/ 2	1/ 2	1/ 2	1/ 2	1/ 1	1/ 1	
0 EXT MISC	71859.	65843.	75136.	72448.	71859.	72448.	72883.	74112.	71219.	71859.	69990.	72678.	862336.
MAX KW	204.8	204.8	204.8	204.8	204.8	204.8	204.8	204.8	204.8	204.8	204.8	204.8	204.8
DAY/HR	4/ 7	1/ 7	1/ 7	1/ 7	3/ 7	1/ 7	1/ 7	2/ 7	1/ 7	1/ 7	1/ 7	1/ 7	
0 TOTAL KWH	2344032.	2232482.	2688883.	2371346.	2443906.	2688450.	2912912.	2841854.	2521585.	2350105.	2462680.	2439490.	30297724.

OFUEL END-USES IN MBTU

	JAN	FEB	MAR	APR	MAY	JUN	JUL	AUG	SEP	OCT	NOV	DEC	TOTAL
0 SPACE HEAT	9092.5	6664.0	5568.7	1881.2	454.2	0.0	0.0	0.0	10.4	1217.5	4303.7	7329.3	36521.4
MAX MBTU	54.559	36.972	25.500	19.638	13.991	0.000	0.000	0.000	10.388	19.806	27.830	37.847	54.559
DAY/HR	23/ 8	6/ 8	1/ 8	8/ 9	4/22	0/ 0	0/ 0	0/ 0	20/ 8	23/14	27/ 8	27/ 5	
0 TOTAL MBTU	9092.5	6664.0	5568.7	1881.2	454.2	0.0	0.0	0.0	10.4	1217.5	4303.7	7329.3	36521.4

1 DOE 2.1E MANHATTAN WEST DOE-2.1E-121 Mon Sep 15 10:47:26 2014PDL RUN 1
 Alnp3: 1600 kW:290 TR SIM: VIRIDIAN ENERGY & ENVIRONMENTAL LL
 REPORT- BEPS BUILDING ENERGY PERFORMANCE SUMMARY WEATHER FILE- NEW YORK CENTRAL NY

ENERGY TYPE: UNITS: MBTU	ELECTRICITY	NATURAL-GAS	FUEL-OIL	RECOVERED
CATEGORY OF USE				
AREA LIGHTS	17382.1	40103.2	0.0	0.0
MISC EQUIPMT	17738.5	46824.3	0.0	0.0
SPACE HEAT	0.0	0.0	36521.5	15279.6
SPACE COOL	9575.2	13232.6	0.0	3223.2
HEAT REJECT	398.6	931.0	0.0	0.0
PUMPS & MISC	5535.6	8585.0	0.0	0.0
VENT FANS	11232.8	18270.6	0.0	0.0
DOMHOT WATER	42.2	151.2	0.0	2540.9
EXT LIGHTS	39.0	270.1	0.0	0.0
EXT MISC	1727.9	4042.9	0.0	0.0
COGEN SURPLS	0.0	0.0	0.0	0.0
TOTAL	63672.0	132410.8	36521.5	21043.7

TOTAL SITE ENERGY 232604.30 MBTU 109.1 KBTU/SQFT-YR GROSS-AREA 109.1 KBTU/SQFT-YR NET-AREA
 TOTAL SOURCE ENERGY 359967.34 MBTU 168.9 KBTU/SQFT-YR GROSS-AREA 168.9 KBTU/SQFT-YR NET-AREA

PERCENT OF HOURS ANY SYSTEM ZONE OUTSIDE OF THROTTLING RANGE = 1.5
 PERCENT OF HOURS ANY PLANT LOAD NOT SATISFIED = 0.0

NOTE: ENERGY IS APPORTIONED HOURLY TO ALL END-USE CATEGORIES.

1 DOE 2.1E MANHATTAN WEST DOE-2.1E-121 Mon Sep 15 10:47:26 2014PDL RUN 1
 Alnp3: 1600 kW:290 TR SIM: VIRIDIAN ENERGY & ENVIRONMENTAL LL
 REPORT- BEPU BUILDING ENERGY PERFORMANCE SUMMARY (UTILITY UNITS) WEATHER FILE- NEW YORK CENTRAL NY

ENERGY TYPE: SITE UNITS:	ELECTRICITY KWH	NATURAL-GAS THERM	FUEL-OIL MMBTU	RECOVERED MBTU
CATEGORY OF USE -----				
AREA LIGHTS	5092942.	401032.	0.	0.
MISC EQUIPMT	5197373.	468243.	0.	0.
SPACE HEAT	0.	0.	38853.	15280.
SPACE COOL	2805544.	132326.	0.	3223.
HEAT REJECT	116798.	9310.	0.	0.
PUMPS & MISC	1621931.	85850.	0.	0.
VENT FANS	3291216.	182706.	0.	0.
DOMHOT WATER	12367.	1512.	0.	2541.
EXT LIGHTS	11430.	2701.	0.	0.
EXT MISC	506284.	40429.	0.	0.
COGEN SURPLS	0.	0.	0.	0.
	-----	-----	-----	-----
TOTAL	18655886.	1324108.	38853.	21044.

TOTAL ELECTRICITY	18655886. KWH	8.753 KWH	/SQFT-YR GROSS-AREA	8.753 KWH	/SQFT-YR NET-AREA
TOTAL NATURAL-GAS	1324108. THERM	0.621 THERM	/SQFT-YR GROSS-AREA	0.621 THERM	/SQFT-YR NET-AREA
TOTAL FUEL-OIL	38853. MMBTU	0.018 MMBTU	/SQFT-YR GROSS-AREA	0.018 MMBTU	/SQFT-YR NET-AREA

PERCENT OF HOURS ANY SYSTEM ZONE OUTSIDE OF THROTTLING RANGE = 1.5
 PERCENT OF HOURS ANY PLANT LOAD NOT SATISFIED = 0.0

NOTE: ENERGY IS APPORTIONED HOURLY TO ALL END-USE CATEGORIES.

1 DOE 2.1E MANHATTAN WEST DOE-2.1E-121 Mon Sep 15 10:47:26 2014EDL RUN 1
 Alnp3: 1600 kW:290 TR SIM: VIRIDIAN ENERGY & ENVIRONMENTAL LL
 REPORT- ES-D ENERGY COST SUMMARY

UTILITY-RATE	RESOURCE	METERS	METERED ENERGY UNITS/YR	TOTAL CHARGE (\$)	VIRTUAL RATE (\$/UNIT)	RATE USED ALL YEAR?
OELEC-SALE	ELEC-NET-SALE	1 2 3 4 5	0. KWH	0.	0.0000	YES
OSC9-ELEC-TARIFF	ELECTRICITY	1 2 3 4 5	18655880. KWH	4546852.	0.2437	YES
ODES-STM-RATE	FUEL-OIL	1 2	38853. MMBTU	861504.	22.1737	YES
ORDR-H-GAS-TARIFF	NATURAL-GAS	5	1324109. THERM	1108197.	0.8369	YES
0				=====		
0				6516554.		

ENERGY COST/GROSS BLDG AREA: 3.06
 ENERGY COST/NET BLDG AREA: 3.06

1 DOE 2.1E MANHATTAN WEST DOE-2.1E-121 Mon Sep 15 11:02:33 2014PDL RUN 1
 ANYEC: NYSECCC code compliance for EN1 SIM: VIRIDIAN ENERGY & ENVIRONMENTAL LL
 REPORT- PS-D PLANT LOADS SATISFIED WEATHER FILE- NEW YORK CENTRAL NY

HEATING LOADS	MBTU SUPPLIED	PCT OF TOTAL LOAD
HW-BOILER	44857.6	94.8
ELEC-DHW-HEATER	2460.4	5.2
	=====	=====
LOAD SATISFIED	47318.0	100.0
TOTAL LOAD ON PLANT	47318.3	
COOLING LOADS	MBTU SUPPLIED	PCT OF TOTAL LOAD
OPEN-CENT-CHLR	83693.0	100.0
	=====	=====
LOAD SATISFIED	83693.0	100.0
TOTAL LOAD ON PLANT	83693.0	
ELECTRICAL LOADS	KWH SUPPLIED	PCT OF TOTAL LOAD

ELECTRICITY 31725734.0 100.0
=====

LOAD SATISFIED 31725734.0 100.0
TOTAL LOAD ON PLANT 31725796.0

TOWER ABOVE DESIGN TEMPERATURE OF 88.F 1 HOURS
MAXIMUM TOWER EXIT TEMPERATURE = 89.F

1 DOE 2.1E MANHATTAN WEST DOE-2.1E-121 Mon Sep 15 11:02:33 2014PDL RUN 1
ANYEC: NYSECCC code compliance for EN1 SIM: VIRIDIAN ENERGY & ENVIRONMENTAL LL
REPORT- PS-D PLANT LOADS SATISFIED WEATHER FILE- NEW YORK CENTRAL NY
----- (CONTINUED) -----

SUMMARY OF LOADS MET

TYPE OF LOAD	TOTAL LOAD (MBTU)	LOAD SATISFIED (MBTU)	TOTAL OVERLOAD (MBTU)	PEAK OVERLOAD (MBTU)	HOURS OVERLOADED
HEATING LOADS	47318.3	47318.0	0.000	0.000	0
COOLING LOADS	83693.0	83693.0	0.521	0.286	2
ELECTRICAL LOADS	108279.2	108279.0	0.000	0.000	0

1 DOE 2.1E MANHATTAN WEST DOE-2.1E-121 Mon Sep 15 11:02:33 2014PDL RUN 1
ANYEC: NYSECCC code compliance for EN1 SIM: VIRIDIAN ENERGY & ENVIRONMENTAL LL
REPORT- PS-E MONTHLY ENERGY END-USE SUMMARY WEATHER FILE- NEW YORK CENTRAL NY

OELECTRICAL END-USES IN KWH

	JAN	FEB	MAR	APR	MAY	JUN	JUL	AUG	SEP	OCT	NOV	DEC	TOTAL
0 AREA LIGHTS	874901.	803868.	919551.	885890.	874320.	885766.	889704.	903882.	870524.	874576.	855576.	889149.	10527706.
MAX KW	1842.1	1842.1	1838.0	1832.0	1832.0	1832.0	1832.0	1832.0	1832.0	1834.5	1842.1	1842.1	1842.1
DAY/HR	4/18	2/18	17/18	1/10	3/10	1/10	1/10	2/10	1/10	26/18	1/18	1/18	
0MISC EQUIPMT	780987.	712654.	806567.	778502.	780987.	778501.	790703.	796851.	768785.	780987.	759069.	787135.	9321729.
MAX KW	1596.4	1596.4	1596.4	1596.4	1596.4	1596.4	1596.4	1596.4	1596.4	1596.4	1596.4	1596.4	1596.4
DAY/HR	4/10	1/10	1/10	1/10	3/10	1/10	1/10	2/10	1/10	1/10	1/10	1/10	
0 SPACE COOL	158959.	187666.	297959.	202965.	261007.	427342.	581832.	510330.	334464.	178970.	278367.	189774.	3609634.
MAX KW	1038.4	1308.0	1513.6	1226.9	1555.4	1541.5	2092.0	2633.2	1592.7	1008.5	1394.3	1174.2	2633.2
DAY/HR	14/14	23/13	16/13	28/16	28/18	23/18	23/18	17/16	3/16	27/13	18/14	16/15	
0 HEAT REJECT	81787.	85978.	123169.	93490.	133036.	210028.	297079.	258788.	170012.	85571.	114413.	90053.	1743404.
MAX KW	293.5	460.2	687.1	635.2	635.2	635.2	707.6	780.0	635.2	488.1	489.8	425.0	780.0
DAY/HR	14/14	1/15	16/12	28/15	10/15	2/13	12/10	17/13	2/15	18/15	18/ 9	16/16	
0PUMPS & MISC	68406.	61740.	69945.	61537.	56343.	49115.	57860.	54376.	44898.	60178.	66109.	67322.	717830.
MAX KW	147.5	151.6	166.9	132.5	151.5	128.5	155.9	186.4	126.2	130.6	159.3	143.7	186.4

	DAY/HR	23/ 8	23/13	16/13	28/17	28/17	23/17	23/18	17/15	3/16	30/14	18/14	16/15	
0	VENT FANS	344174.	311689.	344612.	325150.	320899.	365281.	385606.	378472.	337826.	318803.	305522.	342509.	4080544.
	MAX KW	752.8	753.5	754.2	833.1	987.7	1026.4	1047.3	1120.0	963.4	819.4	764.3	752.3	1120.0
	DAY/HR	27/10	2/10	17/10	28/17	10/16	22/16	21/18	17/16	7/17	1/16	2/12	15/10	
0	ODOMHOT WATER	72999.	70834.	84216.	79489.	69764.	69264.	63166.	62567.	59709.	60247.	63682.	71360.	827297.
	MAX KW	400.7	415.8	417.0	409.8	381.0	352.3	327.5	311.7	310.4	323.2	347.4	375.2	417.0
	DAY/HR	4/13	1/13	1/13	1/13	3/13	1/13	1/13	2/13	1/13	1/13	1/13	1/13	
0	EXT LIGHTS	3302.	2762.	2996.	2899.	2802.	2472.	2690.	2939.	2899.	2996.	3084.	3439.	35280.
	MAX KW	8.1	8.1	8.1	8.1	8.1	8.1	8.1	8.1	8.1	8.1	8.1	8.1	8.1
	DAY/HR	1/ 1	1/ 1	1/ 1	1/ 1	1/ 2	1/ 2	1/ 2	1/ 2	1/ 2	1/ 2	1/ 1	1/ 1	
0	EXT MISC	71859.	65843.	75136.	72448.	71859.	72448.	72883.	74112.	71219.	71859.	69990.	72678.	862336.
	MAX KW	204.8	204.8	204.8	204.8	204.8	204.8	204.8	204.8	204.8	204.8	204.8	204.8	204.8
	DAY/HR	4/ 7	1/ 7	1/ 7	1/ 7	3/ 7	1/ 7	1/ 7	2/ 7	1/ 7	1/ 7	1/ 7	1/ 7	
		=====	=====	=====	=====	=====	=====	=====	=====	=====	=====	=====	=====	=====
0	TOTAL KWH	2457374.	2303034.	2724150.	2502370.	2571018.	2860218.	3141522.	3042315.	2660336.	2434187.	2515813.	2513419.	31725760.

0FUEL END-USES IN MBTU

			JAN	FEB	MAR	APR	MAY	JUN	JUL	AUG	SEP	OCT	NOV	DEC	TOTAL
0	SPACE HEAT		10251.0	7927.5	7116.4	2712.1	676.1	0.0	0.0	0.0	15.1	1821.5	5687.5	8650.5	44857.7
	MAX MBTU		52.764	36.089	28.104	22.635	17.520	0.000	0.000	0.000	15.087	21.709	27.423	36.459	52.764
	DAY/HR		23/ 8	6/ 8	4/10	7/ 9	5/ 8	0/ 0	0/ 0	0/ 0	20/ 8	23/14	27/ 8	11/14	
			=====	=====	=====	=====	=====	=====	=====	=====	=====	=====	=====	=====	=====
0	TOTAL MBTU		10251.0	7927.5	7116.4	2712.1	676.1	0.0	0.0	0.0	15.1	1821.5	5687.5	8650.5	44857.7

1 DOE 2.1E MANHATTAN WEST DOE-2.1E-121 Mon Sep 15 11:02:33 2014PDL RUN 1
 ANYEC: NYSECCC code compliance for EN1 SIM: VIRIDIAN ENERGY & ENVIRONMENTAL LL
 REPORT- BEPS BUILDING ENERGY PERFORMANCE SUMMARY WEATHER FILE- NEW YORK CENTRAL NY

ENERGY TYPE:	ELECTRICITY	FUEL-OIL
UNITS: MBTU		
CATEGORY OF USE		

AREA LIGHTS	35931.1	0.0
MISC EQUIPMT	31814.5	0.0
SPACE HEAT	0.0	44857.6
SPACE COOL	12319.6	0.0
HEAT REJECT	5950.2	0.0
PUMPS & MISC	2449.9	0.0
VENT FANS	13926.8	0.0

DOMHOT WATER	2823.5	0.0
EXT LIGHTS	120.4	0.0
EXT MISC	2943.1	0.0
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TOTAL	108279.0	44857.6

TOTAL SITE ENERGY	153136.67 MBTU	71.8 KBTU/SQFT-YR GROSS-AREA	71.8 KBTU/SQFT-YR NET-AREA
TOTAL SOURCE ENERGY	369727.22 MBTU	173.5 KBTU/SQFT-YR GROSS-AREA	173.5 KBTU/SQFT-YR NET-AREA

PERCENT OF HOURS ANY SYSTEM ZONE OUTSIDE OF THROTTLING RANGE = 0.8
 PERCENT OF HOURS ANY PLANT LOAD NOT SATISFIED = 0.0

NOTE: ENERGY IS APPORTIONED HOURLY TO ALL END-USE CATEGORIES.

1 DOE 2.1E MANHATTAN WEST DOE-2.1E-121 Mon Sep 15 11:02:33 2014PDL RUN 1
 ANYEC: NYSECCC code compliance for EN1 SIM: VIRIDIAN ENERGY & ENVIRONMENTAL LL
 REPORT- BEPU BUILDING ENERGY PERFORMANCE SUMMARY (UTILITY UNITS) WEATHER FILE- NEW YORK CENTRAL NY

ENERGY TYPE: SITE UNITS:	ELECTRICITY KWH	FUEL-OIL MMBTU
CATEGORY OF USE		

AREA LIGHTS	10527813.	0.
MISC EQUIPMT	9321645.	0.
SPACE HEAT	0.	49294.
SPACE COOL	3609633.	0.
HEAT REJECT	1743408.	0.
PUMPS & MISC	717809.	0.
VENT FANS	4080550.	0.
DOMHOT WATER	827296.	0.
EXT LIGHTS	35280.	0.
EXT MISC	862320.	0.
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TOTAL 31725754. 49294.

TOTAL ELECTRICITY 31725754. KWH 14.885 KWH /SQFT-YR GROSS-AREA 14.885 KWH /SQFT-YR NET-AREA
TOTAL FUEL-OIL 49294. MMBTU 0.023 MMBTU /SQFT-YR GROSS-AREA 0.023 MMBTU /SQFT-YR NET-AREA

PERCENT OF HOURS ANY SYSTEM ZONE OUTSIDE OF THROTTLING RANGE = 0.8
PERCENT OF HOURS ANY PLANT LOAD NOT SATISFIED = 0.0

NOTE: ENERGY IS APPORTIONED HOURLY TO ALL END-USE CATEGORIES.

1 DOE 2.1E MANHATTAN WEST DOE-2.1E-121 Mon Sep 15 11:02:33 2014EDL RUN 1
ANYEC: NYSECCC code compliance for ENL SIM: VIRIDIAN ENERGY & ENVIRONMENTAL LL
REPORT- ES-D ENERGY COST SUMMARY

UTILITY-RATE	RESOURCE	METERS	METERED ENERGY UNITS/YR	TOTAL CHARGE (\$)	VIRTUAL RATE (\$/UNIT)	RATE USED ALL YEAR?
OSC9-ELEC-TARIFF	ELECTRICITY	1 2 3 4 5	31725734. KWH	6438364.	0.2029	YES
0DES-STM-RATE	FUEL-OIL	1 2	49294. MMBTU	1090039.	22.1129	YES
0				=====		
0				7528403.		

ENERGY COST/GROSS BLDG AREA: 3.53
ENERGY COST/NET BLDG AREA: 3.53